PROJECT NUMBER: PR-2020-004596

Application Number: SI-2023-01076


Is an Infrastructure List required? () Yes () No If yes, then a set of approved DRC plans with a work order is required for any construction within Public Right-of-Way or for construction of public improvements.

DFT SITE DEVELOPMENT PLAN APPROVAL:

| Traffic Engineering, Transportation Division | Date |
|---|------|
| ABCWUA | Date |
| Parks and Recreation Department | Date |
| Hydrology | Date |
| Code Enforcement | Date |
| Environmental Health Department (conditional) | Date |
| Date Solid Waste Management | Date |
| Planning Department | Date |


1'-0" 1'-0" 4'-0" 4'-0" -CLEAR ZONE - X - X - X 1'-0" 2'-0" 2'-0" 2'-0" 2'-0" 1'-0"

BIKE PARKING

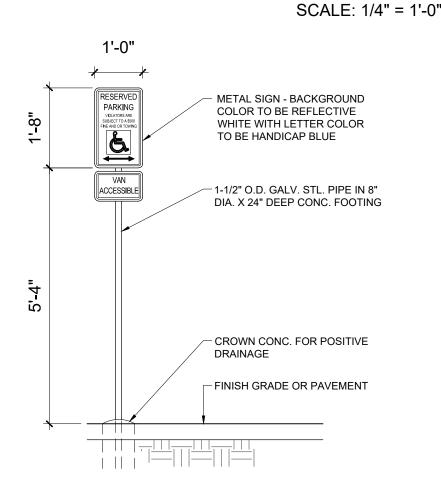

HC SIGN



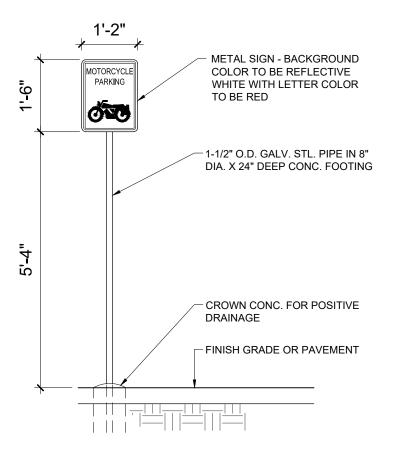

MOTORCYCLE SIGN

SCALE: 1/2" = 1'-0"

UPC: 101006305745520820 LEGAL: LOT 001 BLOCK 8 VOLCANO CLIFFS SUBDIVISION ZONING: MX-L ZONE ATLAS PAGE: D-10

GROSS LOT AREA = 6.5656 AC = 285,999.06 SF BUILDING FOOTPRINT = 92.414 SF NET LOT AREA = 193.585 SF

REQUIRED LANDSCAPE AREA @ 25% = 48,396 SF ; 115,374 SF PROVIDED PARKING:

MULTI-FAMILY

1 BEDROOM: 87 EACH X 1.2 SPACES = 104 SPACES 2 BEDROOM: 88 EACH X 1.6 SPACES = 140 SPACES

LEASING OFFICE 738 SF X 1 PER 3,500 SF = 2 SPACES REQUIRED CLUBHOUSE AMMENITY 583 SF X 1 PER 3,000 SF = 2 SPACES REQUIRED TOTAL SPACES REQUIRED = 248 SPACES SPACES PROVIDED = 296 SPACES 248 SPACES X 5% = 12 CHARGING SPACES REQUIRED, 13 PROVIDED

HC REQUIRED: 4 STANDARD, 3 VAN MOTORCYCLE PARKING 151-300 SPACES: 5 SPACES REQUIRED / 7 PROVIDED BIKE PARKING 10% OF 246: 25 REQUIRED, 32 SPACES PROVIDED

IDO TABLE 5-1-2 OPEN SPACE: 1 BEDROOM: 87 EA X 225 SF = 19,575 SF 2 BEDROOM: 88 EA X 285 SF = 25,080 SF

TOTAL REQUIRED = 44,837 SF

GRADE LEVEL OPEN SPACE = 67,985 SF PROVIDED (EXCLUDING SIDEWALKS) UPPER FLOOR BALCONIES & DECKS = 7,875 SF PROVIDED TOTAL PROVIDED = 75,860 (69% MORE THAN REQUIRED)

NOTE: ALL WINDOWS SHALL BE RECESSED 2 INCHES

ALL IMPROVEMENTS LOCATED IN THE RIGHT OF WAY MUST BE INCLUDED IN ON A PUBLIC WORK ORDER.

LANDSCAPING, FENCING AND SIGNING WILL NOT INTERFERE WITH CLEAR SIGHT REQUIREMENTS. THEREFORE, SIGNS, WALLS, TREES AND SHRUBBERY BETWEEN 3 AND 8 FEET TALL (AS MEASURED FROM THE GUTTER PAN) WILL NOT BE ACCEPTABLE IN THE CLEAR SIGHT TRIANGLE.

ALL PAVING SHALL BE SHALL BE ASPHALT UNLESS NOTED OTHERWISE, REF. DETAIL THIS SHEET.

ALL MECHANICAL EQUIPMENT SHALL BE SCREENED IN ACCORDANCE WITH IDO SECTION 5-5 (G).

ALL OUTDOOR LIGHT FIXTURES SHALL BE LED. FIXTURES 70 WATTS OR GREATER SHALL BE SHIELDED USING FULL CUTOFF LIGHT FIXTURES.


BUILDING MOUNTED SIGNS SHALL BE EXTERNALLY ILLUMINATED AND SHALL NOT EXTEND MORE THAN 2 FEET ABOVE THE EXTERIOR WALLS OF THE BUILDING.

WORK WITHIN THE PUBLIC RIGHT OF WAY REQUIRES A WORK ORDER.

PROVIDE ELECTRIC VEHICLE CHARGER AT EACH BAY OF LEASED GARAGES

SITE LIGHTING WILL BE PROVIDED BY LIGHT BOLLARDS AND WALL MOUNTED FIXTURES AND SHALL COMPLY WITH 5-8 OF THE IDO

"MC" SHALL BE PAINTED ON THE PAVEMENT OF EACH MOTORCYCLE PARKING SPACE

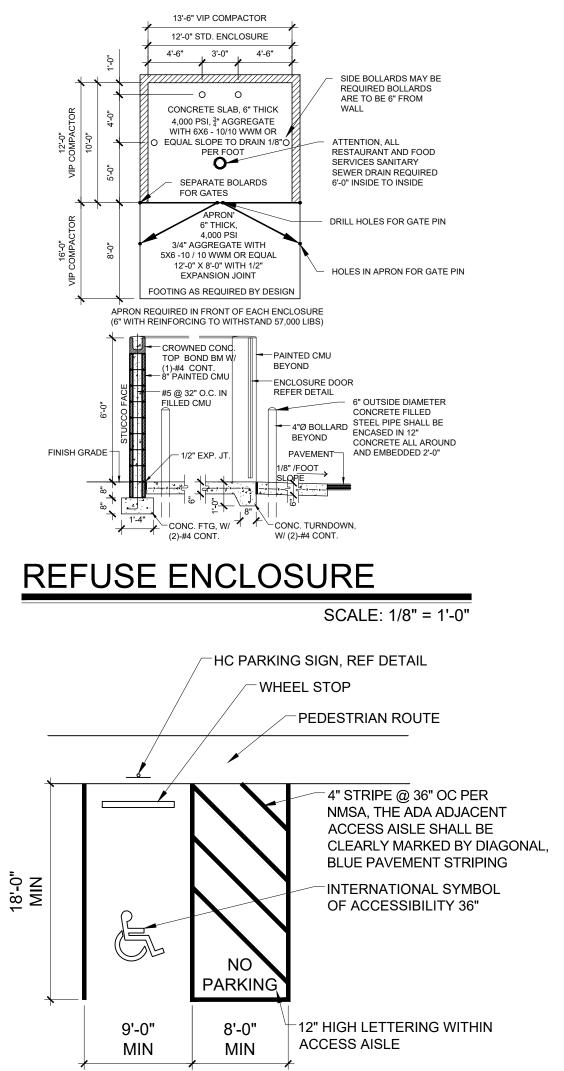

ADA PARKING

SOLID WASTE CALCS: 175 UNITS X 0.55 CY = 96 CY PER WEEK

SOLID WASTE NOTES:

THE DEVELOPMENT HAS GATES, OWNER TO PROVIDE THE REFUSE DRIVER WITH REMOTE CONTROL GATE OPENER.

THE SLOPE LEADING TO THE TRASH ENCLOSURE/DUMPSTER SHALL BE NO GREATER THAN 1/8" PER FOOT ON THE APPROACH.

THERE IS NO FOOD SERVICE FOR THIS PROJECT.


RECYCLING CONTAINERS LOCATED ADJACENT TO THE REFUSE ENCLOSURE, SEE KEYED NOTE.

THE REFUSE DRIVER SHALL HAVE ACCESS TO TRASH ENCLOSURE/DUMPSTER BY 5:00AM.


THERE ARE NO OVERHANGING WIRES LEADING TO AND EXITING FROM THE TRASH ENCLOSURE.

THIS PROJECT WILL NOT ALTER EXISTING TRASH SERVICE FOR THE SURROUNDING BUSINESSES DURING CONSTRUCTION.

OWNER SHALL PURCHASE 8 CY REFUSE CONTAINER.

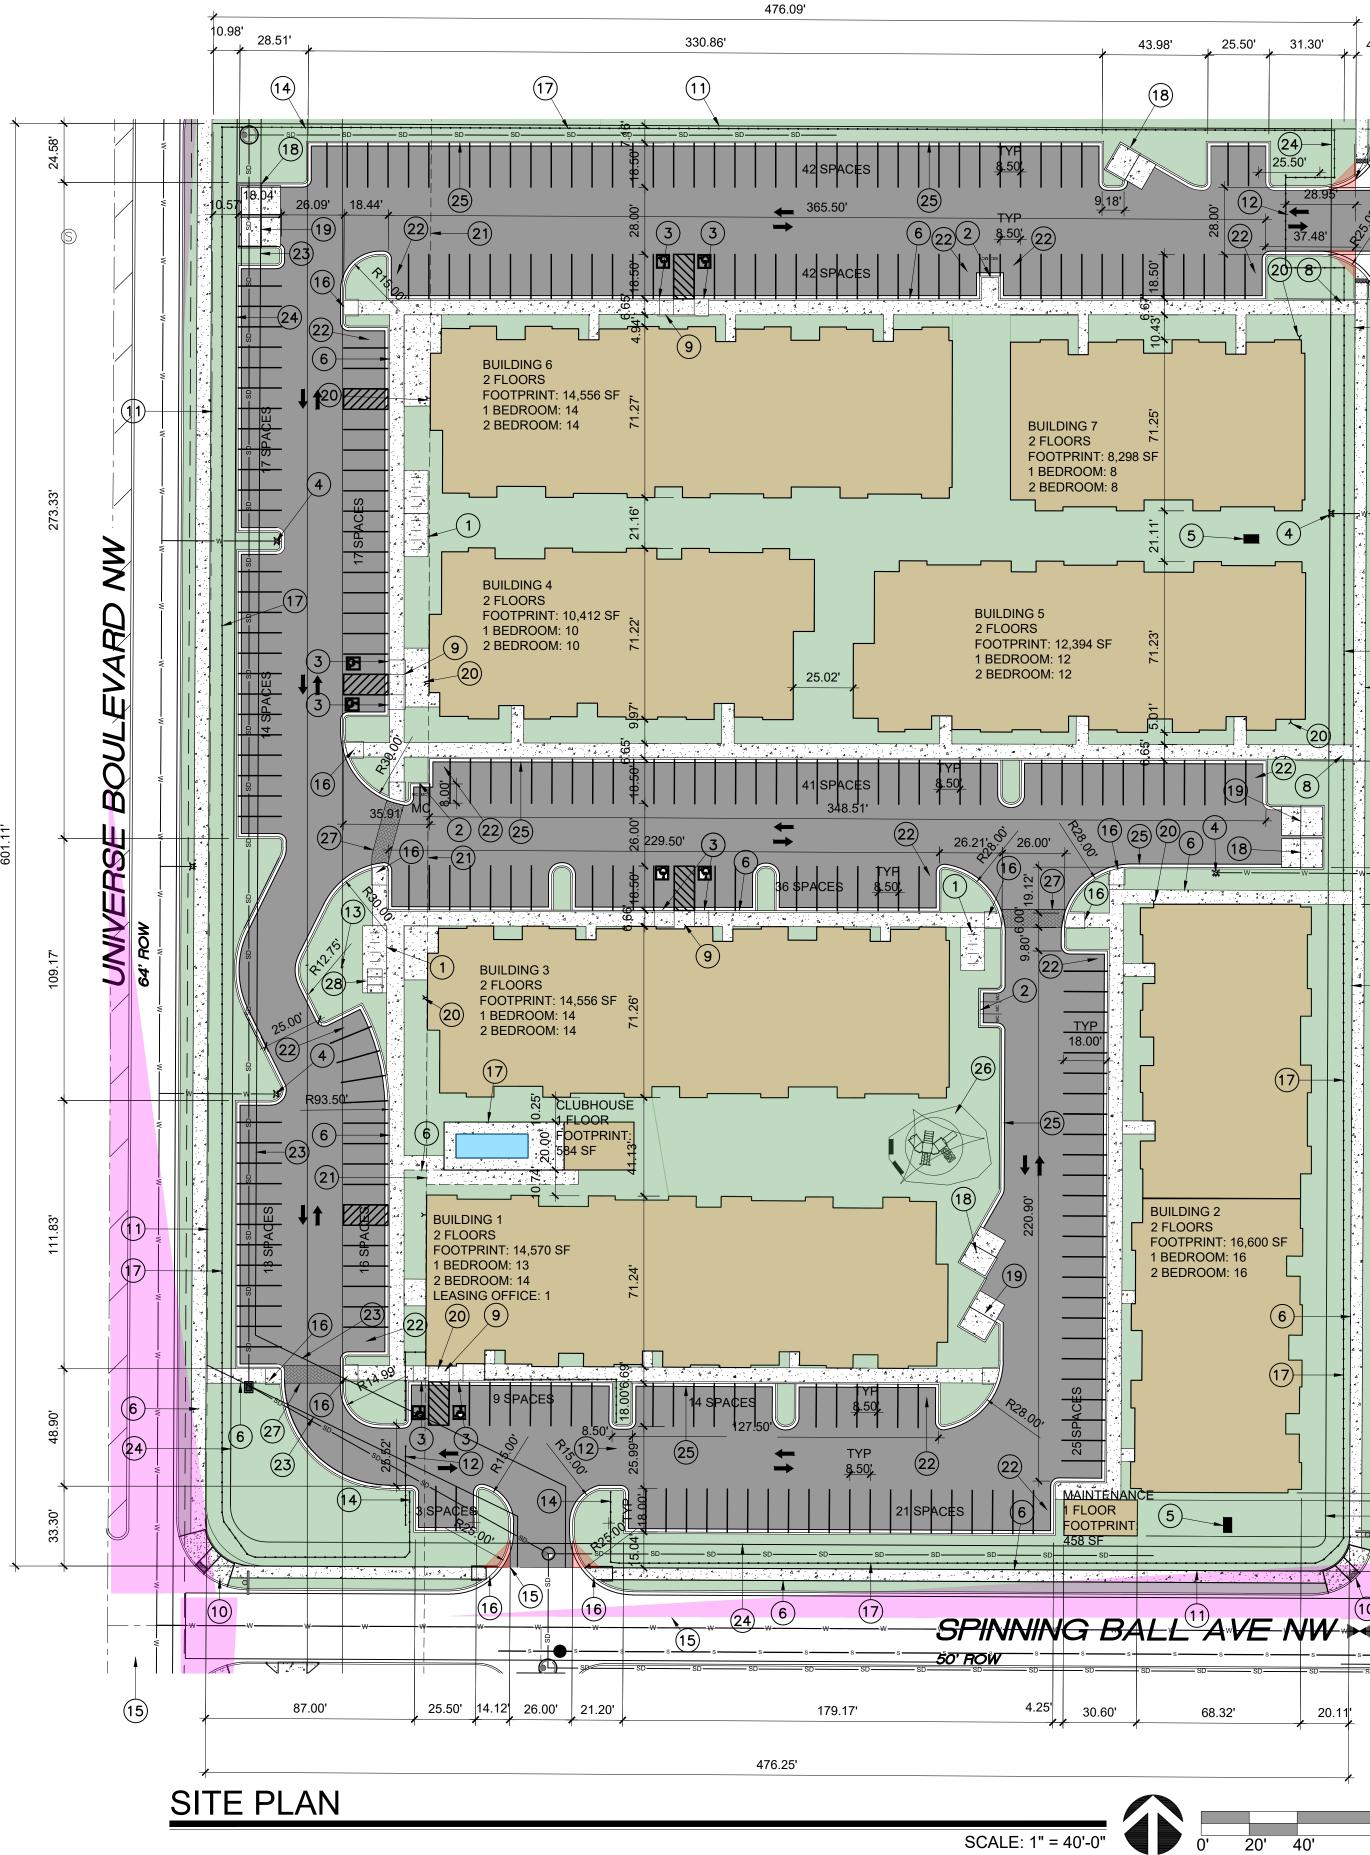




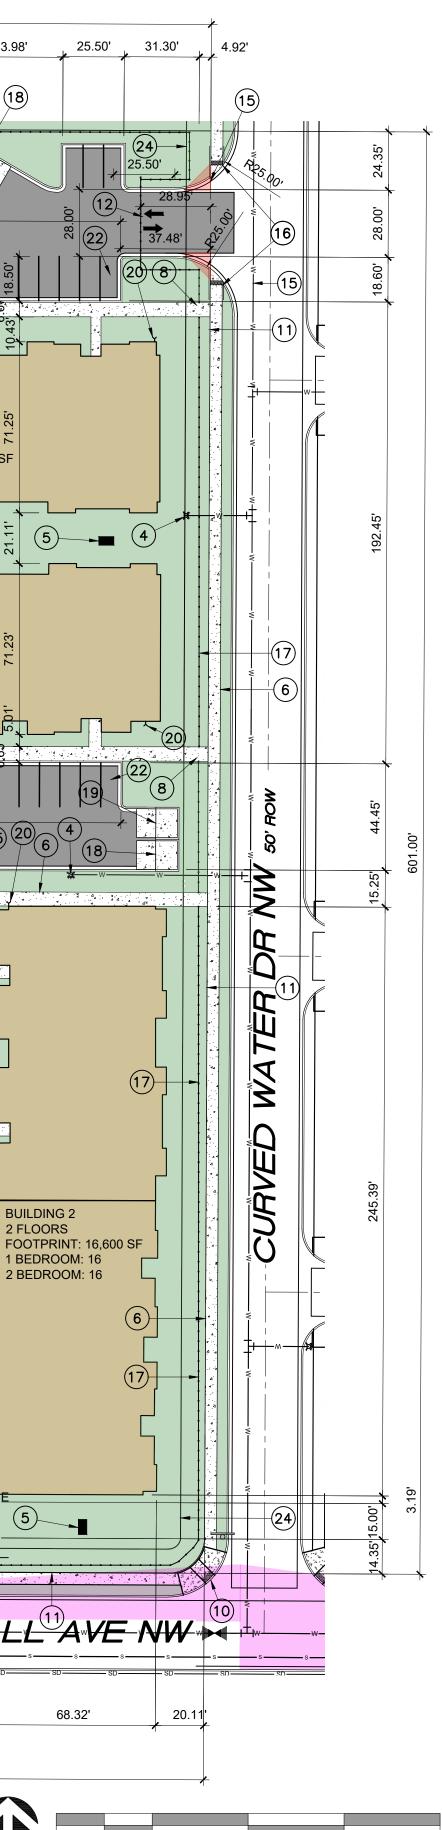


KEYED NOTES

- 1. 8 SPACE BIKE RACK, REF DETAIL THIS SHEET
- MOTORCYCLE PARKING SIGN REF DETAIL THIS SHEET 3. H.C. PARKING SIGN, REF DETAIL ON THIS SHEET
- 4. NEW FIRE HYDRANT
- 5. IRRIGATION BOX
- NEW 6' SIDEWALK, 2% MAX CROSS SLOPE, 1.5% PREFERRED CROSS SLOPE, 6. REFERENCE CITY OF ALBUQUERQUE STANDARD DETAIL 2430 7. FIRE DEPT. CONNECTION
- 8. PEDESTRIAN GATE
- 9. PARALLEL CURB RAMP, REF DETAIL A, COA STANDARD DETAIL 2443 10. PERPENDICULAR CURB RAMP, REF DETAIL B COA STANDARD DETAIL 2441
- 11. PROPERTY LINE
- 12. VEHICULAR GATE
- 13. EXISTING POWER POLE 14. KNOX BOX
- 15. CLEAR SIGHT TRIANGLE. LANDSCAPING, FENCING AND SIGNING WILL NOT INTERFERE WITH CLEAR SIGHT REQUIREMENTS. THEREFORE, SIGNS, WALLS, TREES AND SHRUBBERY BETWEEN 3 AND 8 FT TALL (AS MEASURED FROM THE GUTTER PAN) WILL NOT BE ACCEPTABLE IN THE CLEAR SIGHT TRIANGLE 16. PERPENDICULAR RAMP, REF COA STANDARD DETAIL 2447
- 17. 3'-0" CMU FENCE
- 18. REFUSE CONTAINER, REF DETAIL THIS SHEET 19. RECYCLING CONTAINER, REF DETAIL THIS SHEET
- 20. FIRE DEPARTMENT CONNECTION
- 21. 100FT POWER LINE EASEMENT
- 22. ELECTRIC VEHICLE CHARGING STATION
- 23. 20FT DRAINAGE EASEMNT 24. 10FT PUBLIC UTILITY EASEMENT
- 25. 8" STANDARD C & G PER COA STANDARD DETAIL 2415A
- 26. PLAYGROUND
- 27. COLORED CONCRETE CROSSWALK WITH STAMPED BRICK PATTERN 28. LONG TERM BICYCLE STORAGE LOCKER, GLOBAL INDUSTRIAL T9FB936381, 2 BIKE. 3 LOCKERS PROVIDED WITH 2 BIKES PER LOCKER = 6 SPACES PROVIDED.
- STUCCO LRV:
- 9080 = 26
- 9085 = 28
- 6033 = 19 9095 = 50



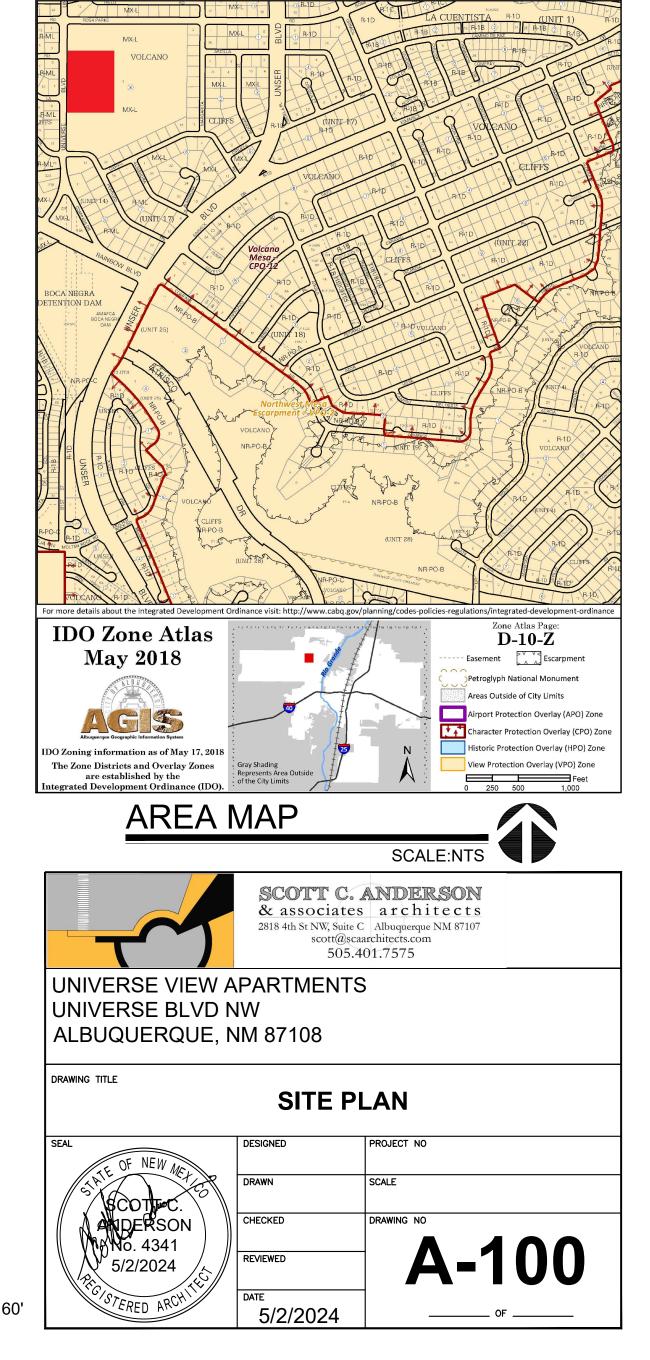

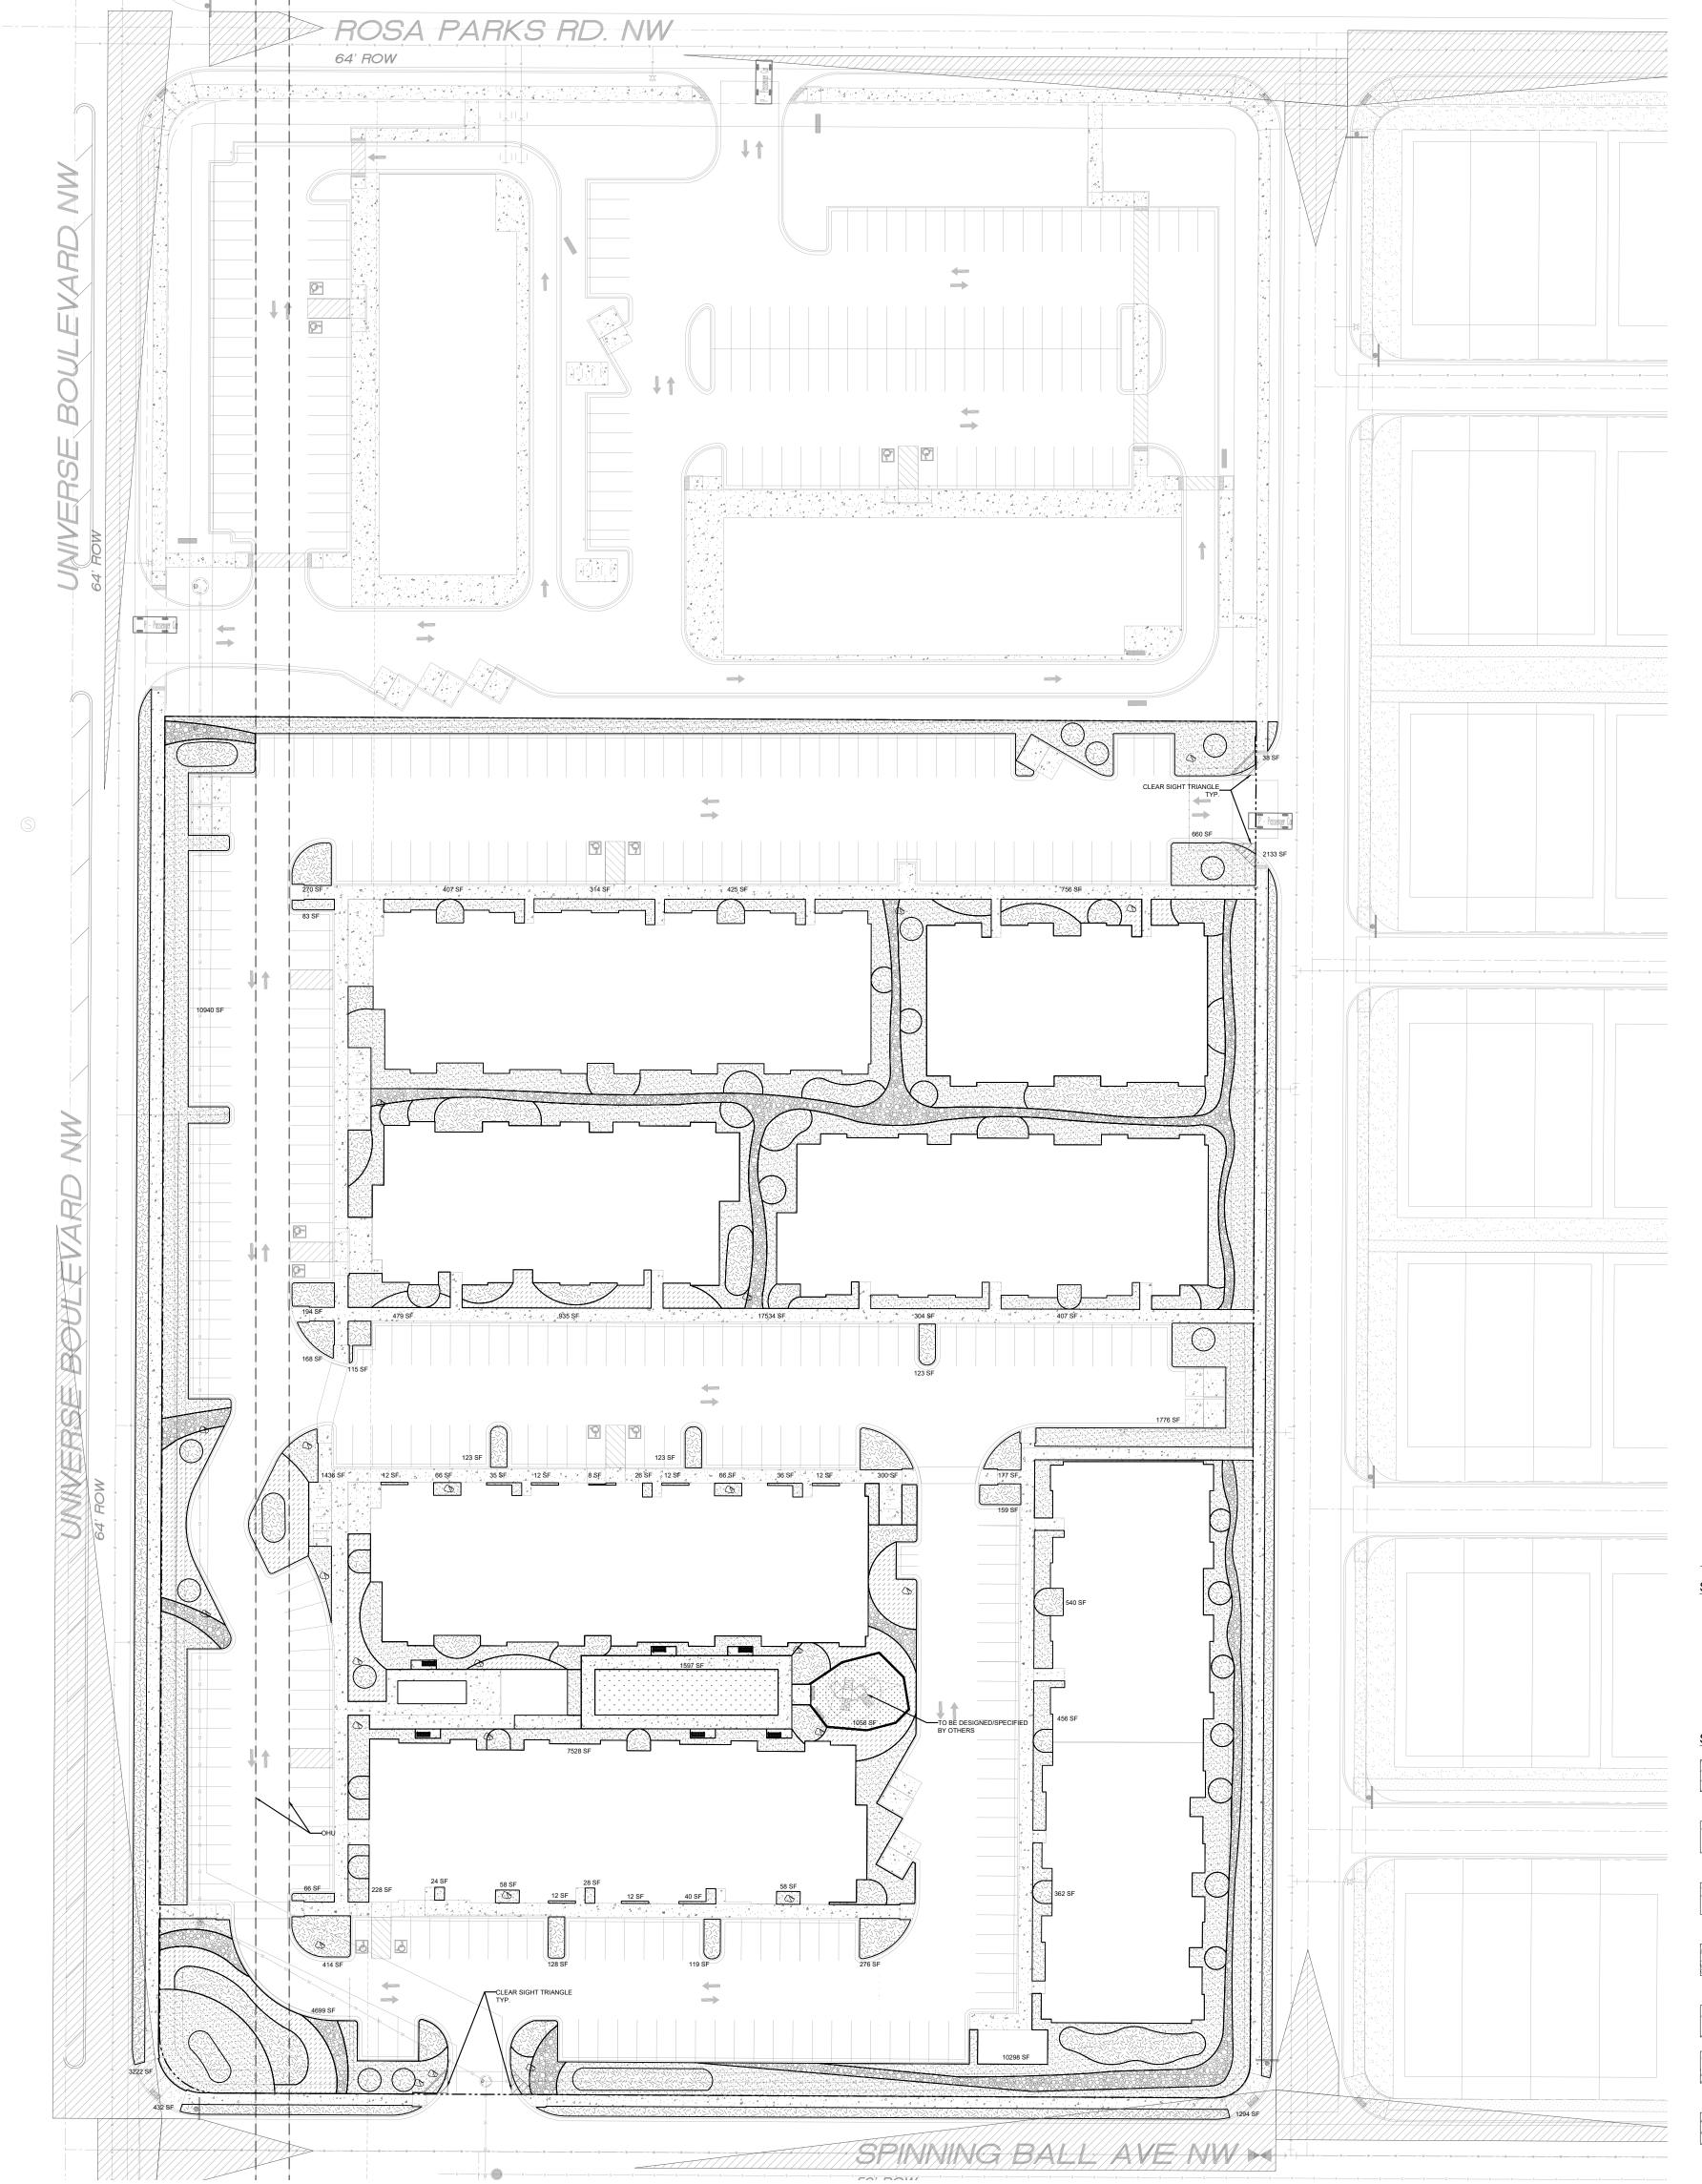

| | | ZONING DESIGN | NATION | |
|--|---|---------------|----------|------|
| IDO UPC# | 101006305745520820 | MX-L | | |
| | GROSS LOT AREA (SF) | 285,999 | | |
| | BUILDING AREA (SF) | 92,414 | | |
| | NET LOT AREA (SF) | 193,585 | | |
| MINIMUM LA | NDSCAPE | REQUIRED | PROVIDED | |
| | AREA (SF) - MINIMUM 25 % OF NET LOT AREA* | 48,396 | 78,170 | 40% |
| | TOTAL VEGETATIVE COVERAGE (SF) @ PLANT MATURITY (75% OF LANDSCAPE AREA) | 36,297 | 68,755 | 142% |
| | VEGETATIVE COVERAGE (SF) OF GROUND-LEVEL PLANTS (25% OF TOTAL, MINIMUM) | 9,074 | 9,130 | 25% |
| | (C)(2)(b), IN DT-UC-MS-PT AREAS, MINIMUM IS 10% OF NET LOT AREA. | | | |
| | Y DWELLING, MINIMUM IS 25% OF NET LOT AREA. SEE 14-16-4-3(B)(8) FOR DETAILS. | I | I | |
| PLANTING A | REA MULCH | REQUIRED | PROVIDED | |
| GRAVEL OR CRUSHER FINES (SF) MAX. 75% 53,0 | | | | 68% |
| * PER IDO 14-15-5-6 | (C)(5) The use of gravel or crusher fines as ground cover is limited to a maximum 50 percent in DT-UC-MS areas. | | | |
| STREET TRE | ES - 1 PER 25 LF | REQUIRED | PROVIDED | |
| | STREET FRONTAGE (LF) | - | 1555 | |
| | STREET TREES | 63 | 63 | |
| | (D)(1)(a) TREES THAT ARE PLANTED WITHIN 20 FEET OF THE BACK OF CURB OF THE ABUTTING STREET MAY FULFILL THIS REQUIREMENT | | | |
| PARKING LO | TINTERIOR | REQUIRED | PROVIDED | |
| | PARKING STALLS | - | 300 | |
| | PARKING LOT AREA (SF) | - | 88,228 | |
| | LANDSCAPED AREA (10% OF PARKING LOT AREA)* | 8,823 | 21,397 | |
| | TREES (1 PER 10 PARKING SPACES) | 30 | 30 | |
| * PER IDO 14-16-5-6 | (F)(2), FOR PARKING LOTS CONTAINING 50 OR FEWER SPACES, MINIMUM IS 10% OF PARKING LOT AREA. | | | |
| COOL SEASO | ON GRASS | REQUIRED | PROVIDED | |
| | NO MORE THAN 10 % OF REQUIRED LANDSCAPE AREA | 4840 | 1597 | 3% |
| ADDITIONAL | REQUIREMENTS FOR MULTI-FAMILY DWELLING | REQUIRED | PROVIDED | |
| | 1 TREE PER GROUND FLOOR AND SECOND FLOOR DWELLING UNIT | 175 | 175 | |
| * PER IDO 14-16-4-3 | (B)(8), IN DT-UC-MS-PT AREAS, SECOND FLOOR DWELLING UNIT TREES ARE NOT REQUIRED. | | | |
| TOTALS | | REQUIRED | PROVIDED | |
| TREES 175 175 | | 175 | | |

MATERIAL SCHEDULE

| SYMBOL | DESCRIPTION | QTY |
|--|---|-----|
| \bigcirc | LARGE BOULDER | 24 |
| dansen og | ANOVA L1441A 6FT. CONTOUR BENCH WITH STEEL SLAT SEAT, ARMRESTS AND CAST IRON PORTABLE/ SURFACE MOUNT LEGS | 6 |
| SYMBOL | DESCRIPTION | |
| | MOUNTAINAIR SUNRISE GOLD 1" GRAVEL 3" DEPTH OVER FILTER FABRIC | |
| | MOUNTAINAIR BLUSH 1" GRAVEL 3" DEPTH OVER FILTER FABRIC | |
| | BARK MULCH 3" DEPTH | |
| | BLUE SAIS 2-4" ANGULAR COBBLE 4" DEPTH OVER FILTER FABRIC | |
| Ψ Ψ Ψ | SANDIA BLUEGRASS SOD | |
| | CONCRETE 3500 PSI 4" DEPTH | |
| $\begin{array}{cccccccccccccccccccccccccccccccccccc$ | ENGINEERED WOOD FIBER PER FALL HEIGHT | |


GENERAL NOTES

- 1. IN CASE OF DISCREPANCIES IN PLANT QUANTITIES SHOWN ON THE PLANT SCHEDULE AND THOSE SHOWN ON THE PLAN, THE QUANTITIES SHOWN ON THE PLAN SHALL PREVAIL. CONTRACTOR SHALL VERIFY ALL QUANTITIES PRIOR TO BID AND INSTALLATION.
- 2. POSITIVE DRAINAGE AWAY FROM ALL STRUCTURES SHALL BE PROVIDED TO THE LANDSCAPE CONTRACTOR AND SHALL BE MAINTAINED BY THE LANDSCAPE CONTRACTOR THROUGHOUT THE DURATION OF THE PROJECT.
- 3. GRADING OF THE SITE PER THE GRADING PLAN IS NOT INCLUDED IN THE SCOPE OF WORK OF THE LANDSCAPE CONTRACTOR. GRADES PER THE GRADING PLAN SHALL BE PROVIDED TO THE LANDSCAPE CONTRACTOR +/-1/10TH OF A FOOT, BY OTHERS.
- 4. ALL MAINTENANCE OF THE LANDSCAPE AND IRRIGATION SYSTEMS SHALL BE PROVIDED BY OWNER. NO CONTRACTUAL MAINTENANCE SHALL BE INCLUDED UNLESS OTHERWISE SPECIFIED IN THE BIDDING DOCUMENTS.
- 5. WATER MANAGEMENT IS THE SOLE RESPONSIBILITY OF THE PROPERTY OWNER. THE LANDSCAPE ARCHITECT IS NOT RESPONSIBLE FOR ANY RESTRICTIONS OF IRRIGATION WATER USE BY ANY GOVERNING BODY. 6. PER 5-6(C)(4)(a) A MINIMUM OF 5 SPECIES MUST BE USED IN THE
- LANDSCAPED AREA.
- 7. PER 5-6(C)(4)(b) ONLY TREES AND SHRUBS SELECTED FROM THE OFFICIAL ALBUQUERQUE PLANT PALETTE OF LOW WATER USE, DROUGHT TOLERANT, OR XERIC SPECIES AND SHOWN ON A LANDSCAPE PLAN CAN COUNT TOWARD THE REQUIREMENTS OF THIS SUBSECTION 14-16-5-6(C) (GENERAL LANDSCAPING STANDARDS), EXCEPT THAT, UPON PRESENTATION OF EVIDENCE, THE RELEVANT DECISION-MAKING BODY MAY AUTHORIZE ALTERNATIVE SPECIES OR CULTIVARS THAT MEET ALL OF THE FOLLOWING REQUIREMENTS:
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4.ARE NOT LISTED IN THE CITY'S WEED IDENTIFICATION HANDBOOK. 5.ARE EQUALLY HARDY TO THE NEW MEXICO CLIMATE.

- 8. PER 5-3(D)(3)(a) 3, SHADE TREES ALONG REQUIRED PEDESTRIAN WALKWAYS ARE REQUIRED PURSUANT TO SUBSECTION 14-16-5-6(C)(4)(i) (REQUIRED PLANT MATERIALS AND SITE AMENITIES). 5-6(C)(4)(i) SHADE TREES PLANTED APPROXIMATELY 25 FEET ON-CENTER ARE REQUIRED ALONG ALL REQUIRED PEDESTRIAN WALKWAYS. IF THE WALKWAY IS LESS THAN FEET LONG, AT LEAST ONE TREE IS REQUIRED, OR, WHERE THERE IS INSUFFICIENT SPACE FOR A TREE, A TRELLIS OF AT LEAST 8 FEET HIGH FOR AT LEAST 5 FEET ALONG THE WALKWAY SHALL BE PROVIDED.
- 9. PER 5-6(F)(1)(i) 1 OF THE IDO, ANY PARKING LOT LOCATED WITHIN 30 FEET OF THE FRONT LOT LINE SHALL BE SCREENED FROM THE STREET EITHER BY A MASONRY WALL CONSTRUCTED OF A MATERIAL SIMILAR IN TEXTURE, APPEARANCE, AND COLOR TO THE STREET-FACING FAÇADE OF THE PRIMARY BUILDING (BUT EXCLUDING EXPOSED CMU BLOCK) AT LEAST 3 BUT NOT MORE THAN 4 FEET IN HEIGHT, OR BY A LANDSCAPE BUFFER AT LEAST 10 FEET IN WIDTH WITH A CONTINUOUS LINE OF EVERGREEN SHRUBBERY 3 FEET IN HEIGHT, OR BY OTHER MEANS THAT THE PLANNING DIRECTOR DETERMINES PROVIDES EQUAL OR BETTER SCREENING OF THE HEADLIGHTS OF PARKED VEHICLES.
- 10. PER 5-6(C)(9)(a), ALL PLANTING OF VEGETATED MATERIAL OR INSTALLATION OF ANY LANDSCAPING, BUFFERING, OR SCREENING MATERIAL IN THE PUBLIC RIGHT-OF-WAY SHALL REQUIRE THE PRIOR APPROVAL OF THE CITY. THE PROPERTY OWNER SHALL BE RESPONSIBLE FOR THE MAINTENANCE, REPAIRS, OR LIABILITY FOR ALL THE LANDSCAPING PLACED IN OR OVER THE PUBLIC RIGHT-OF-WAY.
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- 12. PURSUANT TO 5-6(C)(5)(e), BARK MULCH AREAS CLEARLY DELINEATED ON PLANS FOR LANDSCAPE AREAS AND 5' RADIUS RINGS AROUND TREES. 13. PURSUANT TO 5-6(C)(7)(a), ALL VEGETATION HAS BEEN LOCATED A MINIMUM
- OF 3' IN ANY DIRECTION FROM FIRE HYDRANTS, VALVE VAULTS, HOSE BIBS, MANHOLES, HYDRANTS AND FIRE DEPARTMENT CONNECTIONS.
- 14. PURSUANT TO 5-6(C)(10)(a), TREES AND SHRUBS SHALL NOT BE PLANTED IN UTILITY EASEMENTS UNLESS THERE IS NO OTHER PRACTICABLE LOCATION ON THE LOT WHERE THE LANDSCAPING WOULD ACHIEVE ITS INTENDED PURPOSE.
- 15. PURSUANT TO 5-6(C)(10)(b), TREES SHALL NOT BE PLANTED WITHIN 10' IN ANY DIRECTION OF THE CENTERLINE OF A SEWER OR WATER LINE. 16. CLEAR SIGHT TRIANGLE NOTE: LANDSCAPING, SIGNAGE, WALLS, FENCES, TREES, AND SHRUBBERIES BETWEEN 3' AND 8' TALL (AS MEASURED FROM
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- PREVENTION AND CONTROL ORDINANCE) 18. PER 5-6(C)(14)(b), ALL IRRIGATION SYSTEMS SHALL BE DESIGNED TO MINIMIZE THE USE OF WATER.
- 19. PER 5-6(C)(14)(c), ALL NON-RESIDENTIAL LANDSCAPE IRRIGATION SHALL HAVE AUTOMATIC TIMERS AND/OR PROGRAMMABLE SETTINGS TO AVOID OVERWATERING.
- 20. PER 5-6(C)(14)(d), THE IRRIGATION SYSTEM SHALL NOT SPRAY OR IRRIGATE IMPERVIOUS SURFACES, INCLUDING SIDEWALKS, DRIVEWAYS, DRIVE AISLES, STREETS, AND PARKING AND LOADING AREAS.


| Image: Constraint of the end of the |
|---|
| CODY MCNALLEN 650 CODY MCNALLEN 650 5/3/24 |
| Date: 04/02/2024 Revisions: 05/02/2024 △ |
| Universe View Apartment Abuquerque, New Mexico |
| I'' = 40' |
| Sheet Title: Material Plan |
| Sheet Number: |

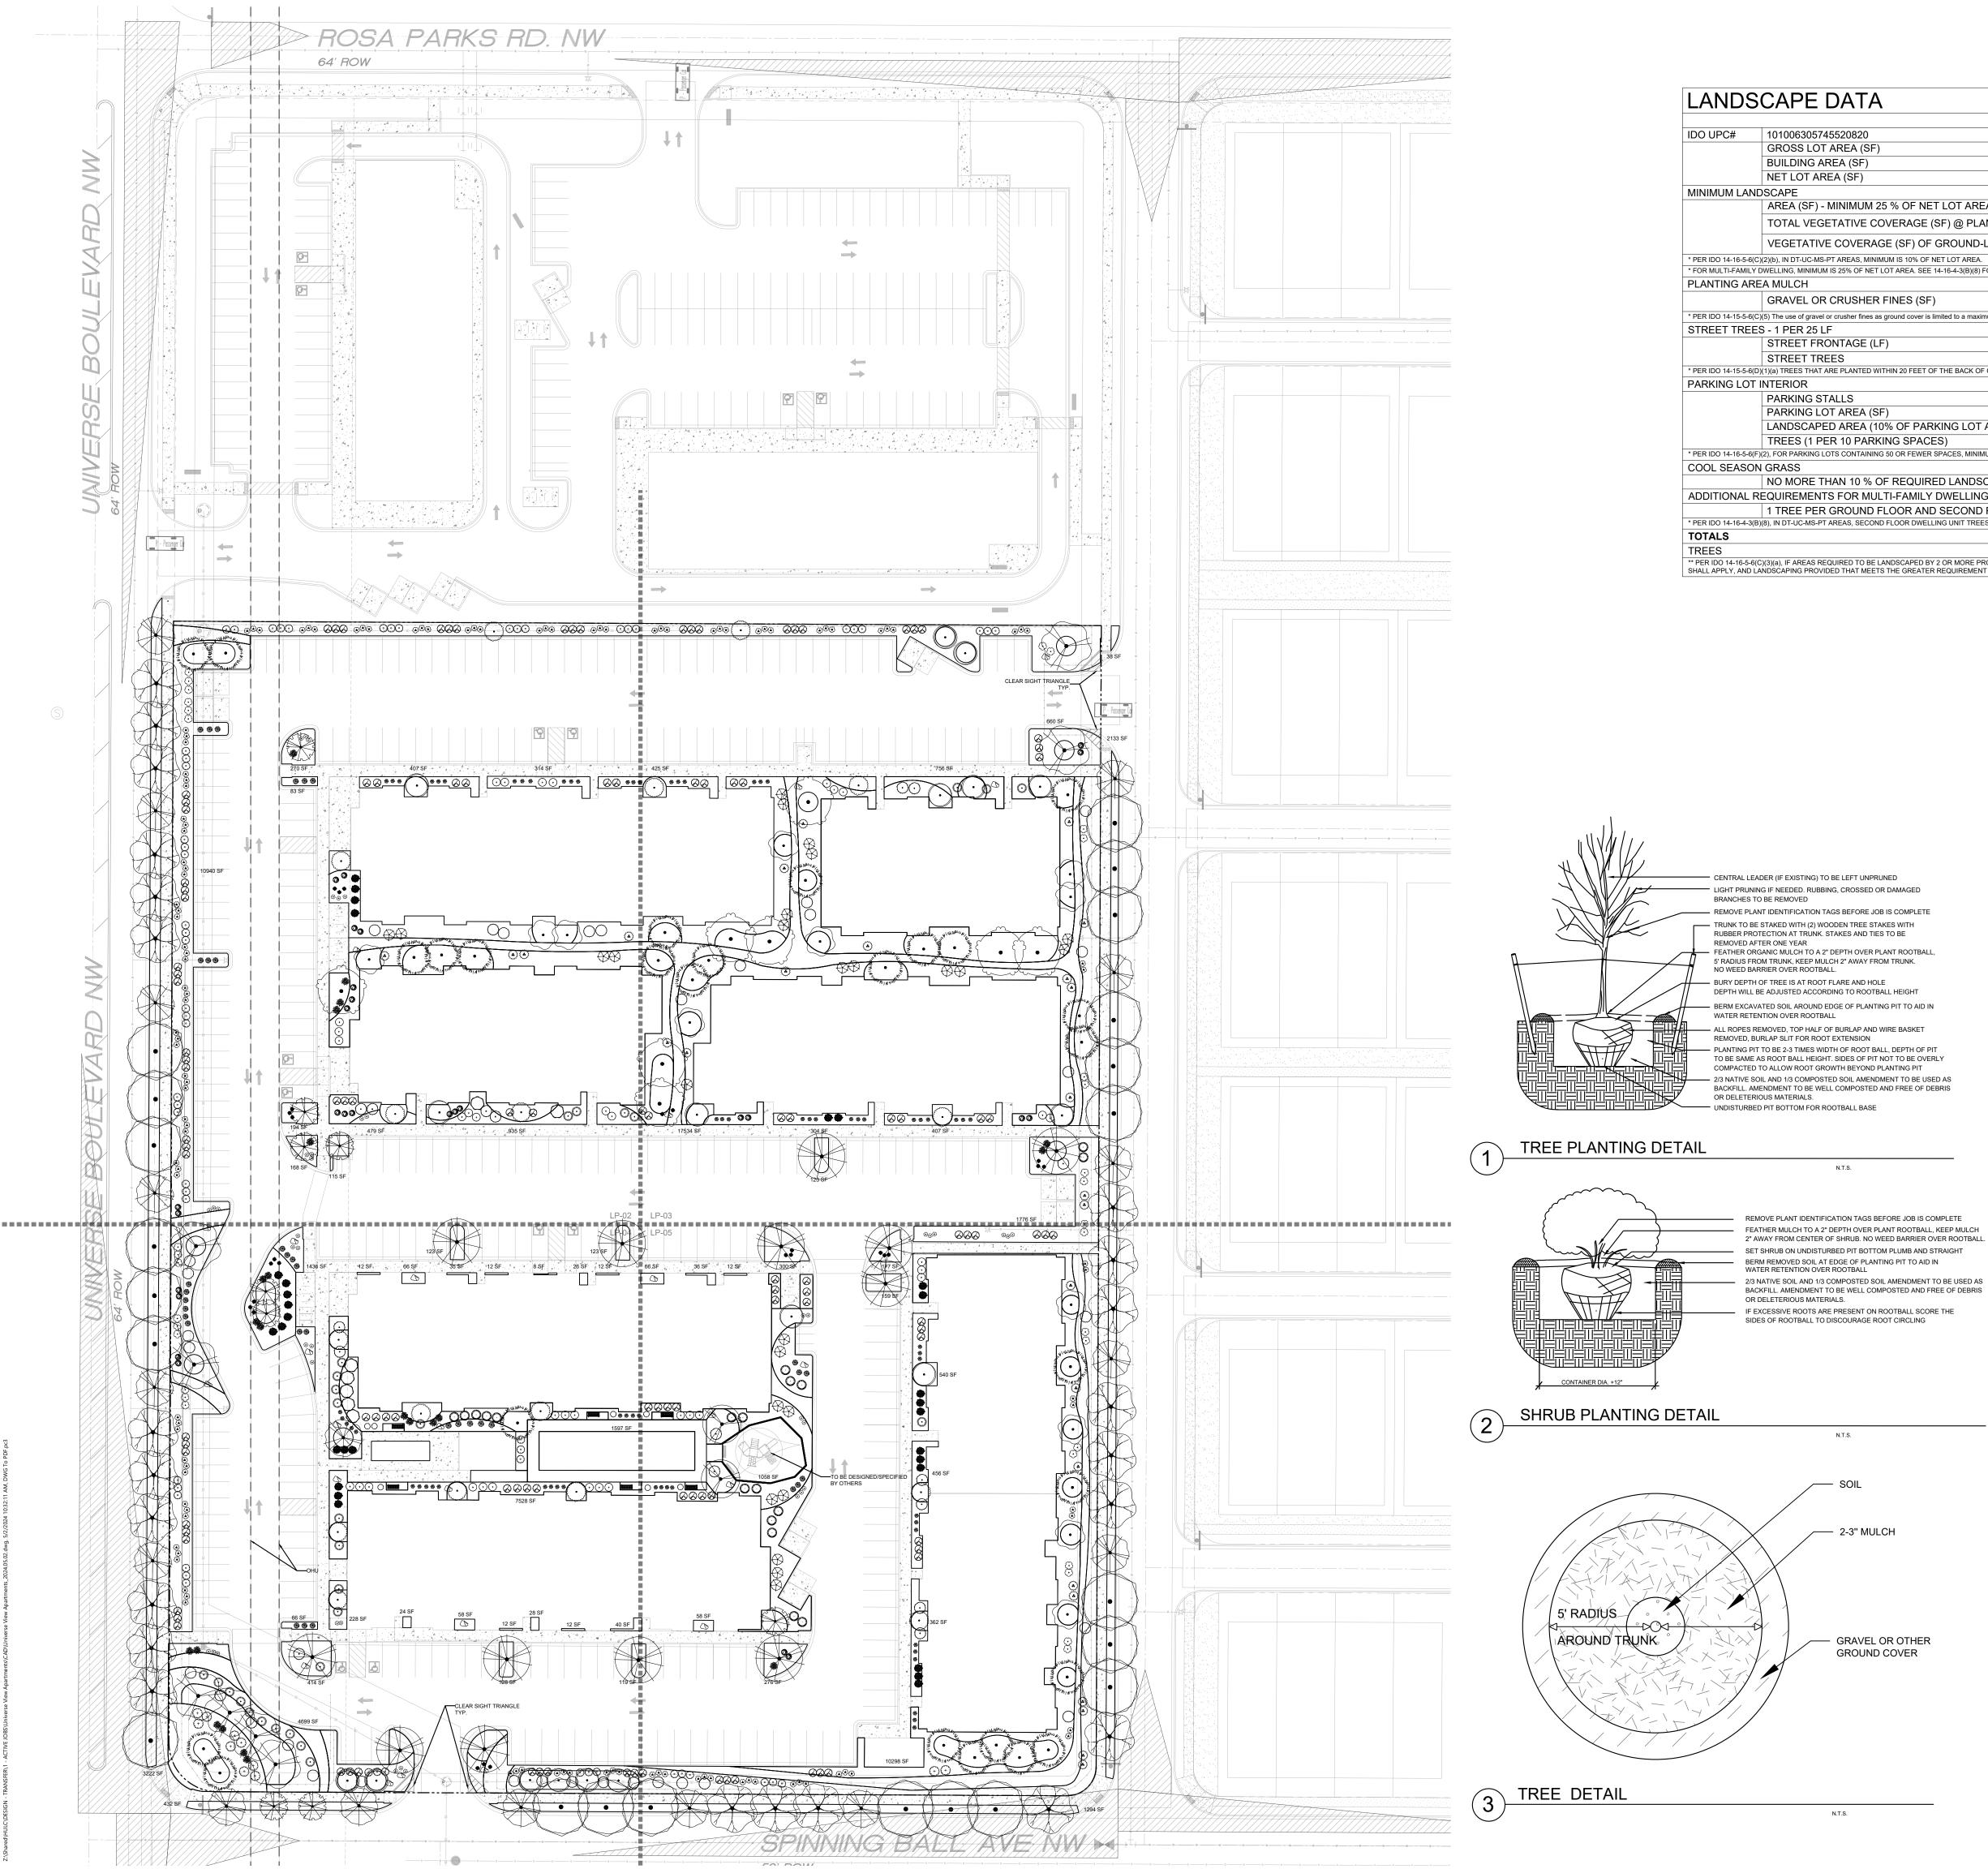

| | ZONING DESIGN | NATION | |
|--|---------------|----------|------|
| | MX-L | | |
| | 285,999 | | |
| | 92,414 | | |
| | 193,585 | | |
| | REQUIRED | PROVIDED | |
| LOT AREA* | 48,396 | 78,170 | 40% |
| F) @ PLANT MATURITY (75% OF LANDSCAPE AREA) | 36,297 | 68,755 | 142% |
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| ET LOT AREA. | | | |
| 4-16-4-3(B)(8) FOR DETAILS. | | | |
| | REQUIRED | PROVIDED | _ |
| | MAX. 75% | 53,043 | 68% |
| nited to a maximum 50 percent in DT-UC-MS areas. | | | - |
| | REQUIRED | PROVIDED | |
| | - | 1555 | |
| | 63 | 63 | |
| THE BACK OF CURB OF THE ABUTTING STREET MAY FULFILL THIS REQUIREME | | | |
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| DWELLING | REQUIRED | PROVIDED | |
| SECOND FLOOR DWELLING UNIT | 175 | 175 | |
| NG UNIT TREES ARE NOT REQUIRED. | | | |
| | REQUIRED | PROVIDED | |
| | 175 | 175 | |

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- 8. PER 5-3(D)(3)(a) 3, SHADE TREES ALONG REQUIRED PEDESTRIAN WALKWAYS ARE REQUIRED PURSUANT TO SUBSECTION 14-16-5-6(C)(4)(i) (REQUIRED PLANT MATERIALS AND SITE AMENITIES). 5-6(C)(4)(i) SHADE TREES PLANTED APPROXIMATELY 25 FEET ON-CENTER ARE REQUIRED ALONG ALL REQUIRED PEDESTRIAN WALKWAYS. IF THE WALKWAY IS LESS THAN FEET LONG, AT LEAST ONE TREE IS REQUIRED, OR, WHERE THERE IS INSUFFICIENT SPACE FOR A TREE, A TRELLIS OF AT LEAST 8 FEET HIGH FOR AT LEAST 5 FEET ALONG THE WALKWAY SHALL BE PROVIDED.
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- YELLOWST www.yellowstonelandscape.com PO Box 10597 Albuquerque, NM 87184 505.898.9615 design@yellowstonelandscape.com CODY MCNALLEN Date: 04/02/2024 **Revisions:** <u>05/02/2024</u> Drawn by: PL Reviewed by: <u>CM</u> exico C \geq \mathbf{T} Ζ U ert art Ð σ \mathbf{O} bn Alb NORTH Scale: 1" = 40' 20 0 Sheet Title: Planting Plan Sheet Number: LP-01

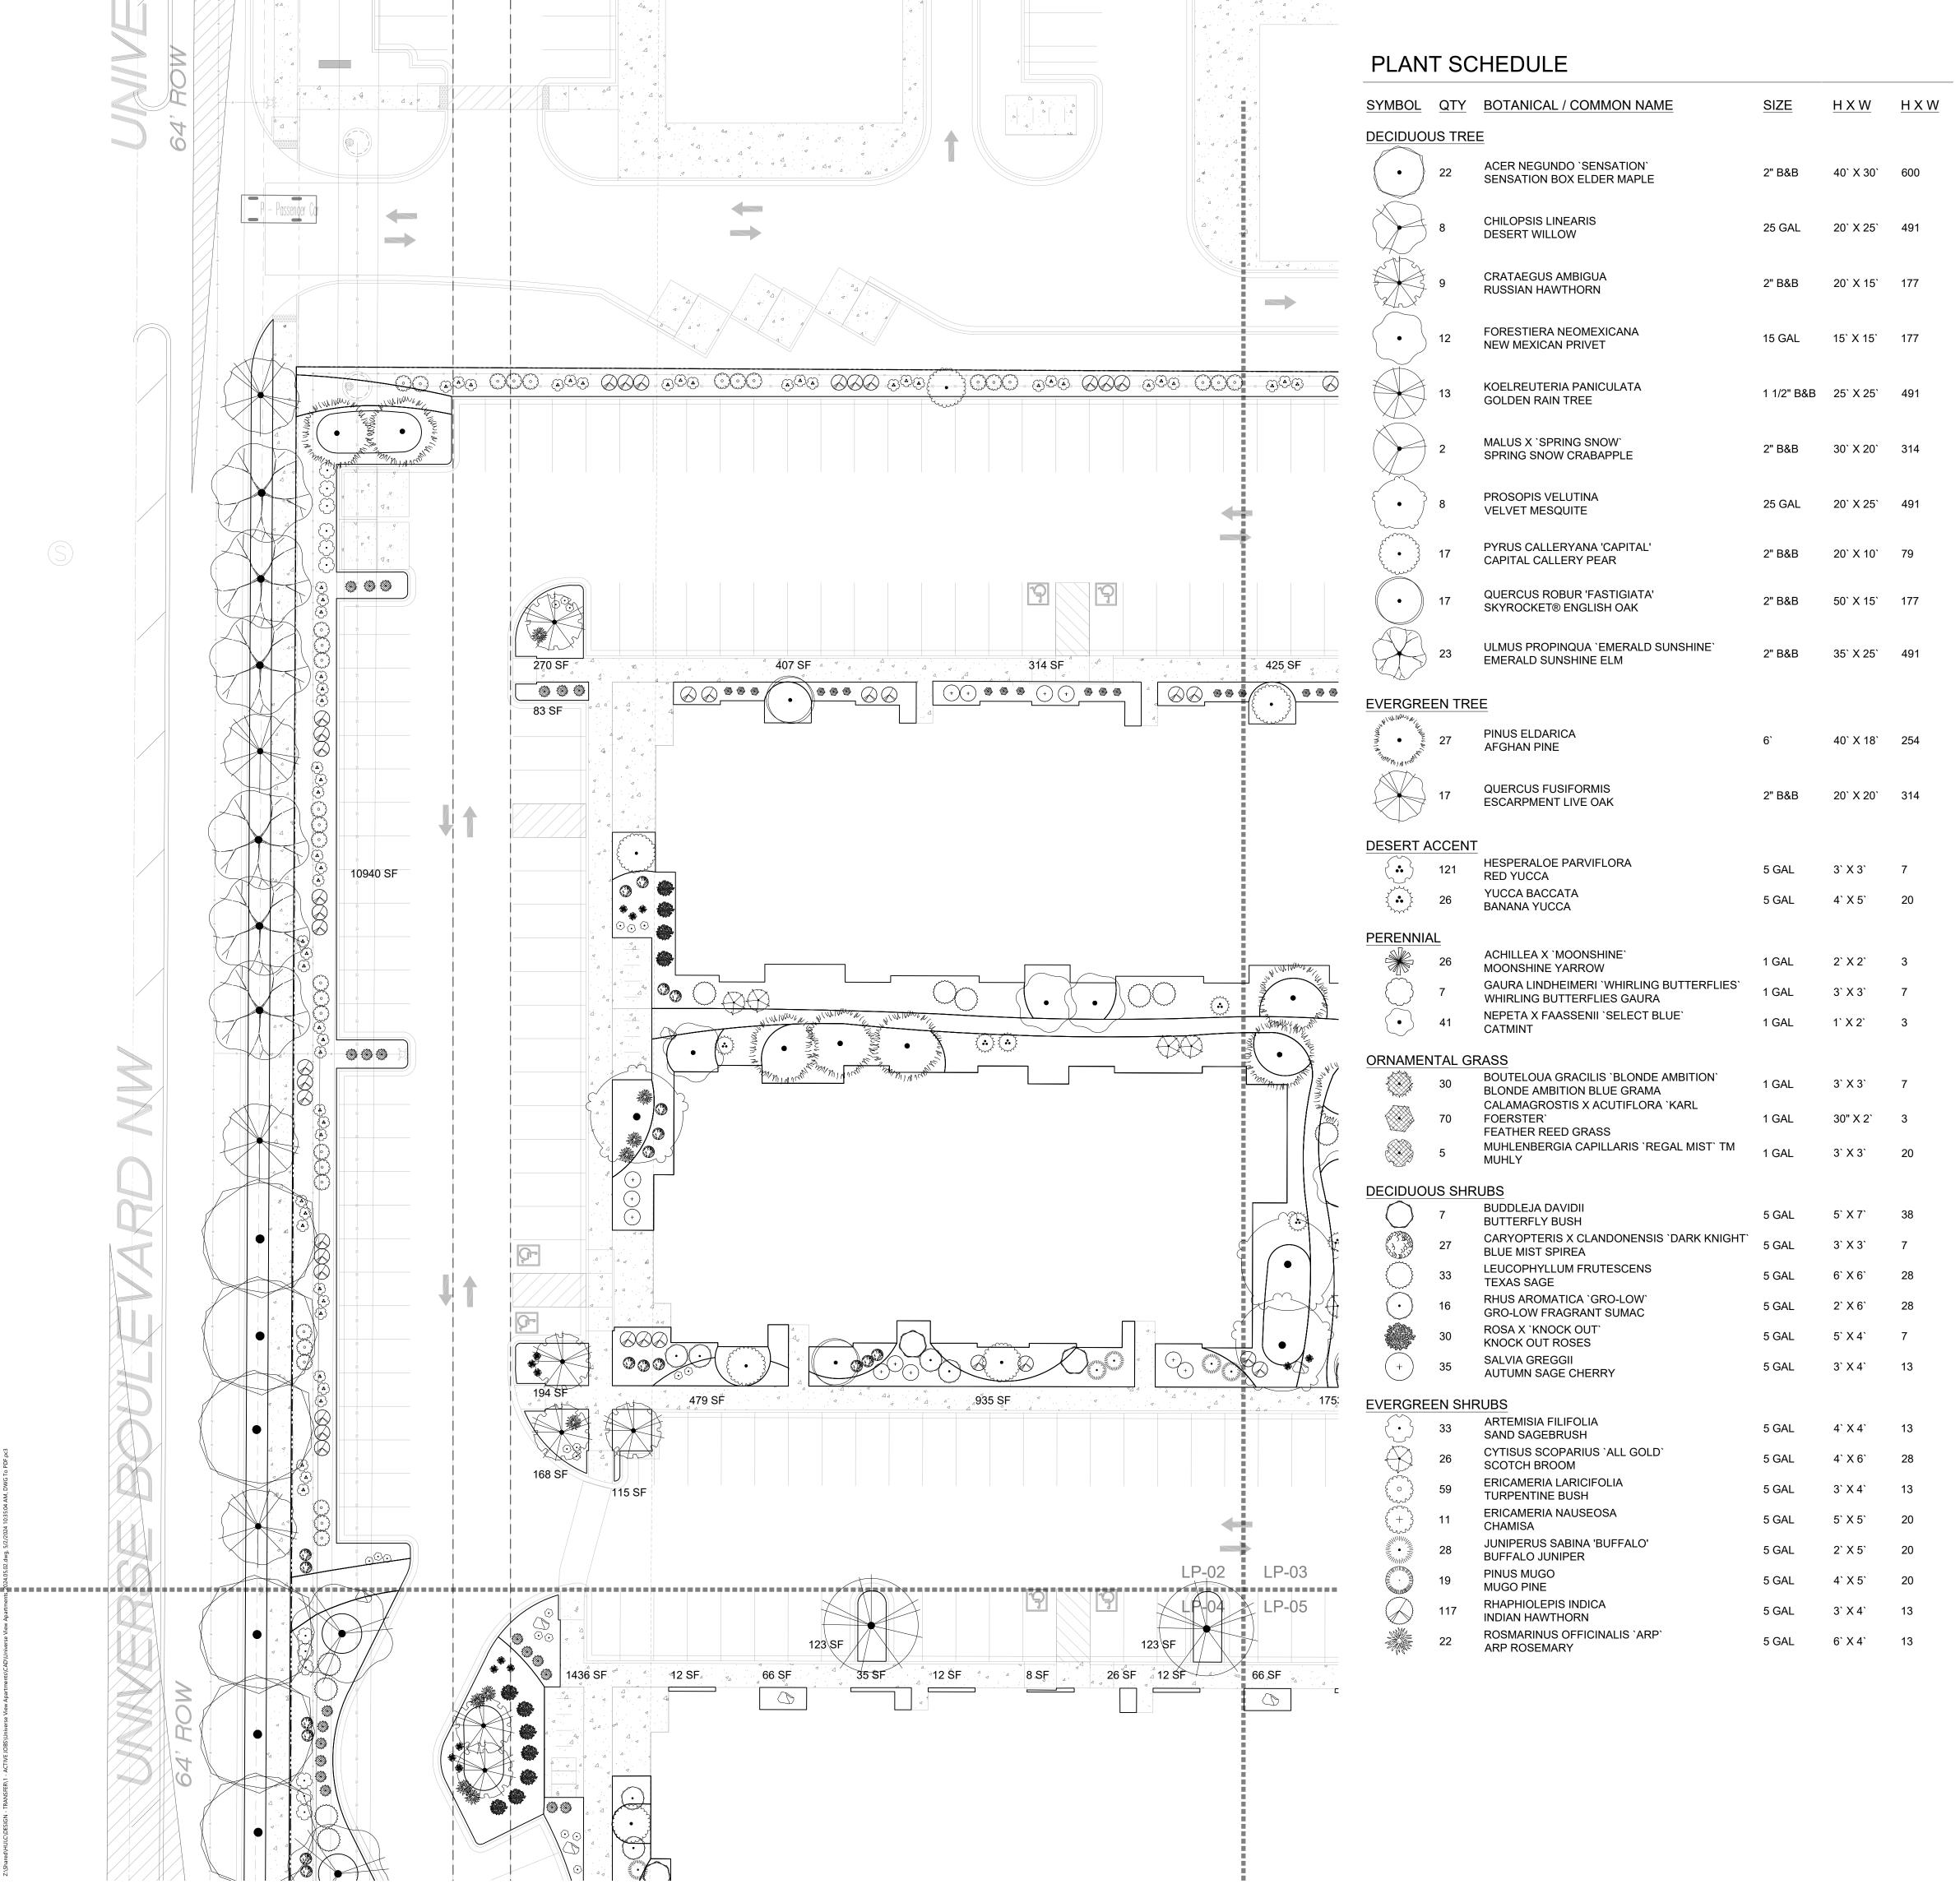


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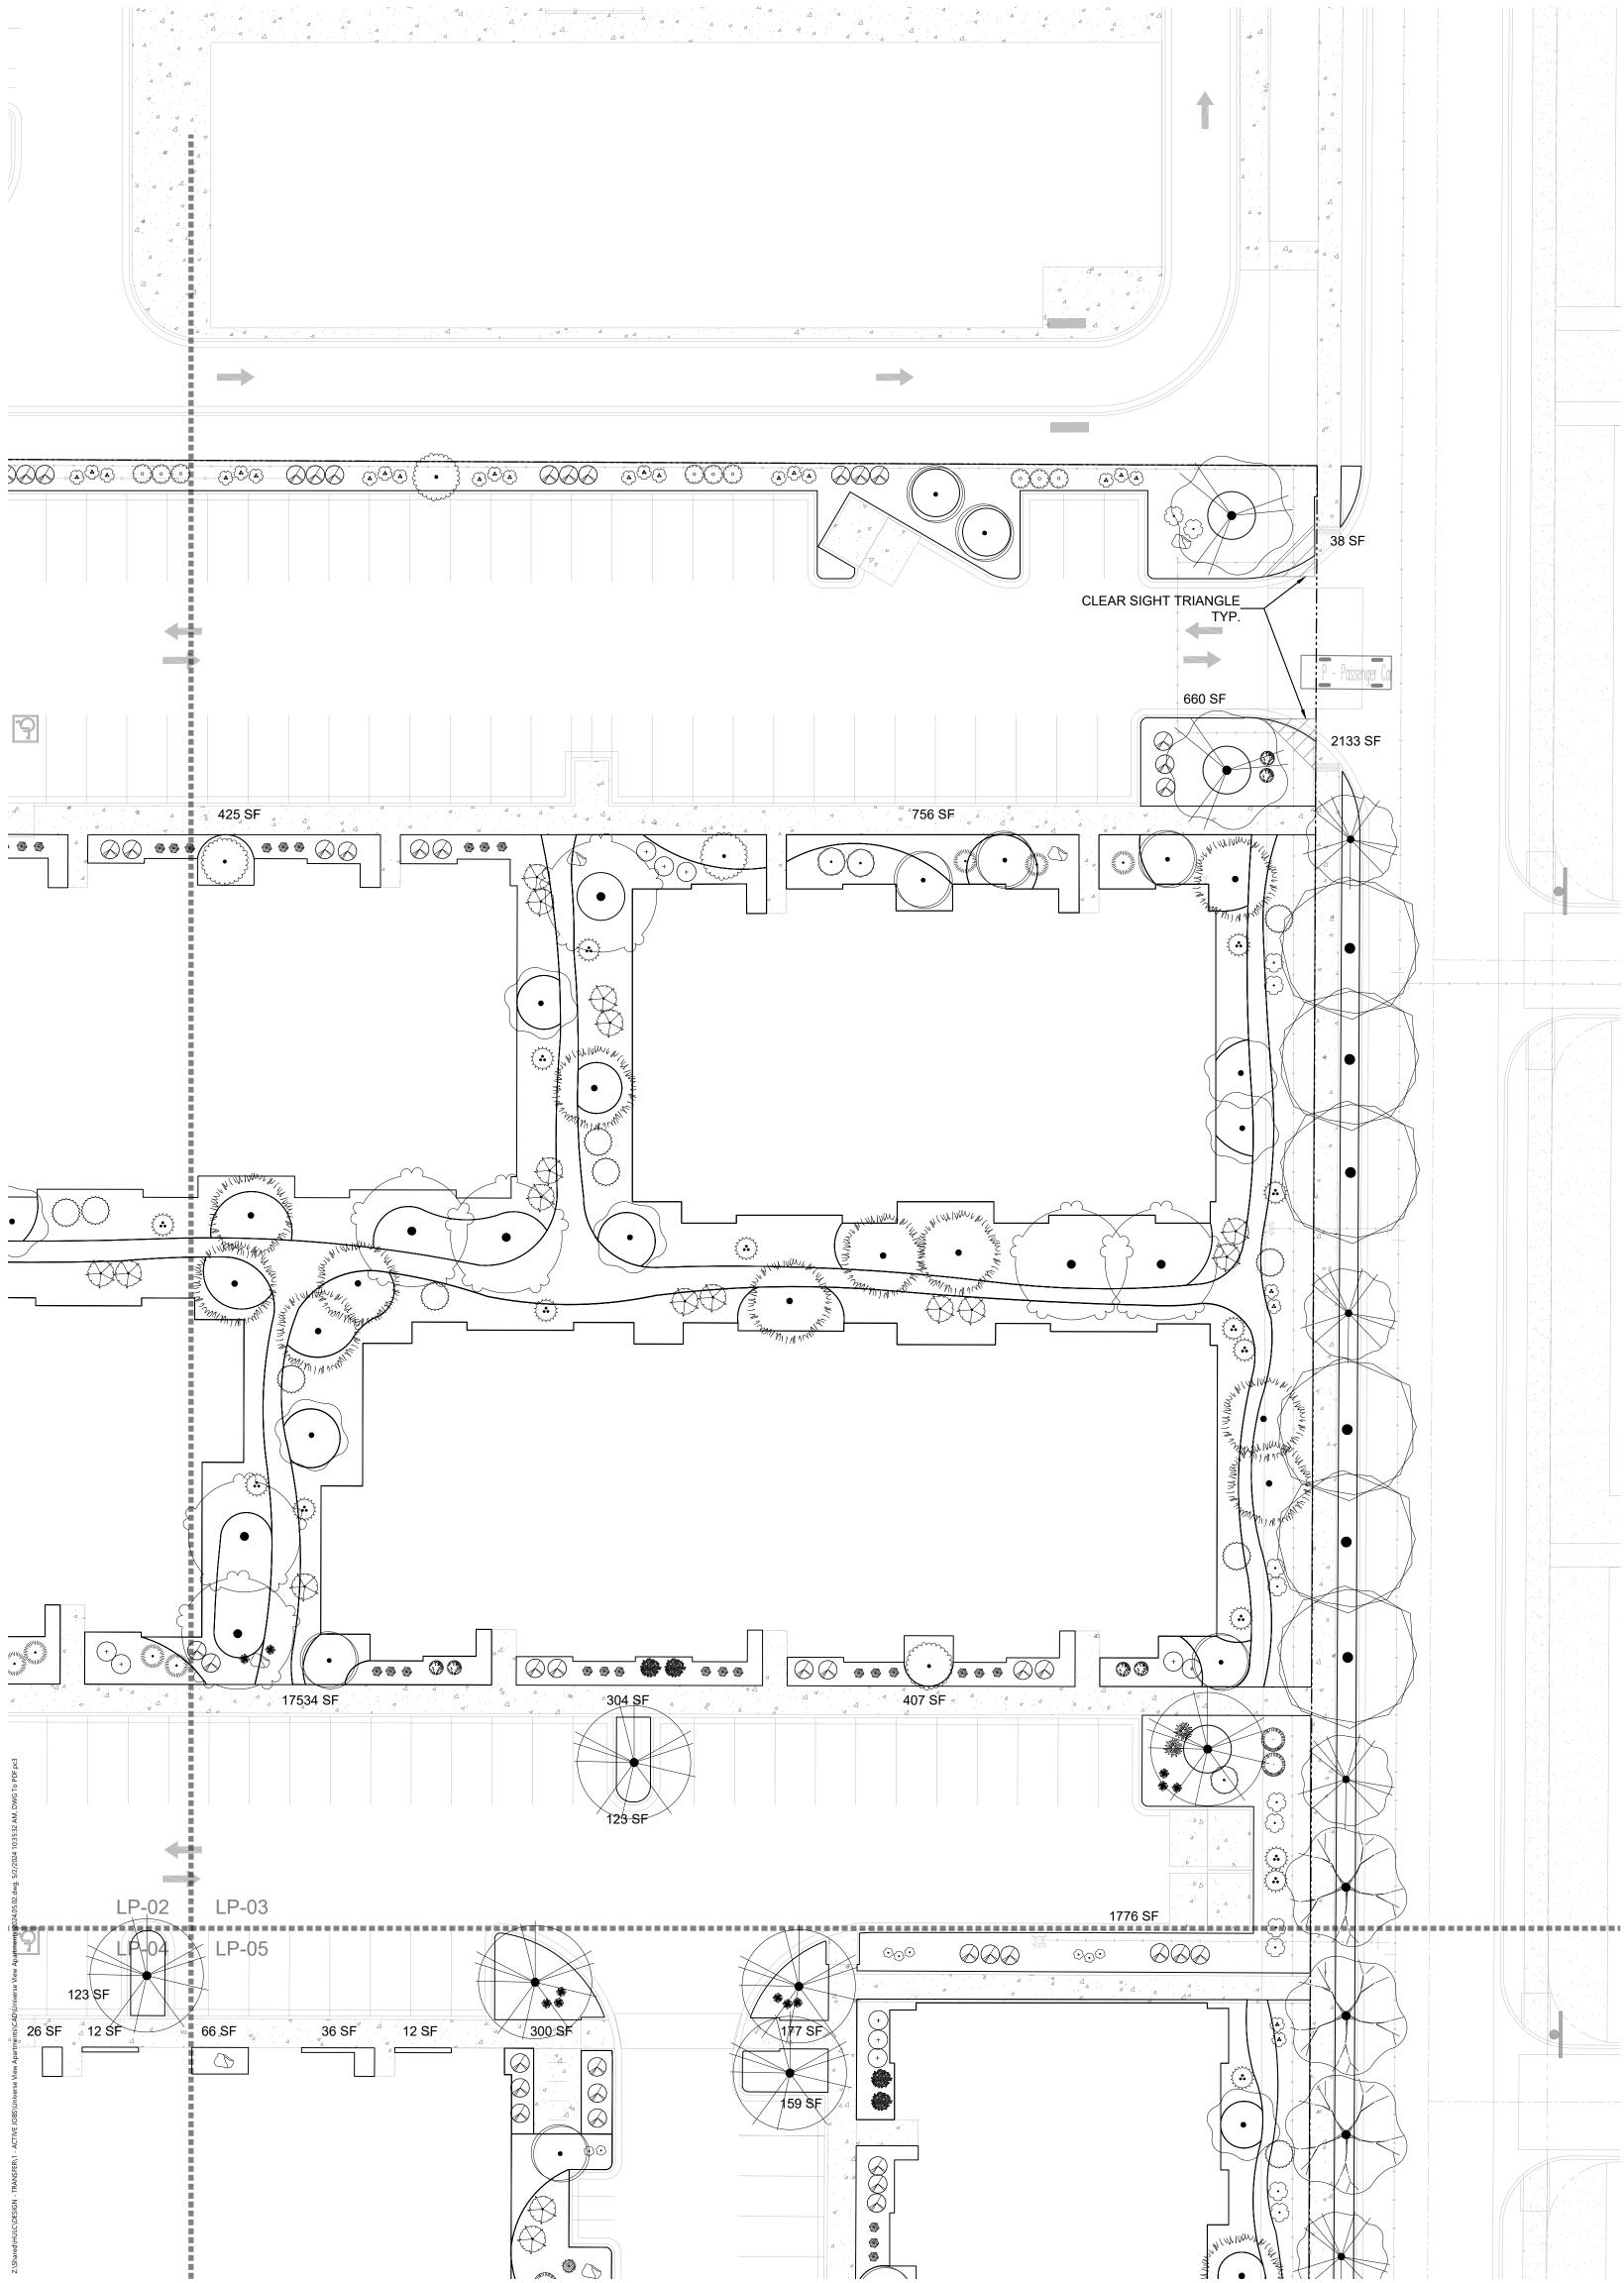
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- 4. ALL MAINTENANCE OF THE LANDSCAPE AND IRRIGATION SYSTEMS SHALL BE PROVIDED BY OWNER. NO CONTRACTUAL MAINTENANCE SHALL BE INCLUDED UNLESS OTHERWISE SPECIFIED IN THE BIDDING DOCUMENTS.
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1.MEET THE INTENDED PURPOSE OF THAT TYPE OF LANDSCAPING. 2.ARE NOT HAZARDOUS. 3.ARE NOT IDENTIFIED AS INVASIVE ON A CITY OR STATE PLANT LIST.

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- 8. PER 5-3(D)(3)(a) 3, SHADE TREES ALONG REQUIRED PEDESTRIAN WALKWAYS ARE REQUIRED PURSUANT TO SUBSECTION 14-16-5-6(C)(4)(i) (REQUIRED PLANT MATERIALS AND SITE AMENITIES). 5-6(C)(4)(i) SHADE TREES PLANTED APPROXIMATELY 25 FEET ON-CENTER ARE REQUIRED ALONG ALL REQUIRED PEDESTRIAN WALKWAYS. IF THE WALKWAY IS LESS THAN FEET LONG, AT LEAST ONE TREE IS REQUIRED, OR, WHERE THERE IS INSUFFICIENT SPACE FOR A TREE, A TRELLIS OF AT LEAST 8 FEET HIGH FOR AT LEAST 5 FEET ALONG THE WALKWAY SHALL BE PROVIDED.
- 9. PER 5-6(F)(1)(i) 1 OF THE IDO, ANY PARKING LOT LOCATED WITHIN 30 FEET OF THE FRONT LOT LINE SHALL BE SCREENED FROM THE STREET EITHER BY A MASONRY WALL CONSTRUCTED OF A MATERIAL SIMILAR IN TEXTURE, APPEARANCE, AND COLOR TO THE STREET-FACING FAÇADE OF THE PRIMARY BUILDING (BUT EXCLUDING EXPOSED CMU BLOCK) AT LEAST 3 BUT NOT MORE THAN 4 FEET IN HEIGHT, OR BY A LANDSCAPE BUFFER AT LEAST 10 FEET IN WIDTH WITH A CONTINUOUS LINE OF EVERGREEN SHRUBBERY 3 FEET IN HEIGHT, OR BY OTHER MEANS THAT THE PLANNING DIRECTOR DETERMINES PROVIDES EQUAL OR BETTER SCREENING OF THE HEADLIGHTS OF PARKED VEHICLES.
- 10. PER 5-6(C)(9)(a), ALL PLANTING OF VEGETATED MATERIAL OR INSTALLATION OF ANY LANDSCAPING, BUFFERING, OR SCREENING MATERIAL IN THE PUBLIC RIGHT-OF-WAY SHALL REQUIRE THE PRIOR APPROVAL OF THE CITY. THE PROPERTY OWNER SHALL BE RESPONSIBLE FOR THE MAINTENANCE, REPAIRS, OR LIABILITY FOR ALL THE LANDSCAPING PLACED IN OR OVER THE PUBLIC RIGHT-OF-WAY.
- 11. PER 5-6(C)(9)(b), ANY TREES THAT OVERHANG A PUBLIC SIDEWALK OR MAJOR PUBLIC OPEN SPACE SHALL BE TRIMMED TO MAINTAIN AN 8 FOOT CLEARANCE OVER THE SIDEWALK. ANY TREES THAT OVERHANG A PUBLIC STREET SHALL BE TRIMMED TO MAINTAIN A 9' CLEARANCE OVER THE STREET SURFACE.
- 12. PURSUANT TO 5-6(C)(5)(e), BARK MULCH AREAS CLEARLY DELINEATED ON PLANS FOR LANDSCAPE AREAS AND 5' RADIUS RINGS AROUND TREES. 13. PURSUANT TO 5-6(C)(7)(a), ALL VEGETATION HAS BEEN LOCATED A MINIMUM
- OF 3' IN ANY DIRECTION FROM FIRE HYDRANTS, VALVE VAULTS, HOSE BIBS, MANHOLES, HYDRANTS AND FIRE DEPARTMENT CONNECTIONS.
- 14. PURSUANT TO 5-6(C)(10)(a), TREES AND SHRUBS SHALL NOT BE PLANTED IN UTILITY EASEMENTS UNLESS THERE IS NO OTHER PRACTICABLE LOCATION ON THE LOT WHERE THE LANDSCAPING WOULD ACHIEVE ITS INTENDED PURPOSE
- 15. PURSUANT TO 5-6(C)(10)(b), TREES SHALL NOT BE PLANTED WITHIN 10' IN ANY DIRECTION OF THE CENTERLINE OF A SEWER OR WATER LINE. 16. CLEAR SIGHT TRIANGLE NOTE: LANDSCAPING, SIGNAGE, WALLS, FENCES,
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PLANT SCHEDULE

| SYMBOL | <u>QTY</u> | BOTANICAL / COMMON NAME | <u>SIZE</u> | <u>H X W</u> | <u>H X W</u> |
|--|------------|--|-------------|--------------|--------------|
| DECIDUOL | JS TRE | E | | | |
| · | 22 | ACER NEGUNDO `SENSATION` SENSATION BOX ELDER MAPLE | 2" B&B | 40` X 30` | 600 |
| | 8 | CHILOPSIS LINEARIS DESERT WILLOW | 25 GAL | 20` X 25` | 491 |
| | 9 | CRATAEGUS AMBIGUA RUSSIAN HAWTHORN | 2" B&B | 20` X 15` | 177 |
| • | 12 | FORESTIERA NEOMEXICANA NEW MEXICAN PRIVET | 15 GAL | 15` X 15` | 177 |
| | 13 | KOELREUTERIA PANICULATA GOLDEN RAIN TREE | 1 1/2" B&B | 25` X 25` | 491 |
| | 2 | MALUS X `SPRING SNOW` SPRING SNOW CRABAPPLE | 2" B&B | 30` X 20` | 314 |
| | 8 | PROSOPIS VELUTINA VELVET MESQUITE | 25 GAL | 20` X 25` | 491 |
| | 17 | PYRUS CALLERYANA 'CAPITAL' CAPITAL CALLERY PEAR | 2" B&B | 20` X 10` | 79 |
| | 17 | QUERCUS ROBUR 'FASTIGIATA' SKYROCKET® ENGLISH OAK | 2" B&B | 50` X 15` | 177 |
| | 23 | ULMUS PROPINQUA `EMERALD SUNSHINE` EMERALD SUNSHINE ELM | 2" B&B | 35` X 25` | 491 |
| EVERGRE | EN TRE | E | | | |
| WINNER WITH MARKE | 27 | PINUS ELDARICA AFGHAN PINE | 6` | 40` X 18` | 254 |
| | 17 | QUERCUS FUSIFORMIS ESCARPMENT LIVE OAK | 2" B&B | 20` X 20` | 314 |
| DESERT A | | | | | |
| | 121 | HESPERALOE PARVIFLORA | 5 GAL | 3` X 3` | 7 |
| July | | RED YUCCA YUCCA BACCATA | | | |
| ۲. ۲. ۲. ۲. ۲. ۲. ۲. ۲. ۲. ۲. ۲. ۲. ۲. ۲. ۲ | 26 | BANANA YUCCA | 5 GAL | 4` X 5` | 20 |
| PERENNIA | <u>L</u> | | | | |
| | 26 | ACHILLEA X `MOONSHINE` MOONSHINE YARROW | 1 GAL | 2` X 2` | 3 |
| \square | 7 | GAURA LINDHEIMERI `WHIRLING BUTTERFLIES` WHIRLING BUTTERFLIES GAURA | 1 GAL | 3` X 3` | 7 |
| | 41 | NEPETA X FAASSENII `SELECT BLUE` | 1 GAL | 1` X 2` | 3 |
| | 41 | CATMINT | IGAL | 1 7 2 | 5 |
| | ITAL GF | | | | |
| | 30 | BOUTELOUA GRACILIS `BLONDE AMBITION` BLONDE AMBITION BLUE GRAMA | 1 GAL | 3` X 3` | 7 |
| | 70 | CALAMAGROSTIS X ACUTIFLORA `KARL FOERSTER` | 1 GAL | 30" X 2` | 3 |
| | 5 | FEATHER REED GRASS MUHLENBERGIA CAPILLARIS `REGAL MIST` TM | 1 GAL | 3` X 3` | 20 |
| | 5 | MUHLY | IGAL | 3 7 3 | 20 |
| | JS SHR | | | | |
| \bigcirc | 7 | BUDDLEJA DAVIDII BUTTERFLY BUSH | 5 GAL | 5` X 7` | 38 |
| | 27 | CARYOPTERIS X CLANDONENSIS `DARK KNIGHT` BLUE MIST SPIREA | 5 GAL | 3` X 3` | 7 |
| | 33 | LEUCOPHYLLUM FRUTESCENS TEXAS SAGE | 5 GAL | 6` X 6` | 28 |
| $\widehat{\cdot}$ | 16 | RHUS AROMATICA `GRO-LOW` | 5 GAL | 2` X 6` | 28 |
| | 30 | GRO-LOW FRAGRANT SUMAC ROSA X `KNOCK OUT` | 5 GAL | 5` X 4` | 7 |
| | | KNOCK OUT ROSES SALVIA GREGGII | | | |
| + | 35 | AUTUMN SAGE CHERRY | 5 GAL | 3` X 4` | 13 |
| EVERGREEN SHRUBS | | | | | |
| ~ • } | 33 | ARTEMISIA FILIFOLIA SAND SAGEBRUSH | 5 GAL | 4` X 4` | 13 |
| Ŕ | 26 | CYTISUS SCOPARIUS `ALL GOLD` SCOTCH BROOM | 5 GAL | 4` X 6` | 28 |
| | 59 | ERICAMERIA LARICIFOLIA | 5 GAL | 3` X 4` | 13 |
| fre the free | 11 | TURPENTINE BUSH ERICAMERIA NAUSEOSA | 5 GAL | 5` X 5` | 20 |
| Source - and | | CHAMISA JUNIPERUS SABINA 'BUFFALO' | | | |
| | 28 | BUFFALO JUNIPER | 5 GAL | 2` X 5` | 20 |
| | 19 | PINUS MUGO MUGO PINE | 5 GAL | 4` X 5` | 20 |
| \bigcirc | 117 | RHAPHIOLEPIS INDICA INDIAN HAWTHORN | 5 GAL | 3` X 4` | 13 |
| | 22 | ROSMARINUS OFFICINALIS `ARP` ARP ROSEMARY | 5 GAL | 6` X 4` | 13 |
| | | | | | |


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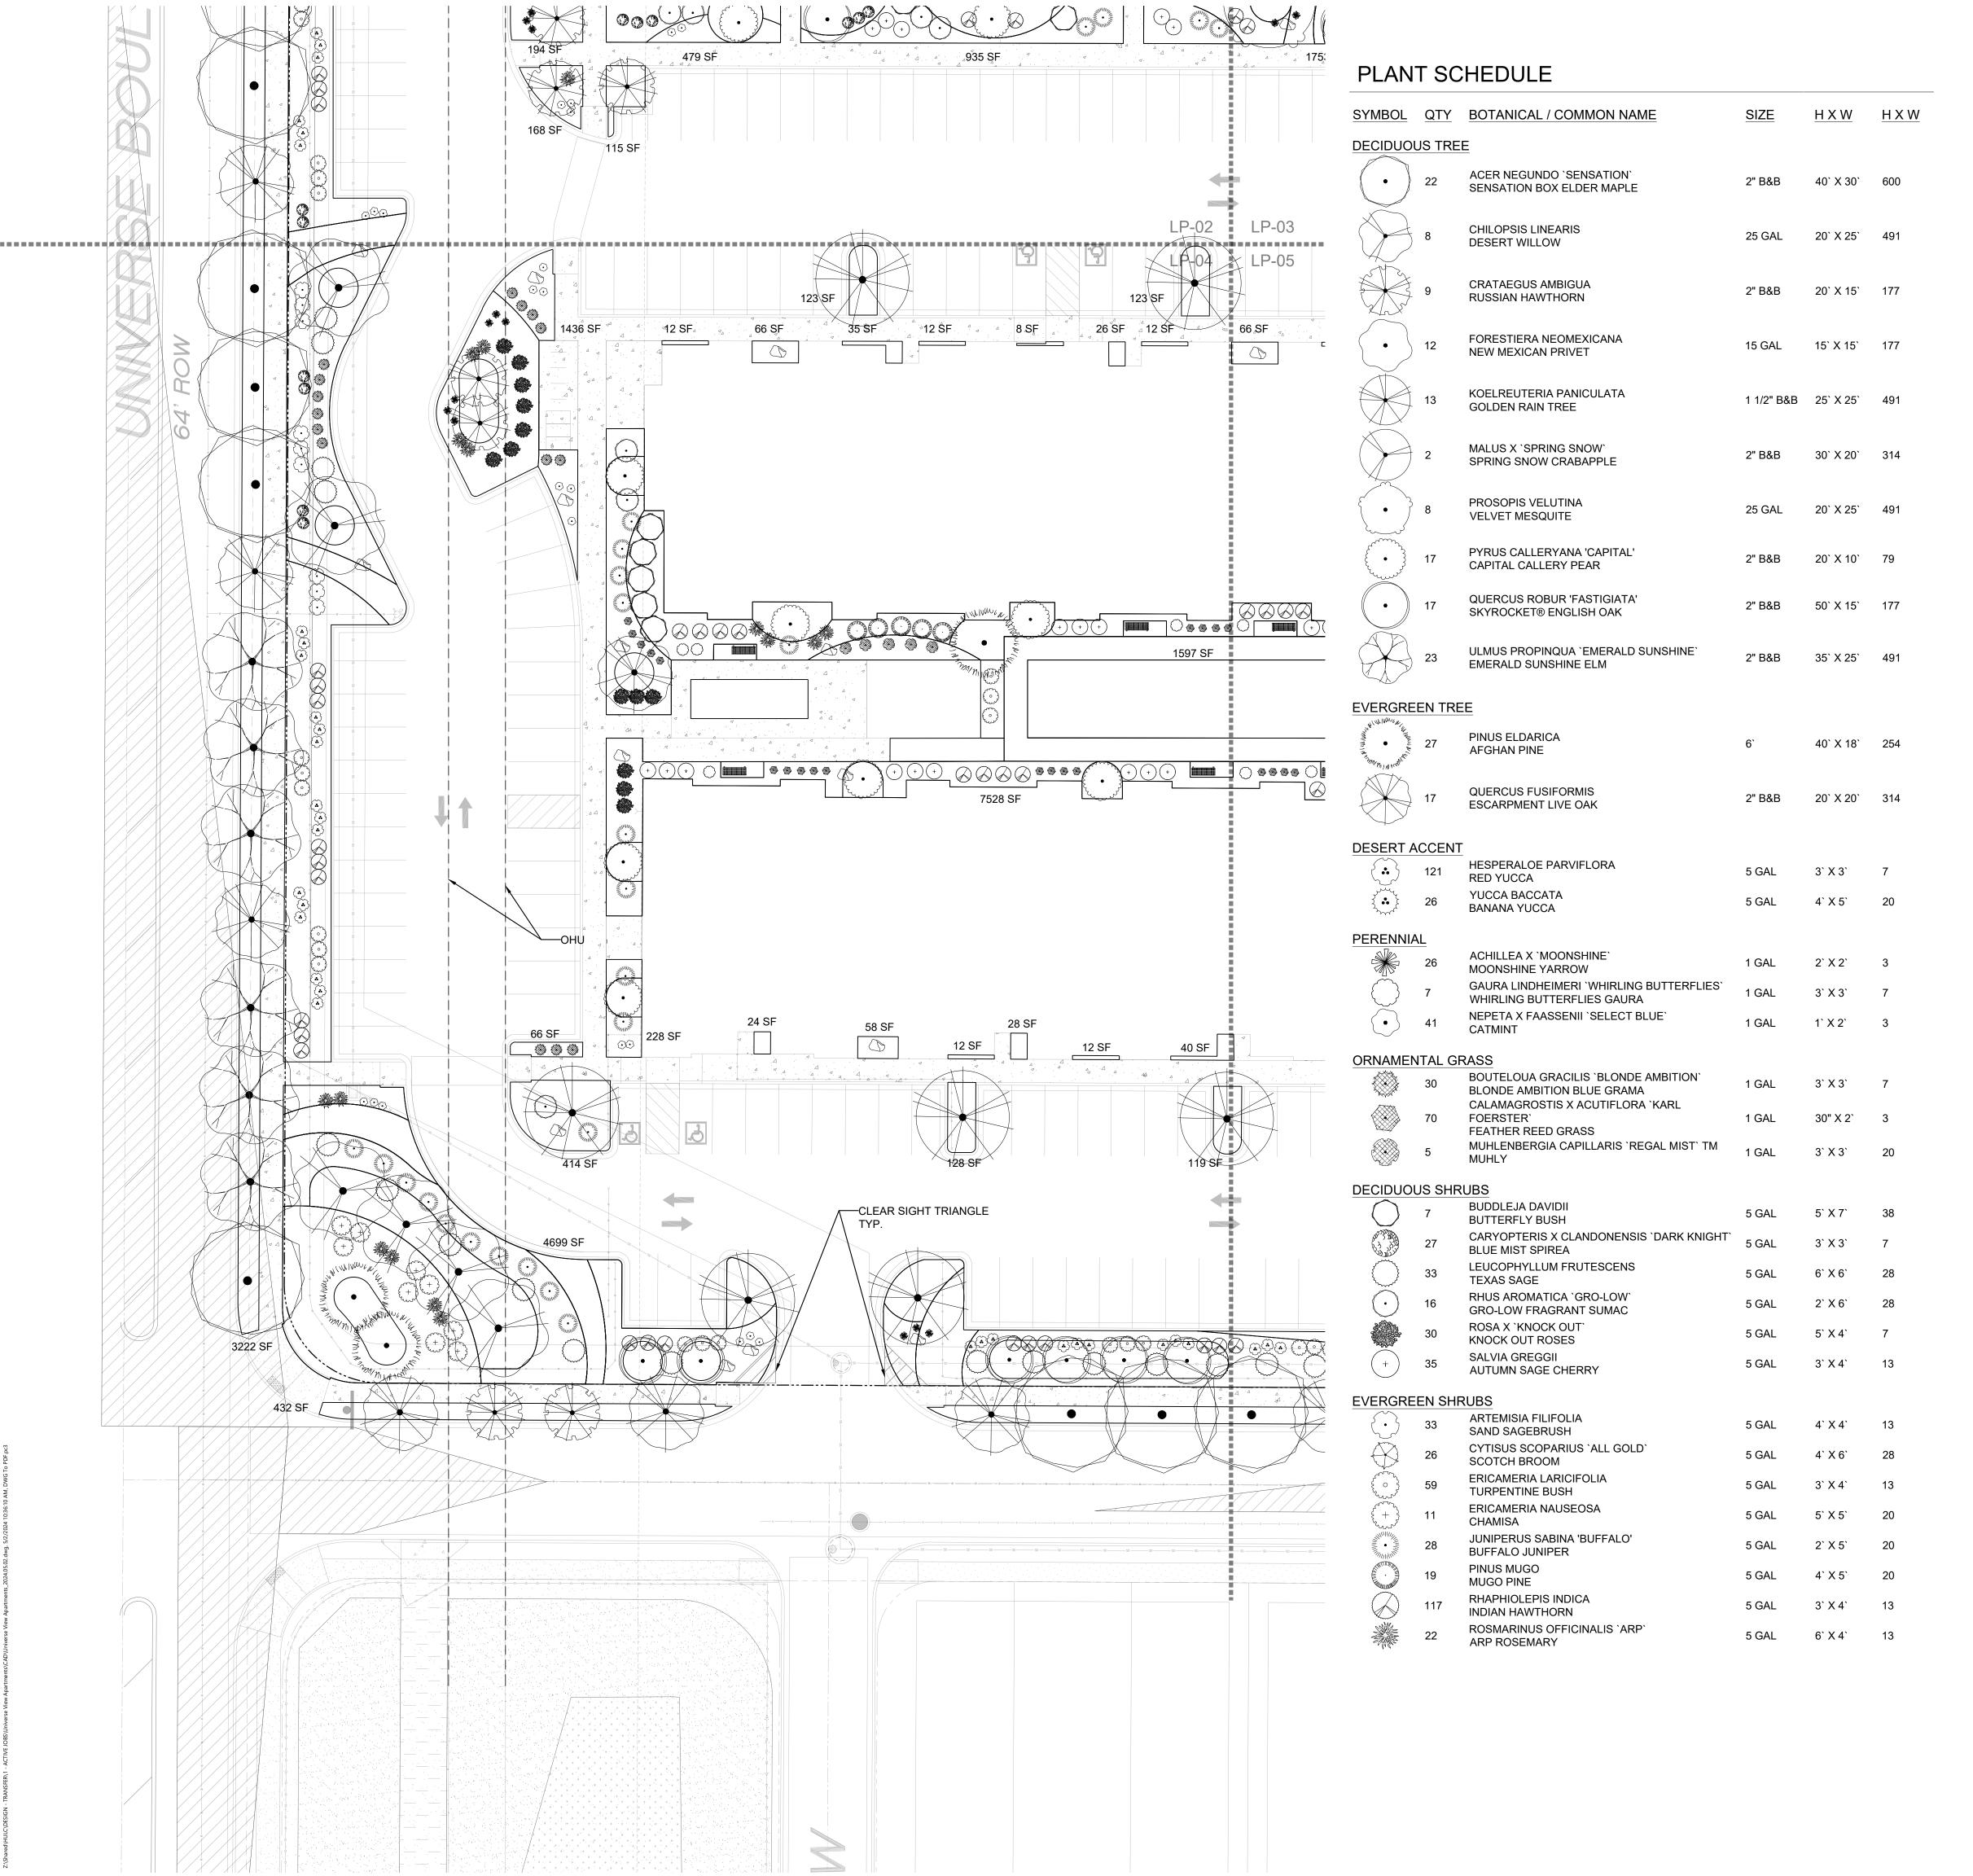
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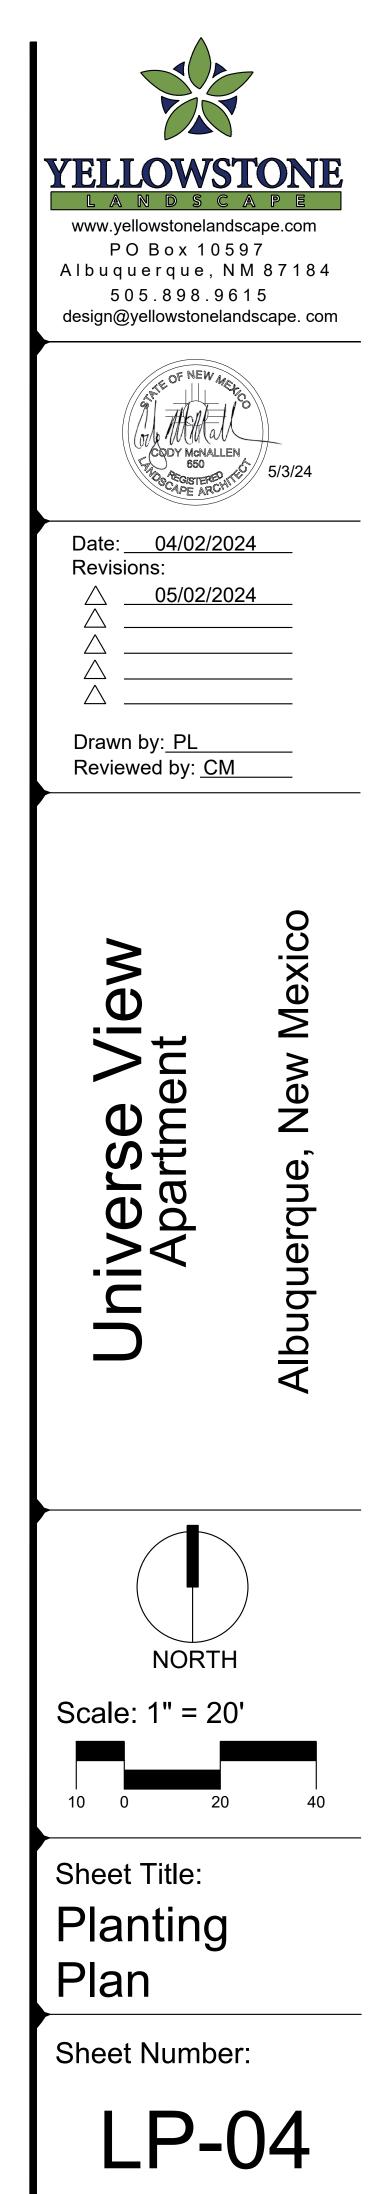
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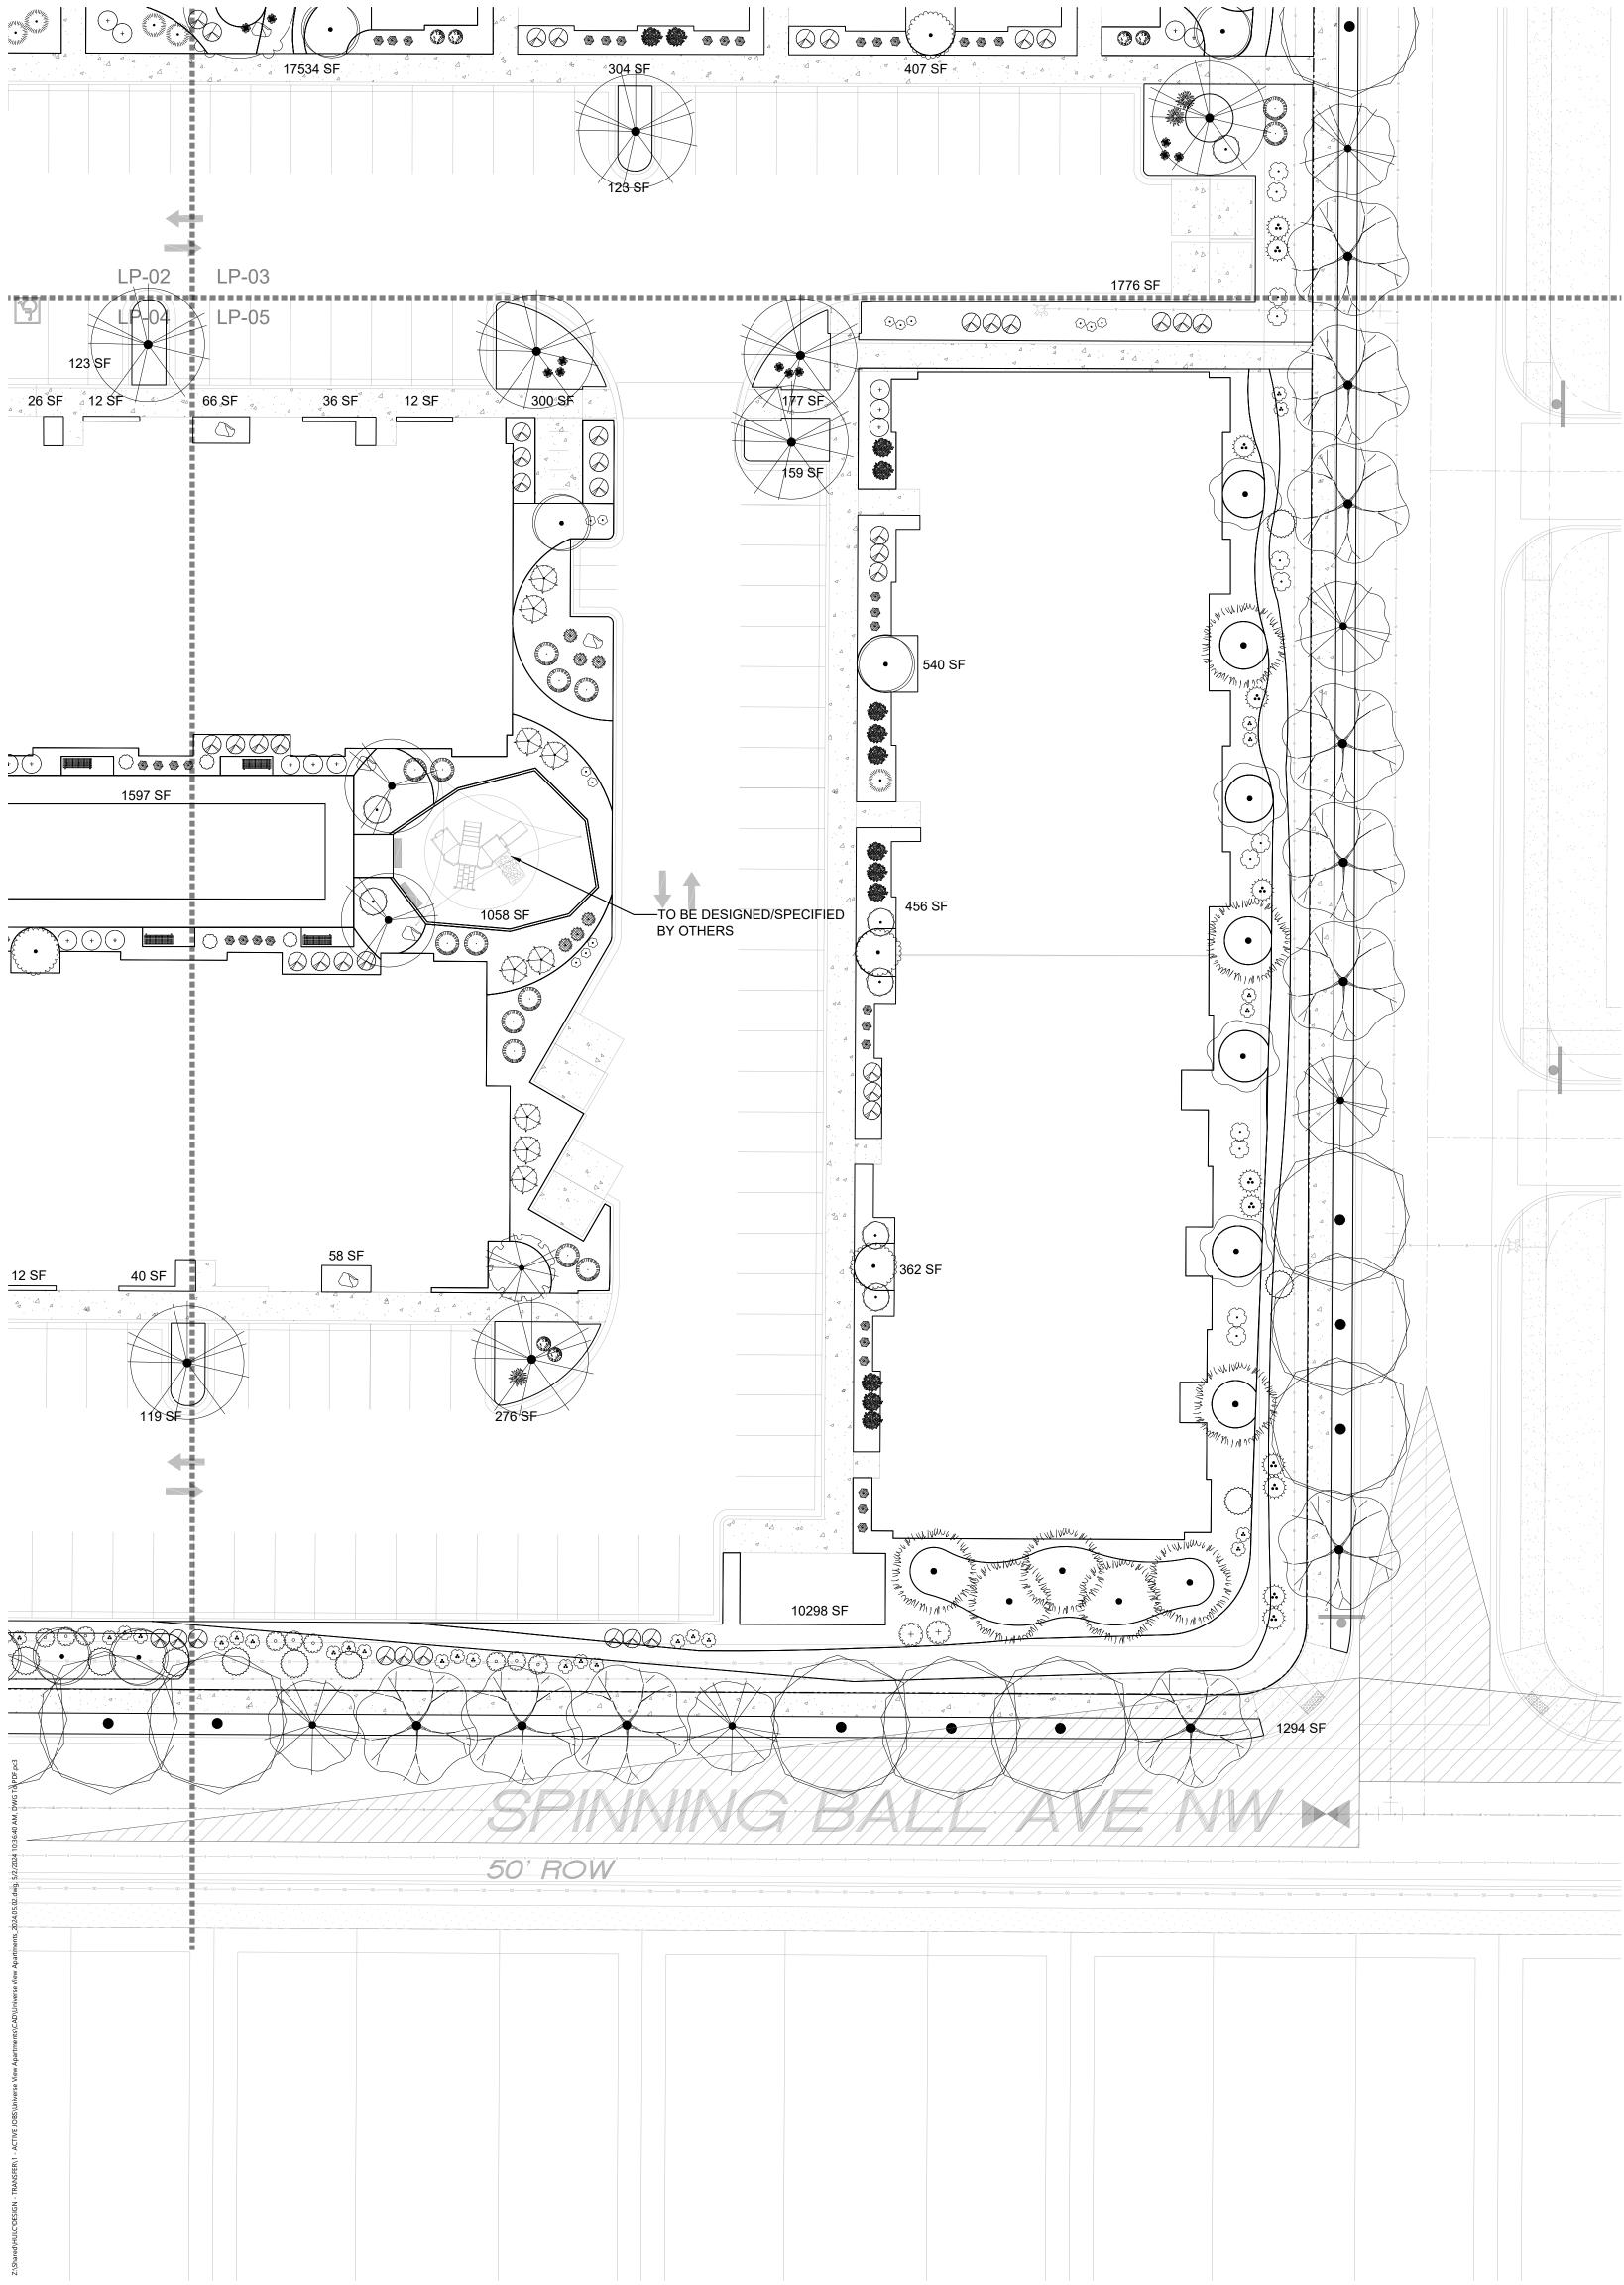
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| A CAR | 9 | CRATAEGUS AMBIGUA RUSSIAN HAWTHORN | 2" B&B | 20` X 15` | 177 |
| • | 12 | FORESTIERA NEOMEXICANA NEW MEXICAN PRIVET | 15 GAL | 15` X 15` | 177 |
| | 13 | KOELREUTERIA PANICULATA GOLDEN RAIN TREE | 1 1/2" B&B | 25` X 25` | 491 |
| | 2 | MALUS X `SPRING SNOW` SPRING SNOW CRABAPPLE | 2" B&B | 30` X 20` | 314 |
| • | 8 | PROSOPIS VELUTINA VELVET MESQUITE | 25 GAL | 20` X 25` | 491 |
| | 17 | PYRUS CALLERYANA 'CAPITAL' CAPITAL CALLERY PEAR | 2" B&B | 20` X 10` | 79 |
| | 17 | QUERCUS ROBUR 'FASTIGIATA' SKYROCKET® ENGLISH OAK | 2" B&B | 50` X 15` | 177 |
| | 23 | ULMUS PROPINQUA `EMERALD SUNSHINE` EMERALD SUNSHINE ELM | 2" B&B | 35` X 25` | 491 |
| EVERGREI | EN TRE | E | | | |
| | 27 | PINUS ELDARICA AFGHAN PINE | 6` | 40` X 18` | 254 |
| | 17 | QUERCUS FUSIFORMIS ESCARPMENT LIVE OAK | 2" B&B | 20` X 20` | 314 |
| DESERT A | CCENT | | | | |
| ~ | 121 | HESPERALOE PARVIFLORA RED YUCCA | 5 GAL | 3` X 3` | 7 |
| | 26 | YUCCA BACCATA | 5 GAL | 4` X 5` | 20 |
| بالمحرب المراجع | | BANANA YUCCA | | | |
| PERENNIA | <u>L</u> | ACHILLEA X `MOONSHINE` | | | |
| | 26 | MOONSHINE YARROW | 1 GAL | 2` X 2` | 3 |
| | 7 | GAURA LINDHEIMERI `WHIRLING BUTTERFLIES` WHIRLING BUTTERFLIES GAURA | 1 GAL | 3` X 3` | 7 |
| • | 41 | NEPETA X FAASSENII `SELECT BLUE` CATMINT | 1 GAL | 1` X 2` | 3 |
| | TAL OF | | | | |
| ORNAMEN | | RASS BOUTELOUA GRACILIS `BLONDE AMBITION` | 4.04 | 0) V 0) | 7 |
| | 30 | BLONDE AMBITION BLUE GRAMA CALAMAGROSTIS X ACUTIFLORA `KARL | 1 GAL | 3` X 3` | 7 |
| | 70 | FOERSTER` FEATHER REED GRASS | 1 GAL | 30" X 2` | 3 |
| | 5 | MUHLENBERGIA CAPILLARIS `REGAL MIST` TM MUHLY | 1 GAL | 3` X 3` | 20 |
| | | | | | |
| | 7 7 | BUDDLEJA DAVIDII | 5 GAL | 5` X 7` | 38 |
| AT THE | | BUTTERFLY BUSH CARYOPTERIS X CLANDONENSIS `DARK KNIGHT` | | | |
| | 27 | BLUE MIST SPIREA LEUCOPHYLLUM FRUTESCENS | 5 GAL | 3` X 3` | 7 |
| | 33 | TEXAS SAGE | 5 GAL | 6` X 6` | 28 |
| (\cdot) | 16 | RHUS AROMATICA `GRO-LOW` GRO-LOW FRAGRANT SUMAC | 5 GAL | 2` X 6` | 28 |
| | 30 | ROSA X `KNOCK OUT` KNOCK OUT ROSES | 5 GAL | 5` X 4` | 7 |
| + | 35 | SALVIA GREGGII AUTUMN SAGE CHERRY | 5 GAL | 3` X 4` | 13 |
| | | | | | |
| EVERGREI | 33 | ARTEMISIA FILIFOLIA | 5 GAL | 4` X 4` | 13 |
| | | SAND SAGEBRUSH CYTISUS SCOPARIUS `ALL GOLD` | | | |
| the second | 26 | SCOTCH BROOM | 5 GAL | 4` X 6` | 28 |
| the second | 59 | ERICAMERIA LARICIFOLIA TURPENTINE BUSH | 5 GAL | 3` X 4` | 13 |
| | 11 | ERICAMERIA NAUSEOSA CHAMISA | 5 GAL | 5` X 5` | 20 |
| | 28 | JUNIPERUS SABINA 'BUFFALO' BUFFALO JUNIPER | 5 GAL | 2` X 5` | 20 |
| | 19 | PINUS MUGO | 5 GAL | 4` X 5` | 20 |
| | | MUGO PINE RHAPHIOLEPIS INDICA | | | |
| | 117 | INDIAN HAWTHORN ROSMARINUS OFFICINALIS `ARP` | 5 GAL | 3` X 4` | 13 |
| | 22 | ARP ROSEMARY | 5 GAL | 6` X 4` | 13 |


GENERAL NOTES

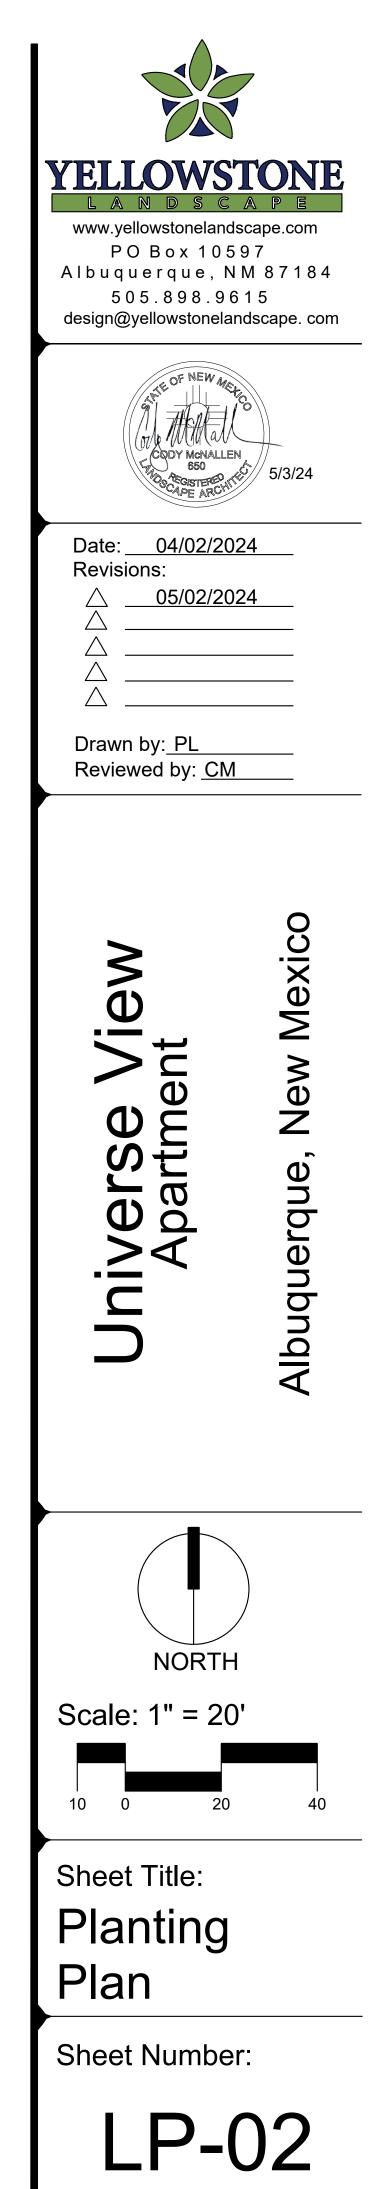
- IN CASE OF DISCREPANCIES IN PLANT QUANTITIES SHOWN ON THE PLANT SCHEDULE AND THOSE SHOWN ON THE PLAN, THE QUANTITIES SHOWN ON THE PLAN SHALL PREVAIL. CONTRACTOR SHALL VERIFY ALL QUANTITIES PRIOR TO BID AND INSTALLATION.
- 2. POSITIVE DRAINAGE AWAY FROM ALL STRUCTURES SHALL BE PROVIDED TO THE LANDSCAPE CONTRACTOR AND SHALL BE MAINTAINED BY THE LANDSCAPE CONTRACTOR THROUGHOUT THE DURATION OF THE PROJECT.
- 3. GRADING OF THE SITE PER THE GRADING PLAN IS NOT INCLUDED IN THE SCOPE OF WORK OF THE LANDSCAPE CONTRACTOR. GRADES PER THE GRADING PLAN SHALL BE PROVIDED TO THE LANDSCAPE CONTRACTOR +/- 1/10TH OF A FOOT, BY OTHERS
- 1/10TH OF A FOOT, BY OTHERS.
 ALL MAINTENANCE OF THE LANDSCAPE AND IRRIGATION SYSTEMS SHALL BE PROVIDED BY OWNER. NO CONTRACTUAL MAINTENANCE SHALL BE INCLUDED UNLESS OTHERWISE SPECIFIED IN THE BIDDING DOCUMENTS.
- WATER MANAGEMENT IS THE SOLE RESPONSIBILITY OF THE PROPERTY OWNER. THE LANDSCAPE ARCHITECT IS NOT RESPONSIBLE FOR ANY RESTRICTIONS OF IRRIGATION WATER USE BY ANY GOVERNING BODY.
 PER 5-6(C)(4)(a) A MINIMUM OF 5 SPECIES MUST BE USED IN THE
- LANDSCAPED AREA.
- 7. PER 5-6(C)(4)(b) ONLY TREES AND SHRUBS SELECTED FROM THE OFFICIAL ALBUQUERQUE PLANT PALETTE OF LOW WATER USE, DROUGHT TOLERANT, OR XERIC SPECIES AND SHOWN ON A LANDSCAPE PLAN CAN COUNT TOWARD THE REQUIREMENTS OF THIS SUBSECTION 14-16-5-6(C) (GENERAL LANDSCAPING STANDARDS), EXCEPT THAT, UPON PRESENTATION OF EVIDENCE, THE RELEVANT DECISION-MAKING BODY MAY AUTHORIZE ALTERNATIVE SPECIES OR CULTIVARS THAT MEET ALL OF THE FOLLOWING REQUIREMENTS:

MEET THE INTENDED PURPOSE OF THAT TYPE OF LANDSCAPING.
 ARE NOT HAZARDOUS.
 ARE NOT IDENTIFIED AS INVASIVE ON A CITY OR STATE PLANT LIST.

5.ARE NOT IDENTIFIED AS INVASIVE ON A CITY OR STATE PLANT LIST. 4.ARE NOT LISTED IN THE CITY'S WEED IDENTIFICATION HANDBOOK. 5.ARE EQUALLY HARDY TO THE NEW MEXICO CLIMATE.

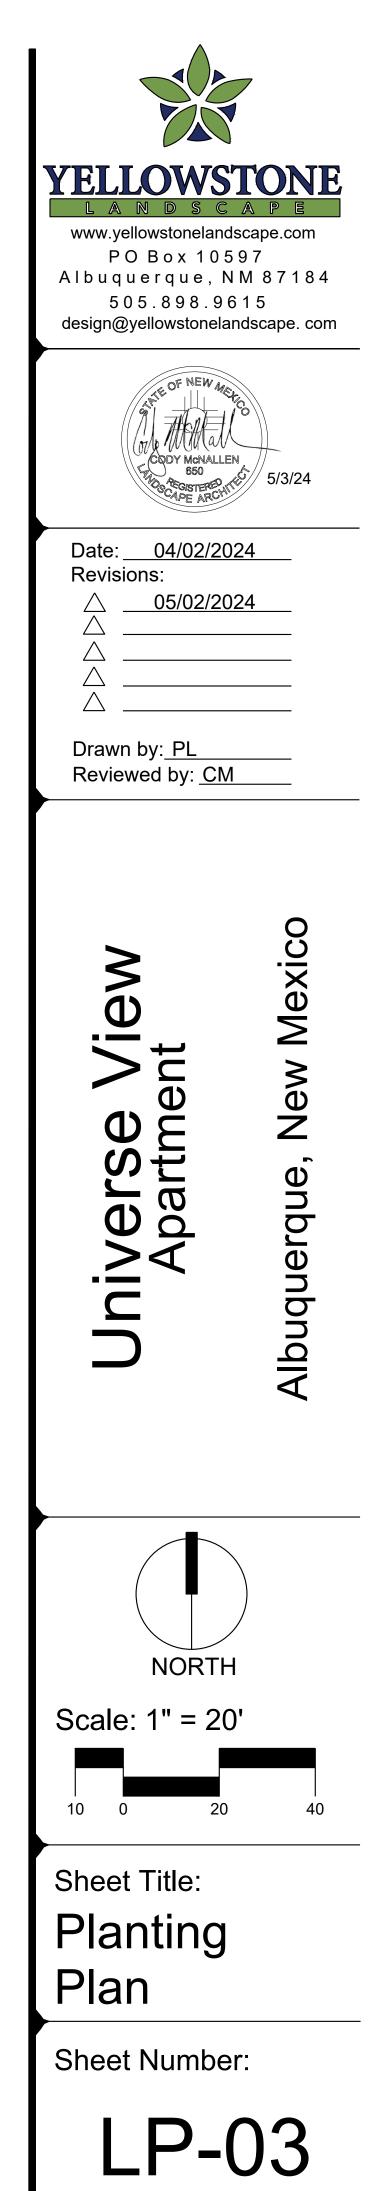- 8. PER 5-3(D)(3)(a) 3, SHADE TREES ALONG REQUIRED PEDESTRIAN WALKWAYS ARE REQUIRED PURSUANT TO SUBSECTION 14-16-5-6(C)(4)(i) (REQUIRED PLANT MATERIALS AND SITE AMENITIES). 5-6(C)(4)(i) SHADE TREES PLANTED APPROXIMATELY 25 FEET ON-CENTER ARE REQUIRED ALONG ALL REQUIRED PEDESTRIAN WALKWAYS. IF THE WALKWAY IS LESS THAN FEET LONG, AT LEAST ONE TREE IS REQUIRED, OR, WHERE THERE IS INSUFFICIENT SPACE FOR A TREE, A TRELLIS OF AT LEAST 8 FEET HIGH FOR AT LEAST 5 FEET ALONG THE WALKWAY SHALL BE PROVIDED.
- 9. PER 5-6(F)(1)(i) 1 OF THE IDO, ANY PARKING LOT LOCATED WITHIN 30 FEET OF THE FRONT LOT LINE SHALL BE SCREENED FROM THE STREET EITHER BY A MASONRY WALL CONSTRUCTED OF A MATERIAL SIMILAR IN TEXTURE, APPEARANCE, AND COLOR TO THE STREET-FACING FAÇADE OF THE PRIMARY BUILDING (BUT EXCLUDING EXPOSED CMU BLOCK) AT LEAST 3 BUT NOT MORE THAN 4 FEET IN HEIGHT, OR BY A LANDSCAPE BUFFER AT LEAST 10 FEET IN WIDTH WITH A CONTINUOUS LINE OF EVERGREEN SHRUBBERY 3 FEET IN HEIGHT, OR BY OTHER MEANS THAT THE PLANNING DIRECTOR DETERMINES PROVIDES EQUAL OR BETTER SCREENING OF THE HEADLIGHTS OF PARKED VEHICLES.
- 10. PER 5-6(C)(9)(a), ALL PLANTING OF VEGETATED MATERIAL OR INSTALLATION OF ANY LANDSCAPING, BUFFERING, OR SCREENING MATERIAL IN THE PUBLIC RIGHT-OF-WAY SHALL REQUIRE THE PRIOR APPROVAL OF THE CITY. THE PROPERTY OWNER SHALL BE RESPONSIBLE FOR THE MAINTENANCE, REPAIRS, OR LIABILITY FOR ALL THE LANDSCAPING PLACED IN OR OVER THE PUBLIC RIGHT-OF-WAY.
- 11. PER 5-6(C)(9)(b), ANY TREES THAT OVERHANG A PUBLIC SIDEWALK OR MAJOR PUBLIC OPEN SPACE SHALL BE TRIMMED TO MAINTAIN AN 8 FOOT CLEARANCE OVER THE SIDEWALK. ANY TREES THAT OVERHANG A PUBLIC STREET SHALL BE TRIMMED TO MAINTAIN A 9' CLEARANCE OVER THE STREET SURFACE.
- PURSUANT TO 5-6(C)(5)(e), BARK MULCH AREAS CLEARLY DELINEATED ON PLANS FOR LANDSCAPE AREAS AND 5' RADIUS RINGS AROUND TREES.
 PURSUANT TO 5-6(C)(7)(a), ALL VEGETATION HAS BEEN LOCATED A MINIMUM
- OF 3' IN ANY DIRECTION FROM FIRE HYDRANTS, VALVE VAULTS, HOSE BIBS, MANHOLES, HYDRANTS AND FIRE DEPARTMENT CONNECTIONS.
- PURSUANT TO 5-6(C)(10)(a), TREES AND SHRUBS SHALL NOT BE PLANTED IN UTILITY EASEMENTS UNLESS THERE IS NO OTHER PRACTICABLE LOCATION ON THE LOT WHERE THE LANDSCAPING WOULD ACHIEVE ITS INTENDED PURPOSE.
 PURSUANT TO 5 6(O)(40)(b), TREES OUTLINE NOT DE DI AUTED WITH AND TO 5 6(O)(40)(b).
- PURSUANT TO 5-6(C)(10)(b), TREES SHALL NOT BE PLANTED WITHIN 10' IN ANY DIRECTION OF THE CENTERLINE OF A SEWER OR WATER LINE.
 CLEAR SIGHT TRIANGLE NOTE: LANDSCAPING, SIGNAGE, WALLS, FENCES, TREES AND SHELL PREPIES PETMEEN OF AND OF TALL (AC MEACURED STOCK)
- TREES, AND SHRUBBERIES BETWEEN 3' AND 8' TALL (AS MEASURED FROM THE GUTTER PAN) ARE NOT ALLOWED WITHIN THE CLEAR SIGHT TRIANGLE.
 17. PER 5-6(C)(14)(a), IRRIGATION SYSTEMS SHALL COMPLY WITH SECTION 8 OF THE ABCWUA LEGISLATION AND ORDINANCES (CROSS CONNECTION
- PREVENTION AND CONTROL ORDINANCE)
 18. PER 5-6(C)(14)(b), ALL IRRIGATION SYSTEMS SHALL BE DESIGNED TO MINIMIZE THE USE OF WATER.
- PER 5-6(C)(14)(c), ALL NON-RESIDENTIAL LANDSCAPE IRRIGATION SHALL HAVE AUTOMATIC TIMERS AND/OR PROGRAMMABLE SETTINGS TO AVOID OVERWATERING.
- 20. PER 5-6(C)(14)(d), THE IRRIGATION SYSTEM SHALL NOT SPRAY OR IRRIGATE IMPERVIOUS SURFACES, INCLUDING SIDEWALKS, DRIVEWAYS, DRIVE AISLES, STREETS, AND PARKING AND LOADING AREAS.

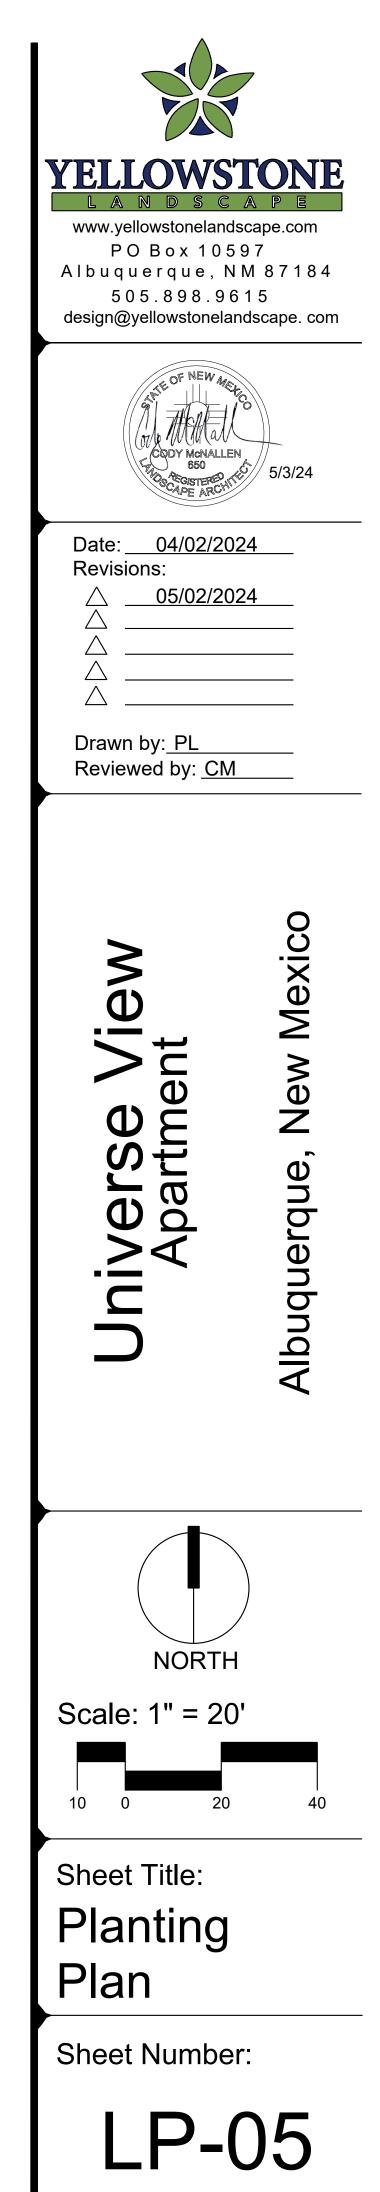

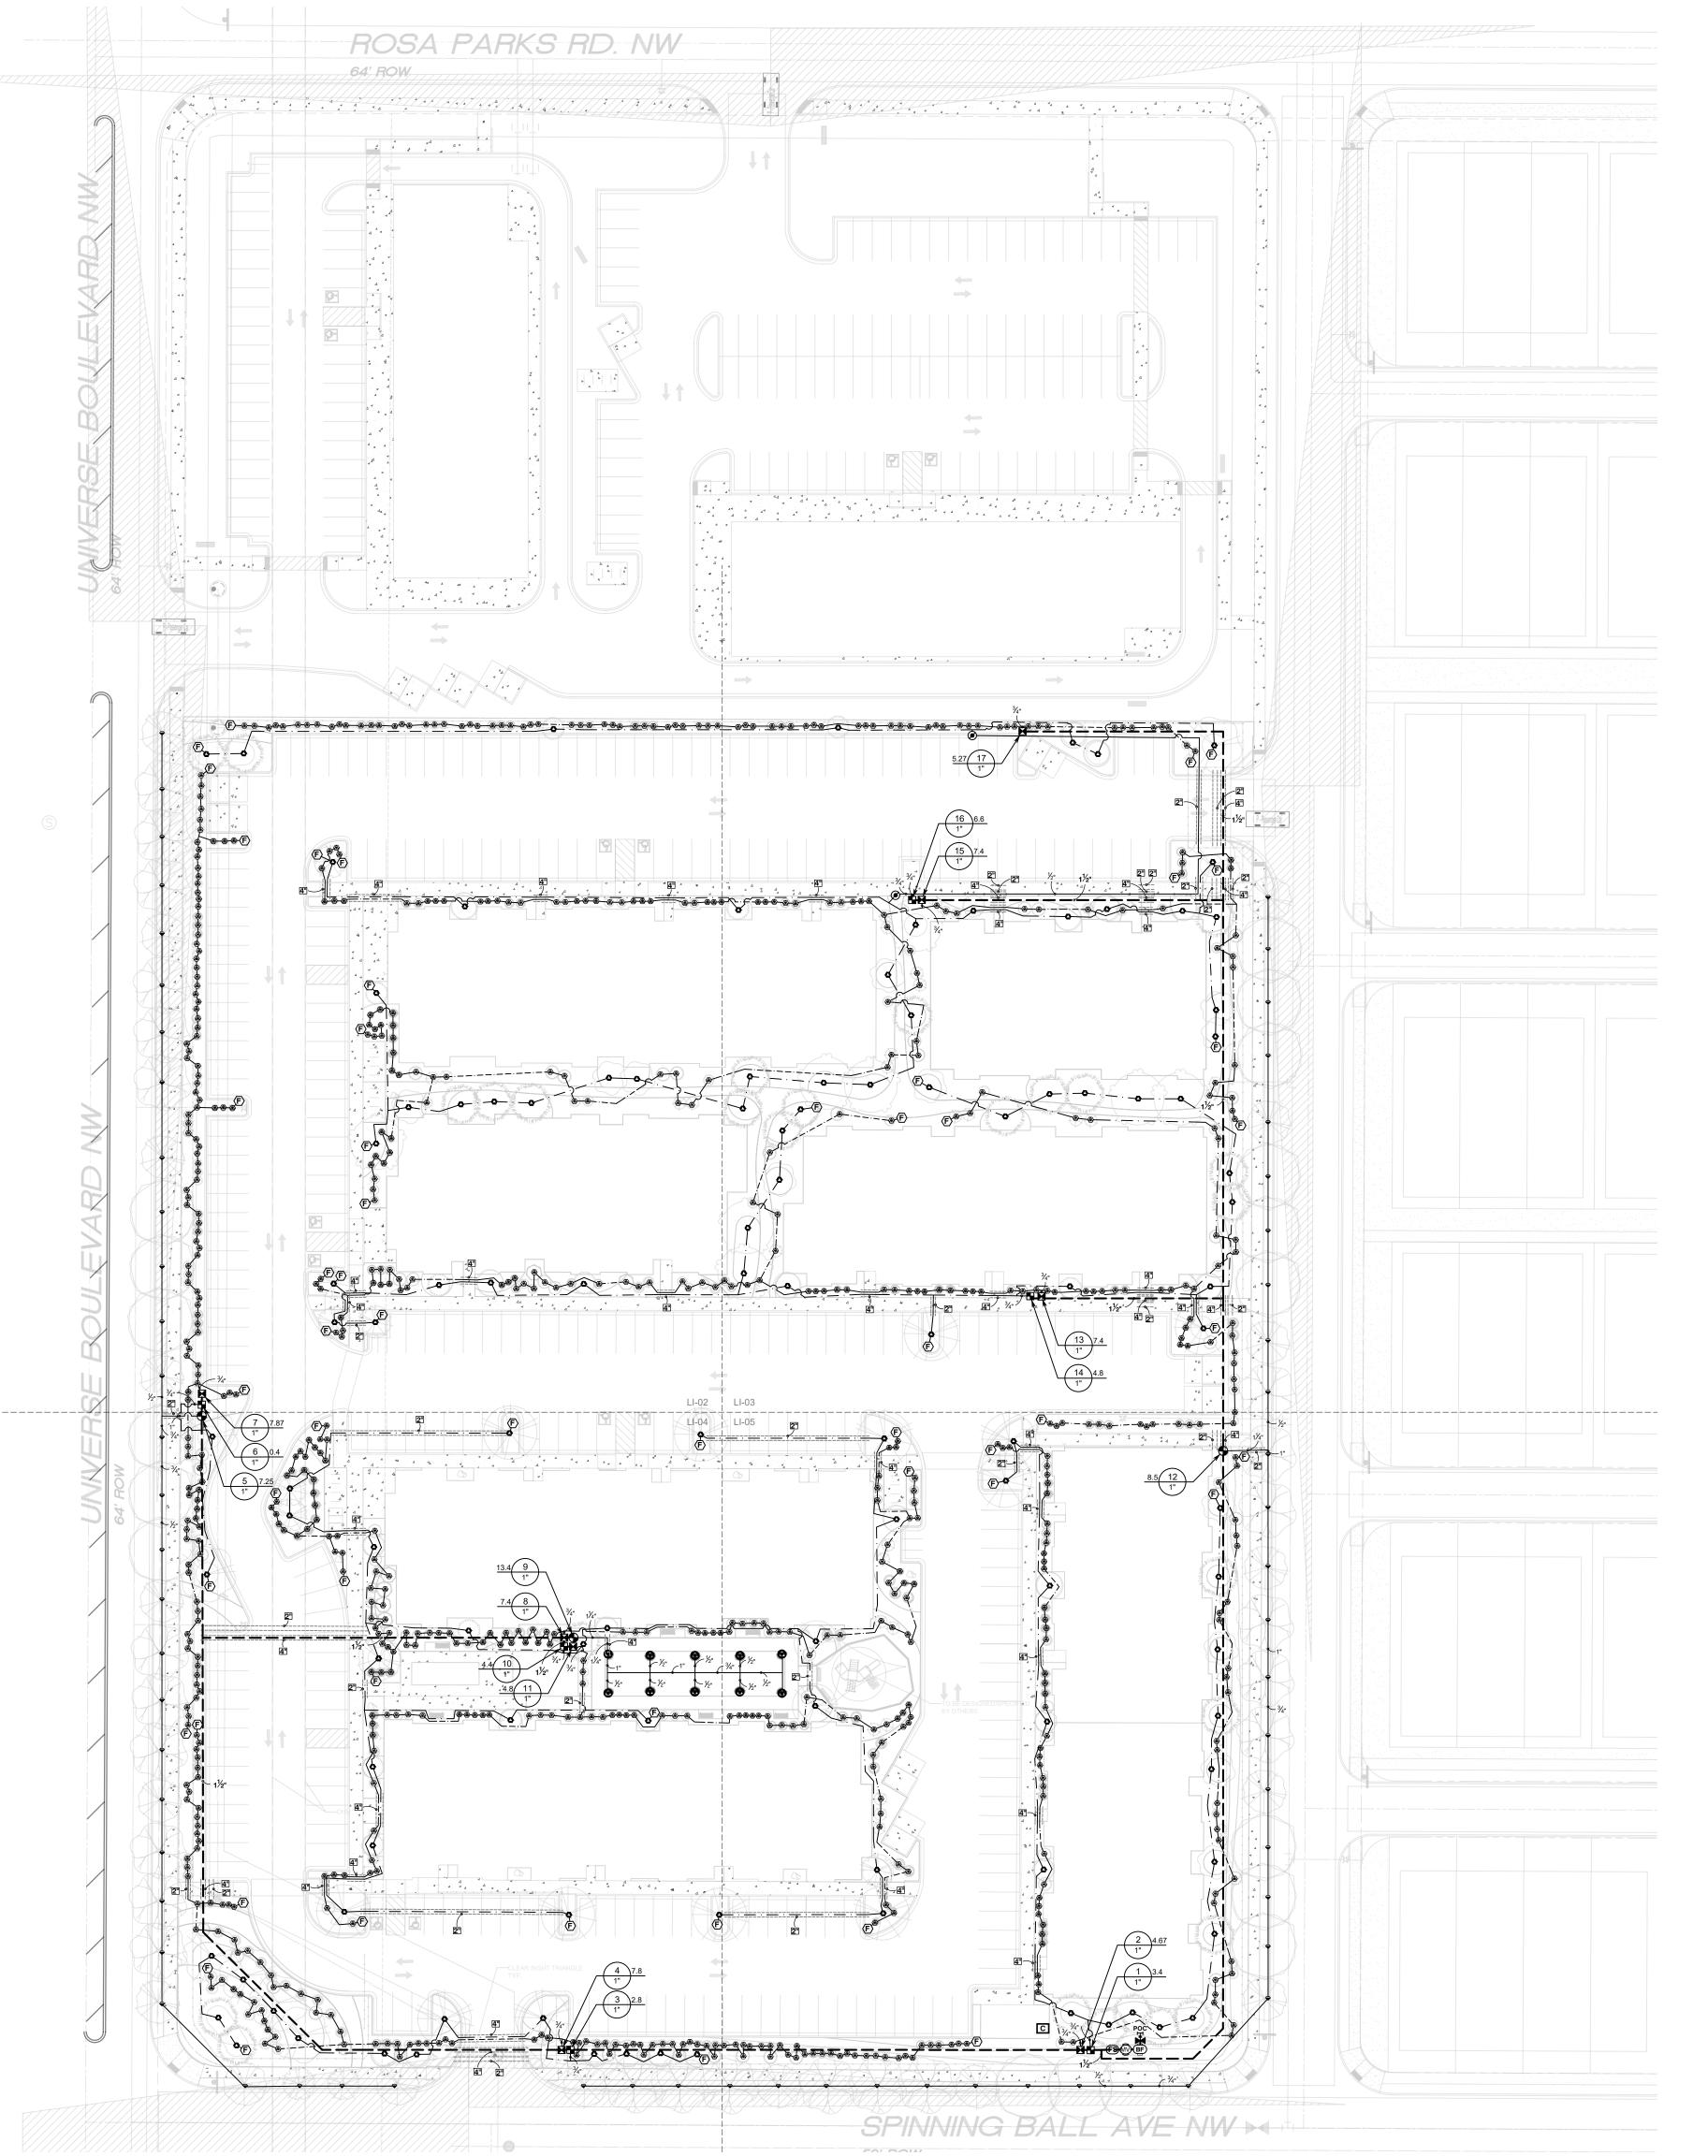

- CLARITY ONLY.
- OF IRRIGATION SYSTEM.
- SYSTEM.
- WITHIN THE PROPERTY LINE.

IRRIGATION SCHEDULE

| VALVE AND 45 PSI IN-STEM PRESSURE REGULATOR. 1/2IN NPT FEMALE THREADED INLET. NPT FEMALE THREADED INLET. RAIN BIRD 1800.1400 FLOOD FIXED FLOW RATE 0.25 GPM - 2.0 GPM, FULL CIRCLE BUBBLER, 1/2IN, FIPT. SYMBOL MANUFACTURER/MODEL/DESCRIPTION DRIP CONTROL VALVE - SHRUB RAIN BIRD XCZ-100-PRF. MEDIUM FLOW DRIP CONTROL K 11N, DV VALVE, 11N, PRESSURE REGULATING FILTER, 40P3 PRESSURE REGULATOR. 5 GPM-20 GPM. DRIP CONTROL VALVE - TREE RAIN BIRD XCZ-100-PRF. MEDIUM FLOW DRIP CONTROL K 11N, DV VALVE, 11N, PRESSURE REGULATING FILTER, 40P3 PRESSURE REGULATOR. 5 GPM-20 GPM. Image: Control VALVE - TREE RAIN BIRD XCZ-100-PRF. MEDIUM FLOW DRIP CONTROL K 11N, DV VALVE, 11N, PRESSURE REGULATING FILTER, 40P3 PRESSURE REGULATOR. 3 GPM-15 GPM. Image: Control VALVE - TREE RAIN BIRD XE2 DORIP EMITTERS Image: Control VALVE - TREE Control VALVE Image: Control VALVE RAIN BIRD PEB. 11N, 1-1/2IN, 21N, PLASTIC INDUSTRIAL VALVES. LOW FLOW OPERATING CAPABILITY, GLOBE CONFIGURATION. Image: Control VALVE 1' MAIN SHUT OFF VALVE SPEARS SCH80 PVC COMPACT BALL VALVE Image: Control VALVE 1' MAIN SHUT OFF VALVE SPEARS SCH80 PVC COMPACT BALL VALVE Image: Control VALVE 1' MAIN SHUT OFF VALVE SPEARS SCH80 PVC COMPACT BALL VALVE Image: Control VALVE 1' MAIN SHUT OFF VALVE SPEARS SCH80 PVC COMPACT BALL VALVE Image: Control VALVE 1' MAIN SHUT OFF VALVE SPEARS SCH8 | | CONEDOLE |
|---|------------------------------|---|
| 1804-SAM-P45.17FT24FT.45.270 DEGREES AND 380 21 DEGREES. HAND ADUISTABLE MULTI-STREAM ROTARY WI1800 TURS SPRAY BODY ON AIN. POP-UP, WITH CHECK VALVE AND 45 PSII.N.STEM PRESSURE REGULATOR. 1/2N NPT FEMALE THREADED INLET. 1801 1802 1800 TURS SPRAY BODY ON AIN. POP-UP, WITH CHECK VALVE AND 45 PSII.N.STEM PRESSURE REGULATOR. 1/2N NPT FEMALE THREADED INLET. 1801 1802 1800 TURS SPRAY BODY ON AIN. POP-UP, WITH CHECK VALVE AND 45 PSII.N.STEM PRESSURE REGULATIOR. 1/2N NPT FEMALE THREADED INLET. 1801 1802 1800 TURS SPRAY BODY ON AIN. POP-UP, WITH CHECK VALVE AND 45 PSII.N.STEM PRESSURE REGULATING FILTER, 40P2 PRESSURE REGULATOR. 3 GPM-30 GPM. 181 1800 1800 X22.100-PRF. MEDIUM FLOW DRIP CONTROL K IN. DV VALVE, TIN. PRESSURE REGULATING FILTER, 40P2 PRESSURE REGULATOR. 3 GPM-30 GPM. 181 DE NOX 21.000-PRF. MEDIUM FLOW DRIP CONTROL K IN. DV VALVE, TIN. PRESSURE REGULATING FILTER, 40P2 PRESSURE REGULATOR. 3 GPM-30 GPM. 181 DEN X02.100-PRF. MEDIUM FLOW DRIP CONTROL K IN. DV VALVE, TIN. PRESSURE REGULATING FILTER, 40P2 PRESSURE REGULATOR. 3 GPM-30 GPM. 181 DEN X02.100-PRF. MEDIUM FLOW DRIP CONTROL K IN. DV VALVE, TIN. THEE RAIN BIRD X22.100 PRIMITERS 181 DEN KITTER - SHRUB (2) NDS TAE 20 DRIP EMITTERS 181 DEN EMITTER - TREE (3) NDS TAE 20 DRIP EMITTERS 29 MBOL MANUFACTURERRANG CAPABILITY, GLOBE CONFIGURATION. 181 DEN PEB.1110, 1-121N, 21N, PLASTIC INDUSTRIAL VALVES LOW FLOW FLOW OPERATING CAPABILITY, GLOBE CONFIGURATION. 181 DEN PEB.200 FLOW OPERATING CAPABILITY, GLOBE CONFIGURATION. 181 DEN PEB.200 FLOW OPERATING | SYMBOL | MANUFACTURER/MODEL/DESCRIPTION |
| INTER FIXED FLOW RATE 0.26 GPM - 2.0 GPM, FULL CIRCLE BUBBLER, 1/2/N. FIPT. SYMBOL MANUFACTURER/MODEL/DESCRIPTION DRIP CONTROL VALVE - SHRUB RAIN BIRD XC2.100-PRF, MEDIUM FLOW DRIP CONTROL K IN. DVALVE, IN. PRESSURE REGULATING FILTER, 40PS PRESSURE REGULATOR: 5 GPM-20 GPM. IN. DVALVE, IN. PRESSURE REGULATING FILTER, 40PS PRESSURE REGULATOR: 3 GPM-15 GPM. IN. DVVALVE, IN. PRESSURE REGULATING FILTER, 40PS PRESSURE REGULATOR: 3 GPM.15 GPM. IN. DVVALVE, IN. PRESSURE REGULATING FILTER, 40PS PRESSURE REGULATOR: 3 GPM.15 GPM. INS CEP900 IND CEP900 IND RIP EMITTER: SHRUB (2) NDS TAE 20 DRIP EMITTERS SYMBOL MANUFACTURER/MODEL/DESCRIPTION CONTROL VALVE IND RED PEB. 11N, 1-1/2IN, 2IN, PLASTIC INDUSTRIAL VALVES: LOW FLOW OPERATING CAPABILITY, GLOBE CONFIGURATION. IND RED PEB. 11N, 1-1/2IN, 2IN, PLASTIC INDUSTRIAL MANUSENCUES MAIN BIRD PEB. 11N, 1-1/2IN, 2IN, PLASTIC INDUSTRIAL MANUFACTURER REAUREMENTS: SYMBOL MANUFACTURER REAUREMENTS: RAIN BIRD PEB. 11N, 1-1/2IN, 2IN, PLASTIC INDUSTRIAL | 24 ADJ 24 F | 1804-SAM-P45, 17FT24FT. 45-270 DEGREES AND 360 DEGREES. HAND ADJUSTABLE MULTI-STREAM ROTARY W/1800 TURF SPRAY BODY ON 4IN. POP-UP, WITH CHECK VALVE AND 45 PSI IN-STEM PRESSURE REGULATOR. 1/2IN. |
| PRIP CONTROL VALVE - SHRUB RAIN BIRD XCZ-100-PRF, MEDIUM FLOW DRIP CONTROL K TIN. DV VALVE, IN. PRESSURE REGULATING FILTER, 40PS PRESSURE REGULATOR. 5 GPM-20 GPM. PRIP CONTROL VALVE - TREE RAIN BIRD XCZ-100-PRF, MEDIUM FLOW DRIP CONTROL K TRANSITION FITING PRESSURE REGULATOR. 3 GPM-15 GPM. PRESSURE REGULATOR. 3 GPM-15 GPM. Image: Control Valve - TREE RAIN BIRD XCZ-100-PRF, MEDIUM FLOW DRIP CONTROL K TRANSITION FITING PIET TRANSITION POINT FROM PVC LATERAL TO DRIP TUBING WITH RISER IN 61N. DRIP BOX. F FLUSH CAP NDS CEP900 DRIP EMITTER - SHRUB (2) NDS TAE 20 DRIP EMITTERS Image: Control Valve RAIN BIRD PEB. 11N., 1-1/2IN., 21N. PLASTIC INDUSTRIAL VALVES. LOW FLOW OPERATING CAPABILITY, GLOBE CONTROL VALVE RAIN BIRD PEB. 11N., 1-1/2IN., 21N. PLASTIC INDUSTRIAL VALVES. LOW FLOW OPERATING CAPABILITY, GLOBE CONFIGURATION. MAIN SHUT OFF VALVE SPEARS SCH60 PVC COMPACT BALL VALVE RAIN BIRD PEB. 11N., 1-1/2IN., 21N. PLASTIC INDUSTRIAL MASTER VALVES. LOW FLOW OPERATING CAPABILITY, GLOBE CONFIGURATION. B RAIN BIRD PEB. 11N., 1-1/2IN., 21N. PLASTIC INDUSTRIAL MASTER VALVES. LOW FLOW OPERATING CAPABILITY, GLOBE CONFIGURATION. B RAIN BIRD PEB. 11N., 1-1/2IN., 21N. PLASTIC INDUSTRIAL MASTER VALVES. LOW FLOW OPERATING CAPABILITY, GLOBE CONFIGURATION. B RAIN BIRD PEB. 11N., 1-1/2IN., 21N. PLAST | | FIXED FLOW RATE 0.25 GPM - 2.0 GPM, FULL CIRCLE |
| RAIN BIRD XC2-100-PRF, MEDIUM FLOW DRIP CONTROL K IN. DV VALVE, IN. PRESSURE REGULATING FILTER, 40PS PRESSURE REGULATOR. 5 GPM-20 GPM. DRIP CONTROL VALVE - THEE RAIN BIRD XC2-100-PRF, MEDIUM FLOW DRIP CONTROL K IN. DV VALVE, IN. PRESSURE REGULATING FILTER, 40PS PRESSURE REGULATOR. 3 GPM-15 GPM. TRANSITION FITING PIPE TRANSITION POINT FROM PVC LATERAL TO DRIP TUBING WITH RISER IN 6IN. DRIP BOX. (2) NDS TAE 20 DRIP EMITTERS DRIP EMITTER - SHRUB (2) NDS TAE 20 DRIP EMITTERS SYMBOL MANUFACTURER/MODEL/DESCRIPTION CONTROL VALVE RAIN BIRD PEB. 11N. 1-1/2IN., 2IN. PLASTIC INDUSTRIAL VALVES. LOW FLOW OPERATING CAPABILITY, GLOBE CONFIGURATION. MAIN SHUT OFF VALVE SPEARS SCH60 PVC COMPACT BALL VALVE MASTER VALVES. LOW FLOW OPERATING CAPABILITY, GLOBE CONFIGURATION. MAIN SHUT OFF VALVE SPEARS SCH60 PVC COMPACT BALL VALVE MASTER VALVES. LOW FLOW OPERATING CAPABILITY, GLOBE CONFIGURATION. RAIN BIRD PEB. 11N. 1-1/2IN., 2IN. PLASTIC INDUSTRIAL MASTER VALVES. LOW FLOW OPERATING CAPABILITY, GLOBE CONFIGURATION. MAIN SHUT OFF VALVE SPEARS SCH60 PVC COMPACT BALL VALVE MASTER VALVES. LOW FLOW OPERATING CAPABILITY, GLOBE CONFIGURATION. MAIN SHUT OFF VALVE SPEARS SCH60 PVC COMPACT BALL VALVE MASTER VALVES. LOW FLOW OPERATING CAPABILITY, GLOBE CONFIGURATION. MAIN SHUT OFF VALVE SPEARS SCH60 PVC COMPACT BALL VALVE MASTER VALVES. LOW FLOW OPERATING CAPABILITY, GLOBE CONFIGURATION. MAIN SHUT OFF VALVE RAIN BIRD PCD SUBMERT RAIN BIRD PCD SUBMERT WALVENT NOT THE AND BIRD PCD SUBMERT WALVENT NOT THE THAN BIRD PCD SUBMERT WALVENT NOT THE AND BIRD PCD SUBMERT WALVENT NOT THE AND BIRD PCD SUBMERT WAN NUMDER VAING NUMBER | SYMBOL | MANUFACTURER/MODEL/DESCRIPTION |
| AIN BIRD XC2-100-PRF. MEDIUM FLOW DRIP CONTROL K IN, OV VALVE, IN, PRESSURE REGULATING FILTER, 40P3 PRESSURE REGULATOR. 3 GPM-15 GPM. TRANSITION POINT FROM PVC LATERAL TO DRIP TUBING WITH RISER IN GIN, DRIP BOX. FLUSH CAP NDS CEP900 ORIP EMITTER. SHRUB (2) NDS TAE 20 DRIP EMITTERS ORIP EMITTER. SHRUB (3) NDS TAE 20 DRIP EMITTERS ORIP EMITTER. SHRUB (4) NDS TAE 20 DRIP EMITTERS ORIFOLVALVE RAIN BIRD PEB. IIN, 1-1/2IN, 2IN. PLASTIC INDUSTRIAL VALVES. LOW FLOW OPERATING CAPABILITY, GLOBE CONFIGURATION. MAIN SHUT OFF VALVE SPEARS SCH60 PVC COMPACT BALL VALVE MASTER VALVE.1 MAIN SHUT OFF VALVE SPEARS SCH60 PVC COMPACT BALL VALVE MASTER VALVE.2 MAIN SHUT OFF VALVE SPEARS SCH60 PVC COMPACT BALL VALVE MASTER VALVE.1 MAIN SHUT OFF VALVE SPEARS SCH60 PVC COMPACT BALL VALVE MASTER VALVE.2 UWE PLOW OPERATING CAPABILITY, GLOBE CONFIGURATION. OFF RAIN BIRD PEB. IIN, 1-1/2IN, 2IN. PLASTIC INDUSTRIAL MASTER VALVES. LOW FLOW OPERATING CAPABILITY, GLOBE CONFIGURATION. OFF RAIN BIRD PED. XD. SO: 000 STATION 2. WRED DECODER BASED CONTROLLER. (1) ESP-LXD 50-STATION, INDOOR/OUTDOOR, PLASTIC (1) ESP-LXD 50-STATIO | | RAIN BIRD XCZ-100-PRF, MEDIUM FLOW DRIP CONTROL KIT 1IN. DV VALVE, 1IN. PRESSURE REGULATING FILTER, 40PSI |
| PIPE TRANSITION POINT FROM PVC LATERAL TO DRIP TUBING WITH RISER IN 6IN. DRIP BOX. FILUSH CAP NDS CEP900 DRIP EMITTER - SHRUB (2) NDS TAE 20 DRIP EMITTERS DRIP EMITTER - TREE (6) NDS TAE 20 DRIP EMITTERS SYMBOL MANUFACTURER/MODEL/DESCRIPTION CONTROL VALVE RAIN BIRD PEB. 1IN., 1-1/2IN., 2IN. PLASTIC INDUSTRIAL VALVES. LOW FLOW OPERATING CAPABILITY, GLOBE CONFIGURATION. MAIN SHUT OFF VALVE SPEARS SCH80 PVC COMPACT BALL VALVE MASTER VALVE 1" RAIN BIRD PEB. 1IN., 1-1/2IN., 2IN. PLASTIC INDUSTRIAL MASTER VALVE 1" RAIN BIRD PEB. 1IN., 1-1/2IN., 2IN. PLASTIC INDUSTRIAL MASTER VALVE 2. LOW FLOW OPERATING CAPABILITY, GLOBE CONFIGURATION. ROLCED PRESSURE BACKFLOW PREVENTER 1" FEBCO 825Y CONTROLLER - RAIN BIRD ESP-LXD 50-200 STATION, 1NDOOR/OUTDOOR, PLASTIC (1) ESP-LXD 50-3710N, 1NDOOR/OUTDOOR, PLASTIC (1) ESP-LXD 50-3710N, INDOOR/OUTDOOR, PLASTIC (1) ESP-LXD 50-3710N, INDOOR/OUTDOOR, PLASTIC (1) ESP-LXD 50-37110N, INDOOR/OUTDOOR, PLASTIC (1) ESP-LXD 50-57110N, INDOOR/OUTDOOR, PLASTIC (1) ESP-LXD 50-57110N, INDOOR/OUTDOOR, PLASTIC (1) ESP-LXD 50-57110N, INDOOR/OUTDOOR, PLASTIC (2) CONTROLLER - RAIN BIRD ESP-LXD (2) CONTROLER - RAIN BIRD ESP-LXD (2) CONTROLLER | | RAIN BIRD XCZ-100-PRF. MEDIUM FLOW DRIP CONTROL KIT 1IN. DV VALVE, 1IN. PRESSURE REGULATING FILTER, 40PSI |
| NDS CEP900 ORIP EMITTER - SHRUB (2) NDS TAE 20 DRIP EMITTERS DRIP EMITTER - TREE | ۲ | PIPE TRANSITION POINT FROM PVC LATERAL TO DRIP |
| ORIP EMITTER - SHRUB (2) NDS TAE 20 DRIP EMITTERS DRIP EMITTER - TREE (6) NDS TAE 20 DRIP EMITTERS SYMBOL MANUFACTURER/MODEL/DESCRIPTION CONTROL VALVE RAIN BIRD PEB. 1IN., 1-1/2IN., 2IN. PLASTIC INDUSTRIAL VALVES. LOW FLOW OPERATING CAPABILITY, GLOBE CONFIGURATION. MAIN SHIUT OFF VALVE SPEARS SCH80 PVC COMPACT BALL VALVE MASTER VALVE 1" RAIN BIRD PEB. 1IN., 1-1/2IN., 2IN. PLASTIC INDUSTRIAL MASTER VALVE 1" RAIN BIRD PEB. 1IN., 1-1/2IN., 2IN. PLASTIC INDUSTRIAL MASTER VALVE 1" RAIN BIRD PEB. 1IN., 1-1/2IN., 2IN. PLASTIC INDUSTRIAL MASTER VALVE 1" RAIN BIRD PEB. 1IN., 1-1/2IN., 2IN. PLASTIC INDUSTRIAL MASTER VALVE 5. LOW FLOW OPERATING CAPABILITY, GLOBE CONFIGURATION. FEDUCED PRESSURE BACKFLOW PREVENTER 1" FEBCO 82SY CONTROLLER - RAIN BIRD ESP-LXD S0-200 STATION, 2-WIRE DECODER BASED CONTROLLER. (1) ESP-LXD 50-STATION, INDOOR/OUTDOOR, PLASTIC (1) ESP-LXD 50-STATION, INDOOR/OUTDOOR, PLASTIC (1) ESP-LXD 50-STATION, INDOOR/OUTDOOR, PLASTIC WALL-MOUNT ENCLOSURE. SYSTEM REQUIREMENTS: RAIN BIRD FD-XXX-TURF FIELD DECODERS, PAIGE ELECTIC CABLE P7072D & RAIN BIRD WC20 DRY SPLICES ONLY, GROUND SYSTEM W/ (X) LSP-1TURF LINE SURGE PROTECTORS IN RAIN BIRD ROUND VALVE BOXES. INSTALL PER MANUFACTURERS RECOMMENDATIONS. FLOW SENSOR CREATIVE SENSOR TECHNOLOGY FSI-TI0-001 1IN. PVC CREATIVE SENSOR TECHNOLOGY FSI-TI0 | $\langle \mathbf{F} \rangle$ | |
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| IRRIGATION MAINLINE: PVC SCHEDULE 40 Image: State of the s | | IRRIGATION LATERAL LINE: A940 DRIP POLYLINE |
| Image: Pipe Size PVC Class 200 SDR 21 Valve Callout Valve Number Valve Flow | · — · — · — · — · — | IRRIGATION LATERAL LINE: A940RDS DRIP POLYLINE |
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| # • # • Valve Number Valve Flow | | PIPE SLEEVE: PVC CLASS 200 SDR 21 |
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| VIIVO OLE | <u> </u> | |
| | # | valve Size |

IRRIGATION NOTES

1. THE LANDSCAPE CONTRACTOR SHALL FURNISH LABOR, MATERIALS AND EQUIPMENT TO INSTALL PROPOSED IRRIGATION SYSTEM AS SHOWN PER PLAN AND DETAILS. 2. IF ANY ERRORS OR DISCREPANCIES APPEAR ON THE PLAN, THEY MUST BE BROUGHT TO THE ATTENTION OF

THE LANDSCAPE ARCHITECT BEFORE CONSTRUCTION OF THE IRRIGATION SYSTEM BEGINS. 3. LANDSCAPE INSTALLER SHALL PERFORM PRESSURE/GPM TEST AT POINT OF CONNECTION BEFORE INSTALLING IRRIGATION SYSTEM TO VERIFY PSI AND GPM FOR THE SITE.

4. IRRIGATION SYSTEM HAS BEEN DESIGNED TO A MINIMUM DYNAMIC PRESSURE OF 75 PSI AT 50 GPM. IF THE PSI/GPM ARE LOWER THAN 75/50 THE LANDSCAPE ARCHITECT MUST BE NOTIFIED IMMEDIATELY. 5. THE CONTRACTOR SHALL FIELD VERIFY UTILITY LOCATIONS AND MAKE ANY NECESSARY FIELD ADJUSTMENTS WITH GENERAL CONTRACTOR.

6. THE LOCATION OF IRRIGATION EQUIPMENT IS APPROXIMATE AND SHALL BE LOCATED IN THE LANDSCAPE AREAS. ANY IRRIGATION EQUIPMENT AND PIPING SHOWN OUTSIDE OF LANDSCAPE AREAS ARE FOR GRAPHIC

7. THE LANDSCAPE CONTRACTOR SHALL PROVIDE TO OWNER AN ACCURATE AS-BUILT IRRIGATION PLAN WHEN THE WORK IS COMPLETED. AS-BUILT DOCUMENTS SHOULD BE UPDATED WEEKLY FOR ACCURATE RECORDING

8. VALVE LOCATIONS TO BE APPROVED BY LANDSCAPE ARCHITECT. VALVE BOX LIDS TO BE TAN IN GRAVEL AREAS AND GREEN IN SOD/SEED AREAS.


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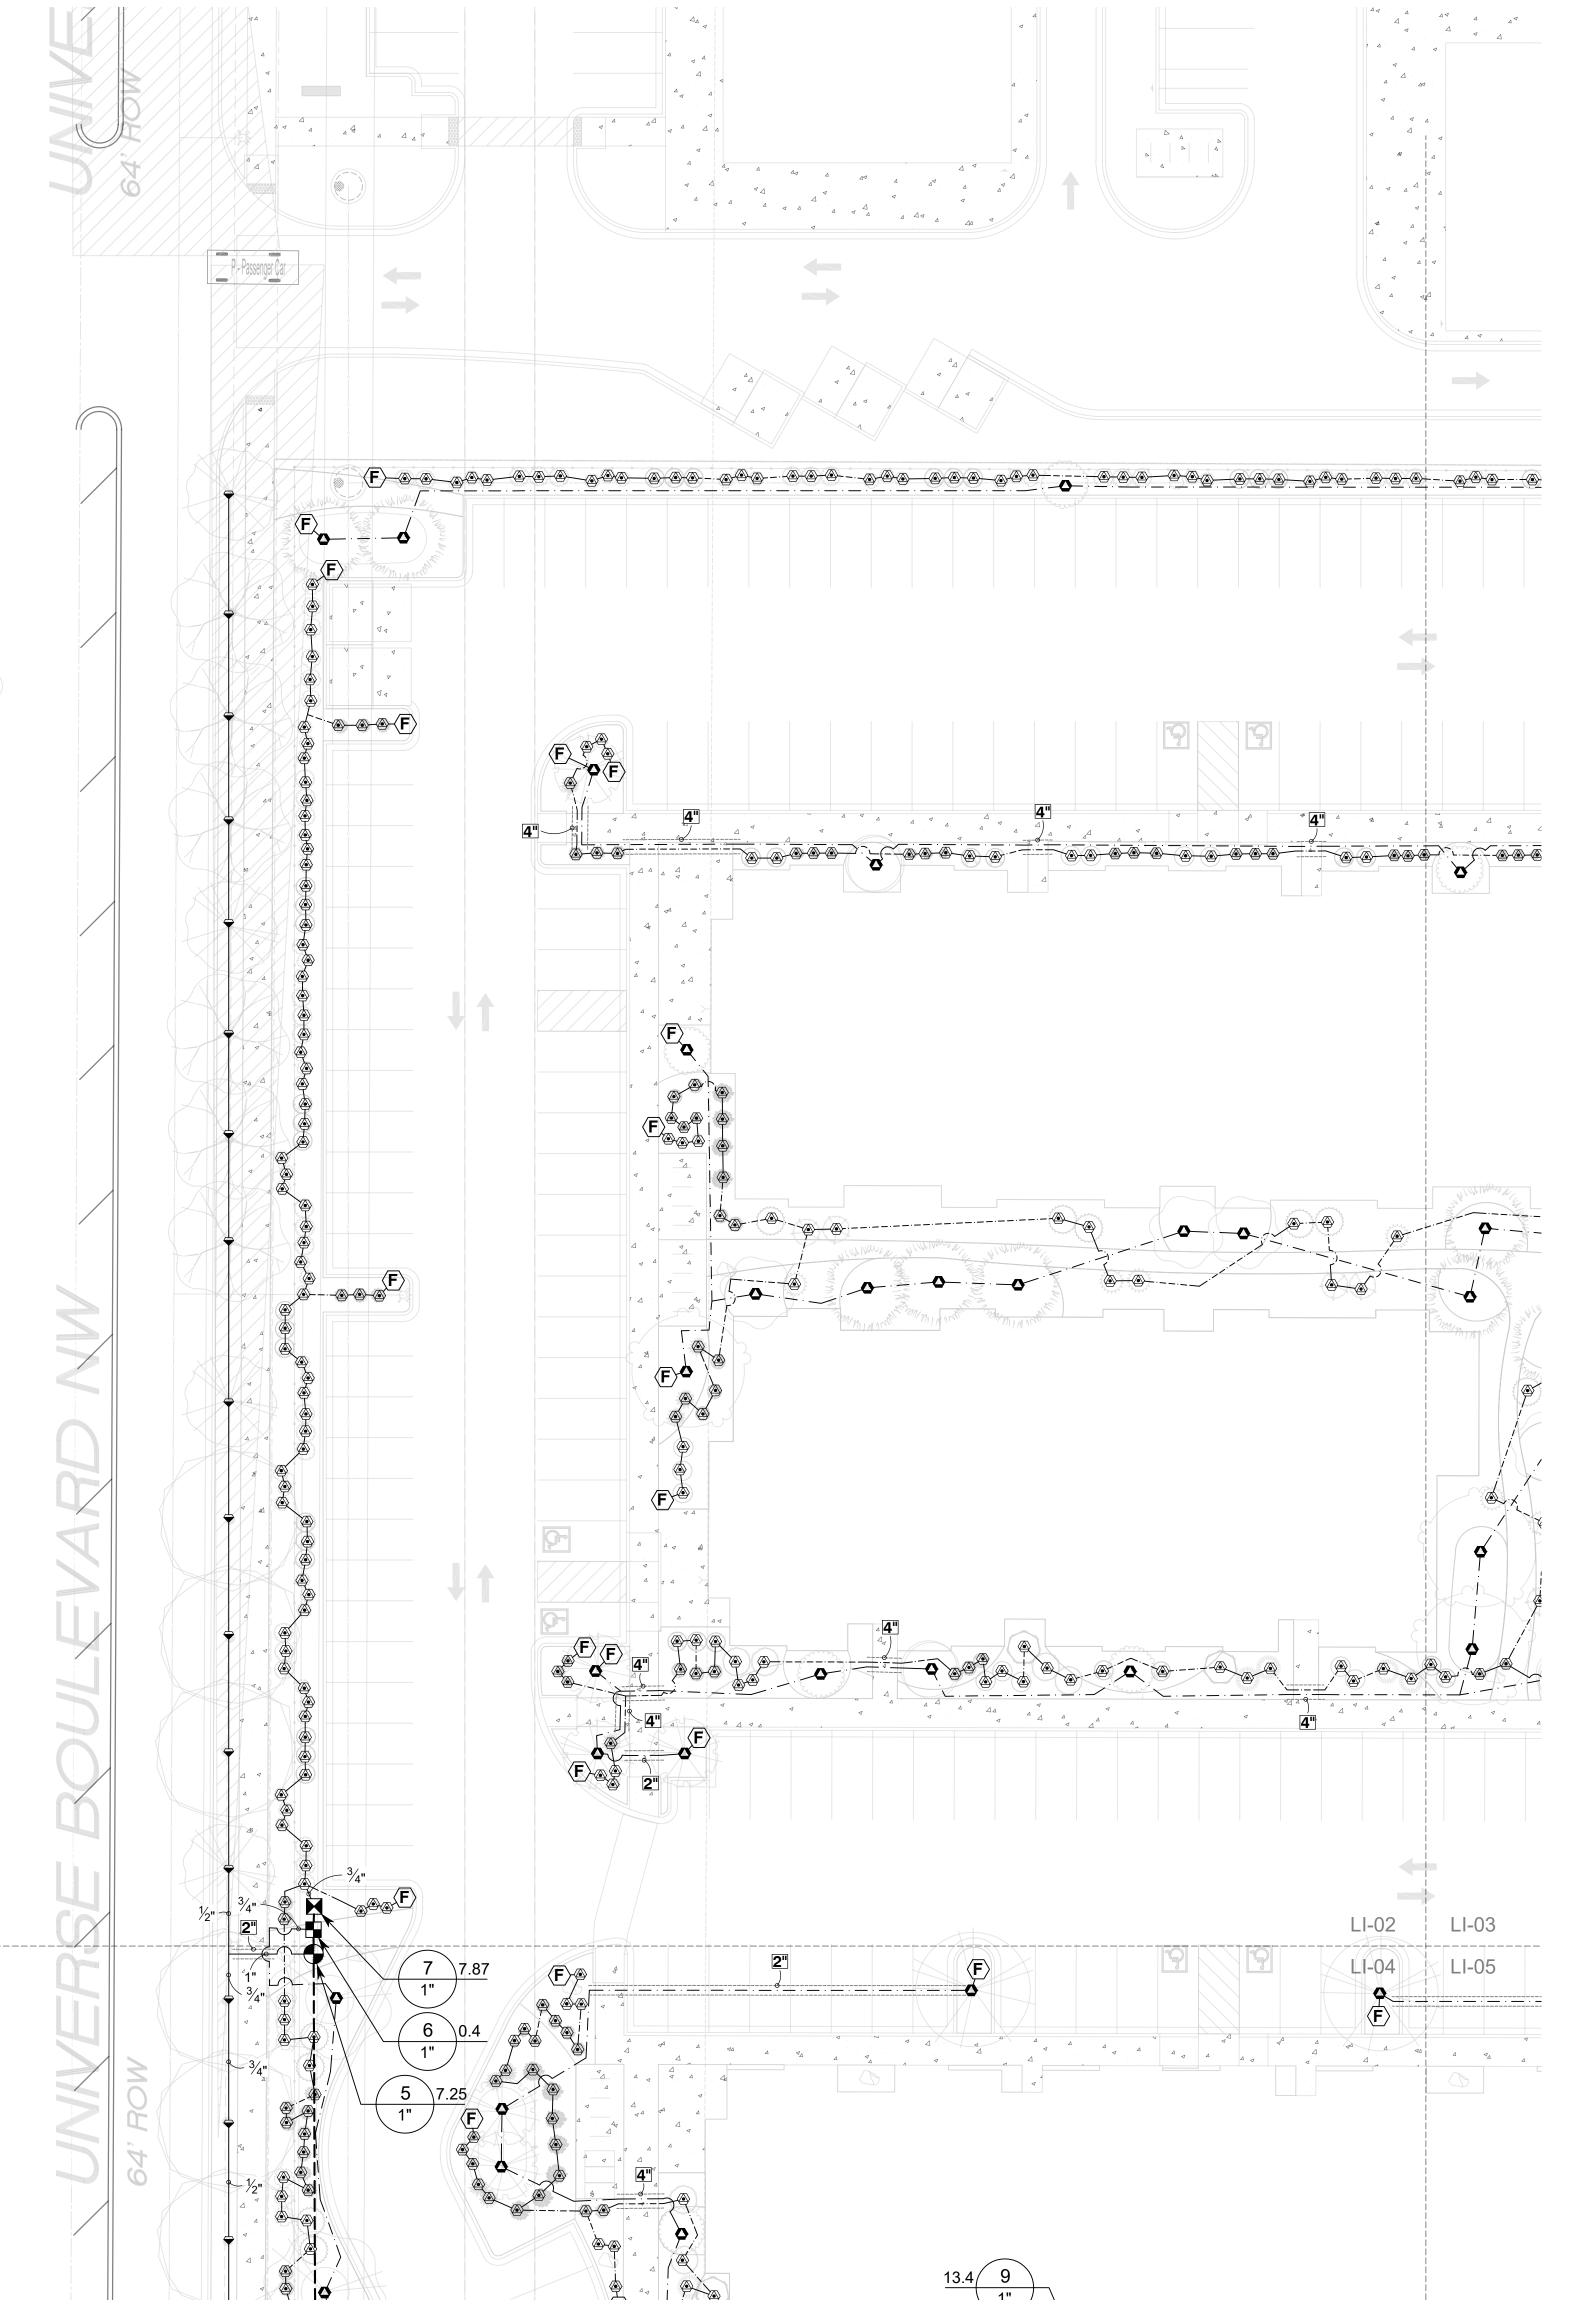
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16. PER 5-6(C)(14)(a), IRRIGATION SYSTEMS SHALL COMPLY WITH SECTION 8 OF THE ABCWUA LEGISLATION AND ORDINANCES (CROSS CONNECTION PREVENTION AND CONTROL ORDINANCE) 17. PER 5-6(C)(14)(b), ALL IRRIGATION SYSTEMS SHALL BE DESIGNED TO MINIMIZE THE USE OF WATER. 18. PER 5-6(C)(14)(c), ALL NON-RESIDENTIAL LANDSCAPE IRRIGATION SHALL HAVE AUTOMATIC TIMERS AND/OR

PROGRAMMABLE SETTINGS TO AVOID OVERWATERING. 19. PER 5-6(C)(14)(d), THE IRRIGATION SYSTEM SHALL NOT SPRAY OR IRRIGATE IMPERVIOUS SURFACES, INCLUDING SIDEWALKS, DRIVEWAYS, DRIVE AISLES, STREETS, AND PARKING AND LOADING AREAS.





- WITH GENERAL CONTRACTOR.
- CLARITY ONLY. OF IRRIGATION SYSTEM.
- SYSTEM.

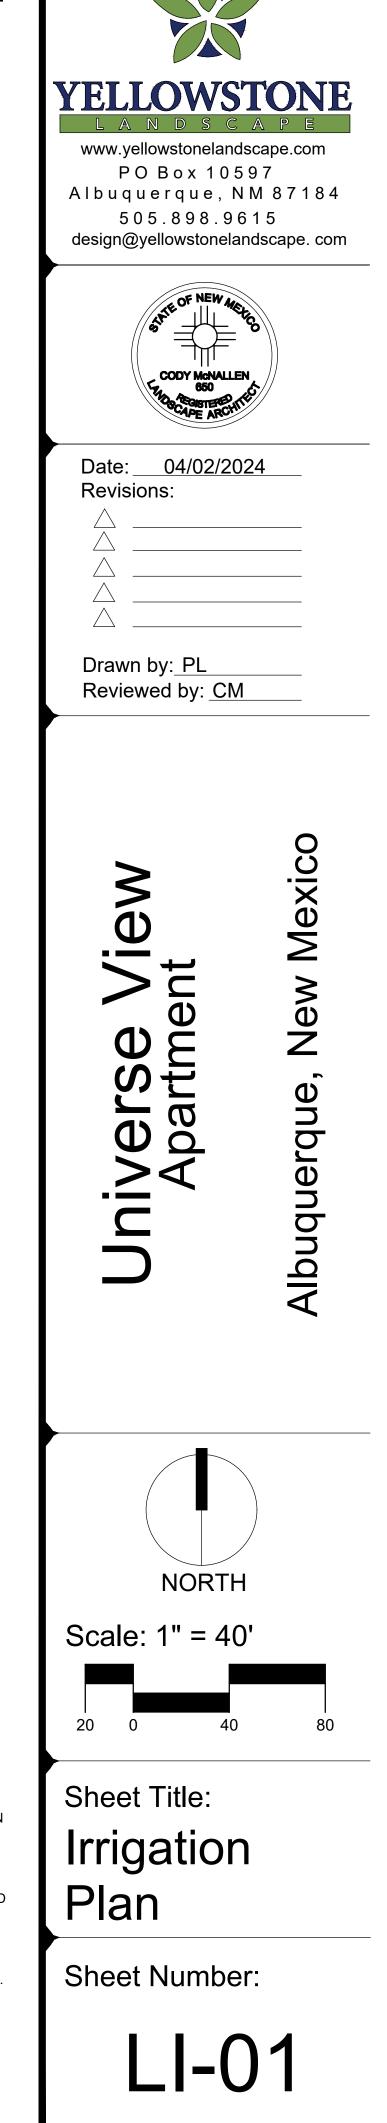- PROGRAMMABLE SETTINGS TO AVOID OVERWATERING.

IRRIGATION SCHEDULE

| | OULEDOLE |
|---|---|
| SYMBOL | MANUFACTURER/MODEL/DESCRIPTION |
| 24 ADJ 24 F | RAIN BIRD R-VAN24 - TURF ROTARY 1804-SAM-P45, 17FT24FT. 45-270 DEGREES AND 360 DEGREES. HAND ADJUSTABLE MULTI-STREAM ROTARY W/1800 TURF SPRAY BODY ON 4IN. POP-UP, WITH CHECK VALVE AND 45 PSI IN-STEM PRESSURE REGULATOR. 1/2IN. NPT FEMALE THREADED INLET. |
| ♥♥♥♥1401140214041408 | RAIN BIRD 1800-1400 FLOOD FIXED FLOW RATE 0.25 GPM - 2.0 GPM, FULL CIRCLE BUBBLER, 1/2IN. FIPT. |
| SYMBOL | MANUFACTURER/MODEL/DESCRIPTION |
| | DRIP CONTROL VALVE - SHRUB RAIN BIRD XCZ-100-PRF, MEDIUM FLOW DRIP CONTROL KIT, 1IN. DV VALVE, 1IN. PRESSURE REGULATING FILTER, 40PSI PRESSURE REGULATOR. 5 GPM-20 GPM. |
| | DRIP CONTROL VALVE - TREE RAIN BIRD XCZ-100-PRF. MEDIUM FLOW DRIP CONTROL KIT, 1IN. DV VALVE, 1IN. PRESSURE REGULATING FILTER, 40PSI PRESSURE REGULATOR. 3 GPM-15 GPM. |
| ۲ | TRANSITION FITTING PIPE TRANSITION POINT FROM PVC LATERAL TO DRIP TUBING WITH RISER IN 6IN. DRIP BOX. |
| $\langle \mathbf{F} \rangle$ | FLUSH CAP NDS CEP900 |
| | DRIP EMITTER - SHRUB (2) NDS TAE 20 DRIP EMITTERS |
| ٥ | DRIP EMITTER - TREE (6) NDS TAE 20 DRIP EMITTERS |
| SYMBOL | MANUFACTURER/MODEL/DESCRIPTION |
| G | CONTROL VALVE RAIN BIRD PEB. 1IN., 1-1/2IN., 2IN. PLASTIC INDUSTRIAL VALVES. LOW FLOW OPERATING CAPABILITY, GLOBE CONFIGURATION. |
| \mathbf{M} | MAIN SHUT OFF VALVE SPEARS SCH80 PVC COMPACT BALL VALVE |
| | MASTER VALVE 1" RAIN BIRD PEB. 1IN., 1-1/2IN., 2IN. PLASTIC INDUSTRIAL MASTER VALVES. LOW FLOW OPERATING CAPABILITY, GLOBE CONFIGURATION. |
| BF | REDUCED PRESSURE BACKFLOW PREVENTER 1" FEBCO 825Y |
| С | CONTROLLER - RAIN BIRD ESP-LXD 50-200 STATION, 2-WIRE DECODER BASED CONTROLLER. (1) ESP-LXD 50-STATION, INDOOR/OUTDOOR, PLASTIC WALL-MOUNT ENCLOSURE. SYSTEM REQUIREMENTS: RAIN BIRD FD-XXX-TURF FIELD DECODERS, PAIGE ELECTRIC CABLE P7072D & RAIN BIRD WC20 DRY SPLICES ONLY. GROUND SYSTEM W/ (X) LSP-1TURF LINE SURGE PROTECTORS IN RAIN BIRD ROUND VALVE BOXES. INSTALL PER MANUFACTURERS RECOMMENDATIONS. |
| MV POC | FLOW SENSOR CREATIVE SENSOR TECHNOLOGY FSI-T10-001 1IN. PVC TEE TYPE FLOW SENSOR W/SOCKET ENDS, CUSTOM MOUNTING TEE AND ULTRA-LIGHTWEIGHT IMPELLER ENHANCES LOW FLOW MEASUREMENT. 2 WIRE DIGITAL OUTPUT COMPATIBLE W/ALL IRRIGATION CONTROLLERS. FLOW RANGE: .86 GPM - 52 GPM. POINT OF CONNECTION 1 1/2" |
| `L` | IRRIGATION LATERAL LINE: PVC SCHEDULE 40 |
| | IRRIGATION LATERAL LINE: A940 DRIP POLYLINE |
| | IRRIGATION LATERAL LINE: A940RDS DRIP POLYLINE |
| | IRRIGATION MAINLINE: PVC SCHEDULE 40 |
| | PIPE SLEEVE: PVC CLASS 200 SDR 21 |
| N | /alve Callout |
| # • # • | Valve Number Valve Flow |
| #"• | Valve Size |
| | |

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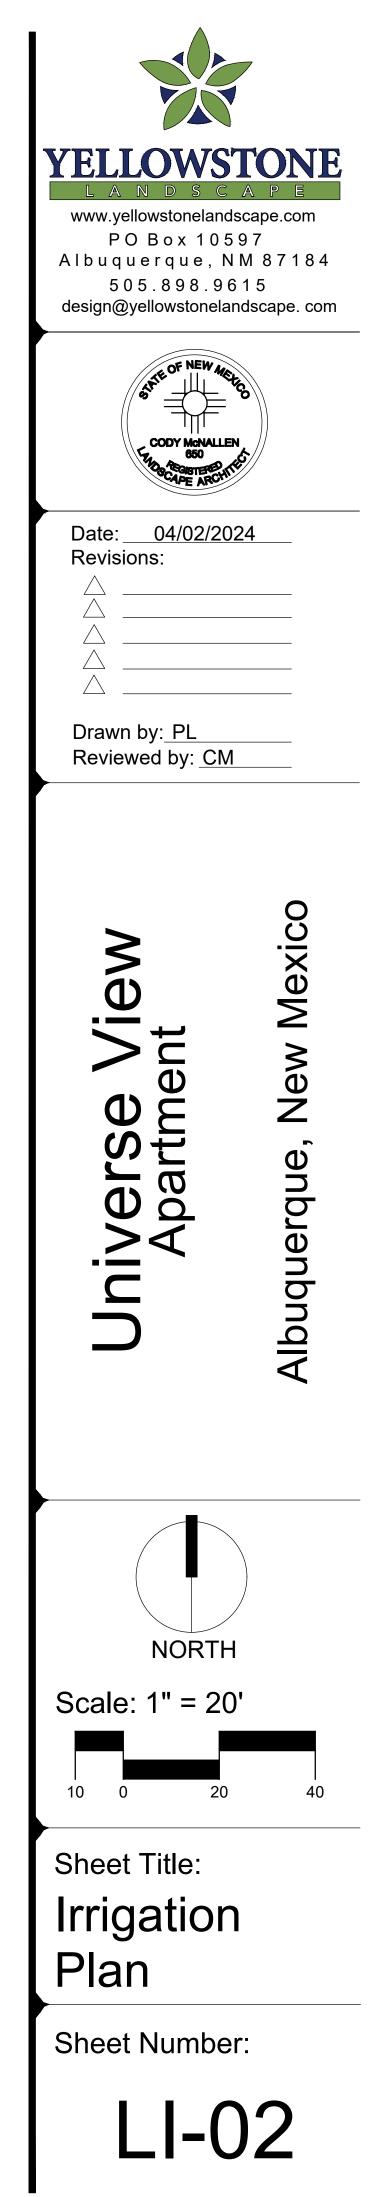
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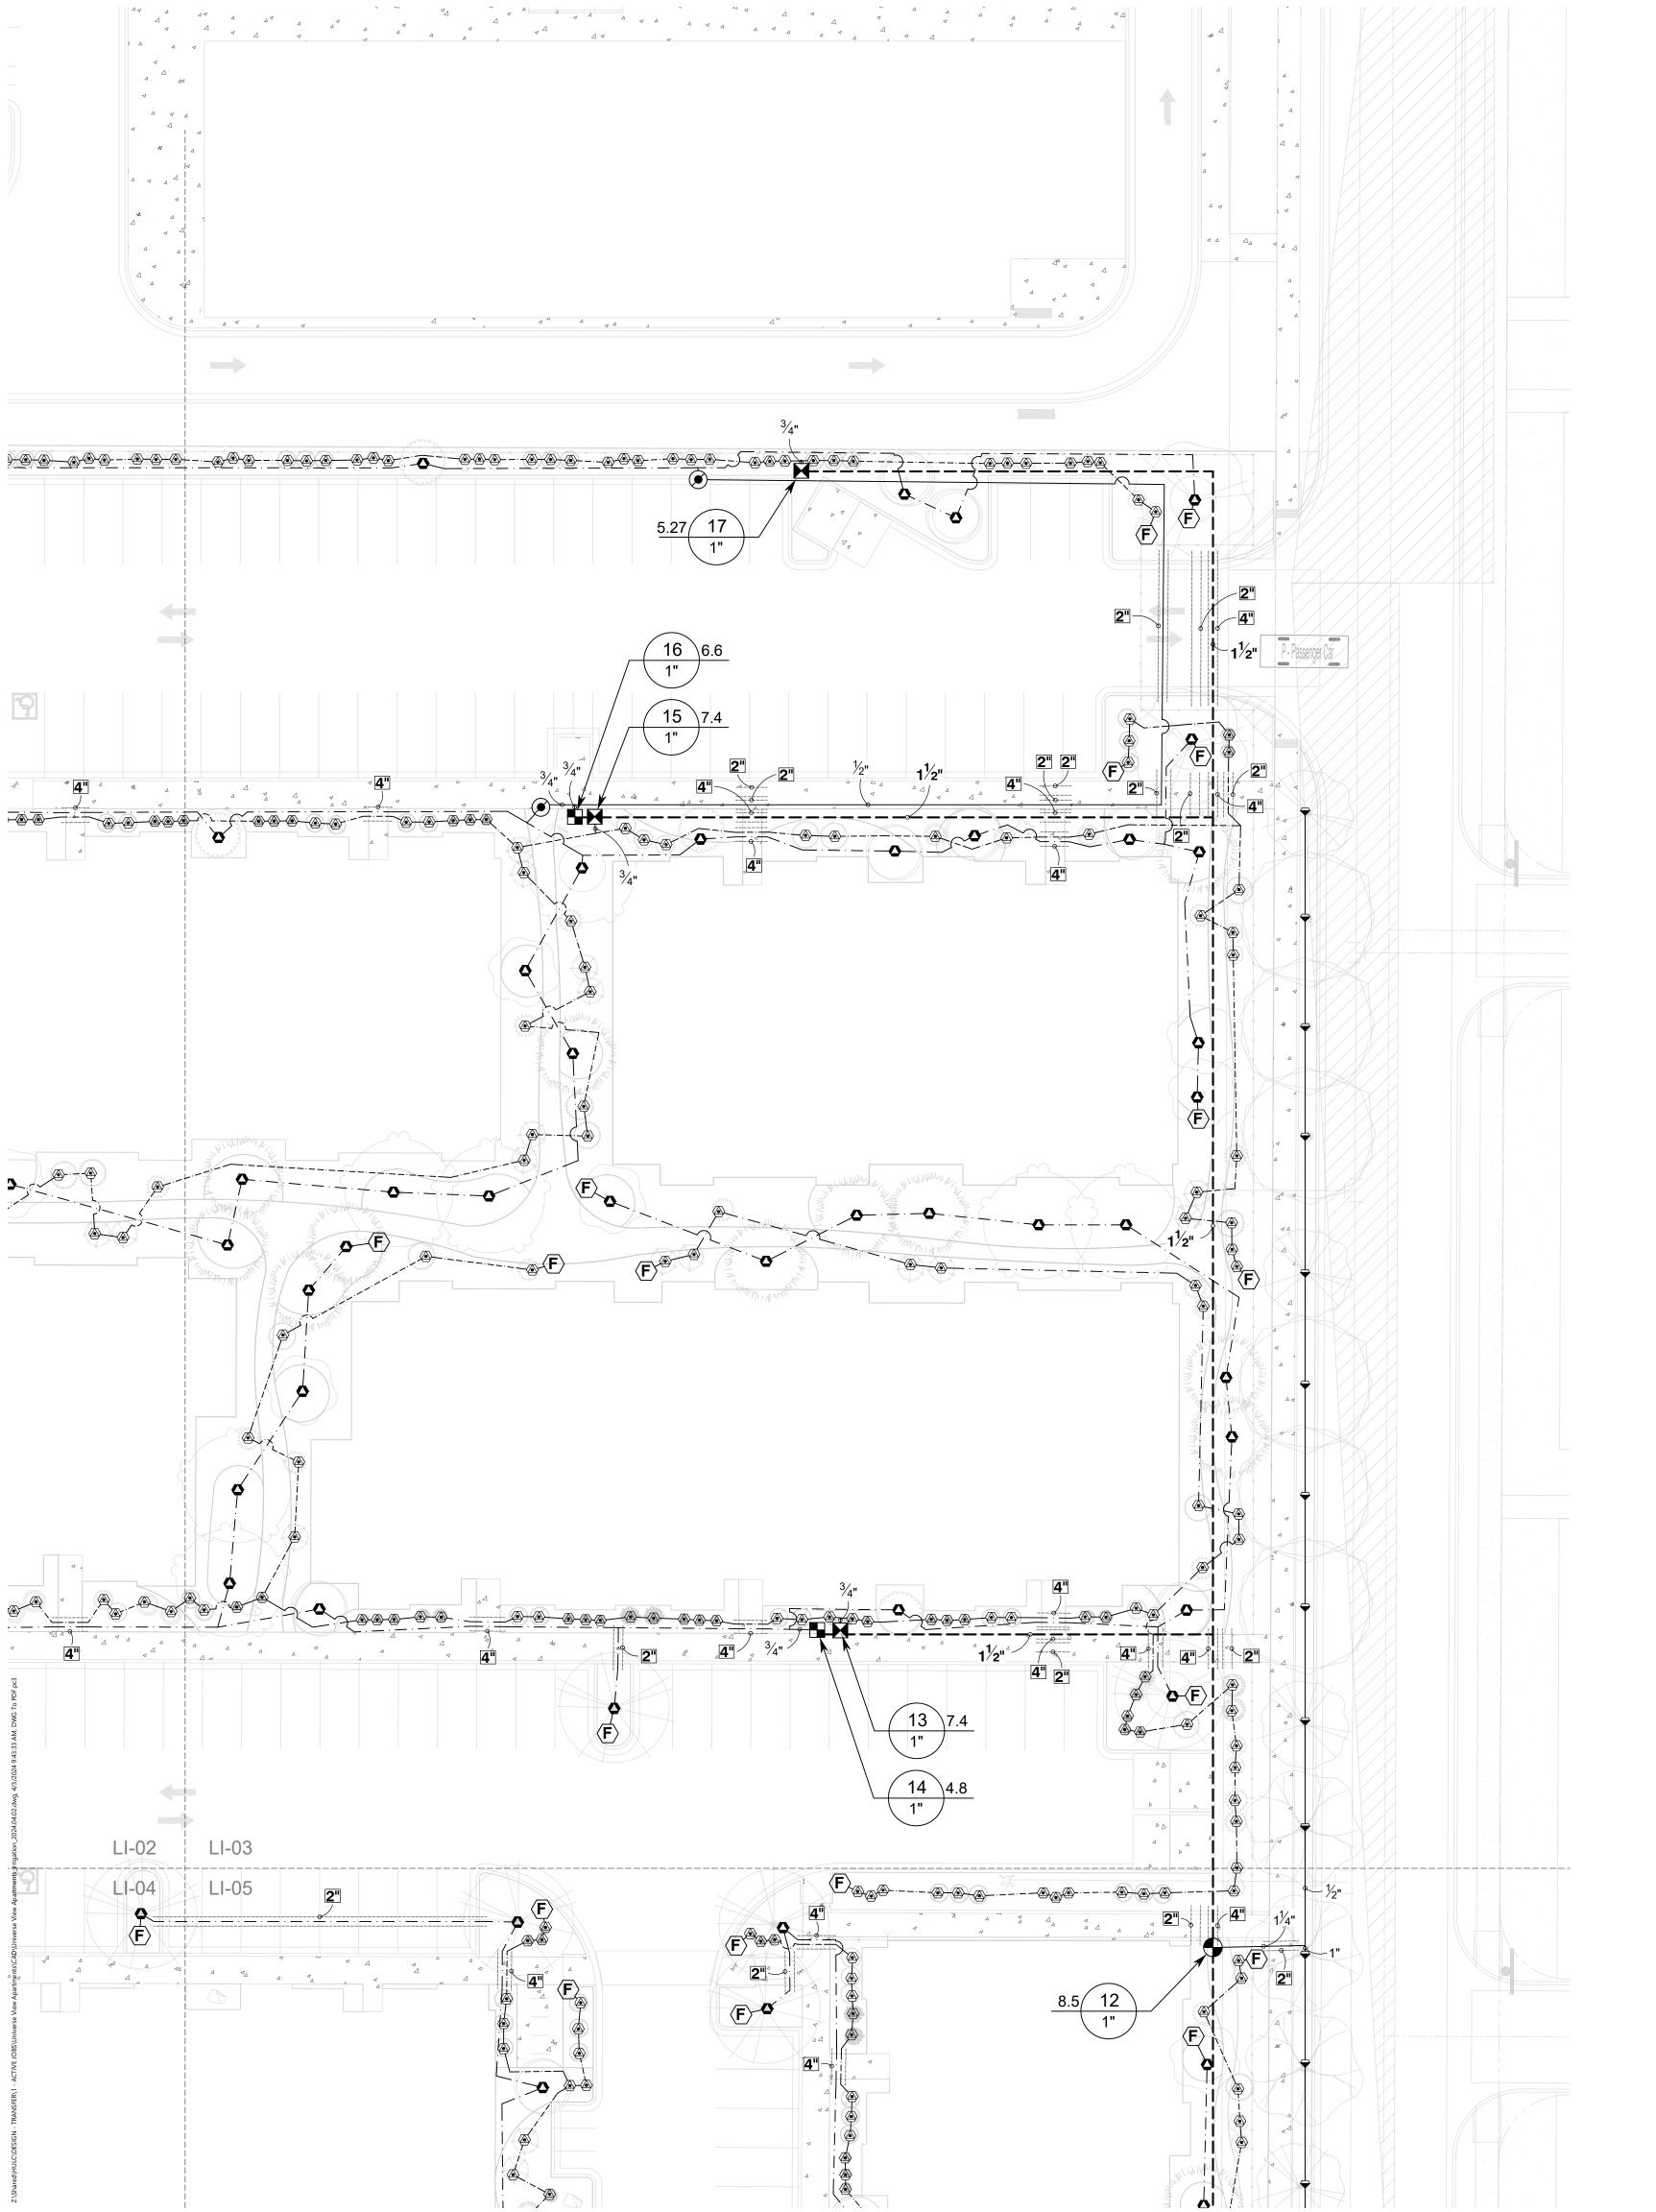
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IRRIGATION NOTES

- WITH GENERAL CONTRACTOR.
- CLARITY ONLY.
- OF IRRIGATION SYSTEM.
- SYSTEM.
- WITHIN THE PROPERTY LINE.

IRRIGATION SCHEDULE

| | OULEDOLE |
|---|---|
| SYMBOL | MANUFACTURER/MODEL/DESCRIPTION |
| 24 ADJ 24 F | RAIN BIRD R-VAN24 - TURF ROTARY 1804-SAM-P45, 17FT24FT. 45-270 DEGREES AND 360 DEGREES. HAND ADJUSTABLE MULTI-STREAM ROTARY W/1800 TURF SPRAY BODY ON 4IN. POP-UP, WITH CHECK VALVE AND 45 PSI IN-STEM PRESSURE REGULATOR. 1/2IN. NPT FEMALE THREADED INLET. |
| ♥♥♥♥1401140214041408 | RAIN BIRD 1800-1400 FLOOD FIXED FLOW RATE 0.25 GPM - 2.0 GPM, FULL CIRCLE BUBBLER, 1/2IN. FIPT. |
| SYMBOL | MANUFACTURER/MODEL/DESCRIPTION |
| | DRIP CONTROL VALVE - SHRUB RAIN BIRD XCZ-100-PRF, MEDIUM FLOW DRIP CONTROL KIT, 1IN. DV VALVE, 1IN. PRESSURE REGULATING FILTER, 40PSI PRESSURE REGULATOR. 5 GPM-20 GPM. |
| | DRIP CONTROL VALVE - TREE RAIN BIRD XCZ-100-PRF. MEDIUM FLOW DRIP CONTROL KIT, 1IN. DV VALVE, 1IN. PRESSURE REGULATING FILTER, 40PSI PRESSURE REGULATOR. 3 GPM-15 GPM. |
| ۲ | TRANSITION FITTING PIPE TRANSITION POINT FROM PVC LATERAL TO DRIP TUBING WITH RISER IN 6IN. DRIP BOX. |
| $\langle \mathbf{F} \rangle$ | FLUSH CAP NDS CEP900 |
| | DRIP EMITTER - SHRUB (2) NDS TAE 20 DRIP EMITTERS |
| ٥ | DRIP EMITTER - TREE (6) NDS TAE 20 DRIP EMITTERS |
| SYMBOL | MANUFACTURER/MODEL/DESCRIPTION |
| G | CONTROL VALVE RAIN BIRD PEB. 1IN., 1-1/2IN., 2IN. PLASTIC INDUSTRIAL VALVES. LOW FLOW OPERATING CAPABILITY, GLOBE CONFIGURATION. |
| \mathbf{M} | MAIN SHUT OFF VALVE SPEARS SCH80 PVC COMPACT BALL VALVE |
| | MASTER VALVE 1" RAIN BIRD PEB. 1IN., 1-1/2IN., 2IN. PLASTIC INDUSTRIAL MASTER VALVES. LOW FLOW OPERATING CAPABILITY, GLOBE CONFIGURATION. |
| BF | REDUCED PRESSURE BACKFLOW PREVENTER 1" FEBCO 825Y |
| С | CONTROLLER - RAIN BIRD ESP-LXD 50-200 STATION, 2-WIRE DECODER BASED CONTROLLER. (1) ESP-LXD 50-STATION, INDOOR/OUTDOOR, PLASTIC WALL-MOUNT ENCLOSURE. SYSTEM REQUIREMENTS: RAIN BIRD FD-XXX-TURF FIELD DECODERS, PAIGE ELECTRIC CABLE P7072D & RAIN BIRD WC20 DRY SPLICES ONLY. GROUND SYSTEM W/ (X) LSP-1TURF LINE SURGE PROTECTORS IN RAIN BIRD ROUND VALVE BOXES. INSTALL PER MANUFACTURERS RECOMMENDATIONS. |
| MV POC | FLOW SENSOR CREATIVE SENSOR TECHNOLOGY FSI-T10-001 1IN. PVC TEE TYPE FLOW SENSOR W/SOCKET ENDS, CUSTOM MOUNTING TEE AND ULTRA-LIGHTWEIGHT IMPELLER ENHANCES LOW FLOW MEASUREMENT. 2 WIRE DIGITAL OUTPUT COMPATIBLE W/ALL IRRIGATION CONTROLLERS. FLOW RANGE: .86 GPM - 52 GPM. POINT OF CONNECTION 1 1/2" |
| `L` | IRRIGATION LATERAL LINE: PVC SCHEDULE 40 |
| | IRRIGATION LATERAL LINE: A940 DRIP POLYLINE |
| | IRRIGATION LATERAL LINE: A940RDS DRIP POLYLINE |
| | IRRIGATION MAINLINE: PVC SCHEDULE 40 |
| | PIPE SLEEVE: PVC CLASS 200 SDR 21 |
| N | /alve Callout |
| # • # • | Valve Number Valve Flow |
| #"• | Valve Size |
| | |

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THE LANDSCAPE ARCHITECT BEFORE CONSTRUCTION OF THE IRRIGATION SYSTEM BEGINS. 3. LANDSCAPE INSTALLER SHALL PERFORM PRESSURE/GPM TEST AT POINT OF CONNECTION BEFORE INSTALLING IRRIGATION SYSTEM TO VERIFY PSI AND GPM FOR THE SITE.

4. IRRIGATION SYSTEM HAS BEEN DESIGNED TO A MINIMUM DYNAMIC PRESSURE OF 75 PSI AT 50 GPM. IF THE PSI/GPM ARE LOWER THAN 75/50 THE LANDSCAPE ARCHITECT MUST BE NOTIFIED IMMEDIATELY. 5. THE CONTRACTOR SHALL FIELD VERIFY UTILITY LOCATIONS AND MAKE ANY NECESSARY FIELD ADJUSTMENTS

6. THE LOCATION OF IRRIGATION EQUIPMENT IS APPROXIMATE AND SHALL BE LOCATED IN THE LANDSCAPE AREAS. ANY IRRIGATION EQUIPMENT AND PIPING SHOWN OUTSIDE OF LANDSCAPE AREAS ARE FOR GRAPHIC

7. THE LANDSCAPE CONTRACTOR SHALL PROVIDE TO OWNER AN ACCURATE AS-BUILT IRRIGATION PLAN WHEN THE WORK IS COMPLETED. AS-BUILT DOCUMENTS SHOULD BE UPDATED WEEKLY FOR ACCURATE RECORDING

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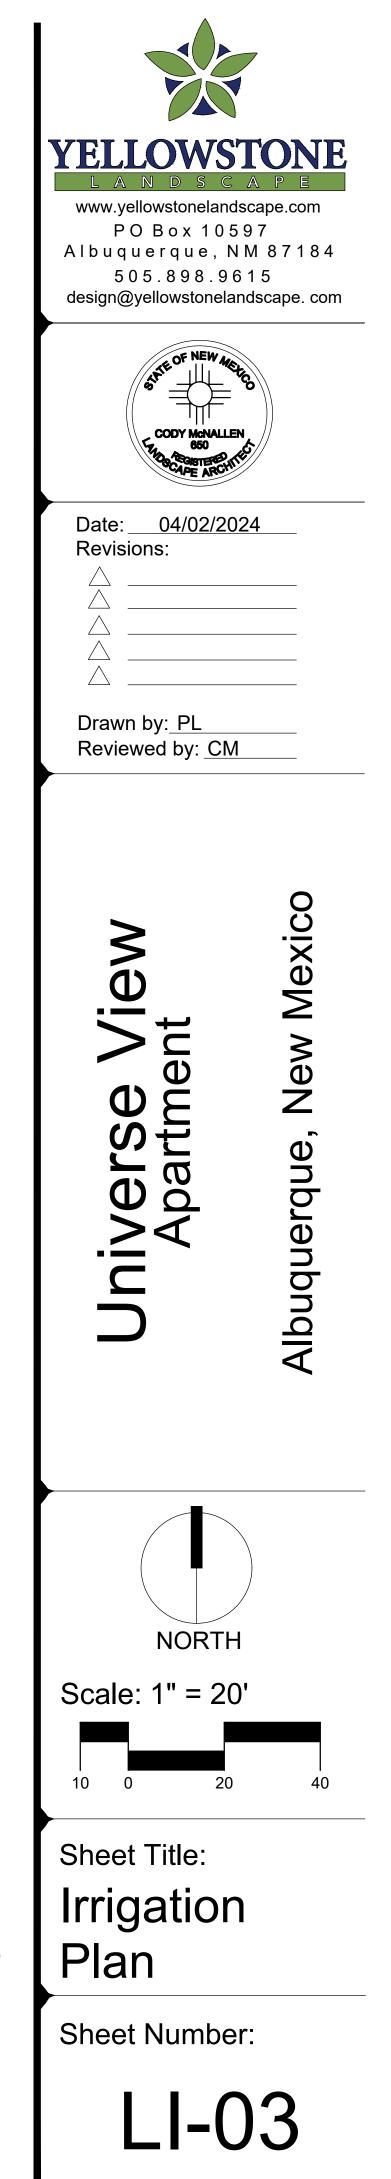
9. ALL PLANTS WITHIN THE PROPERTY LINE SHALL BE IRRIGATED BY LOW FLOW POINT-SOURCE DRIP IRRIGATION 10. ALL PLANTS WITHIN PUBLIC RIGHT-OF-WAY SHALL BE IRRIGATED BY BUBBLER IRRIGATION SYSTEM PER COA


SPEC. ALL PLANTS WITHIN THE PUBLIC RIGHT-OF-WAY SHALL BE ZONED SEPARATELY FROM THE PLANTS 11. POWER FOR IRRIGATION SYSTEM TO BE PROVIDED BY THE GENERAL CONTRACTOR. 110V POWER IS REQUIRED

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- WITH GENERAL CONTRACTOR.
- CLARITY ONLY.
- OF IRRIGATION SYSTEM.
- SYSTEM.
- WITHIN THE PROPERTY LINE.

IRRIGATION SCHEDULE

| | OONEDOLL |
|---------------------------------------|---|
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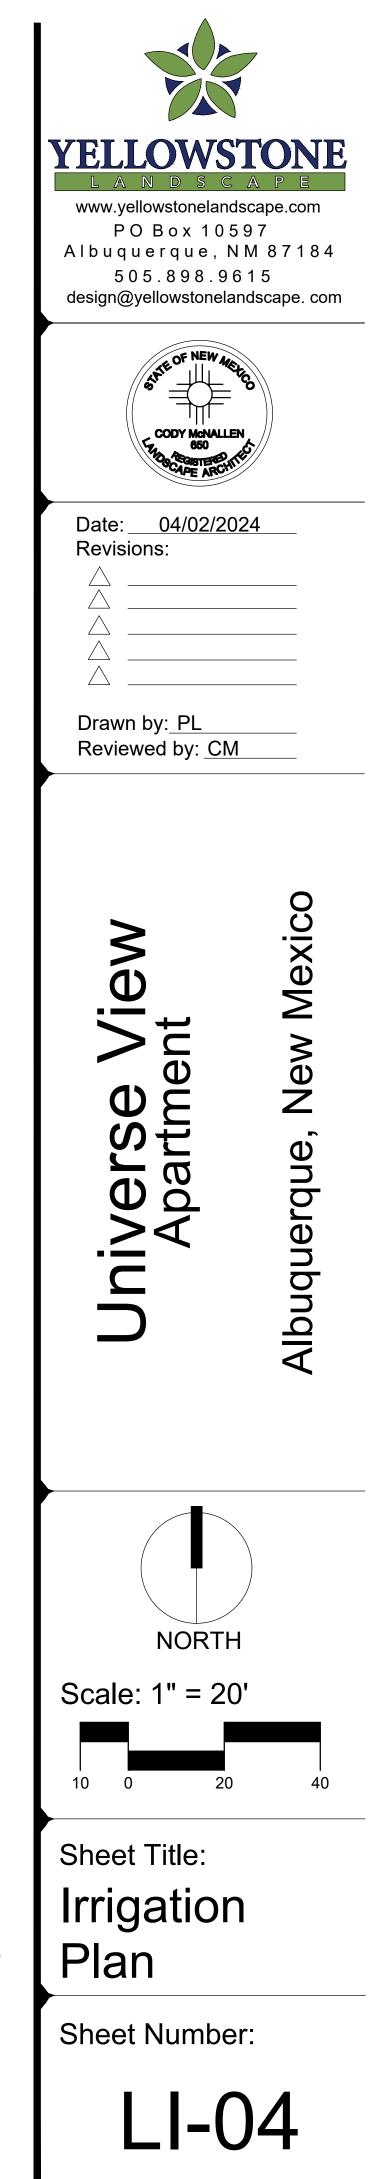
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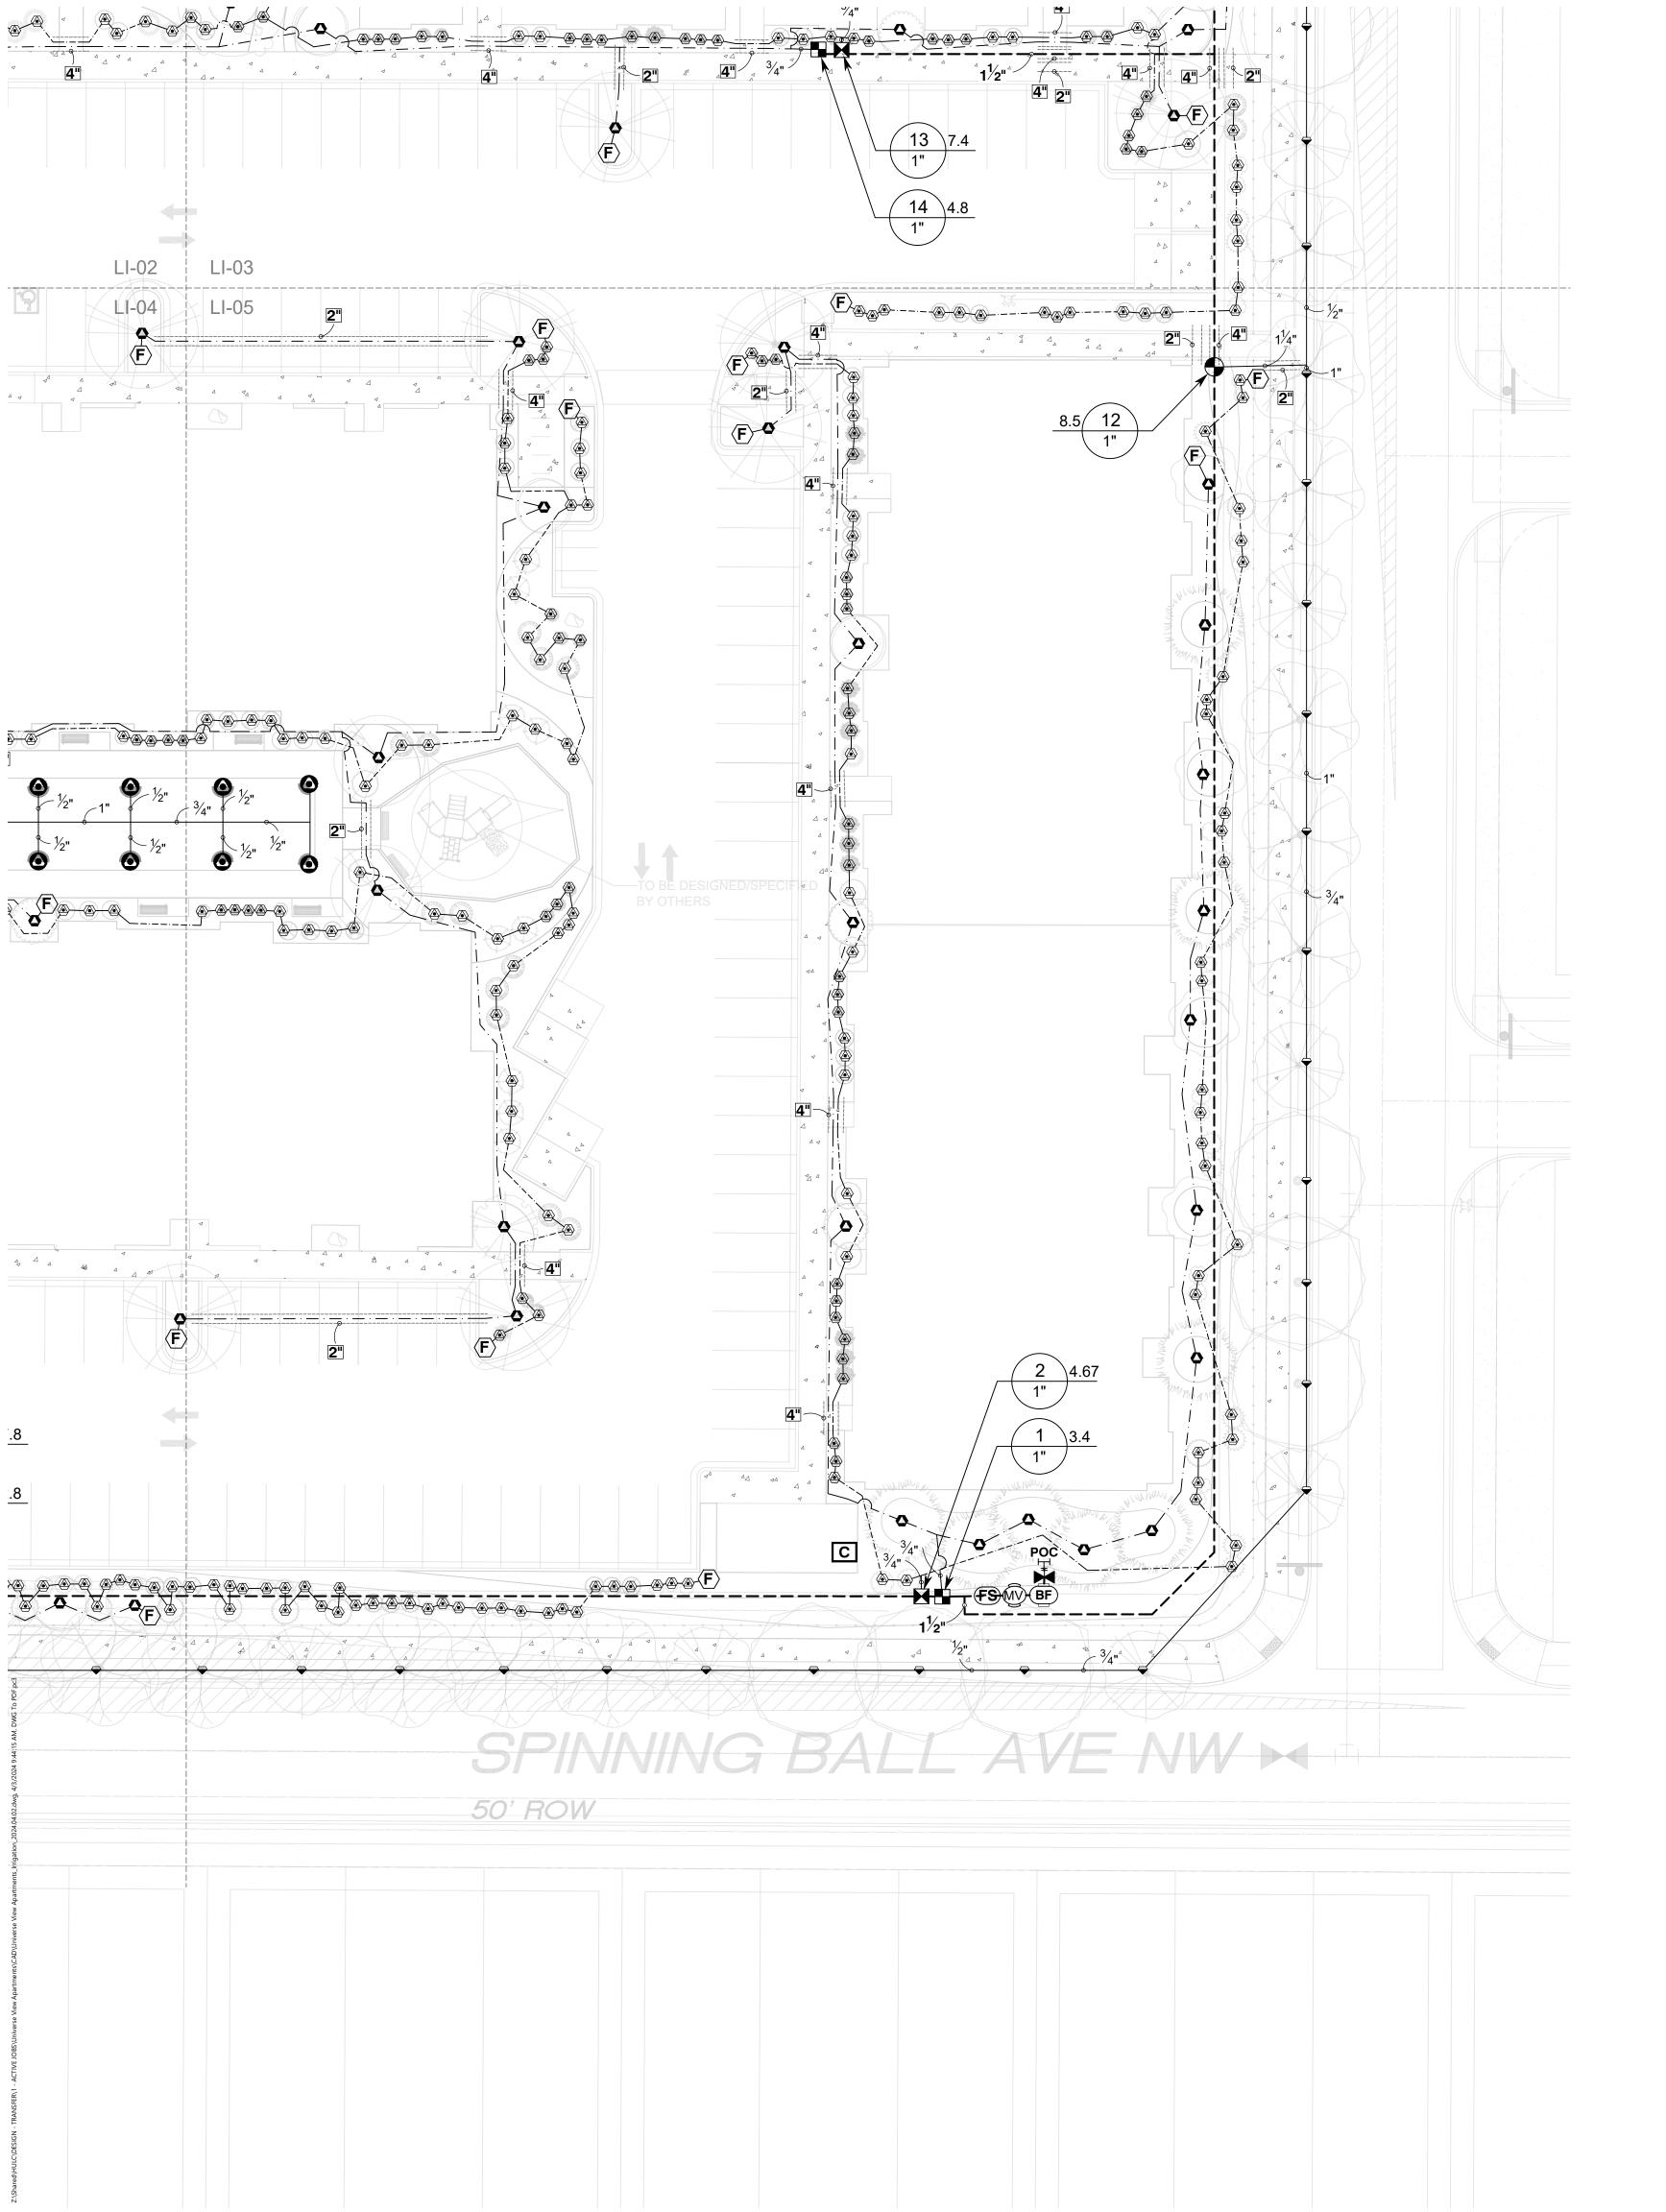
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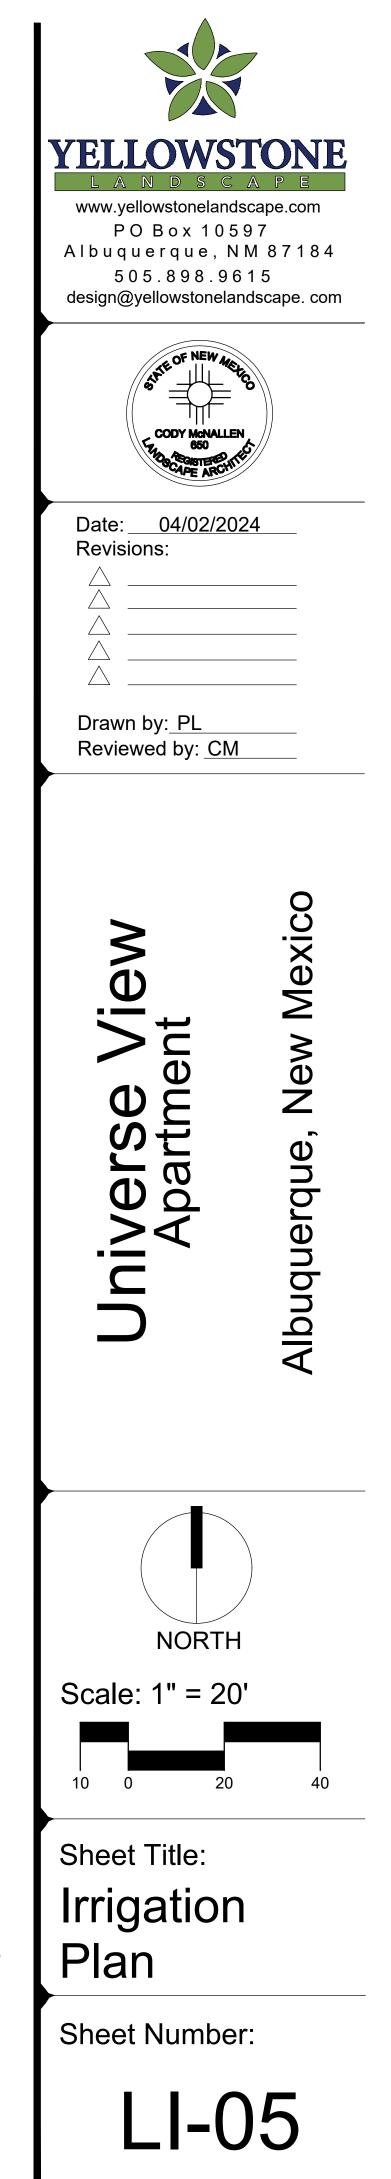
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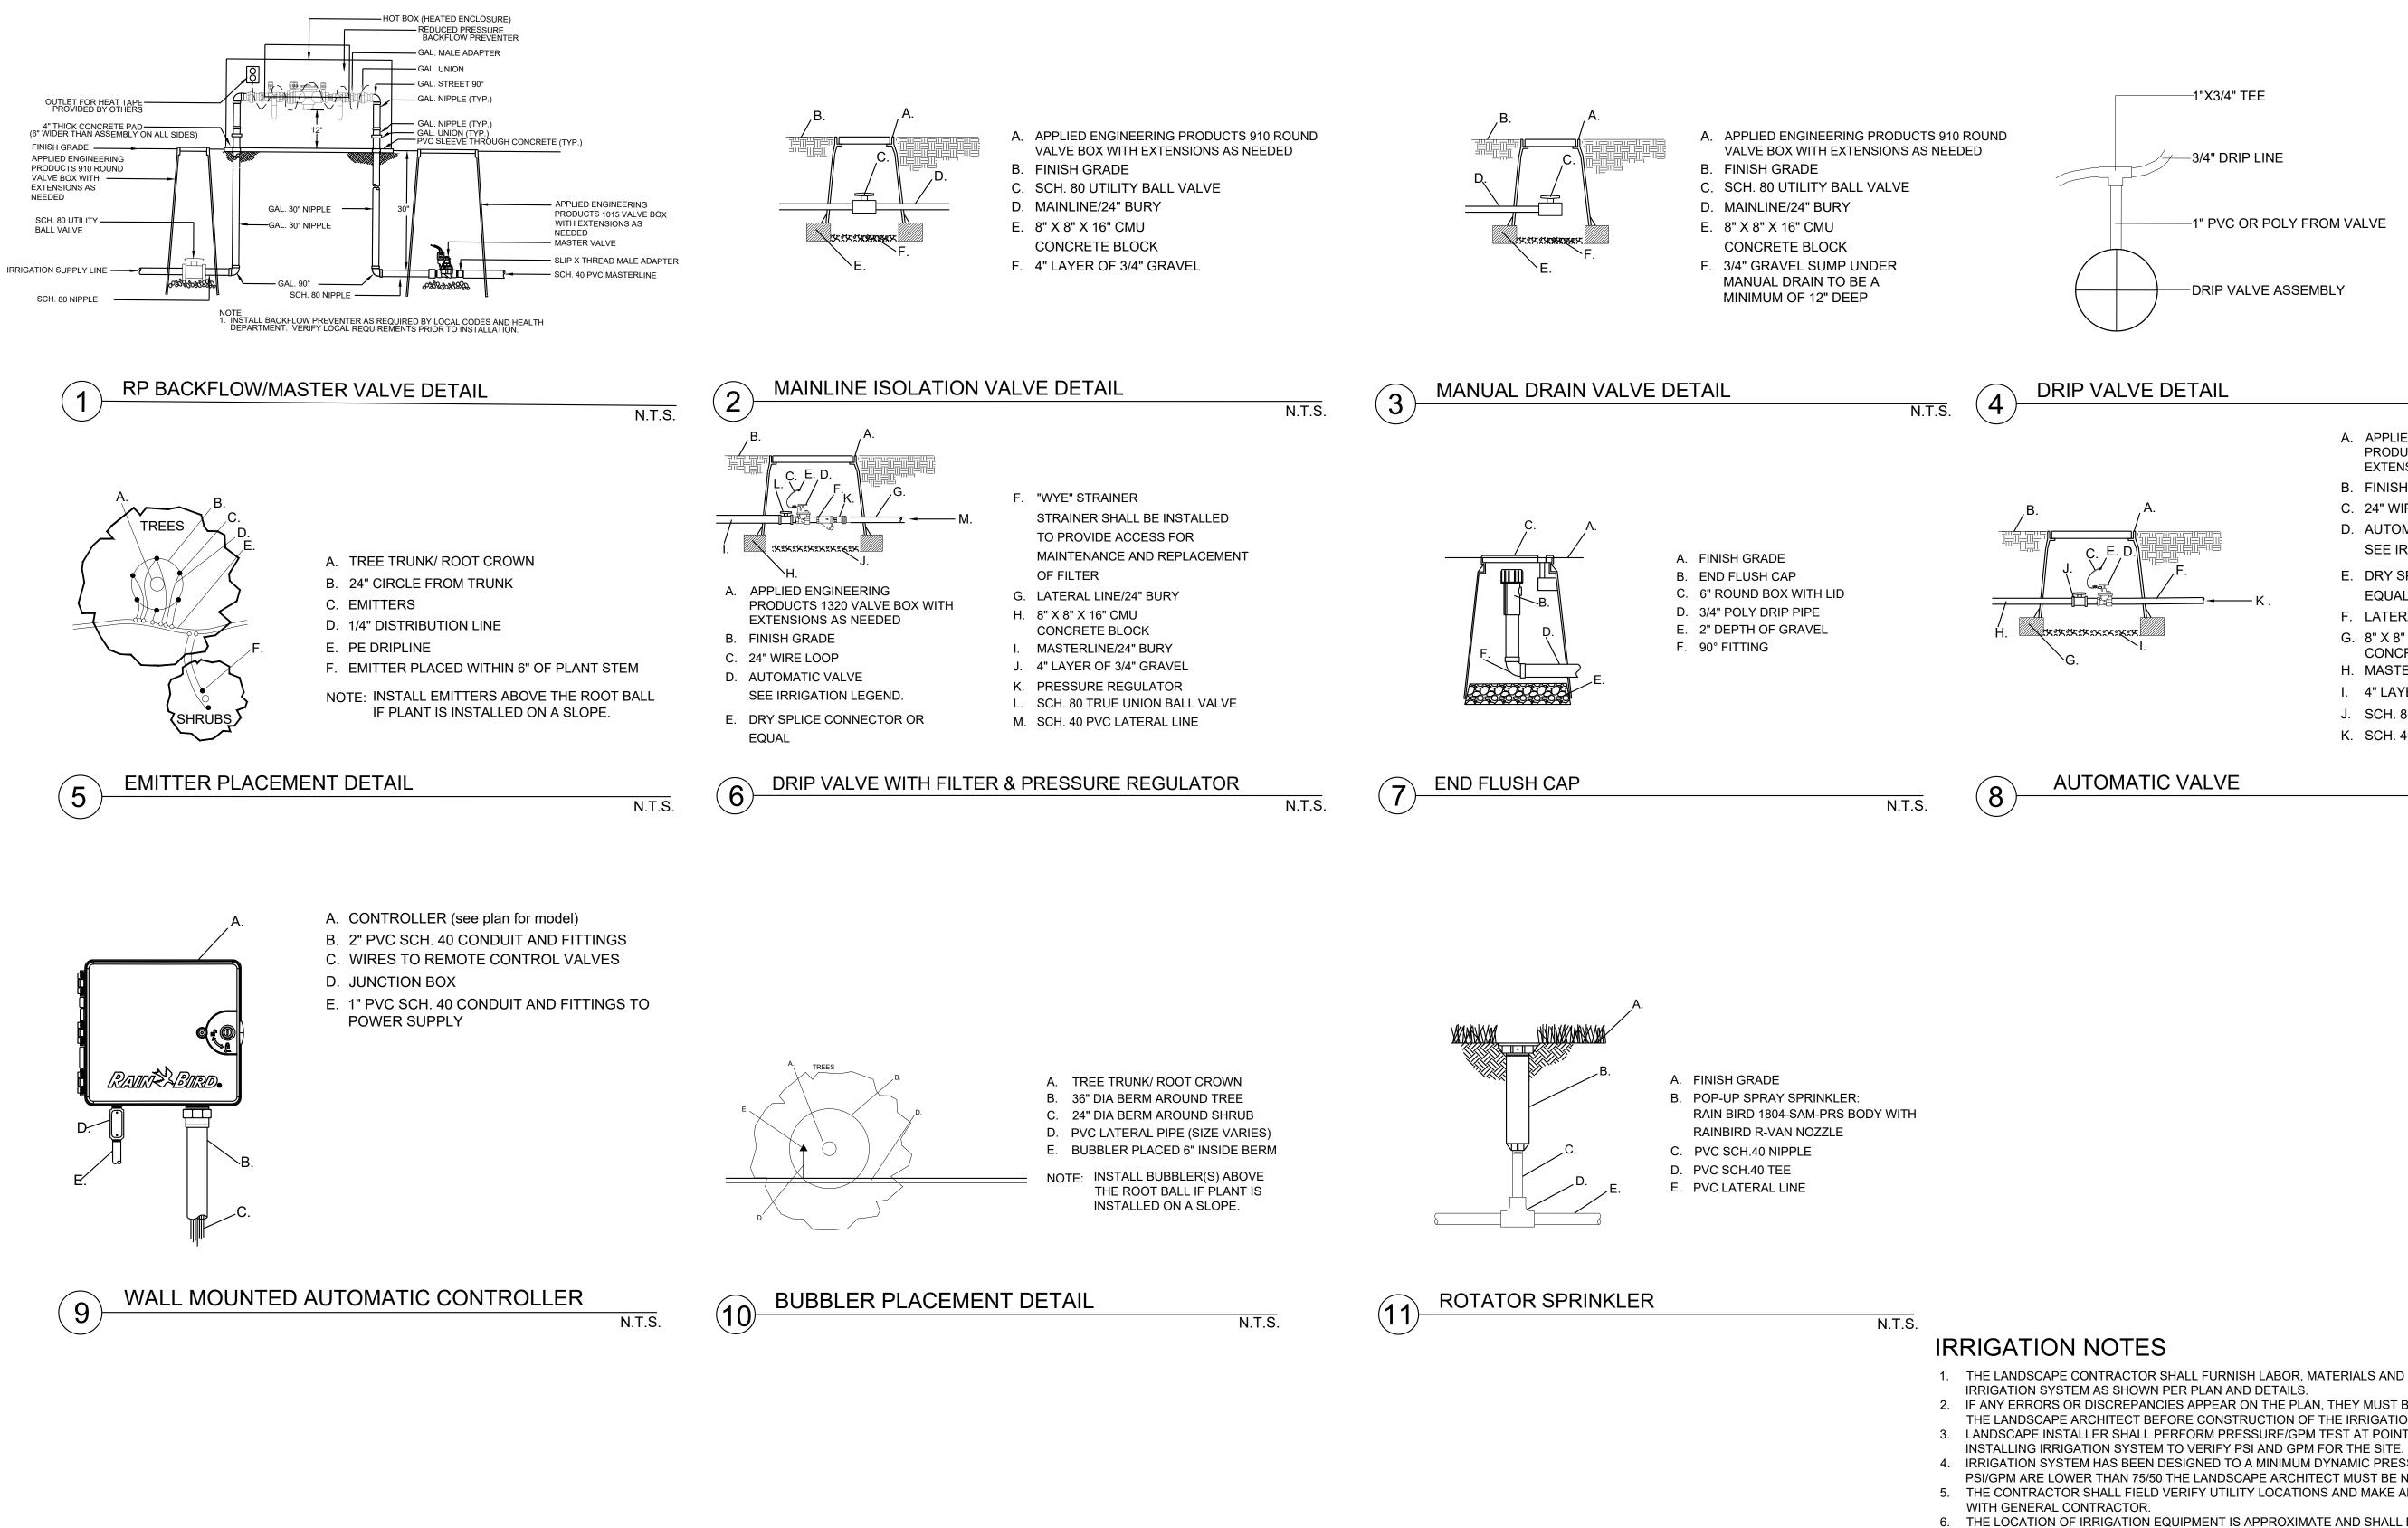
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- A. APPLIED ENGINEERING
- PRODUCTS 1320 VALVE BOX WITH EXTENSIONS AS NEEDED
- B. FINISH GRADE
- C. 24" WIRE LOOP D. AUTOMATIC VALVE-
- SEE IRRIGATION LEGEND.
- E. DRY SPLICE CONNECTOR OR EQUAL
- F. LATERAL LINE/24" BURY
- G. 8" X 8" X 16" CMU
- CONCRETE BLOCK H. MASTERLINE/24" BURY
- I. 4" LAYER OF 3/4" GRAVEL
- J. SCH. 80 TRUE UNION BALL VALVE
- K. SCH. 40 PVC LATERAL LINE


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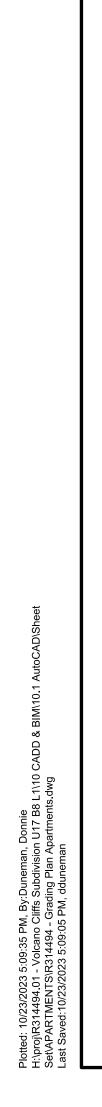
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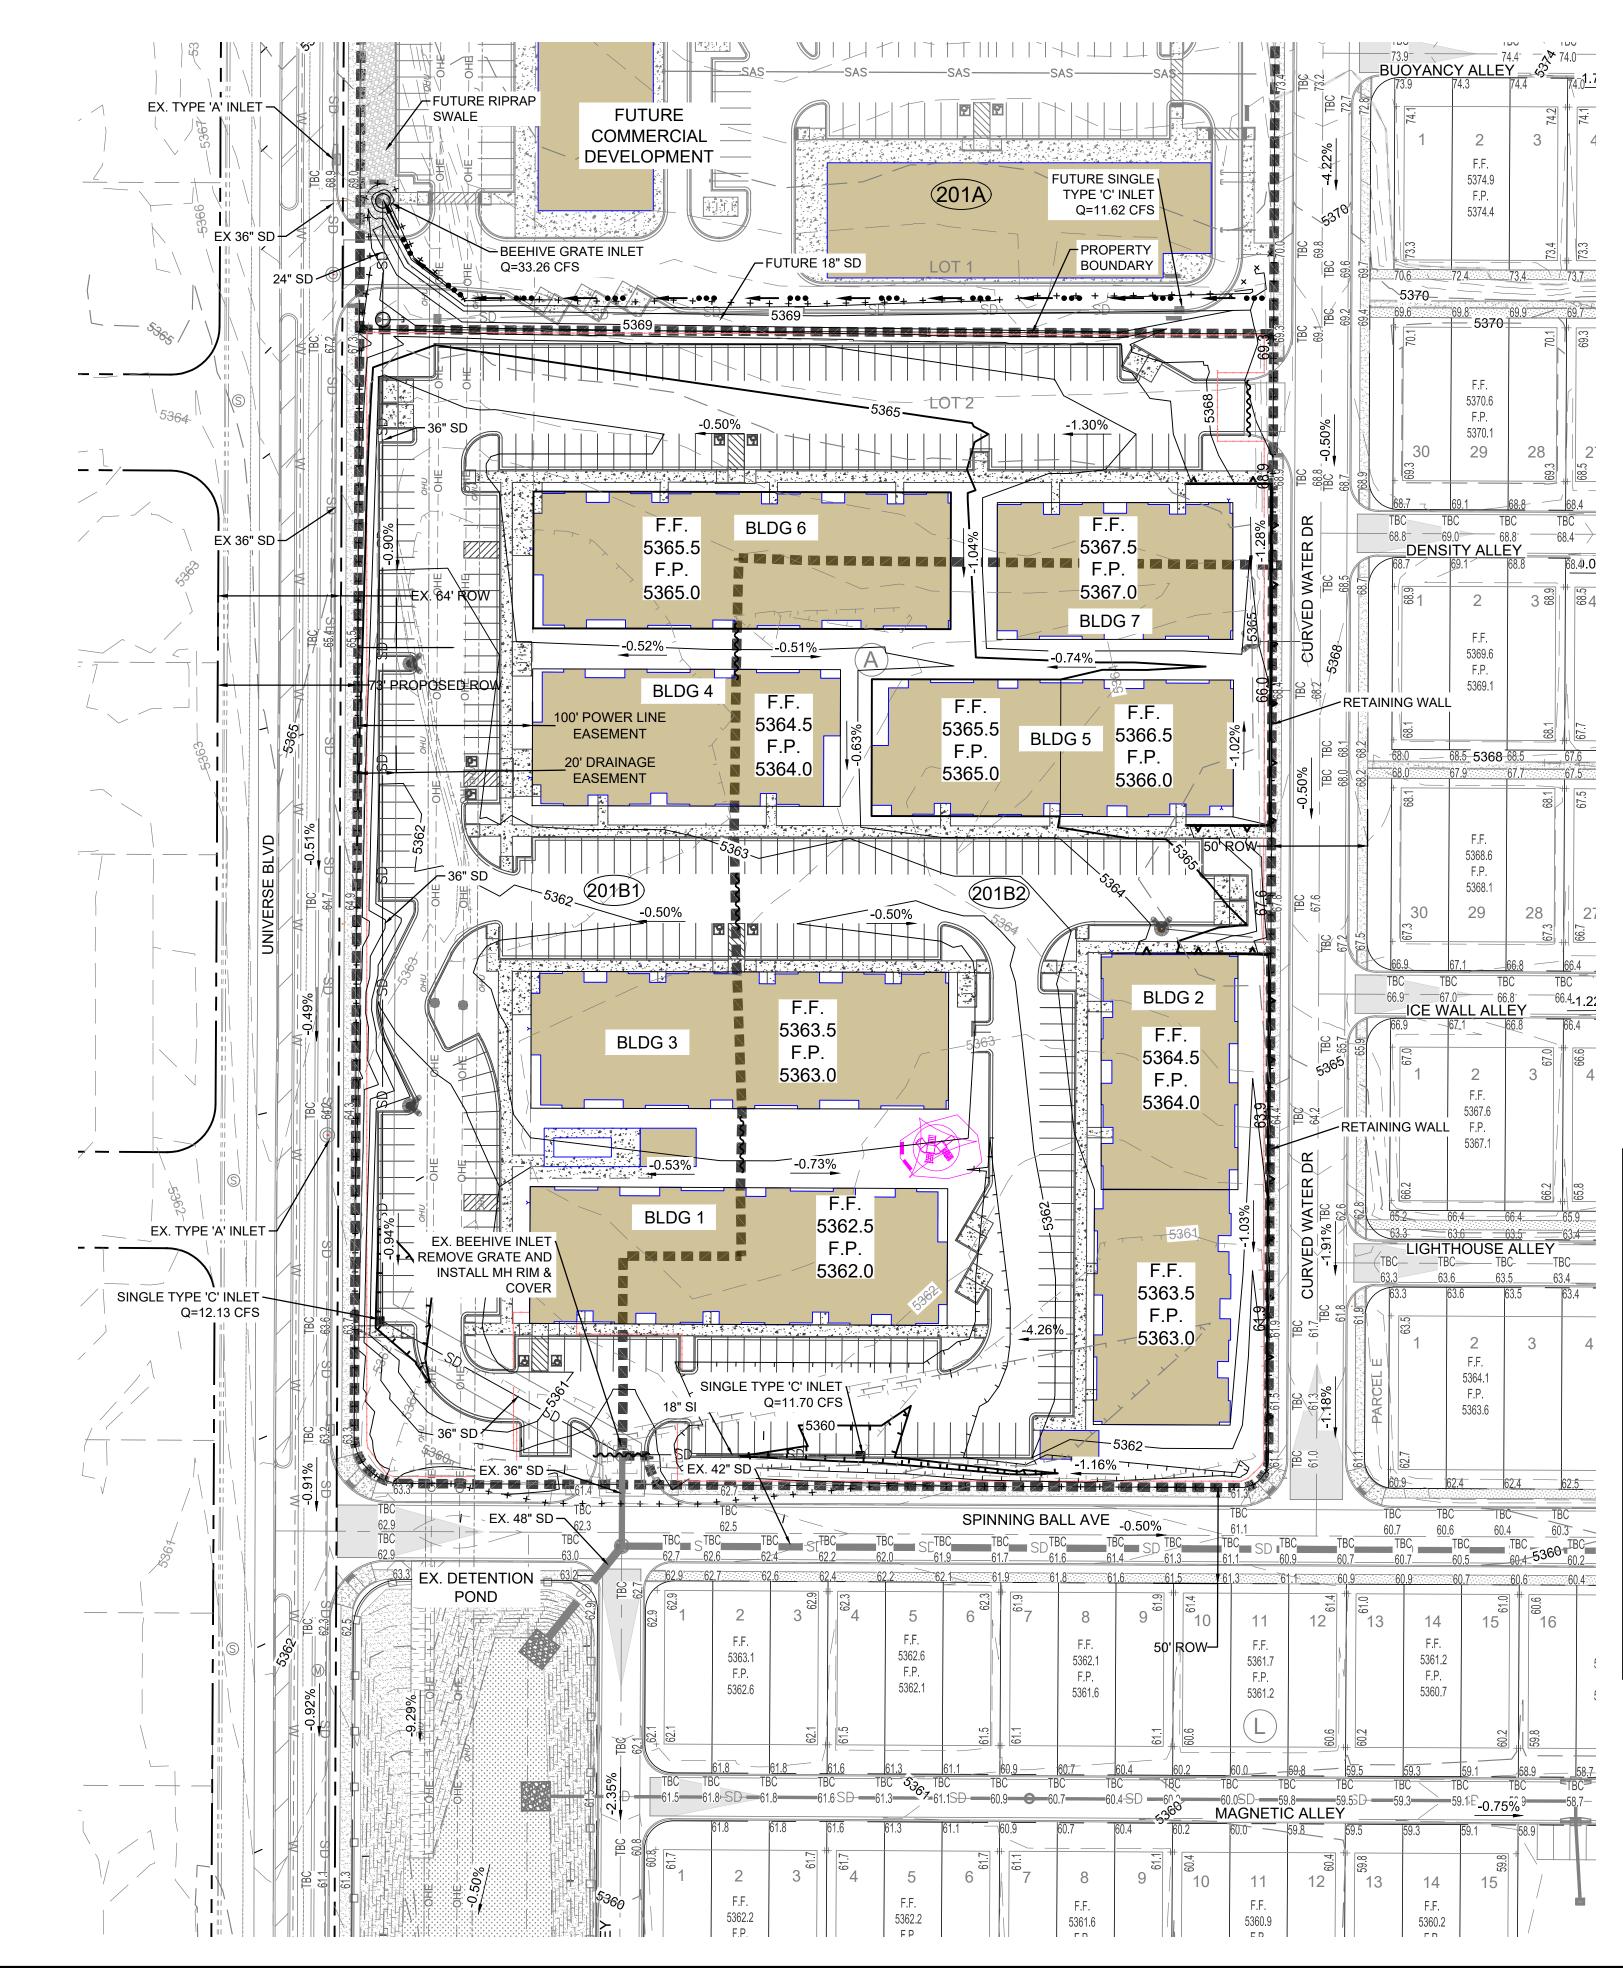
CLARITY ONLY.
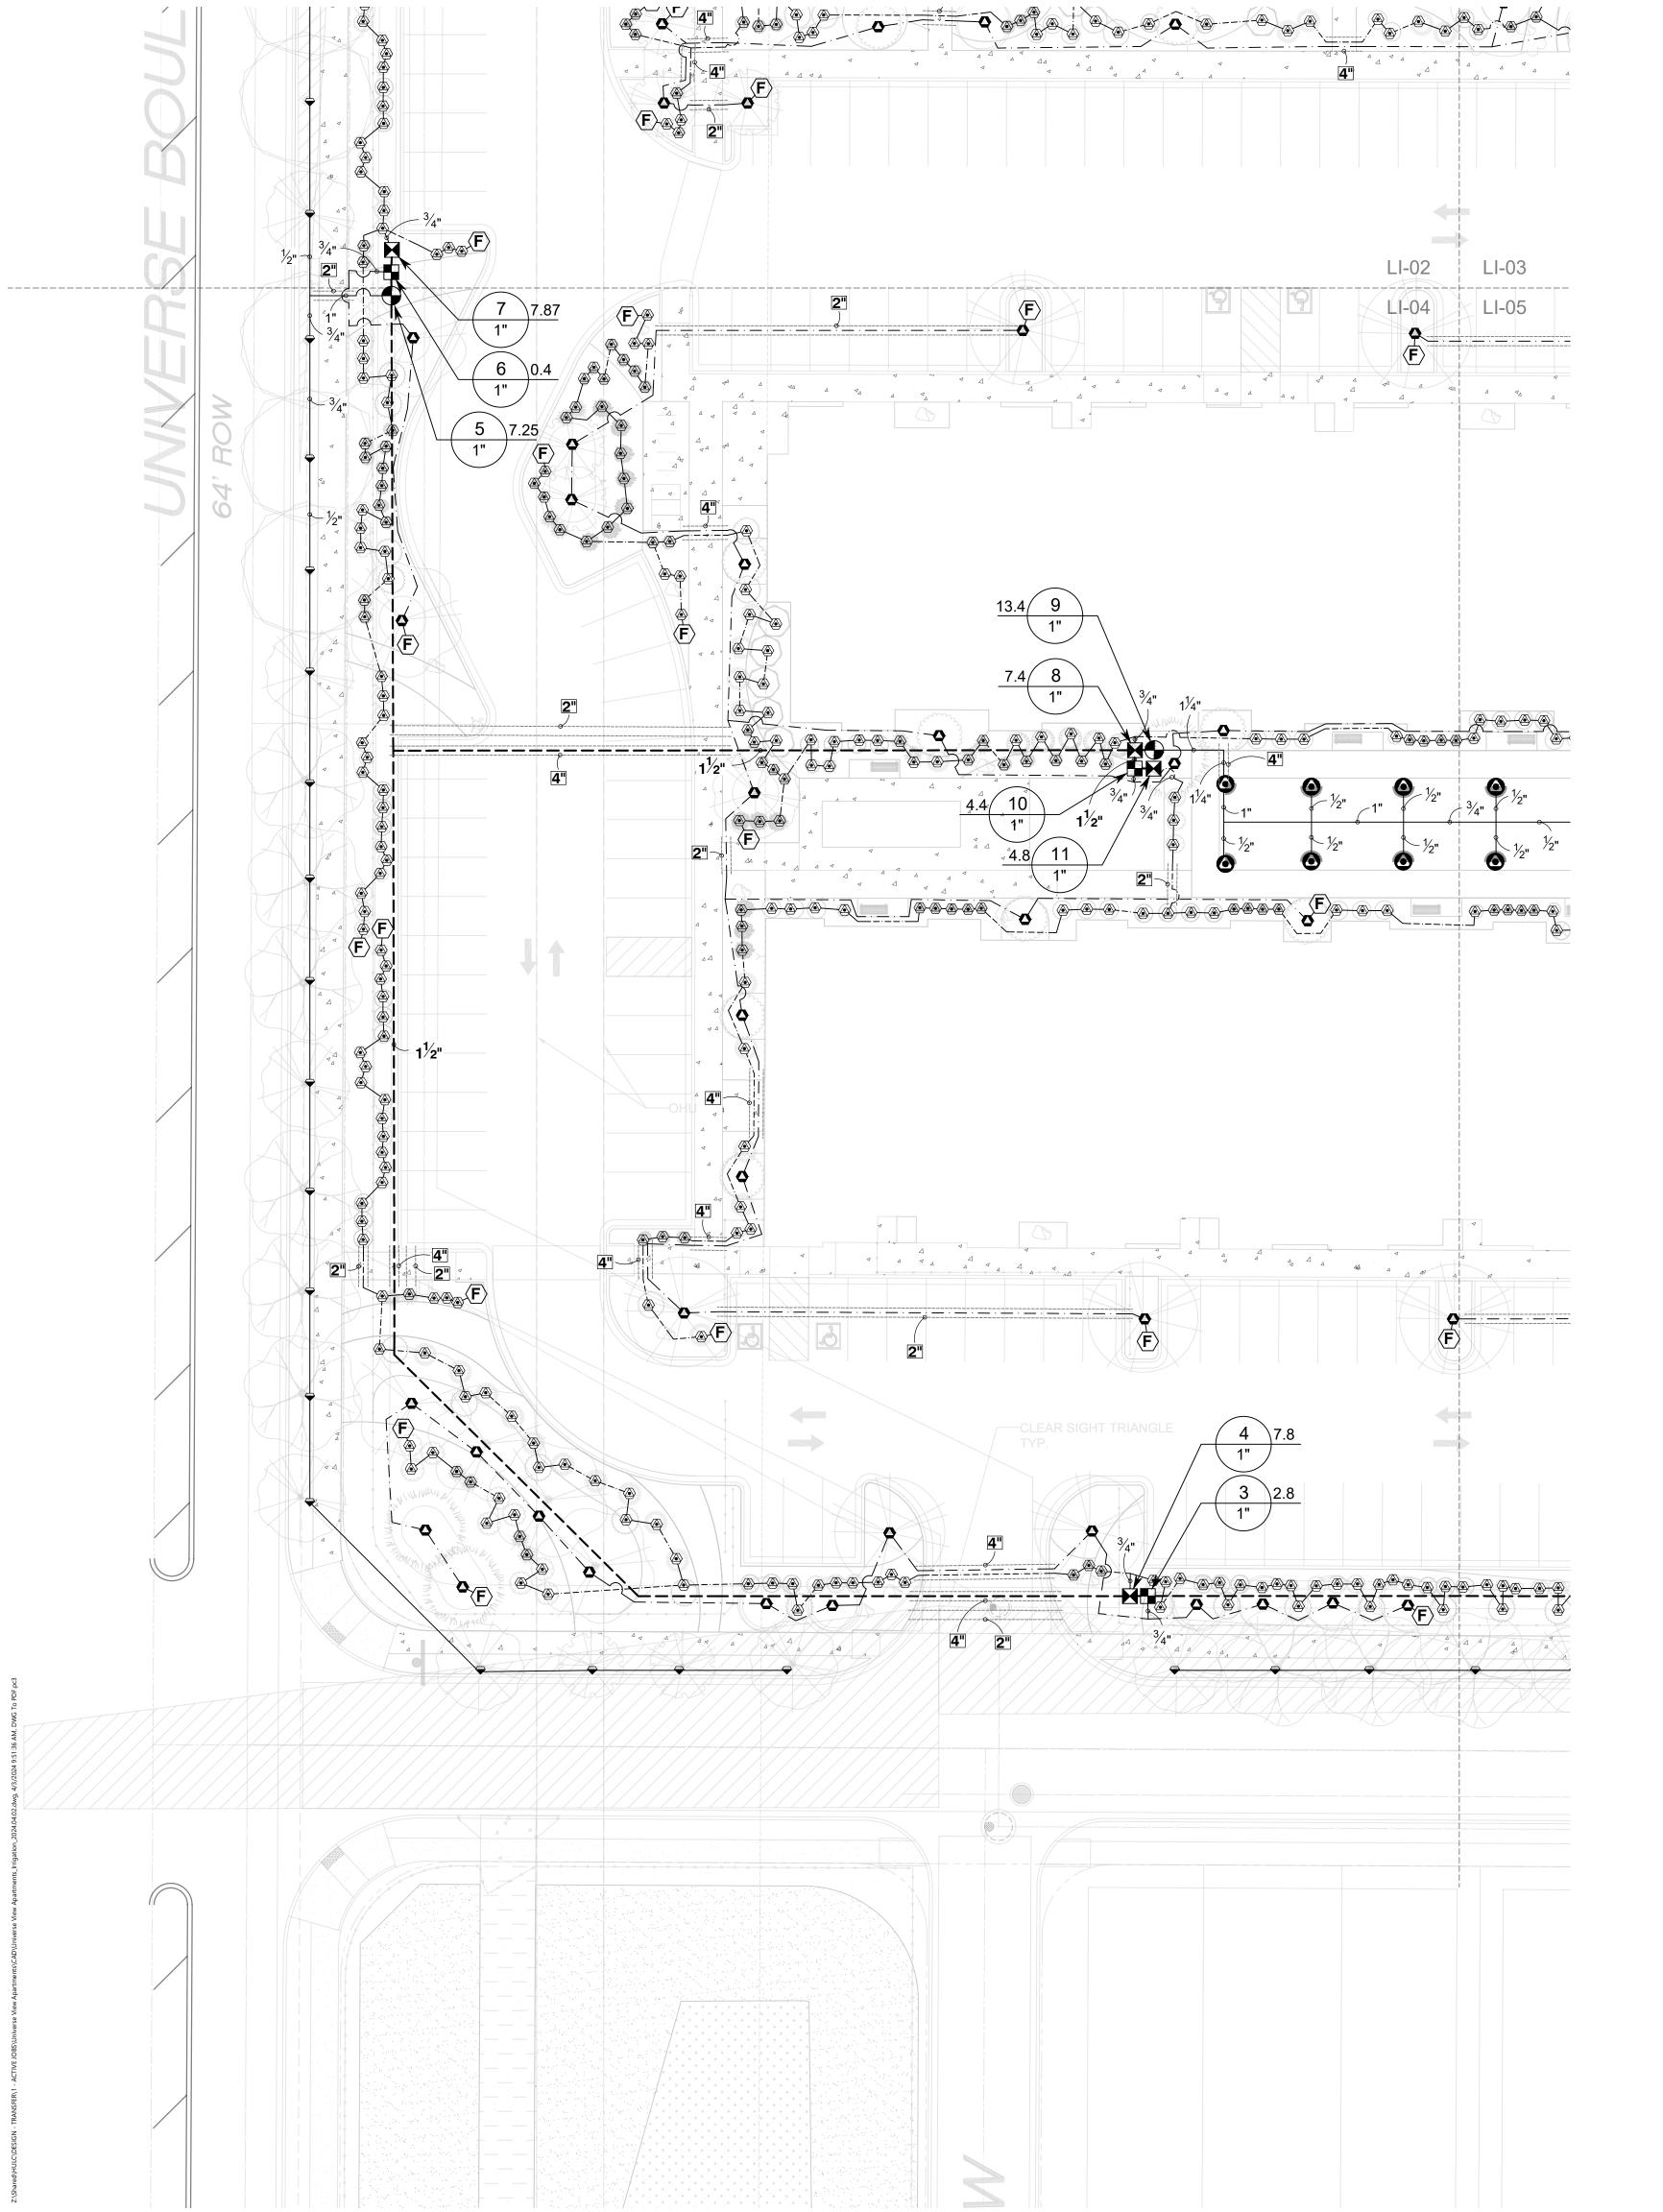
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- WITHIN THE PROPERTY LINE. 11. POWER FOR IRRIGATION SYSTEM TO BE PROVIDED BY THE GENERAL CONTRACTOR. 110V POWER IS REQUIRED AT THE LOCATIONS OF THE IRRIGATION CONTROLLER AND BACKFLOW PREVENTER.
- 12. BACKFLOW PREVENTER MUST BE TESTED AND CERTIFIED BEFORE FINAL ACCEPTANCE OF THE JOB. 13. CONTROLLER LOCATION IS APPROXIMATE AND THE FINAL LOCATION WILL BE DETERMINED IN THE FIELD. 14. SLEEVES TO BE INSTALLED, AS SHOWN PER PLAN, BEFORE HARDSCAPE IS INSTALLED. THE LANDSCAPE CONTRACTOR MUST BE GIVEN A MINIMUM OF 72 HOUR NOTICE BEFORE SLEEVE LOCATIONS ARE PAVED OVER. 15. WATER METER TO BE PROVIDED BY OTHERS.
- 16. PER 5-6(C)(14)(a), IRRIGATION SYSTEMS SHALL COMPLY WITH SECTION 8 OF THE ABCWUA LEGISLATION AND ORDINANCES (CROSS CONNECTION PREVENTION AND CONTROL ORDINANCE) 17. PER 5-6(C)(14)(b), ALL IRRIGATION SYSTEMS SHALL BE DESIGNED TO MINIMIZE THE USE OF WATER.





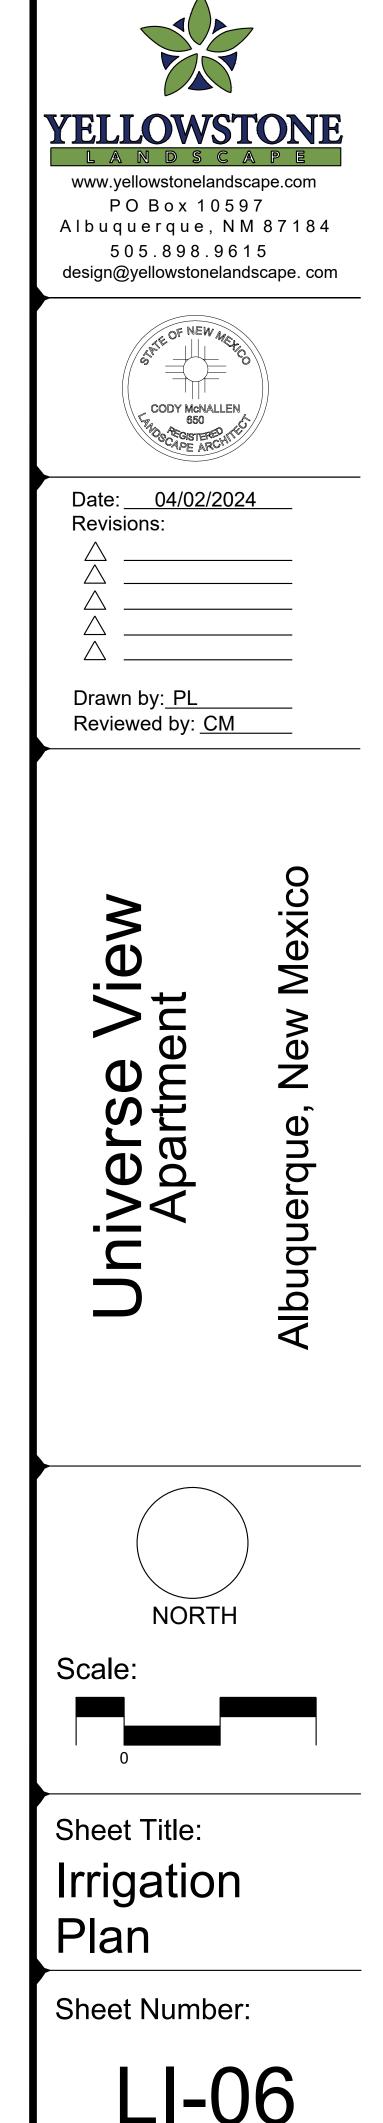

GENERAL NOTES

- 1. SEE SWPPP (BY OTHERS) FOR STABILIZATION MEASURES.
- 2. SEE PLAT FOR LOT DIMENSIONS.
- 3. RETAINING WALL DESIGN WILL BE SUBMITTED SEPARATELY FOR BUILDING PERMIT.
- 4. EARTHWORK SHALL BE PERFORMED IN ACCORDANCE WITH THE GEOTECHNICAL INVESTIGATION FOR THIS PROJECT.
- 5. THE STORM WATER POLLUTION PREVENTION PLAN SHALL BE MAINTAINED AT ALL TIMES DURING THE CONSTRUCTION PROJECT.
- 6. CONTRACTOR SHALL OBTAIN PERMISSION TO GRADE ON PRIVATE PROPERTY. CITY SHALL NOT BE RESPONSIBLE FOR CONTRACTOR TRESPASSING ON PRIVATE PROPERTY

LEGEND

| EXISTING (INDEX) CONTOUR |
|--------------------------------------|
| EXISTING (INTERMED.) CONTOUR |
| PROPOSED (INDEX) CONTOUR |
| PROPOSED (INTERMED.) CONTOUR |
| GRADING LIMITS |
| NATIVE SEEDING PER SECTION 1013 |
| GRAVEL MULCH PER SECTION 1013 |
| 2" - 4" LANDSCAPE ROCK (DEFERRED) |
| 2" - 4" LANDSCAPE ROCK |
| 6" - 8" LANDSCAPE ROCK |
| 12" - 18" LANDSCAPE ROCK |
| 12" SUBGRADE PREP |
| CONCRETE |
| BASE COURSE ACCESS ROAD |
| WATERBLOCK (HIGH POINT) |
| SWALE |
| PROPOSED RETAINING WALL |
| DRAINAGE BASIN BOUNDARY |
| DRAINAGE BASIN NUMBER |
| |

DRAINAGE PLAN:

LOCATION: LOT 2 OF UNIVERSE VIEW SUBDIVISION (A REPLAT OF LOT 1, BLOCK 8, UNIT 17, VOLCANO CLIFFS SUBDIVISION)

SITE AREA: APPROX. 6.6 ACRES

FLOOD HAZARD STATEMENT: THE SITE IS NOT ENCUMBERED BY A FLOOD HAZARD AREA ACCORDING TO F.E.M.A. FIRM MAP DATED SEPTEMBER 26, 2008 (MAP NUMBER 35001C0111G).


EXISTING DRAINAGE CONDITIONS:

THE PROJECT SITE IS LOT 2 OF UNIVERSE VIEW SUBDIVISION, WHICH HAS BEEN APPROVED WITH CONDITIONS FOR PRELIMINARY PLAT. THE AREA IS UNDEVELOPED AND IS SPLIT INTO TWO DRAINAGE BASINS: A NORTHERN PORTION WHICH DRAINS WEST AND THE SOUTHERN PORTION WHICH DRAINS SOUTH. THERE IS AN EXISTING "PLAYA" OR DEPRESSION TO THE WEST OF THE SITE WHICH PREVENTS STORM-WATER RUNOFF FROM DRAINING INTO THE UNIVERSE BOULEVARD RIGHT-OF-WAY. STORM-WATER RUNOFF FROM THE SOUTHERN BASIN DRAINS SOUTH TO AN EXISTING DETENTION POND (POND 4A) LOCATED AT THE NORTHWEST CORNER OF UNSER BOULEVARD AND RAINBOW BOULEVARD. THE SITE IS BOUND BY UNIVERSE BOULEVARD TO THE WEST, A COMMERCIAL LOT TO THE NORTH, SPINNING BALL AVENUE TO THE SOUTH AND CURVED WATER DRIVE TO THE EAST.


DEVELOPED DRAINAGE CONDITIONS:


THE AMENDED DRAINAGE STUDY FOR UNIVERSE VIEW SUBDIVISION DATED MARCH 8, 2023 WAS APPROVED BY CITY HYDROLOGY ON MARCH 16, 2023 AND SERVES AS THE BASIS FOR DESIGN OF THE PROJECT SITE. DEVELOPED CONDITIONS STORM-WATER RUNOFF WILL DRAIN ON THE SURFACE TO 2-SINGLE TYPE 'C' INLETS IN SAG LOCATED NEAR THE SOUTHERN PROPERTY LINE OF THE SITE, THEN CONVEYED TO THE DETENTION POND 1 TO BE CONSTRUCTED WITH COA WORK ORDER PROJECT #709790. OFFSITE BASINS OS-1 (LOCATED TO THE NORTH OF BASIN 201A) AND BASIN 201A WILL BE CAPTURED BY A BEEHIVE TYPE INLET LOCATED TO THE NORTHWEST OF THE APARTMENT SITE. A BASIN SUMMARY TABLE WITH LAND TREATMENTS AND RESULTS OF THE HYDROLOGIC ANALYSIS IS SHOWN BELOW. THE APPROVED DRAINAGE REPORT AND THIS ANALYSIS IS IN ACCORDANCE WITH THE CITY OF ALBUQUERQUE DEVELOPMENT PROCESS MANUAL.


| | | Universe View Apartments | | | | | | |
|---|---------------|---------------------------------------|-------|---------|------------|----------|--------|--|
| | | | Basin | Summary | / - Develo | ped Cond | itions | |
| | Basin | Basin Area (Acre) %A %B %C %D 100-Yea | | | | | | |
| | OS-1 | 27.96 | 98 | 0 | 0 | 2 | 1.35 | |
| | 201A | 2.94 | 0 | 5 | 5 | 90 | 0.45 | |
| | 201 B1 | 3.34 | 0 | 15 | 15 | 70 | 0.45 | |
| | 201B2 | 3.22 | 0 | 15 | 15 | 70 | 0.43 | |
| ſ | | 37.5 | | | | | 2.68 | |

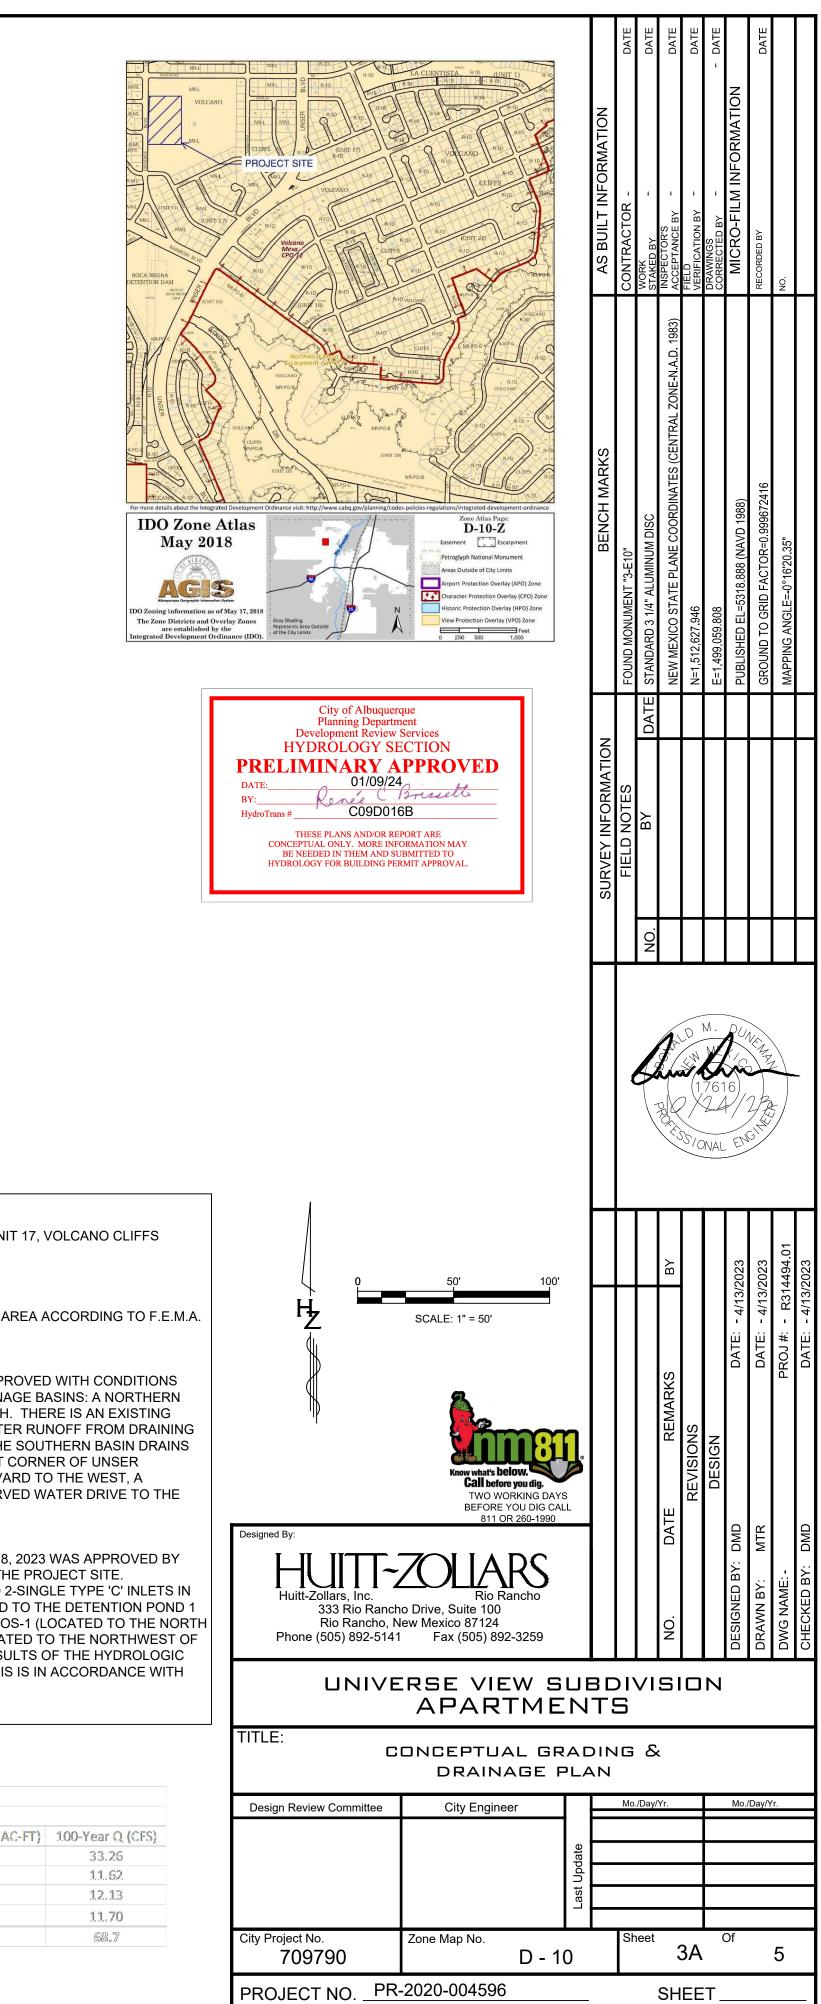


ed: 10/23/2023 5:17:33 PM, By:Duneman, Donnie oj\R314494.01 - Volcano Cliffs Subdivision U17 B8 APARTMENTS\R314494 - Apartments XSECT.dwg Saved:7/31/2023 2:01:00 PM. dduneman

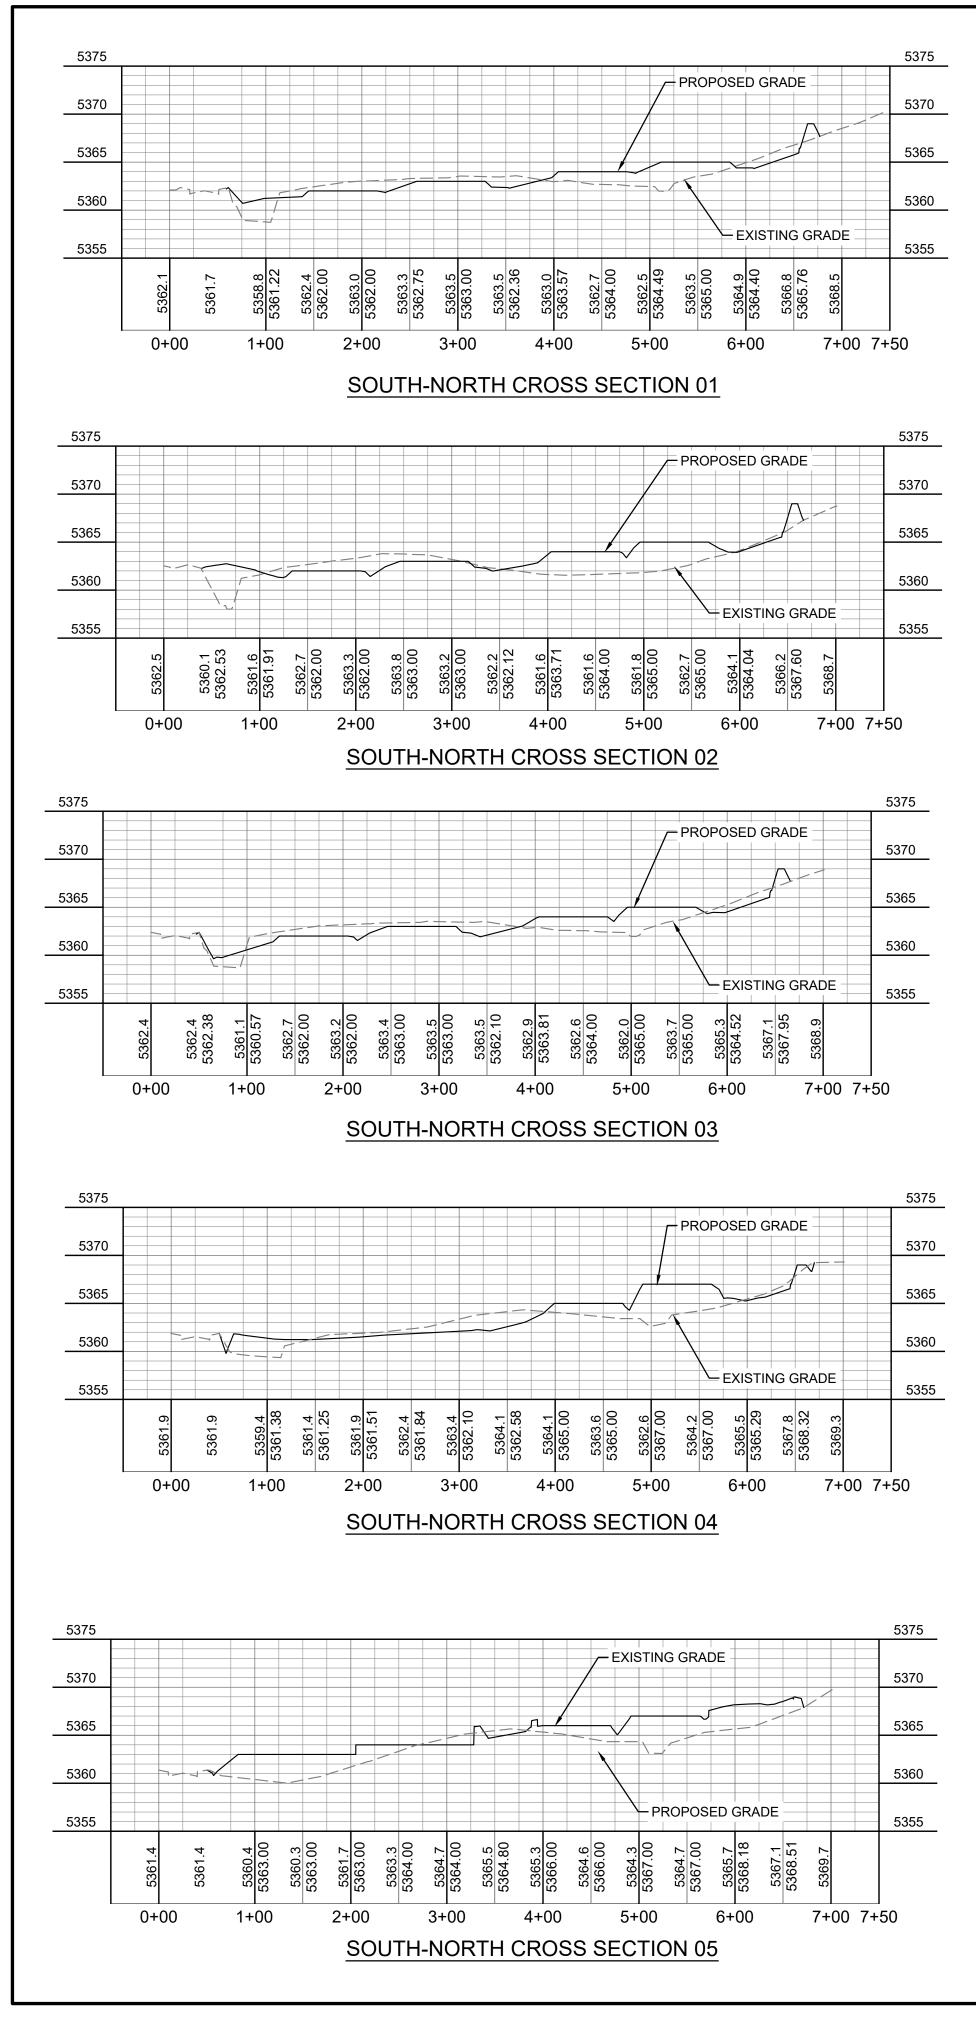


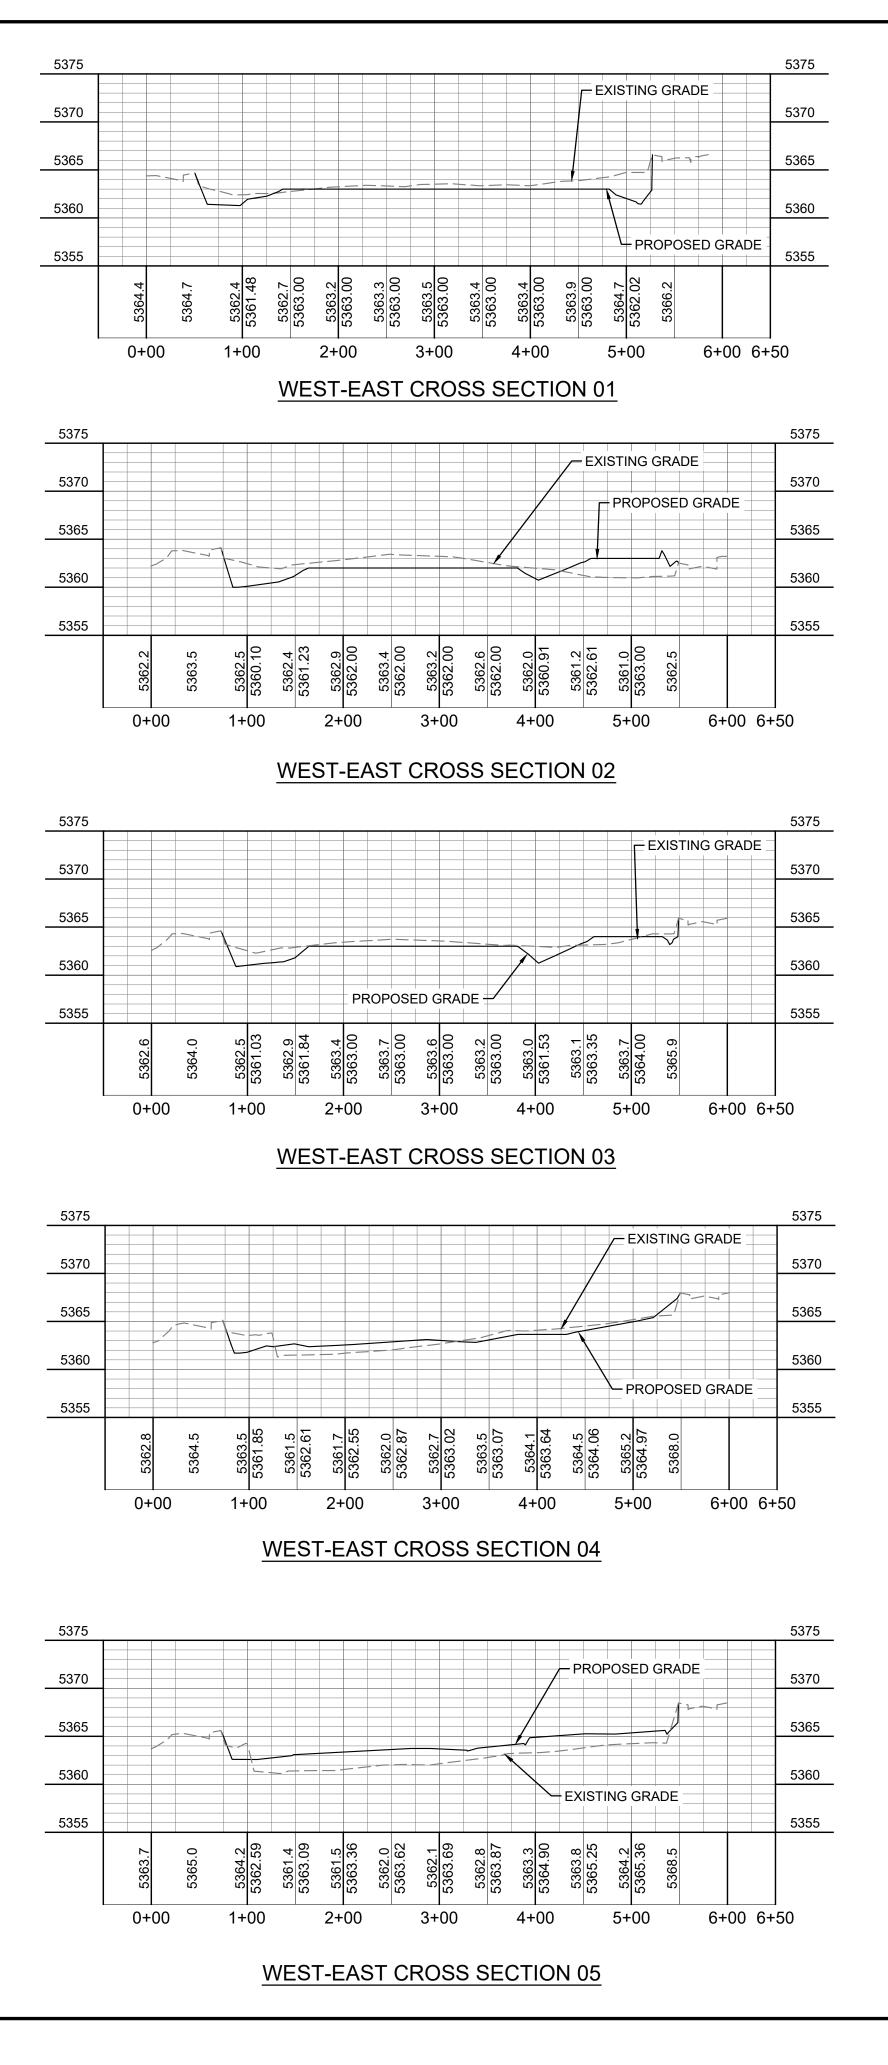


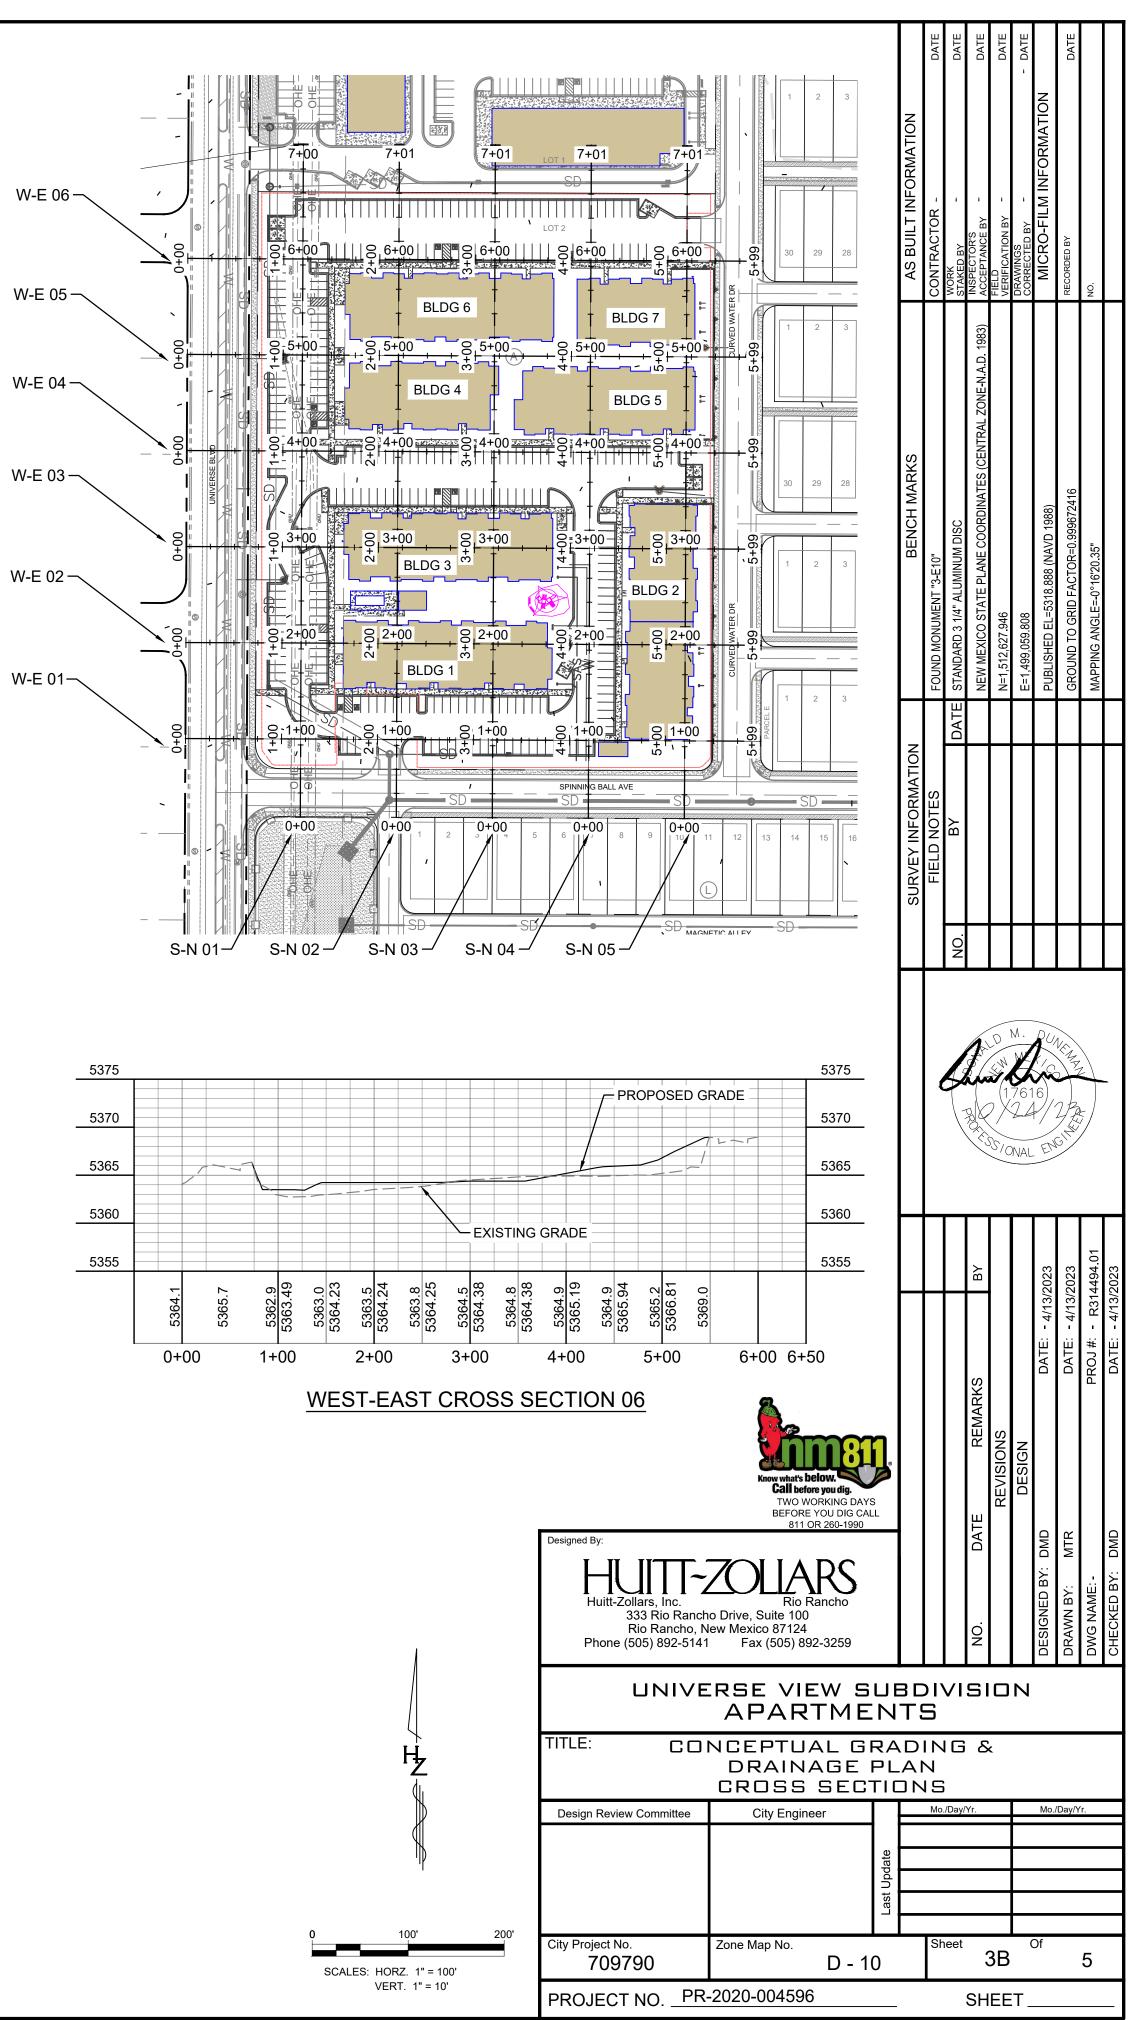

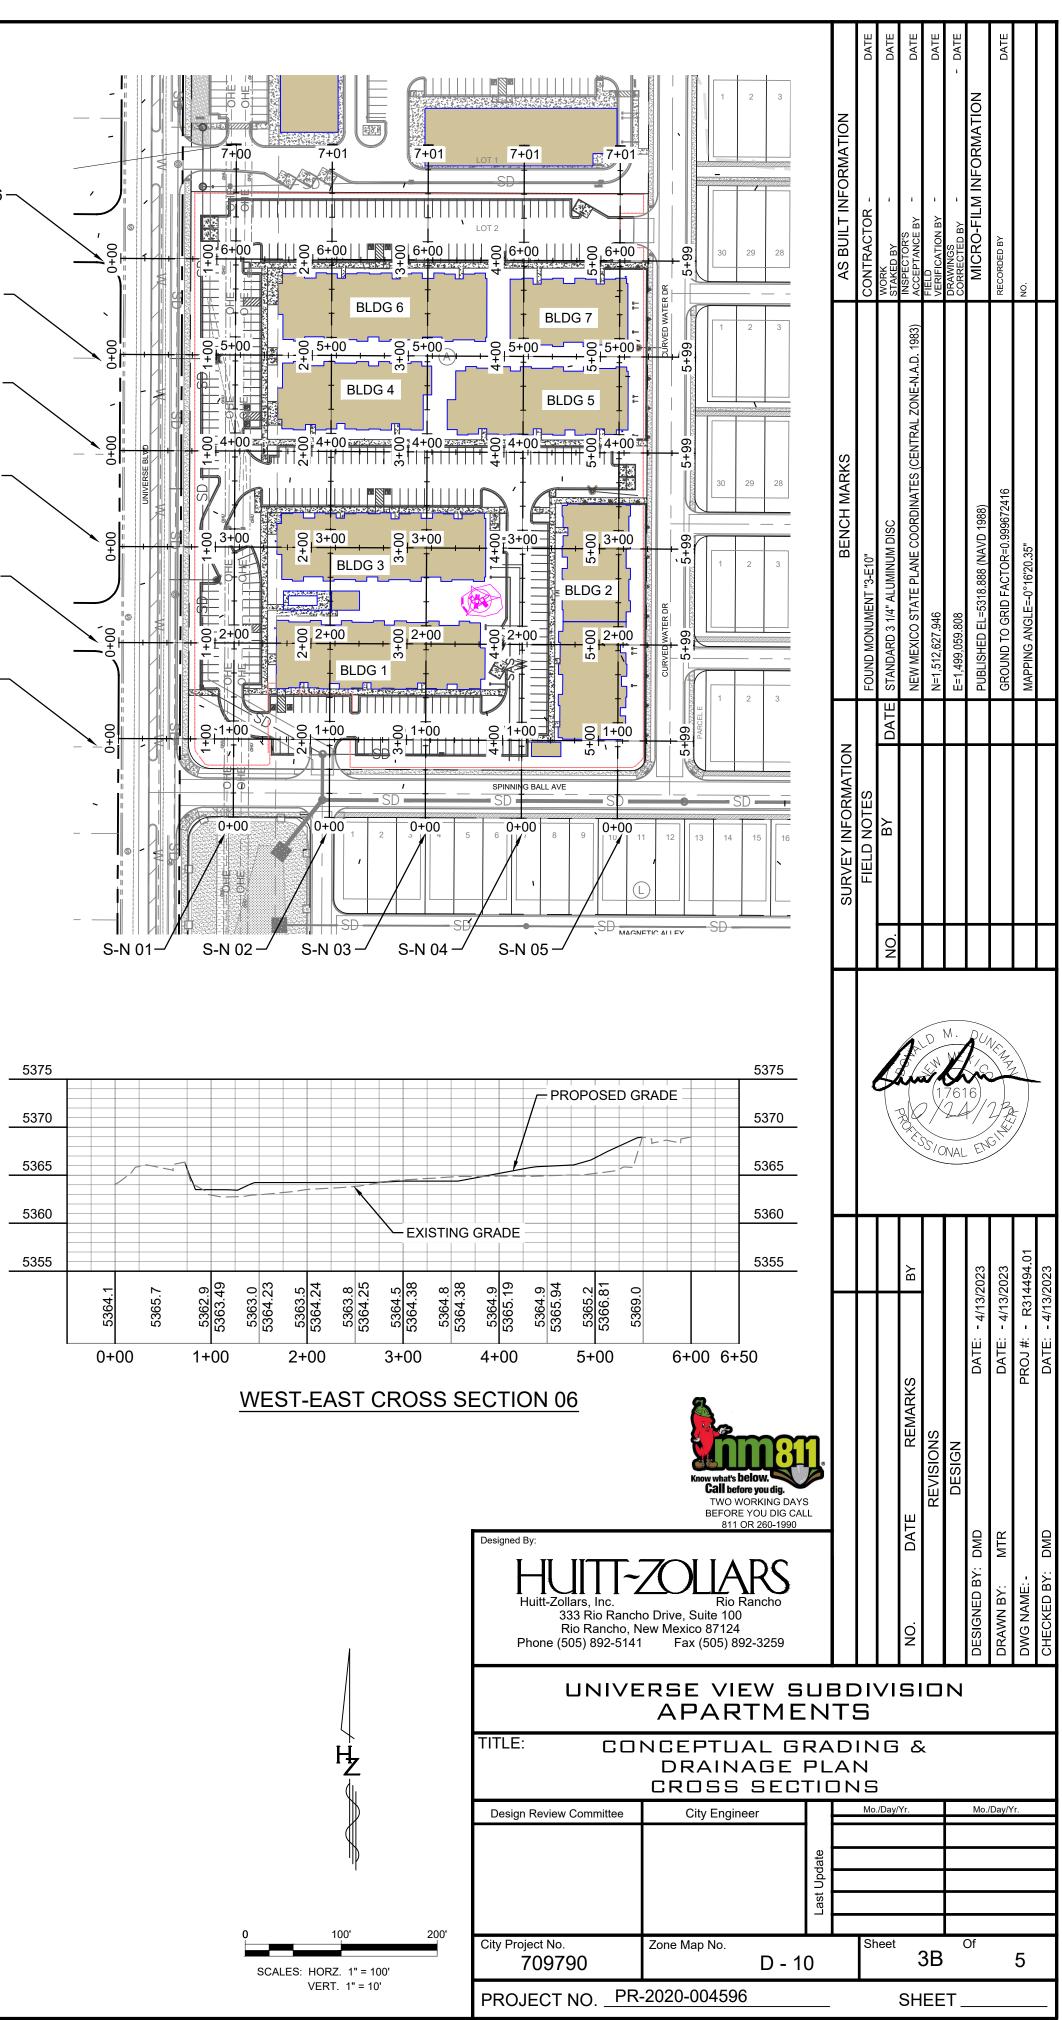




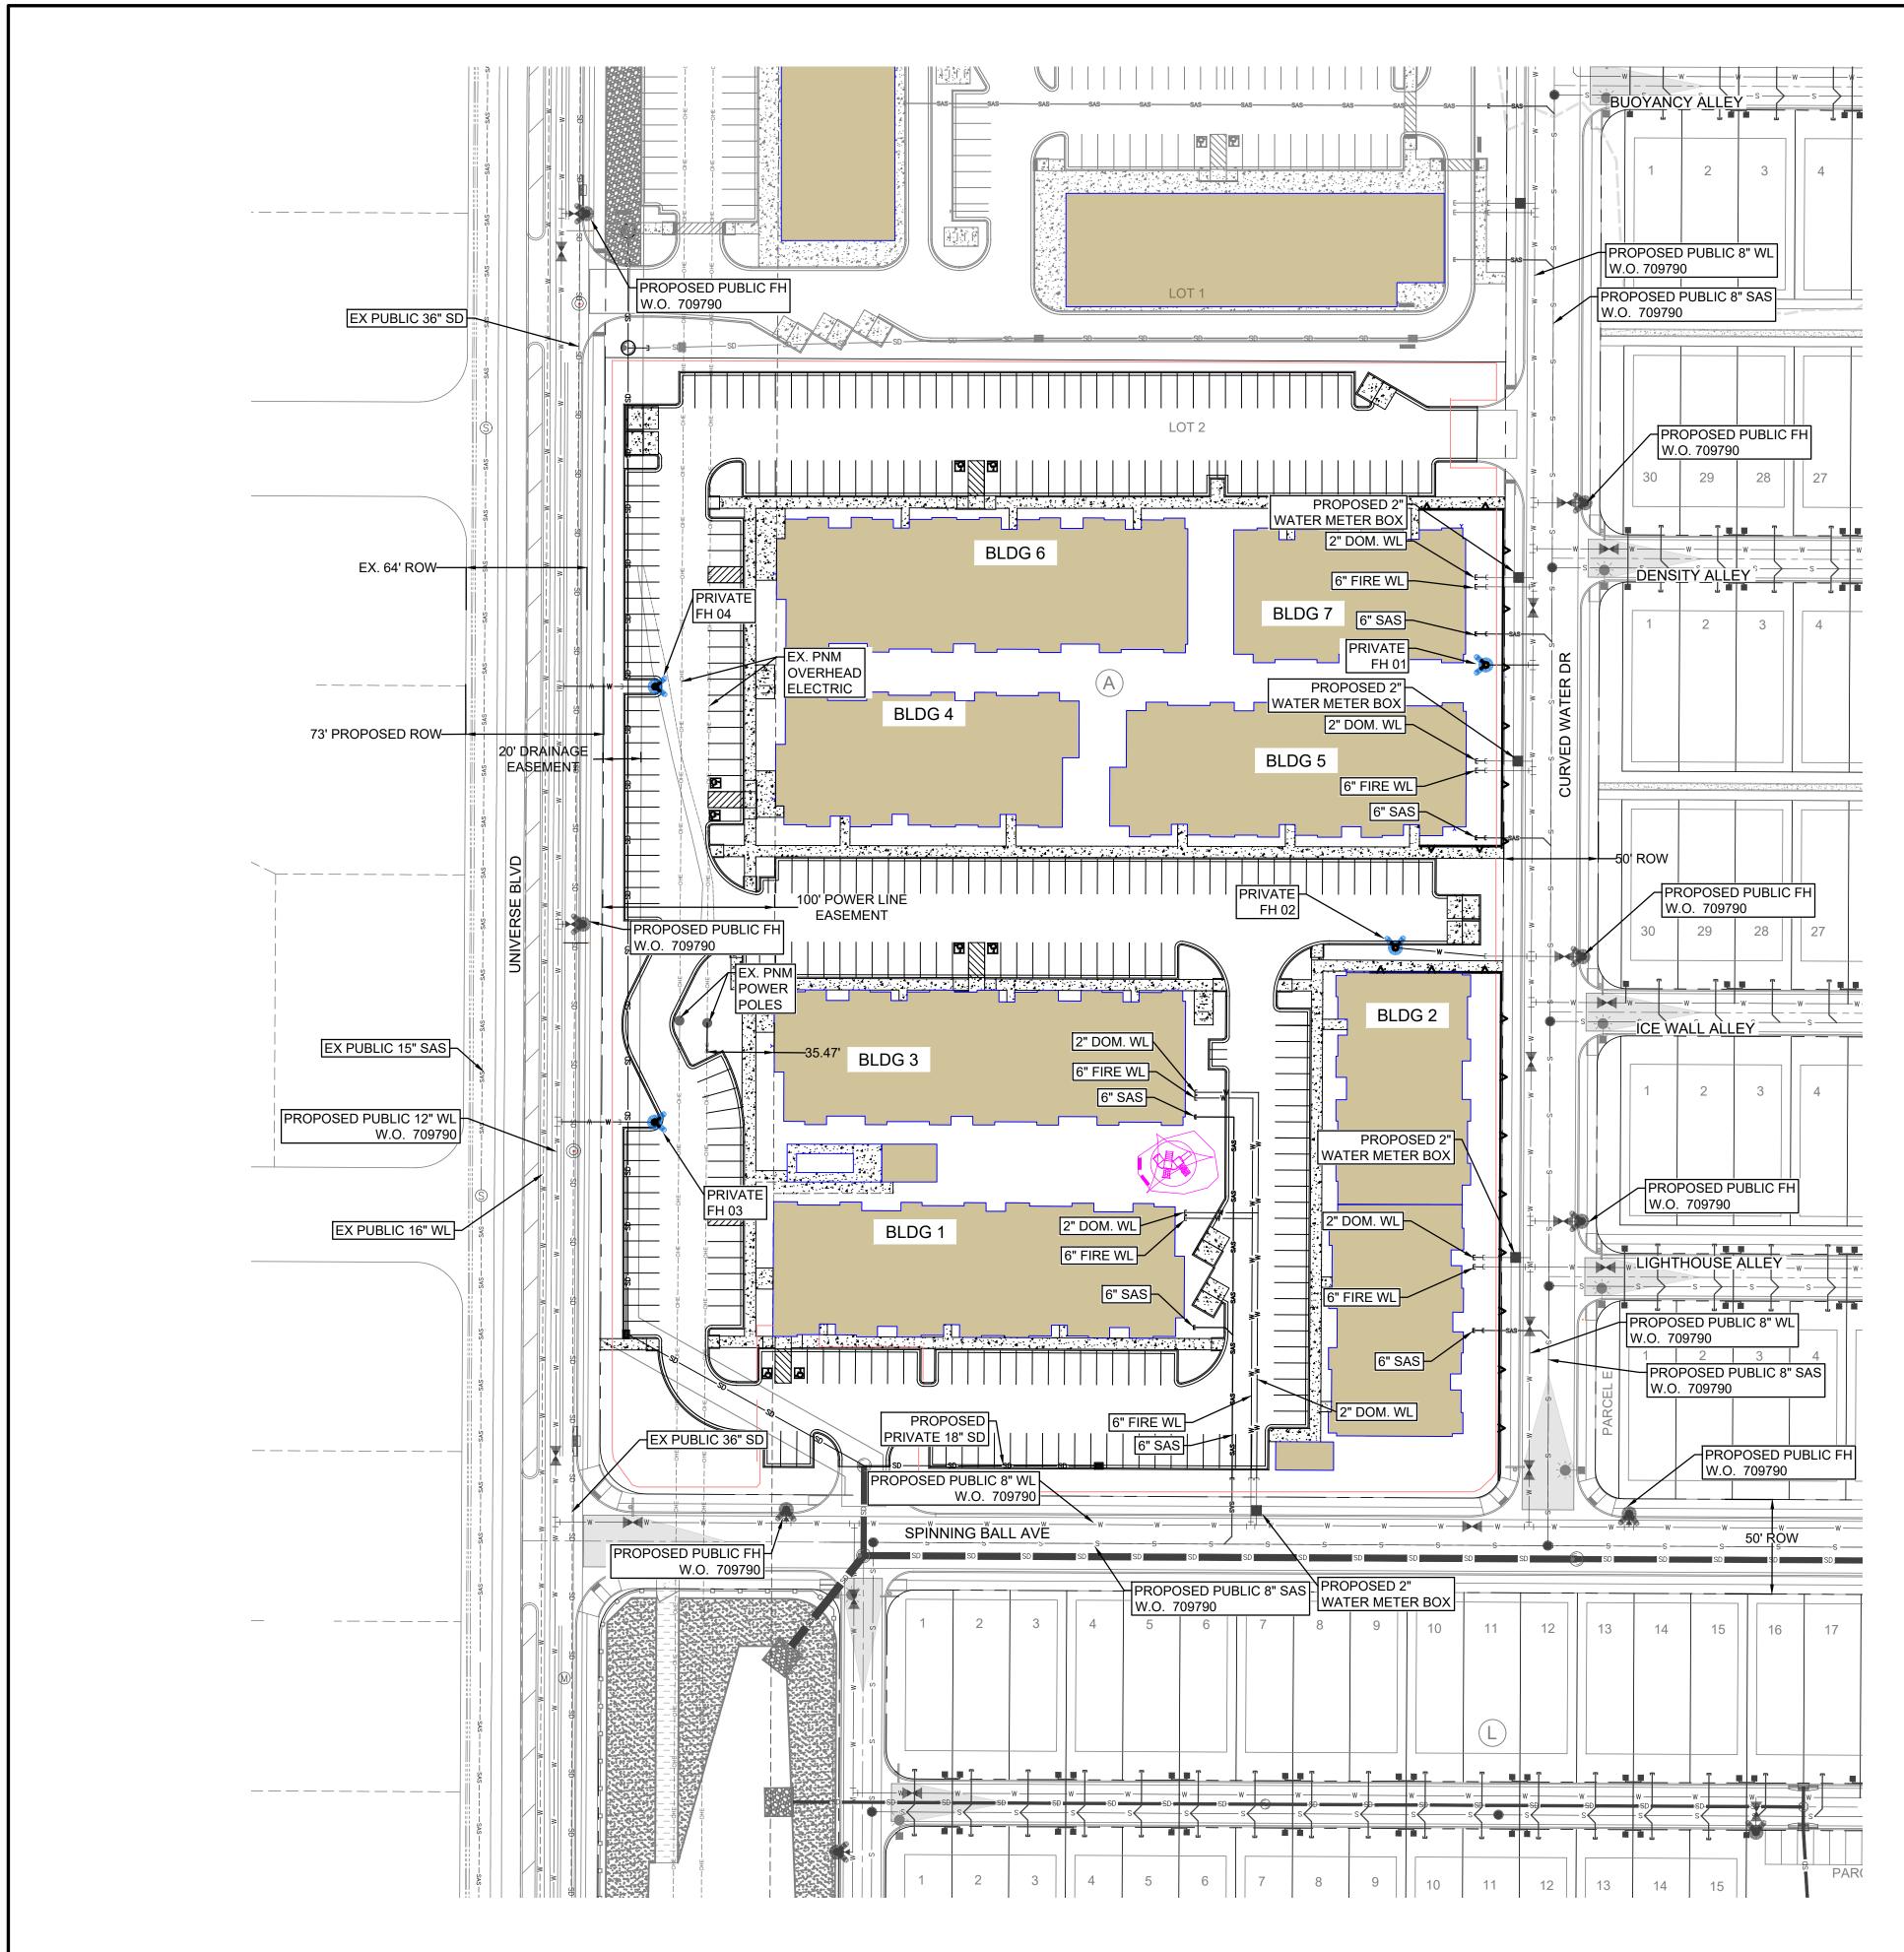

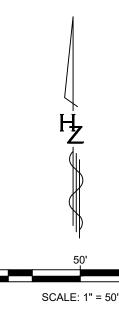


| | | | | | DATE | DATE | DATE | DATE | - DATE | | DATE | | |
|------|--|---------------------------------------|--|--------------------|-------------------|-------------------------------|--|--------------------------|--------------------------|-----------------------------------|---|--------------------|-------------|
| | GENERAL NOTES | | | NOI | | | | | | ATION | | | |
| 1. | SD/SAS MANHOLES SHA CORR STD DWG S-03-01, PER CORR STD DWG S-0 COLLAR PER CORR STD | , MH FRAME & COVER 02 AND MH CONC. | | BUILT INFORMATION | JR - | , | , , | - ~ | , | MICRO-FILM INFORMATION | | | |
| 2. | SD/SAS DROP MANHOLE INSTALLED PER CORR S S-03-01, MH FRAME & CC DWG S-02 AND MH CONO STD DWG S-01. | TD DWG S-10 & OVER PER CORR STD | | AS BUILT | CONTRACTOR | WORK STAKED BY | INSPECTOR'S ACCEPTANCE BY | FIELD VERIFICATION BY | DRAWINGS CORRECTED BY | MICRO-F | RECORDED BY | ON | |
| 3. | FIRE HYDRANT ASSEMB | | | | | | A.D. 1983) | | | | | | |
| 4. | GATE VALVES SHALL BE WITH CONCRETE COLLA DWG W-05. GATE VALVE BY THE CITY ONLY. | RS PER CORR STD | | | | | ANE COORDINATES (CENTRAL ZONE-N.A.D. 1983) | | | | | | |
| 5. | FITTINGS SHALL BE FULI MARKER BALL PER COR | | | ENCH MARKS | | | NATES (CF | | | | 416 | | |
| 6. | SD PIPE MATERIAL PER | | | ENCH | | DISC | COORDIN | | | VD 1988) | 0.999672 | _ | |
| 7. | ALL CONCRETE PADS FO MUST BE PLACED 3" ABO | | | BE | T "3-E10" | TUMINUM | Ч | | | 8.888 (NA' | GRID FACTOR=0.999672416 | 0°16'20.35" | |
| 8. | WORK WITHIN CITY OF F WAY IS BY A SEPARATE | | | | FOUND MONUMENT "3 | STANDARD 3 1/4" ALUMINUM DISC | NEW MEXICO STATE | N=1,512,627.946 | E=1,499,059.808 | PUBLISHED EL=5318.888 (NAVD 1988) | GROUND TO GRID F | MAPPING ANGLE=-0°1 | |
| | | | | ┢ | FO | DATE STA | NE | N=1 | Ë. | PUL | GR | MA | |
| NOTE | <u>-</u> . | | | NO | | ₽D | $\left - \right $ | | ┝┤ | | | | |
| 1. | WORK ORDER 7097 INFRASTRUCTURE I COMPLETED PRIOR | MUST BE | | SURVEY INFORMATION | JOTES | ВΥ | | | | | | | |
| | SERVICE FOR THE A | APARTMENT Г. | | VEY IN | FIELD N | | | | | | | | |
| 2. | INFRASTRUCTURE | 90 INCLUDES ALL | | SUF | | | | | | | | | |
| | PAVING, SANITARY LINE, AND DRAINAG IMPROVEMENTS WI | E | | | | NO. | | | | | | | |
| | BOULEVARD, SPINN AVENUE AND CURV | IING BALL | | Γ | | | | | | | | | |
| | DRIVE. ALL INFRAS | TRUCTURE | | | | 4 | | p' | M . | PUN | | \ | |
| 3. | PUBLIC. ALL IMPROVEMENT | | | | | J. | E. | (1) | E 761 | K/ X~ 6) | | 4 | - |
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| | | | | ┢ | ┠ | Η | | | | - 4/13/2023 | - 4/13/2023 | - R314494.01 | - 4/13/2023 |
| | | | | | | | | | | DATE: - | DATE: - | PROJ #: - | DATE: - |
| | | | 2 | | | | REMARKS | | | | | РР | |
| | | | Shim man | | | | REM/ | SNC | N | | | | |
| | | | Know what's below. Call before you dig. TWO WORKING DAYS | | | | | REVISIONS | DESIGN | | | | |
| | Г | Designed By: | BEFORE YOU DIG CAL 811 OR 260-1990 | | | | DATE | | | DMD | MTR | | DMD |
| | | | 701 IARS | | | | | | | | | , | |
| | | Rio Rancho, N | Rio Rancho o Drive, Suite 100 ew Mexico 87124 | | | | | | | DESIGNED BY: | DRAWN BY: | DWG NAME: | CHECKED BY: |
| | ŀ | Phone (505) 892-5141 | | | | | NO | | | DES | DR/ | Ň | CHF |
| | | UNIVE | RSE VIEW S APARTME | | | ∨ I∶ | SI | | Ν | | | | |
| | | TITLE: CON | CEPTUAL UT | | ΥI | PL | _A | N | | | | | |
| | | Design Review Committee | City Engineer | | Mo | ./Day/ | Yr. | | | Mo./ | Day/Yı | r. | |
| | 100' | | | ate | | | | | | | | | |
| | | | | Last Update | | | | | _ | | | | |
| | · | City Project No. | Zone Map No. | | Sh | neet | | | (| Df | | _ | |
| | | 709790 | D - 10 -2020-004596 | C | | | | 4 | | | | 5 | |
| | | PROJECT NO. PR- | -7/17/1_11/15/UA | | | | SH | | | | | | |



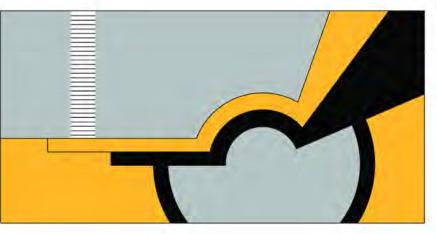





SCOTT C. ANDERSON & associates architects albuquerque

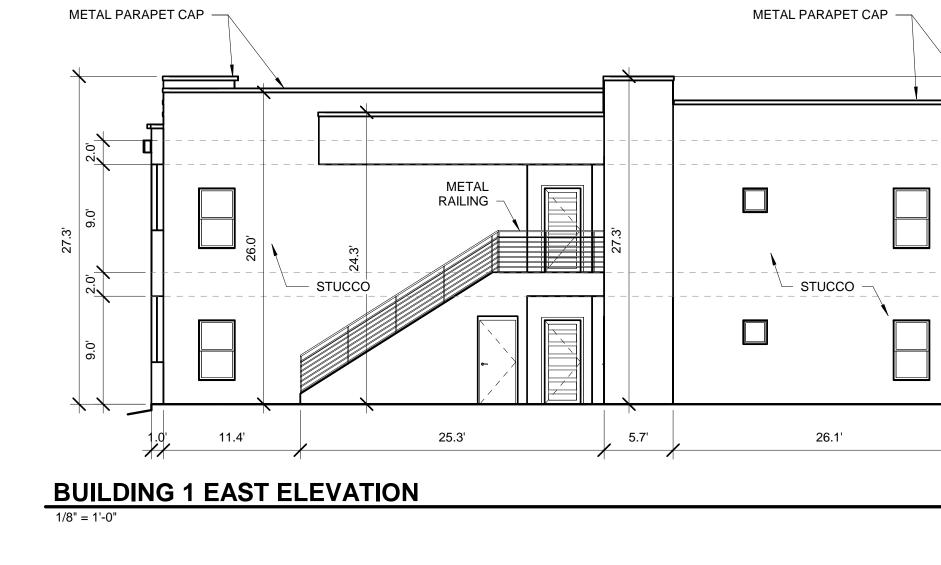




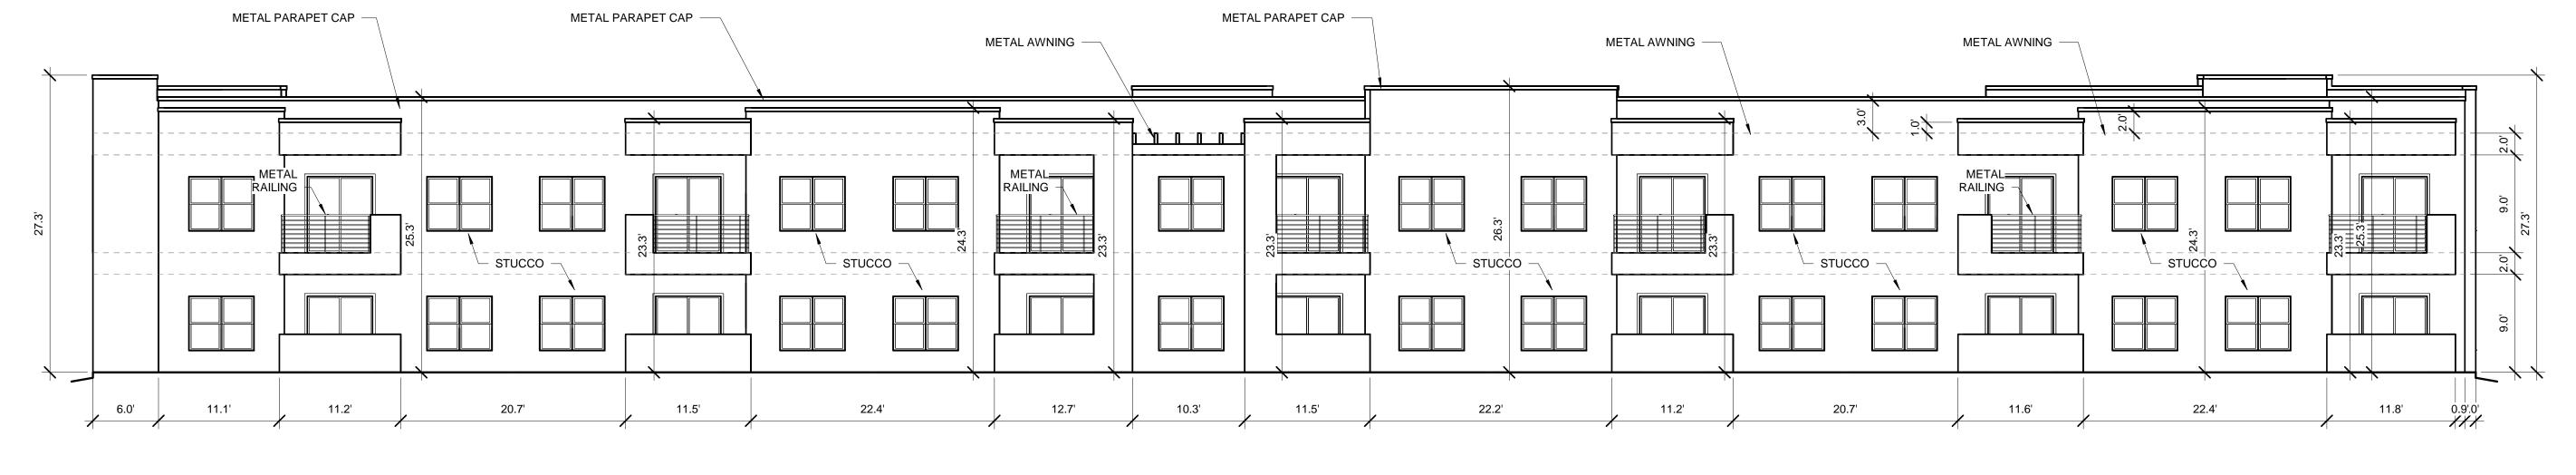



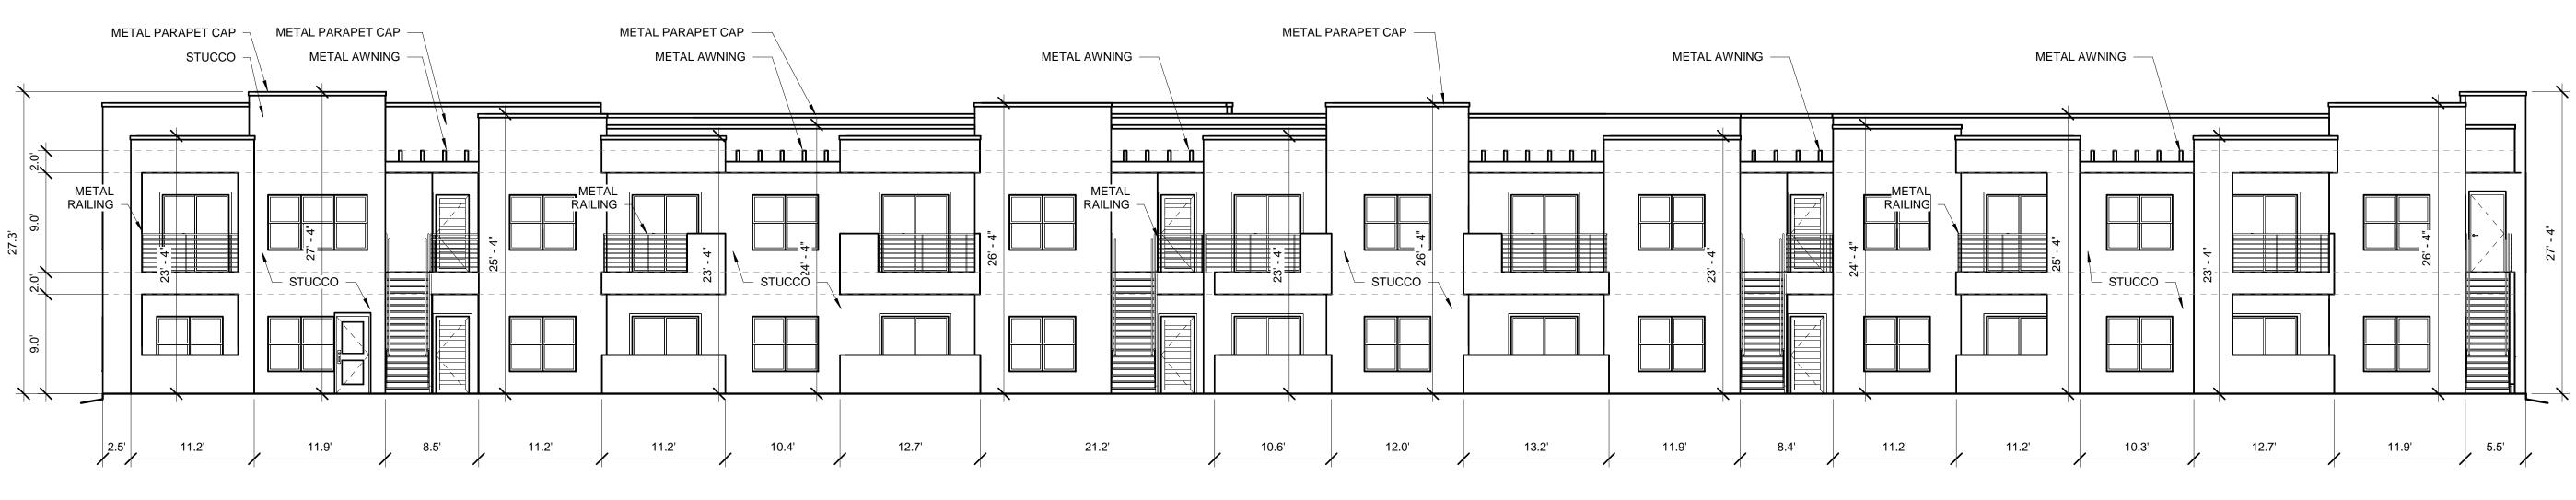



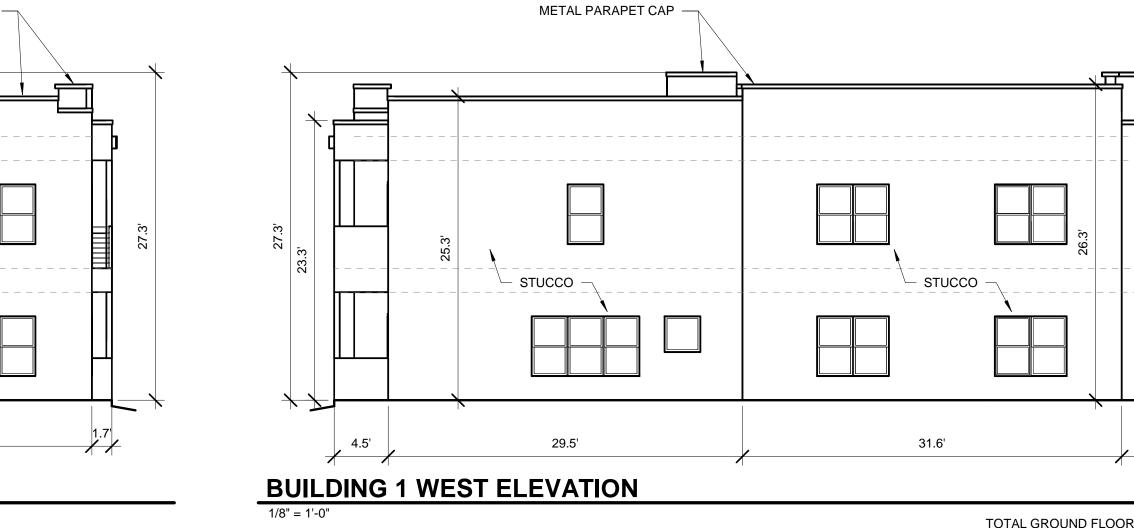

TOTAL GROUND FLOOR FACADE =1925.25 SF GLAZING = 552 SF 552/1925.25 = 28%


> WINDOWS SHALL BE RECESSED 2 INCHES AS PER 14-16-5-11(C)(2) PROVIDE LOW-E GLAZING AT ALL WEST FACING FACADES PER IDO

14-16-5-11 (D)(2)(a)(3) PROVIDE FULL SHEILDS AT ALL WALL MOUNTED LIGHT FIXTURES



BUILDING 1 ELEVATIONS


PROJECT

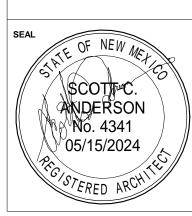

| DESIGNED Designer | . ^{NO} 18-072 |
|----------------------|------------------------|
| DRAWN Author | SCALE 1/8" = 1'-0" |
| CHECKED Checker | DRAWING NO |
| REVIEWED Designer | Δ- |
| DATE | |

05/15/2024

A-201

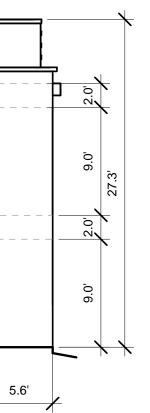




BUILDING 1 SOUTH COLOR ELEVATION 1/8" = 1'-0"




BUILDING 1 NORTH COLOR ELEVATION

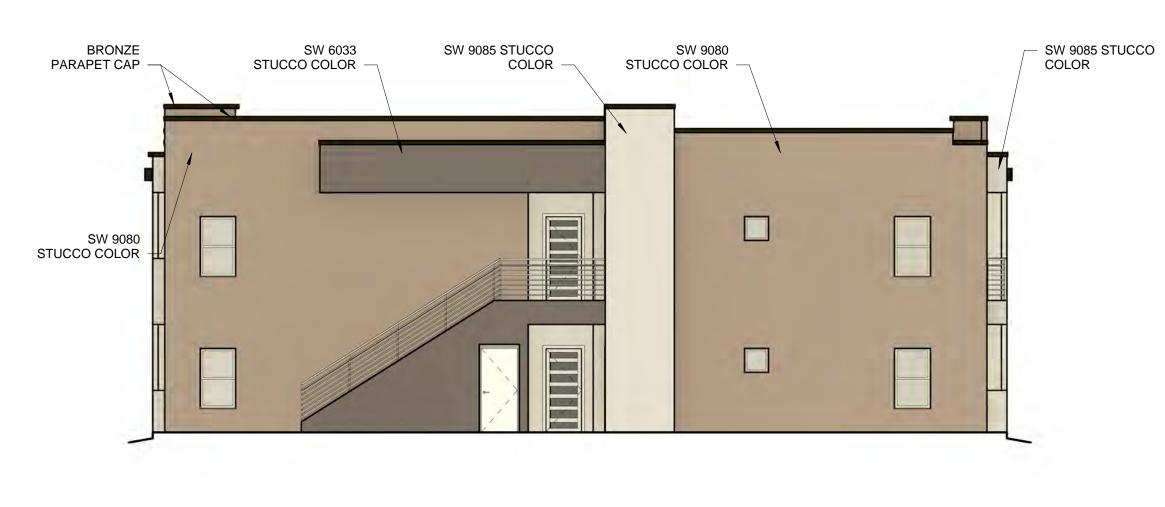

BUILDING 1 EAST COLOR ELEVATION

BUILDING 1 WEST COLOR ELEVATION

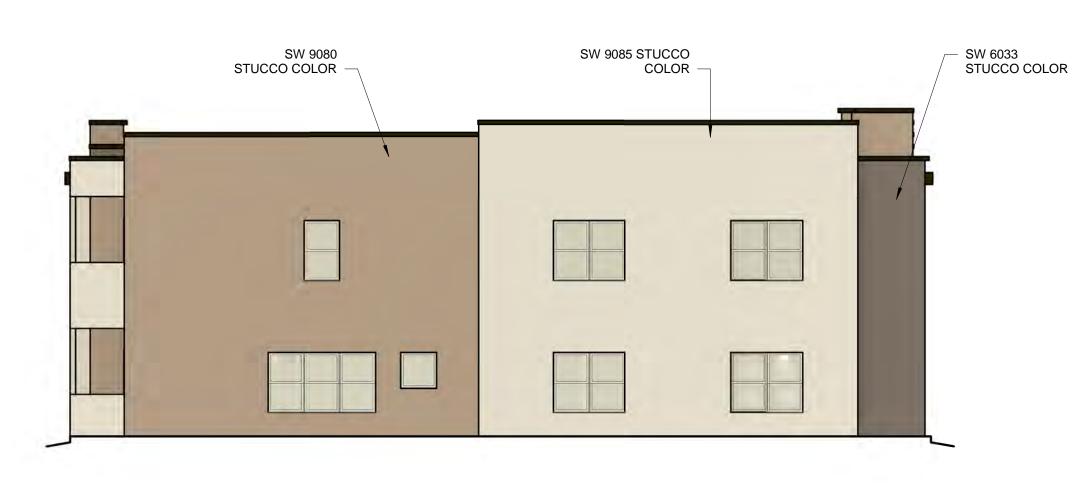

WINDOWS SHALL BE RECESSED 2 INCHES AS PER 14-16-5-11(C)(2)

PROVIDE LOW-E GLAZING AT ALL WEST FACING FACADES PER IDO 14-16-5-11 (D)(2)(a)(3)

PROVIDE FULL SHEILDS AT ALL WALL MOUNTED LIGHT FIXTURES



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SCOTPC. ANDERSON No. 4341 05/15/2024

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SCOTT C. ANDERSON & associates architects 2818 4th St NW, Suite C Albuquerque NM 87107 scott@scaarchitects.com 505.401.7575

UNIVERESE VIEW APARTMENTS PERESOSO TRAIL NW ALBUQERQUE, NEW MEXICO

BUILDING 1 COLOR ELEVATIONS

Designed No 18-072

SCALE

Designer DRAWN Author


CHECKED Checker REVIEWED Designer


05/15/2024

DATE

A-201.C


1/8" = 1'-0"

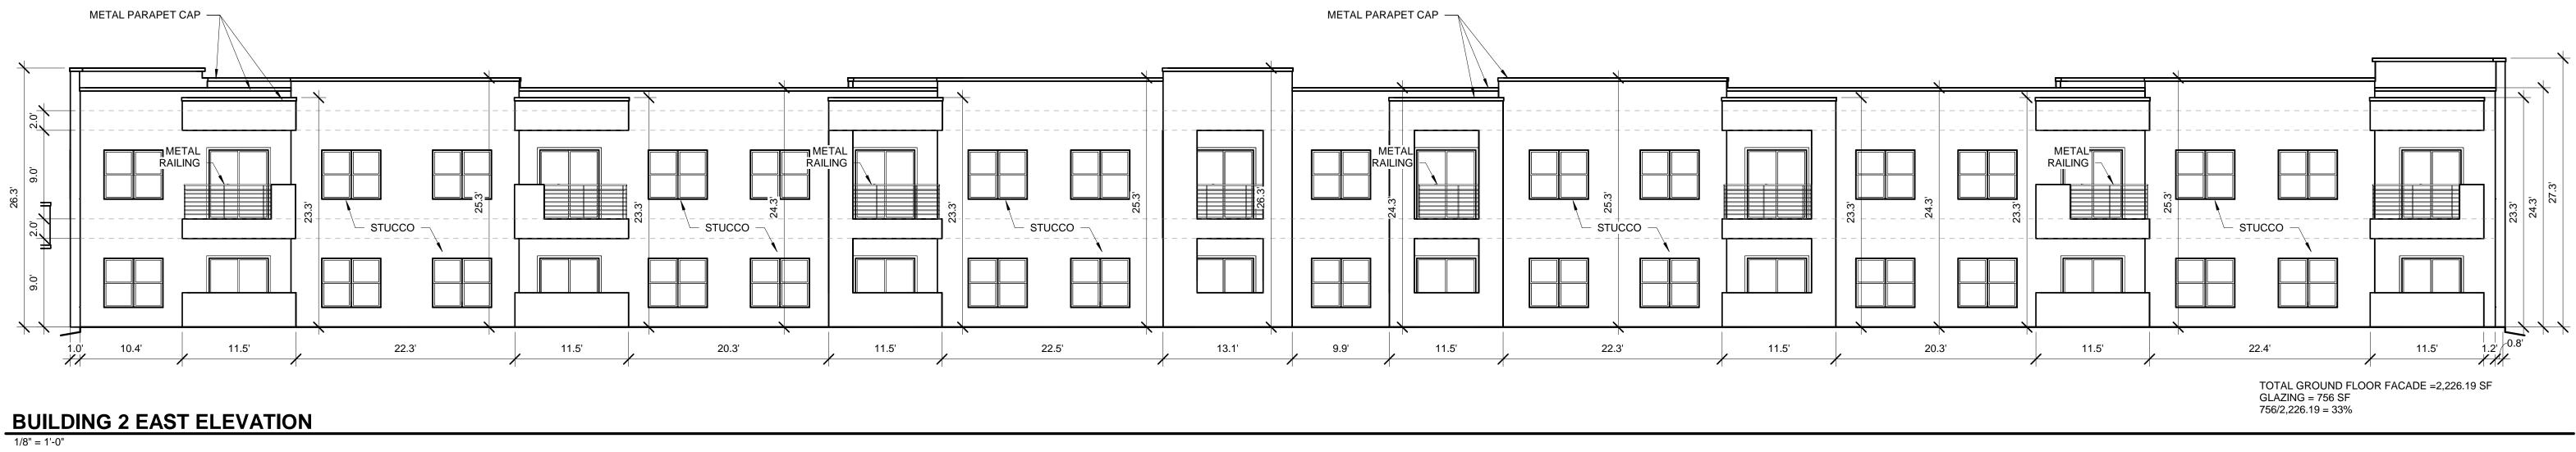

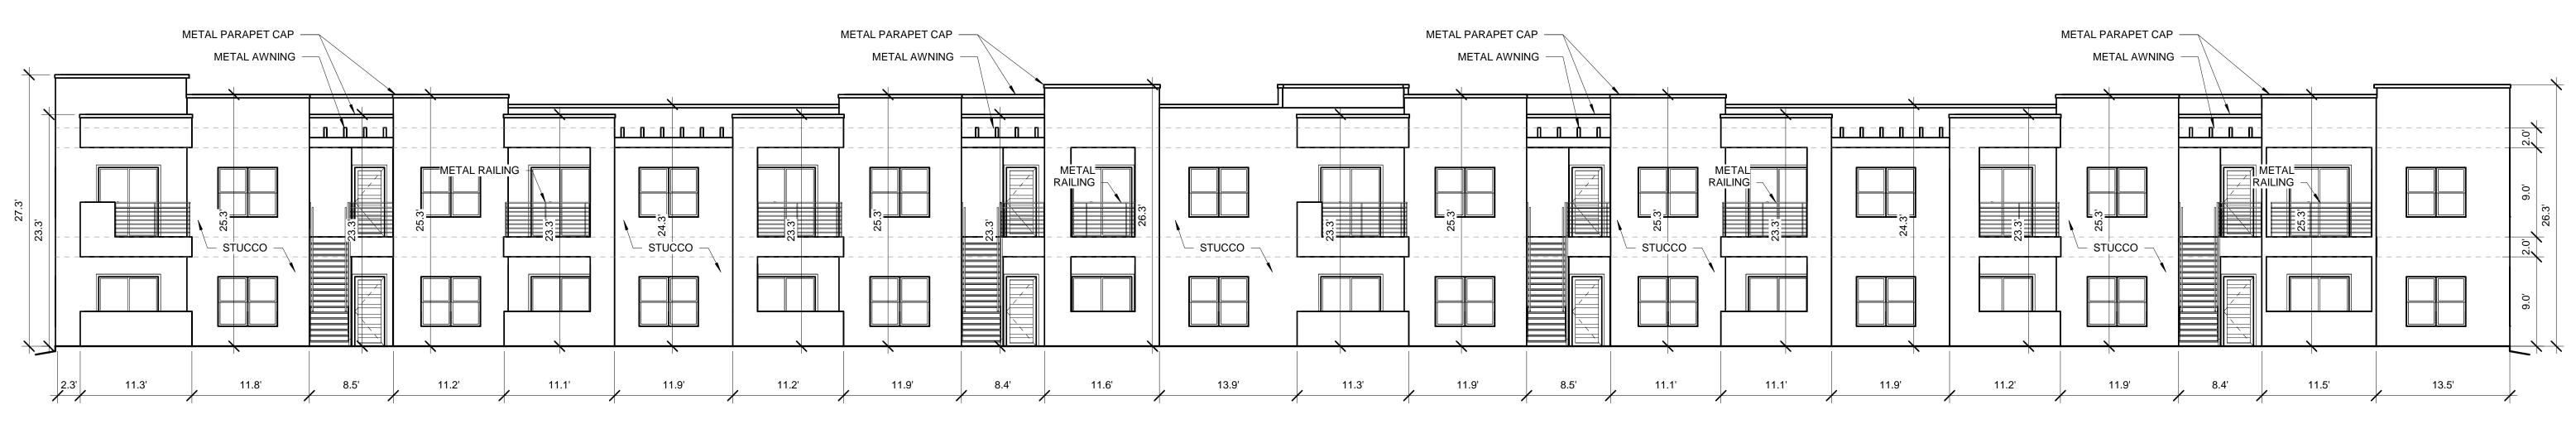

BUILDING 2 WEST ELEVATION

1/8" = 1'-0"

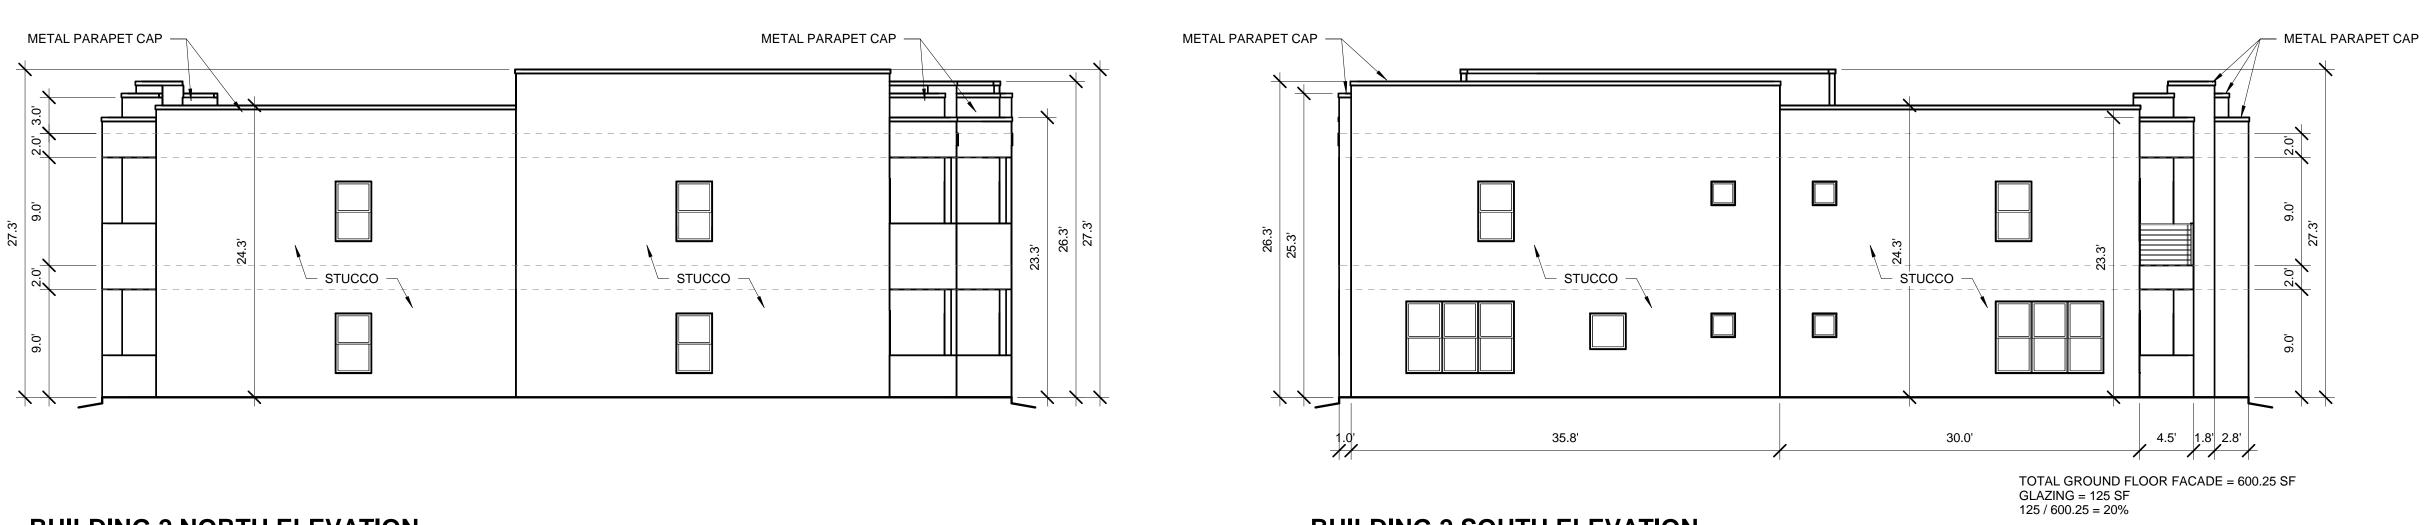

BUILDING 2 NORTH ELEVATION

BUILDING 2 SOUTH ELEVATION

WINDOWS SHALL BE RECESSED 2 INCHES AS PER 14-16-5-11(C)(2) PROVIDE LOW-E GLAZING AT ALL WEST FACING FACADES PER IDO 14-16-5-11 (D)(2)(a)(3)

PROVIDE FULL SHEILDS AT ALL WALL MOUNTED LIGHT FIXTURES




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UNIVERESE VIEW APARTMENTS PERESOSO TRAIL NW ALBUQERQUE, NEW MEXICO DRAWING TITLE


05/15/2024

BUILDING 2 ELEVATIONS

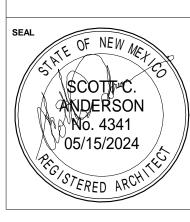

| DESIGNED Designer | PROJECT NO 18-072 |
|----------------------|-------------------------|
| DRAWN Author | SCALE 1/8" = 1'-0" |
| CHECKED Checker | DRAWING NO |
| REVIEWED Designer | A-2 |
| DATE |] |

A-202

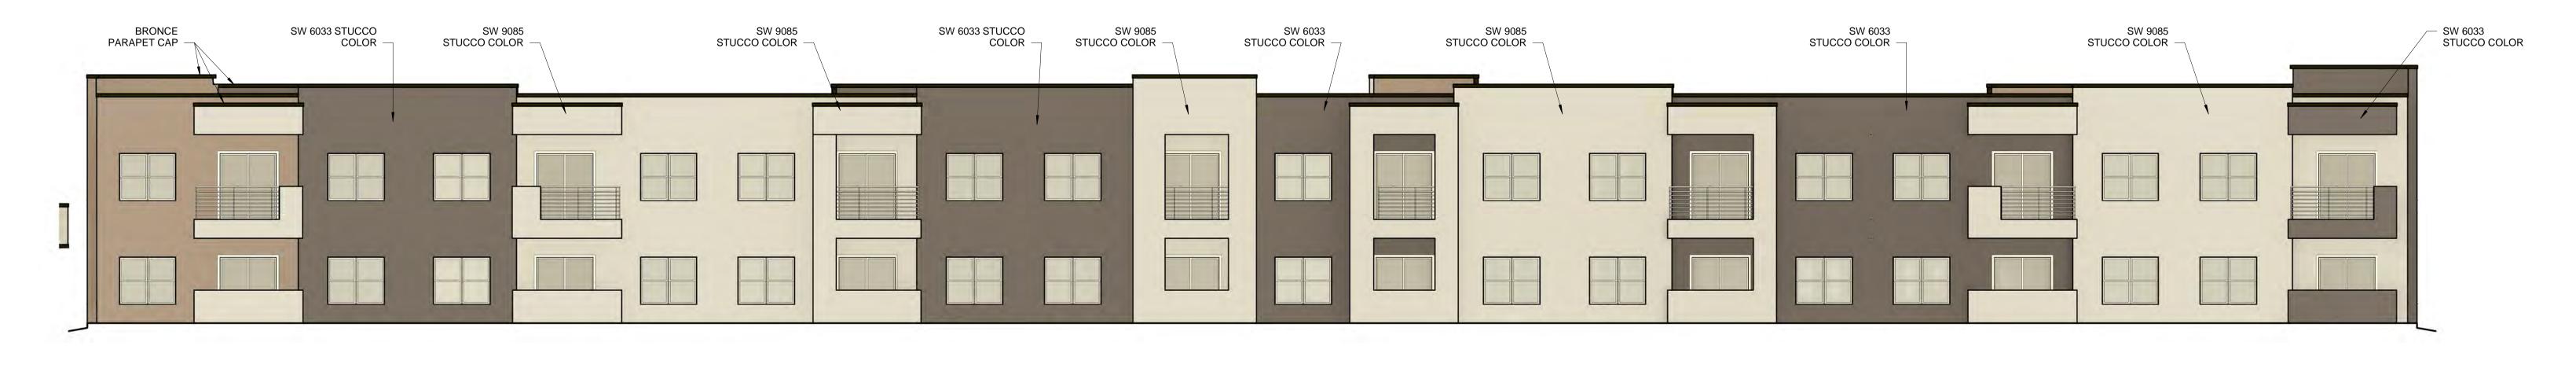


1 BUILDING 2 EAST COLOR ELEVATION 1/8" = 1'-0"

BRONCE AWNING BRONCE AWNING SW 9085 BRONCE AWNING SW 9085 BRONCE AWNING STUCCO COLOR


2 BUILDING 2 WEST COLOR ELEVATION


1/8" = 1'-0"

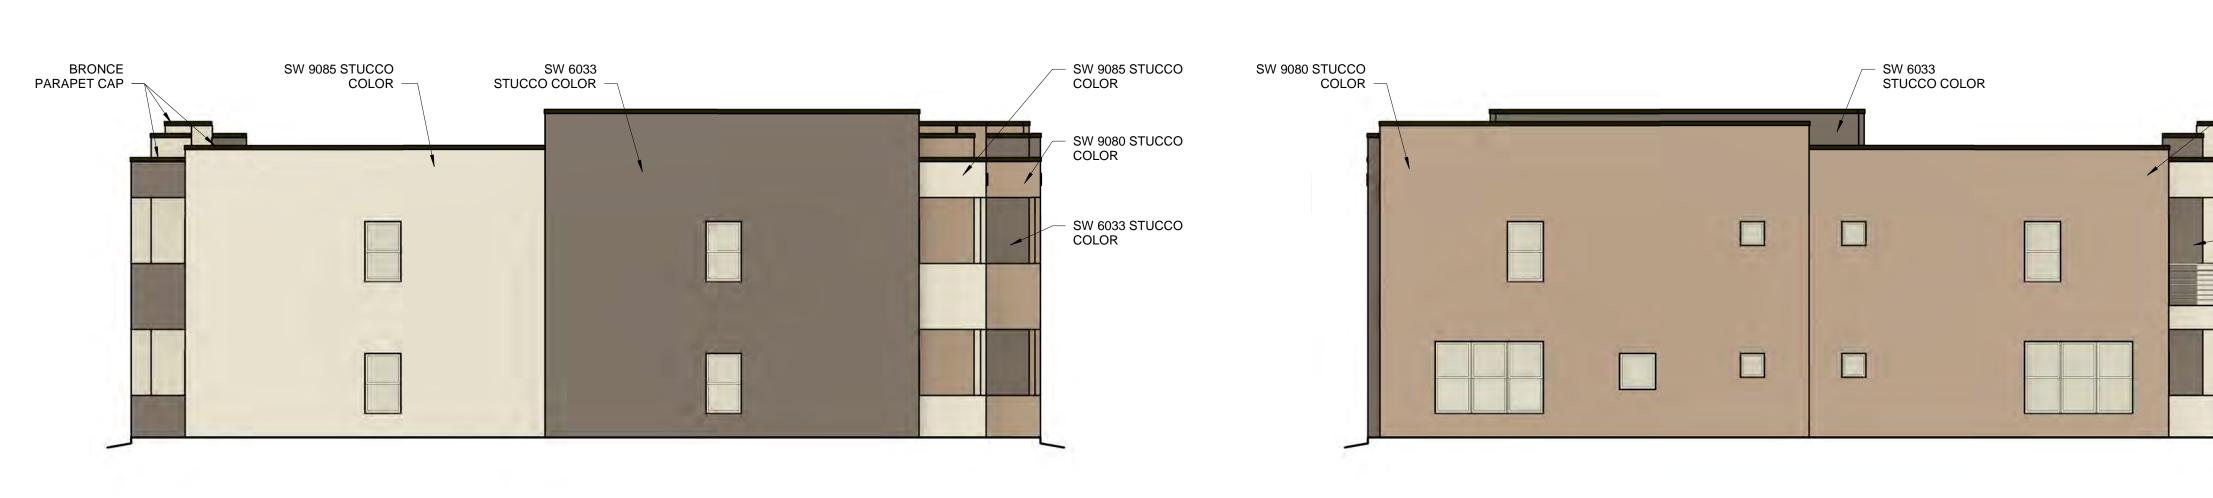


3 BUILDING 2 NORTH COLOR ELEVATION 1/8" = 1'-0"


4 BUILDING 2 SOUTH COLOR ELEVATION 1/8" = 1'-0"

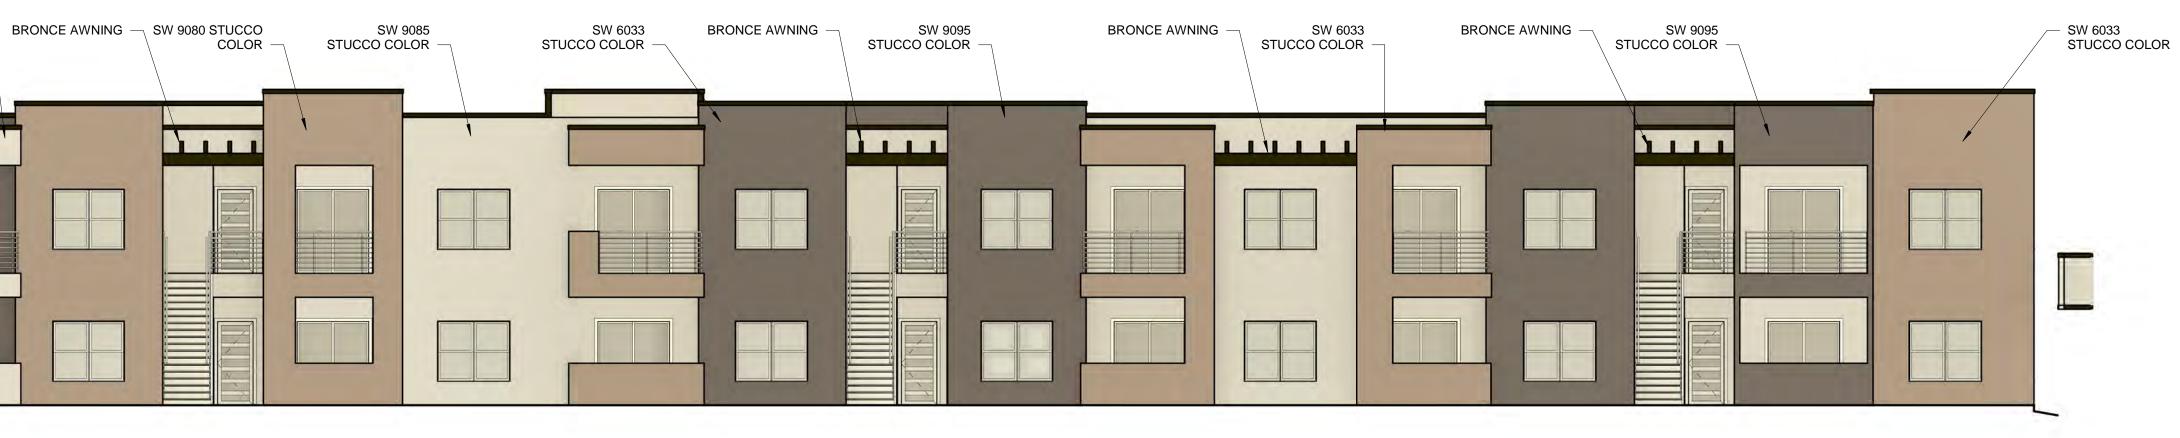

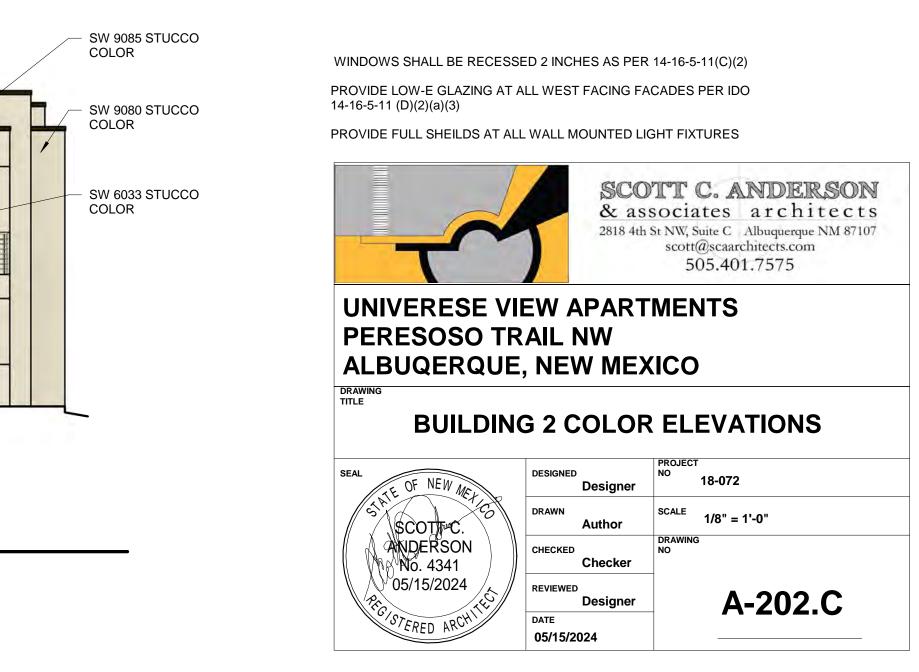


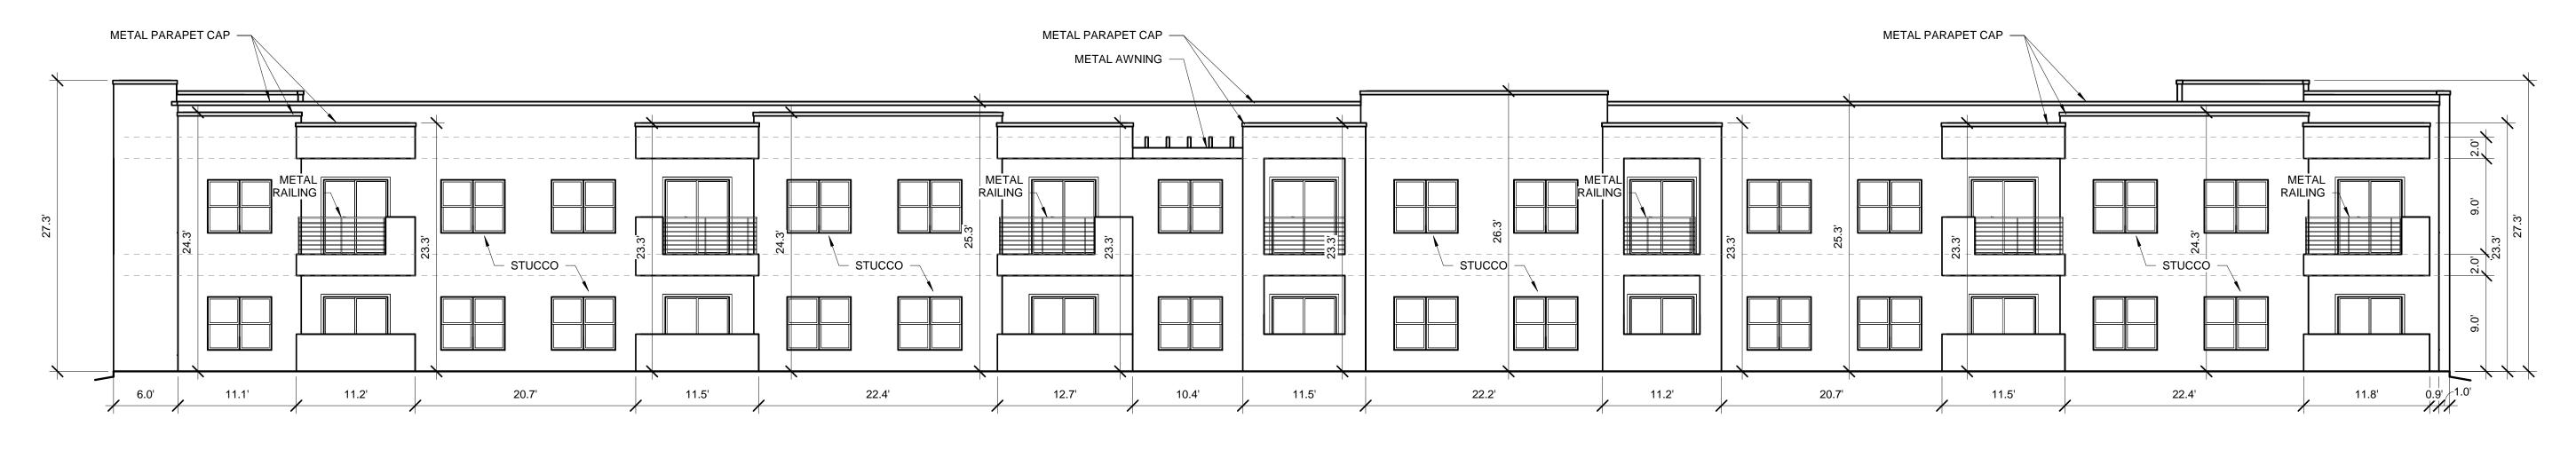



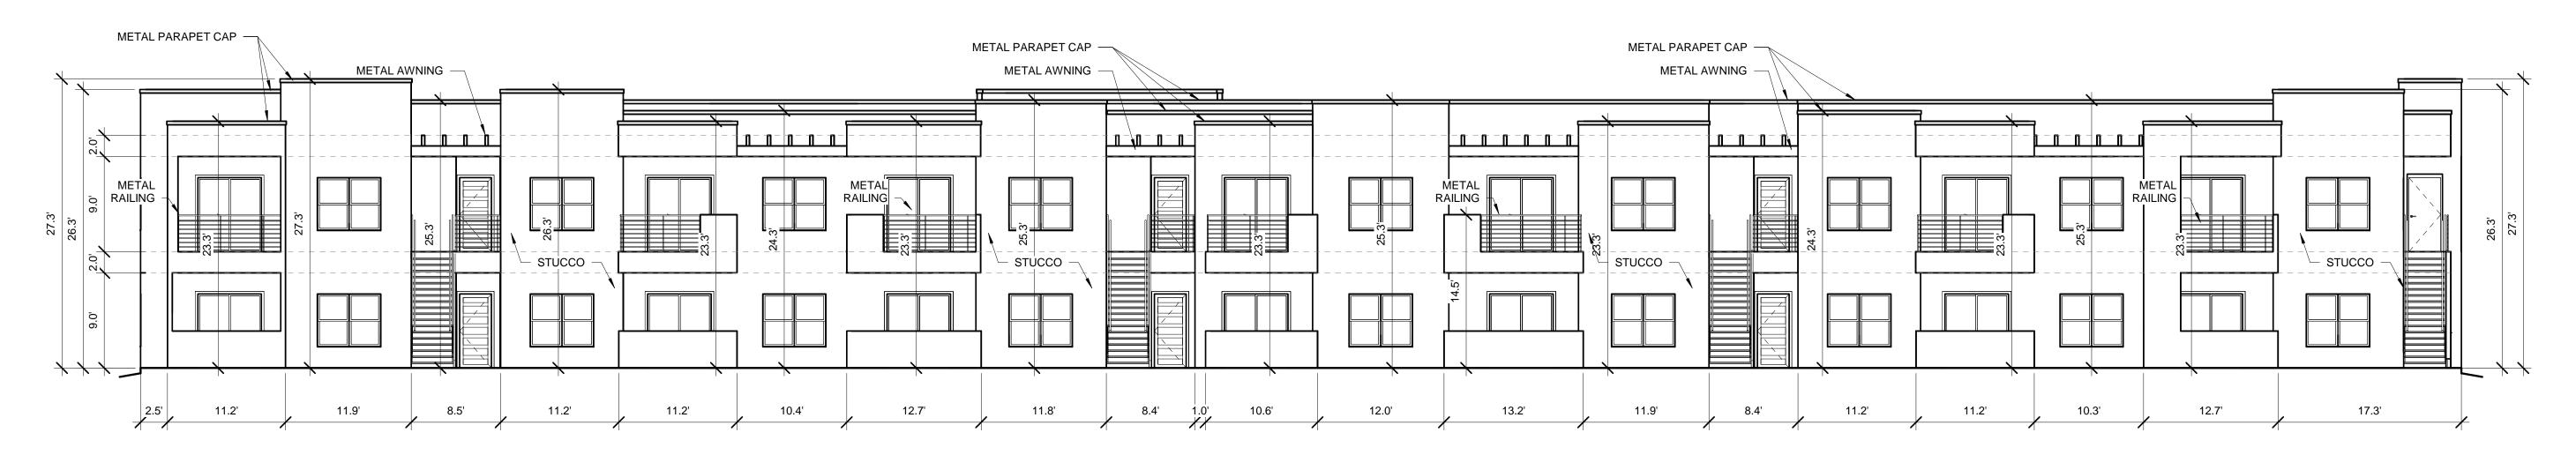



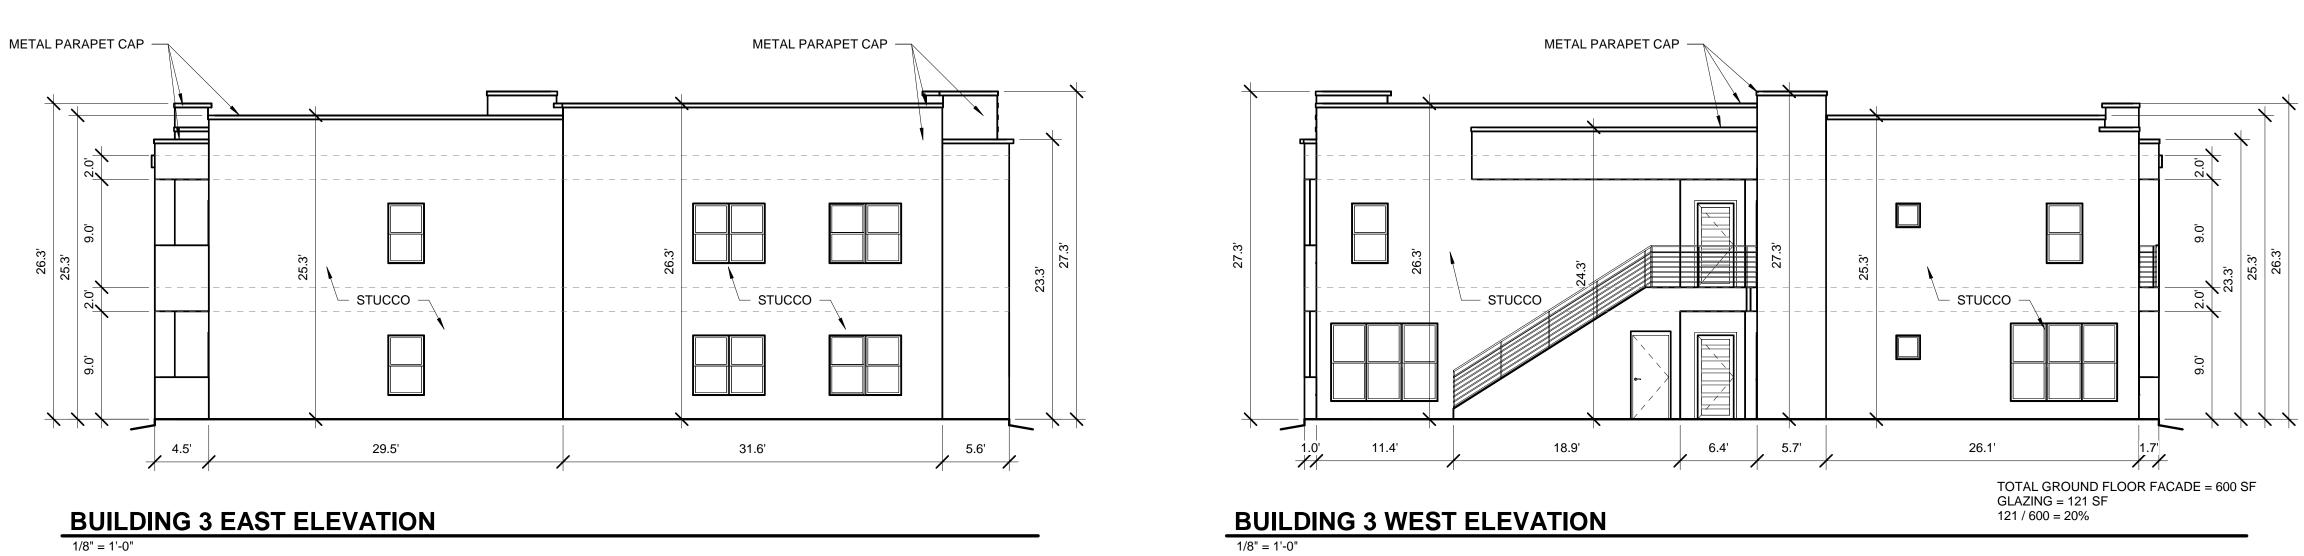



WINDOWS SHALL BE RECESSED 2 INCHES AS PER 14-16-5-11(C)(2) PROVIDE LOW-E GLAZING AT ALL WEST FACING FACADES PER IDO 14-16-5-11 (D)(2)(a)(3)

PROVIDE FULL SHEILDS AT ALL WALL MOUNTED LIGHT FIXTURES



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UNIVERESE VIEW APARTMENTS PERESOSO TRAIL NW ALBUQERQUE, NEW MEXICO DRAWING TITLE

DESIGNED

DATE

05/15/2024


BUILDING 3 ELEVATIONS

PROJECT

18-072

1/8" = 1'-0"


NO

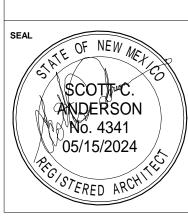

Designer DRAWN SCALE Author CHECKED Checker REVIEWED Designer



BUILDING 3 EAST COLOR ELEVATION

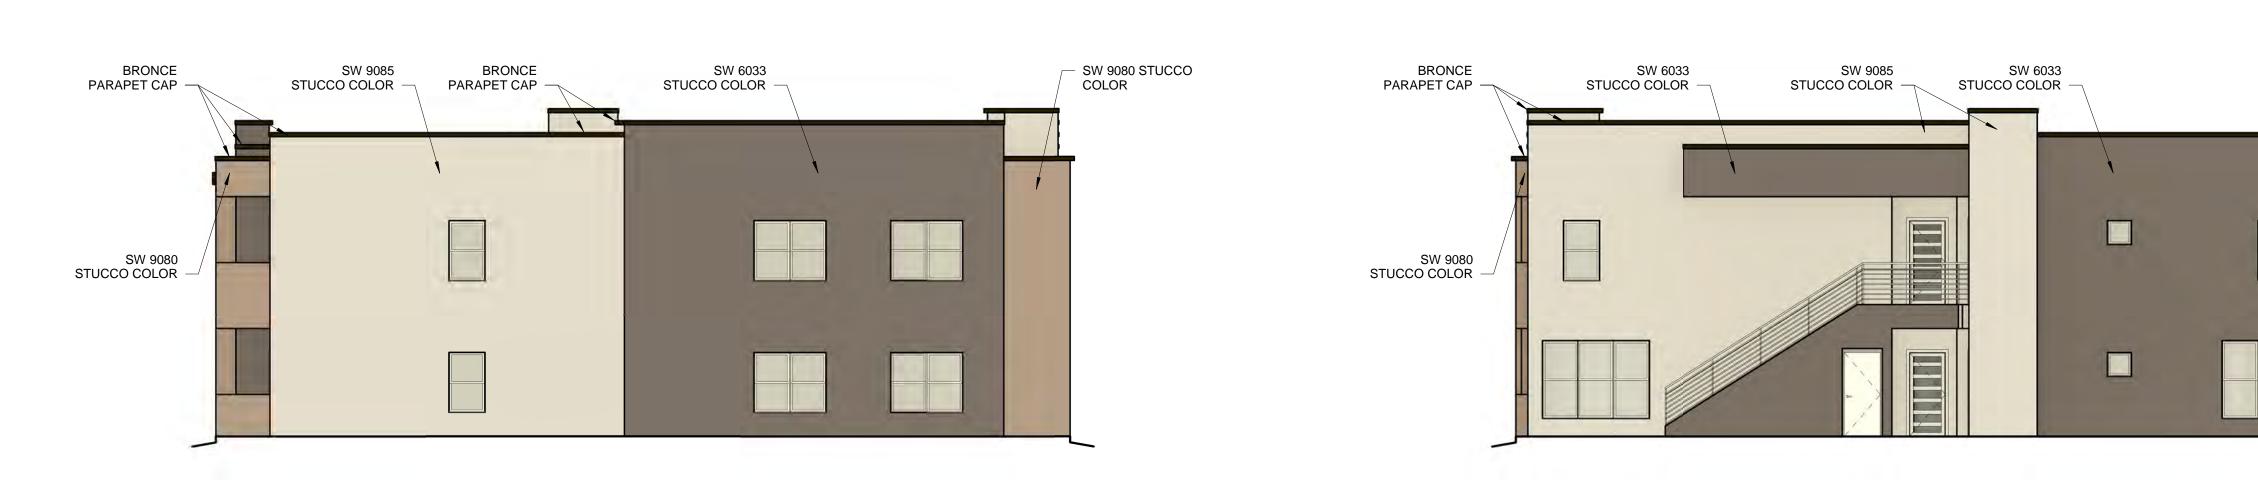

BUILDING 3 NORTH COLOR ELEVATION



BUILDING 3 SOUTH COLOR ELEVATION



BUILDING 3 WEST COLOR ELEVATION





UNIVERESE VIEW APARTMENTS PERESOSO TRAIL NW

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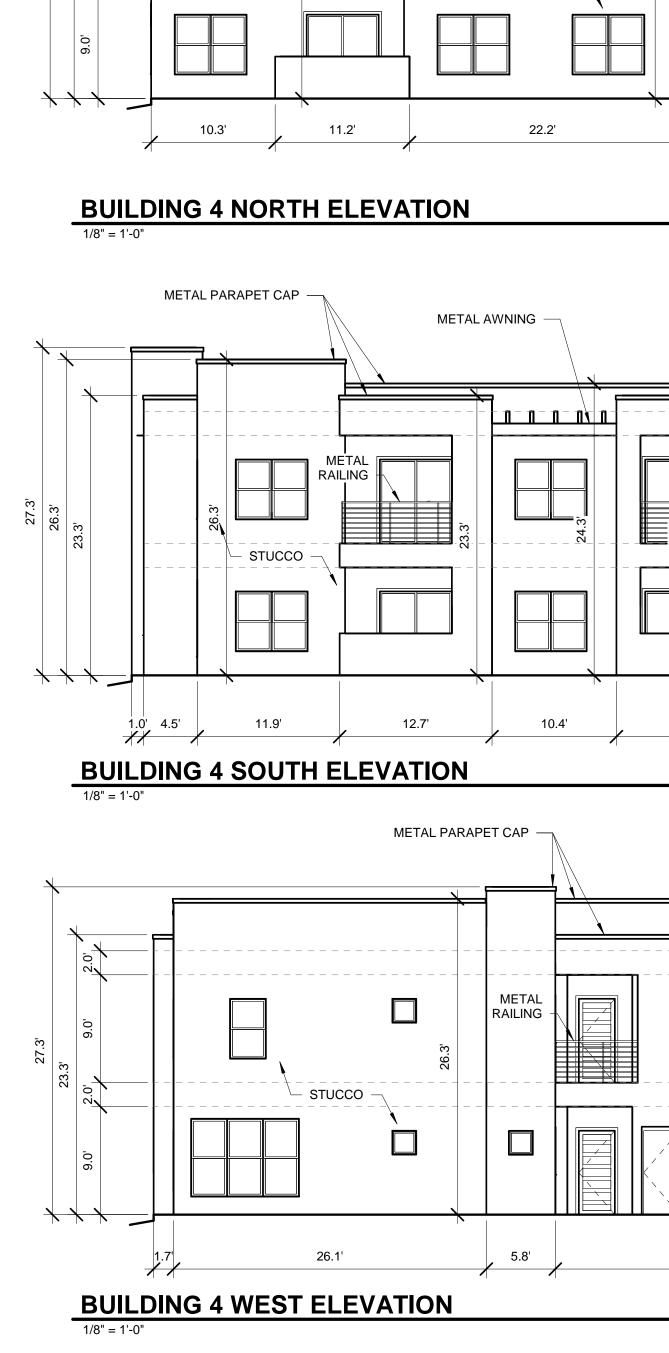
PROVIDE FULL SHEILDS AT ALL WALL MOUNTED LIGHT FIXTURES

PROVIDE LOW-E GLAZING AT ALL WEST FACING FACADES PER IDO

WINDOWS SHALL BE RECESSED 2 INCHES AS PER 14-16-5-11(C)(2)



- SW 9080 STUCCO COLOR



METAL PARAPET CAP

RAILING

0.0


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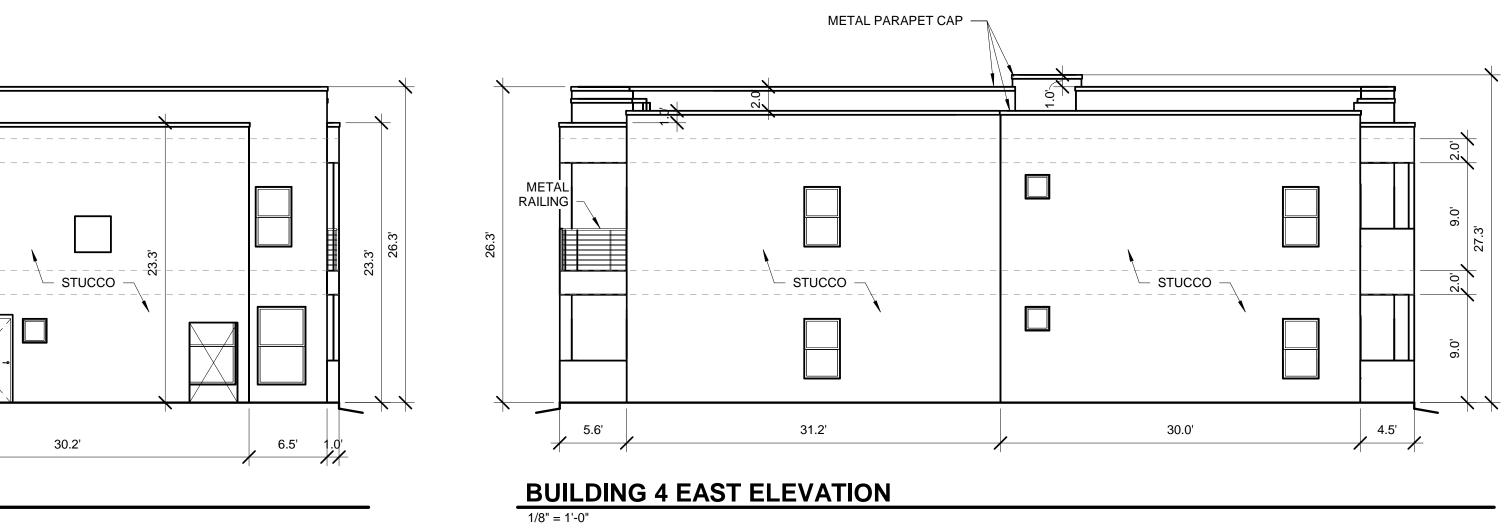
25.3 24.3' - - - - -

_ _ _ _ _ _

- STUCCO —






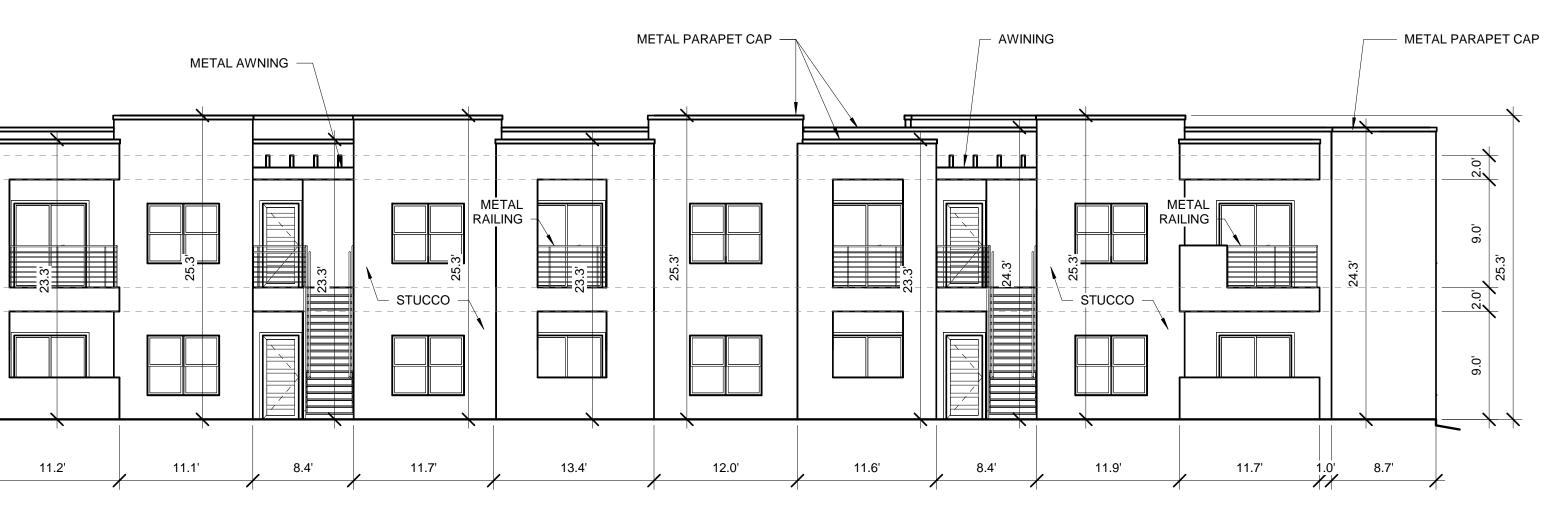

TOTAL GROUND FLOOR FACADE = 600 SF GLAZING = 123 SF 123 / 600 = .20% WINDOWS SHALL BE RECESSED 2 INCHES AS PER 14-16-5-11(C)(2) PROVIDE LOW-E GLAZING AT ALL WEST FACING FACADES PER IDO 14-16-5-11 (D)(2)(a)(3)

PROVIDE FULL SHEILDS AT ALL WALL MOUNTED LIGHT FIXTURES

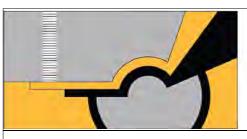


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UNIVERESE VIEW APARTMENTS PERESOSO TRAIL NW ALBUQERQUE, NEW MEXICO

BUILDING 4 ELEVATIONS

PROJECT

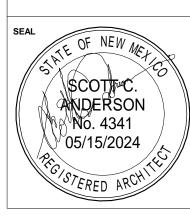

 Designer
 NO
 18-072


 DRAWN
 SCALE
 1/8" = 1'-0"

 CHECKED
 DRAWING
 DRAWING

 REVIEWED
 Designer
 Author

05/15/2024

A-204

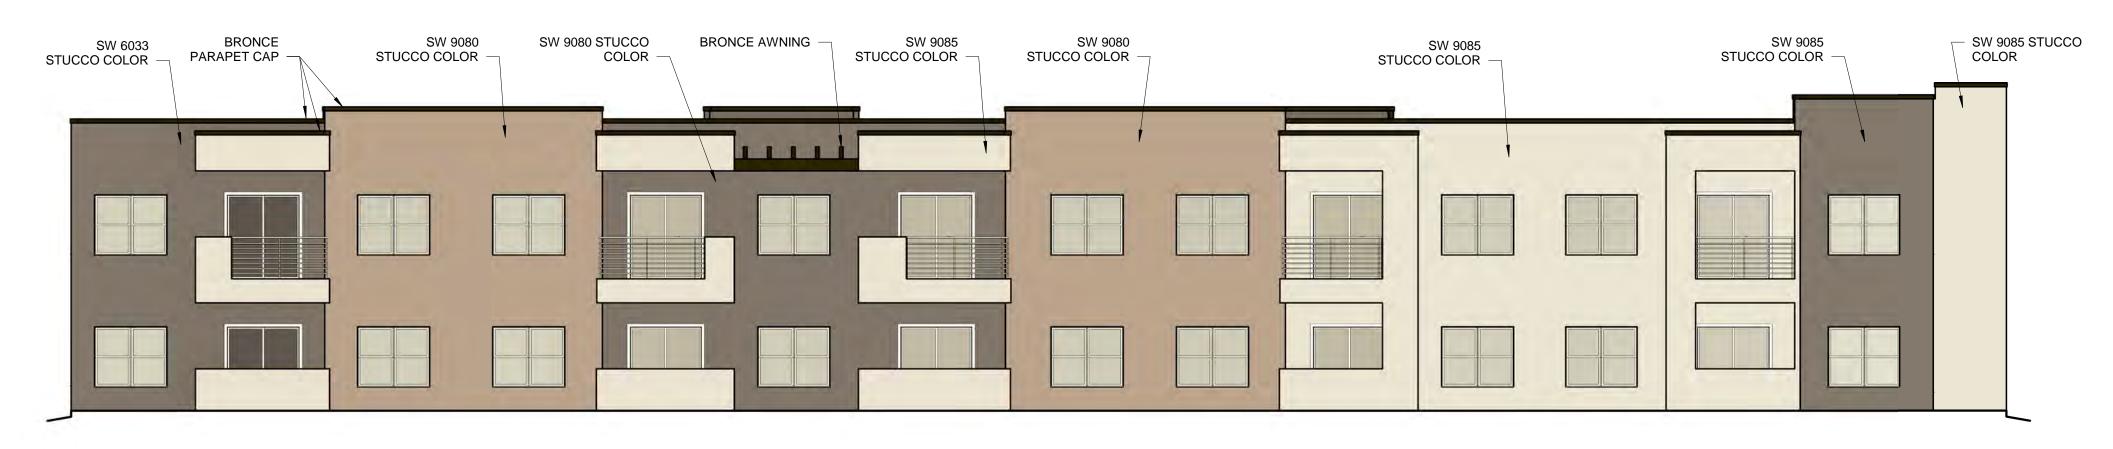


BUILDING 4 NORTH COLOR ELEVATION 1/8" = 1'-0"



BUILDING 4 SOUTH COLOR ELEVATION 1/8" = 1'-0"

SW 6033 STUCCO COLOR -SW 9085 STUCCO COLOR -BRONCE PARAPET CAP STUCCO COLOR SW 9085 STUCCO COLOR


BUILDING 4 WEST COLOR ELEVATION

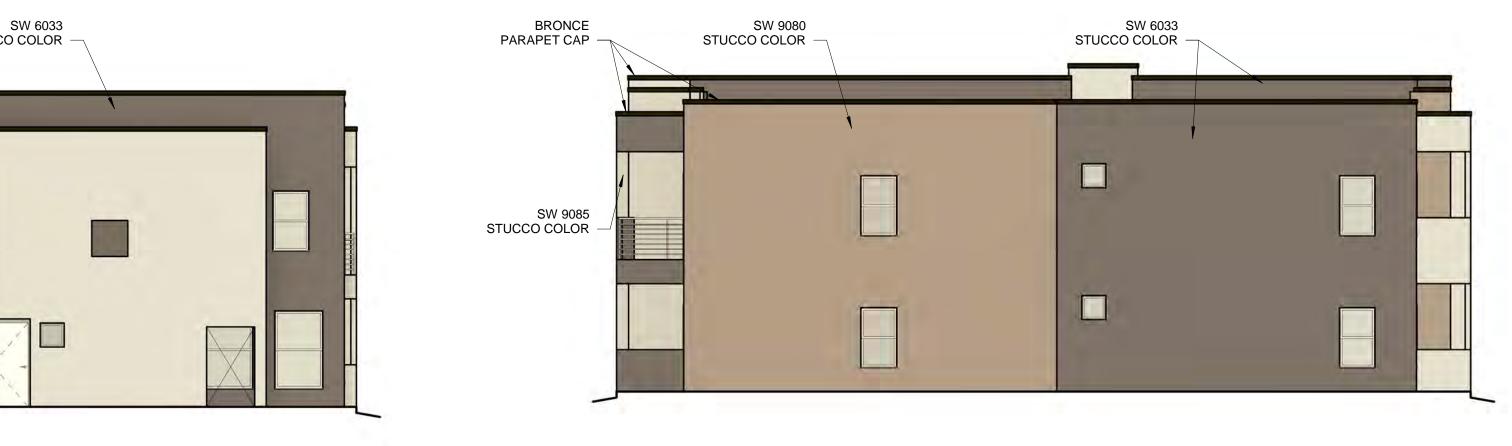

BUILDING 4 EAST COLOR ELEVATION

WINDOWS SHALL BE RECESSED 2 INCHES AS PER 14-16-5-11(C)(2) PROVIDE LOW-E GLAZING AT ALL WEST FACING FACADES PER IDO

PROVIDE FULL SHEILDS AT ALL WALL MOUNTED LIGHT FIXTURES

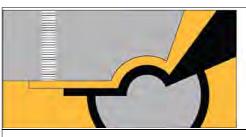

14-16-5-11 (D)(2)(a)(3)

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SCOTTPC. ANDERSON No. 4341 05/15/2024

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SCOTT C. ANDERSON & associates architects 2818 4th St NW, Suite C Albuquerque NM 87107 scott@scaarchitects.com 505.401.7575

UNIVERESE VIEW APARTMENTS PERESOSO TRAIL NW ALBUQERQUE, NEW MEXICO DRAWING TITLE

BUILDING 4 COLOR ELEVATIONS

PROJECT DESIGNED NO 18-072 Designer

SCALE


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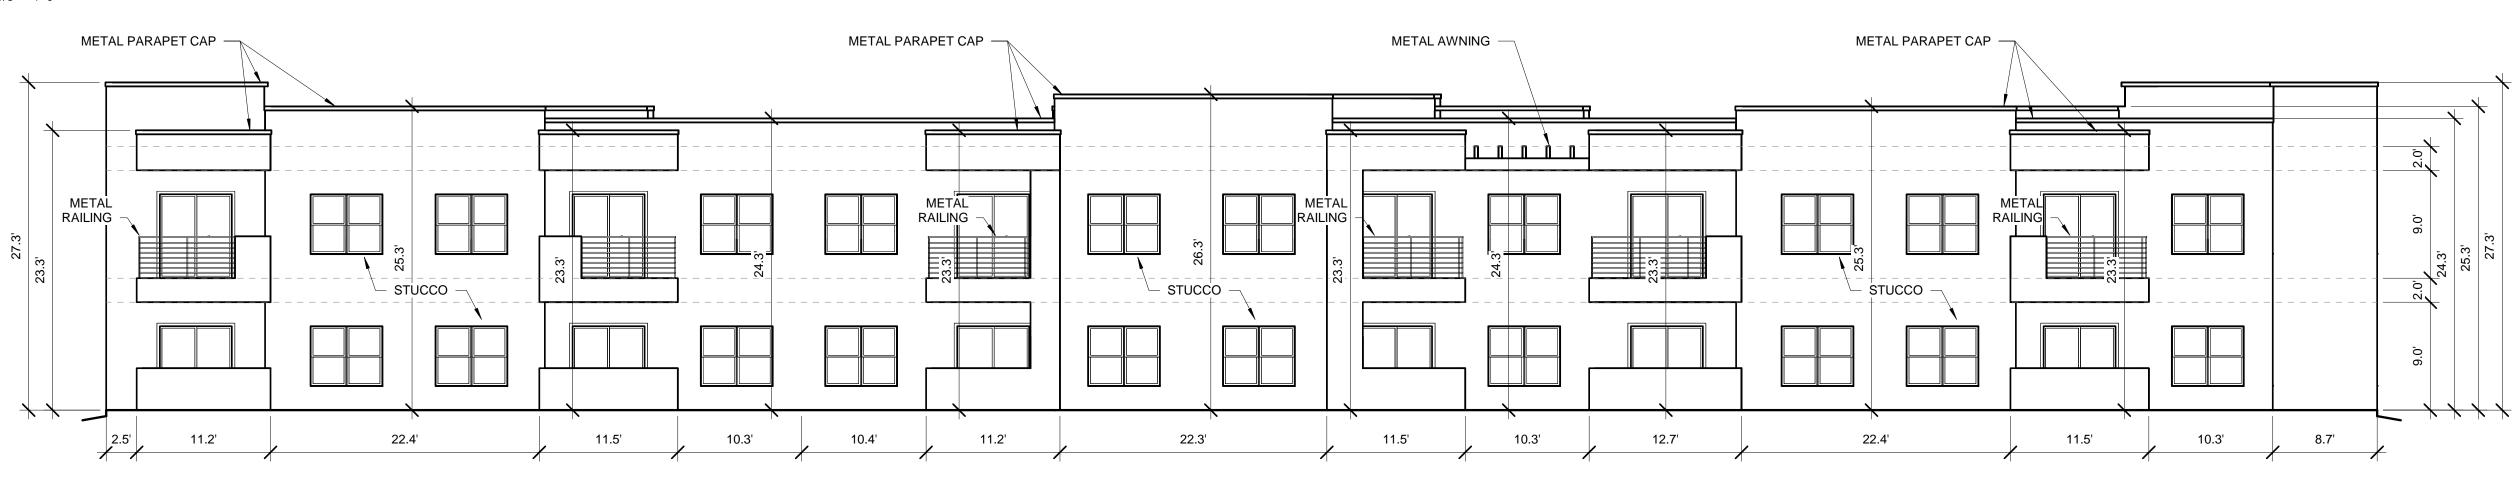
Checker REVIEWED Designer DATE 05/15/2024

A-204.C


1/8" = 1'-0"

BUILDING 5 EAST ELEVATION 1/8" = 1'-0"



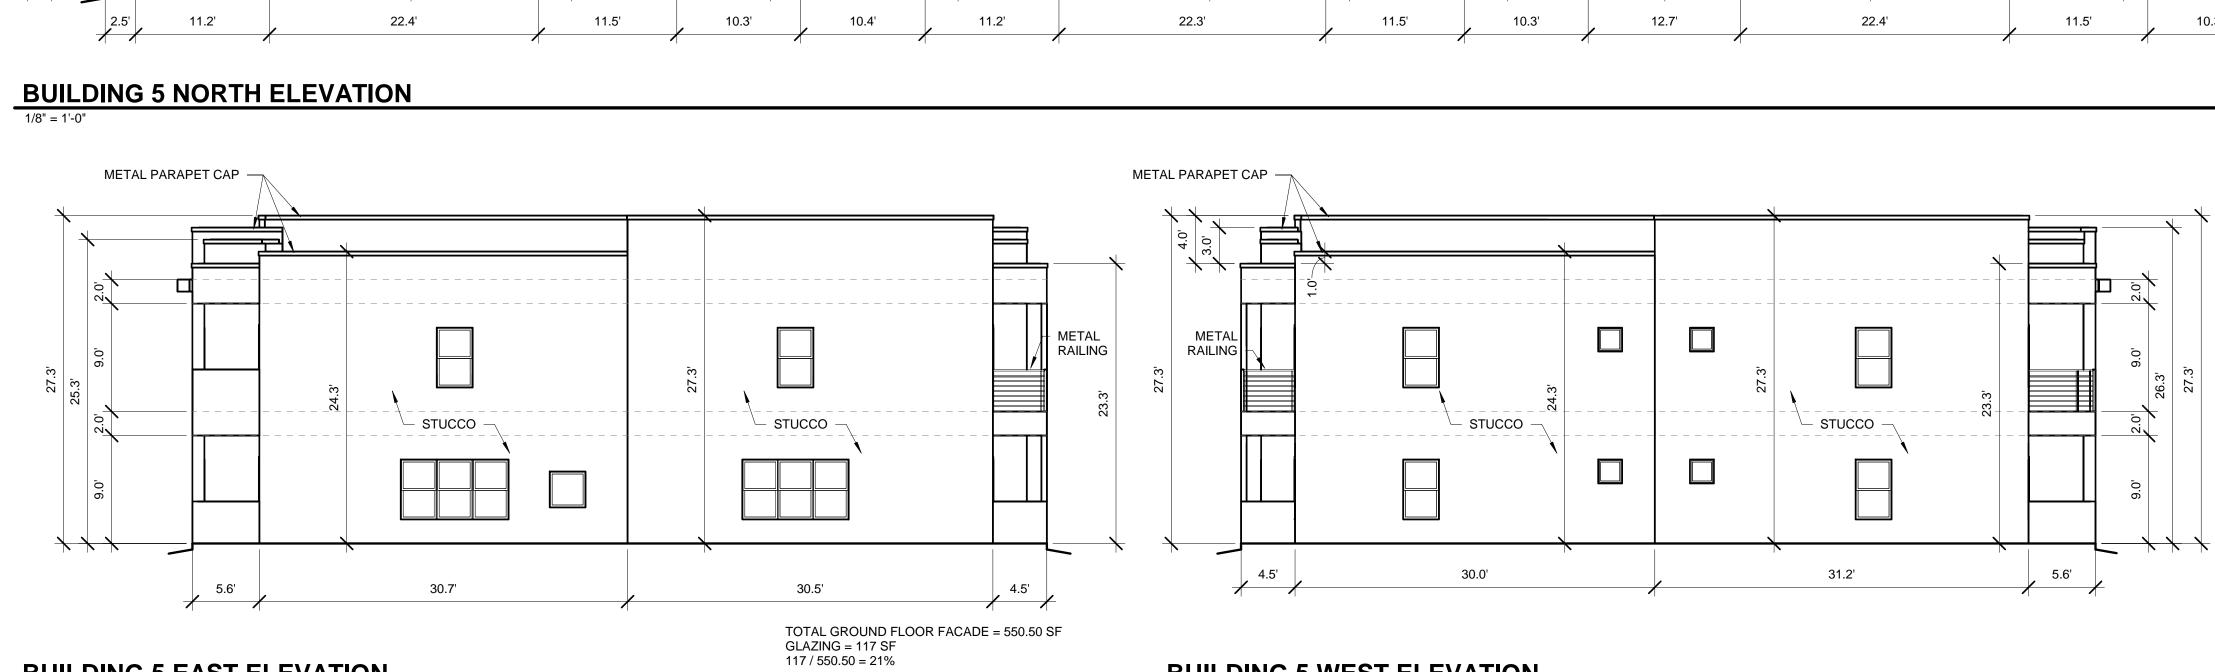

BUILDING 5 SOUTH ELEVATION

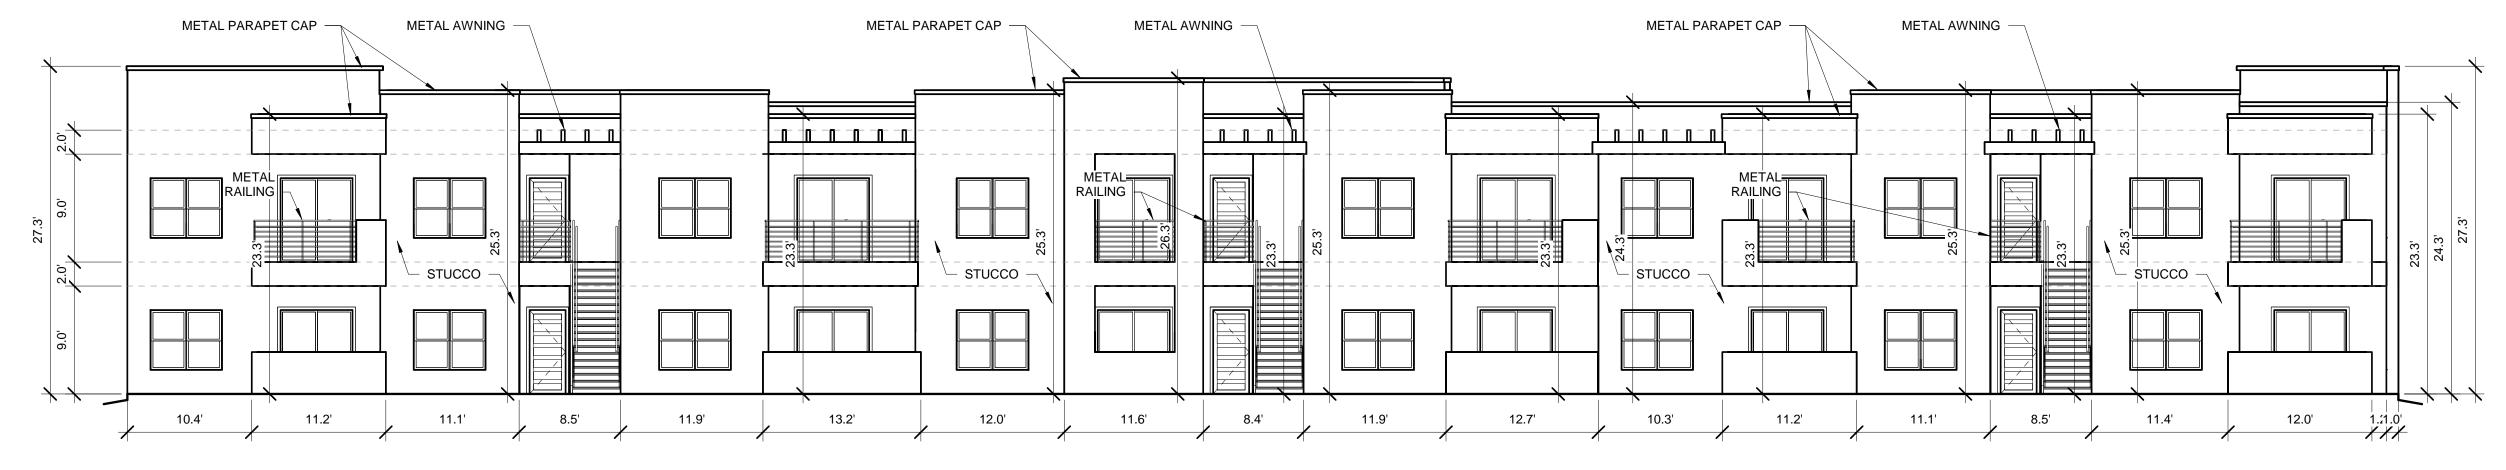

BUILDING 5 WEST ELEVATION

WINDOWS SHALL BE RECESSED 2 INCHES AS PER 14-16-5-11(C)(2) PROVIDE LOW-E GLAZING AT ALL WEST FACING FACADES PER IDO

14-16-5-11 (D)(2)(a)(3) PROVIDE FULL SHEILDS AT ALL WALL MOUNTED LIGHT FIXTURES



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UNIVERESE VIEW APARTMENTS PERESOSO TRAIL NW ALBUQERQUE, NEW MEXICO DRAWING TITLE


DESIGNED

05/15/2024

BUILDING 5 ELEVATIONS

PROJECT


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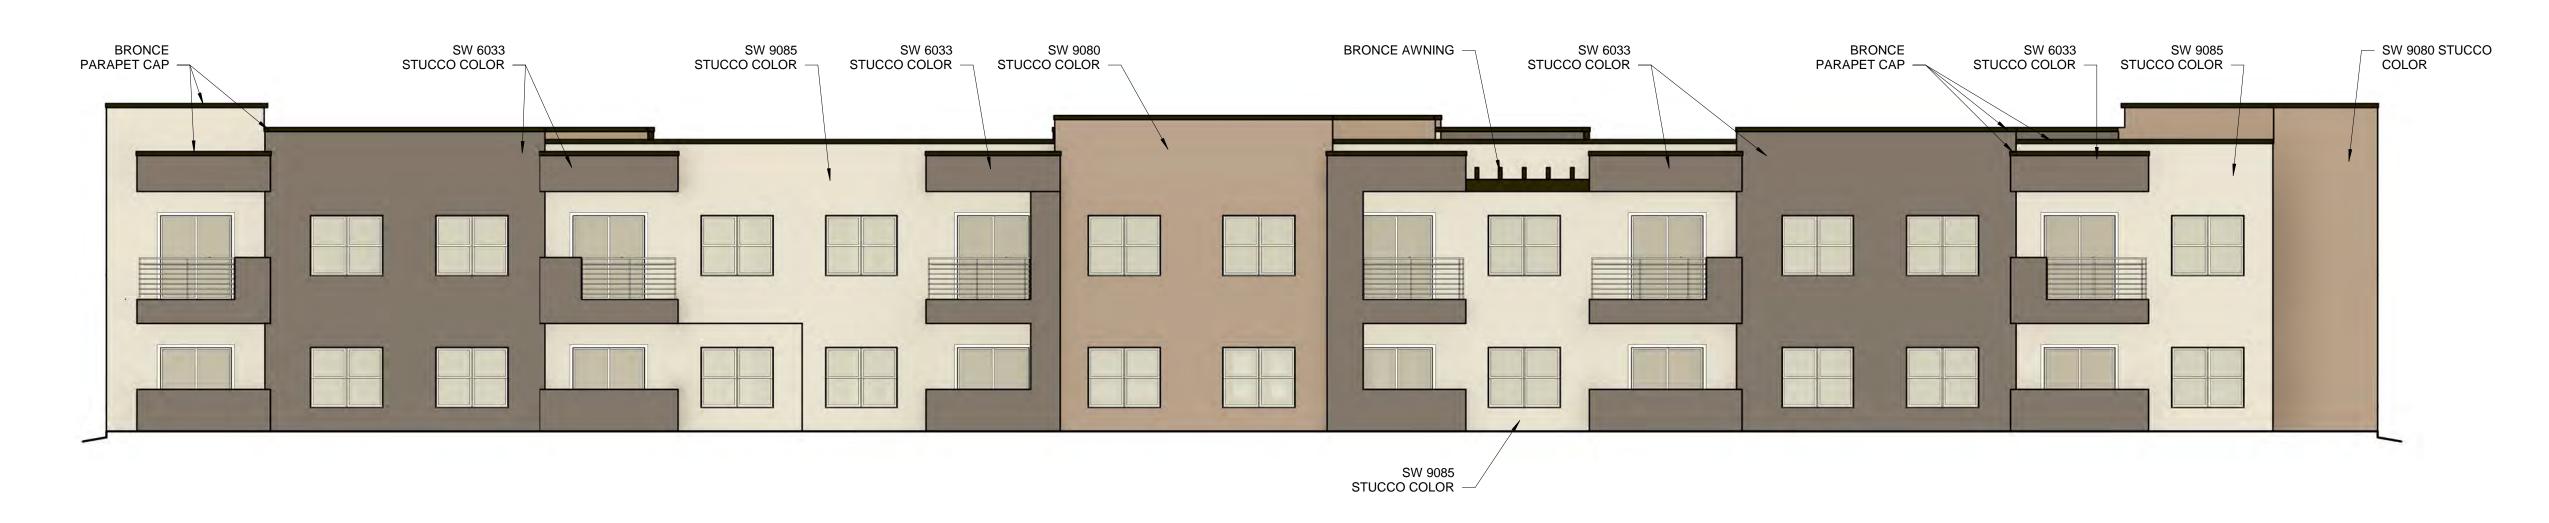
18-072 Designer DRAWN SCALE Author CHECKED Checker REVIEWED Designer DATE

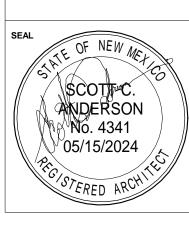A-205


1/8" = 1'-0"



BUILDING 5 SOUTH COLOR ELEVATION 1/8" = 1'-0"

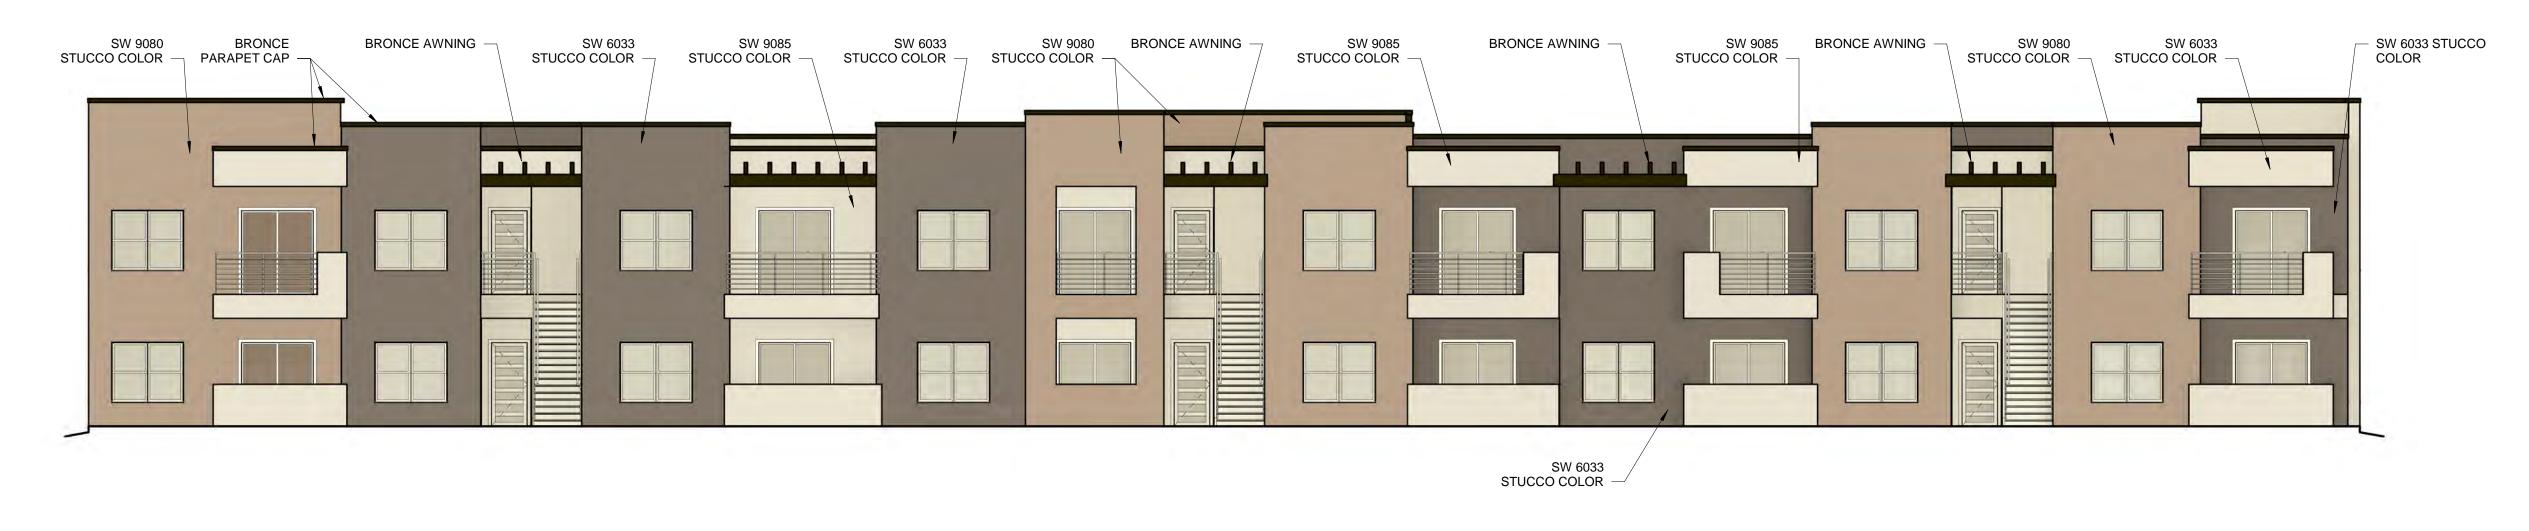


BUILDING 5 NORTH COLOR ELEVATION

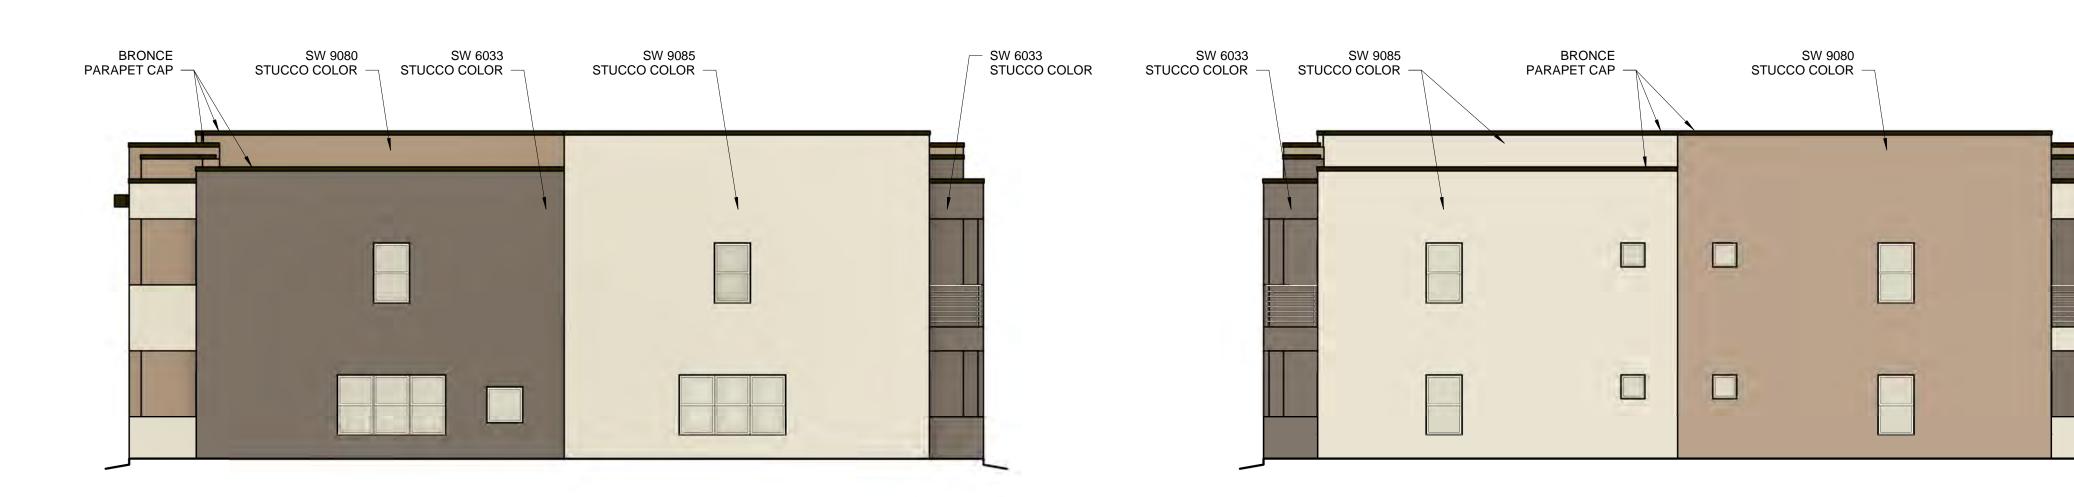

BUILDING 5 EAST COLOR ELEVATION

BUILDING 5 WEST COLOR ELEVATION

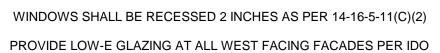

14-16-5-11 (D)(2)(a)(3)

PROVIDE FULL SHEILDS AT ALL WALL MOUNTED LIGHT FIXTURES


SW 6033
 STUCCO COLOR

SW 9080
 STUCCO COLOR

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UNIVERESE VIEW APARTMENTS PERESOSO TRAIL NW ALBUQERQUE, NEW MEXICO DRAWING TITLE


BUILDING 5 COLOR ELEVATIONS

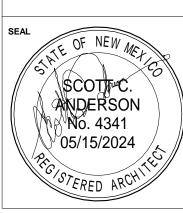


PROJECT DESIGNED NO 18-072 Designer DRAWN SCALE 1/8" = 1'-0" Author CHECKED Checker REVIEWED Designer DATE

05/15/2024


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BUILDING 6 NORTH ELEVATION

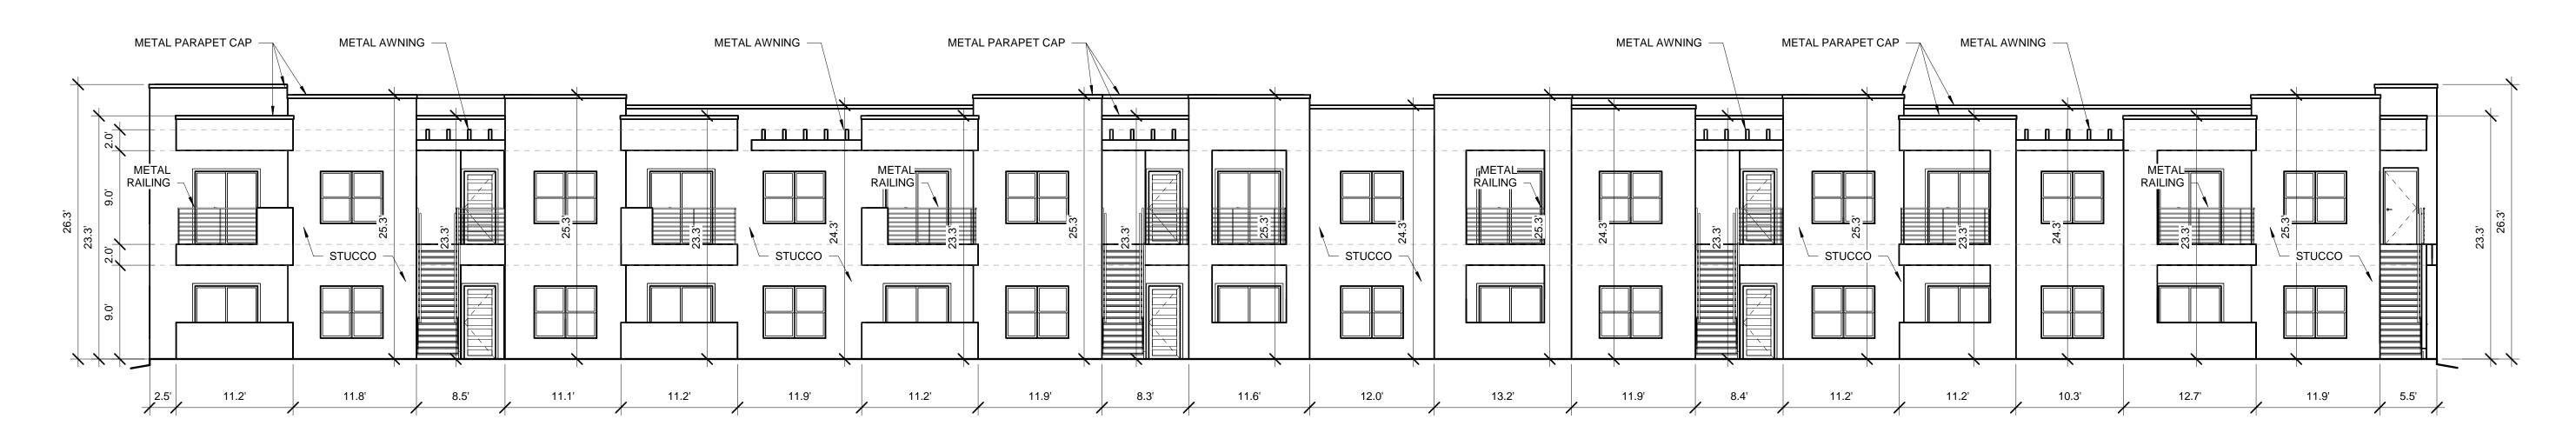


BUILDING 6 SOUTH ELEVATION

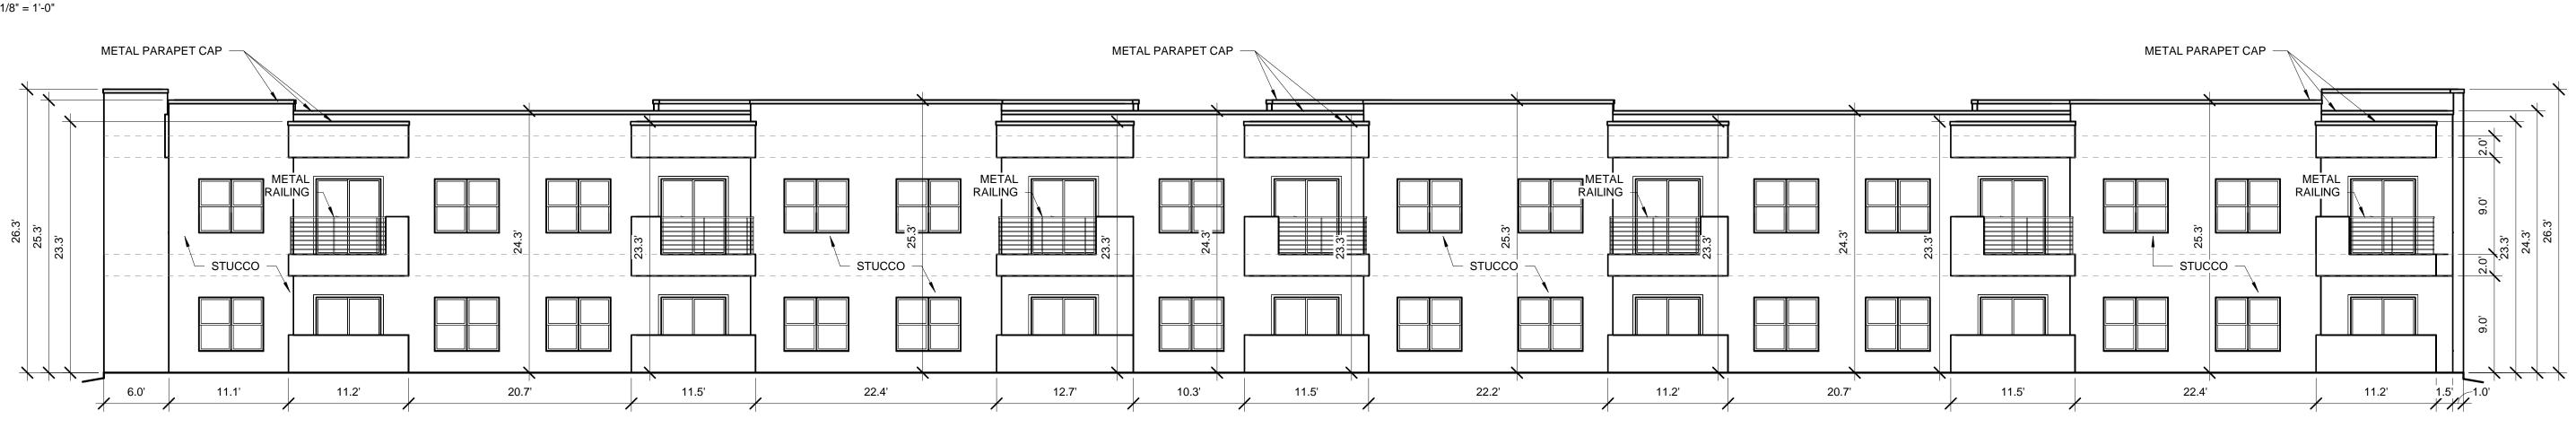

BUILDING 6 EAST ELEVAION

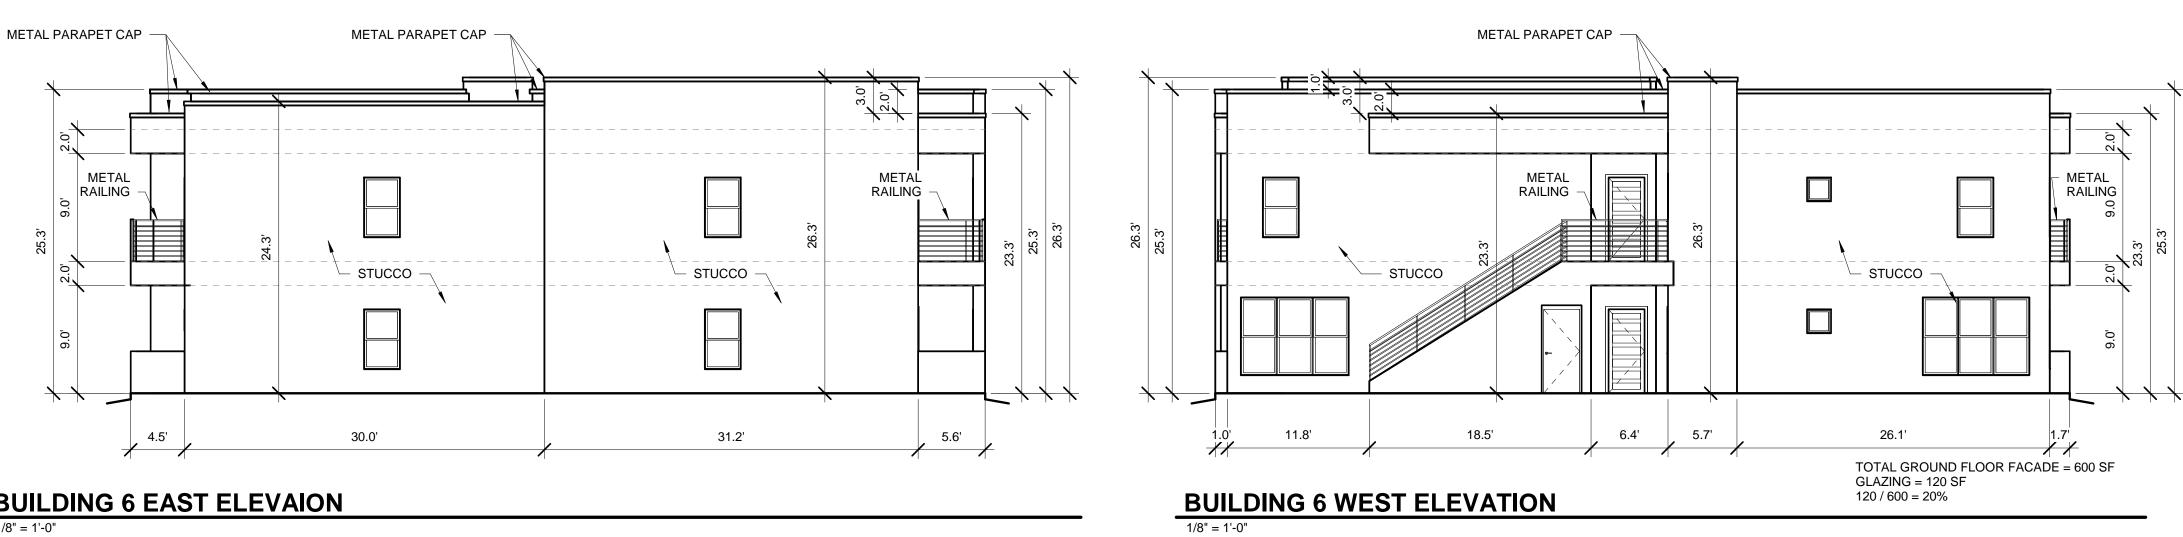WINDOWS SHALL BE RECESSED 2 INCHES AS PER 14-16-5-11(C)(2) PROVIDE LOW-E GLAZING AT ALL WEST FACING FACADES PER IDO 14-16-5-11 (D)(2)(a)(3)

PROVIDE FULL SHEILDS AT ALL WALL MOUNTED LIGHT FIXTURES

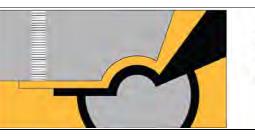


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UNIVERESE VIEW APARTMENTS PERESOSO TRAIL NW ALBUQERQUE, NEW MEXICO DRAWING TITLE


05/15/2024

BUILDING 6 ELEVATIONS

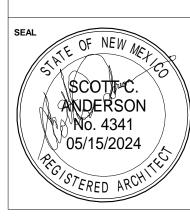


| DESIGNED | Designer | PROJECT NO | 18-072 |
|----------|----------|---------------|--------------|
| DRAWN | Author | SCALE | 1/8" = 1'-0" |
| CHECKED | Checker | DRAWING NO | |
| REVIEWED | Designer | | A-2 |
| DATE | | | |



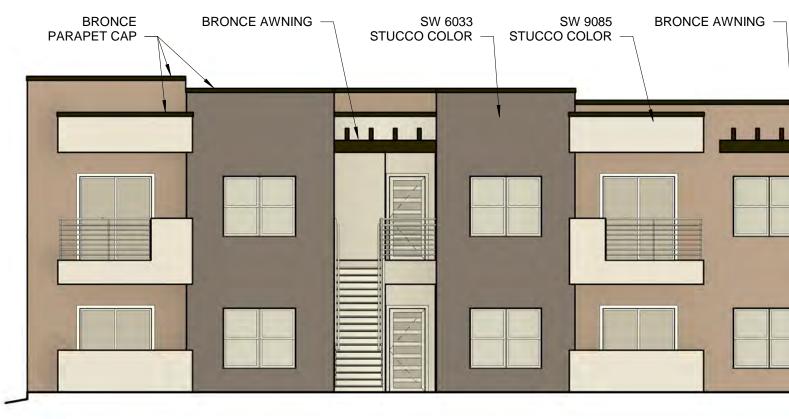

BUILDING 6 NORTH COLOR ELEVATION

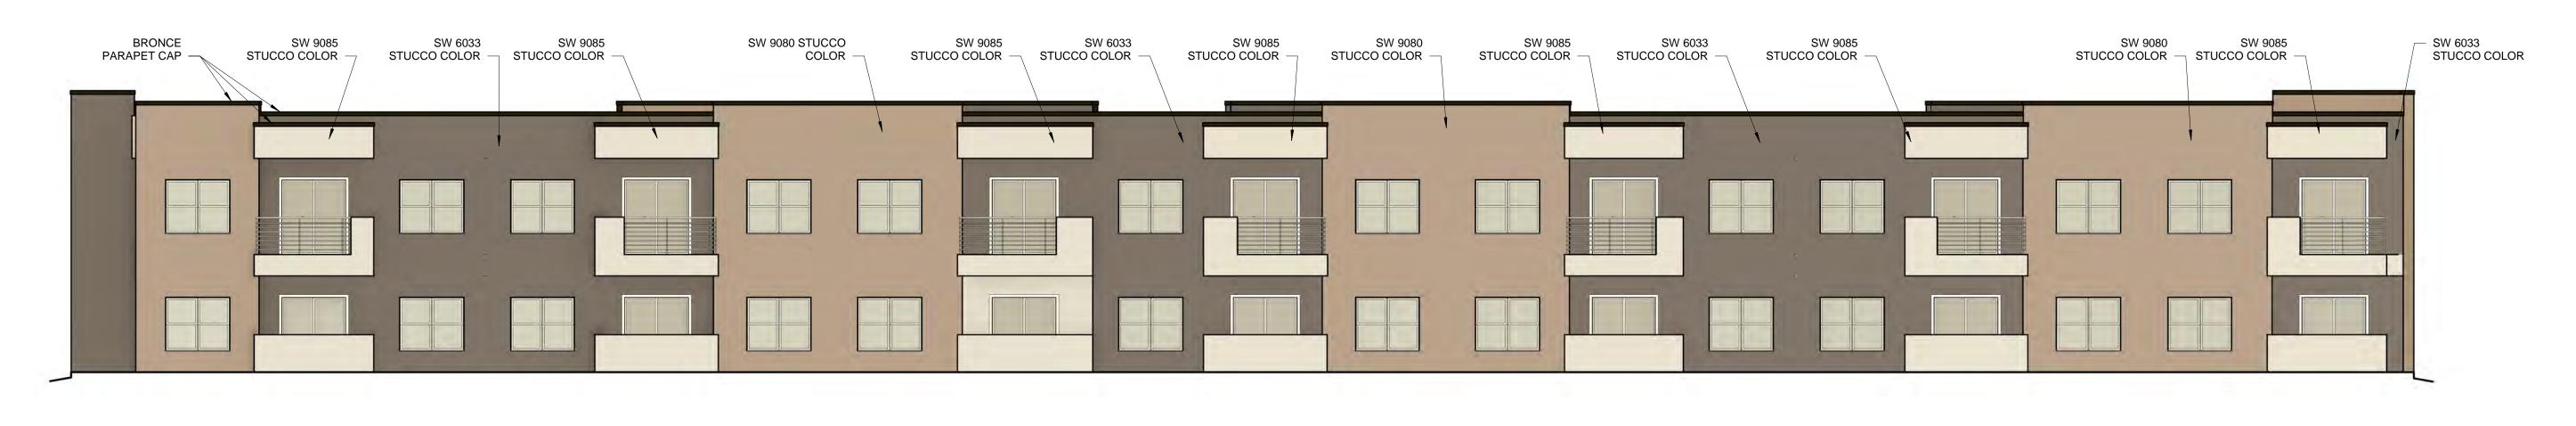


BUILDING 6 SOUTH COLOR ELEVATION



BUILDING 6 EAST COLOR ELEVAION

| SW 9085 STUCCO SW 6033 I | BRONCE AWNING SW 90 | OR SW 6033 | SW 9080 BRON | ICE AWNING SW 9 |
|--------------------------|---------------------|-----------------|--------------|-----------------|
| COLOR STUCCO COLOR | STUCCO COL | OR STUCCO COLOR | | STUCCO COL |
| | | | | |

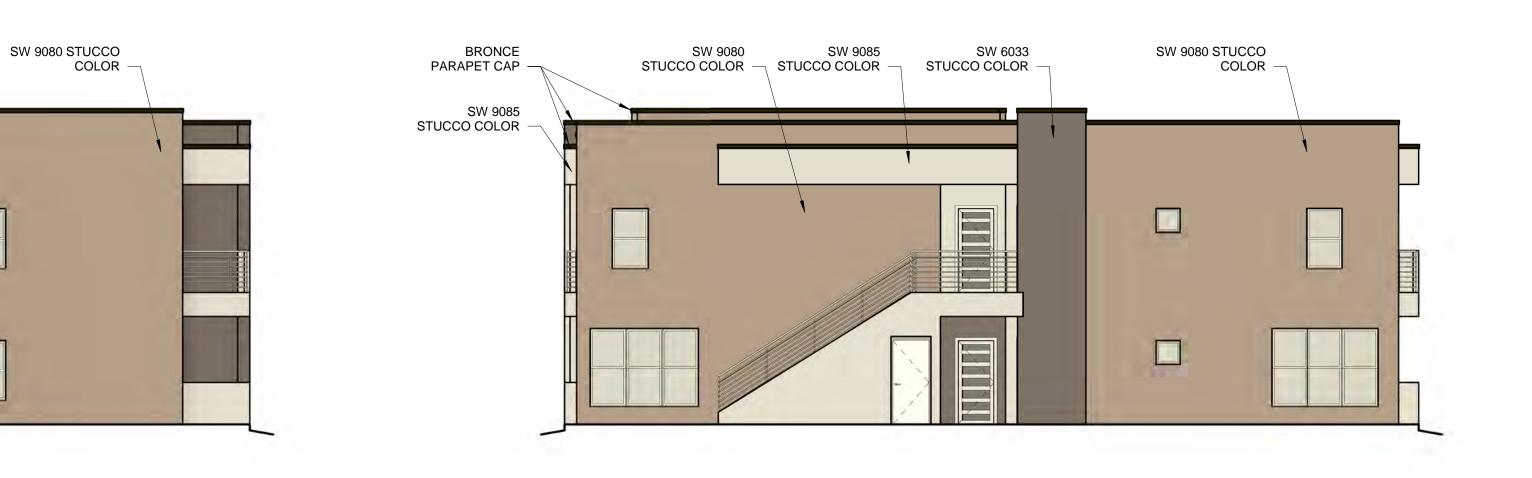

BUILDING 6 WEST COLOR ELEVATION



WINDOWS SHALL BE RECESSED 2 INCHES AS PER 14-16-5-11(C)(2) PROVIDE LOW-E GLAZING AT ALL WEST FACING FACADES PER IDO 14-16-5-11 (D)(2)(a)(3)

PROVIDE FULL SHEILDS AT ALL WALL MOUNTED LIGHT FIXTURES



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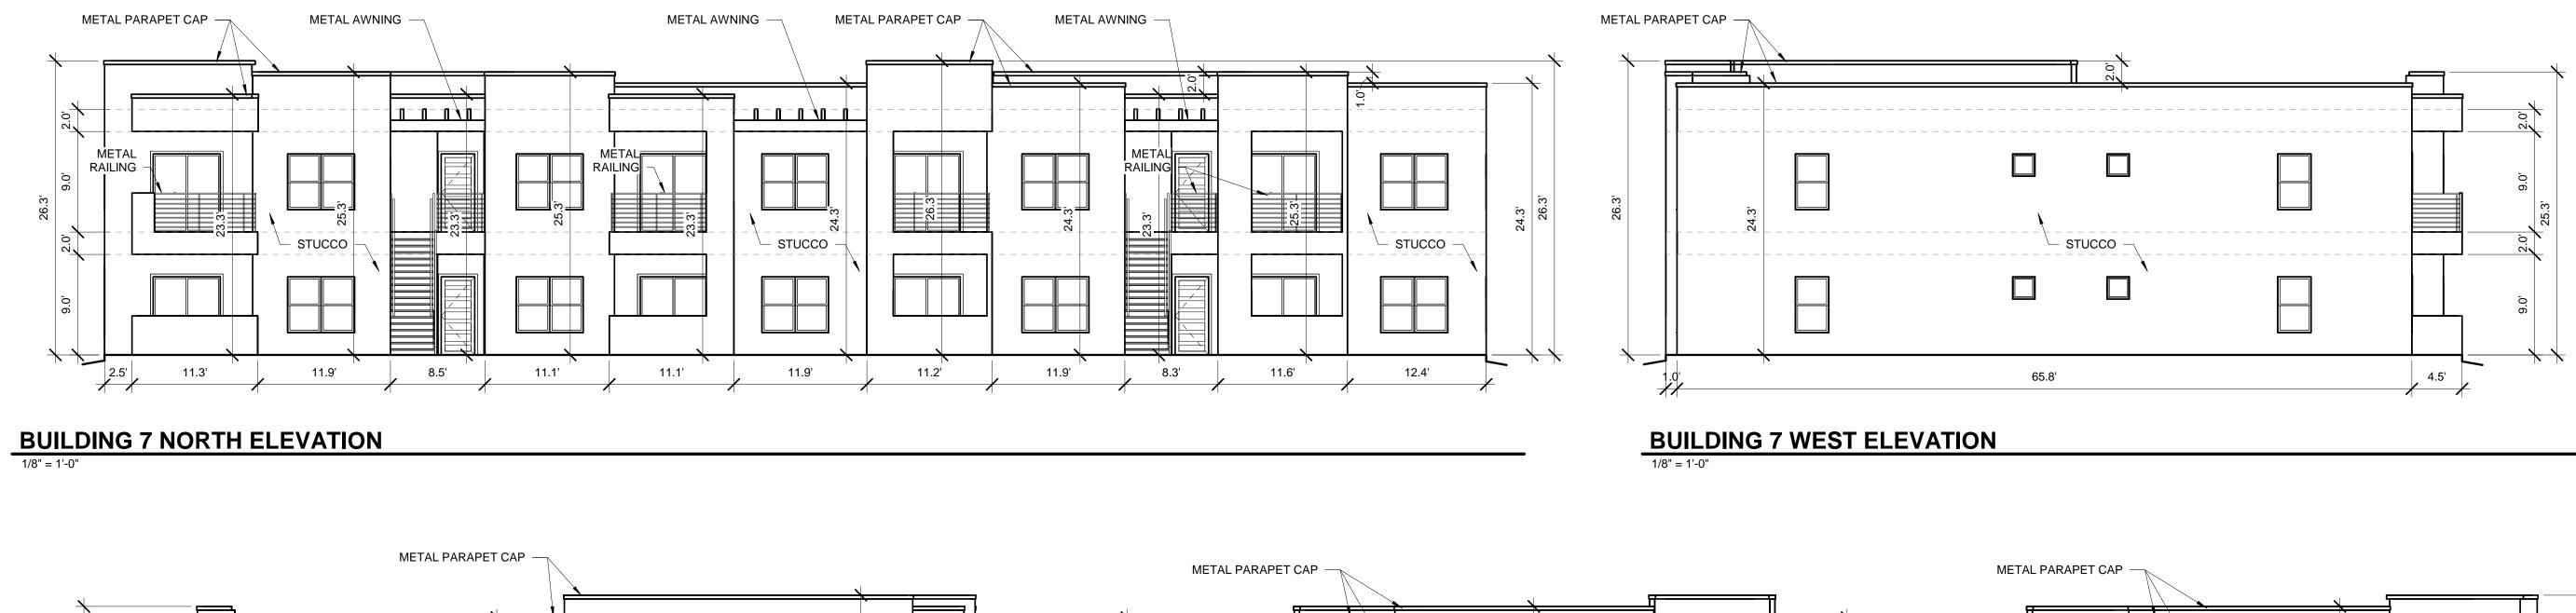
UNIVERESE VIEW APARTMENTS PERESOSO TRAIL NW ALBUQERQUE, NEW MEXICO


BUILDING 6 COLOR ELEVATIONS

SEAL SCOTING SCOTIN


| DESIGNED Designer | PROJECT NO 18-072 |
|----------------------|-------------------------|
| DRAWN Author | SCALE 1/8" = 1'-0" |
| CHECKED Checker | DRAWING NO |
| REVIEWED Designer | A-20 |
| DATE | |
| 05/15/2024 | |


-206.C



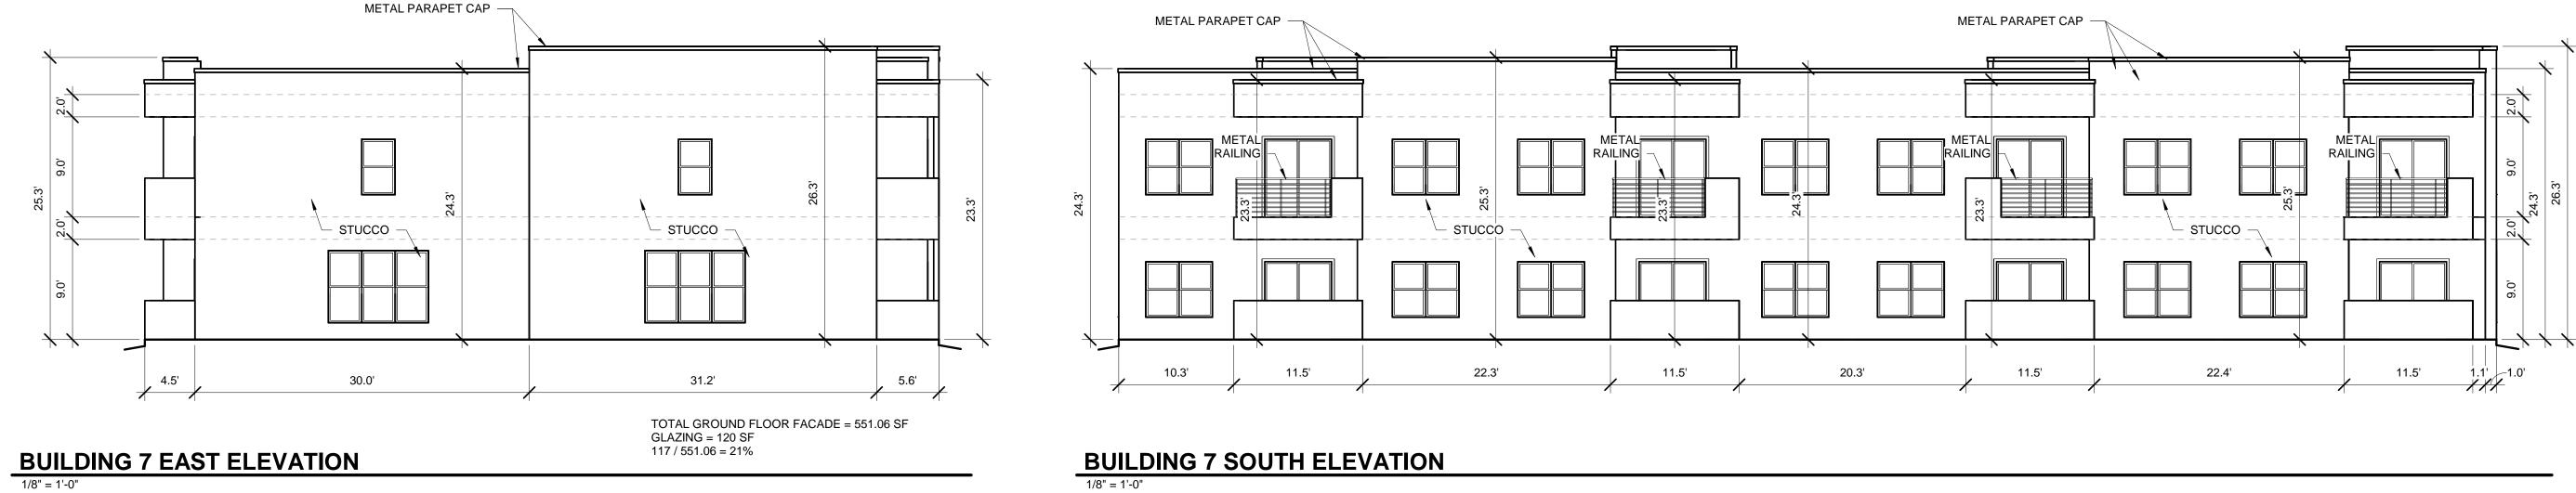

WINDOWS SHALL BE RECESSED 2 INCHES AS PER 14-16-5-11(C)(2) PROVIDE LOW-E GLAZING AT ALL WEST FACING FACADES PER IDO 14-16-5-11 (D)(2)(a)(3) PROVIDE FULL SHEILDS AT ALL WALL MOUNTED LIGHT FIXTURES

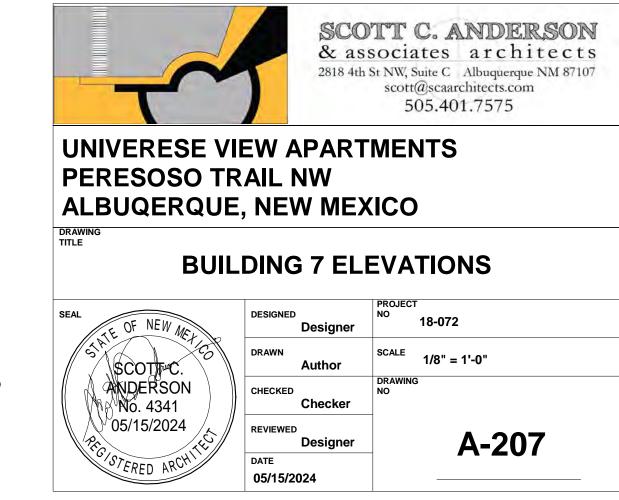


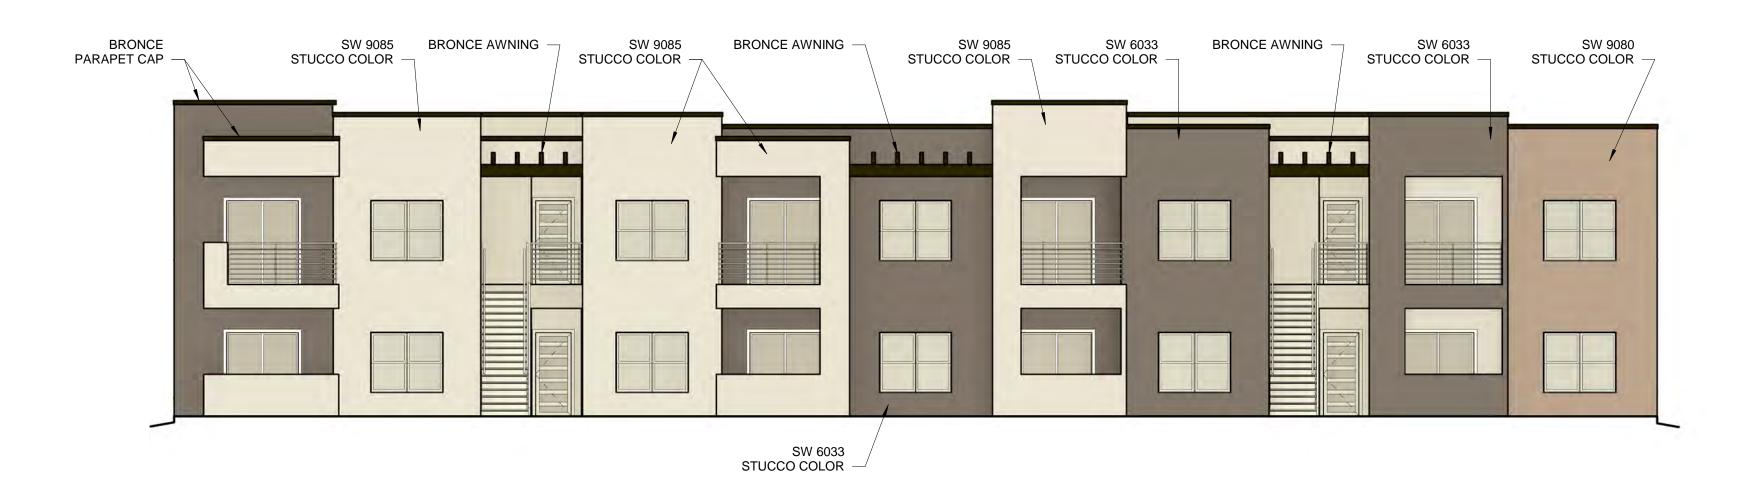

BUILDING 7 NORTH COLOR ELEVATION

BRONCE PARAPET CAP -SW 9080 STUCCO COLOR SW 6033 STUCCO COLOR -1

BUILDING 7 EAST COLOR ELEVATION 1/8" = 1'-0"

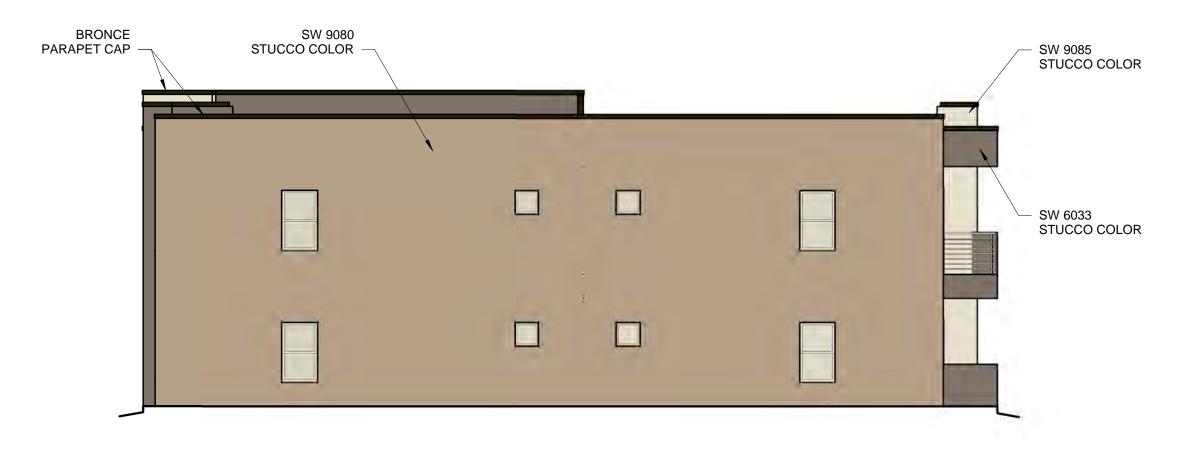



BUILDING 7 WEST COLOR ELEVATION





BUILDING 7 SOUTH COLOR ELEVATION 1/8" = 1'-0"

WINDOWS SHALL BE RECESSED 2 INCHES AS PER 14-16-5-11(C)(2) PROVIDE LOW-E GLAZING AT ALL WEST FACING FACADES PER IDO 14-16-5-11 (D)(2)(a)(3) PROVIDE FULL SHEILDS AT ALL WALL MOUNTED LIGHT FIXTURES

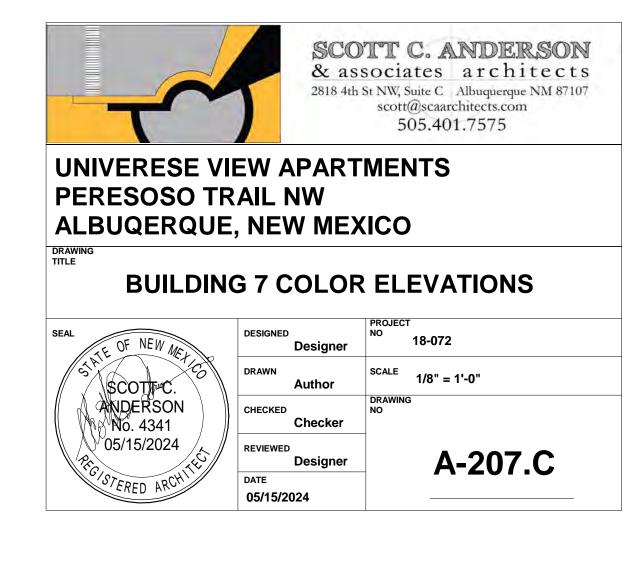

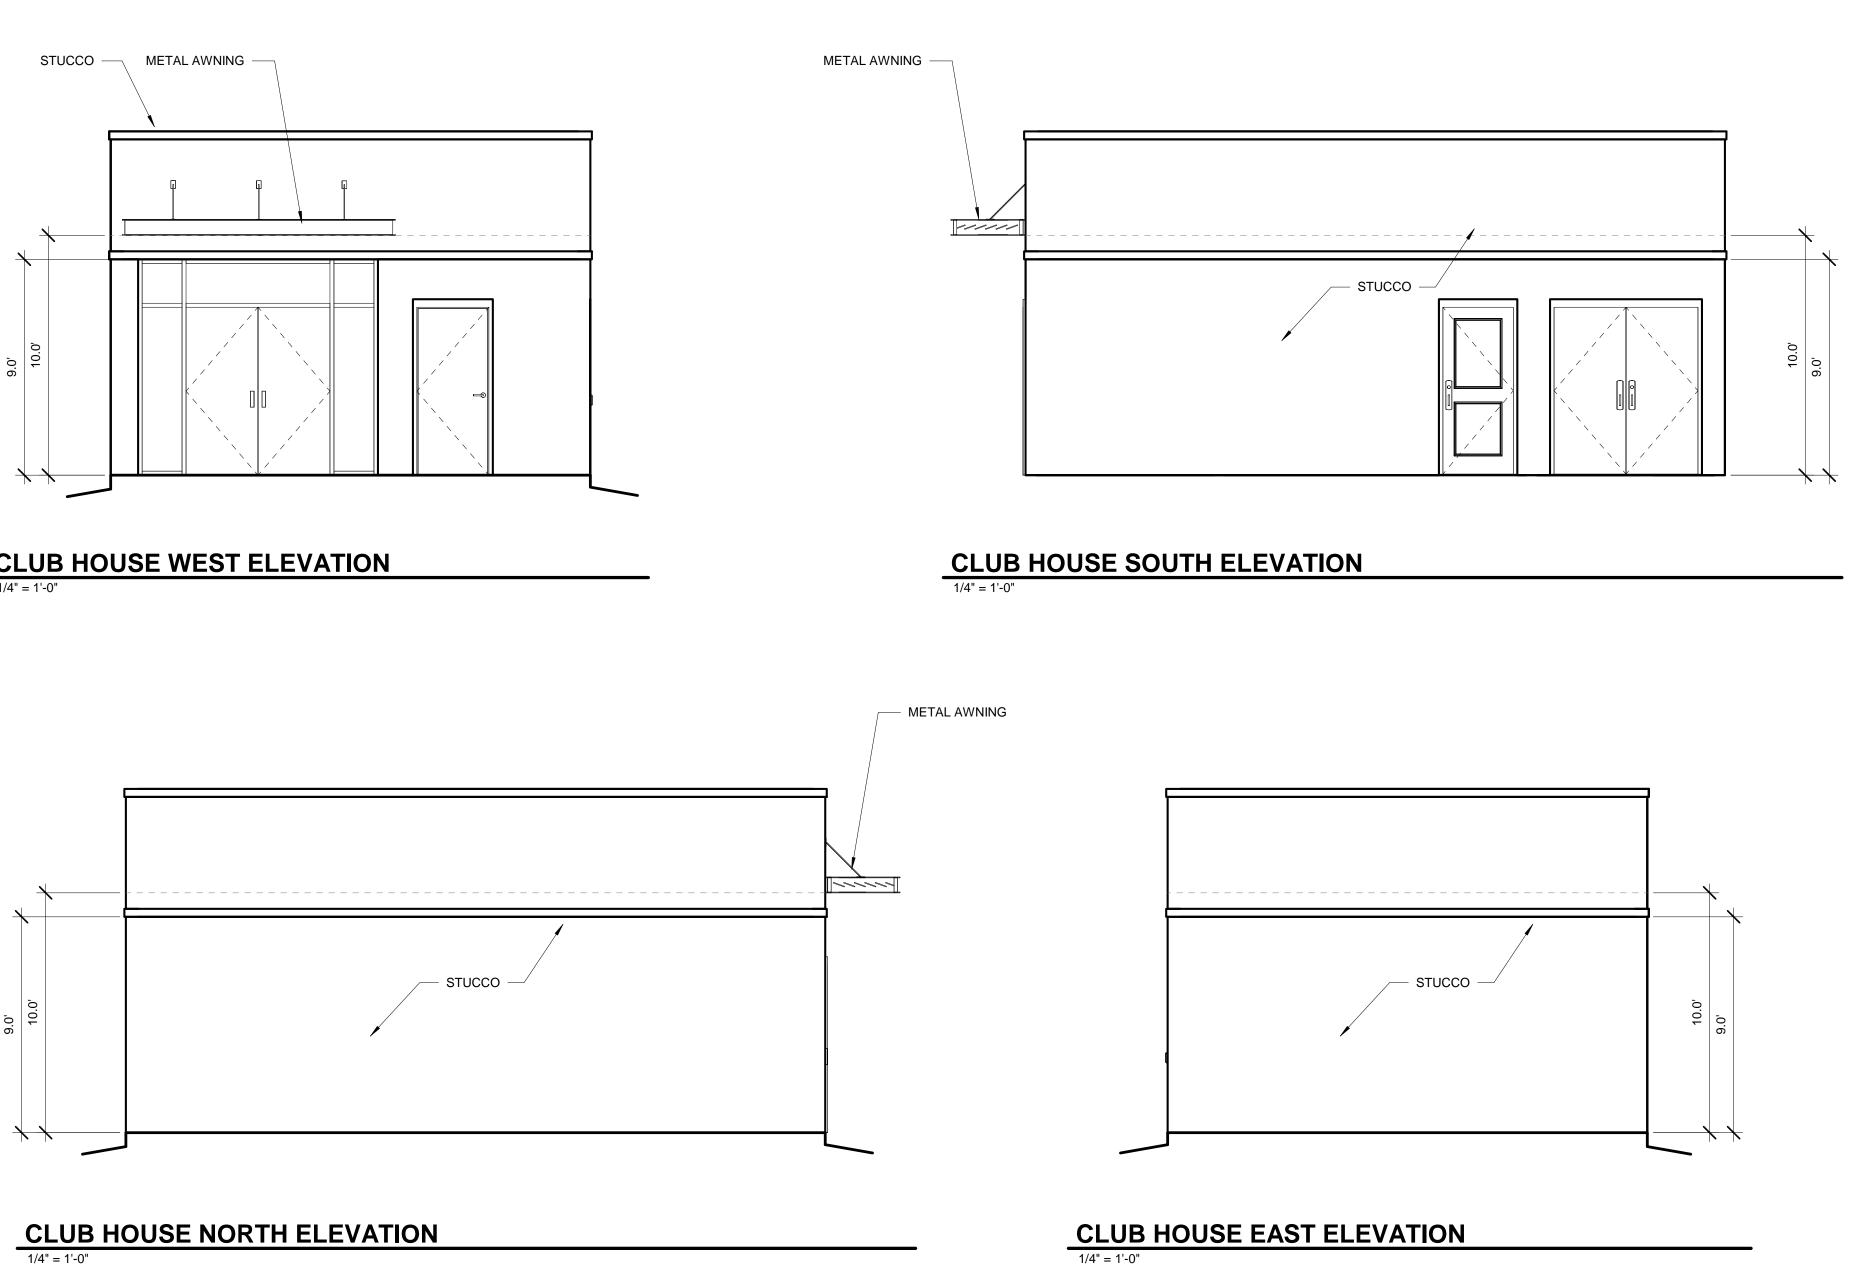

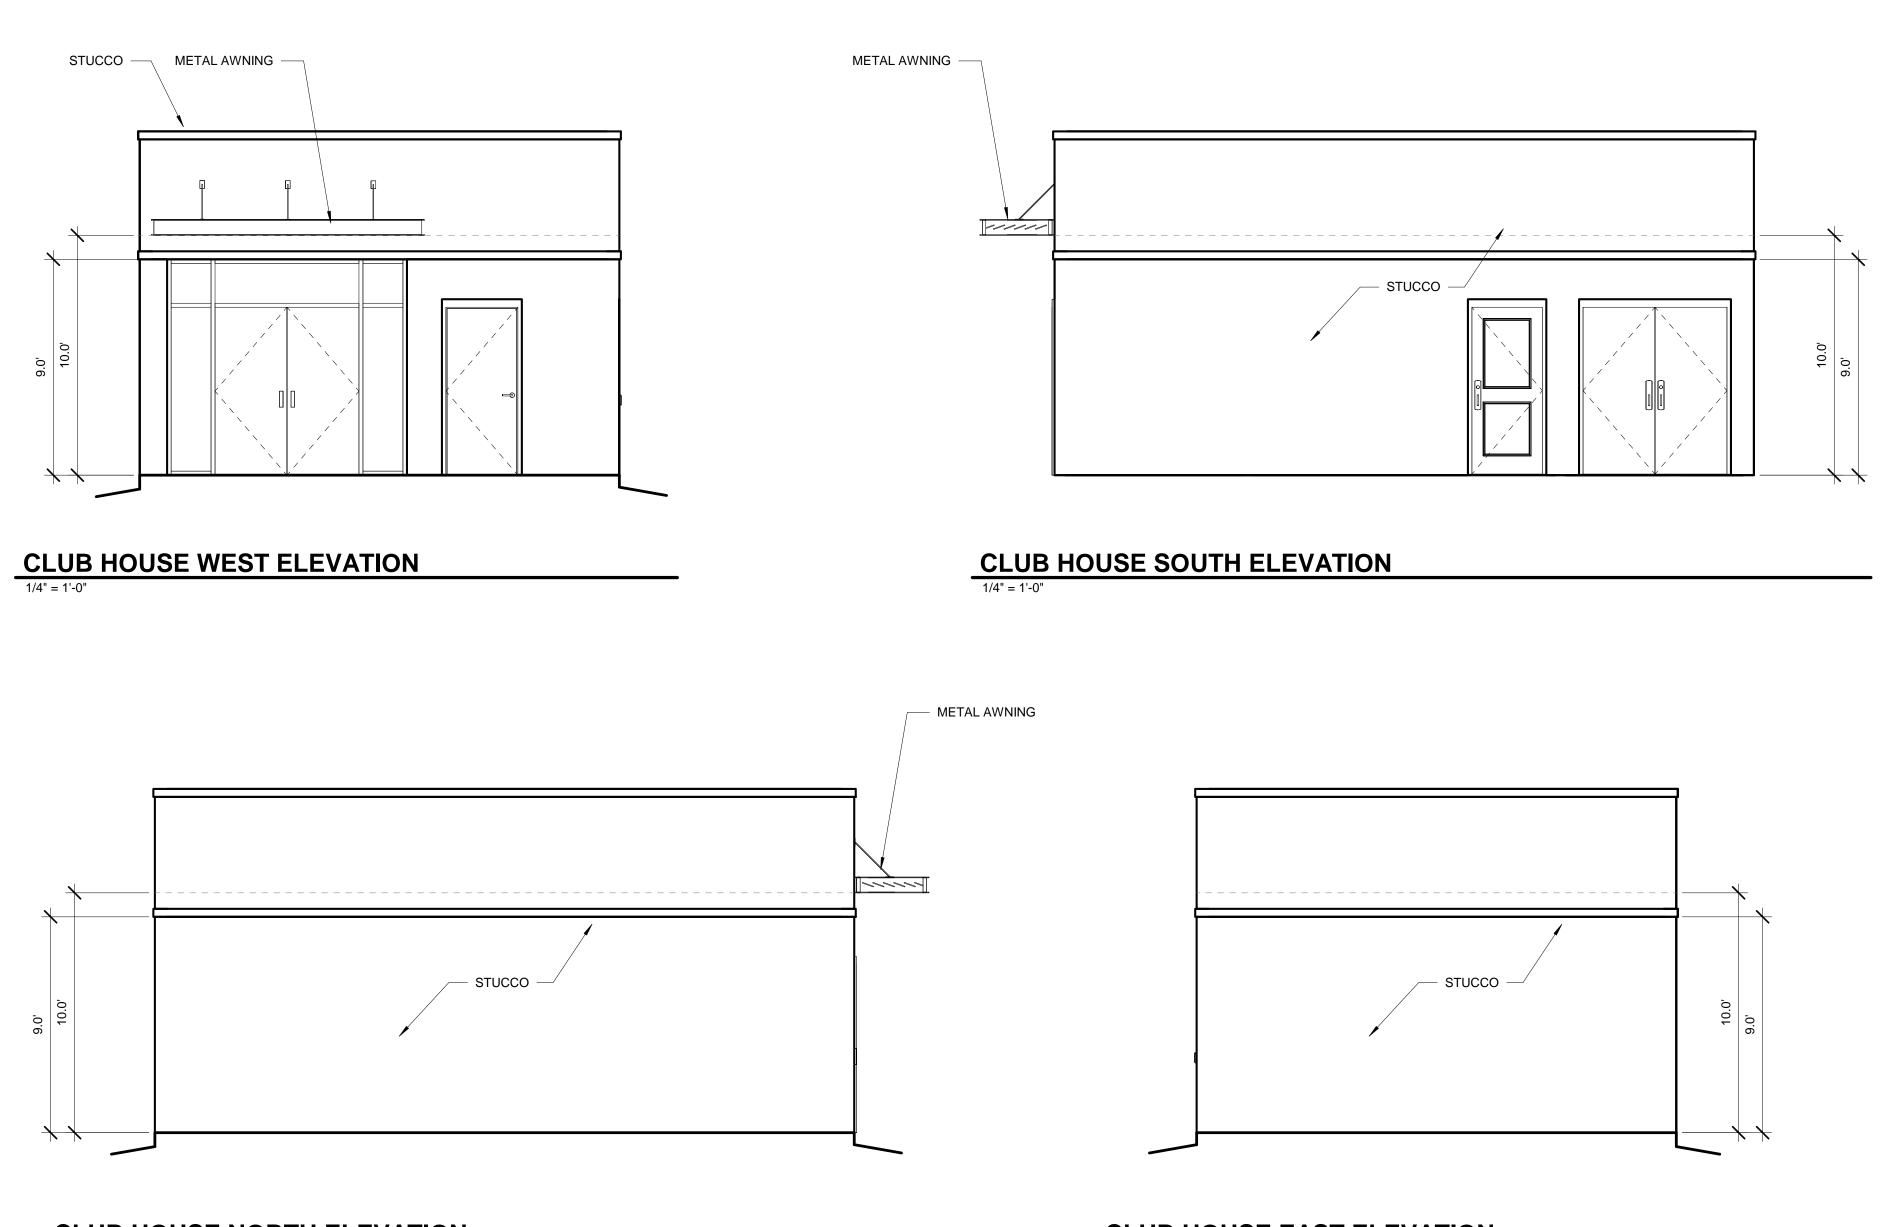

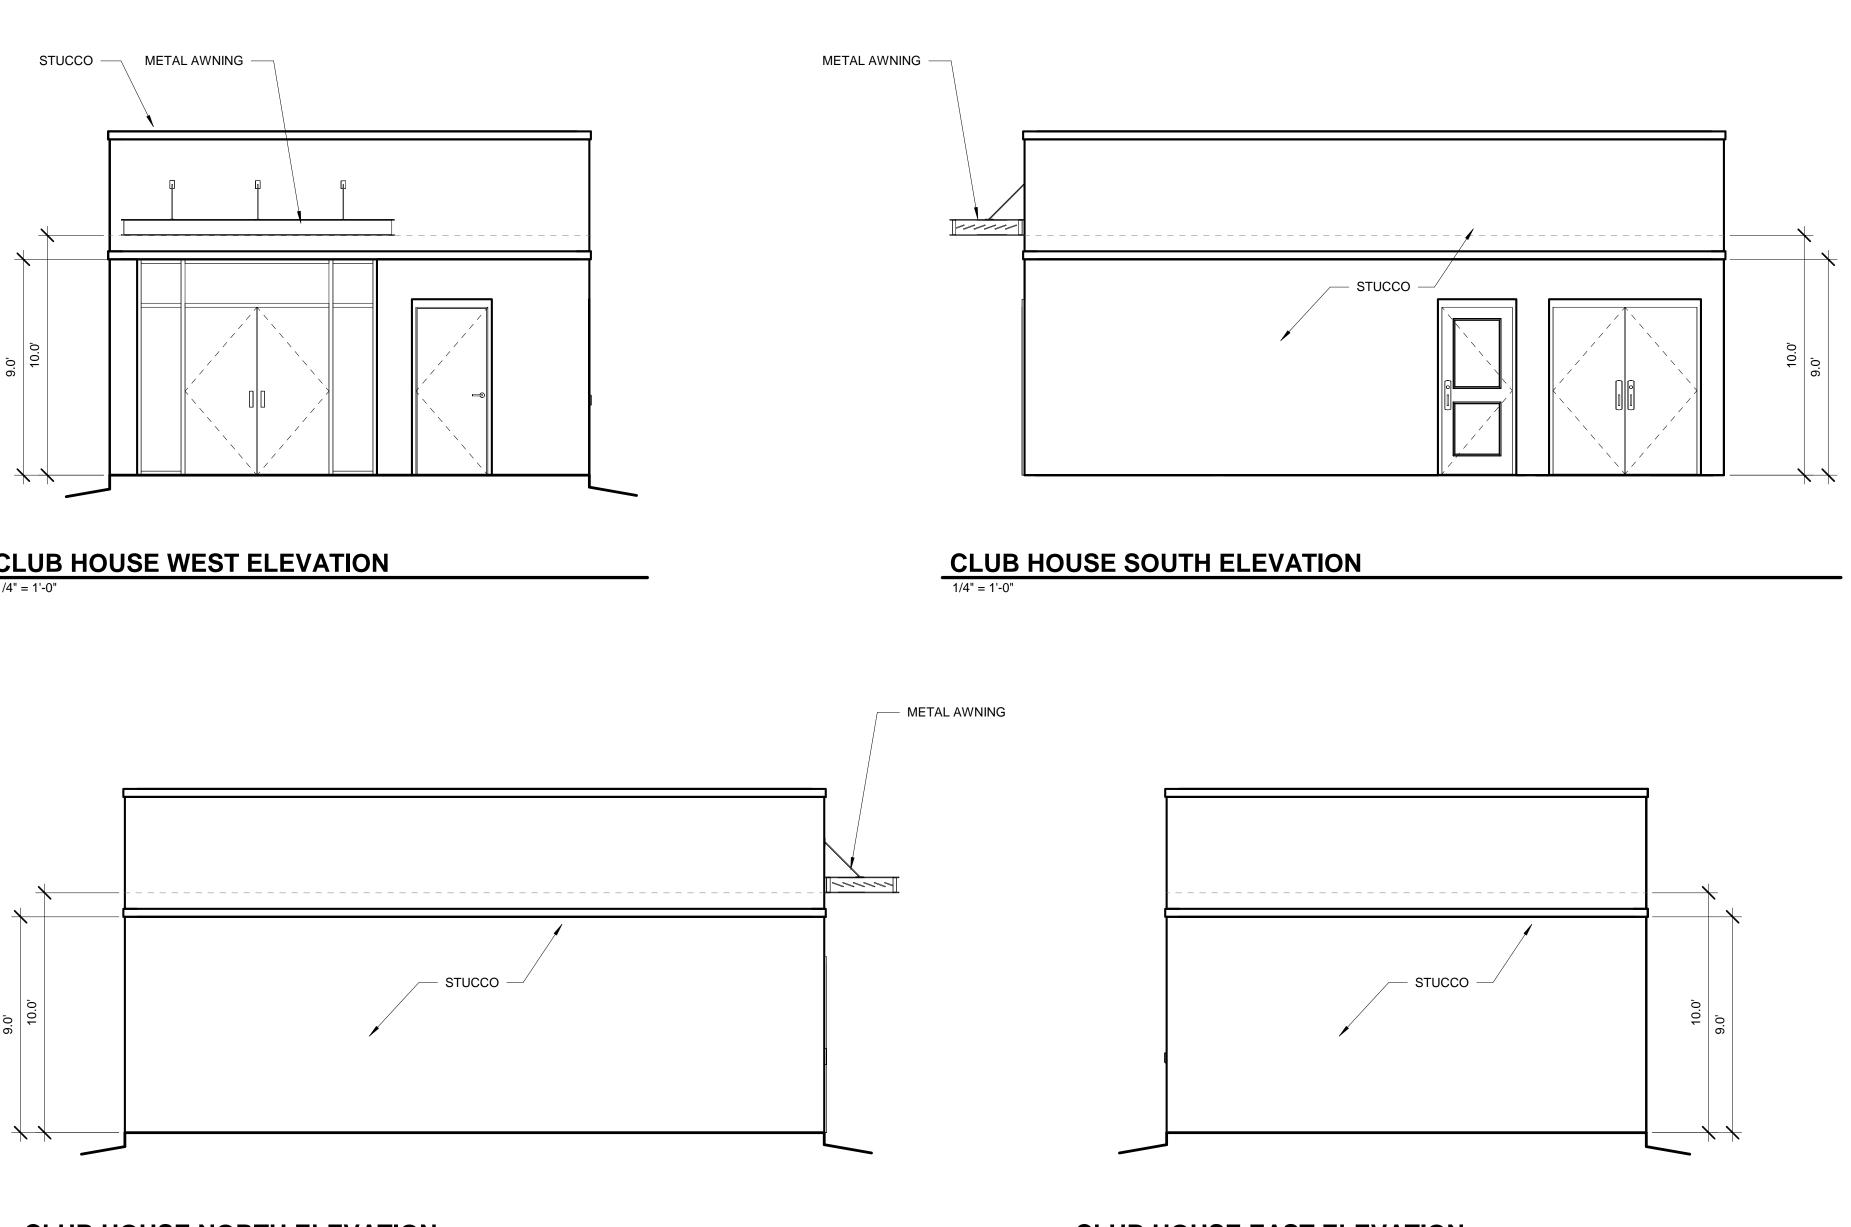



CLUB HOUSE NORTH ELEVATION 1/4" = 1'-0"


WINDOWS SHALL BE RECESSED 2 INCHES AS PER 14-16-5-11(C)(2)

PROVIDE LOW-E GLAZING AT ALL WEST FACING FACADES PER IDO 14-16-5-11 (D)(2)(a)(3)

PROVIDE FULL SHEILDS AT ALL WALL MOUNTED LIGHT FIXTURES

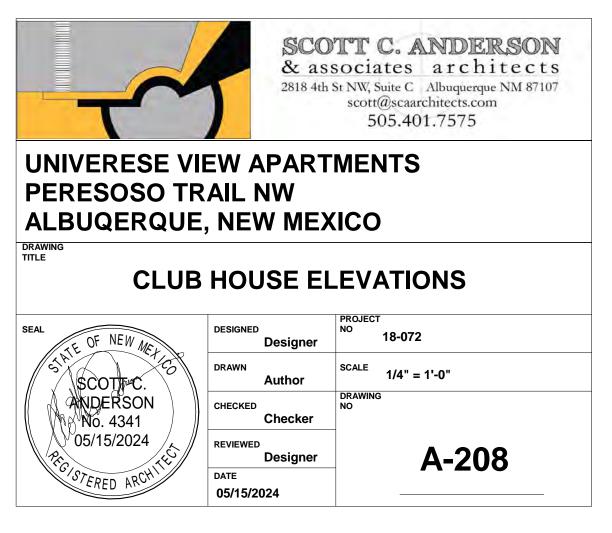


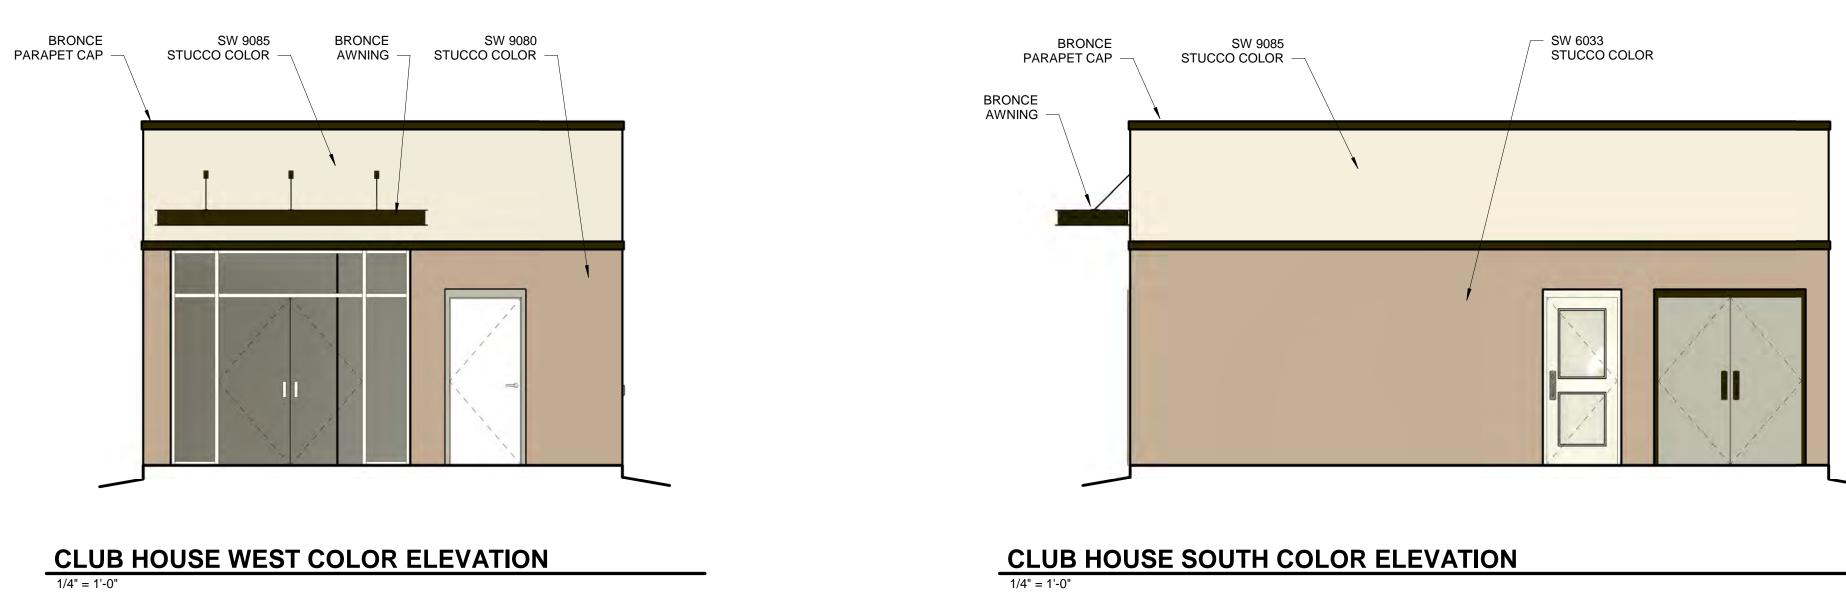

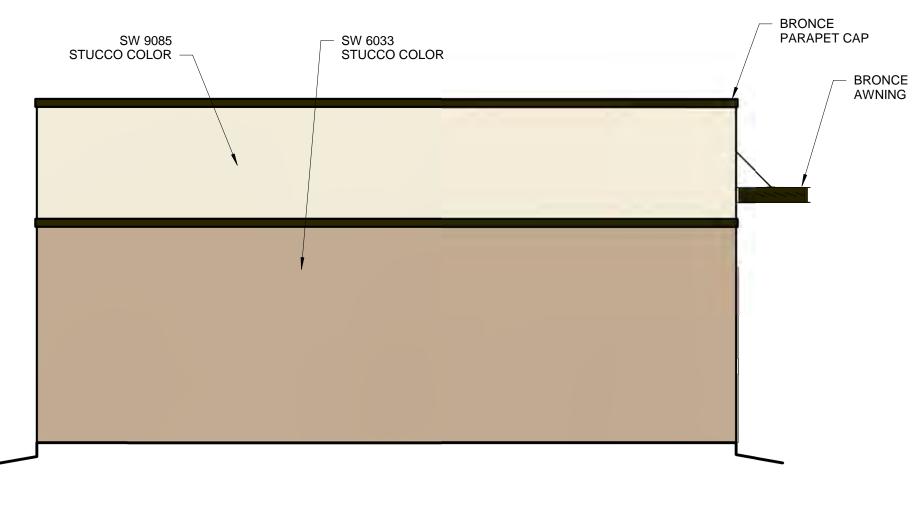

CLUB HOUSE NORTH COLOR ELEVATION



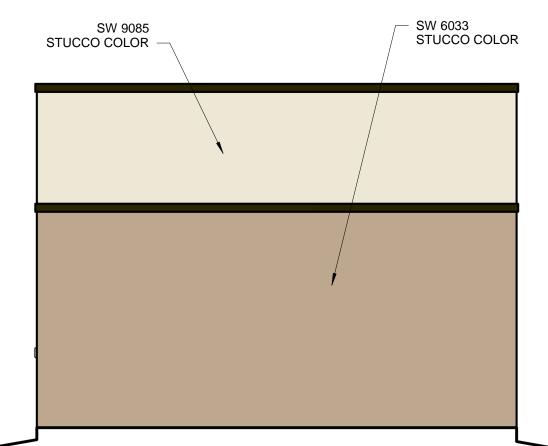

CLUB HOUSE EAST COLOR ELEVATION

WINDOWS SHALL BE RECESSED 2 INCHES AS PER 14-16-5-11(C)(2)

PROVIDE LOW-E GLAZING AT ALL WEST FACING FACADES PER IDO 14-16-5-11 (D)(2)(a)(3)

PROVIDE FULL SHEILDS AT ALL WALL MOUNTED LIGHT FIXTURES



Designer


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STERED ARCH


DATE

05/15/2024

A-208.C

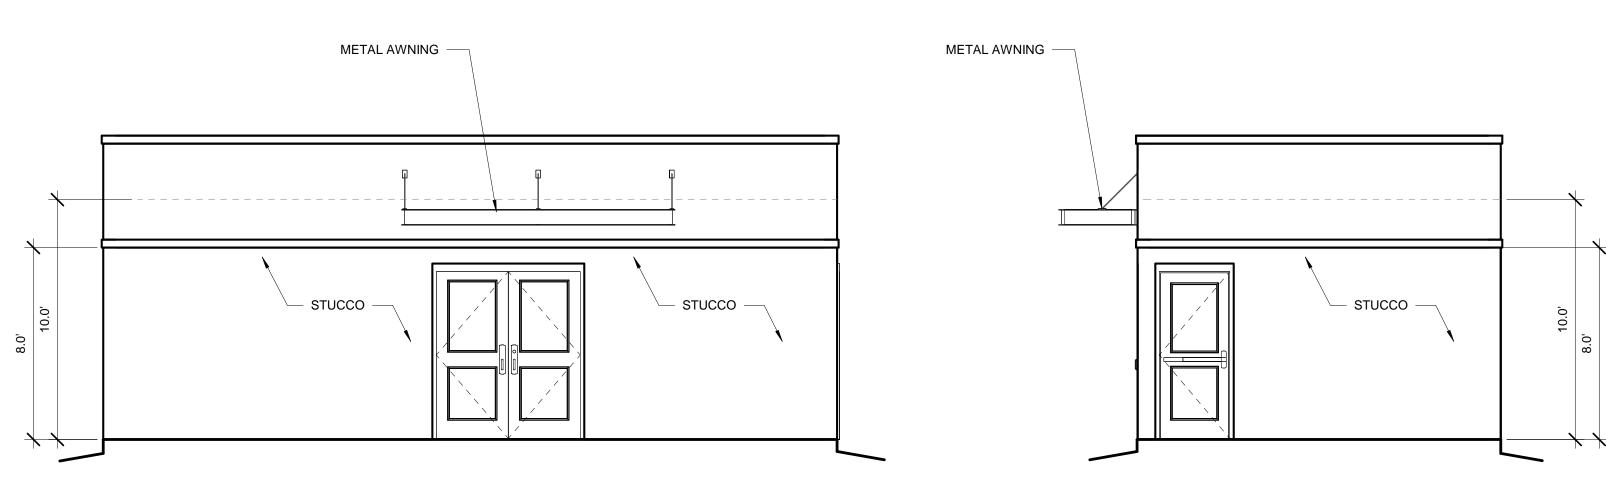

MAINTENANCE BUILDING NORTH ELEVATION

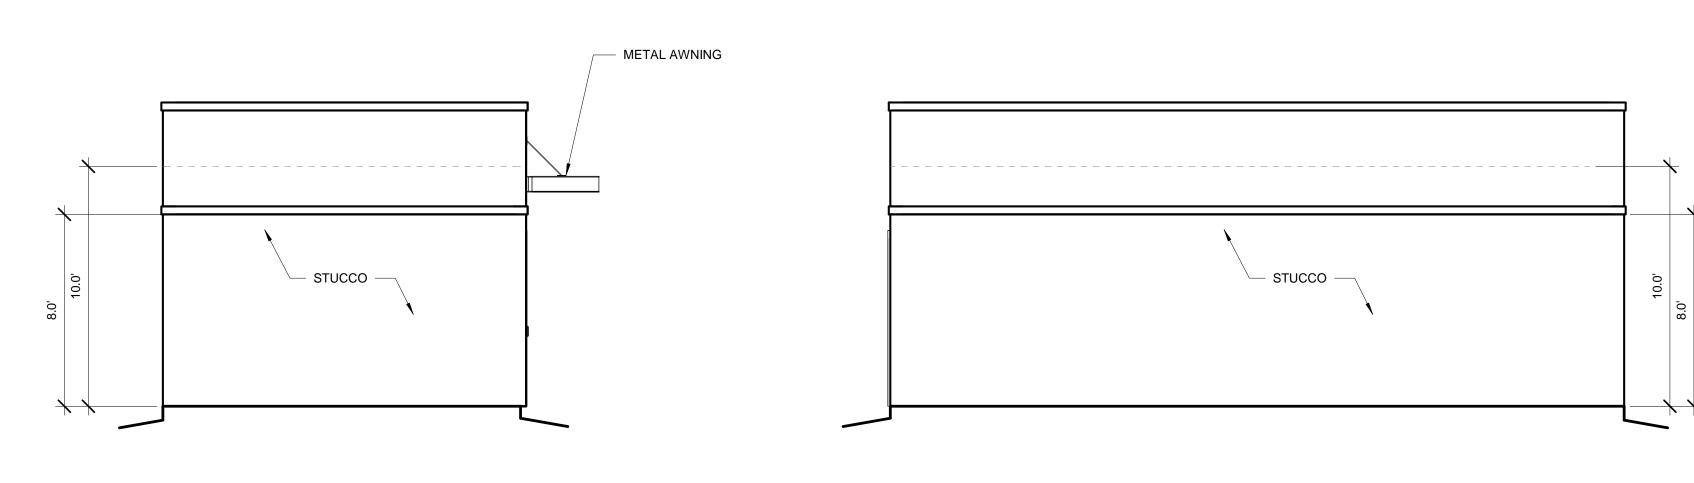


MAINTENANCE BUILDING EAST ELEVATION

MAINTENANCE BUILDING WEST ELEVATION 1/4" = 1'-0"

MAINTENANCE BUILDING SOUTH ELEVATION

WINDOWS SHALL BE RECESSED 2 INCHES AS PER 14-16-5-11(C)(2) PROVIDE LOW-E GLAZING AT ALL WEST FACING FACADES PER IDO 14-16-5-11 (D)(2)(a)(3)

PROVIDE FULL SHEILDS AT ALL WALL MOUNTED LIGHT FIXTURES

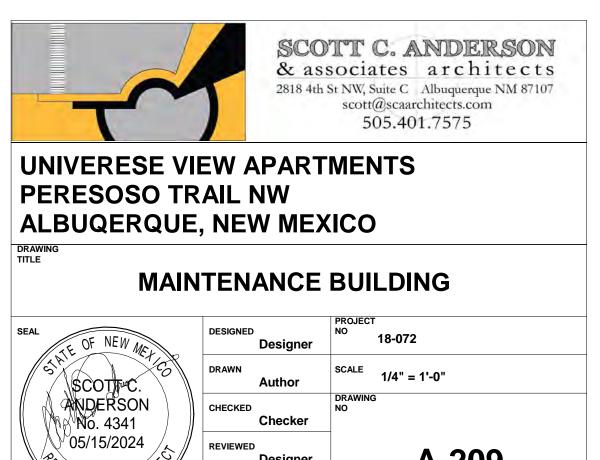

Designer


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STERED ARCH


DATE

05/15/2024

A-209

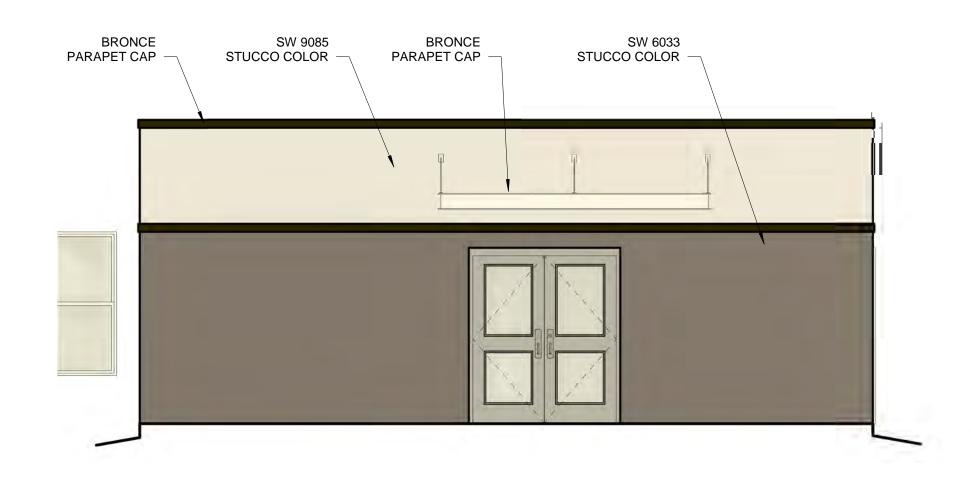

MAINTENANCE BUILDING NORTH COLOR ELEVATION

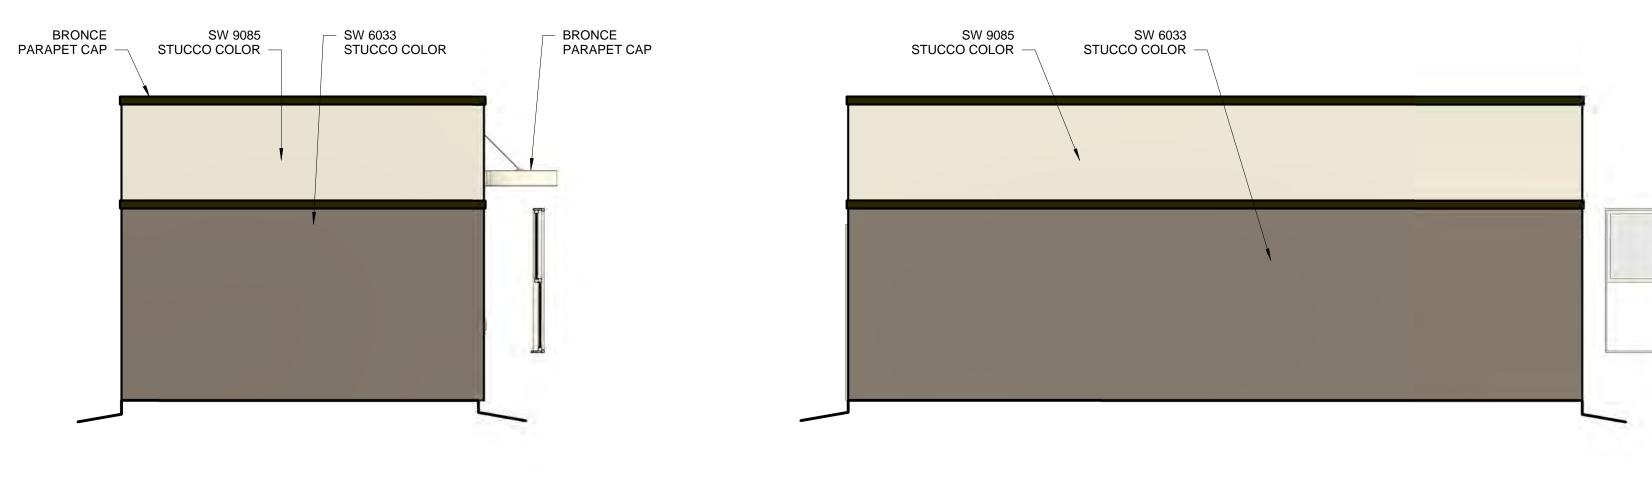

MAINTENANCE BUILDING EAST COLOR ELEVATION 1/4" = 1'-0"

BRONCE PARAPET CAP SW 9085 STUCCO COLOR -

MAINTENANCE BUILDING WEST COLOR ELEVATION 1/4" = 1'-0"

MAINTENANCE BUILDING SOUTH COLOR ELEVATION

SW 6033
 STUCCO COLOR

WINDOWS SHALL BE RECESSED 2 INCHES AS PER 14-16-5-11(C)(2) PROVIDE LOW-E GLAZING AT ALL WEST FACING FACADES PER IDO 14-16-5-11 (D)(2)(a)(3)

PROVIDE FULL SHEILDS AT ALL WALL MOUNTED LIGHT FIXTURES



PERESOSO TRAIL NW ALBUQERQUE, NEW MEXICO DRAWING TITLE

SEAL

SCOTF™C. SCOTF™C. ANDERSON No. 4341 05/15/2024

STERED ARCH

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MAINTENANCE COLOR BUILDING

PROJECT DESIGNED NO 18-072 Designer

SCALE

DRAWN Author CHECKED

Checker REVIEWED Designer DATE 05/15/2024

A-209.C

1/4" = 1'-0"





BUILDING 1 SW ELEVATION



BUILDING 1 SE ELEVATION

BUILDING 1 NE ELEVATION



BUILDING 2 NW ELEVATION



BUILDING 2 SE ELEVATION





BUILDING 3 NE ELEVATION



BUILDING 3 SE ELEVATION





BUILDING 3 NW ELEVATION





BUILDING 4 SW ELEVATION



BUILDING 4 NE ELEVATION



BUILDING 6 NE ELEVATION





BUILDING 4 NW ELEVATION



BUILDING 4 SE ELEVATION



BUILDING 6 SE ELEVATION



BUILDING 6 NW ELEVATION



BUILDING 5 NW ELEVATION



BUILDING 5 NE ELEVATION



BUILDING 7 SW ELEVATION



BUILDING 7 NW ELEVATION



BUILDING 5 SW ELEVATION



BUILDING 5 SE ELEVATION






BUILDING 7 SE ELEVATION




BUILDING 7 NE ELEVATION

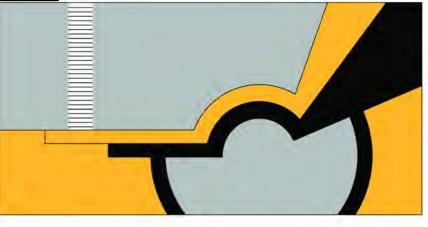




SCOTT C. ANDERSON & associates architects albuquerque



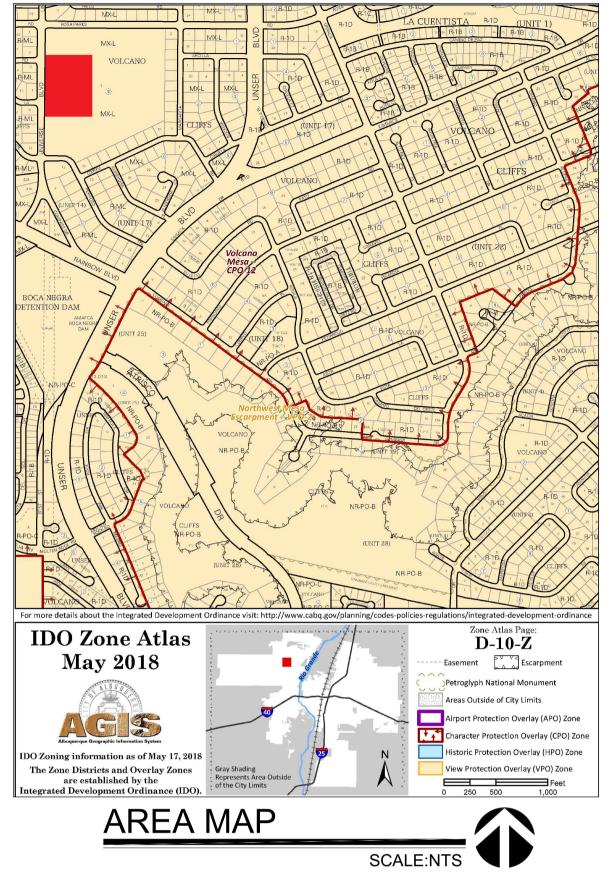


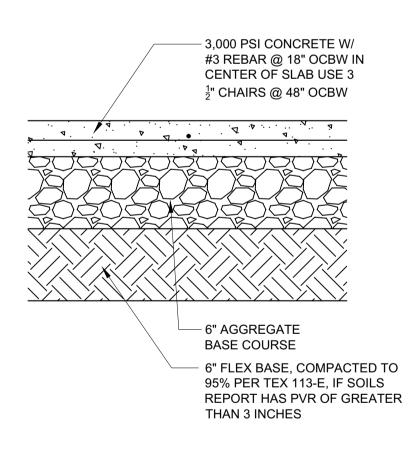

PAVING SECTION

SCALE: NTS

 (\mathbb{S})

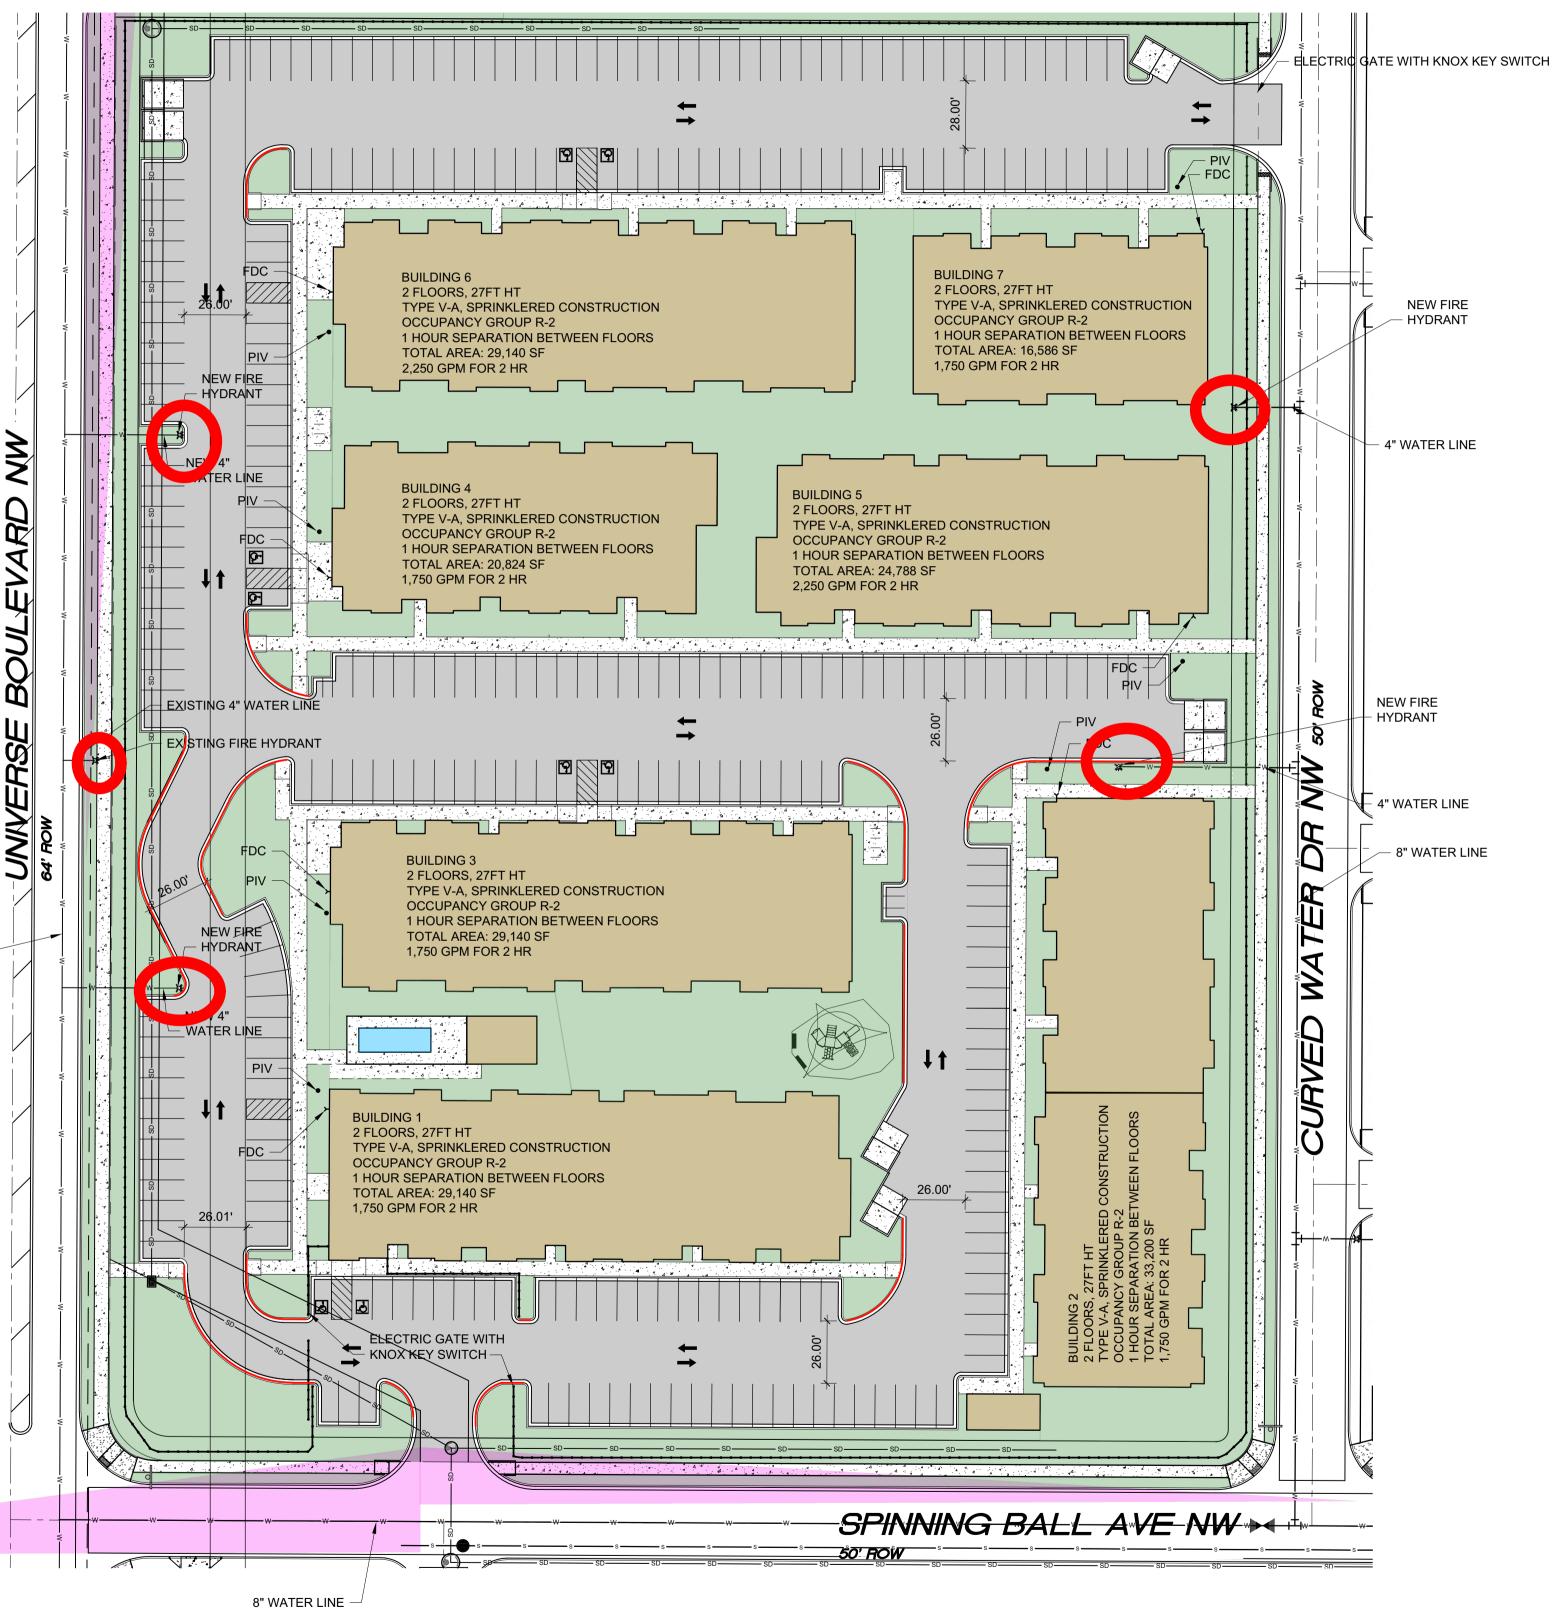

SITE PLAN



ALBUQUERQUE FIRE 1 SITE PLAN CHECKLIST

DIVISION OFFICE APLANSED FIRE 1 PLAN WILL BE SUBMITTED AT PERMIT CHECKING DIVISION

PER²**W**^F**P**⁴**F**²**UR**²**U**

PERMIT NUMBER: FP-23-015811 APPROVED DATAE: 09/27/28/ING HYDRANT PROVIDED, 3 NEW HYDRANT PROVIDED

Y ST 🔜 H 🕧 RANTS AND NEW HYDRANT IDENTIFIED

THESE CONSTRUCTION DOCUMENTS WERE REVIEWED AND APPROVED BY THE ALBUQUERQUE FIRE MARSHAL'S OFFICE IN ACCORDANCE WITH THE CITY LINES IDENTIFIED ON THE PLAN

ORDINACE, THE INTERNATIONAL FIRE CODE, AND NFPA STANDARDS. THIS PERMIT IS VALID FOR 180 DAYS. FINAL INSPECTION IS REQUIRED JBLIC WATER MAIN IDENTIFIED ON THE PLAN

FIRE FLOW: 1750 GPM, 1 HYDRANT. VA. 8. NO PARKING 15FT FROM THE HYDRANT

- 9. ACCESS PROVIDED TO 150FT
- 10. BUILDING HT 27FT, 3 MEANS OF APPARATUS ACCESS
- 11. TOTAL BUILDING AREA LESS THAN 62,000 SF, 2 MEANS OF APPARATUS ACCESS
- 12. THIS IS A 175 UNIT MULTI-FAMILY, 2 MEANS OF APPARATUS ACCESS PROVIDED
- 13. THIS IS NOT A ONE OR TWO FAMILY RESIDENTIAL PROJECT
- 14. 2 MEANS OF ACCESS PROVIDED, 2 REQUIRED
- 15. BUILDING LESS THAN 30 FT IN HT, 24 FT ROAD WIDTH PROVIDED
- 16. ACCESS ROAD 26 FT WIDE
- 17. ACCESS ROAD 26 FT WIDE
- 18. ACCESS ROADS ARE PUBLIC STREETS
- 19. TURNING RADIUS = 28 FT
- 20. DEAD END IS LESS THAN 150 FT
- 21. ACCESS ROAD IS CONCRETE CAPABLE OF SUPPORTING 75,000LBS
- 22. REFERENCE DETAIL THIS SHEET AND CIVIL SHEETS FOR CONCRETE PAVING DATA
- 23. ACCESS ROAD GRADE LESS THAN 10%
- 24. KNOX BOX PROVIDED AT EACH GATE
- 25. REFER TO G SHEETS FOR FIRE RATINGS, 1HR SEPARATION BETWEEN DWELLING UNITS, 1HOUR SEPARATION BETWEEN FLOORS
- 26. SPRINKLER SYSTEM PROVIDED
- 27. FDC LOCATED LESS THAN 100 FT FROM HYDRANT
- 28. FDC HAS 3FT CLEARANCE
- 29. PIV ON EAST SIDE OF EACH RISER ROOM
- 30. STANDPIPE NOT REQUIRED
- 31. STANDPIPE NOT REQUIRED
- 32. REMISE ID SHALL BE 12" BRONZE LETTERS MOUNTED TO WEST FACADE (UNIVERSE BLVD NW)
- 33. MULTIPLE BUILDINGS WITH SINGLE ADDRESS
- 34. KNOX BOX PROVIDED AT MAIN ENTRANCE TO THE BUILDING

FIRE LANE

FIRE CALCULATIONS

BUILDING HEIGHT = 27'-0", 2 STORY

TYPE V-A, SPRINKLERED CONSTRUCTION


HYDRANTS REQUIRED PER IFC TABLE C105.1 = 2 HYDRANT @ 450FT MAX


CONCRETE PAVING SHALL SUPPORT 75,000 LBS.

FIRE FLOW CALCULATION IFC 2015 APPENDIX B TABLE B105.1:


IFC B105.1 CONSTRUCTION TYPE V-A SPRINKLERED

29,140 SF: FLOW @ 3,000 GPM X 50% (SPRINKLERS) = : 2,250 GPM FOR 2 HR

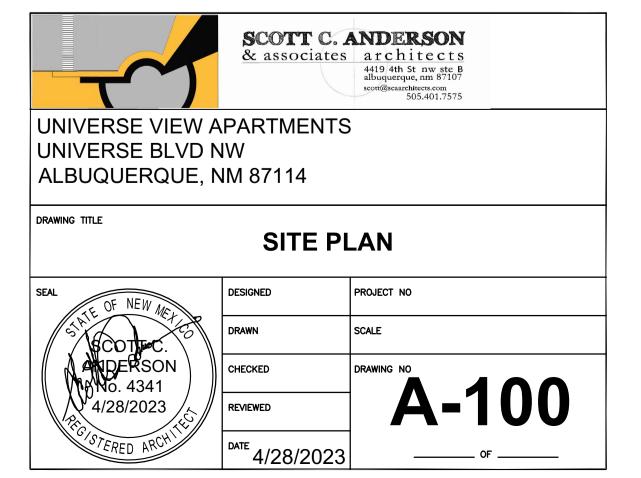


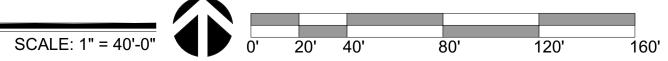



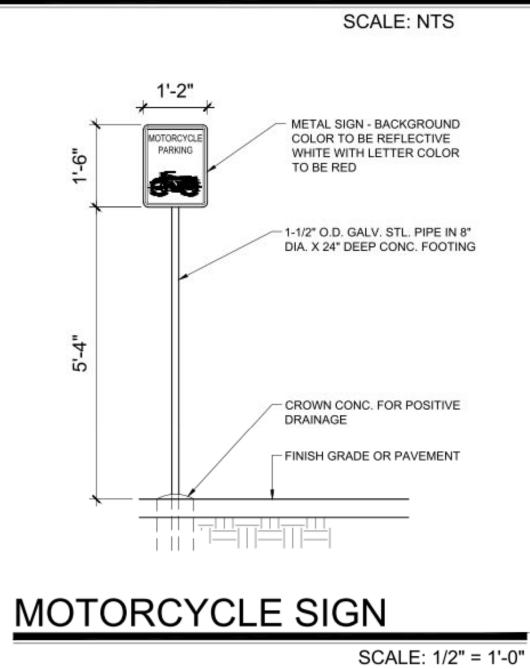



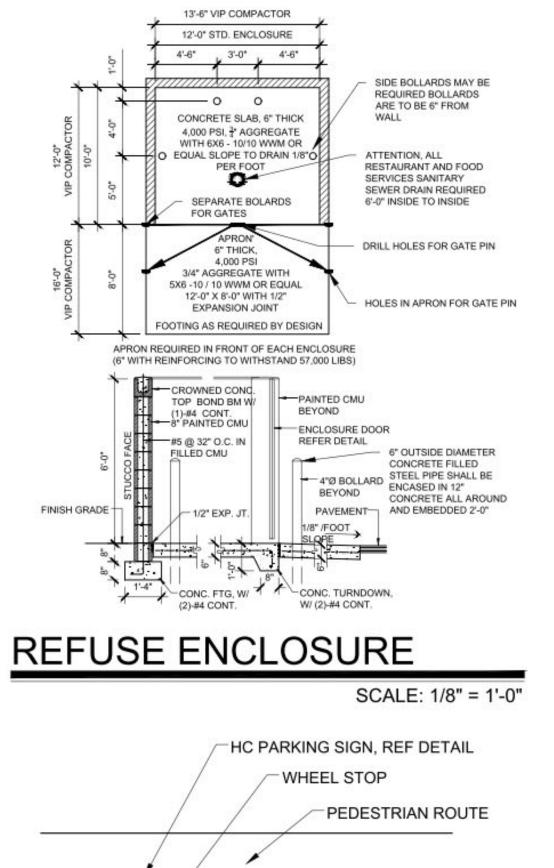

"MC" SHALL BE PAINTED ON THE PAVEMENT OF EACH MOTORCYCLE PARKING SPACE

5-5 (G). ALL OUTDOOR LIGHT FIXTURES SHALL BE LED. FIXTURES 70 WATTS OR GREATER SHALL BE SHIELDED USING FULL CUTOFF LIGHT FIXTURES. BUILDING MOUNTED SIGNS SHALL BE EXTERNALLY ILLUMINATED AND SHALL NOT EXTEND MORE THAN 2 FEET ABOVE THE EXTERIOR WALLS OF THE BUILDING. WORK WITHIN THE PUBLIC RIGHT OF WAY REQUIRES A WORK ORDER. PROVIDE ELECTRIC VEHICLE CHARGER AT EACH BAY OF LEASED GARAGES SITE LIGHTING WILL BE PROVIDED BY LIGHT BOLLARDS AND WALL MOUNTED FIXTURES AND SHALL COMPLY WITH 5-8 OF THE IDO

ALL IMPROVEMENTS LOCATED IN THE RIGHT OF WAY MUST BE INCLUDED IN ON A PUBLIC WORK ORDER. LANDSCAPING, FENCING AND SIGNING WILL NOT INTERFERE WITH CLEAR SIGHT REQUIREMENTS, THEREFORE, SIGNS, WALLS, TREES AND SHRUBBERY BETWEEN 3 AND 8 FEET TALL (AS MEASURED FROM THE GUTTER PAN) WILL NOT BE ACCEPTABLE IN THE

ALL WINDOWS SHALL BE RECESSED 2 INCHES

GRADE LEVEL OPEN SPACE = 67,985 SF PROVIDED (EXCLUDING SIDEWALKS) UPPER FLOOR BALCONIES & DECKS = 7,875 SF PROVIDED TOTAL PROVIDED = 75,860 (69% MORE THAN REQUIRED)

TOTAL REQUIRED = 44,837 SF

CLEAR SIGHT TRIANGLE.

THIS SHEET

IDO TABLE 5-1-2 OPEN SPACE: 1 BEDROOM: 87 EA X 225 SF = 19,575 SF 2 BEDROOM: 88 EA X 285 SF = 25,080 SF

UPC: 101006305745520820

HC REQUIRED: 4 STANDARD, 3 VAN MOTORCYCLE PARKING 151-300 SPACES: 5 SPACES REQUIRED / 7 PROVIDED BIKE PARKING 10% OF 246: 25 REQUIRED, 32 SPACES PROVIDED

LEASING OFFICE 738 SF X 1 PER 3,500 SF = 2 SPACES REQUIRED CLUBHOUSE AMMENITY 583 SF X 1 PER 3,000 SF = 2 SPACES REQUIRED TOTAL SPACES REQUIRED = 248 SPACES SPACES PROVIDED = 300 SPACES 248 SPACES X 5% = 12 CHARGING SPACES REQUIRED, 13 PROVIDED

NET LOT AREA = 172,209 SF REQUIRED LANDSCAPE AREA @ 25% = 43,052 SF ; 115,374 SF PROVIDED PARKING: MULTI-FAMILY 1 BEDROOM: 87 EACH X 1.2 SPACES = 104 SPACES 2 BEDROOM: 88 EACH X 1.6 SPACES = 140 SPACES

ZONING: MX-L ZONE ATLAS PAGE: D-10 GROSS LOT AREA = 6.5656 AC = 285,999.06 SF BUILDING FOOTPRINT = 113,790 SF

THE DEVELOPMENT HAS GATES, OWNER TO PROVIDE THE REFUSE DRIVER WITH REMOTE CONTROL GATE OPENER. THE SLOPE LEADING TO THE TRASH ENCLOSURE/DUMPSTER SHALL BE NO GREATER THAN 1/8" PER FOOT ON THE APPROACH.

RECYCLING CONTAINERS LOCATED ADJACENT TO THE REFUSE ENCLOSURE, SEE

THE REFUSE DRIVER SHALL HAVE ACCESS TO TRASH ENCLOSURE/DUMPSTER BY

1'-0"

CLEAR ZONE

SCALE: 1/4" = 1'-0"

METAL SIGN - BACKGROUND

COLOR TO BE REFLECTIVE

WHITE WITH LETTER COLOR

- 1-1/2" O.D. GALV. STL. PIPE IN 8"

- CROWN CONC. FOR POSITIVE

- FINISH GRADE OR PAVEMENT

DRAINAGE

DIA. X 24" DEEP CONC. FOOTING

TO BE HANDICAP BLUE

4'-0"

THERE ARE NO OVERHANGING WIRES LEADING TO AND EXITING FROM THE

THIS PROJECT WILL NOT ALTER EXISTING TRASH SERVICE FOR THE

SURROUNDING BUSINESSES DURING CONSTRUCTION.

OWNER SHALL PURCHASE 8 CY REFUSE CONTAINER.

4'-0"

1'-0"

1 1

11 1

BIKE PARKING

HC SIGN

1'-0" 2'-0" 2'-0" 2'-0" 2'-0" 1'-0"

1'-0"

* *

 \rightarrow

SOLID WASTE NOTES:


SOLID WASTE CALCS: 175 UNITS X 0.55 CY = 96 CY PER WEEK

THERE IS NO FOOD SERVICE FOR THIS PROJECT.

KEYED NOTE.

TRASH ENCLOSURE.

5:00AM.

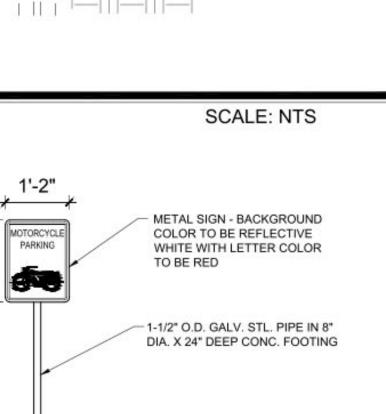

18'-0' MIN E 9'-0" MIN 8'-0" MIN

ADA PARKING

LEGAL: LOT 001 BLOCK 8 VOLCANO CLIFFS SUBDIVISION


ALL PAVING SHALL BE SHALL BE ASPHALT UNLESS NOTED OTHERWISE, REF. DETAIL

ALL MECHANICAL EQUIPMENT SHALL BE SCREENED IN ACCORDANCE WITH IDO SECTION

4" STRIPE @ 36" OC PER NMSA, THE ADA ADJACENT ACCESS AISLE SHALL BE CLEARLY MARKED BY DIAGONAL, BLUE PAVEMENT STRIPING INTERNATIONAL SYMBOL OF ACCESSIBILITY 36" PARKI

> 12" HIGH LETTERING WITHIN ACCESS AISLE


SCALE: ¹/₈" = 1'-0"

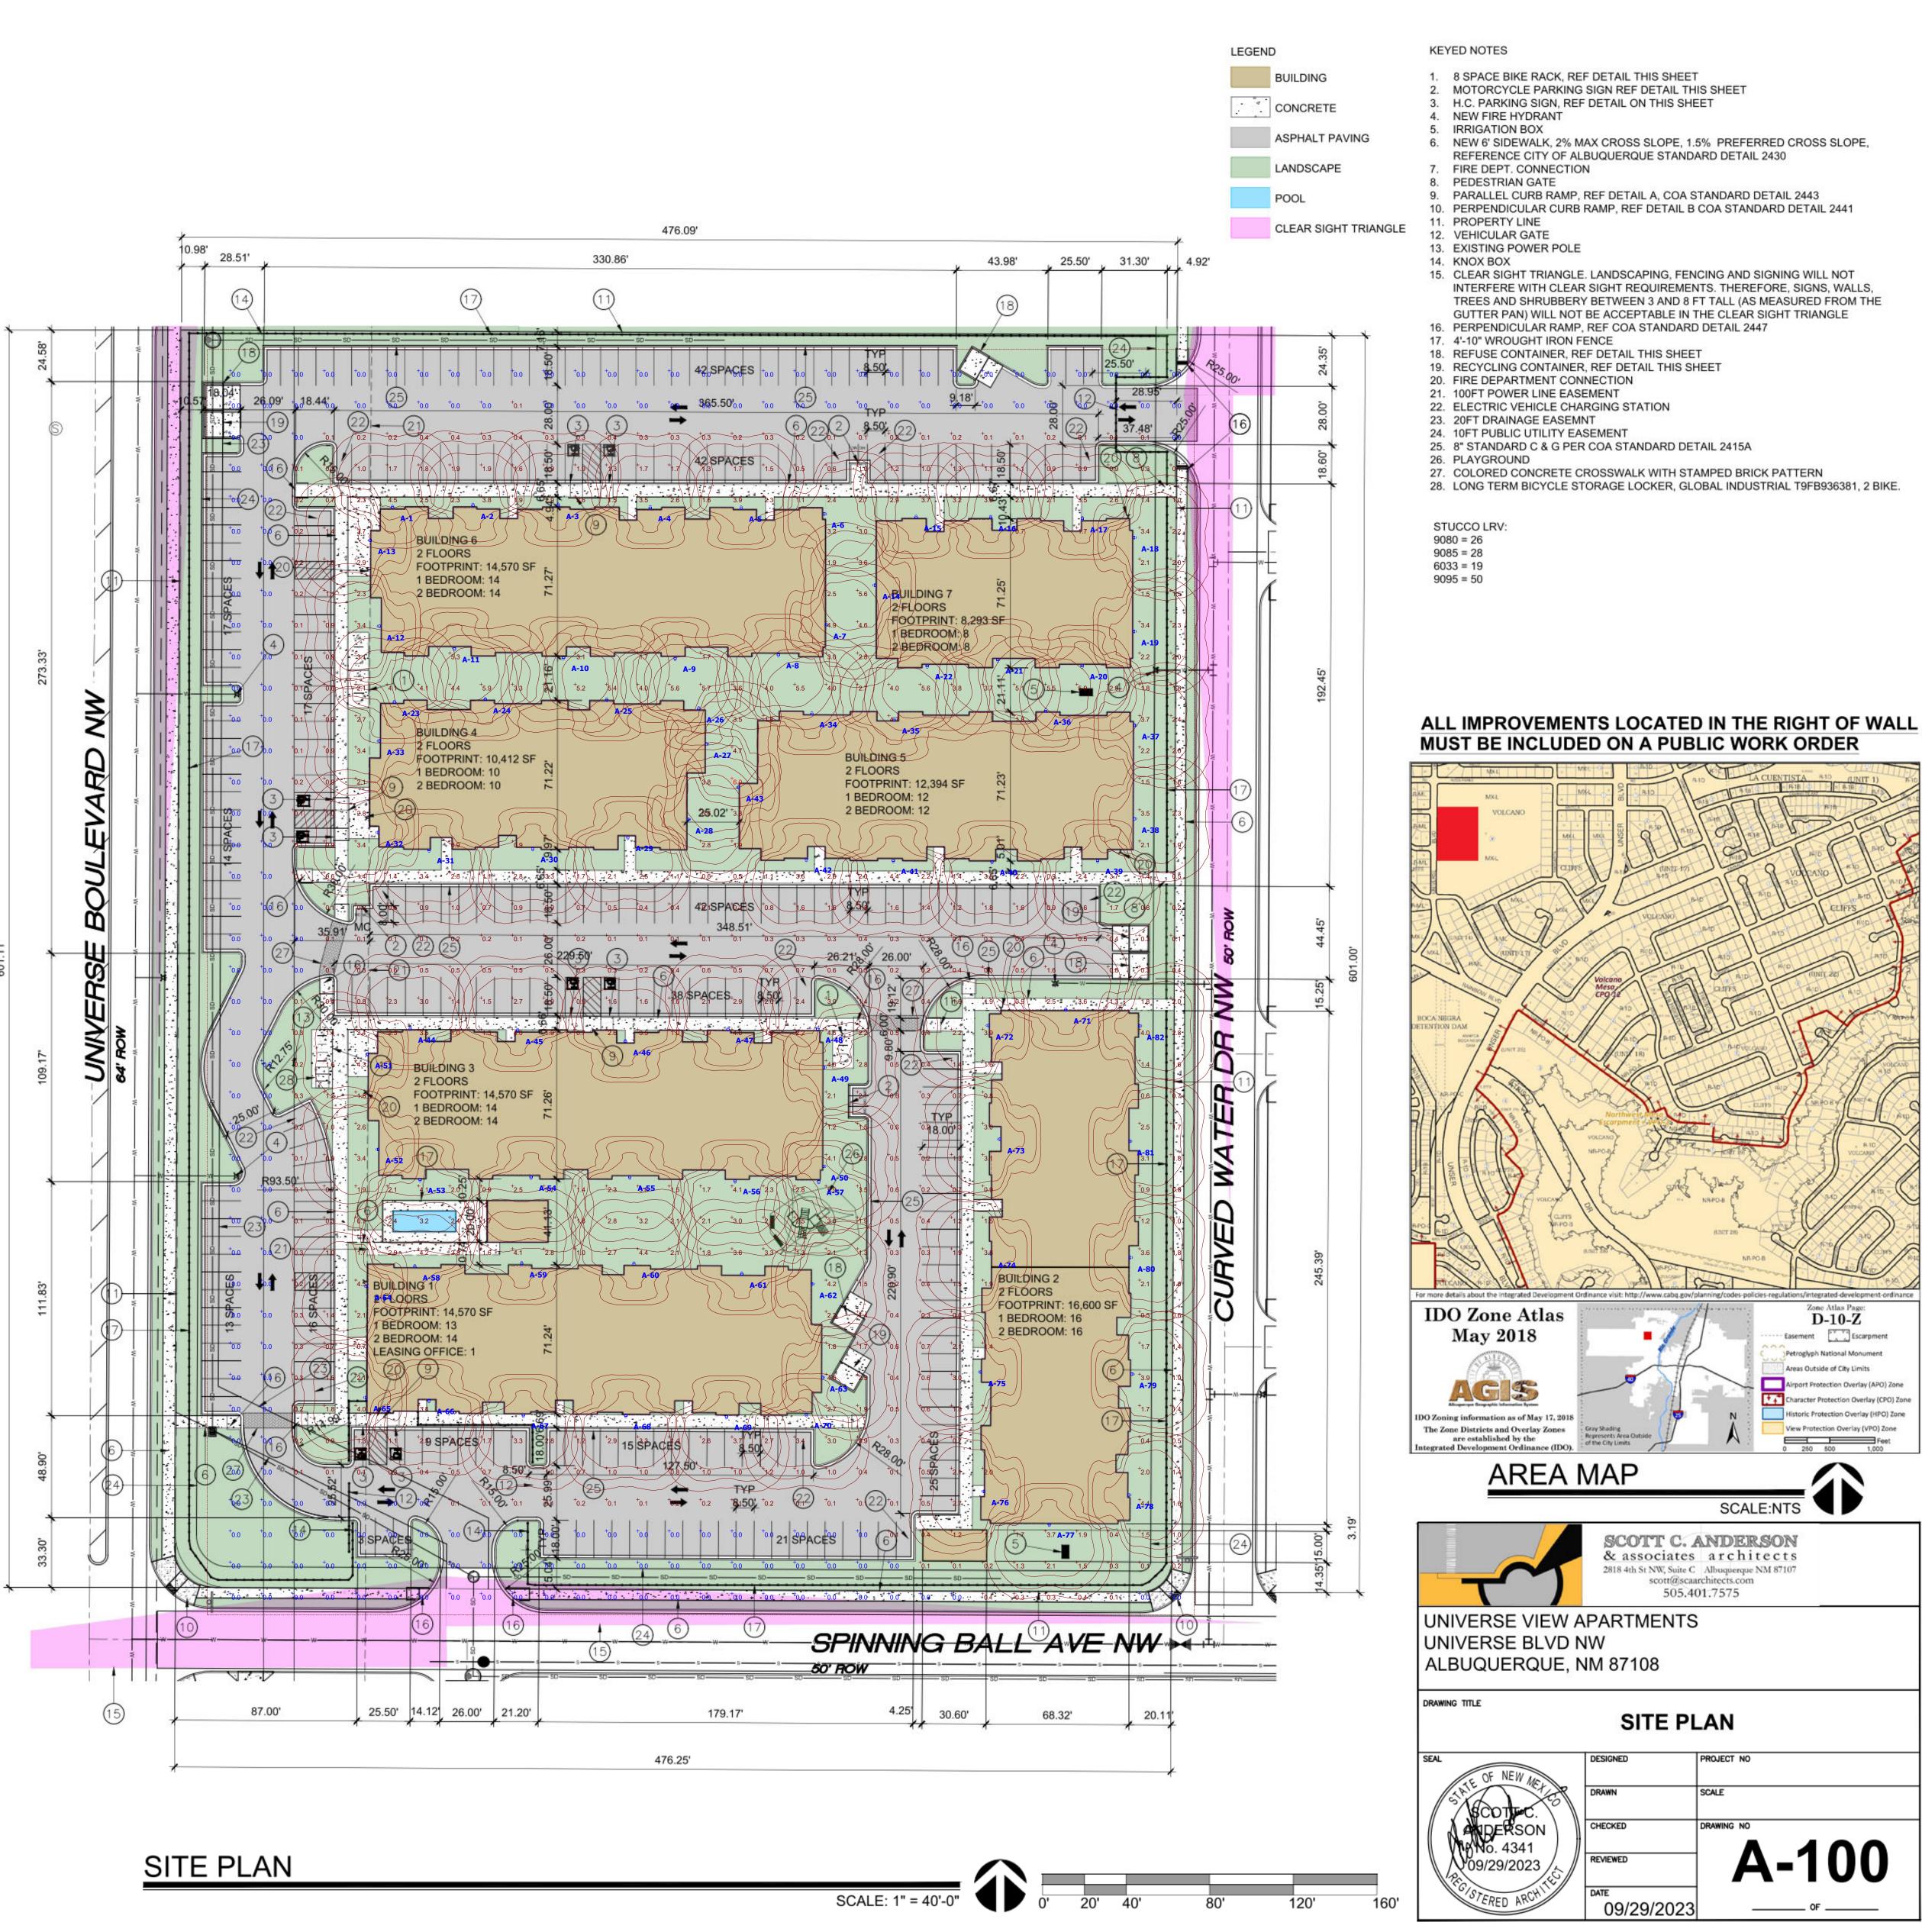

<u>Plan View</u> Scale - 1" = 35ft

VISUAL

Designer Date 01/25/2024 Scale Not to Scale Drawing No. Summary

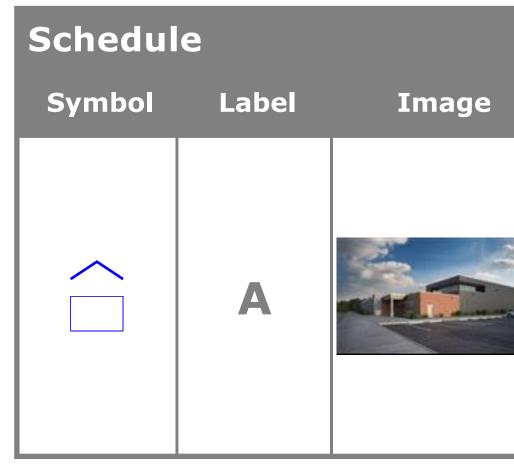



| 1 | QTY | Manufacturer | Catalog | Description | Number Lamps | Lamp Output | LLF | Input Power | Polar Plot |
|---|-----|-------------------|--------------------------------|--|-----------------|----------------|-----|----------------|-------------|
| | 82 | Lithonia Lighting | WDGE2 LED P3 40K 70CRI TFTM | WDGE2 LED WITH P3 - PERFORMANCE PACKAGE, 4000K, 70CRI, TYPE FORWARD THROW MEDIUM OPTIC | 1 | 3573 | 1 | 32.1375 | Max: 2457cd |

| Statis | tics | | | | | | |
|---------|------|--------------------------------------|--------|--------|--------|---------|---------|
| Descrip | tion | Symbol | Avg | Max | Min | Max/Min | Avg/Min |
| GRADE L | EVEL | + | 1.2 fc | 6.0 fc | 0.0 fc | N/A | N/A |
| | | PACK LIGHTING FI JLATION POINTS S | | | GRADE. | | |









Specifications

| Depth (D1): | 7" |
|------------------------------|----------|
| Depth (D2): | 1.5" |
| Height: | 9" |
| Width: | 11.5" |
| Weight: (without options) | 13.5 lbs |

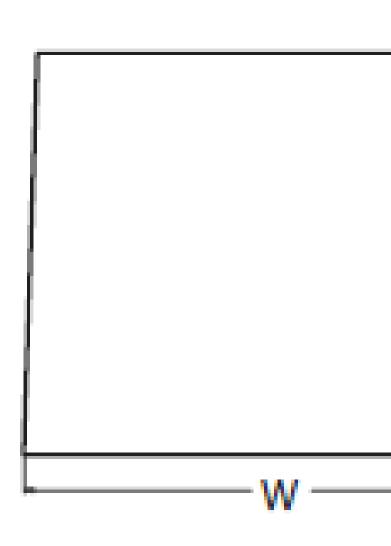

WDGE2 LED Architectural Wall Sconce Precision Refractive Optic



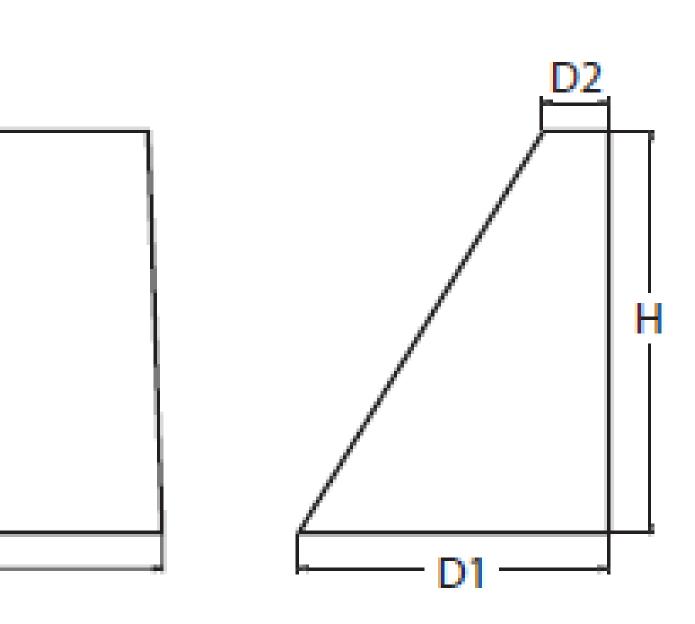



2 of 2

SOLID WASTE CALCS: 175 UNITS X 0.55 CY = 96 CY PER WEEK

SOLID WASTE NOTES:

THE DEVELOPMENT HAS GATES, OWNER TO PROVIDE THE REFUSE DRIVER WITH REMOTE CONTROL GATE OPENER.

THE SLOPE LEADING TO THE TRASH ENCLOSURE/DUMPSTER SHALL BE NO GREATER THAN 1/8" PER FOOT ON THE APPROACH.

THERE IS NO FOOD SERVICE FOR THIS PROJECT.


RECYCLING CONTAINERS LOCATED ADJACENT TO THE REFUSE ENCLOSURE, SEE KEYED NOTE.

THE REFUSE DRIVER SHALL HAVE ACCESS TO TRASH ENCLOSURE/DUMPSTER BY 5:00AM.


THERE ARE NO OVERHANGING WIRES LEADING TO AND EXITING FROM THE TRASH ENCLOSURE.

THIS PROJECT WILL NOT ALTER EXISTING TRASH SERVICE FOR THE SURROUNDING BUSINESSES DURING CONSTRUCTION.

OWNER SHALL PURCHASE 8 CY REFUSE CONTAINER.

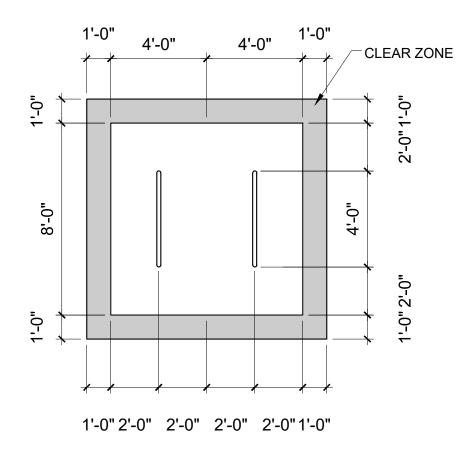


BIKE PARKING

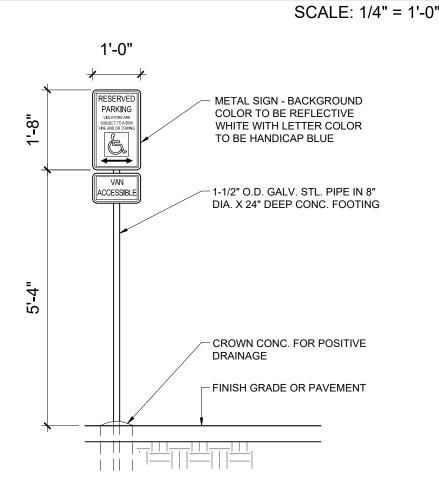

HC SIGN



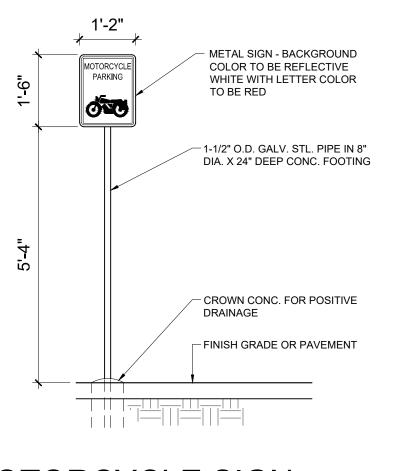

MOTORCYCLE SIGN

SCALE: 1/2" = 1'-0"

UPC: 101006305745520820 LEGAL: LOT 001 BLOCK 8 VOLCANO CLIFFS SUBDIVISION ZONING: MX-L ZONE ATLAS PAGE: D-10

GROSS LOT AREA = 6.5656 AC = 285,999.06 SF BUILDING FOOTPRINT = 31.561 SF NET LOT AREA = 30 SE REQUIRED LANDSCAPE AREA @ 15% = 29,023 SF ; 74,520 SF PROVIDED

PARKING: MULTI-FAMILY 1 BEDROOM: 87 EACH X 1.2 SPACES = 104 SPACES 2 BEDROOM: 88 EACH X 1.6 SPACES = 140 SPACES LEASING OFFICE 738 SF X 0.0035 = 2 SPACES REQUIRED TOTAL SPACES REQUIRED = 246 SPACES SPACES PROVIDED = 300 SPACES 246 SPACES X 2% = 5 CHARGING SPACES REQUIRED, 6 PROVIDED

HC REQUIRED: 4 STANDARD, 3 VAN MOTORCYCLE PARKING 151-300 SPACES: 5 SPACES REQUIRED / 7 PROVIDED BIKE PARKING 10% OF 246: 25 REQUIRED, 32 SPACES PROVIDED

IDO TABLE 5-1-2 OPEN SPACE: 1 BEDROOM: 87 EA X 225 SF = 19,575 SF 2 BEDROOM: 88 EA X 285 SF = 25,080 SF

TOTAL REQUIRED = 44,837 SF

GRADE LEVEL OPEN SPACE = 67,985 SF PROVIDED (EXCLUDING SIDEWALKS) UPPER FLOOR BALCONIES & DECKS = 7,875 SF PROVIDED TOTAL PROVIDED = 75,860 (69% MORE THAN REQUIRED)

NOTE:

ALL IMPROVEMENTS LOCATED IN THE RIGHT OF WAY MUST BE INCLUDED IN ON A PUBLIC WORK ORDER.

LANDSCAPING, FENCING AND SIGNING WILL NOT INTERFERE WITH CLEAR SIGHT REQUIREMENTS. THEREFORE, SIGNS, WALLS, TREES AND SHRUBBERY BETWEEN 3 AND 8 FEET TALL (AS MEASURED FROM THE GUTTER PAN) WILL NOT BE ACCEPTABLE IN THE CLEAR SIGHT TRIANGLE.

ALL PAVING SHALL BE SHALL BE ASPHALT UNLESS NOTED OTHERWISE, REF. DETAIL THIS SHEET.

ALL MECHANICAL EQUIPMENT SHALL BE SCREENED IN ACCORDANCE WITH IDO SECTION 5-5 (G).

ALL OUTDOOR LIGHT FIXTURES SHALL BE LED. FIXTURES 70 WATTS OR GREATER SHALL BE SHIELDED USING FULL CUTOFF LIGHT FIXTURES.


BUILDING MOUNTED SIGNS SHALL BE EXTERNALLY ILLUMINATED AND SHALL NOT EXTEND MORE THAN 2 FEET ABOVE THE EXTERIOR WALLS OF THE BUILDING.

WORK WITHIN THE PUBLIC RIGHT OF WAY REQUIRES A WORK ORDER.

PROVIDE ELECTRIC VEHICLE CHARGER AT EACH BAY OF LEASED GARAGES


SITE LIGHTING WILL BE PROVIDED BY LIGHT BOLLARDS AND WALL MOUNTED FIXTURES AND SHALL COMPLY WITH 5-8 OF THE IDO

"MC" SHALL BE PAINTED ON THE PAVEMENT OF EACH MOTORCYCLE PARKING SPACE

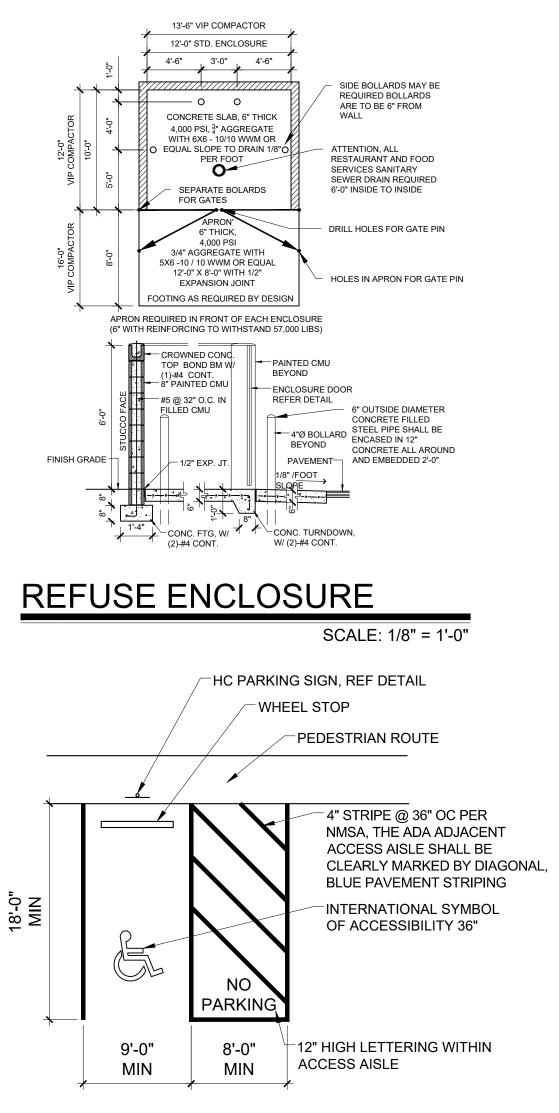

ADA PARKING

AN APPROVED WORK ORDER IS A CONDITION OF RELEASING THE FINAL CO.

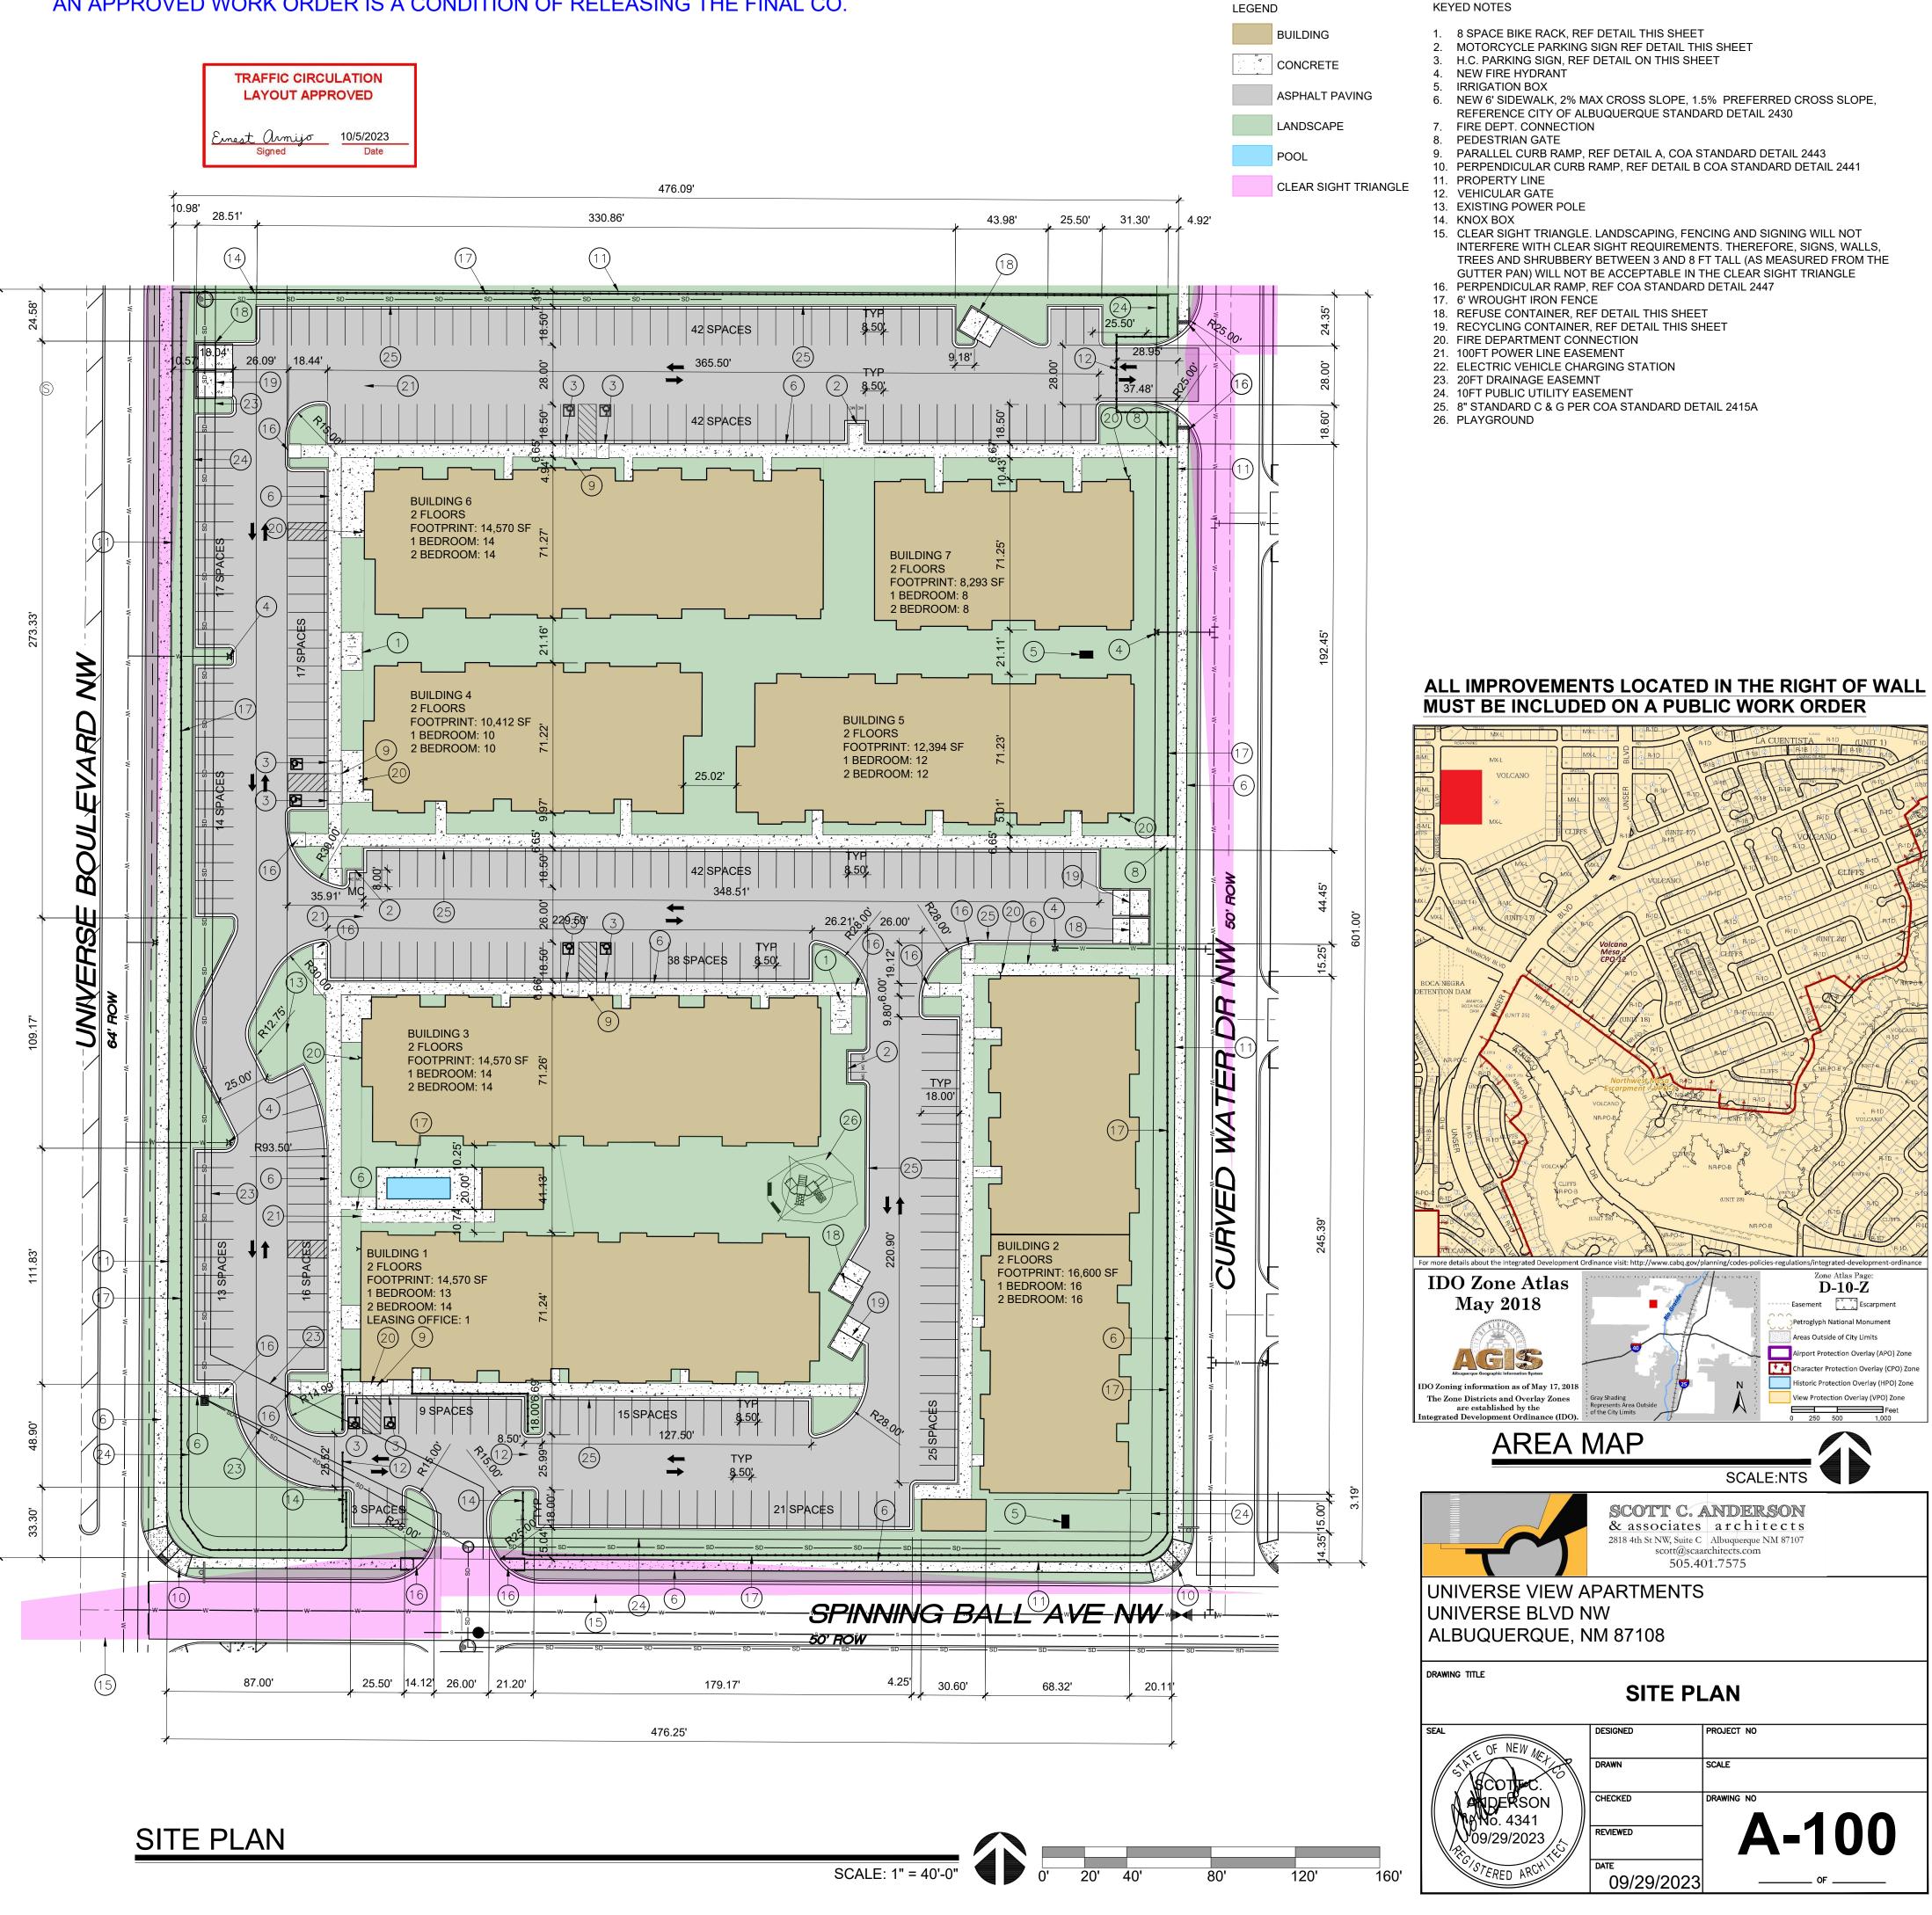

KEYED NOTES

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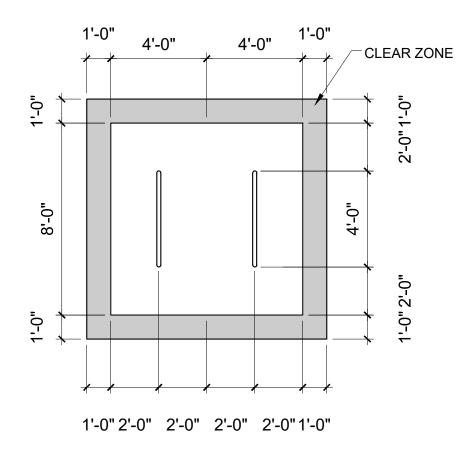
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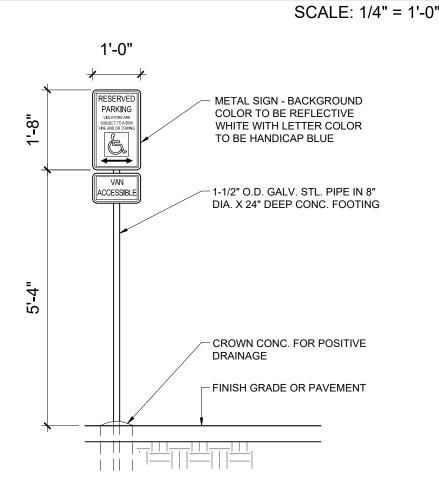
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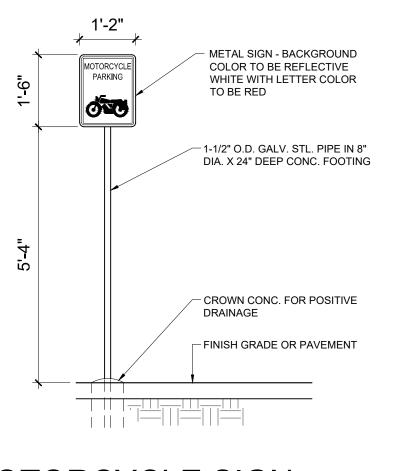


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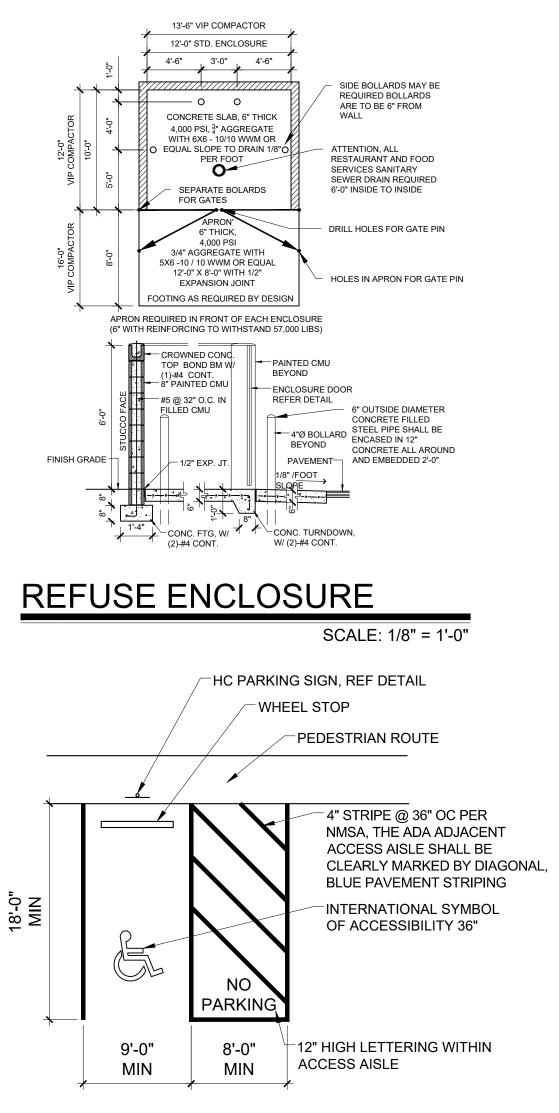
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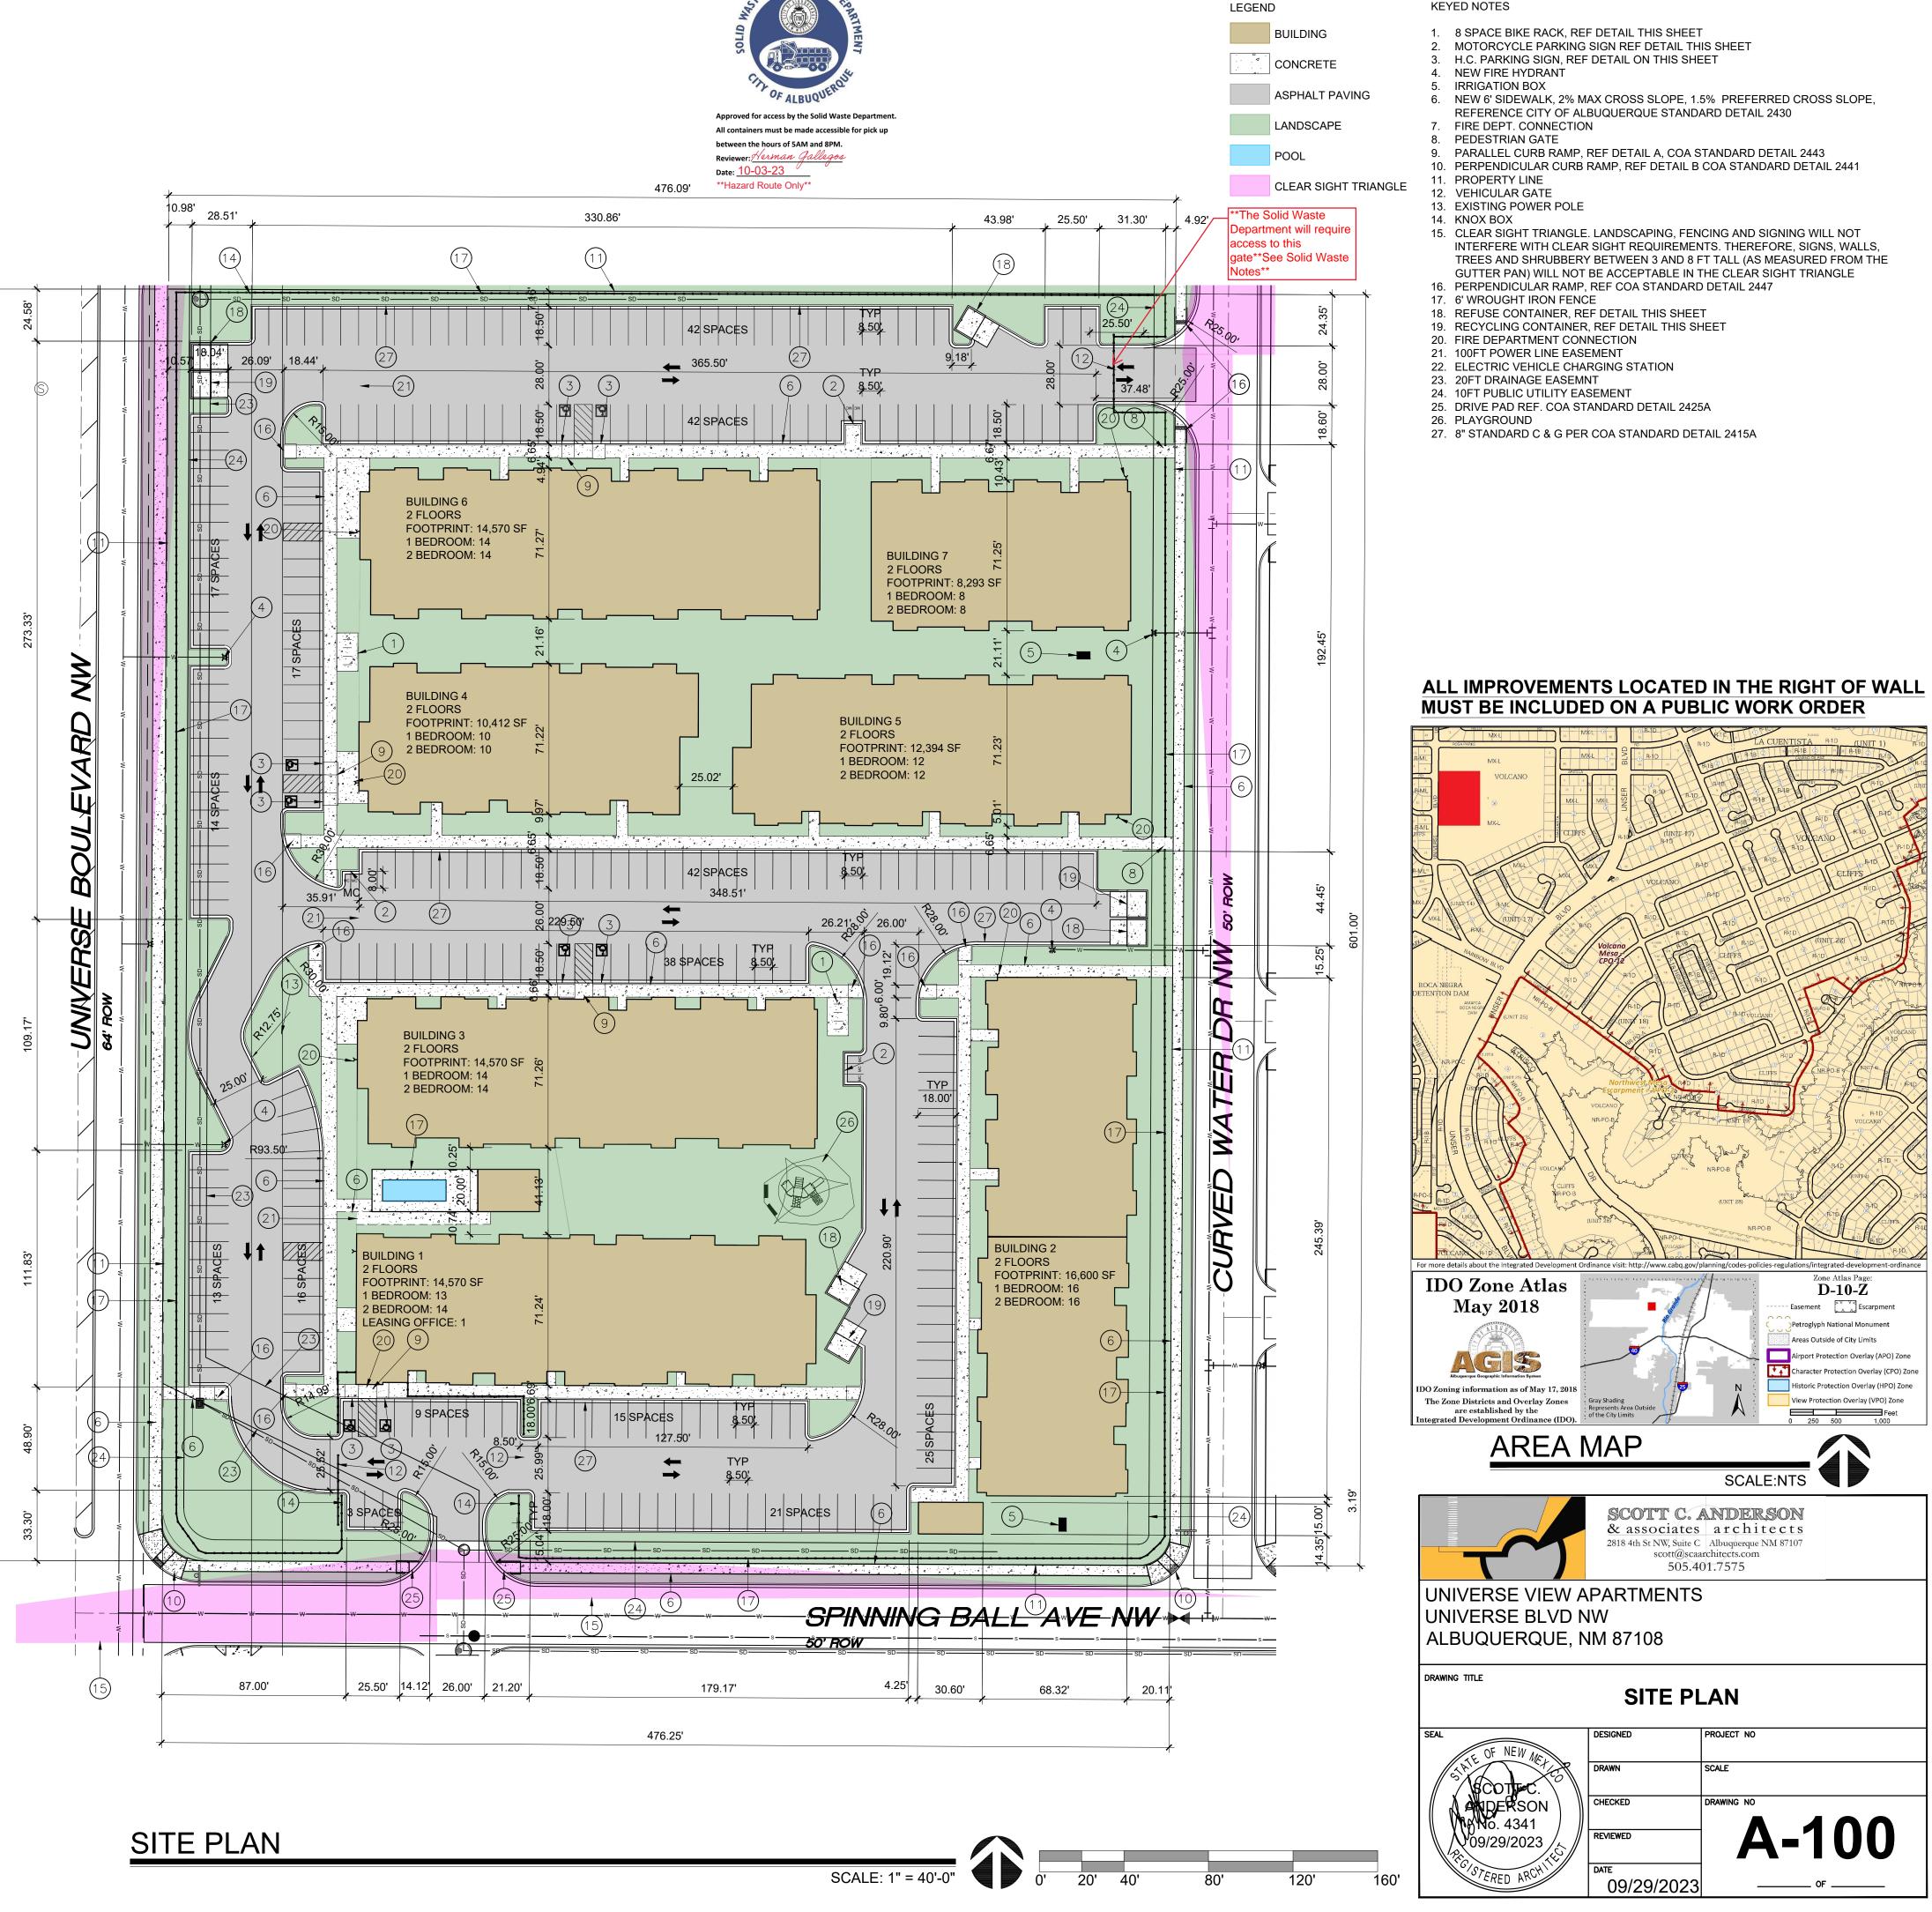
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