


ROSA PARKS RD. NW

64' ROW

GENERAL NOTES

- IN CASE OF DISCREPANCIES IN PLANT QUANTITIES SHOWN ON THE PLANT SCHEDULE AND THOSE SHOWN ON THE PLAN, THE QUANTITIES SHOWN ON THE PLAN SHALL PREVAIL. CONTRACTOR SHALL VERIFY ALL QUANTITIES PRIOR TO BID AND INSTALLATION.
- POSITIVE DRAINAGE AWAY FROM ALL STRUCTURES SHALL BE PROVIDED TO THE LANDSCAPE CONTRACTOR AND SHALL BE MAINTAINED BY THE LANDSCAPE CONTRACTOR THROUGHOUT THE DURATION OF THE PROJECT.
- GRADING OF THE SITE PER THE GRADING PLAN IS NOT INCLUDED IN THE SCOPE OF WORK OF THE LANDSCAPE CONTRACTOR. GRADES PER THE GRADING PLAN SHALL BE PROVIDED TO THE LANDSCAPE CONTRACTOR +/- 1/10TH OF A FOOT, BY OTHERS.
- ALL MAINTENANCE OF THE LANDSCAPE AND IRRIGATION SYSTEMS SHALL BE PROVIDED BY OWNER. NO CONTRACTUAL MAINTENANCE SHALL BE INCLUDED UNLESS OTHERWISE SPECIFIED IN THE BIDDING DOCUMENTS.
- WATER MANAGEMENT IS THE SOLE RESPONSIBILITY OF THE PROPERTY OWNER. THE LANDSCAPE ARCHITECT IS NOT RESPONSIBLE FOR ANY RESTRICTIONS OF IRRIGATION WATER USE BY ANY GOVERNING BODY.
- PER 5-6(C)(4)(a) A MINIMUM OF 5 SPECIES MUST BE USED IN THE LANDSCAPED AREA.
- PER 5-6(C)(4)(b) ONLY TREES AND SHRUBS SELECTED FROM THE OFFICIAL ALBUQUERQUE PLANT PALETTE OF LOW WATER USE, DROUGHT TOLERANT, OR XERIC SPECIES AND SHOWN ON A LANDSCAPE PLAN CAN COUNT TOWARD THE REQUIREMENTS OF THIS SUBSECTION 14-16-5-6(C) (GENERAL LANDSCAPING STANDARDS), EXCEPT THAT, UPON PRESENTATION OF EVIDENCE, THE RELEVANT DECISION-MAKING BODY MAY AUTHORIZE ALTERNATIVE SPECIES OR CULTIVARS THAT MEET ALL OF THE FOLLOWING REQUIREMENTS:
  - MEET THE INTENDED PURPOSE OF THAT TYPE OF LANDSCAPING.
  - ARE NOT HAZARDOUS.
  - ARE NOT IDENTIFIED AS INVASIVE ON A CITY OR STATE PLANT LIST.
  - ARE NOT LISTED IN THE CITY'S WEED IDENTIFICATION HANDBOOK.
  - ARE EQUALLY HARDY TO THE NEW MEXICO CLIMATE.
- PER 5-3(D)(3)(a) 3, SHADE TREES ALONG REQUIRED PEDESTRIAN WALKWAYS ARE REQUIRED PURSUANT TO SUBSECTION 14-16-5-6(C)(4)(i) (REQUIRED PLANT MATERIALS AND SITE AMENITIES), 5-6(C)(4)(i) SHADE TREES PLANTED APPROXIMATELY 25 FEET ON-CENTER ARE REQUIRED ALONG ALL REQUIRED PEDESTRIAN WALKWAYS. IF THE WALKWAY IS LESS THAN FEET LONG, AT LEAST ONE TREE IS REQUIRED, OR, WHERE THERE IS INSUFFICIENT SPACE FOR A TREE, A TRELLIS OF AT LEAST 8 FEET HIGH FOR AT LEAST 5 FEET ALONG THE WALKWAY SHALL BE PROVIDED.
- PER 5-6(F)(1)(i) 1 OF THE IDO, ANY PARKING LOT LOCATED WITHIN 30 FEET OF THE FRONT LOT LINE, SHALL BE SCREENED FROM THE STREET EITHER BY A MASONRY WALL CONSTRUCTED OF A MATERIAL SIMILAR IN TEXTURE, APPEARANCE, AND COLOR TO THE STREET-FACING FAÇADE OF THE PRIMARY BUILDING (BUT EXCLUDING EXPOSED CMU BLOCK) AT LEAST 3 BUT NOT MORE THAN 4 FEET IN HEIGHT, OR BY A LANDSCAPE BUFFER AT LEAST 10 FEET IN WIDTH WITH A CONTINUOUS LINE OF EVERGREEN SHRUBBERY 3 FEET IN HEIGHT, OR BY OTHER MEANS THAT THE PLANNING DIRECTOR DETERMINES PROVIDES EQUAL OR BETTER SCREENING OF THE HEADLIGHTS OF PARKED VEHICLES.
- PER 5-6(C)(9)(a), ALL PLANTING OF VEGETATED MATERIAL OR INSTALLATION OF ANY LANDSCAPING, BUFFERING, OR SCREENING MATERIAL IN THE PUBLIC RIGHT-OF-WAY SHALL REQUIRE THE PRIOR APPROVAL OF THE CITY. THE PROPERTY OWNER SHALL BE RESPONSIBLE FOR THE MAINTENANCE, REPAIRS, OR LIABILITY FOR ALL THE LANDSCAPING PLACED IN OR OVER THE PUBLIC RIGHT-OF-WAY.
- PER 5-6(C)(9)(b), ANY TREES THAT OVERHANG A PUBLIC SIDEWALK OR MAJOR PUBLIC OPEN SPACE SHALL BE TRIMMED TO MAINTAIN AN 8 FOOT CLEARANCE OVER THE SIDEWALK. ANY TREES THAT OVERHANG A PUBLIC STREET SHALL BE TRIMMED TO MAINTAIN A 9' CLEARANCE OVER THE STREET SURFACE.
- PURSUANT TO 5-6(C)(5)(e), BARK MULCH AREAS CLEARLY DELINEATED ON PLANS FOR LANDSCAPE AREAS AND 5' RADIUS RINGS AROUND TREES.
- PURSUANT TO 5-6(C)(7)(a), ALL VEGETATION HAS BEEN LOCATED A MINIMUM OF 3' IN ANY DIRECTION FROM FIRE HYDRANTS, VALVE VAULTS, HOSE BIBS, MANHOLES, HYDRANTS AND FIRE DEPARTMENT CONNECTIONS.
- PURSUANT TO 5-6(C)(10)(a), TREES AND SHRUBS SHALL NOT BE PLANTED IN UTILITY EASEMENTS UNLESS THERE IS NO OTHER PRACTICABLE LOCATION ON THE LOT WHERE THE LANDSCAPING WOULD ACHIEVE ITS INTENDED PURPOSE.
- PURSUANT TO 5-6(C)(10)(b), TREES SHALL NOT BE PLANTED WITHIN 10' IN ANY DIRECTION OF THE CENTERLINE OF A SEWER OR WATER LINE.
- CLEAR SIGHT TRIANGLE NOTE: LANDSCAPING, SIGNAGE, WALLS, FENCES, TREES, AND SHRUBBERIES BETWEEN 3' AND 8' TALL (AS MEASURED FROM THE GUTTER PAN) ARE NOT ALLOWED WITHIN THE CLEAR SIGHT TRIANGLE. PER 5-6(C)(14)(a), IRRIGATION SYSTEMS SHALL COMPLY WITH SECTION 8 OF THE ABCWA LEGISLATION AND ORDINANCES (CROSS CONNECTION PREVENTION AND CONTROL ORDINANCE)
- PER 5-6(C)(14)(b), ALL IRRIGATION SYSTEMS SHALL BE DESIGNED TO MINIMIZE THE USE OF WATER.
- PER 5-6(C)(14)(c), ALL NON-RESIDENTIAL LANDSCAPE IRRIGATION SHALL HAVE AUTOMATIC TIMERS AND/OR PROGRAMMABLE SETTINGS TO AVOID OVERWATERING.
- PER 5-6(C)(14)(d), THE IRRIGATION SYSTEM SHALL NOT SPRAY OR IRRIGATE IMPERVIOUS SURFACES, INCLUDING SIDEWALKS, DRIVEWAYS, DRIVE AISLES, STREETS, AND PARKING AND LOADING AREAS.

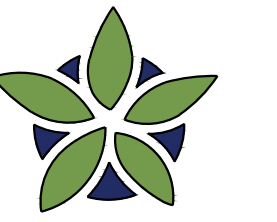

**YELLOWSTONE**  
LANDSCAPE


www.yellowstonelandscape.com  
P O Box 10597  
Albuquerque, NM 87184  
505.898.9615  
design@yellowstonelandscape.com



Date: 04/08/2024  
Revisions:  
△ 04/29/2024  
△ 05/02/2024  
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Drawn by: PL  
Reviewed by: CM

Universe View Commercial  
Albuquerque, New Mexico

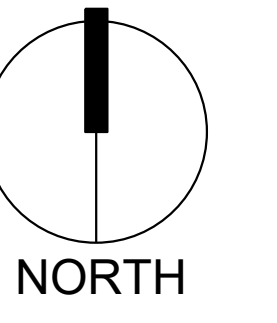


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Sheet Title:  
**Material Plan**

Sheet Number:  
**LS-01**


UNIVERSE BOULEVARD NW  
64' ROW

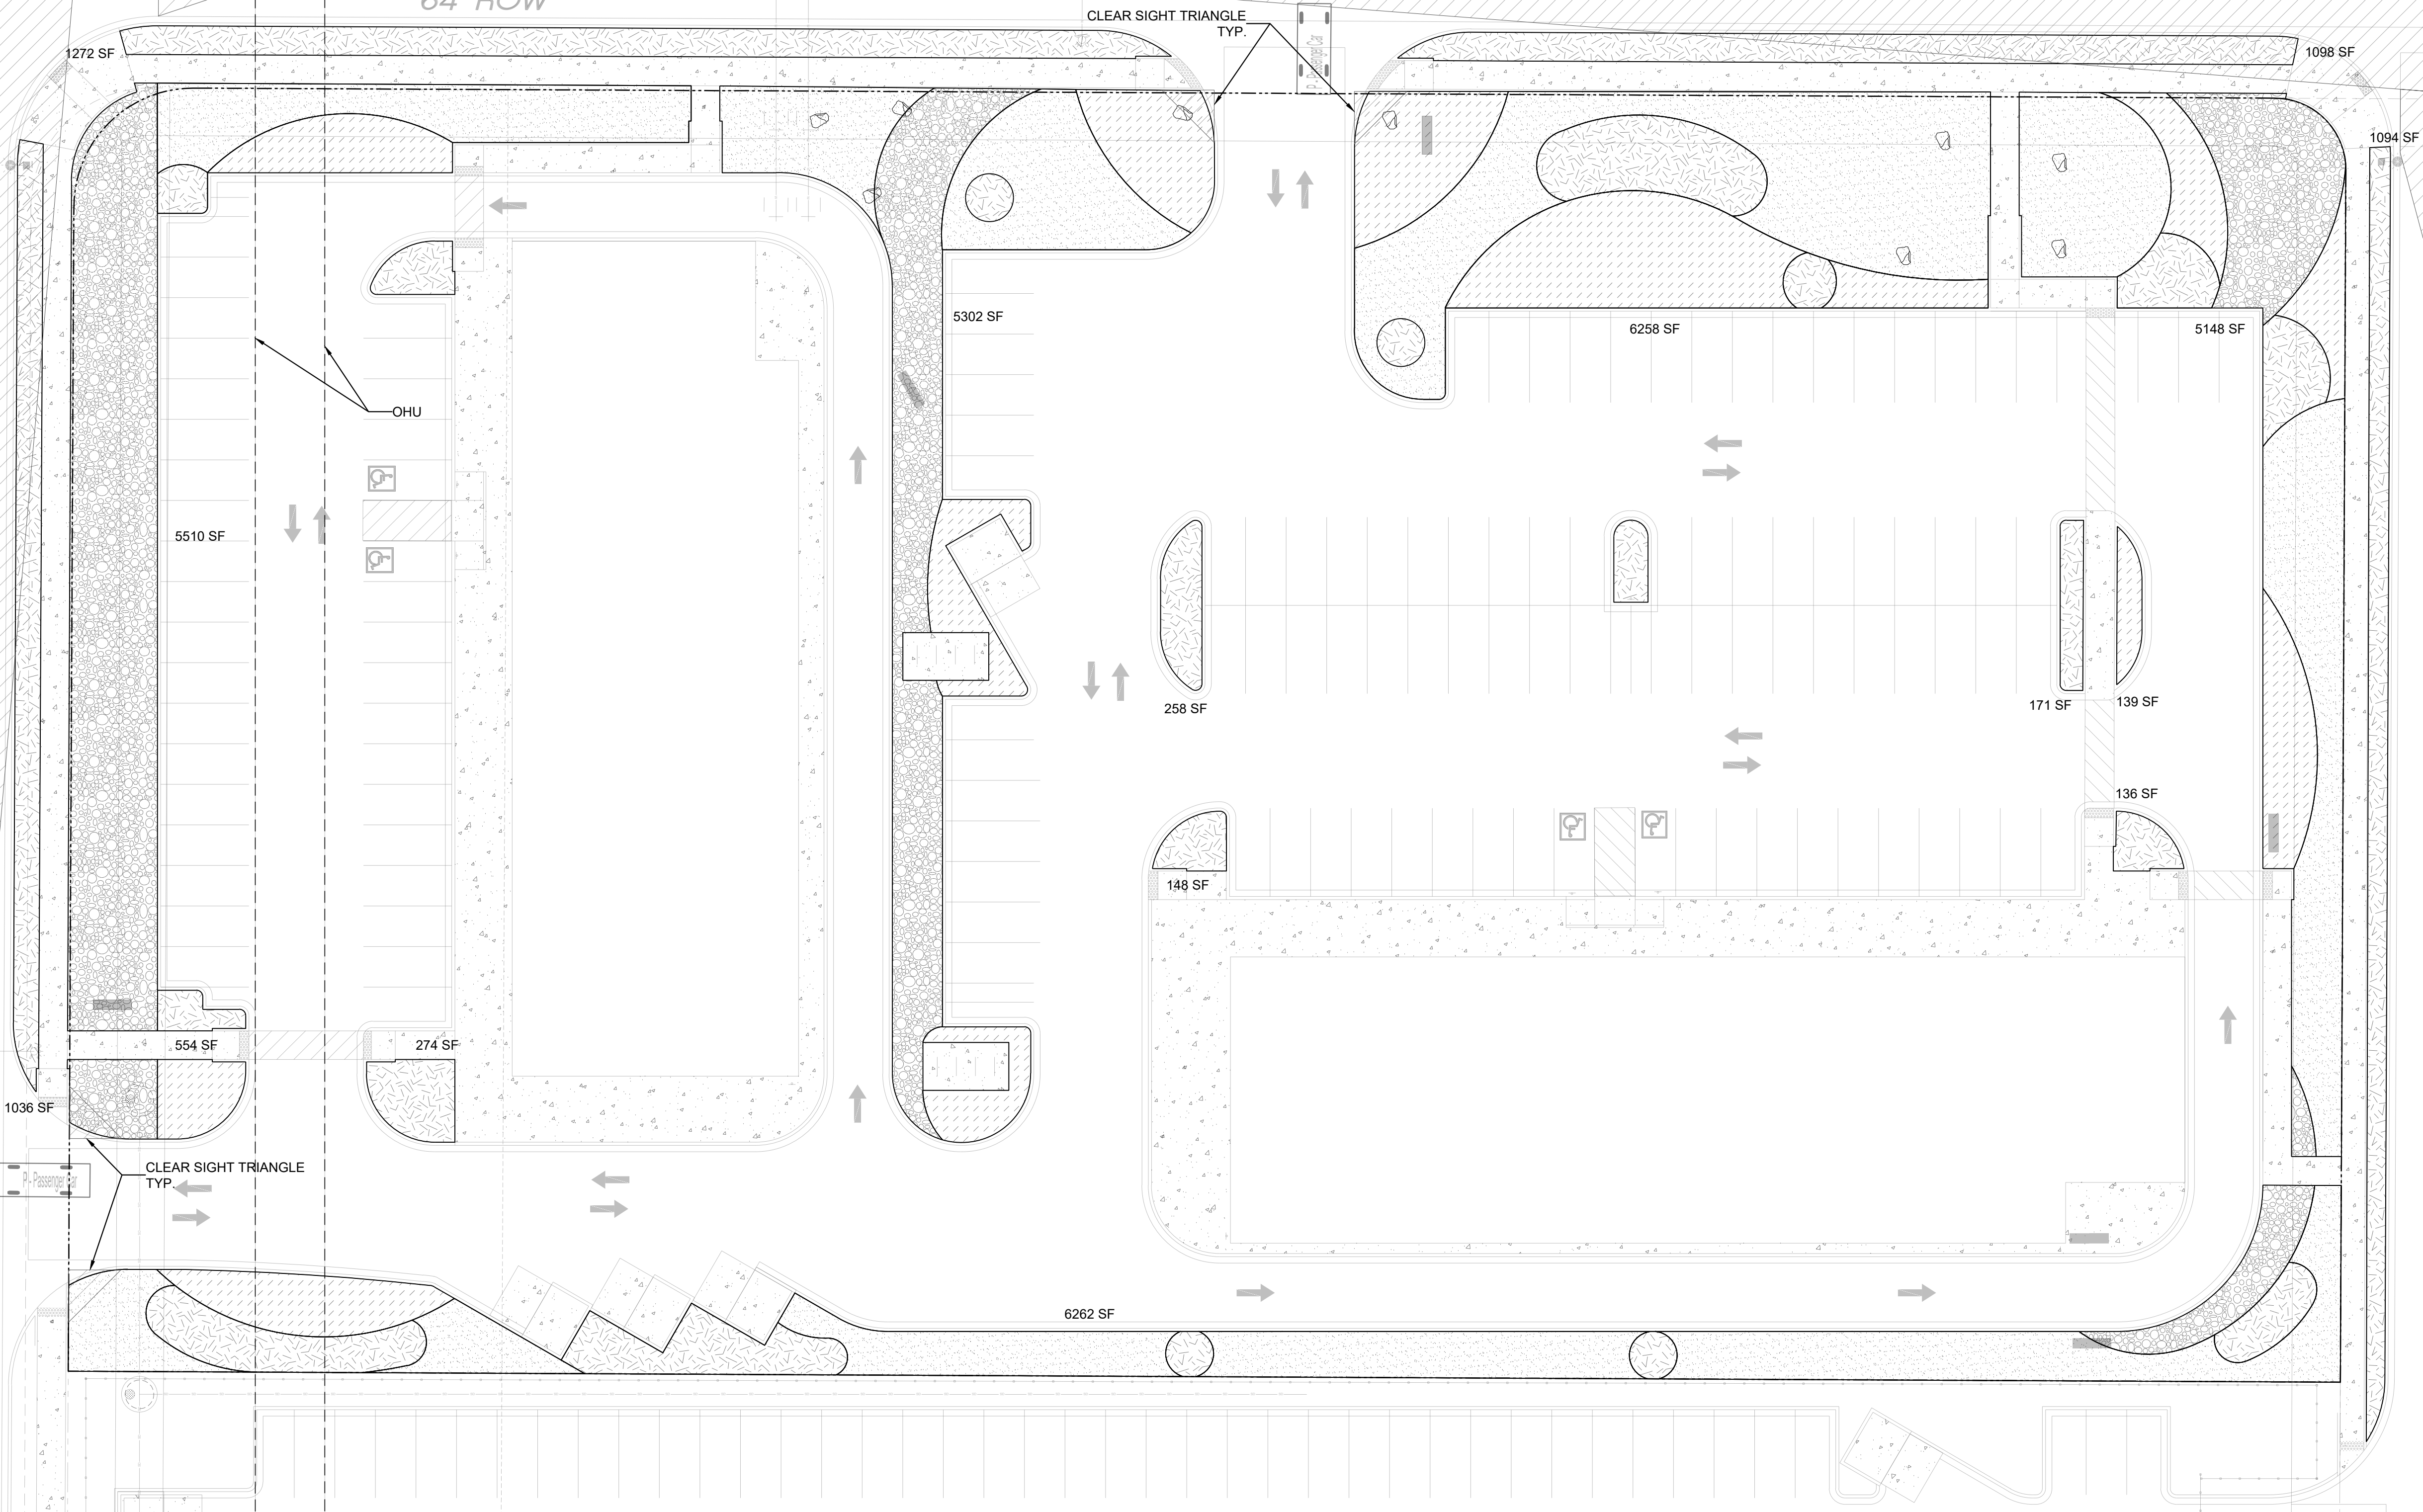


LANDSCAPE DATA		ZONING DESIGNATION	
IDO UPC#	101006305745520820	MX-L	
GROSS LOT AREA (SF)	285,999		
BUILDING AREA (SF)	31,561		
NET LOT AREA (SF)	193,585		
MINIMUM LANDSCAPE AREA (SF) - MINIMUM 15% OF NET LOT AREA*	29,038	REQUIRED	PROVIDED
TOTAL VEGETATIVE COVERAGE (SF) @ PLANT MATURITY (75% OF LANDSCAPE AREA)	21,778	35,454	18%
VEGETATIVE COVERAGE (SF) OF GROUND-LEVEL PLANTS (25% OF TOTAL, MINIMUM)	5,445	30,840	106%
* PER IDO 14-16-5-6(C)(2)(b), IN DTJUC-MS-PT AREAS, MINIMUM IS 10% OF NET LOT AREA.			
* FOR MULTI-FAMILY DWELLING, MINIMUM IS 25% OF NET LOT AREA. SEE 14-16-4-3(B)(9) FOR DETAILS.			
PLANTING AREA MULCH		REQUIRED	PROVIDED
GRAVEL OR CRUSHER FINES (SF)		MAX. 75%	26,548 75%
* PER IDO 14-15-5-6(C)(5) The use of gravel or crusher fines as ground cover is limited to a maximum 50 percent in DTJUC-MS areas.			
STREET TREES - 1 PER 25 LF		REQUIRED	PROVIDED
STREET FRONTAGE (LF)		885	
STREET TREES		36	36
* PER IDO 14-15-5-6(D)(1)(a) TREES THAT ARE PLANTED WITHIN 20 FEET OF THE BACK OF CURB OF THE ABUTTING STREET MAY FULFILL THIS REQUIREMENT.			
PARKING LOT INTERIOR		REQUIRED	PROVIDED
PARKING STALLS		111	
PARKING LOT AREA (SF)		38,049	
LANDSCAPED AREA (10% OF PARKING LOT AREA)*		3,805	28,753
TREES (1 PER 10 PARKING SPACES)		11	14
* PER IDO 14-16-5-6(F)(2), FOR PARKING LOTS CONTAINING 50 OR FEWER SPACES, MINIMUM IS 10% OF PARKING LOT AREA.			
TOTALS		REQUIRED	PROVIDED
TREES		47	67

MATERIAL SCHEDULE


SYMBOL	DESCRIPTION	QTY
	LARGE BOULDER	9
	MOUNTAINAIR SUNRISE GOLD 1" GRAVEL 3" DEPTH OVER FILTER FABRIC	
	MOUNTAINAIR BLUSH 1" GRAVEL 3" DEPTH OVER FILTER FABRIC	
	NATIVE MULCH SHREDDED WOOD MULCH 3" DEPTH NOT OVER FILTER FABRIC	
	BLUE SAIS 2-4" ANGULAR COBBLE 4" DEPTH OVER FILTER FABRIC	

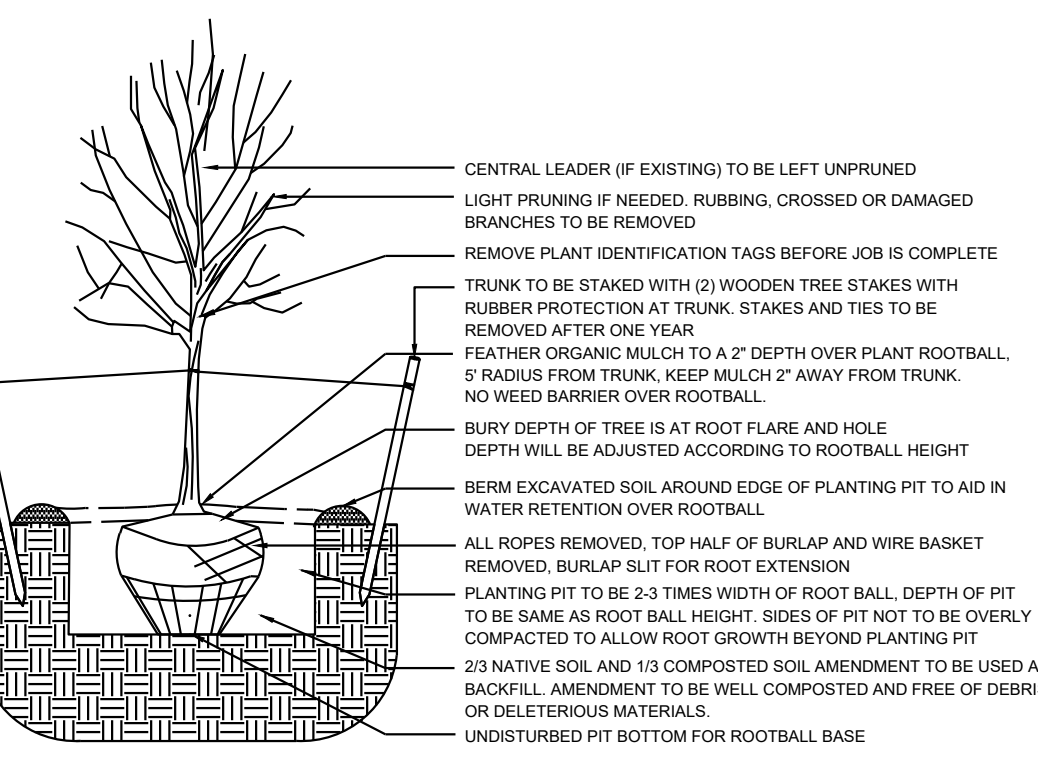

① TREE PLANTING DETAIL

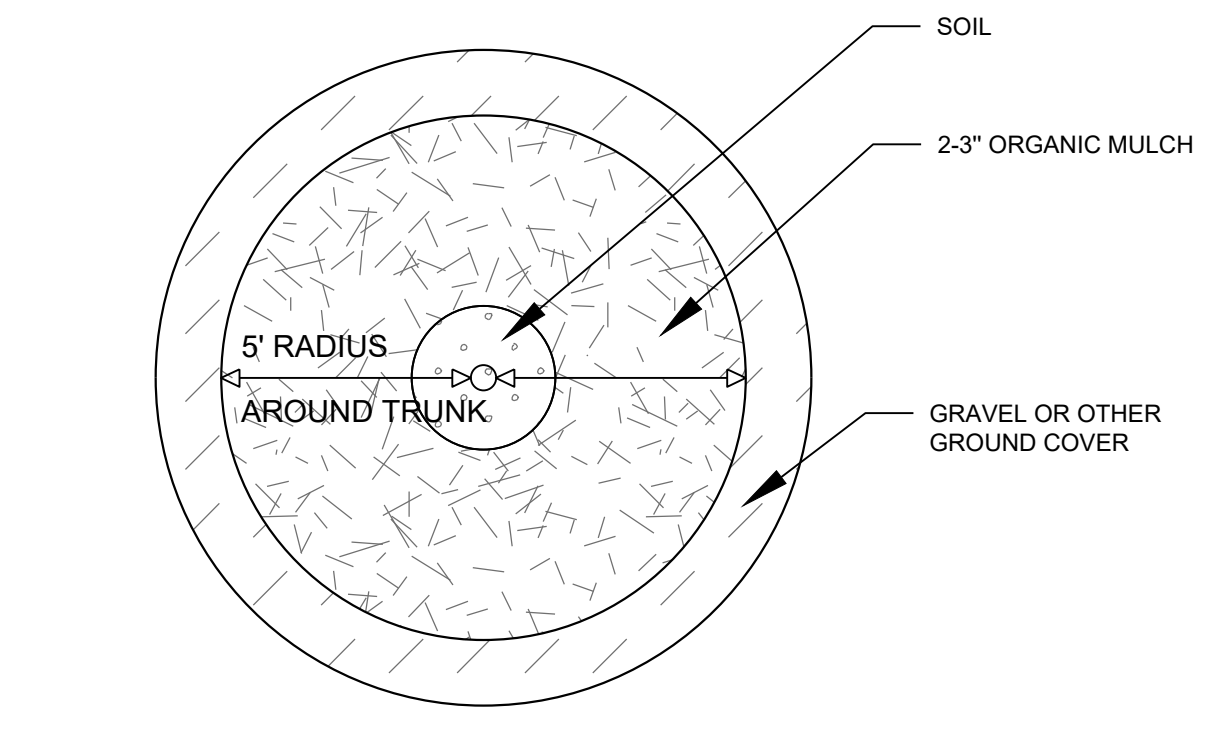

② TREE DETAIL

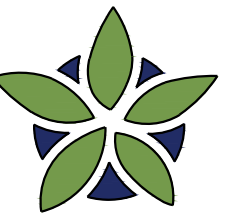

**YELLOWSTONE**  
LANDSCAPE


www.yellowstonelandscape.com  
PO Box 10597  
Albuquerque, NM 87184  
505.898.9615  
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Drawn by: PL  
Reviewed by: CM

Universe View  
Apartment  
Albuquerque, New Mexico




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Sheet Title:  
**Planting Plan**

Sheet Number:  
**LP-01**

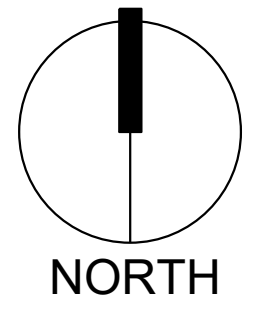UNIVERSE BOULEVARD NW  
64' ROW

ROSA PARKS RD. NW  
64' ROW

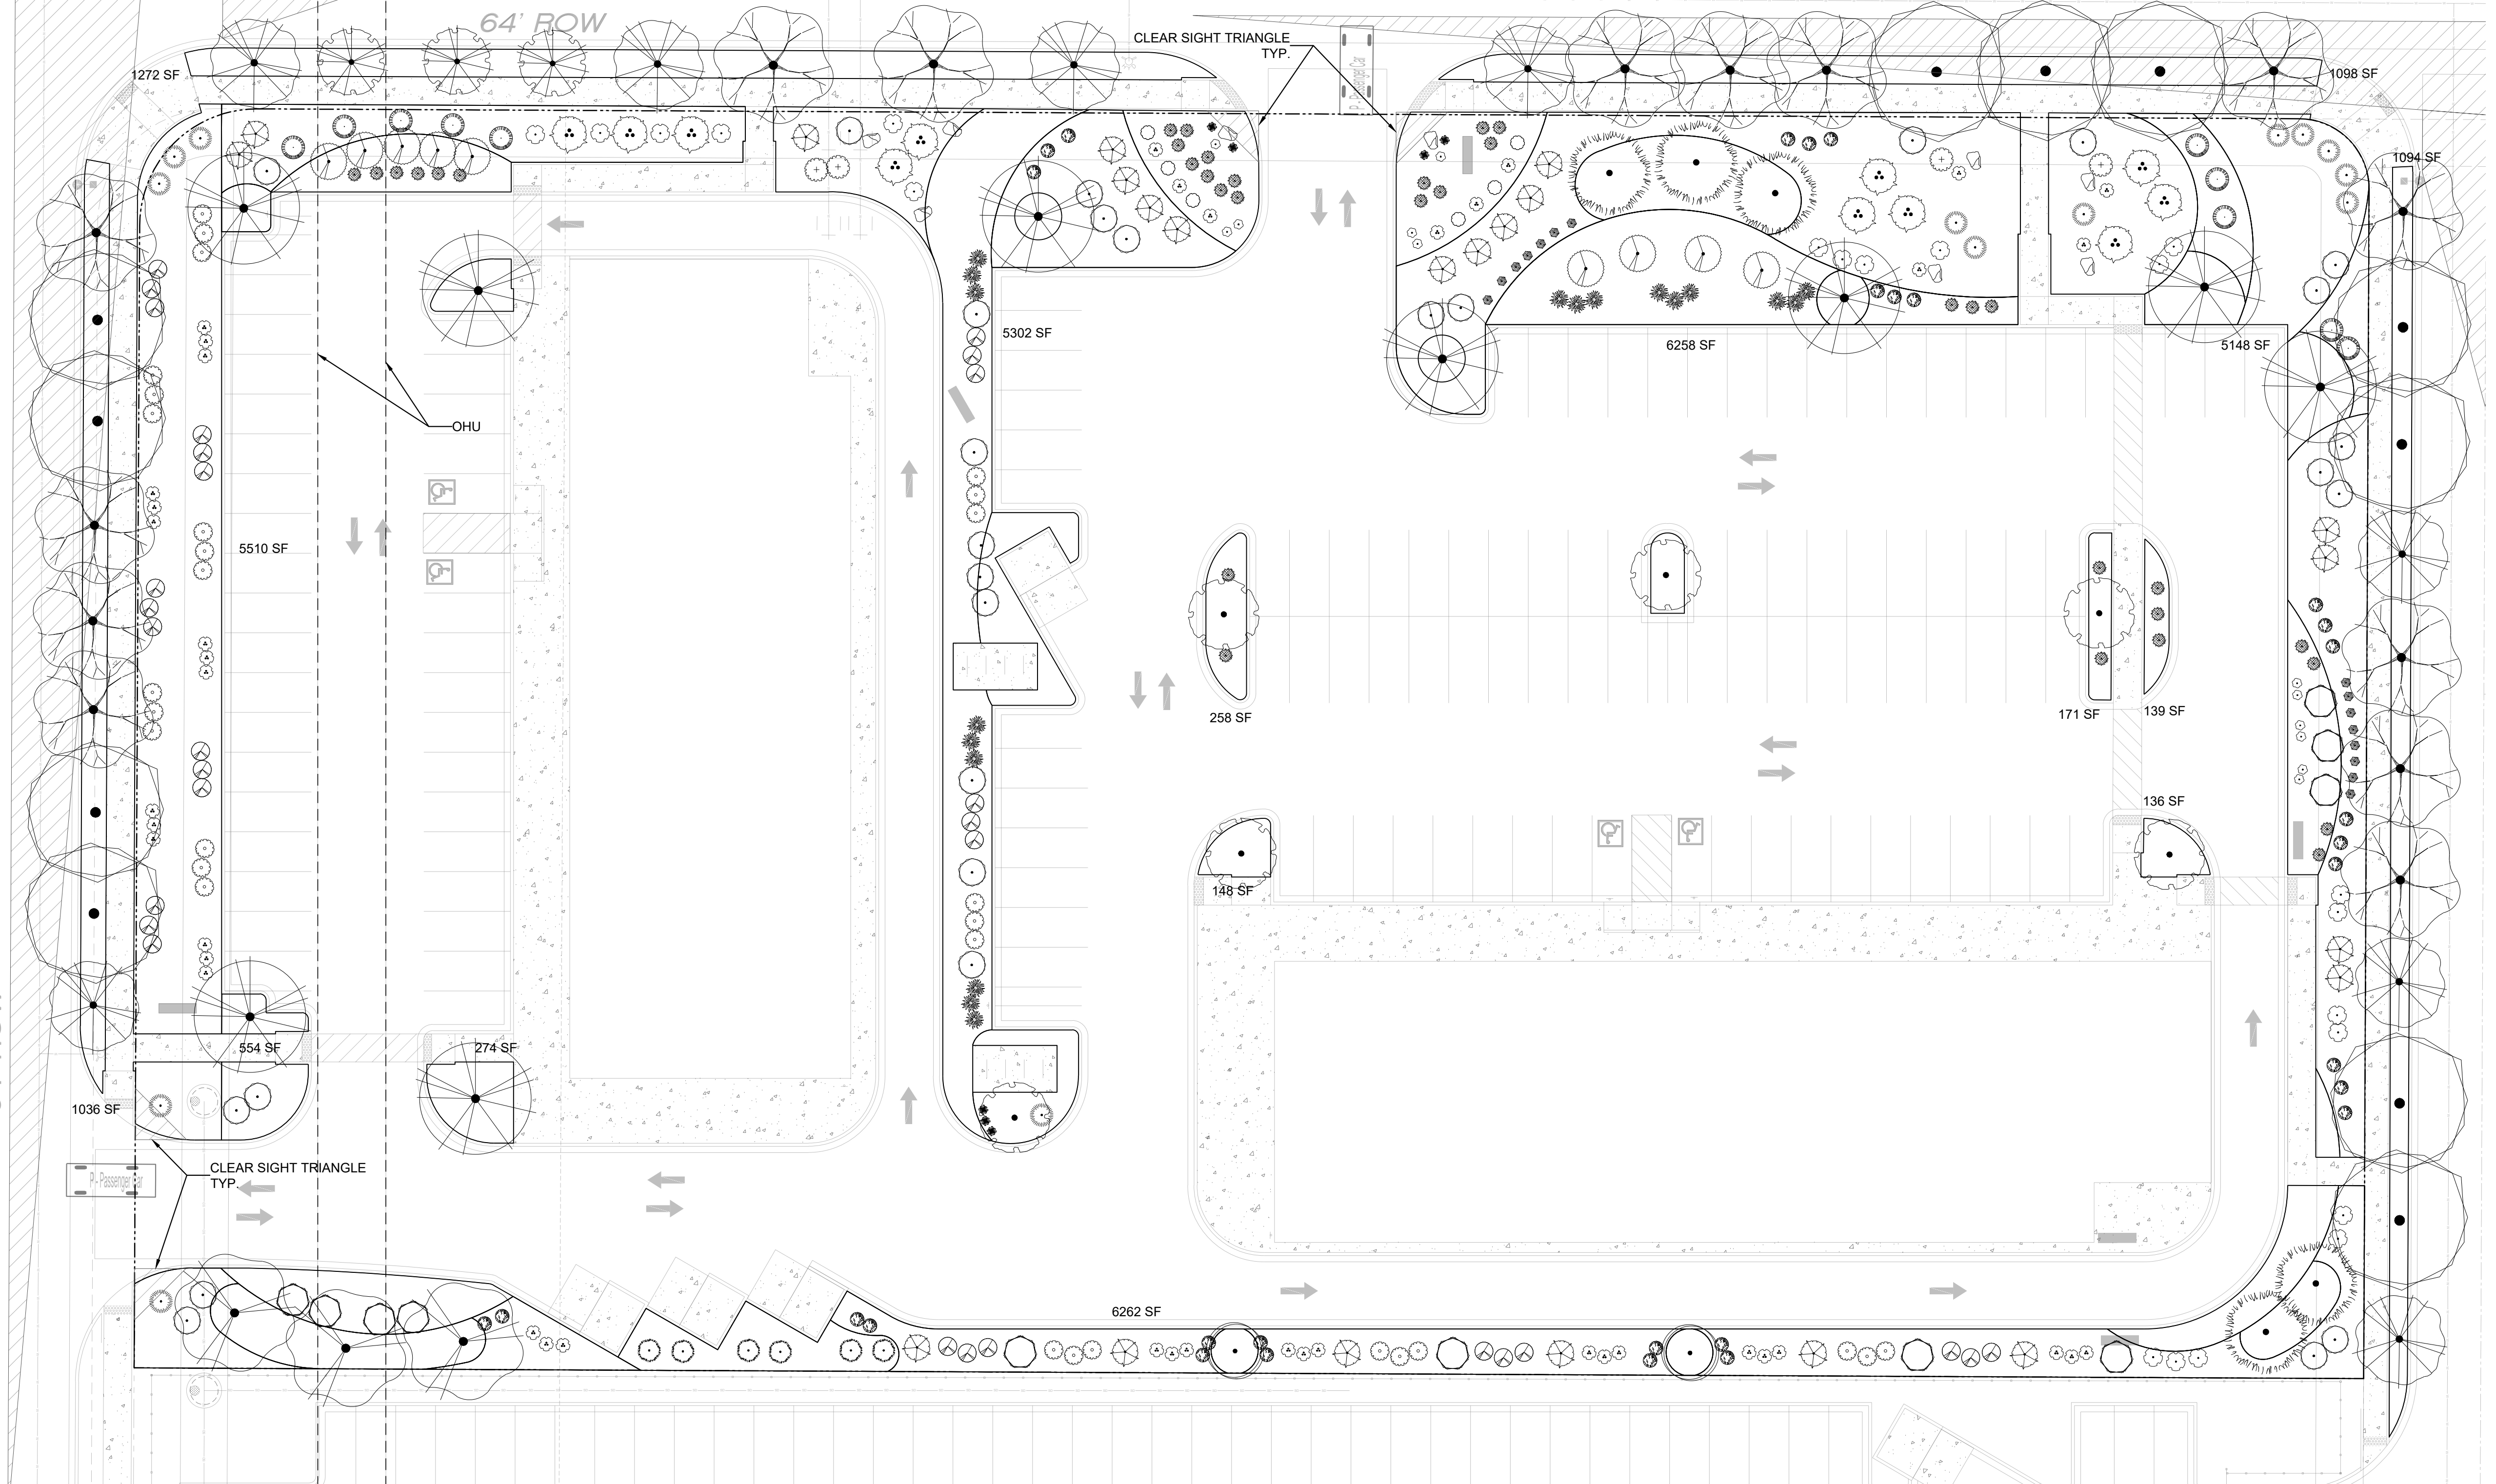

**PLANT SCHEDULE**

SYMBOL	QTY	BOTANICAL / COMMON NAME	SIZE	H X W	H X W
<b>DECIDUOUS TREE</b>					
	11	ACER NEGUNDO 'SENSATION' SENSATION BOX ELDER MAPLE	2" B&B	40' X 30'	600
	3	CHILOPSIS LINEARIS DESERT WILLOW	25 GAL	20' X 25'	491
	3	CRATAEGUS AMBIGUA RUSSIAN HAWTHORN	2" B&B	20' X 15'	177
	9	KOELREUTERIA PANICULATA GOLDEN RAIN TREE	1 1/2" B&B	25' X 25'	491
	6	PYRUS CALLERYANA 'CLEVELAND SELECT' CLEVELAND SELECT PEAR	2" B&B	25' X 15'	177
	2	QUERCUS ROBUR 'FASTIGIATA' SKYROCKET® ENGLISH OAK	2" B&B	50' X 15'	177
	14	ULMUS PROPINQUA 'EMERALD SUNSHINE' EMERALD SUNSHINE ELM	2" B&B	35' X 25'	491

SYMBOL	QTY	BOTANICAL / COMMON NAME	SIZE	H X W	H X W
<b>EVERGREEN TREE</b>					
	6	JUNIPERUS CHINENSIS 'SPARTAN' SPARTAN JUNIPER	15 GAL	20' X 5'	20
	5	PINUS ELДАРICA AFGHAN PINE	6"	40' X 18'	254
	8	QUERCUS FUSIFORMIS ESCARPMENT LIVE OAK	2" B&B	20' X 20'	314
<b>DESERT ACCENT</b>					
	11	FOUQUIERIA SPLENDENS OCOTILLO	5 GAL	12' X 8'	50
	43	HESPERALOE PARVIFLORA RED YUCCA	5 GAL	3' X 3'	7
<b>PERENNIAL</b>					
	7	ACHILLEA X 'MOONSHINE' MOONSHINE YARROW	1 GAL	2' X 2'	3
	6	GAURA LINDHEIMERI 'WHIRLING BUTTERFLIES' WHIRLING BUTTERFLIES GAURA	1 GAL	3' X 3'	7
	12	NEPETA X FAASSENII 'SELECT BLUE' CATMINT	1 GAL	1' X 2'	3


SYMBOL	QTY	BOTANICAL / COMMON NAME	SIZE	H X W	H X W
<b>ORNAMENTAL GRASS</b>					
	35	BOUTELLOUA GRACILIS 'BLONDE AMBITION' BLONDE AMBITION BLUE GRAMA	1 GAL	3' X 3'	7
	15	CALAMAGROSTIS X ACUTIFLORA 'KARL FOERSTER' FEATHER REED GRASS	1 GAL	30" X 2'	3
<b>DECIDUOUS SHRUBS</b>					
	11	BUDDLEJA DAVIDII BUTTERFLY BUSH	5 GAL	5' X 7'	38
	30	CARYOPTERIS X CLANDONENSIS 'DARK KNIGHT' BLUE MIST SPIREA	5 GAL	3' X 3'	7
	28	RHUS AROMATICA 'GRO-LOW' GRO-LOW FRAGRANT SUMAC	5 GAL	2' X 6'	28
	9	ROSA WOODSII MOUNTAIN ROSE	5 GAL	6' X 8'	50
<b>EVERGREEN SHRUBS</b>					
	21	ARTEMISIA FILIFOLIA SAND SAGEBRUSH	5 GAL	4' X 4'	13
	22	CYTISUS SCOPARIUS 'ALL GOLD' SCOTCH BROOM	5 GAL	4' X 6'	28
	30	ERICAMERIA LARICIFOLIA TURPENTINE BUSH	5 GAL	3' X 4'	13
	4	ERICAMERIA NAUSEOSA CHAMISA	5 GAL	5' X 5'	20

SYMBOL	QTY	BOTANICAL / COMMON NAME	SIZE	H X W	H X W
	14	JUNIPERUS SABINA 'BUFFALO' BUFFALO JUNIPER	5 GAL	2' X 5'	20
	10	PINUS MUGO MUGO PINE	5 GAL	4' X 5'	20
	30	RHAPHIOLEPIS INDICA INDIAN HAWTHORN	5 GAL	3' X 4'	13
	18	ROSMARINUS OFFICINALIS 'ARP' ARP ROSEMARY	5 GAL	6' X 4'	13

# ROSA PARKS RD. NW

64' ROW

UNIVERSE BOULEVARD NW  
64' ROW

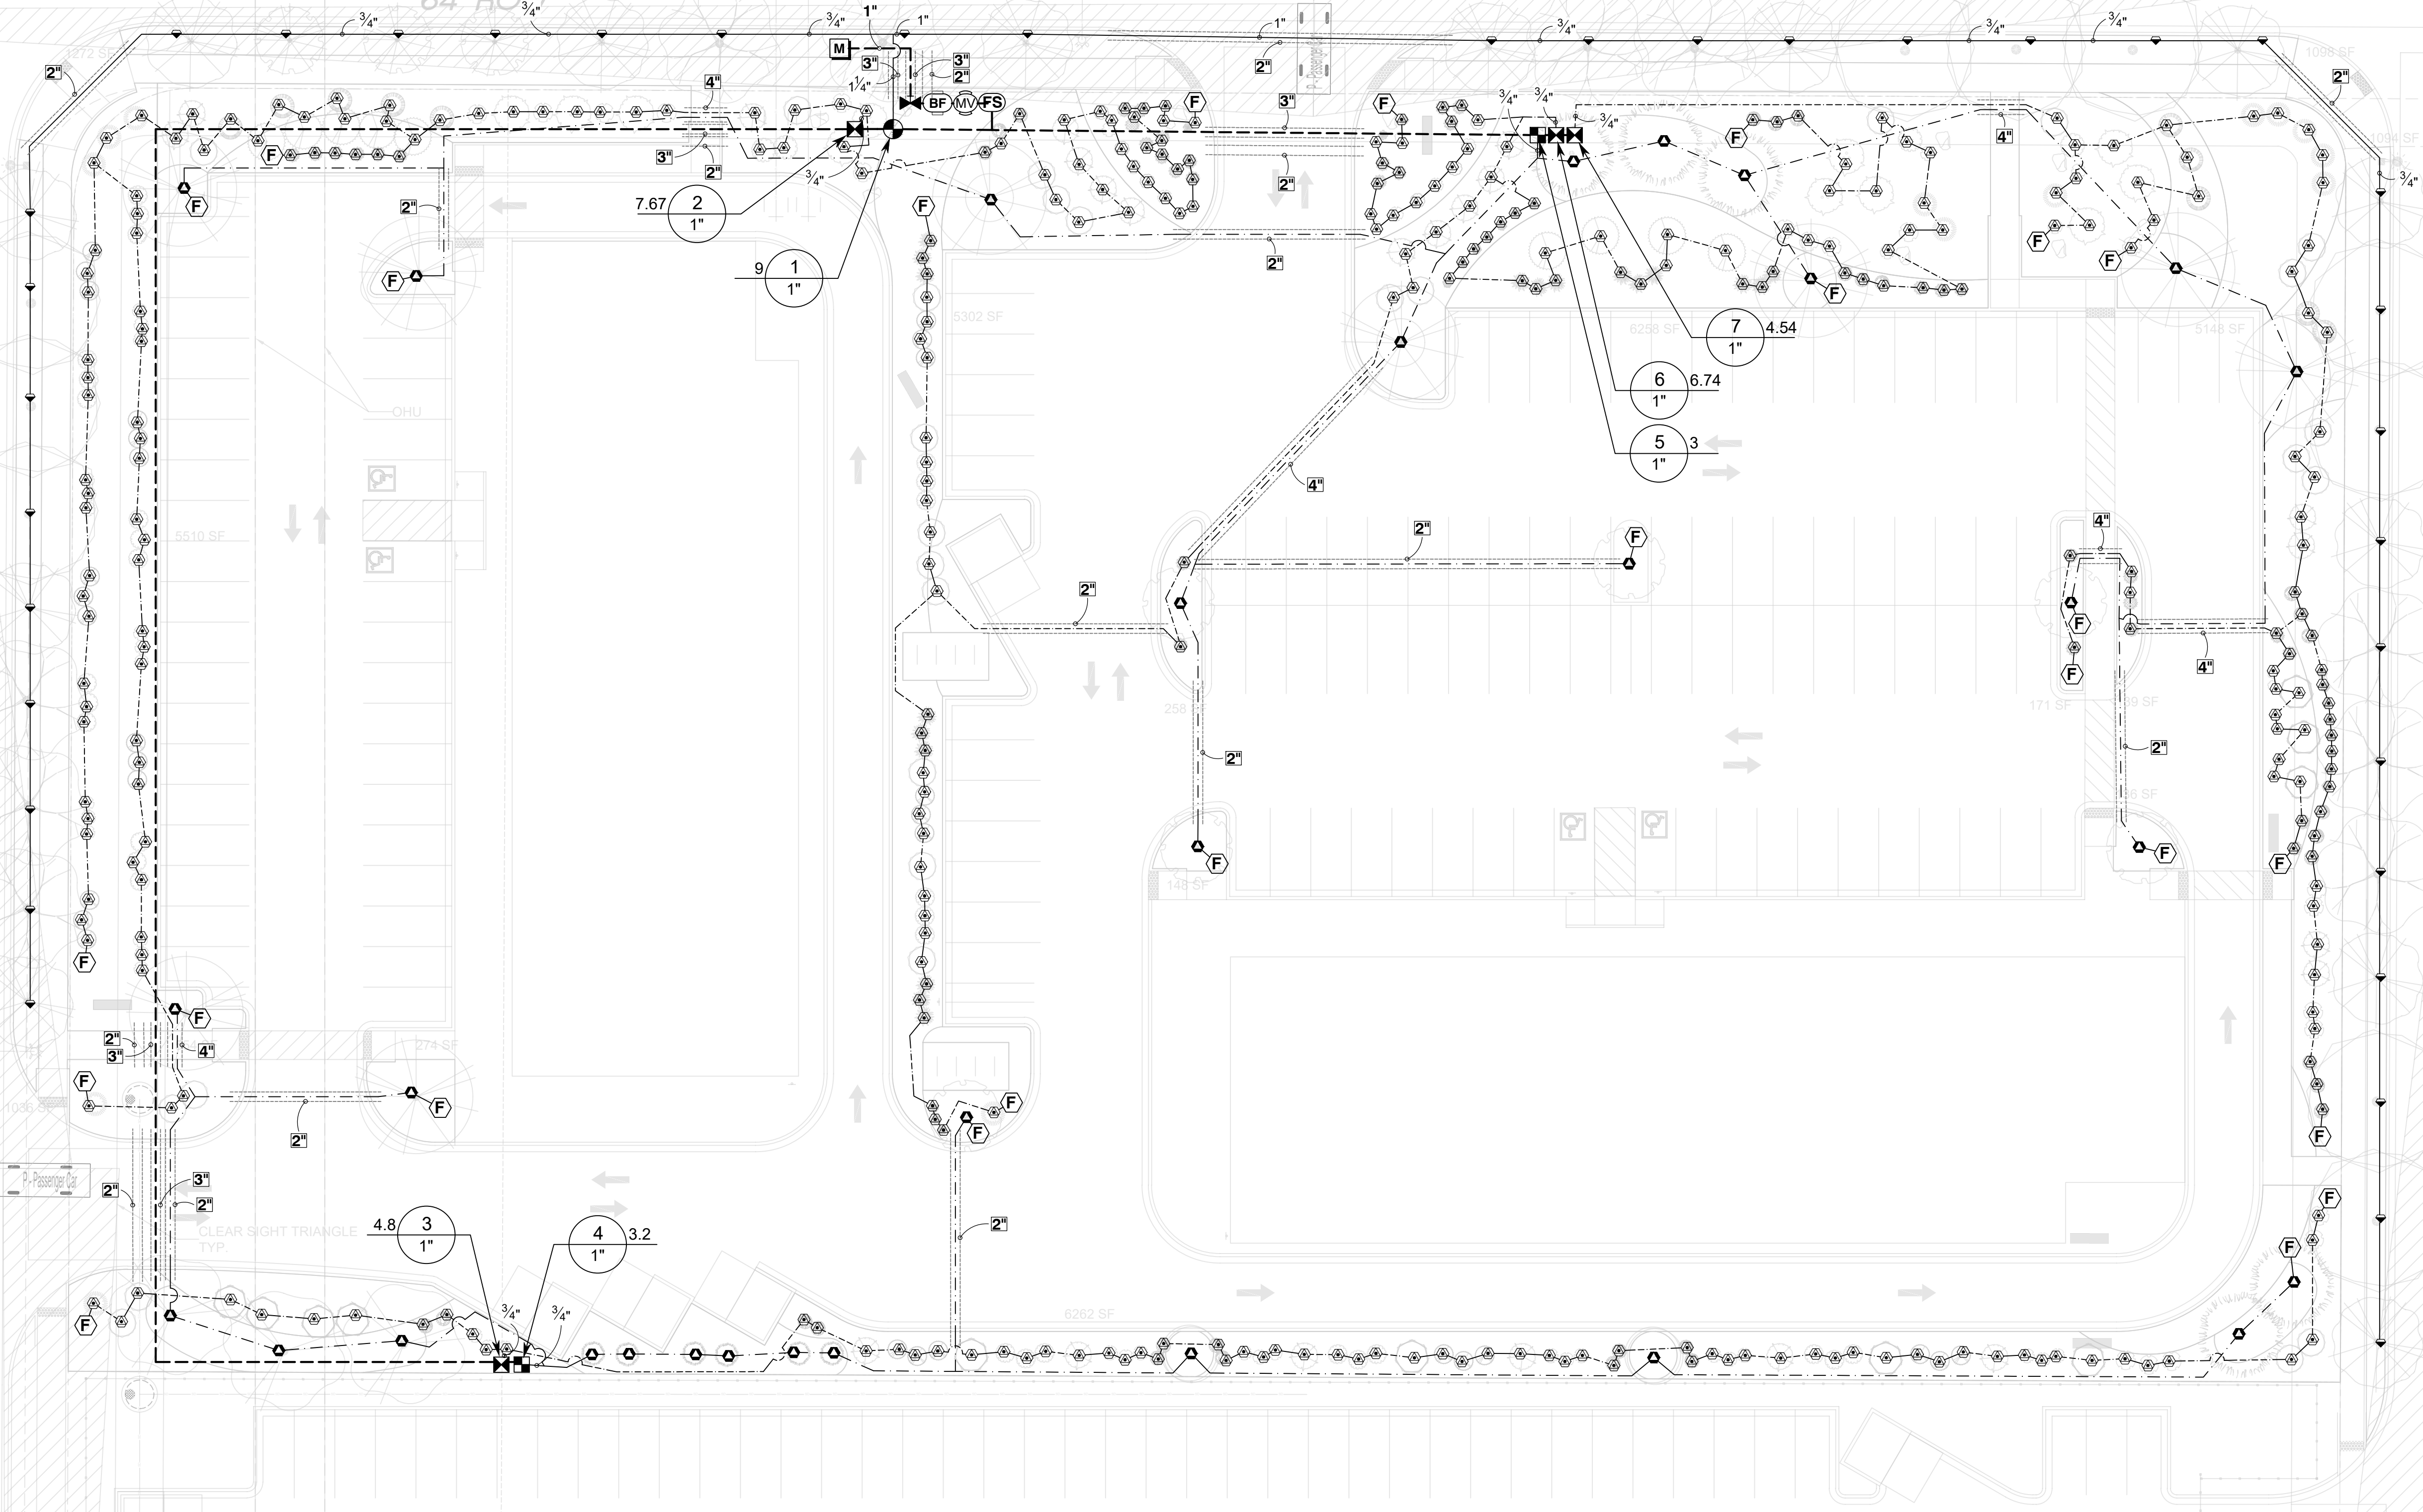

## IRRIGATION NOTES


1. THE LANDSCAPE CONTRACTOR SHALL FURNISH LABOR, MATERIALS AND EQUIPMENT TO INSTALL PROPOSED IRRIGATION SYSTEM AS SHOWN PER PLAN AND DETAILS.
2. IF ANY ERRORS OR DISCREPANCIES APPEAR ON THE PLAN, THEY MUST BE BROUGHT TO THE ATTENTION OF THE LANDSCAPE ARCHITECT BEFORE CONSTRUCTION OF THE IRRIGATION SYSTEM BEGINS.
3. LANDSCAPE INSTALLER SHALL PERFORM PRESSURE/GPM TEST AT POINT OF CONNECTION BEFORE INSTALLING IRRIGATION SYSTEM TO VERIFY PSI AND GPM FOR THE SITE.
4. IRRIGATION SYSTEM HAS BEEN DESIGNED TO A MINIMUM DYNAMIC PRESSURE OF 75 PSI AT 50 GPM. IF THE PSI/GPM ARE LOWER THAN 75/50 THE LANDSCAPE ARCHITECT MUST BE NOTIFIED IMMEDIATELY.
5. THE CONTRACTOR SHALL FIELD VERIFY UTILITY LOCATIONS AND MAKE ANY NECESSARY FIELD ADJUSTMENTS WITH GENERAL CONTRACTOR.
6. THE LOCATION OF IRRIGATION EQUIPMENT IS APPROXIMATE AND SHALL BE LOCATED IN THE LANDSCAPE AREAS. ANY IRRIGATION EQUIPMENT AND PIPING SHOWN OUTSIDE OF LANDSCAPE AREAS ARE FOR GRAPHIC CLARITY ONLY.
7. THE LANDSCAPE CONTRACTOR SHALL PROVIDE TO OWNER AN ACCURATE AS-BUILT IRRIGATION PLAN WHEN THE WORK IS COMPLETED. AS-BUILT DOCUMENTS SHOULD BE UPDATED WEEKLY FOR ACCURATE RECORDING OF IRRIGATION SYSTEM.
8. VALVE LOCATIONS TO BE APPROVED BY LANDSCAPE ARCHITECT. VALVE BOX LIDS TO BE TAN IN GRAVEL AREAS AND GREEN IN SOD/SEED AREAS.
9. ALL PLANTS WITHIN THE PROPERTY LINE SHALL BE IRRIGATED BY LOW FLOW POINT-SOURCE DRIP IRRIGATION SYSTEM.
10. ALL PLANTS WITHIN PUBLIC RIGHT-OF-WAY SHALL BE IRRIGATED BY BUBBLER IRRIGATION SYSTEM PER COA SPEC. ALL PLANTS WITHIN THE PUBLIC RIGHT-OF-WAY SHALL BE ZONED SEPARATELY FROM THE PLANTS WITHIN THE PROPERTY LINE.
11. POWER FOR IRRIGATION SYSTEM TO BE PROVIDED BY THE GENERAL CONTRACTOR. 110V POWER IS REQUIRED AT THE LOCATIONS OF THE IRRIGATION CONTROLLER AND BACKFLOW PREVENTER.
12. BACKFLOW PREVENTER MUST BE TESTED AND CERTIFIED BEFORE FINAL ACCEPTANCE OF THE JOB.
13. CONTROLLER LOCATION IS APPROXIMATE AND THE FINAL LOCATION WILL BE DETERMINED IN THE FIELD.
14. SLEEVES TO BE INSTALLED, AS SHOWN PER PLAN, BEFORE HARDSCAPE IS INSTALLED. THE LANDSCAPE CONTRACTOR MUST BE GIVEN A MINIMUM OF 72 HOUR NOTICE BEFORE SLEEVE LOCATIONS ARE PAVED OVER.
15. WATER METER TO BE PROVIDED BY OTHERS.

**YELLOWSTONE**  
LANDSCAPE  
www.yellowstonelandscape.com  
PO Box 10597  
Albuquerque, NM 87184  
505.898.9615  
design@yellowstonelandscape.com

5/3/24


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**Universe View**  
**Commercial**  
 Albuquerque, New Mexico

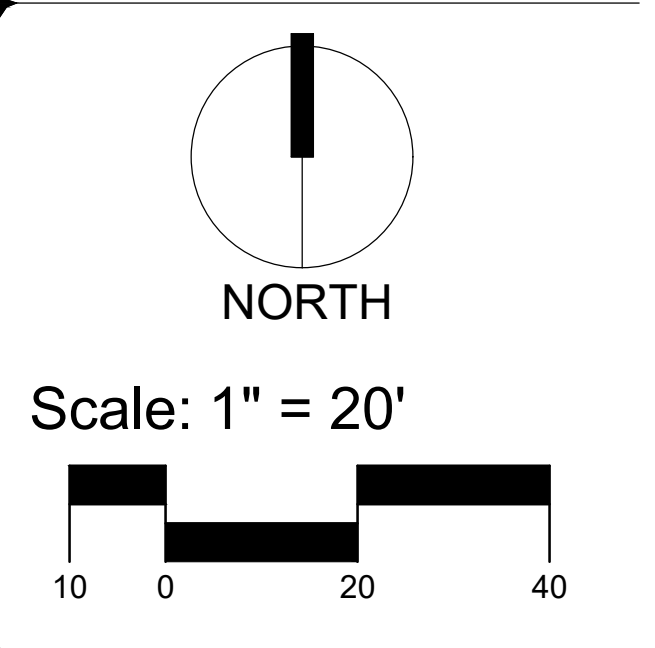


## IRRIGATION SCHEDULE

SYMBOL	MANUFACTURER/MODEL/DESCRIPTION	SYMBOL	MANUFACTURER/MODEL/DESCRIPTION	SYMBOL	MANUFACTURER/MODEL/DESCRIPTION
1401 1402 1404 1406	RAIN BIRD 1800-1400 FLOOD FIXED FLOW RATE 0.25 GPM - 2.0 GPM, FULL CIRCLE BUBBLER, 1/2IN. FIPT.	CV	CONTROL VALVE RAIN BIRD PEB, 1IN., 1-1/2IN., 2IN. PLASTIC INDUSTRIAL VALVES. LOW FLOW OPERATING CAPABILITY, GLOBE CONFIGURATION.	FS	FLOW SENSOR CREATIVE SENSOR TECHNOLOGY FSI-T10-001 1IN. PVC TEE TYPE FLOW SENSOR W/SOCKET ENDS. CUSTOM MOUNTING TEE AND ULTRA-LIGHTWEIGHT IMPELLER ENHANCES LOW FLOW MEASUREMENT. 2 WIRE DIGITAL OUTPUT COMPATIBLE WALL IRRIGATION CONTROLLERS. FLOW RANGE: .88 GPM - 52 GPM.
CV	DRIP CONTROL VALVE - SHRUB RAIN BIRD XCZ-100-PRF, MEDIUM FLOW DRIP CONTROL KIT, 1IN. DV VALVE, 1IN. PRESSURE REGULATING FILTER, 40PSI PRESSURE REGULATOR. 5 GPM-20 GPM.	MV	MAIN SHUT OFF VALVE SPEARS SCH80 PVC COMPACT BALL VALVE	M	WATER METER 1" IRRIGATION WATER METER
CV	DRIP CONTROL VALVE - TREE RAIN BIRD XCZ-100-PRF, MEDIUM FLOW DRIP CONTROL KIT, 1IN. DV VALVE, 1IN. PRESSURE REGULATING FILTER, 40PSI PRESSURE REGULATOR. 3 GPM-15 GPM.	BF	REDUCED PRESSURE BACKFLOW PREVENTER 1" FEBCO 825Y	---	IRRIGATION LATERAL LINE: PVC SCHEDULE 40
F	FLUSH CAP NDS CEP900	C	CONTROLLER - RAIN BIRD ESP-LXD 50-200 STATION, 2-WIRE DECODER BASED CONTROLLER. (1) ESP-LXD 50-STATION, INDOOR/OUTDOOR, PLASTIC WALL-MOUNT ENCLOSURE. SYSTEM REQUIREMENTS: RAIN BIRD FD-XXX-TURF FIELD DECODERS, PAIGE ELECTRIC CABLE P7072D & RAIN BIRD WC20 DRY SPLICES ONLY. GROUND SYSTEM W/ (X) LSP-1 TURF LINE SURGE PROTECTORS IN RAIN BIRD ROUND VALVE BOXES. INSTALL PER MANUFACTURERS RECOMMENDATIONS. TO BE LOCATED ON SITE.	---	IRRIGATION LATERAL LINE: A940RDS DRIP POLYLINE - TREES
E	DRIP EMITTER - SHRUB (2) NDS TAE 20 DRIP EMITTERS			---	IRRIGATION MAINLINE: PVC SCHEDULE 40
E	DRIP EMITTER - TREE (6) NDS TAE 20 DRIP EMITTERS			---	PIPE SLEEVE: PVC CLASS 200 SDR 21

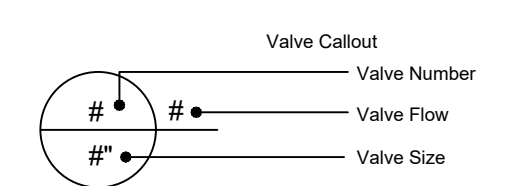


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**Irrigation**  
**Plan**


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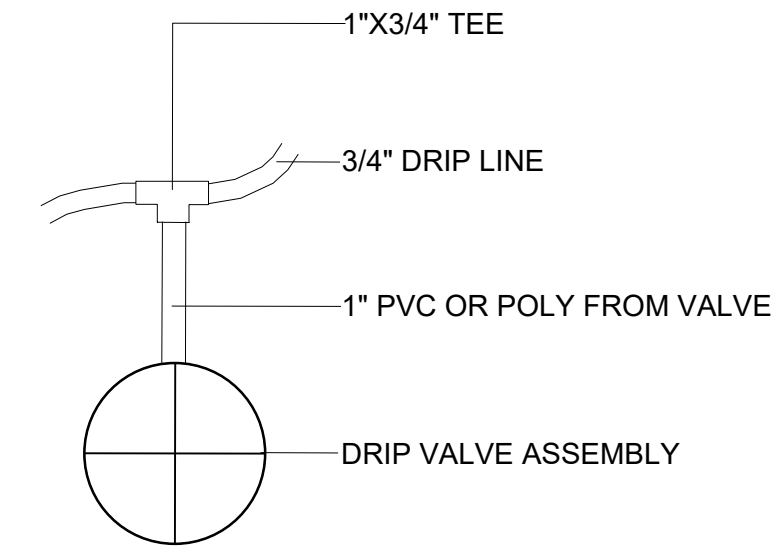
1 RP BACKFLOW/MASTER VALVE DETAIL N.T.S.

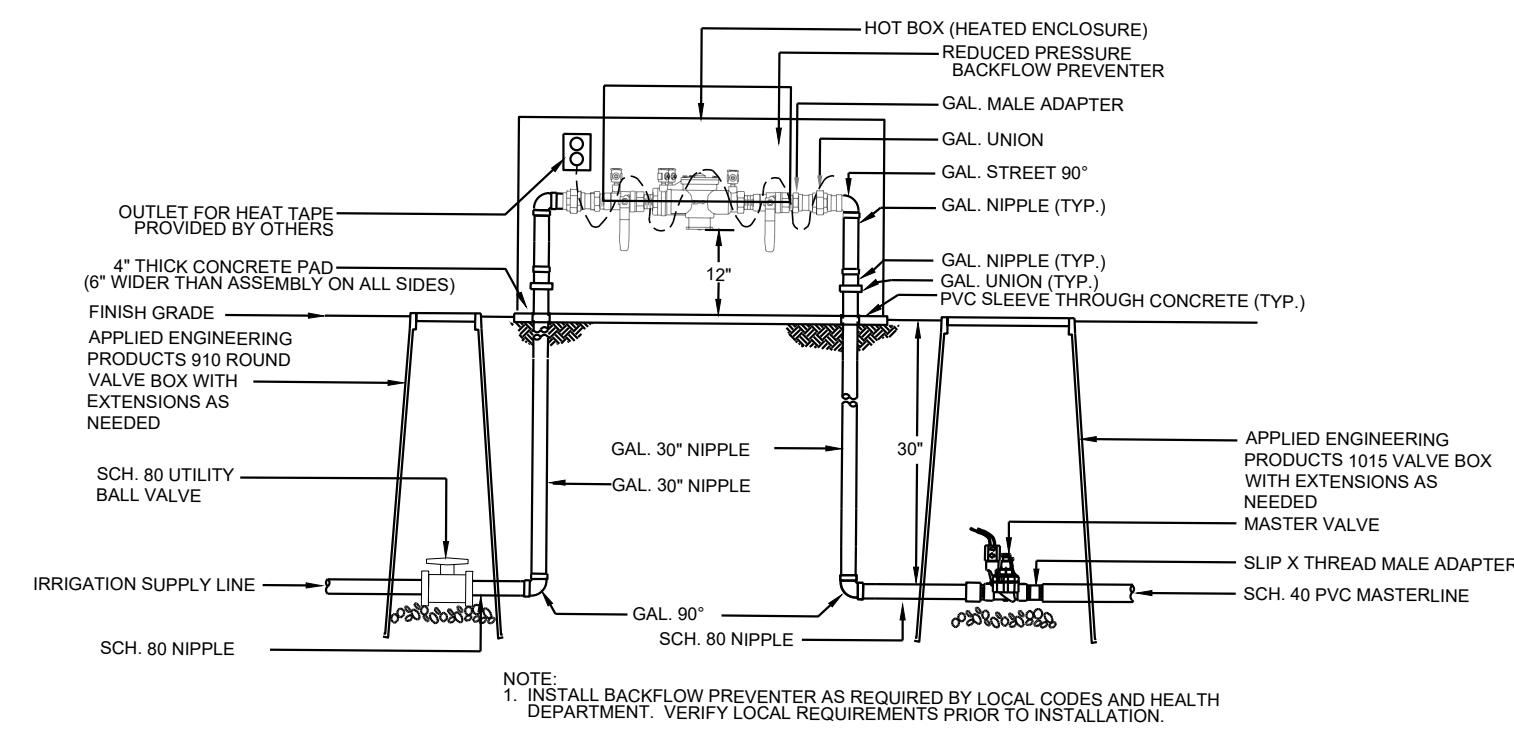


- A. APPLIED ENGINEERING PRODUCTS 910 ROUND VALVE BOX WITH EXTENSIONS AS NEEDED
- B. FINISH GRADE
- C. SCH. 80 UTILITY BALL VALVE
- D. MAINLINE/24" BURY
- E. 8" X 8" X 16" CMU CONCRETE BLOCK
- F. 4" LAYER OF 3/4" GRAVEL

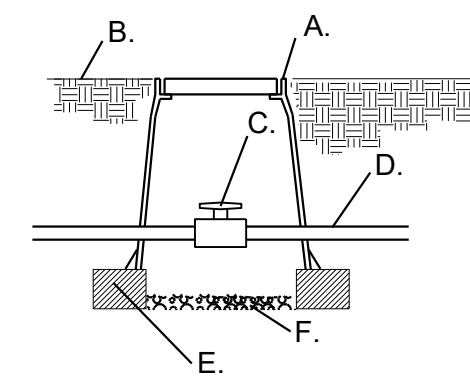

- A. APPLIED ENGINEERING PRODUCTS 910 ROUND VALVE BOX WITH EXTENSIONS AS NEEDED
- B. FINISH GRADE
- C. SCH. 80 UTILITY BALL VALVE
- D. MAINLINE/24" BURY
- E. 8" X 8" X 16" CMU CONCRETE BLOCK
- F. 3/4" GRAVEL SUMP UNDER MANUAL DRAIN TO BE A MINIMUM OF 12" DEEP

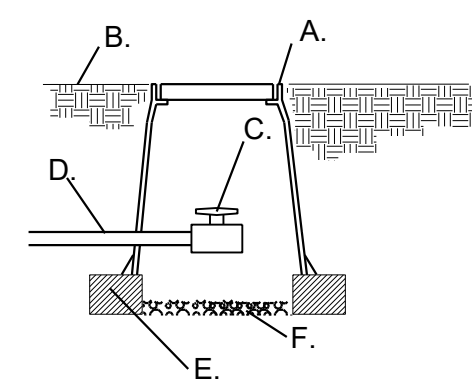


4 DRIP VALVE DETAIL N.T.S.

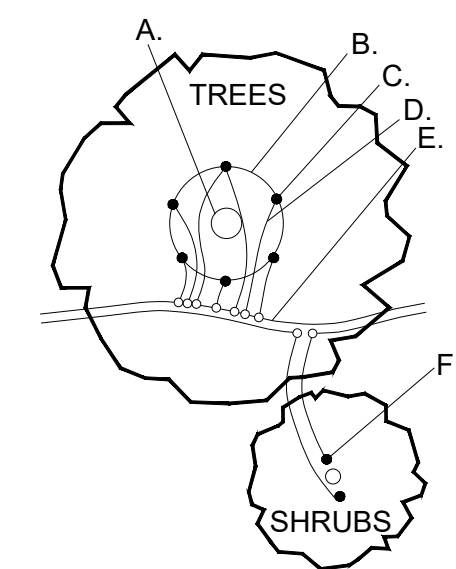


- A. TREE TRUNK/ ROOT CROWN
  - B. 24" CIRCLE FROM TRUNK
  - C. EMITTERS
  - D. 1/4" DISTRIBUTION LINE
  - E. PE DRIFLINE
  - F. EMITTER PLACED WITHIN 6" OF PLANT STEM
- NOTE: INSTALL EMITTERS ABOVE THE ROOT BALL IF PLANT IS INSTALLED ON A SLOPE.

5 EMITTER PLACEMENT DETAIL N.T.S.

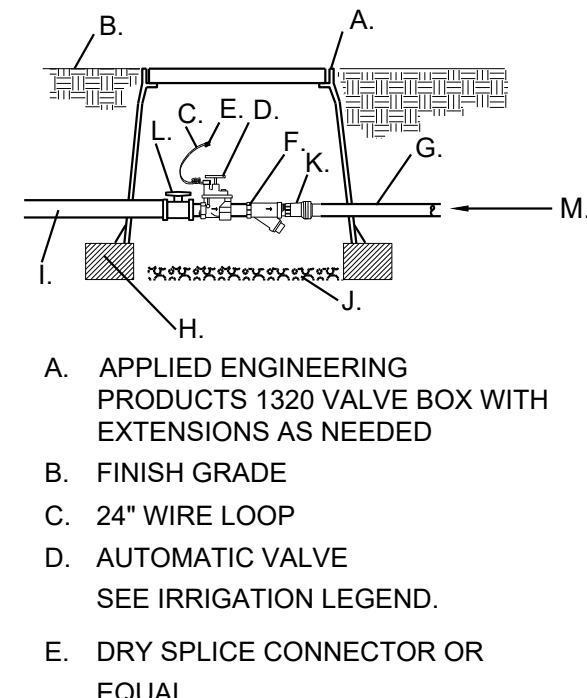


- F. "WYE" STRAINER STRAINER SHALL BE INSTALLED TO PROVIDE ACCESS FOR MAINTENANCE AND REPLACEMENT OF FILTER
- G. LATERAL LINE/24" BURY
- H. 8" X 8" X 16" CMU CONCRETE BLOCK
- I. MASTERLINE/24" BURY
- J. 4" LAYER OF 3/4" GRAVEL
- K. PRESSURE REGULATOR
- L. SCH. 80 TRUE UNION BALL VALVE
- M. SCH. 40 PVC LATERAL LINE

6 DRIP VALVE WITH FILTER & PRESSURE REGULATOR N.T.S.

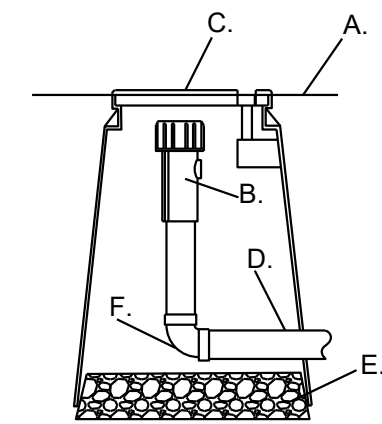


- A. FINISH GRADE
- B. END FLUSH CAP
- C. 6" ROUND BOX WITH LID
- D. 3/4" POLY DRIP PIPE
- E. 2" DEPTH OF GRAVEL
- F. 90° FITTING

7 END FLUSH CAP N.T.S.

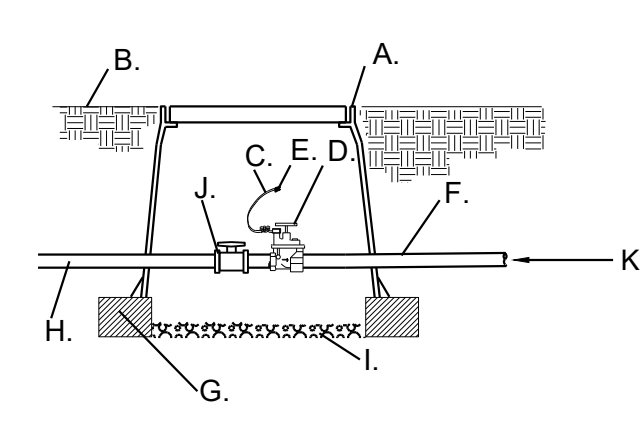


- A. APPLIED ENGINEERING PRODUCTS 1320 VALVE BOX WITH EXTENSIONS AS NEEDED
- B. FINISH GRADE
- C. 24" WIRE LOOP
- D. AUTOMATIC VALVE- SEE IRRIGATION LEGEND.
- E. DRY SPLICE CONNECTOR OR EQUAL
- F. LATERAL LINE/24" BURY
- G. 8" X 8" X 16" CMU CONCRETE BLOCK
- H. MASTERLINE/24" BURY
- I. 4" LAYER OF 3/4" GRAVEL
- J. SCH. 80 TRUE UNION BALL VALVE
- K. SCH. 40 PVC LATERAL LINE

8 AUTOMATIC VALVE N.T.S.

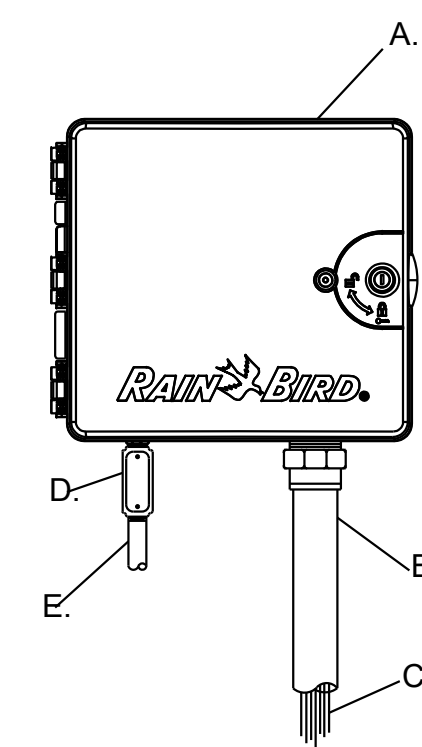


- A. CONTROLLER (see plan for model)
- B. 2" PVC SCH. 40 CONDUIT AND FITTINGS
- C. WIRES TO REMOTE CONTROL VALVES
- D. JUNCTION BOX
- E. 1" PVC SCH. 40 CONDUIT AND FITTINGS TO POWER SUPPLY

9 WALL MOUNTED AUTOMATIC CONTROLLER N.T.S.

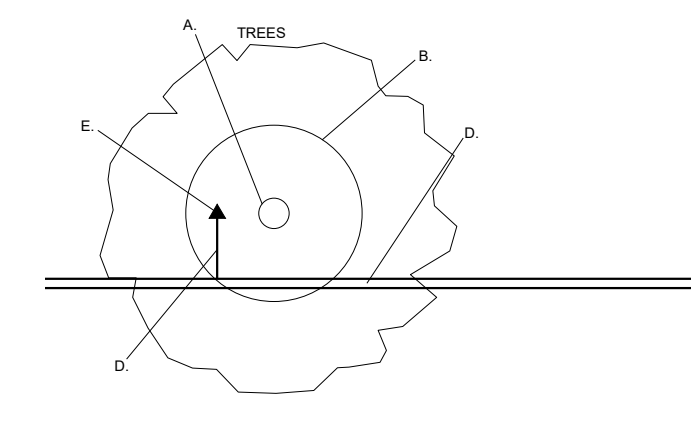

- A. TREE TRUNK/ ROOT CROWN
  - B. 36" DIA BERM AROUND TREE
  - C. 24" DIA BERM AROUND SHRUB
  - D. PVC LATERAL PIPE (SIZE VARIES)
  - E. BUBBLER PLACED 6" INSIDE BERM
- NOTE: INSTALL BUBBLER(S) ABOVE THE ROOT BALL IF PLANT IS INSTALLED ON A SLOPE.

10 BUBBLER PLACEMENT DETAIL N.T.S.

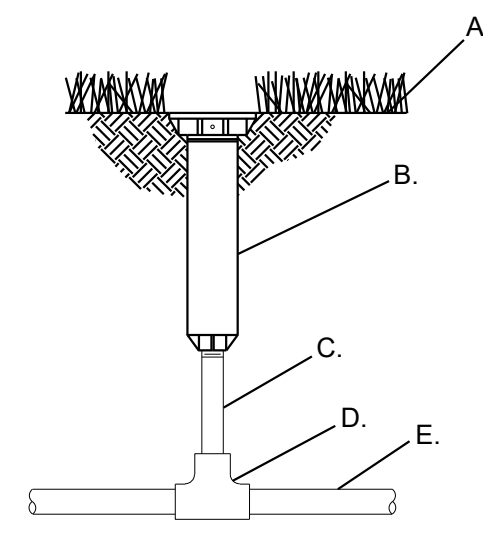


- A. FINISH GRADE
- B. POP-UP SPRAY SPRINKLER: RAIN BIRD 1804-SAM-PRS BODY WITH RAINBIRD R-VAN NOZZLE
- C. PVC SCH.40 NIPPLE
- D. PVC SCH.40 TEE
- E. PVC LATERAL LINE

11 ROTATOR SPRINKLER N.T.S.

IRRIGATION NOTES

1. THE LANDSCAPE CONTRACTOR SHALL FURNISH LABOR, MATERIALS AND EQUIPMENT TO INSTALL PROPOSED IRRIGATION SYSTEM AS SHOWN PER PLAN AND DETAILS.
2. IF ANY ERRORS OR DISCREPANCIES APPEAR ON THE PLAN, THEY MUST BE BROUGHT TO THE ATTENTION OF THE LANDSCAPE ARCHITECT BEFORE CONSTRUCTION OF THE IRRIGATION SYSTEM BEGINS.
3. LANDSCAPE INSTALLER SHALL PERFORM PRESSURE/GPM TEST AT POINT OF CONNECTION BEFORE INSTALLING IRRIGATION SYSTEM TO VERIFY PSI AND GPM FOR THE SITE.
4. IRRIGATION SYSTEM HAS BEEN DESIGNED TO A MINIMUM DYNAMIC PRESSURE OF 75 PSI AT 50 GPM. IF THE PSI/GPM ARE LOWER THAN 75/50 THE LANDSCAPE ARCHITECT MUST BE NOTIFIED IMMEDIATELY.
5. THE CONTRACTOR SHALL FIELD VERIFY UTILITY LOCATIONS AND MAKE ANY NECESSARY FIELD ADJUSTMENTS WITH GENERAL CONTRACTOR.
6. THE LOCATION OF IRRIGATION EQUIPMENT IS APPROXIMATE AND SHALL BE LOCATED IN THE LANDSCAPE AREAS. ANY IRRIGATION EQUIPMENT AND PIPING SHOWN OUTSIDE OF LANDSCAPE AREAS ARE FOR GRAPHIC CLARITY ONLY.
7. THE LANDSCAPE CONTRACTOR SHALL PROVIDE TO OWNER AN ACCURATE AS-BUILT IRRIGATION PLAN WHEN THE WORK IS COMPLETED. AS-BUILT DOCUMENTS SHOULD BE UPDATED WEEKLY FOR ACCURATE RECORDING OF IRRIGATION SYSTEM.
8. VALVE LOCATIONS TO BE APPROVED BY LANDSCAPE ARCHITECT. VALVE BOX LIDS TO BE TAN IN GRAVEL AREAS AND GREEN IN SO/SEED AREAS.
9. ALL PLANTS WITHIN THE PROPERTY LINE SHALL BE IRRIGATED BY LOW FLOW POINT-SOURCE DRIP IRRIGATION SYSTEM.
10. ALL PLANTS WITHIN PUBLIC RIGHT-OF-WAY SHALL BE IRRIGATED BY BUBBLER IRRIGATION SYSTEM PER COA SPEC. ALL PLANTS WITHIN THE PUBLIC RIGHT-OF-WAY SHALL BE ZONED SEPARATELY FROM THE PLANTS WITHIN THE PROPERTY LINE.
11. POWER FOR IRRIGATION SYSTEM TO BE PROVIDED BY THE GENERAL CONTRACTOR. 110V POWER IS REQUIRED AT THE LOCATIONS OF THE IRRIGATION CONTROLLER AND BACKFLOW PREVENTER.
12. BACKFLOW PREVENTER MUST BE TESTED AND CERTIFIED BEFORE FINAL ACCEPTANCE OF THE JOB.
13. CONTROLLER LOCATION IS APPROXIMATE AND THE FINAL LOCATION WILL BE DETERMINED IN THE FIELD.
14. SLEEVES TO BE INSTALLED, AS SHOWN PER PLAN, BEFORE HARDSCAPE IS INSTALLED. THE LANDSCAPE CONTRACTOR MUST BE GIVEN A MINIMUM OF 72 HOUR NOTICE BEFORE SLEEVE LOCATIONS ARE PAVED OVER.
15. WATER METER TO BE PROVIDED BY OTHERS.

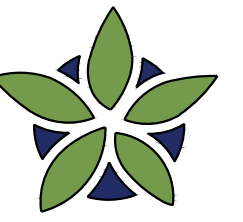

**YELLOWSTONE**  
LANDSCAPE

www.yellowstonelandscape.com  
PO Box 10597  
Albuquerque, NM 87184  
505.898.9615  
design@yellowstonelandscape.com



5/3/24

Date: 04/08/2024

Revisions:

△ 04/29/2024

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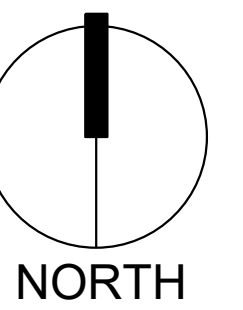
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Drawn by: PL

Reviewed by: CM


Universe View  
Commercial

Albuquerque, New Mexico



NORTH

Scale: 1" = 20'

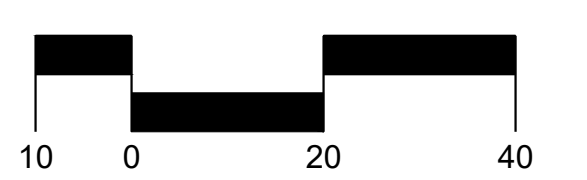

Sheet Title:  
**Irrigation  
Plan**

Sheet Number:

**LI-02**