


NET LOT AREA (SF) 193,585 MINIMUM LANDSCAPE REQUIRED PROVIDED AREA (SF) - MINIMUM 15 % OF NET LOT AREA* 29,038 35,454 18% TOTAL VEGETATIVE COVERAGE (SF) @ PLANT MATURITY (75% OF LANDSCAPE AREA) 21,778 30,840 106% VEGETATIVE COVERAGE (SF) OF GROUND-LEVEL PLANTS (25% OF TOTAL, MINIMUM) 5,445 5,625 26% * PER IDO 14-16-5-6(C)(2)(b). IN DT-UC-MS-PT AREAS. MINIMUM IS 10% OF NET LOT AREA * FOR MULTI-FAMILY DWELLING, MINIMUM IS 25% OF NET LOT AREA. SEE 14-16-4-3(B)(8) FOR DETAILS PLANTING AREA MULCH REQUIRED PROVIDED GRAVEL OR CRUSHER FINES (SF) 26,548 MAX. 75% 75% * PER IDO 14-15-5-6(C)(5) The use of gravel or crusher fines as ground cover is limited to a maximum 50 percent in DT-UC-MS areas. **PROVIDED** STREET TREES - 1 PER 25 LF REQUIRED STREET FRONTAGE (LF) 885 * PER IDO 14-15-5-6(D)(1)(a) TREES THAT ARE PLANTED WITHIN 20 FEET OF THE BACK OF CURB OF THE ABUTTING STREET MAY FULFILL THIS REQUIREMENT PARKING LOT INTERIOR REQUIRED **PROVIDED** PARKING STALLS PARKING LOT AREA (SF) 38,049 LANDSCAPED AREA (10% OF PARKING LOT AREA)* 28,753 TREES (1 PER 10 PARKING SPACES) PER IDO 14-16-5-6(F)(2), FOR PARKING LOTS CONTAINING 50 OR FEWER SPACES, MINIMUM IS 10% OF PARKING LOT AREA. **TOTALS** REQUIRED PROVIDED ** PER IDO 14-16-5-6(C)(3)(a), IF AREAS REQUIRED TO BE LANDSCAPED BY 2 OR MORE PROVISIONS OF THIS SECTION 14-16-5-6 OVERLAP EACH OTHER, THE PROVISION REQUIRING THE GREATER AMOUNT OF LANDSCAPING SHALL APPLY, AND LANDSCAPING PROVIDED THAT MEETS THE GREATER REQUIREMENT SHALL COUNT TOWARD FULFILLING THE OVERLAPPING REQUIREMENTS.

YMBOL	DESCRIPTION	<u>C</u>
	LARGE BOULDER	g
YMBOL	DESCRIPTION	
	MOUNTAINAIR SUNRISE GOLD 1" GRAVEL 3" DEPTH OVER FILTER FABRIC	
	MOUNTAINAIR BLUSH 1" GRAVEL 3" DEPTH OVER FILTER FABRIC	
	NATIVE MULCH SHREDDED WOOD MULCH 3" DEPTH NOT OVER FILTER FABRIC	
	BLUE SAIS 2-4" ANGULAR COBBLE 4" DEPTH OVER FILTER FABRIC	

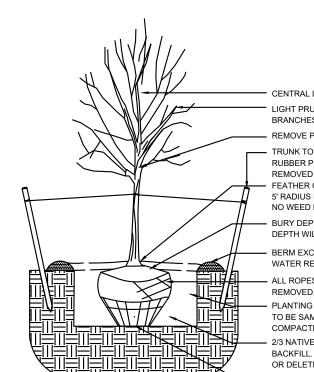

TREE PLANTING DETAIL

 CENTRAL LEADER (IF EXISTING) TO BE LEFT UNPRUNED LIGHT PRUNING IF NEEDED. RUBBING, CROSSED OR DAMAGED REMOVE PLANT IDENTIFICATION TAGS BEFORE JOB IS COMPLETE - TRUNK TO BE STAKED WITH (2) WOODEN TREE STAKES WITH RUBBER PROTECTION AT TRUNK. STAKES AND TIES TO BE REMOVED AFTER ONE YEAR FEATHER ORGANIC MULCH TO A 2" DEPTH OVER PLANT ROOTBALL, 5' RADIUS FROM TRUNK, KEEP MULCH 2" AWAY FROM TRUNK. NO WEED BARRIER OVER ROOTBALL - BURY DEPTH OF TREE IS AT ROOT FLARE AND HOLE DEPTH WILL BE ADJUSTED ACCORDING TO ROOTBALL HEIGHT BERM EXCAVATED SOIL AROUND EDGE OF PLANTING PIT TO AID IN WATER RETENTION OVER ROOTBALL ALL ROPES REMOVED, TOP HALF OF BURLAP AND WIRE BASKET REMOVED, BURLAP SLIT FOR ROOT EXTENSION - PLANTING PIT TO BE 2-3 TIMES WIDTH OF ROOT BALL, DEPTH OF PIT TO BE SAME AS ROOT BALL HEIGHT. SIDES OF PIT NOT TO BE OVERLY COMPACTED TO ALLOW ROOT GROWTH BEYOND PLANTING PIT 2/3 NATIVE SOIL AND 1/3 COMPOSTED SOIL AMENDMENT TO BE USED AS BACKFILL, AMENDMENT TO BE WELL COMPOSTED AND FREE OF DEBRIS

OR DELETERIOUS MATERIALS. UNDISTURBED PIT BOTTOM FOR ROOTBALL BASE

5' RADIUS

AROUND TRUNK

GENERAL NOTES

- 1. IN CASE OF DISCREPANCIES IN PLANT QUANTITIES SHOWN ON THE PLANT SCHEDULE AND THOSE SHOWN ON THE PLAN. THE QUANTITIES SHOWN ON THE PLAN SHALL PREVAIL. CONTRACTOR SHALL VERIFY ALL QUANTITIES PRIOR TO BID AND
- INSTALLATION. 2. POSITIVE DRAINAGE AWAY FROM ALL STRUCTUF SHALL BE PROVIDED TO THE LANDSCAPE CONTRACTOR AND SHALL BE MAINTAINED BY THE LANDSCAPE CONTRACTOR THROUGHOUT THE
- DURATION OF THE PROJECT. GRADING OF THE SITE PER THE GRADING PLAN IS NOT INCLUDED IN THE SCOPE OF WORK OF THE LANDSCAPE CONTRACTOR. GRADES PER THE GRADING PLAN SHALL BE PROVIDED TO THE LANDSCAPE CONTRACTOR +/- 1/10TH OF A FOOT, B
- 4. ALL MAINTENANCE OF THE LANDSCAPE AND IRRIGATION SYSTEMS SHALL BE PROVIDED BY OWNER. NO CONTRACTUAL MAINTENANCE SHALL BE INCLUDED UNLESS OTHERWISE SPECIFIED IN THE BIDDING DOCUMENTS. 5. WATER MANAGEMENT IS THE SOLE RESPONSIBILIT
- OF THE PROPERTY OWNER. THE LANDSCAPE ARCHITECT IS NOT RESPONSIBLE FOR ANY RESTRICTIONS OF IRRIGATION WATER USE BY ANY GOVERNING BODY.
- 6. PER 5-6(C)(4)(a) A MINIMUM OF 5 SPECIES MUST BE USED IN THE LANDSCAPED AREA.
- 7. PER 5-6(C)(4)(b) ONLY TREES AND SHRUBS SELECTED FROM THE OFFICIAL ALBUQUERQUE PLANT PALETTE OF LOW WATER USE, DROUGHT TOLERANT, OR XERIC SPECIES AND SHOWN ON A LANDSCAPE PLAN CAN COUNT TOWARD THE REQUIREMENTS OF THIS SUBSECTION 14-16-5-6(C) (GENERAL LANDSCAPING STANDARDS), EXCEPT THAT, UPON PRESENTATION OF EVIDENCE, THE RELEVANT DECISION-MAKING BODY MAY AUTHORIZE ALTERNATIVE SPECIES OR CULTIVARS THAT MEET ALL OF THE FOLLOWING REQUIREMENTS:

1.MEET THE INTENDED PURPOSE OF THAT TYPE OF LANDSCAPING. 2.ARE NOT HAZARDOUS

4.ARE NOT LISTED IN THE CITY'S WEED IDENTIFICATION HANDBOOK. 5.ARE EQUALLY HARDY TO THE NEW MEXICO

PEDESTRIAN WALKWAYS ARE REQUIRED PURSUANT TO SUBSECTION 14-16-5-6(C)(4)(i) (REQUIRED PLANT MATERIALS AND SITE AMENITIES). 5-6(C)(4)(i) SHADE TREES PLANTED APPROXIMATELY 25 FEET ON-CENTER ARE REQUIRED ALONG ALL REQUIRED PEDESTRIAN WALKWAYS. IF THE WALKWAY IS LESS THAN FEET LONG, AT LEAST ONE TREE IS REQUIRED, OR, WHERE THERE IS INSUFFICIENT

SHALL BE PROVIDED. LOCATED WITHIN 30 FEET OF THE FRONT LOT LINE SHALL BE SCREENED FROM THE STREET EITHER BY A MASONRY WALL CONSTRUCTED OF A MATERIA SIMILAR IN TEXTURE, APPEARANCE, AND COLOR T THE STREET-FACING FAÇADE OF THE PRIMARY BUILDING (BUT EXCLUDING EXPOSED CMU BLOCK) AT LEAST 3 BUT NOT MORE THAN 4 FEET IN HEIGHT OR BY A LANDSCAPE BUFFER AT LEAST 10 FEET IN WIDTH WITH A CONTINUOUS LINE OF EVERGREEN SHRUBBERY 3 FEET IN HEIGHT, OR BY OTHER MEANS THAT THE PLANNING DIRECTOR DETERMINES PROVIDES EQUAL OR BETTER

MATERIAL OR INSTALLATION OF ANY LANDSCAPING BUFFERING, OR SCREENING MATERIAL IN THE PUBLIC RIGHT-OF-WAY SHALL REQUIRE THE PRIOR APPROVAL OF THE CITY. THE PROPERTY OWNER SHALL BE RESPONSIBLE FOR THE MAINTENANCE, REPAIRS, OR LIABILITY FOR ALL THE LANDSCAPING PLACED IN OR OVER THE PUBLIC RIGHT-OF-WAY. 11. PER 5-6(C)(9)(b), ANY TREES THAT OVERHANG A PUBLIC SIDEWALK OR MAJOR PUBLIC OPEN SPACE SHALL BE TRIMMED TO MAINTAIN AN 8 FOOT CLEARANCE OVER THE SIDEWALK. ANY TREES THA OVERHANG A PUBLIC STREET SHALL BE TRIMMED TO MAINTAIN A 9' CLEARANCE OVER THE STREET

CLEARLY DELINEATED ON PLANS FOR LANDSCAPE

13. PURSUANT TO 5-6(C)(7)(a), ALL VEGETATION HAS BEEN LOCATED A MINIMUM OF 3' IN ANY DIRECTION FROM FIRE HYDRANTS, VALVE VAULTS, HOSE BIBS, MANHOLES, HYDRANTS AND FIRE DEPARTMENT CONNECTIONS.

14. PURSUANT TO 5-6(C)(10)(a), TREES AND SHRUBS SHALL NOT BE PLANTED IN UTILITY EASEMENTS UNLESS THERE IS NO OTHER PRACTICABLE LOCATION ON THE LOT WHERE THE LANDSCAPING WOULD ACHIEVE ITS INTENDED PURPOSE.

15. PURSUANT TO 5-6(C)(10)(b), TREES SHALL NOT B PLANTED WITHIN 10' IN ANY DIRECTION OF THE CENTERLINE OF A SEWER OR WATER LINE.

2-3" ORGANIC MULCH

— GRAVEL OR OTHER

GROUND COVER

SHRUBBERIES BETWEEN 3' AND 8' TALL (AS MEASURED FROM THE GUTTER PAN) ARE NOT


LEGISLATION AND ORDINANCES (CROSS CONNECTION PREVENTION AND CONTROL ORDINANCE)

18. PER 5-6(C)(14)(b), ALL IRRIGATION SYSTEMS SHALL BE DESIGNED TO MINIMIZE THE USE OF WATER.

19. PER 5-6(C)(14)(c), ALL NON-RESIDENTIAL LANDSCAPE IRRIGATION SHALL HAVE AUTOMATIC TIMERS AND/OR PROGRAMMABLE SETTINGS TO AVOID OVERWATERING.



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Drawn by: PL Reviewed by: <u>CM</u>

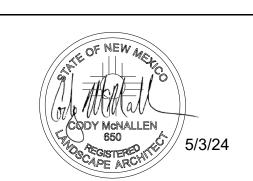3.ARE NOT IDENTIFIED AS INVASIVE ON A CITY OR STATE PLANT LIST. CLIMATE.

8. PER 5-3(D)(3)(a) 3, SHADE TREES ALONG REQUIRED SPACE FOR A TREE, A TRELLIS OF AT LEAST 8 FEET HIGH FOR AT LEAST 5 FEET ALONG THE WALKWAY

9. PER 5-6(F)(1)(i) 1 OF THE IDO, ANY PARKING LOT SCREENING OF THE HEADLIGHTS OF PARKED

10. PER 5-6(C)(9)(a), ALL PLANTING OF VEGETATED


SURFACE. 12. PURSUANT TO 5-6(C)(5)(e), BARK MULCH AREAS AREAS AND 5' RADIUS RINGS AROUND TREES.


16. CLEAR SIGHT TRIANGLE NOTE: LANDSCAPING, SIGNAGE, WALLS, FENCES, TREES, AND

ALLOWED WITHIN THE CLEAR SIGHT TRIANGLE 17. PER 5-6(C)(14)(a), IRRIGATION SYSTEMS SHALL COMPLY WITH SECTION 8 OF THE ABCWUA

20. PER 5-6(C)(14)(d), THE IRRIGATION SYSTEM SHALL NOT SPRAY OR IRRIGATE IMPERVIOUS SURFACES, INCLUDING SIDEWALKS, DRIVEWAYS, DRIVE AISLES STREETS, AND PARKING AND LOADING AREAS.

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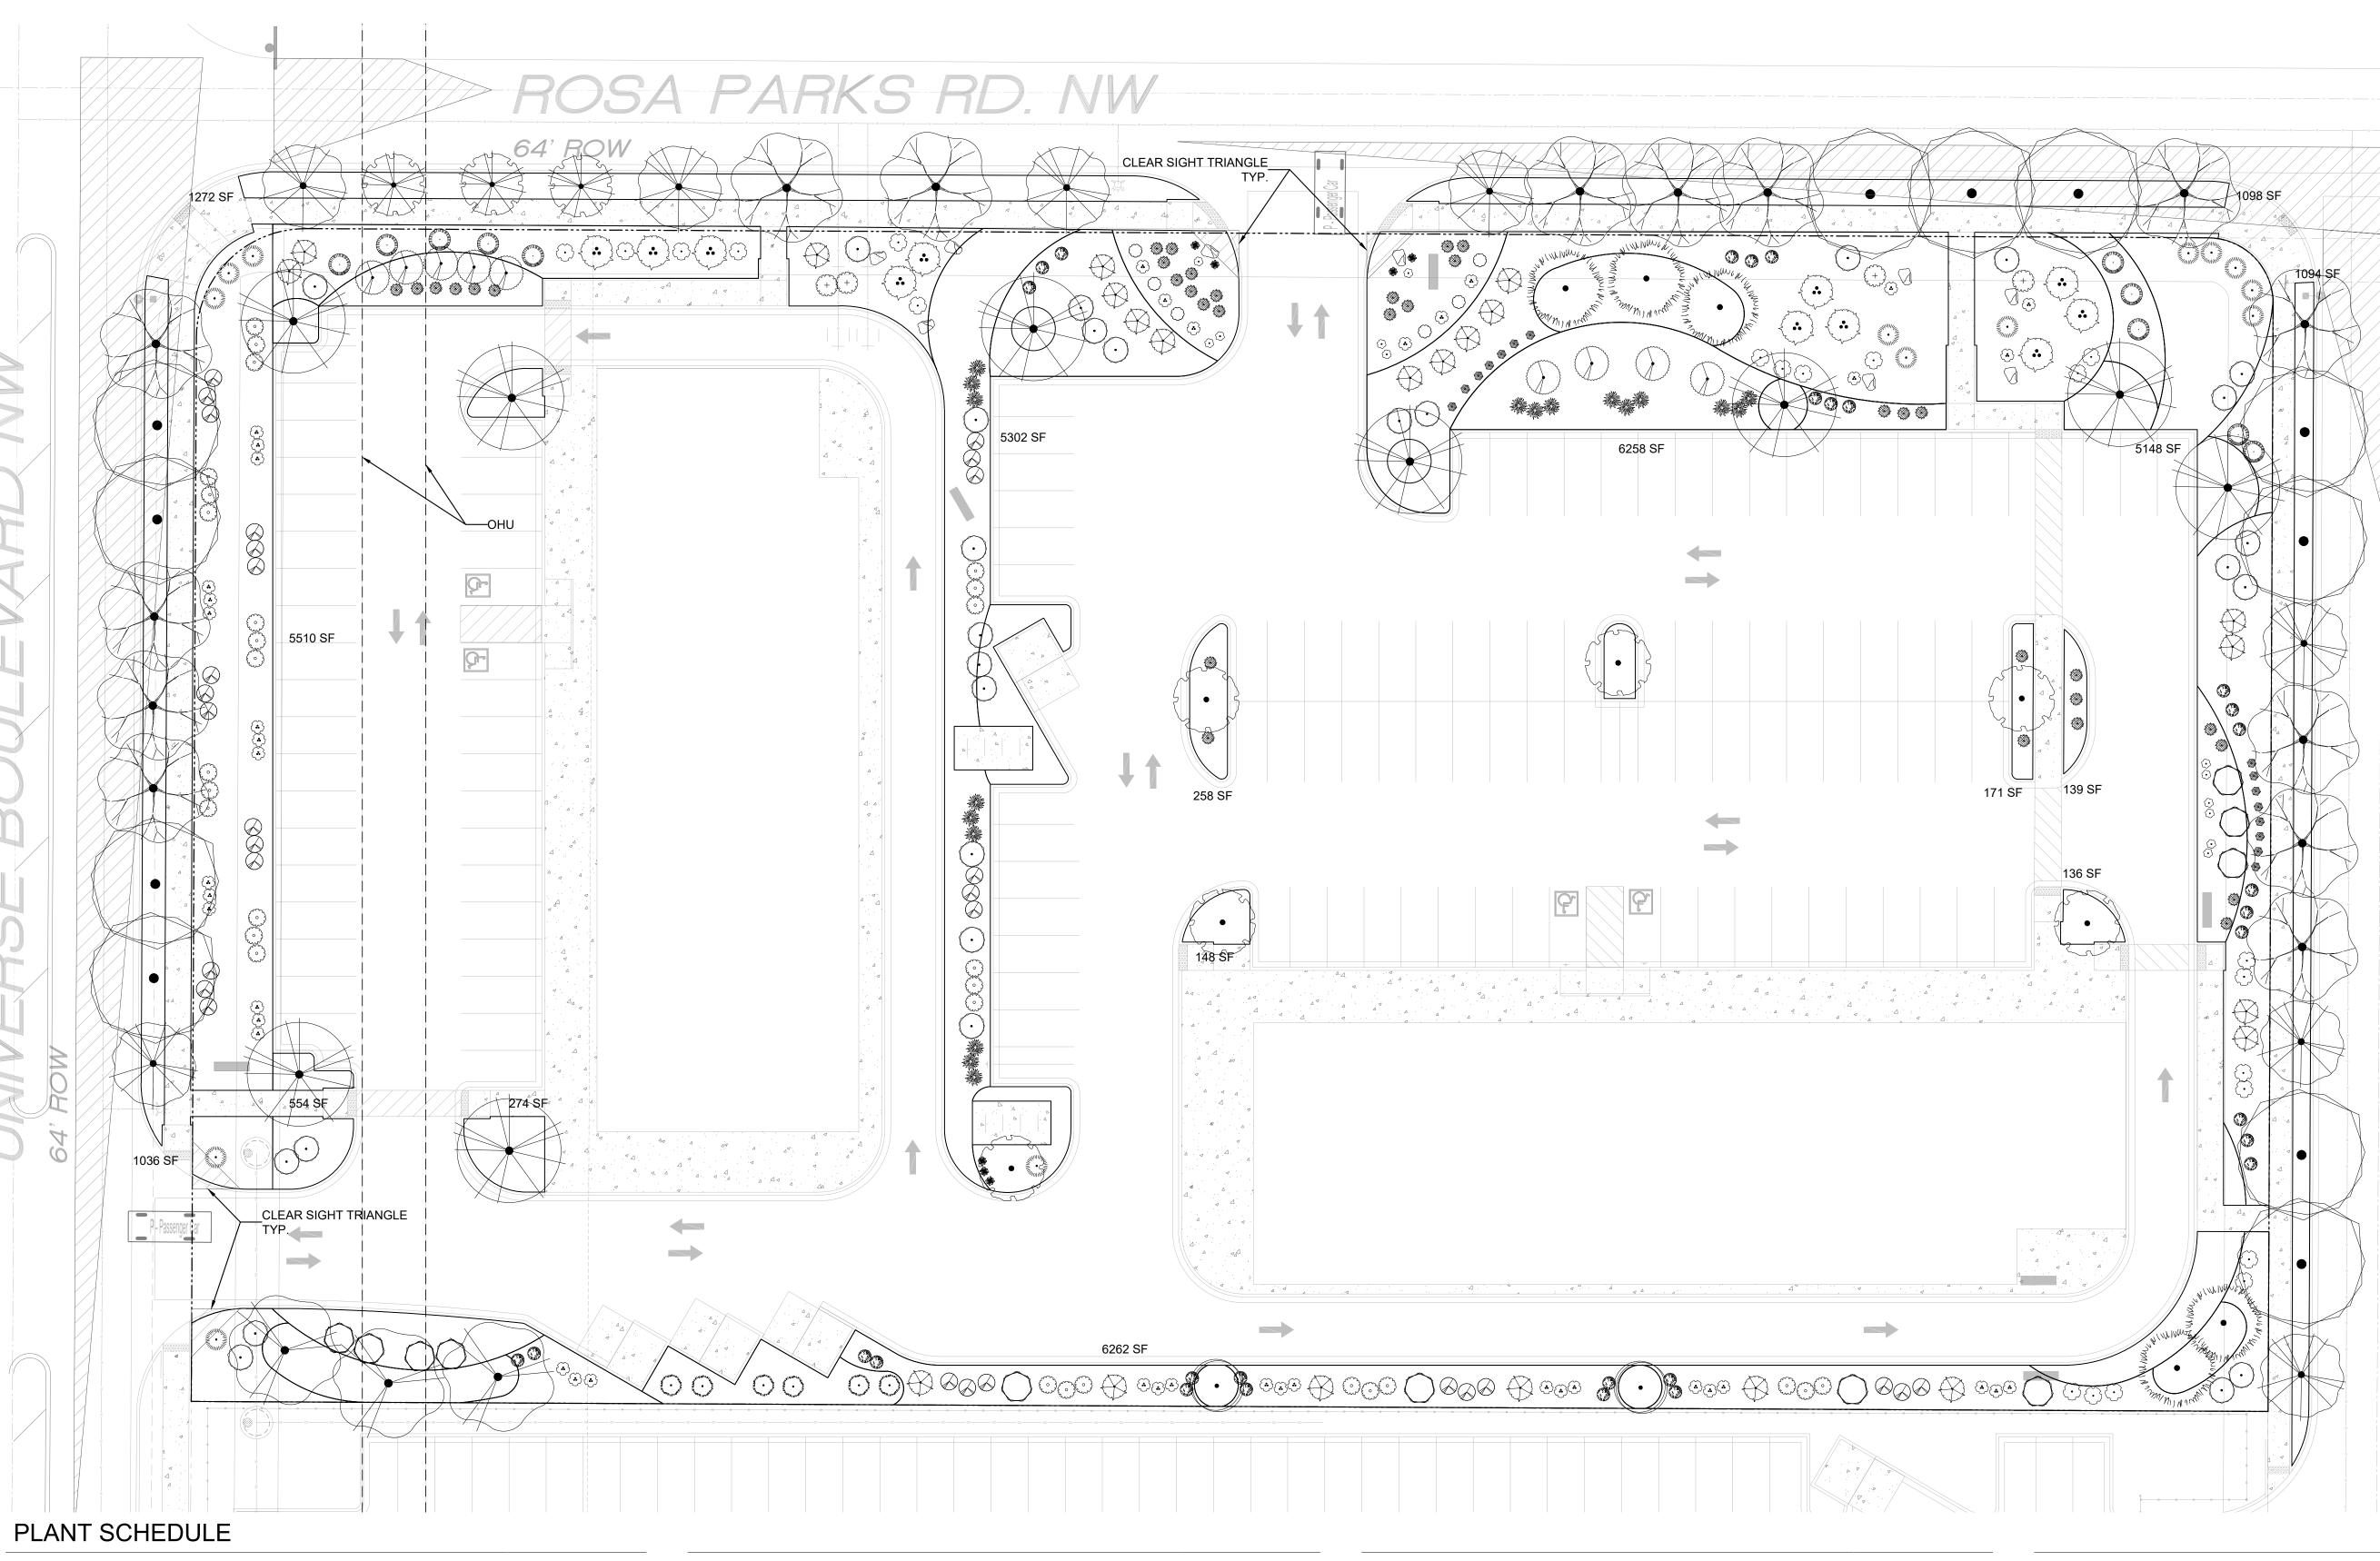


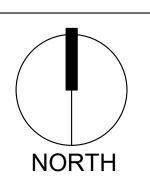

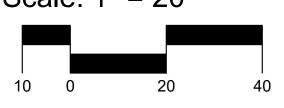Sheet Title:

Material Plan

Sheet Number:




PLAIN	1 30	HEDULE									
SYMBOL	QTY	BOTANICAL / COMMON NAME	SIZE	<u>H X W</u>	<u>H X W</u>	SYMBOL	QTY	BOTANICAL / COMMON NAME	SIZE	<u>H X W</u>	<u>H X W</u>
DECIDUOUS TREE					EVERGREEN TREE						
•	11	ACER NEGUNDO `SENSATION` SENSATION BOX ELDER MAPLE	2" B&B	40` X 30`	600	A CONTRACTOR OF THE PROPERTY O	6	JUNIPERUS CHINENSIS 'SPARTAN' SPARTAN JUNIPER	15 GAL	20` X 5`	20
	3	CHILOPSIS LINEARIS DESERT WILLOW	25 GAL	20` X 25`	491	William W. Working Control of the Co	5	PINUS ELDARICA AFGHAN PINE	6`	40` X 18`	254
	3	CRATAEGUS AMBIGUA RUSSIAN HAWTHORN	2" B&B	20` X 15`	177		8	QUERCUS FUSIFORMIS ESCARPMENT LIVE OAK	2" B&B	20` X 20`	314
		KOELREUTERIA PANICULATA				DESERT A	ACCENT	<u></u>			
	9	GOLDEN RAIN TREE	1 1/2" B&E	3 25` X 25`	491	₹	11	FOUQUIERIA SPLENDENS OCOTILLO	5 GAL	12` X 8`	50
	6	PYRUS CALLERYANA `CLEVELAND SELECT` CLEVELAND SELECT PEAR	2" B&B	25` X 15`	177	•	43	HESPERALOE PARVIFLORA RED YUCCA	5 GAL	3, X 3,	7
						PERENNIA	<u>AL</u>				
(•)	2	QUERCUS ROBUR 'FASTIGIATA' SKYROCKET® ENGLISH OAK	2" B&B	50` X 15`	177		7	ACHILLEA X `MOONSHINE` MOONSHINE YARROW	1 GAL	2` X 2`	3
		5					6	GAURA LINDHEIMERI 'WHIRLING BUTTERFLIES' WHIRLING BUTTERFLIES GAURA	1 GAL	3, X 3,	7
	14	ULMUS PROPINQUA `EMERALD SUNSHINE` EMERALD SUNSHINE ELM	2" B&B	35` X 25`	491		12	NEPETA X FAASSENII `SELECT BLUE` CATMINT	1 GAL	1` X 2`	3
~											

SYMBOL	QTY	BOTANICAL / COMMON NAME	SIZE	HXW	<u>H</u>
ORNAMEN	NTAL GI	RASS			
	35	BOUTELOUA GRACILIS 'BLONDE AMBITION' BLONDE AMBITION BLUE GRAMA	1 GAL	3, X 3,	7
	15	CALAMAGROSTIS X ACUTIFLORA `KARL FOERSTER` FEATHER REED GRASS	1 GAL	30" X 2`	3
DECIDUO	US SHF	RUBS			
	11	BUDDLEJA DAVIDII BUTTERFLY BUSH	5 GAL	5` X 7`	38
13 33 33 33 33 33 33 33 33 33 33 33 33 3	30	CARYOPTERIS X CLANDONENSIS `DARK KNIGHT` BLUE MIST SPIREA	5 GAL	3, X 3,	7
\bigcirc	28	RHUS AROMATICA `GRO-LOW` GRO-LOW FRAGRANT SUMAC	5 GAL	2` X 6`	28
	9	ROSA WOODSII MOUNTAIN ROSE	5 GAL	6, X 8,	50
EVERGRE	EN SH	RUBS			
	21	ARTEMISIA FILIFOLIA SAND SAGEBRUSH	5 GAL	4` X 4`	13
	22	CYTISUS SCOPARIUS `ALL GOLD` SCOTCH BROOM	5 GAL	4` X 6`	28
A CONTRACTOR OF THE CONTRACTOR	30	ERICAMERIA LARICIFOLIA TURPENTINE BUSH	5 GAL	3` X 4`	13
Lund	4	ERICAMERIA NAUSEOSA CHAMISA	5 GAL	5` X 5`	20

SYMBOL	QTY	BOTANICAL / COMMON NAME	SIZE	<u>H X W</u>	<u>H X W</u>
•	14	JUNIPERUS SABINA 'BUFFALO' BUFFALO JUNIPER	5 GAL	2` X 5`	20
	10	PINUS MUGO MUGO PINE	5 GAL	4` X 5`	20
	30	RHAPHIOLEPIS INDICA INDIAN HAWTHORN	5 GAL	3` X 4`	13
	18	ROSMARINUS OFFICINALIS `ARP` ARP ROSEMARY	5 GAL	6` X 4`	13




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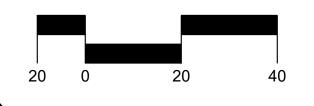
Date: <u>04/08/2024</u> Revisions: 04/29/2024 05/02/2024

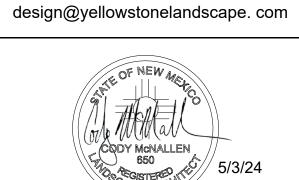Drawn by: PL

Reviewed by: <u>CM</u>




Scale: 1" = 20'

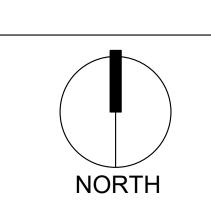

Sheet Title:

Planting Plan

Sheet Number:

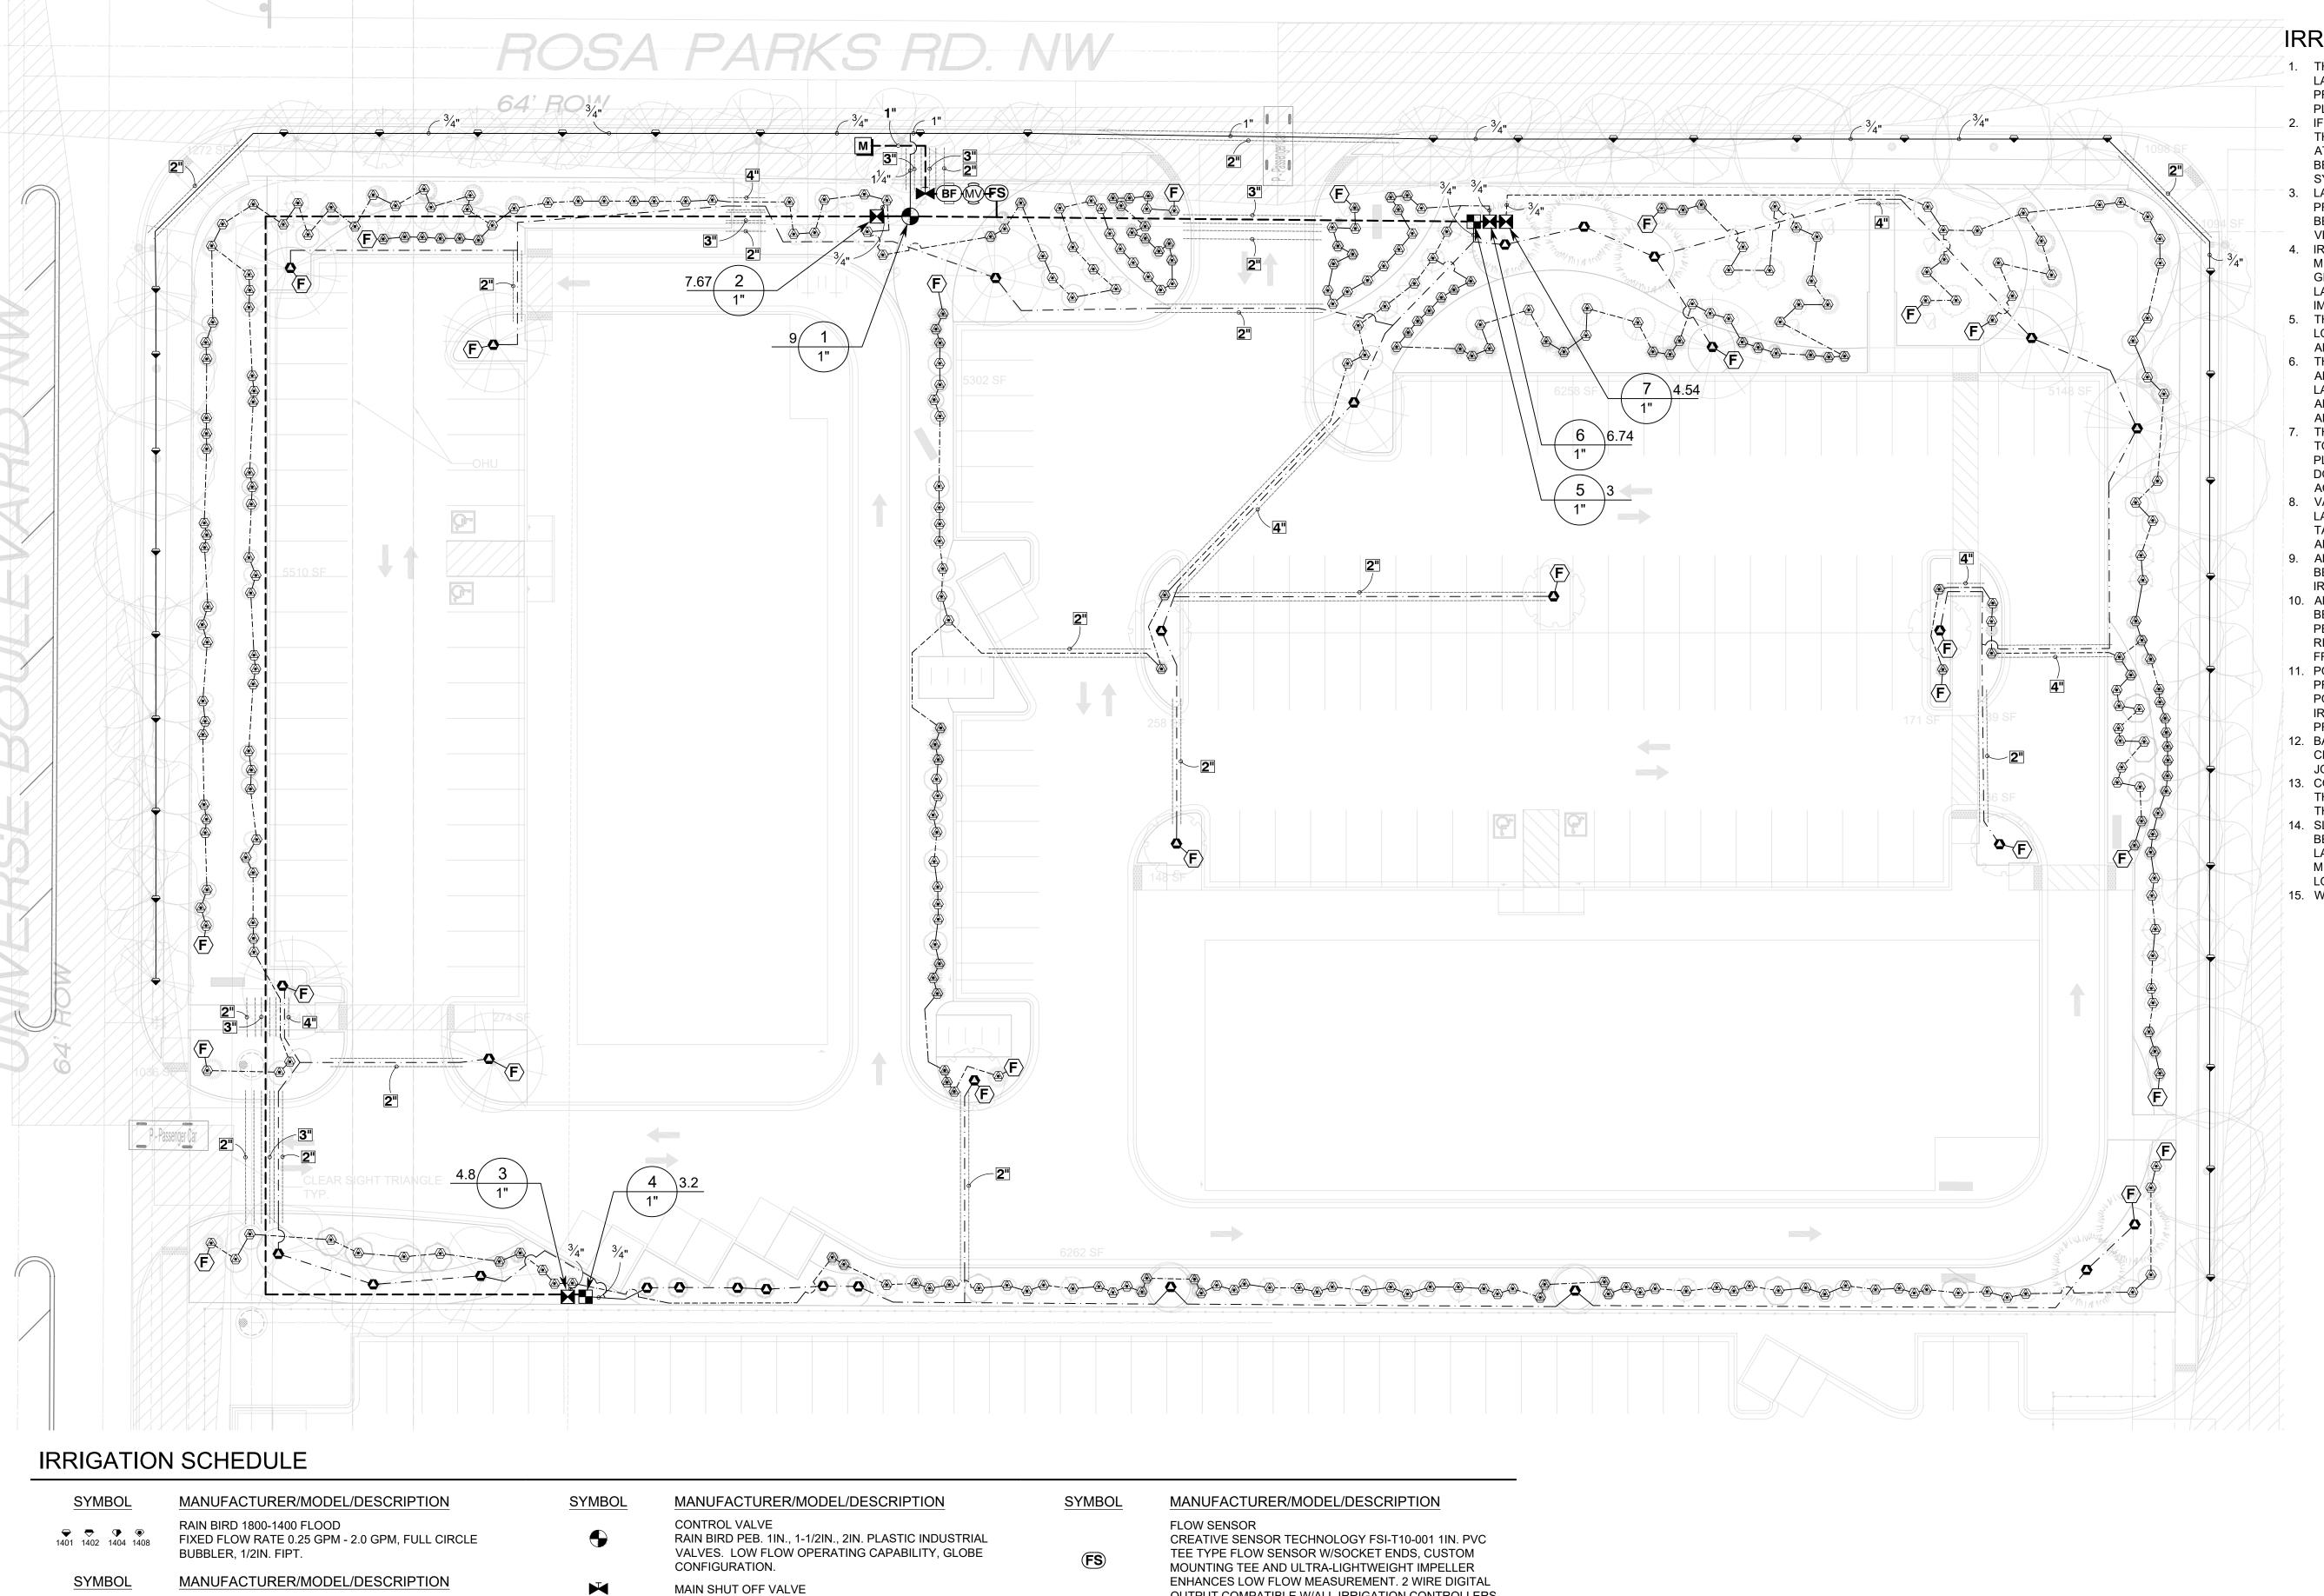

IRRIGATION NOTES

- THE LANDSCAPE CONTRACTOR SHALL FURNISH LABOR, MATERIALS AND EQUIPMENT TO INSTALL PROPOSED IRRIGATION SYSTEM AS SHOWN PER PLAN AND DETAILS.
- 2. IF ANY ERRORS OR DISCREPANCIES APPEAR ON THE PLAN, THEY MUST BE BROUGHT TO THE ATTENTION OF THE LANDSCAPE ARCHITECT BEFORE CONSTRUCTION OF THE IRRIGATION SYSTEM BEGINS.
- 3. LANDSCAPE INSTALLER SHALL PERFORM PRESSURE/GPM TEST AT POINT OF CONNECTION BEFORE INSTALLING IRRIGATION SYSTEM TO VERIFY PSI AND GPM FOR THE SITE.
- IRRIGATION SYSTEM HAS BEEN DESIGNED TO A MINIMUM DYNAMIC PRESSURE OF 75 PSI AT 50 GPM. IF THE PSI/GPM ARE LOWER THAN 75/50 THE LANDSCAPE ARCHITECT MUST BE NOTIFIED IMMEDIATELY.
- 5. THE CONTRACTOR SHALL FIELD VERIFY UTILITY LOCATIONS AND MAKE ANY NECESSARY FIELD ADJUSTMENTS WITH GENERAL CONTRACTOR. 6. THE LOCATION OF IRRIGATION EQUIPMENT IS APPROXIMATE AND SHALL BE LOCATED IN THE LANDSCAPE AREAS. ANY IRRIGATION EQUIPMENT AND PIPING SHOWN OUTSIDE OF LANDSCAPE AREAS ARE FOR GRAPHIC CLARITY ONLY.
- 7. THE LANDSCAPE CONTRACTOR SHALL PROVIDE TO OWNER AN ACCURATE AS-BUILT IRRIGATION PLAN WHEN THE WORK IS COMPLETED. AS-BUILT DOCUMENTS SHOULD BE UPDATED WEEKLY FOR ACCURATE RECORDING OF IRRIGATION SYSTEM.
- 8. VALVE LOCATIONS TO BE APPROVED BY LANDSCAPE ARCHITECT. VALVE BOX LIDS TO BE TAN IN GRAVEL AREAS AND GREEN IN SOD/SEED
- 9. ALL PLANTS WITHIN THE PROPERTY LINE SHALL BE IRRIGATED BY LOW FLOW POINT-SOURCE DRIP IRRIGATION SYSTEM.
- 10. ALL PLANTS WITHIN PUBLIC RIGHT-OF-WAY SHALL BE IRRIGATED BY BUBBLER IRRIGATION SYSTEM PER COA SPEC. ALL PLANTS WITHIN THE PUBLIC RIGHT-OF-WAY SHALL BE ZONED SEPARATELY FROM THE PLANTS WITHIN THE PROPERTY LINE.
- 11. POWER FOR IRRIGATION SYSTEM TO BE PROVIDED BY THE GENERAL CONTRACTOR. 110V POWER IS REQUIRED AT THE LOCATIONS OF THE IRRIGATION CONTROLLER AND BACKFLOW 12. BACKFLOW PREVENTER MUST BE TESTED AND
- CERTIFIED BEFORE FINAL ACCEPTANCE OF THE
- 13. CONTROLLER LOCATION IS APPROXIMATE AND THE FINAL LOCATION WILL BE DETERMINED IN THE FIELD.
- 14. SLEEVES TO BE INSTALLED, AS SHOWN PER PLAN, BEFORE HARDSCAPE IS INSTALLED. THE LANDSCAPE CONTRACTOR MUST BE GIVEN A MINIMUM OF 72 HOUR NOTICE BEFORE SLEEVE LOCATIONS ARE PAVED OVER.
- 15. WATER METER TO BE PROVIDED BY OTHERS.




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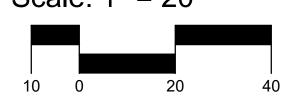
04/29/2024

Drawn by: PL Reviewed by: CM



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Scale: 1" = 20'

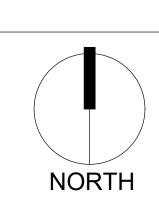

Sheet Title:

Irrigation Plan

Sheet Number:

SPEARS SCH80 PVC COMPACT BALL VALVE

TO BE LOCATED ON SITE

DRIP CONTROL VALVE - SHRUB

DRIP CONTROL VALVE - TREE

FLUSH CAP

NDS CEP900

DRIP EMITTER - SHRUB

DRIP EMITTER - TREE

(2) NDS TAE 20 DRIP EMITTERS

(6) NDS TAE 20 DRIP EMITTERS

PRESSURE REGULATOR. 5 GPM-20 GPM.

PRESSURE REGULATOR. 3 GPM-15 GPM.

RAIN BIRD XCZ-100-PRF, MEDIUM FLOW DRIP CONTROL KIT,

1IN. DV VALVE, 1IN. PRESSURE REGULATING FILTER, 40PSI

RAIN BIRD XCZ-100-PRF. MEDIUM FLOW DRIP CONTROL KIT,

1IN. DV VALVE, 1IN. PRESSURE REGULATING FILTER, 40PSI

MASTER VALVE 1" RAIN BIRD PEB. 1IN., 1-1/2IN., 2IN. PLASTIC INDUSTRIAL MASTER VALVES. LOW FLOW OPERATING CAPABILITY, GLOBE CONFIGURATION.

REDUCED PRESSURE BACKFLOW PREVENTER 1" FEBCO 825Y

CONTROLLER - RAIN BIRD ESP-LXD 50-200 STATION, 2-WIRE DECODER BASED CONTROLLER. (1) ESP-LXD 50-STATION, INDOOR/OUTDOOR, PLASTIC WALL-MOUNT ENCLOSURE. SYSTEM REQUIREMENTS: RAIN BIRD FD-XXX-TURF FIELD DECODERS, PAIGE ELECTRIC CABLE P7072D & RAIN BIRD WC20 DRY SPLICES ONLY. GROUND SYSTEM W/ (X) LSP-1TURF LINE SURGE PROTECTORS IN RAIN BIRD ROUND VALVE BOXES. INSTALL PER MANUFACTURERS RECOMMENDATIONS.

OUTPUT COMPATIBLE W/ALL IRRIGATION CONTROLLERS. FLOW RANGE: .86 GPM - 52 GPM.

WATER METER 1" IRRIGATION WATER METER


IRRIGATION LATERAL LINE: PVC SCHEDULE 40


------ IRRIGATION LATERAL LINE: A940 DRIP POLYLINE - SHRUBS IRRIGATION LATERAL LINE: A940RDS DRIP POLYLINE -


---- --- IRRIGATION MAINLINE: PVC SCHEDULE 40

_____ PIPE SLEEVE: PVC CLASS 200 SDR 21


Valve Callout Valve Number Valve Flow

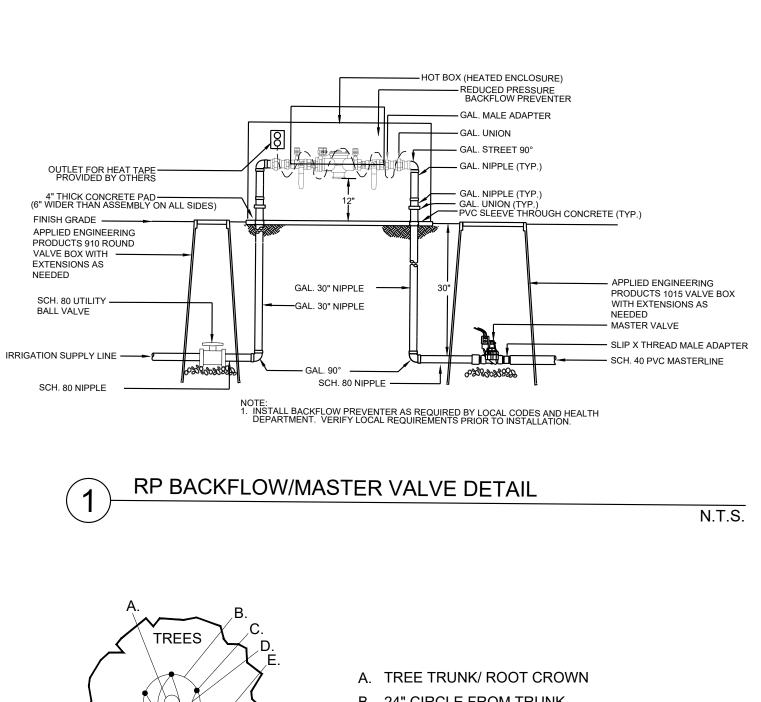


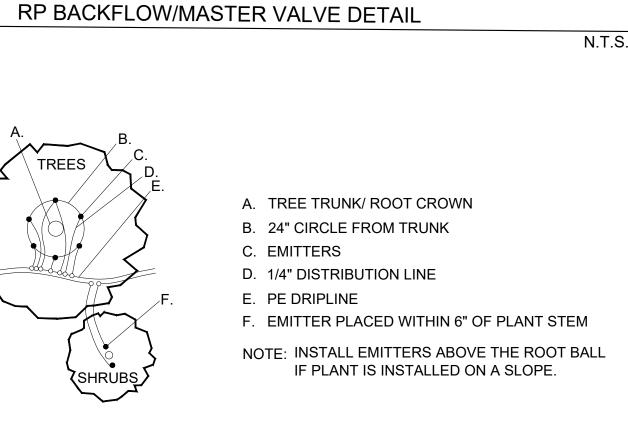

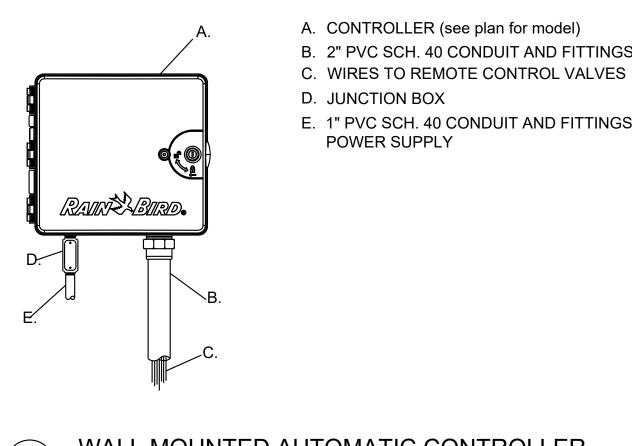

EMITTER PLACEMENT DETAIL

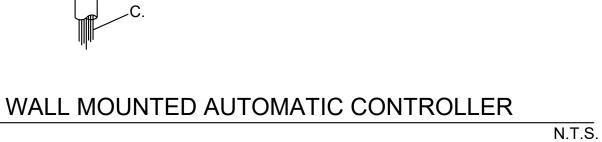

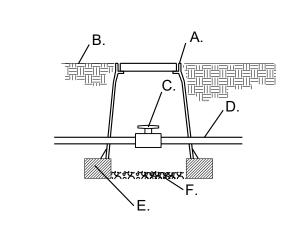

A. APPLIED ENGINEERING

B. FINISH GRADE

C. 24" WIRE LOOP

EQUAL

N.T.S.

D. AUTOMATIC VALVE

EXTENSIONS AS NEEDED

SEE IRRIGATION LEGEND.

E. DRY SPLICE CONNECTOR OR

PRODUCTS 1320 VALVE BOX WITH

MAINLINE ISOLATION VALVE DETAIL

- A. APPLIED ENGINEERING PRODUCTS 910 ROUND VALVE BOX WITH EXTENSIONS AS NEEDED
- B. FINISH GRADE
- C. SCH. 80 UTILITY BALL VALVE

F. "WYE" STRAINER

OF FILTER

H. 8" X 8" X 16" CMU

DRIP VALVE WITH FILTER & PRESSURE REGULATOR

STRAINER SHALL BE INSTALLED

MAINTENANCE AND REPLACEMENT

TO PROVIDE ACCESS FOR

G. LATERAL LINE/24" BURY

CONCRETE BLOCK

I. MASTERLINE/24" BURY

J. 4" LAYER OF 3/4" GRAVEL


K. PRESSURE REGULATOR

M. SCH. 40 PVC LATERAL LINE

L. SCH. 80 TRUE UNION BALL VALVE


N.T.S.


- D. MAINLINE/24" BURY
- E. 8" X 8" X 16" CMU
- CONCRETE BLOCK F. 4" LAYER OF 3/4" GRAVEL

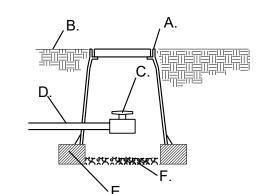

- A. APPLIED ENGINEERING PRODUCTS 910 ROUND VALVE BOX WITH EXTENSIONS AS NEEDED
- B. FINISH GRADE
- C. SCH. 80 UTILITY BALL VALVE
- D. MAINLINE/24" BURY E. 8" X 8" X 16" CMU
- CONCRETE BLOCK F. 3/4" GRAVEL SUMP UNDER MANUAL DRAIN TO BE A

MINIMUM OF 12" DEEP

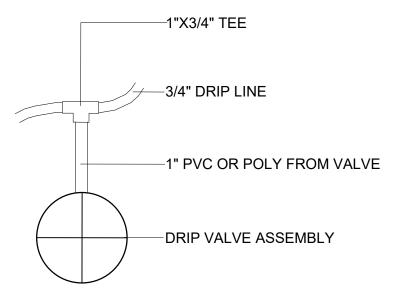


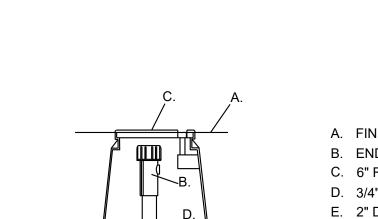

END FLUSH CAP

MANUAL DRAIN VALVE DETAIL

A. FINISH GRADE B. END FLUSH CAP C. 6" ROUND BOX WITH LID D. 3/4" POLY DRIP PIPE E. 2" DEPTH OF GRAVEL F. 90° FITTING

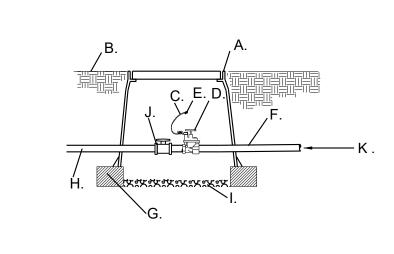

AUTOMATIC VALVE

A. APPLIED ENGINEERING PRODUCTS 1320 VALVE BOX WITH EXTENSIONS AS NEEDED


- B. FINISH GRADE
- C. 24" WIRE LOOP
- D. AUTOMATIC VALVE-SEE IRRIGATION LEGEND.
- E. DRY SPLICE CONNECTOR OR
- F. LATERAL LINE/24" BURY
- G. 8" X 8" X 16" CMU CONCRETE BLOCK
- H. MASTERLINE/24" BURY
- I. 4" LAYER OF 3/4" GRAVEL
- J. SCH. 80 TRUE UNION BALL VALVE
- K. SCH. 40 PVC LATERAL LINE

N.T.S.

N.T.S.

A. CONTROLLER (see plan for model)

- B. 2" PVC SCH. 40 CONDUIT AND FITTINGS
- E. 1" PVC SCH. 40 CONDUIT AND FITTINGS TO POWER SUPPLY

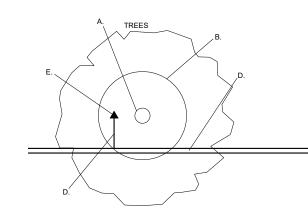


BUBBLER PLACEMENT DETAIL

A. TREE TRUNK/ ROOT CROWN B. 36" DIA BERM AROUND TREE C. 24" DIA BERM AROUND SHRUB D. PVC LATERAL PIPE (SIZE VARIES)

E. BUBBLER PLACED 6" INSIDE BERM

NOTE: INSTALL BUBBLER(S) ABOVE THE ROOT BALL IF PLANT IS INSTALLED ON A SLOPE.

N.T.S.

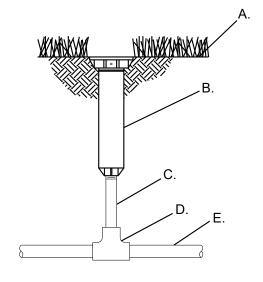

A. FINISH GRADE

B. POP-UP SPRAY SPRINKLER: RAIN BIRD 1804-SAM-PRS BODY WITH RAINBIRD R-VAN NOZZLE

N.T.S.

N.T.S.

C. PVC SCH.40 NIPPLE D. PVC SCH.40 TEE

E. PVC LATERAL LINE

ROTATOR SPRINKLER

IRRIGATION NOTES

- 1. THE LANDSCAPE CONTRACTOR SHALL FURNISH LABOR, MATERIALS AND EQUIPMENT TO INSTALL PROPOSED IRRIGATION SYSTEM AS SHOWN PER PLAN AND DETAILS.
- 2. IF ANY ERRORS OR DISCREPANCIES APPEAR ON THE PLAN, THEY MUST BE BROUGHT TO THE ATTENTION OF THE LANDSCAPE ARCHITECT BEFORE CONSTRUCTION OF THE IRRIGATION SYSTEM BEGINS.
- 3. LANDSCAPE INSTALLER SHALL PERFORM PRESSURE/GPM TEST AT POINT OF CONNECTION
- BEFORE INSTALLING IRRIGATION SYSTEM TO VERIFY PSI AND GPM FOR THE SITE. 4. IRRIGATION SYSTEM HAS BEEN DESIGNED TO A MINIMUM DYNAMIC PRESSURE OF 75 PSI AT 50 GPM. IF THE PSI/GPM ARE LOWER THAN 75/50 THE LANDSCAPE ARCHITECT MUST BE NOTIFIED IMMEDIATELY.
- 5. THE CONTRACTOR SHALL FIELD VERIFY UTILITY LOCATIONS AND MAKE ANY NECESSARY FIELD
- ADJUSTMENTS WITH GENERAL CONTRACTOR. 6. THE LOCATION OF IRRIGATION EQUIPMENT IS APPROXIMATE AND SHALL BE LOCATED IN THE
- LANDSCAPE AREAS. ANY IRRIGATION EQUIPMENT AND PIPING SHOWN OUTSIDE OF LANDSCAPE AREAS ARE FOR GRAPHIC CLARITY ONLY.
- IRRIGATION PLAN WHEN THE WORK IS COMPLETED. AS-BUILT DOCUMENTS SHOULD BE UPDATED WEEKLY FOR ACCURATE RECORDING OF IRRIGATION SYSTEM. 8. VALVE LOCATIONS TO BE APPROVED BY LANDSCAPE ARCHITECT. VALVE BOX LIDS TO BE TAN

7. THE LANDSCAPE CONTRACTOR SHALL PROVIDE TO OWNER AN ACCURATE AS-BUILT

- IN GRAVEL AREAS AND GREEN IN SOD/SEED AREAS. 9. ALL PLANTS WITHIN THE PROPERTY LINE SHALL BE IRRIGATED BY LOW FLOW POINT-SOURCE
- DRIP IRRIGATION SYSTEM. 10. ALL PLANTS WITHIN PUBLIC RIGHT-OF-WAY SHALL BE IRRIGATED BY BUBBLER IRRIGATION SYSTEM PER COA SPEC. ALL PLANTS WITHIN THE PUBLIC RIGHT-OF-WAY SHALL BE ZONED
- SEPARATELY FROM THE PLANTS WITHIN THE PROPERTY LINE. 11. POWER FOR IRRIGATION SYSTEM TO BE PROVIDED BY THE GENERAL CONTRACTOR. 110V POWER IS REQUIRED AT THE LOCATIONS OF THE IRRIGATION CONTROLLER AND BACKFLOW PREVENTER.
- 12. BACKFLOW PREVENTER MUST BE TESTED AND CERTIFIED BEFORE FINAL ACCEPTANCE OF THE JOB.
- 13. CONTROLLER LOCATION IS APPROXIMATE AND THE FINAL LOCATION WILL BE DETERMINED IN THE FIELD.
- 14. SLEEVES TO BE INSTALLED, AS SHOWN PER PLAN, BEFORE HARDSCAPE IS INSTALLED. THE LANDSCAPE CONTRACTOR MUST BE GIVEN A MINIMUM OF 72 HOUR NOTICE BEFORE SLEEVE LOCATIONS ARE PAVED OVER.
- 15. WATER METER TO BE PROVIDED BY OTHERS.



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Revisi	ons:
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Drawn by: PL Reviewed by: <u>CM</u>

NORTH

Scale: 1" = 20'



Sheet Title:

Irrigation Plan

Sheet Number: