




NOTE: CONTRACTOR TO VERIFY PAVEMENT MINIMUMS WITH SOILS REPORT PROVIDED BY THE DEVELOPER/OWNER.

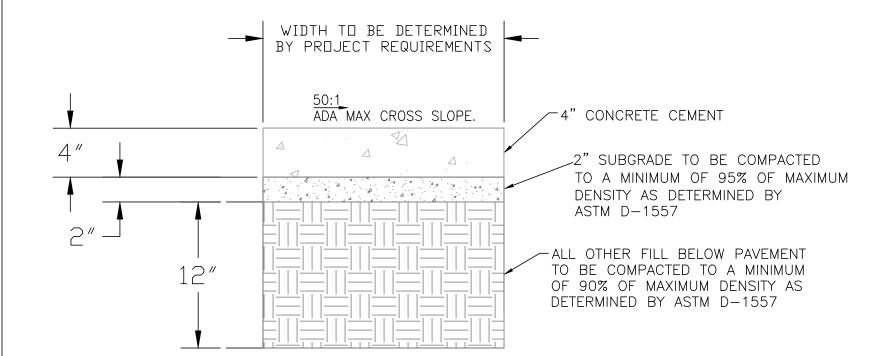

### CONCRETE SIDEWALK SECTION

NTS

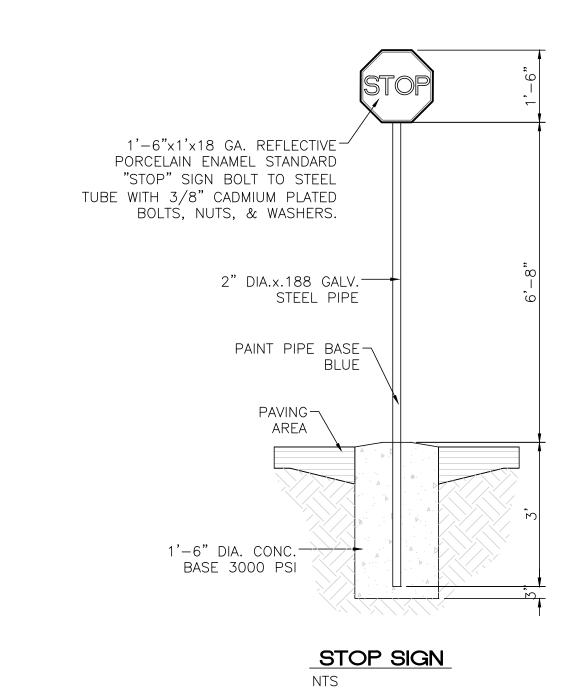


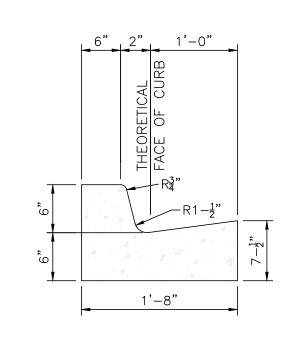


CURB GENERAL NOTES: 1. ALL CURBS TO BE CONSTRUCTED OF PORTLAND


- CEMENT CONCRETE, PER SPECIFICATIONS. 2. PROVIDE CONTRACTION JTS. 12' MAX., SPACING, 1/2" EXP. JTS. AT CURB RETURNS AND AT A MAX. SPACING OF 120' BETWEEN CURB RETURNS AND EACH SIDE OF SEPARATELY CONSTRUCTED DRIVEWAYS. CONTRACTION JTS., SHALL BE EITHER SAWED OR TOOLED A MINIMUM OF 1" DEEP AT FINISHED FACES.
- 3. ALL EDGES SHALL BE EDGED WITH A 3/8" RADUIS EDGING TOOL.
- 4. 1/4" ISOLATION JOINT SHALL BE PLACED BETWEEN SIDEWALK AND CURB WHEN CAST ADJACENT TO EACH

## 6" PRIVATE CURB & GUTTER

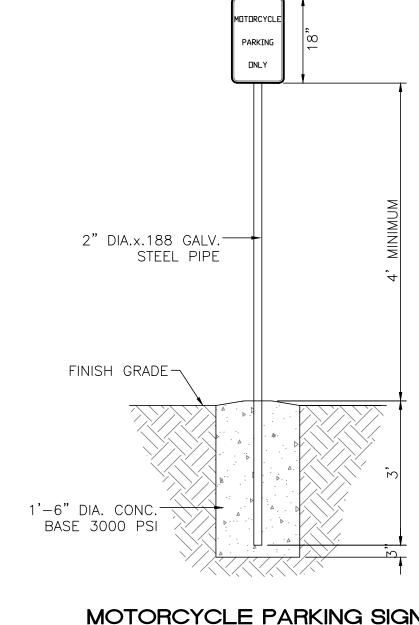


# MOTORCYCLE PARKING SIGN

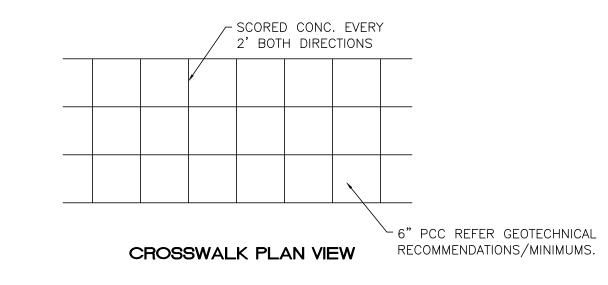

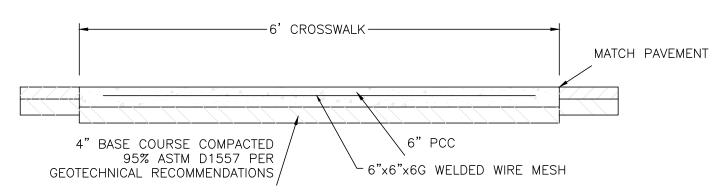



# CONCRETE CROSSWALK (OR SIMILAR)

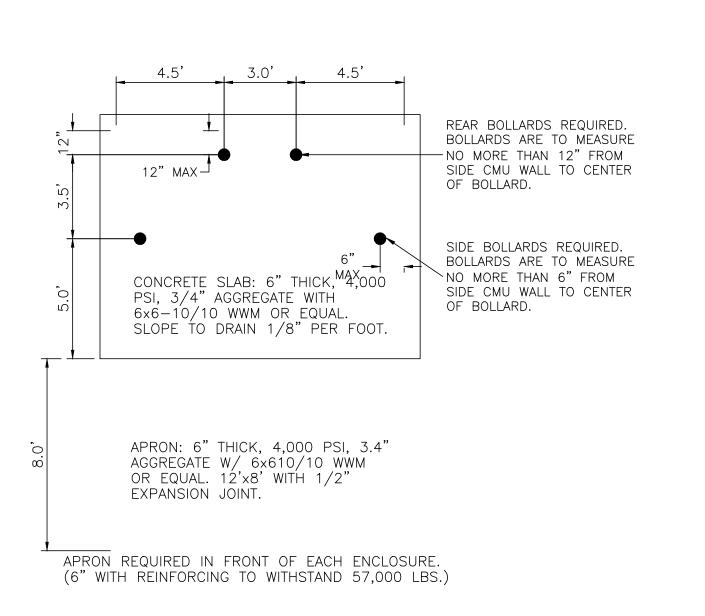

## **DUMPSTER BOLLARD DETAIL**

NOTE: ACTUAL DIMENSIONS PROVIDED BY DEVELOPER/OWNER (REFER ARCHITECTURAL PLANS/DETAILS)

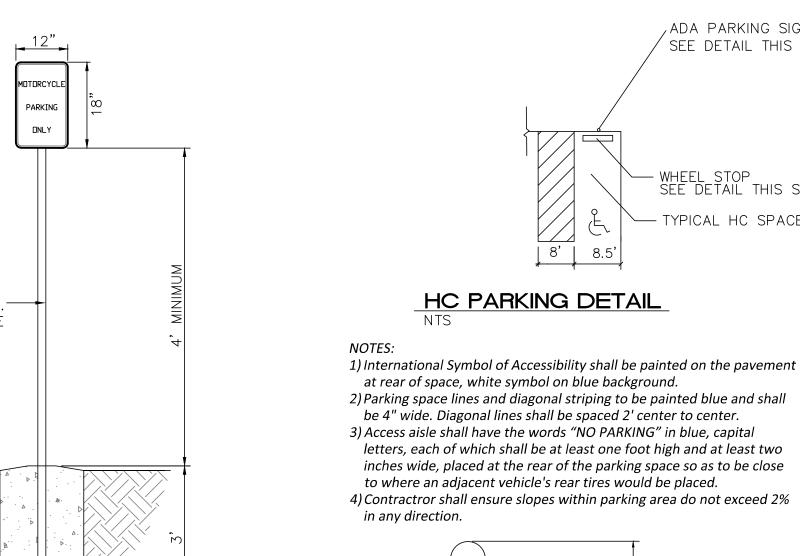

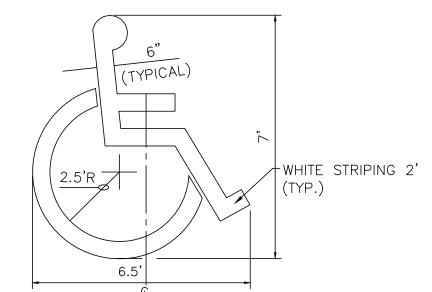

| 8' |

, ADA PARKING SIGN


- WHEEL STOP SEE DETAIL THIS SHEET


- TYPICAL HC SPACE


SEE DETAIL THIS SHEET


LOCATE AT EDGE OF PARKING SPACE UNLESS ACCOMPANIED BY "VAN" LETTERING

ACCESSIBLE PARKING SYMBOL

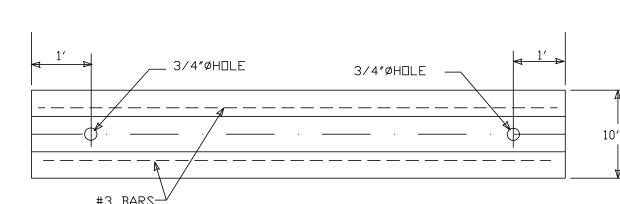

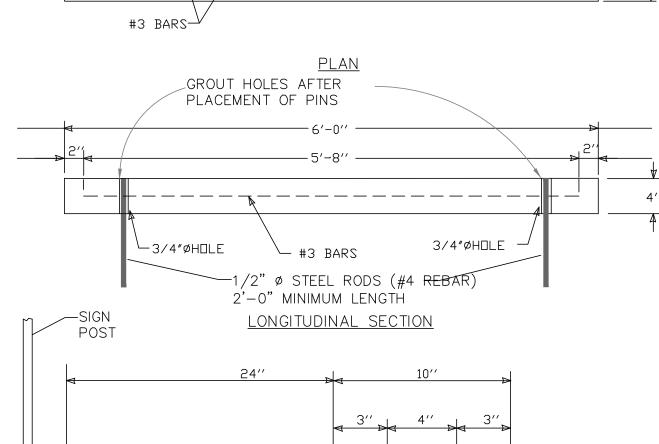


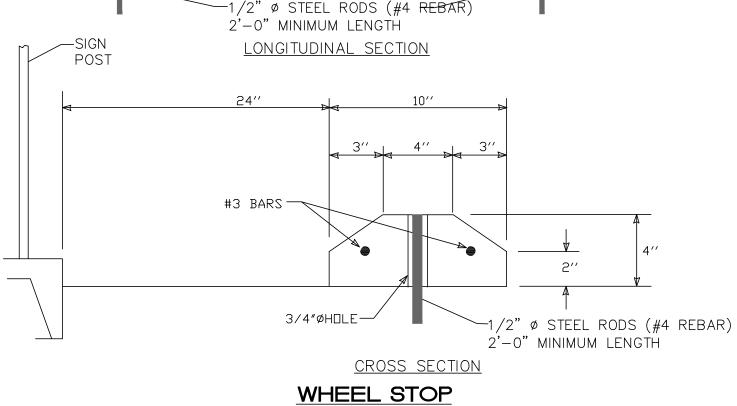

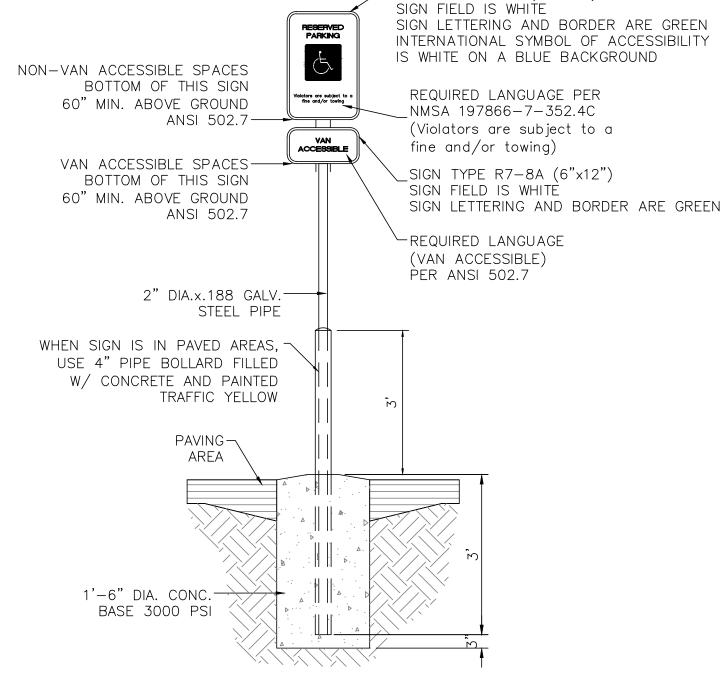

SIGN TYPE R7-8 (12"x18")



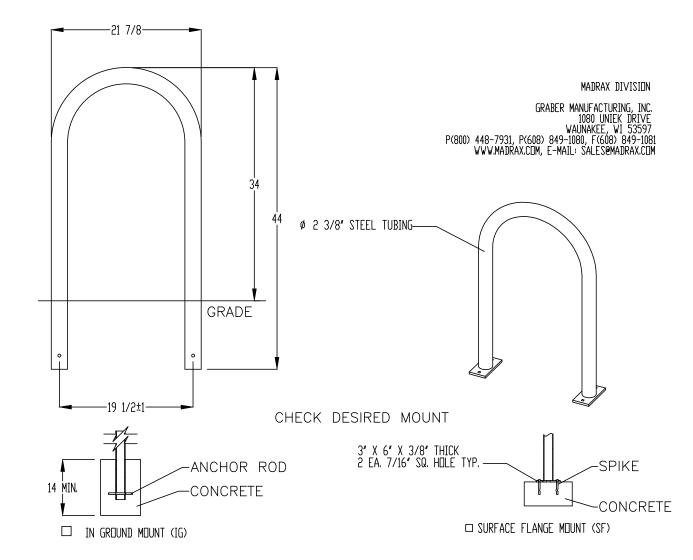

PRODUCT: U238-IG(SF) DESCRIPTION: 'U' BIKE RACK 2 BIKE, SURFACE OR IN GROUND MOUNT CONFIDENTIAL DRAWING AND INFORMATION IS NOT TO BE COPIED OR DISCLOSED TO OTHERS WITHOUT THE CONSENT OF GRABER MANUFACTURING, INC. SPECIFICATIONS ARE SUBJECT TO CHANGE WITHOUT NOTICE. ©2018 GRABER MANUFACTURING, INC. ALL PROPRIETARY RIGHTS RESERVED.

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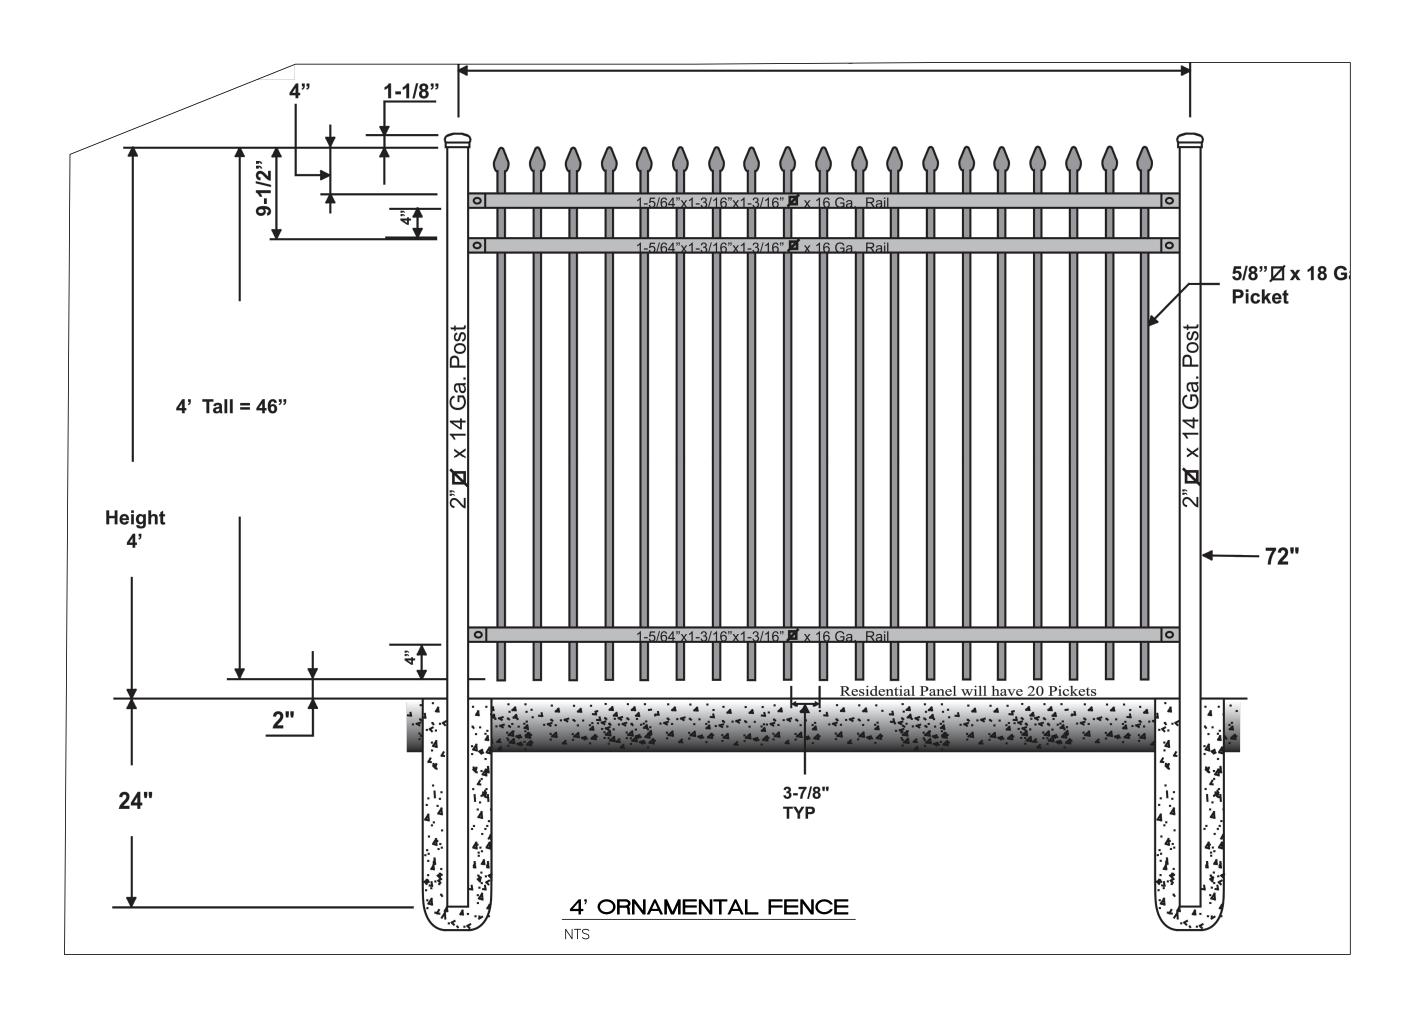



**BIKE RACK** SCALE: NONE


REVISION	12/07/2023	LN						
ISSUED FOR DFT SITE PLAN								
ENGINEER'S SEAL	98TH & SAGE STORAGE ALBUQUERQUE, NM	DRAWN BY  BF  DATE						
OR. BOHAND Z (7868)	CONSTRUCTION DETAILS	10/31/2023 2023018_DTE						
11/30/2023	TIERRA WEST, LLC  5571 MIDWAY PARK PLACE NE ALBUQUERQUE, 7487109	SHEET #  DFT-2						
RONALD R. BOHANNAN	(505) 858-3100	JOB #						


www.tierrawestllc.com


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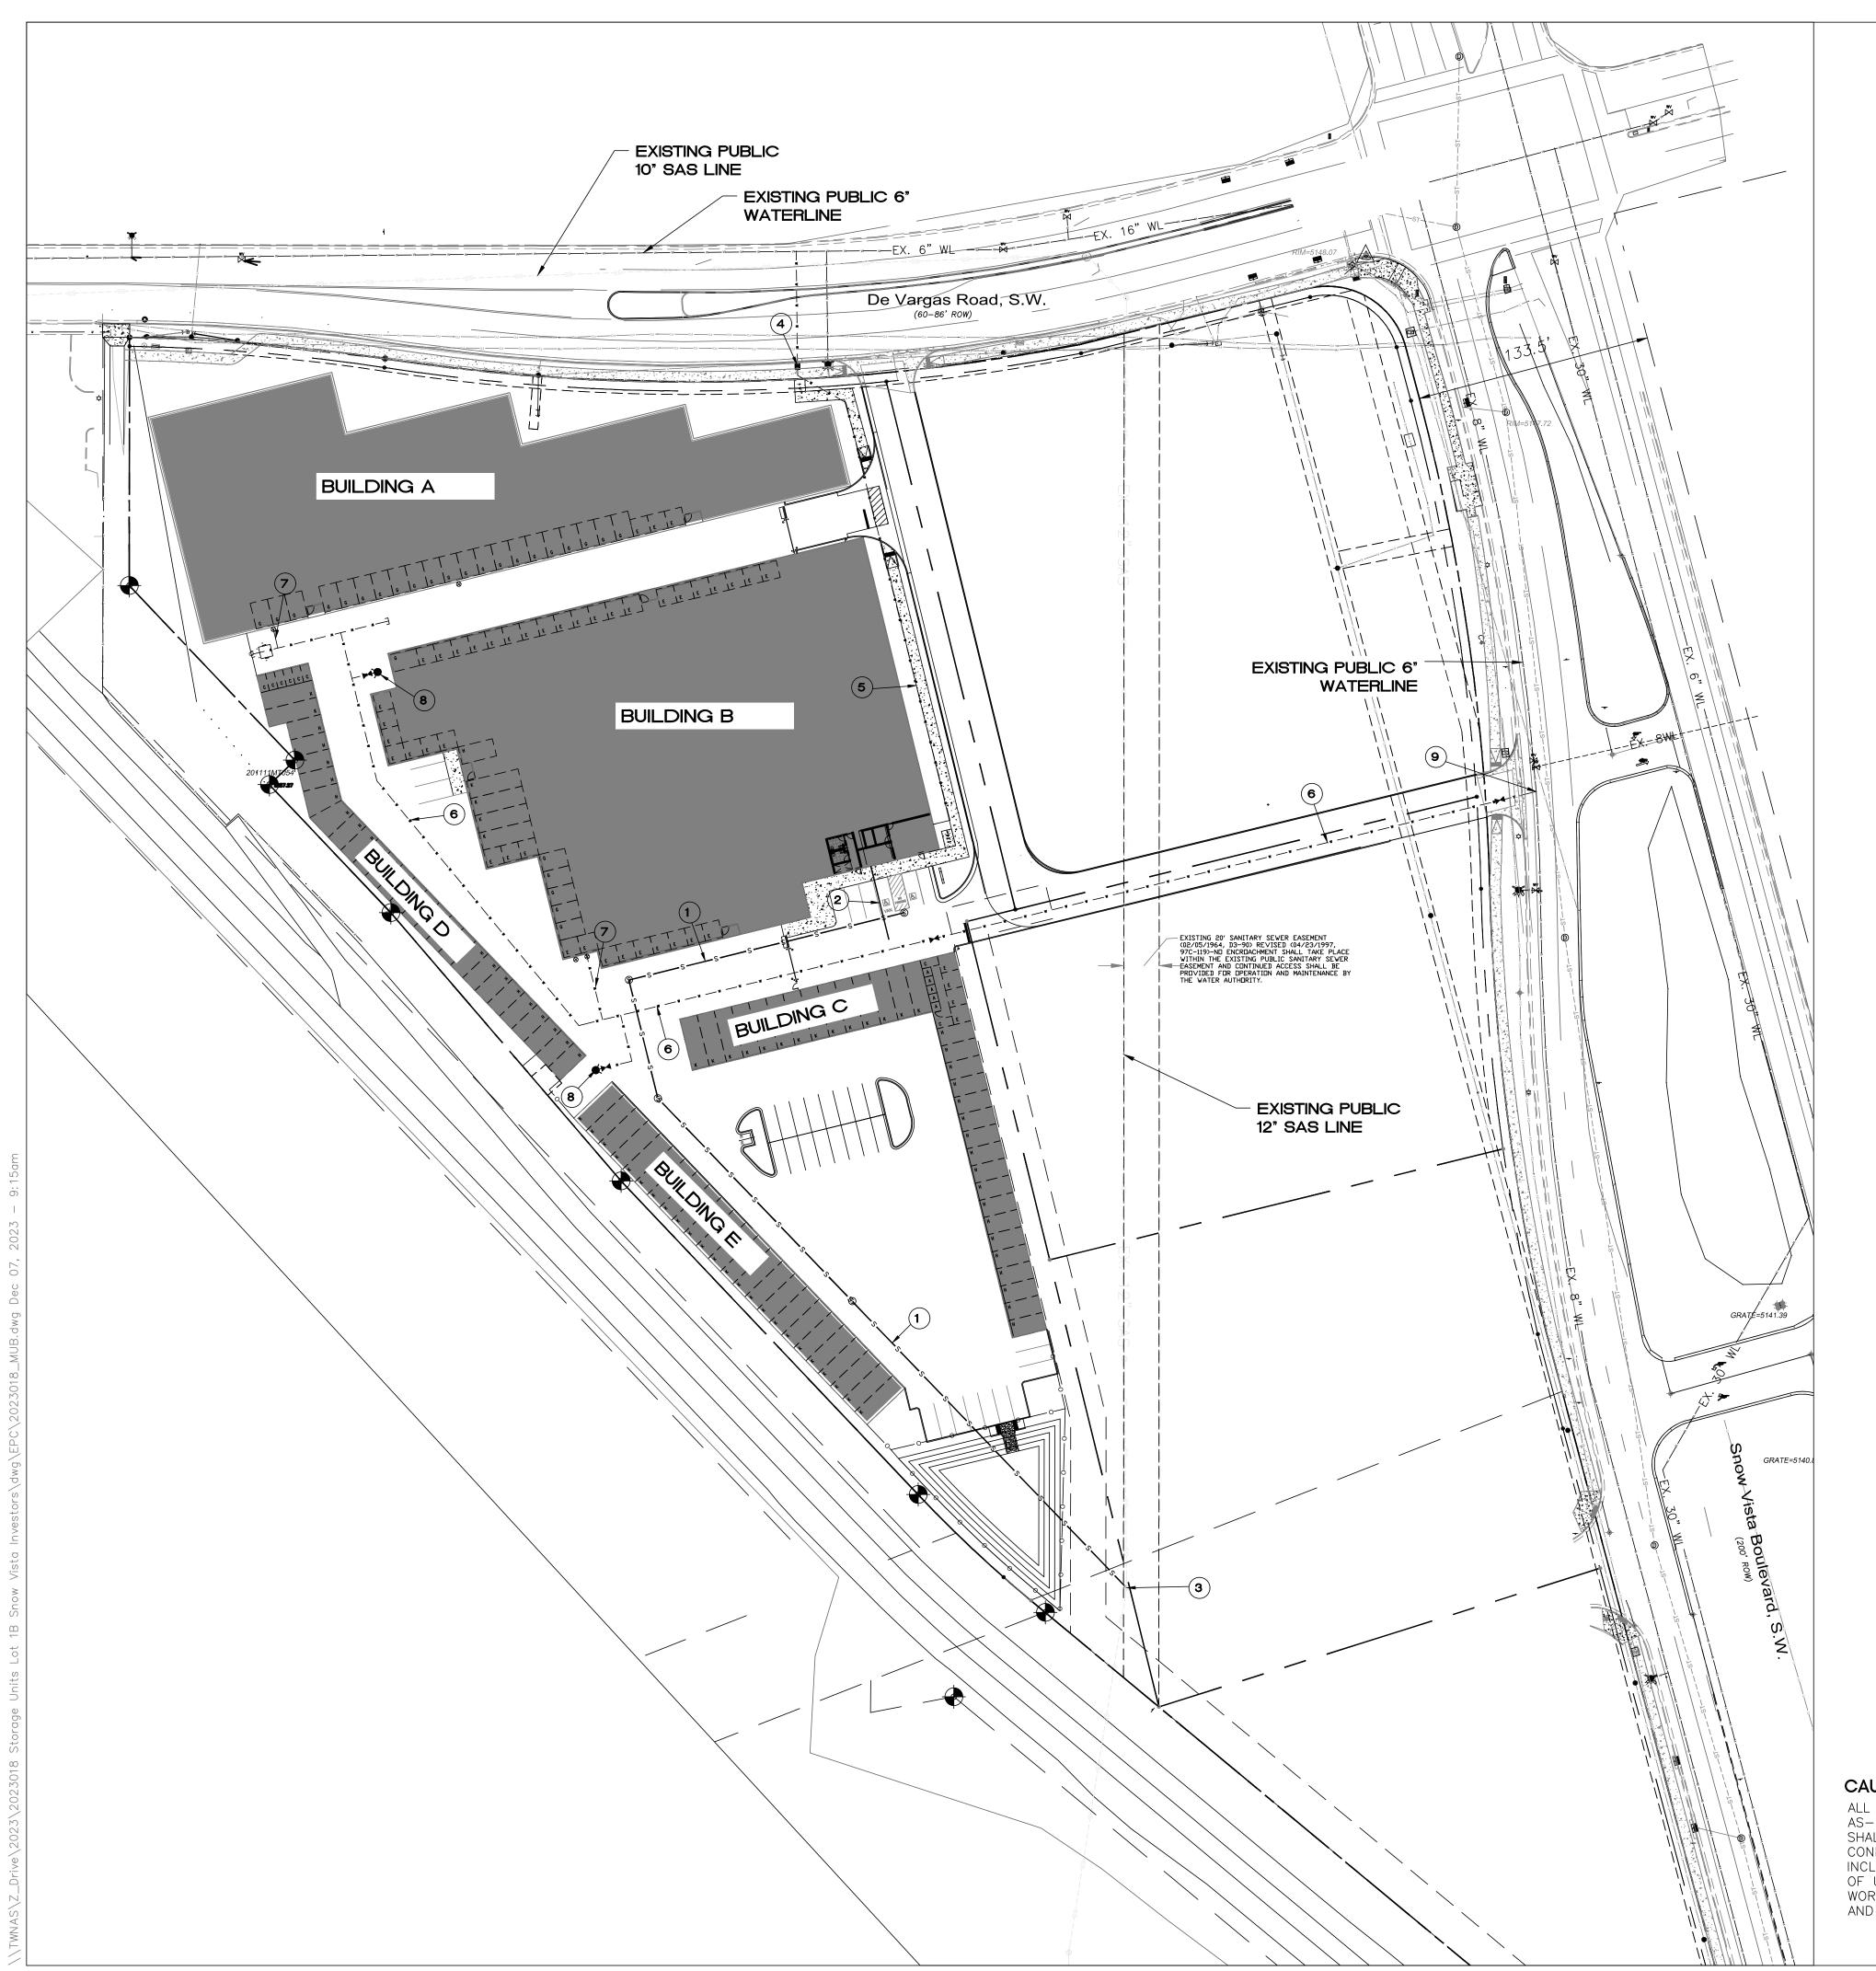




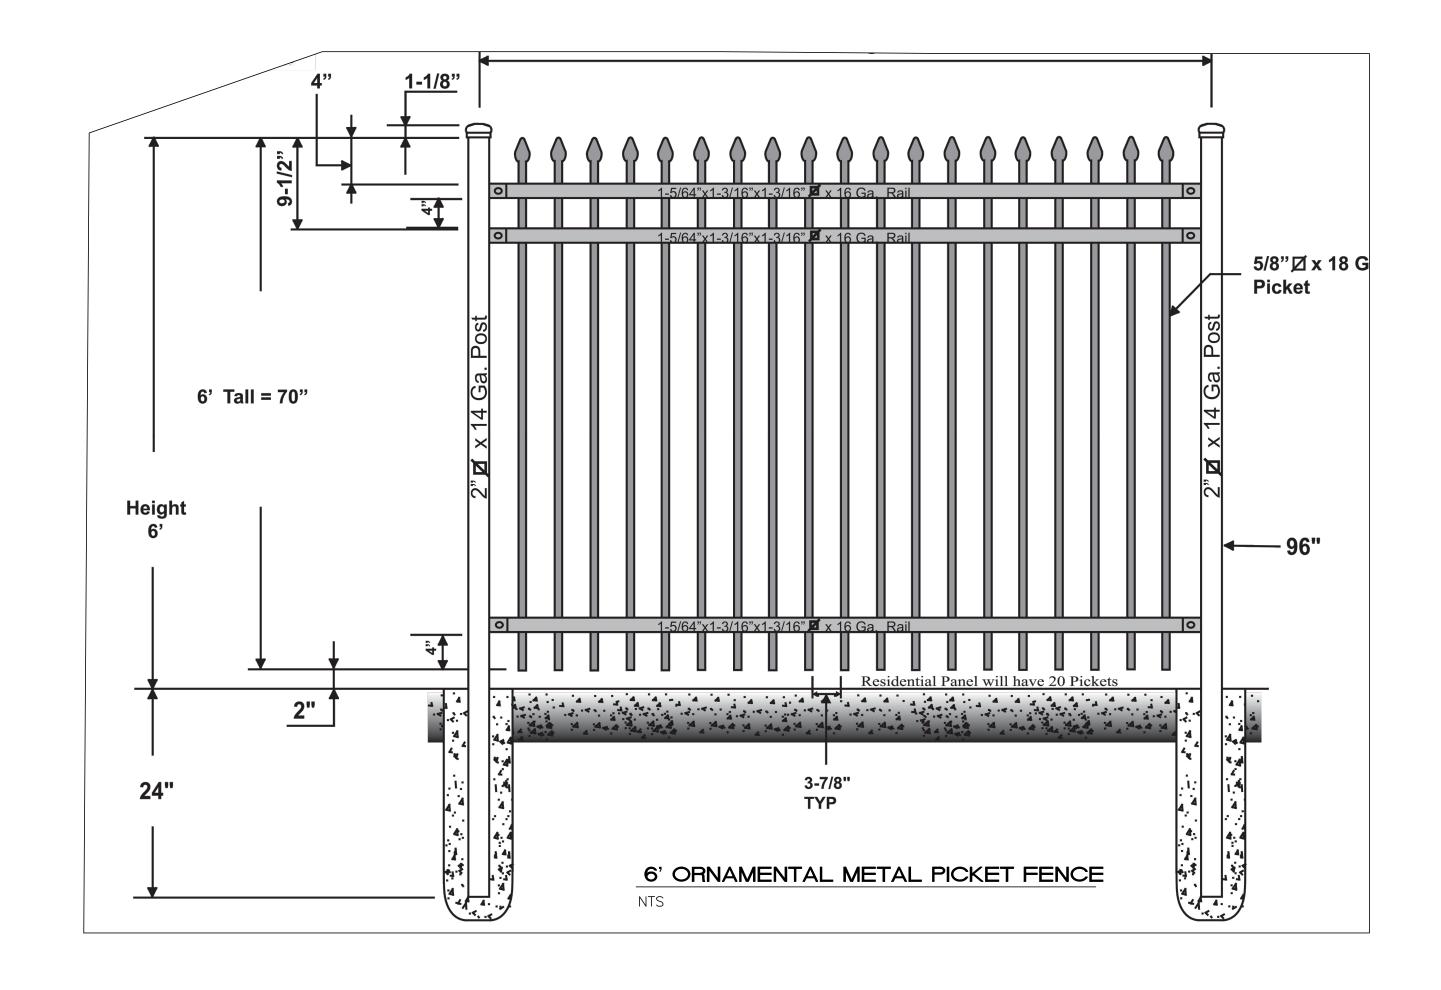

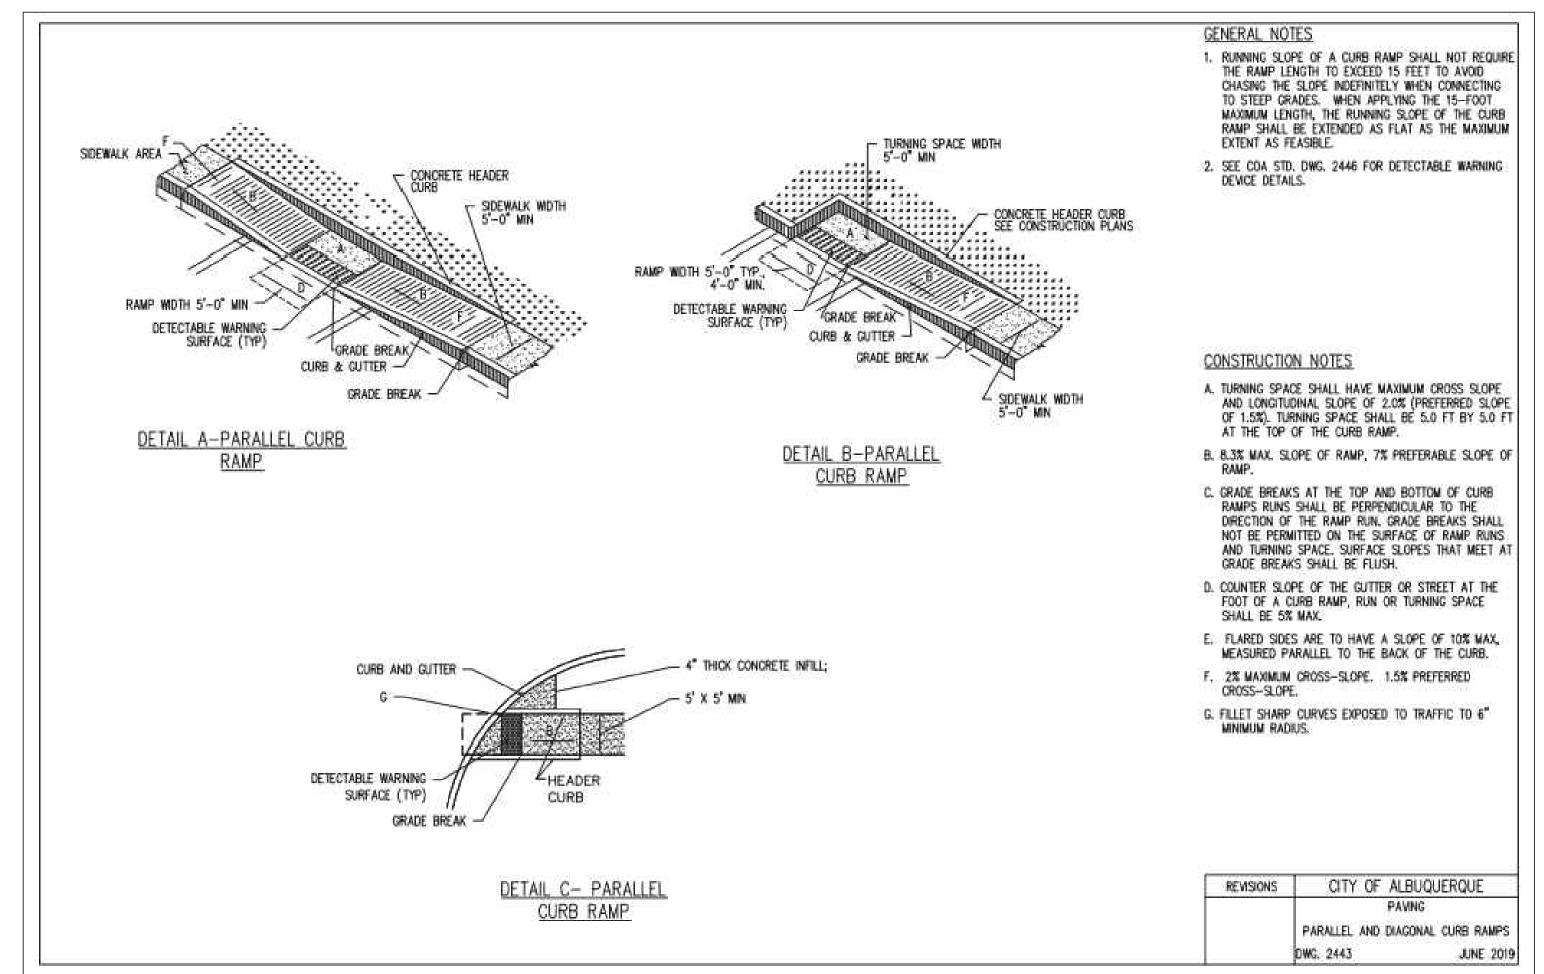

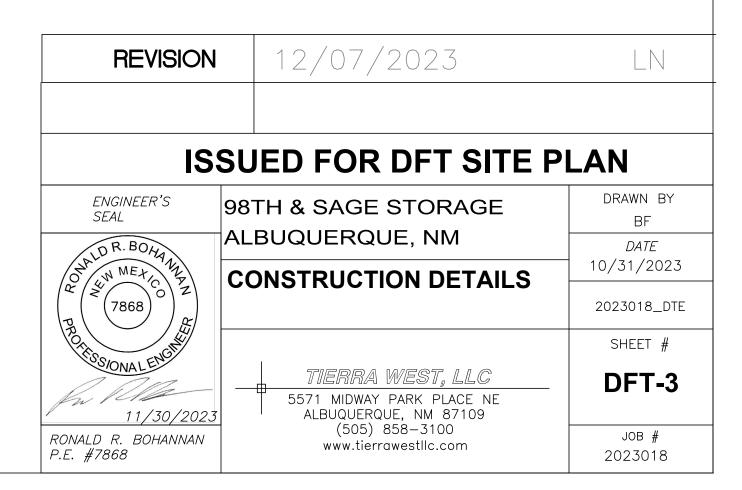

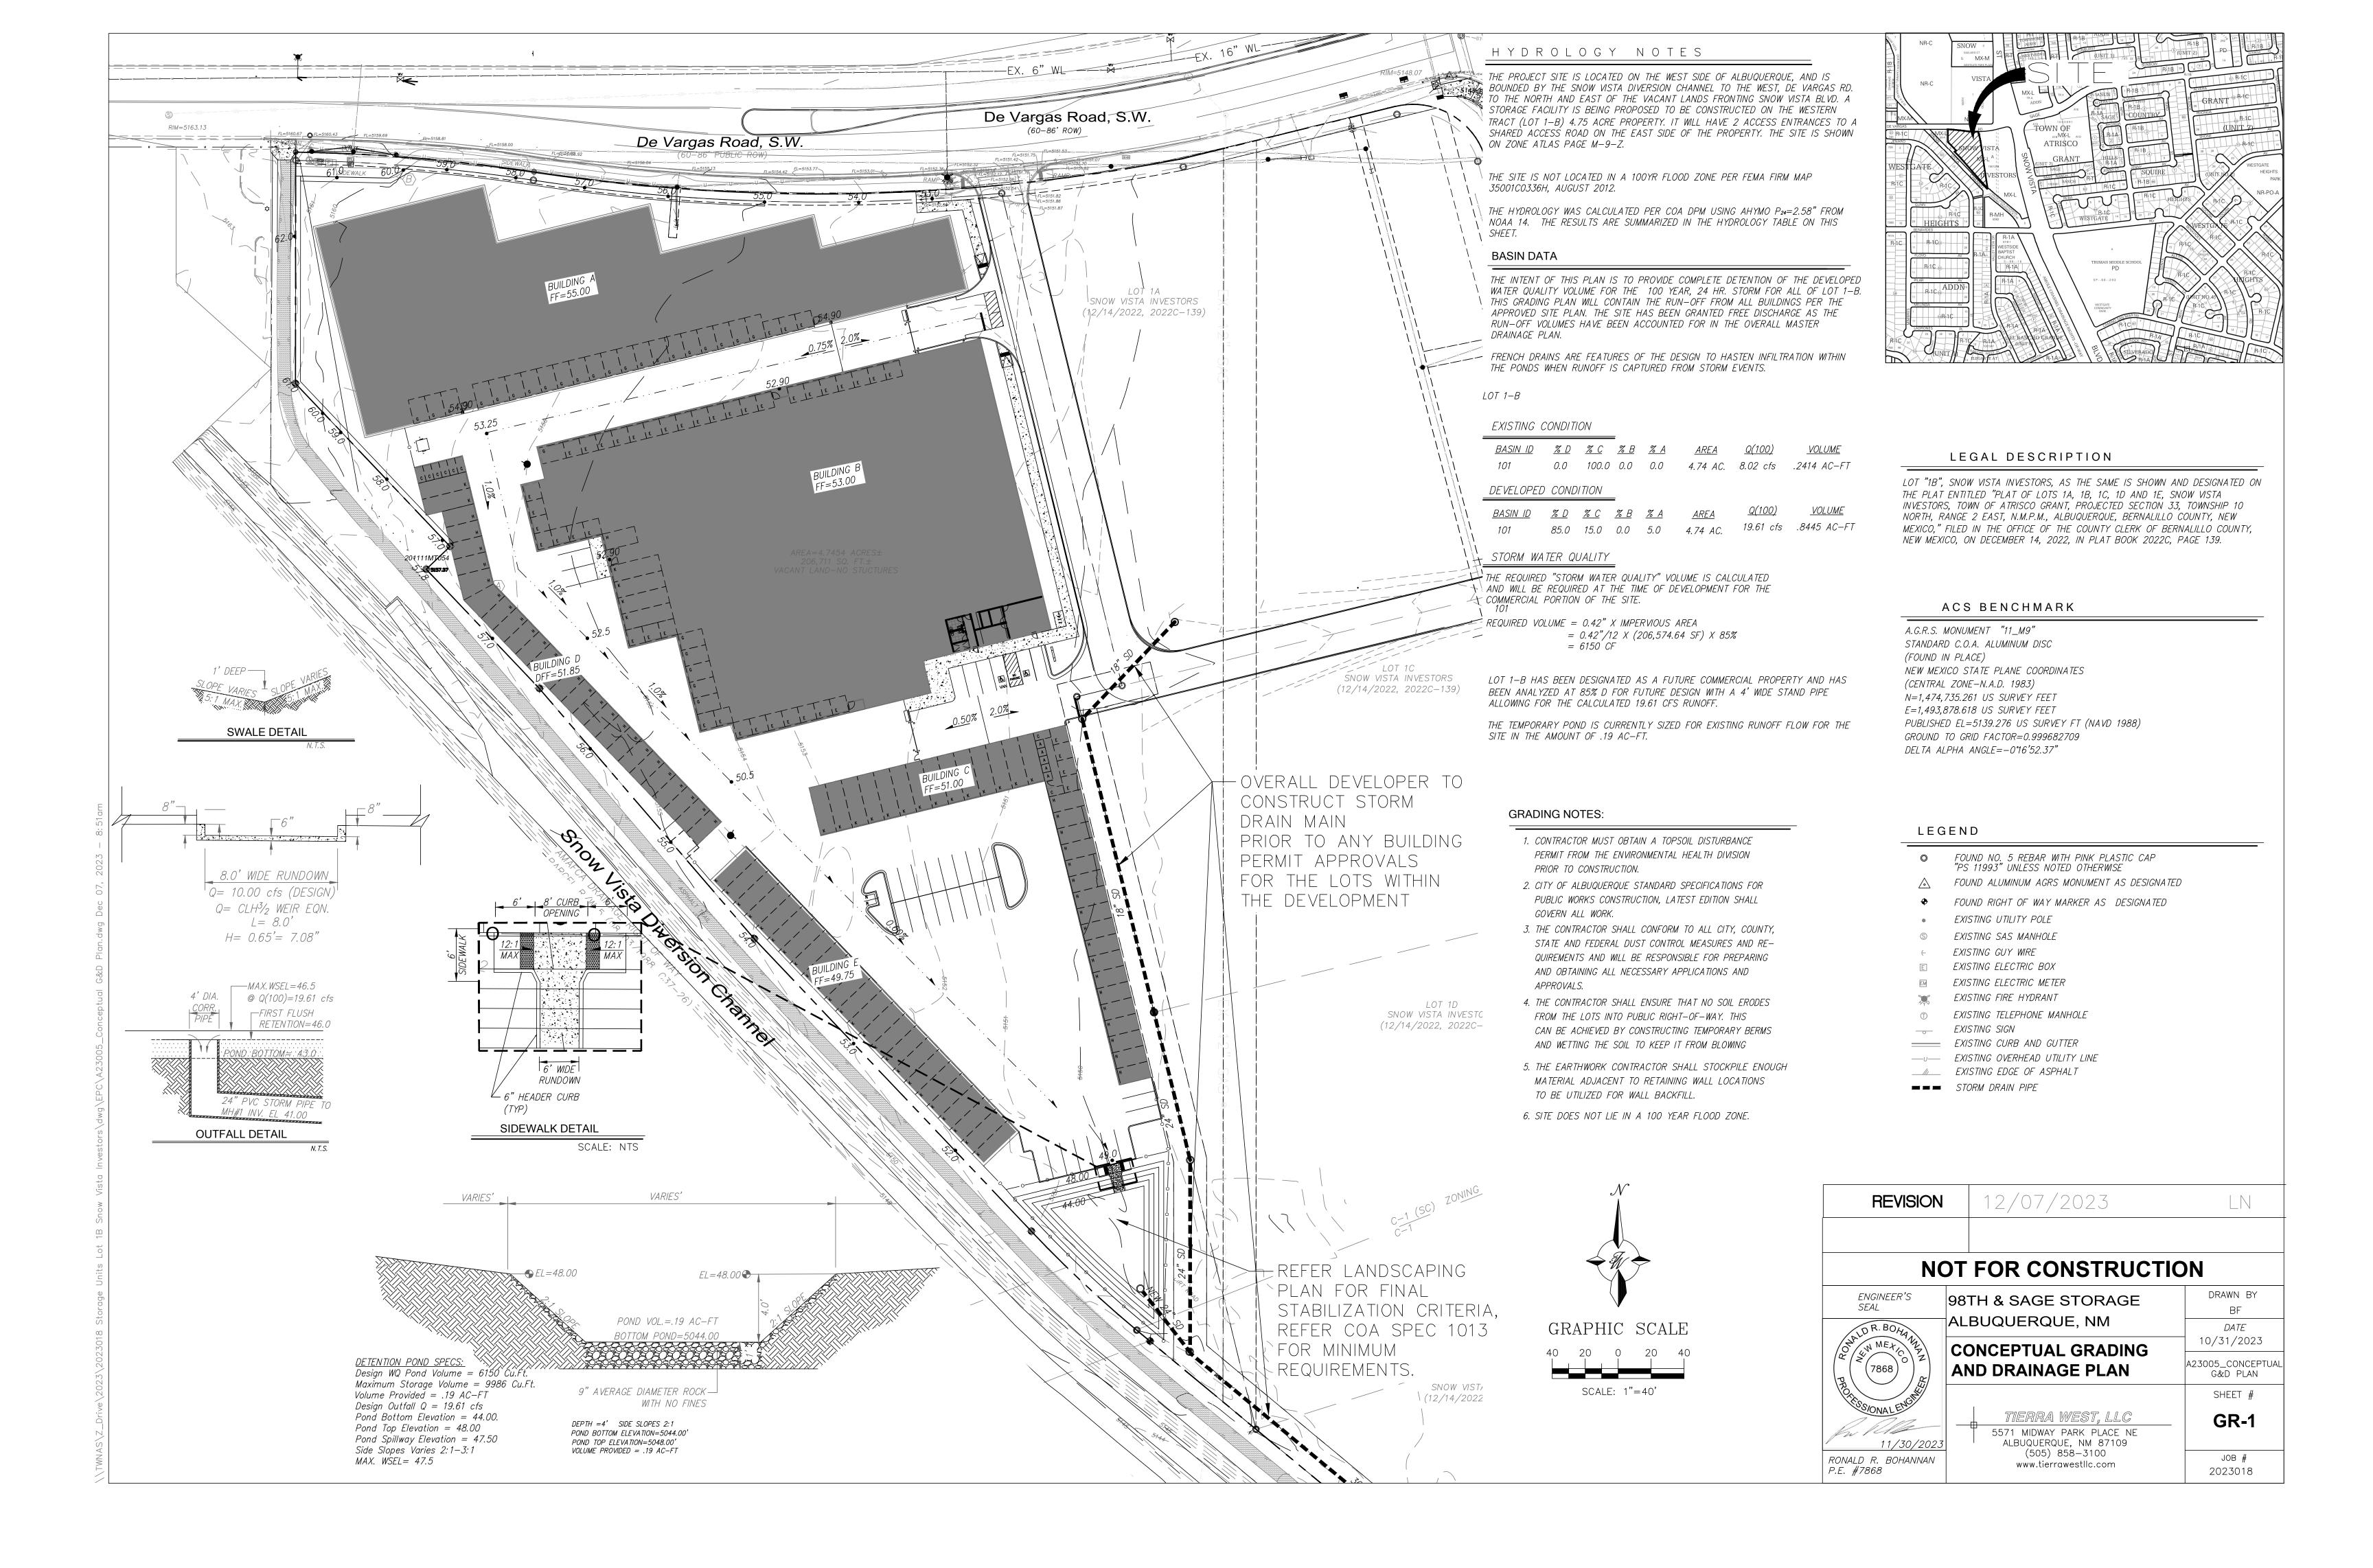

## LEGEND

	CURB & GUTTER			
	BOUNDARY LINE			
	EASEMENT			
	RIGHT-OF-WAY			
	BUILDING			
	SIDEWALK			
	SCREEN WALL			
	RETAINING WALL			
	EXISTING CURB & GUTTER			
	EXISTING BOUNDARY LINE			
36" SD	STORM SEWER LINE			
	PUBLIC SANITARY SEWER LINE			
	PRIVATE SANITARY SEWER LINE			
w w	WATERLINE			
w w	FIRE LINE			
0	SINGLE CLEAN OUT			
$\infty$	DOUBLE CLEAN OUT			
Ď.	EXISTING SD MANHOLE			
	EXISTING INLET			
S	EXISTING SAS MANHOLE			
***	EXISTING FIRE HYDRANT			
wv	EXISTING WATER VALVE			
(W)	EXISTING WATER METER			
•	EXISTING POWER POLE			
@	EXISTING GAS VALVE			
	EXISTING OVERHEAD UTILITIES			
— — —EX. UGE — — —	EXISTING UNDERGROUND UTILITIES			
— — — EX. 2" GAS— — —	EXISTING GAS			
————EX. 8" SAS—————	EXISTING SANITARY SEWER LINE			
— — — EX. 10" WL— — —	EXISTING WATER LINE			
—— · ——EX. 18" RCP———	EXISTING STORM SEWER LINE			

## KEYED NOTES

- 1 PRIVATE 6" SANITARY SEWER LINE
- 2 PRIVATE 4" SAS SERVICE LINE
- (3) CONNECT TO EXISTING PUBLIC SAS MANHOLE
- (4) 1.5" WATER SERVICE LINE AND METER BOX PER ABCWUA.
- (5) PRIVATE 2" DOMESTIC WATER LINE
- 6 PRIVATE 8" FIRE LINE
- 7 PRIVATE 6' FIRE LINE
- 8 PRIVATE FIRE HYDRANT PAINTED ORANGE
- 9 CONNECT TO EXISTING 8" WATER MAIN

#### GENERAL UTILITY NOTES:

- 1. ALL WATER AND SEWER UTILITY WORK TO BE DONE IN ACCORDANCE WITH CITY OF ALBUQUERQUE SPECIFICATIONS FOR PUBLIC UTILITY CONSTRUCTION, 1986 EDITION (UPDATE NO 8) INCLUDING AMENDMENT NO 1.
- 2. REFERENCE ARCHITECTURAL PLANS FOR WATER LINE RISER
- 3. CLEAN OUTS ARE TO BE BUILT PER UNIFORM PLUMBING CODE STANDARDS
- 4. ALL PLUMBING PIPE MATERIAL TO BE USED PER UPC.
- 5. IRRIGATION AND DOMESTIC WATERLINE MUST HAVE BACKFLOW PREVENTORS PER UPC. IF BACKFLOW PREVENTOR IS INSTALLED EXTERIOR OF BUILDING A HOT BOX SHALL BE INSTALLED AND
- 6. ALL EXCAVATION, TRENCHING AND SHORING ACTIVITIES MUST BE CARRIED-OUT IN ACCORDANCE WITH OSHA 29 CFR 1926.650 SUBPART P.
- 7. ALL UTILITY DISTANCES SHOWN ARE FOR REFERENCE ONLY. CALL 811 FOR PUBLIC UTILITIES LOCATES.
- 9. PNM WILL REVIEW ALL TECHNICAL NEEDS, ISSUES AND SAFETY CLEARANCES FOR ITS ELECTRIC POWER SYSTEMS. ANY EXISTING AND PROPOSED PUBLIC UTILITY EASEMENTS SHALL BE INDICATED ON THE SITE PLAN UTILITY SHEET PRIOR TO DRB REVIEW. PNM'S STANDARD FOR PUBLIC UTILITY EASEMENTS IS 10 FEET IN WIDTH TO ENSURE ADEQUATE, SAFE CLEARANCES.


#### **GENERAL UTILITY NOTES:**

- 1. CONTRACTOR MUST COORDINATE WATER SYSTEM WITH SEWER SYSTEM TO PREVENT ANY CONFLICTS WHERE THESE LINES INTERSECT ONE ANOTHER.
- 2. PROVIDE 3 FEET OF COVER MINIMUM FOR ALL PROPOSED WATER LINES.
- 3. AREAS WHERE WATER PIPES CROSS OVER SEWER PIPES SHALL NOT HAVE ANY JOINTS.
- 4. NO FENCES, SIGNS, TREES OR ROCKWALLS TO BE PLACED WITHIN UTILITY EASEMENTS.
- 5. CONTACT UTILITY COMPANIES FOR EXACT LOCATION OF UNDERGROUND UTILITIES IN THIS AREA BEFORE EXCAVATION.
- 6. INSTALL A TRENCH SAFETY SYSTEM TO PROVIDE FOR THE SAFE EXCAVATION OF ALL TRENCHES EXCEEDING A DEPTH OF (5') FEET AS PER O.S.H.A. STANDARDS.
- 7. PROVIDE ADEQUATE CONCRETE THRUST BLOCKING AT THE FOLLOWING: TAPPING SLEEVES, TEES, BENDS, PLUGS AND ALL FITTINGS. REFER TO ABCWUA STANDARD DETAIL DRAWING 2320
- 8. P.V.C. PIPE SHALL BE PLACED WITH SELECT BEDDING MATERIAL ALL AROUND.
- 9. CAUTION: VERIFY LOCATION & DEPTH OF EXISTING GAS MAIN IN THE AREA OF CONSTRUCTION, BEFORE INSTALLING WATER LINE.
- 10. CONTRACTOR TO ADJUST WATER VALVES TO FINAL GRADE WHERE NECESSARY.


## ABCWUA NOTES:

COORDINATION WITH WATER AUTHORITY CROSS CONNECTION SECTION WILL BE REQUIRED TO ENSURE PROPER BACKFLOW CONTAINMENT IS IN PLACE PRIOR TO RELEASE OF METER FOR THE SITE. CONTACT THE CROSS CONNECTION SECTION AT 505-289-3454.

COORDINATION WITH THE WATER AUTHORITY PRE—TREATMENT ENGINEER IS REQUIRED TO ENSURE THE SITE COMPLIES WITH WATER AUTHORITY SEWER USE ORDINANCE. CONTACT THE PRE—TREATMENT ENGINEER AT 505—289—3439.

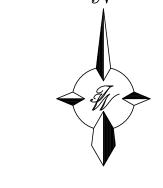

GRAPHIC SCALE

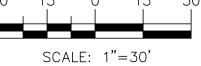

## CAUTION:

ALL EXISTING UTILITIES SHOWN WERE OBTAINED FROM RESEARCH, AS-BUILTS, SURVEYS OR INFORMATION PROVIDED BY OTHERS. IT SHALL BE THE SOLE RESPONSIBILITY OF THE CONTRACTOR TO CONDUCT ALL NECESSARY FIELD INVESTIGATIONS PRIOR TO AND INCLUDING ANY EXCAVATION, TO DETERMINE THE ACTUAL LOCATION OF UTILITIES AND OTHER IMPROVEMENTS, PRIOR TO STARTING THE WORK. ANY CHANGES FROM THIS PLAN SHALL BE COORDINATED WITH AND APPROVED BY THE ENGINEER.

NOT FOR CONSTRUCTION

12/07/2023

DRAWN BY

*DATE* 10/31/2023

2023018\_MUB

SHEET #

MU-1

JOB #

2023018

# 98TH & SAGE STORAGE ALBUQUERQUE, NM

R. BOHANNAN

ALE

CO

TRONALD R. BOHANNAN


P.E. #7868

**REVISION** 

CONCEPT UTILITY PLAN

TIERRA WEST, LLC


5571 MIDWAY PARK PLACE NE
ALBUQUERQUE, NM 87109
(505) 858-3100
www.tierrawestllc.com

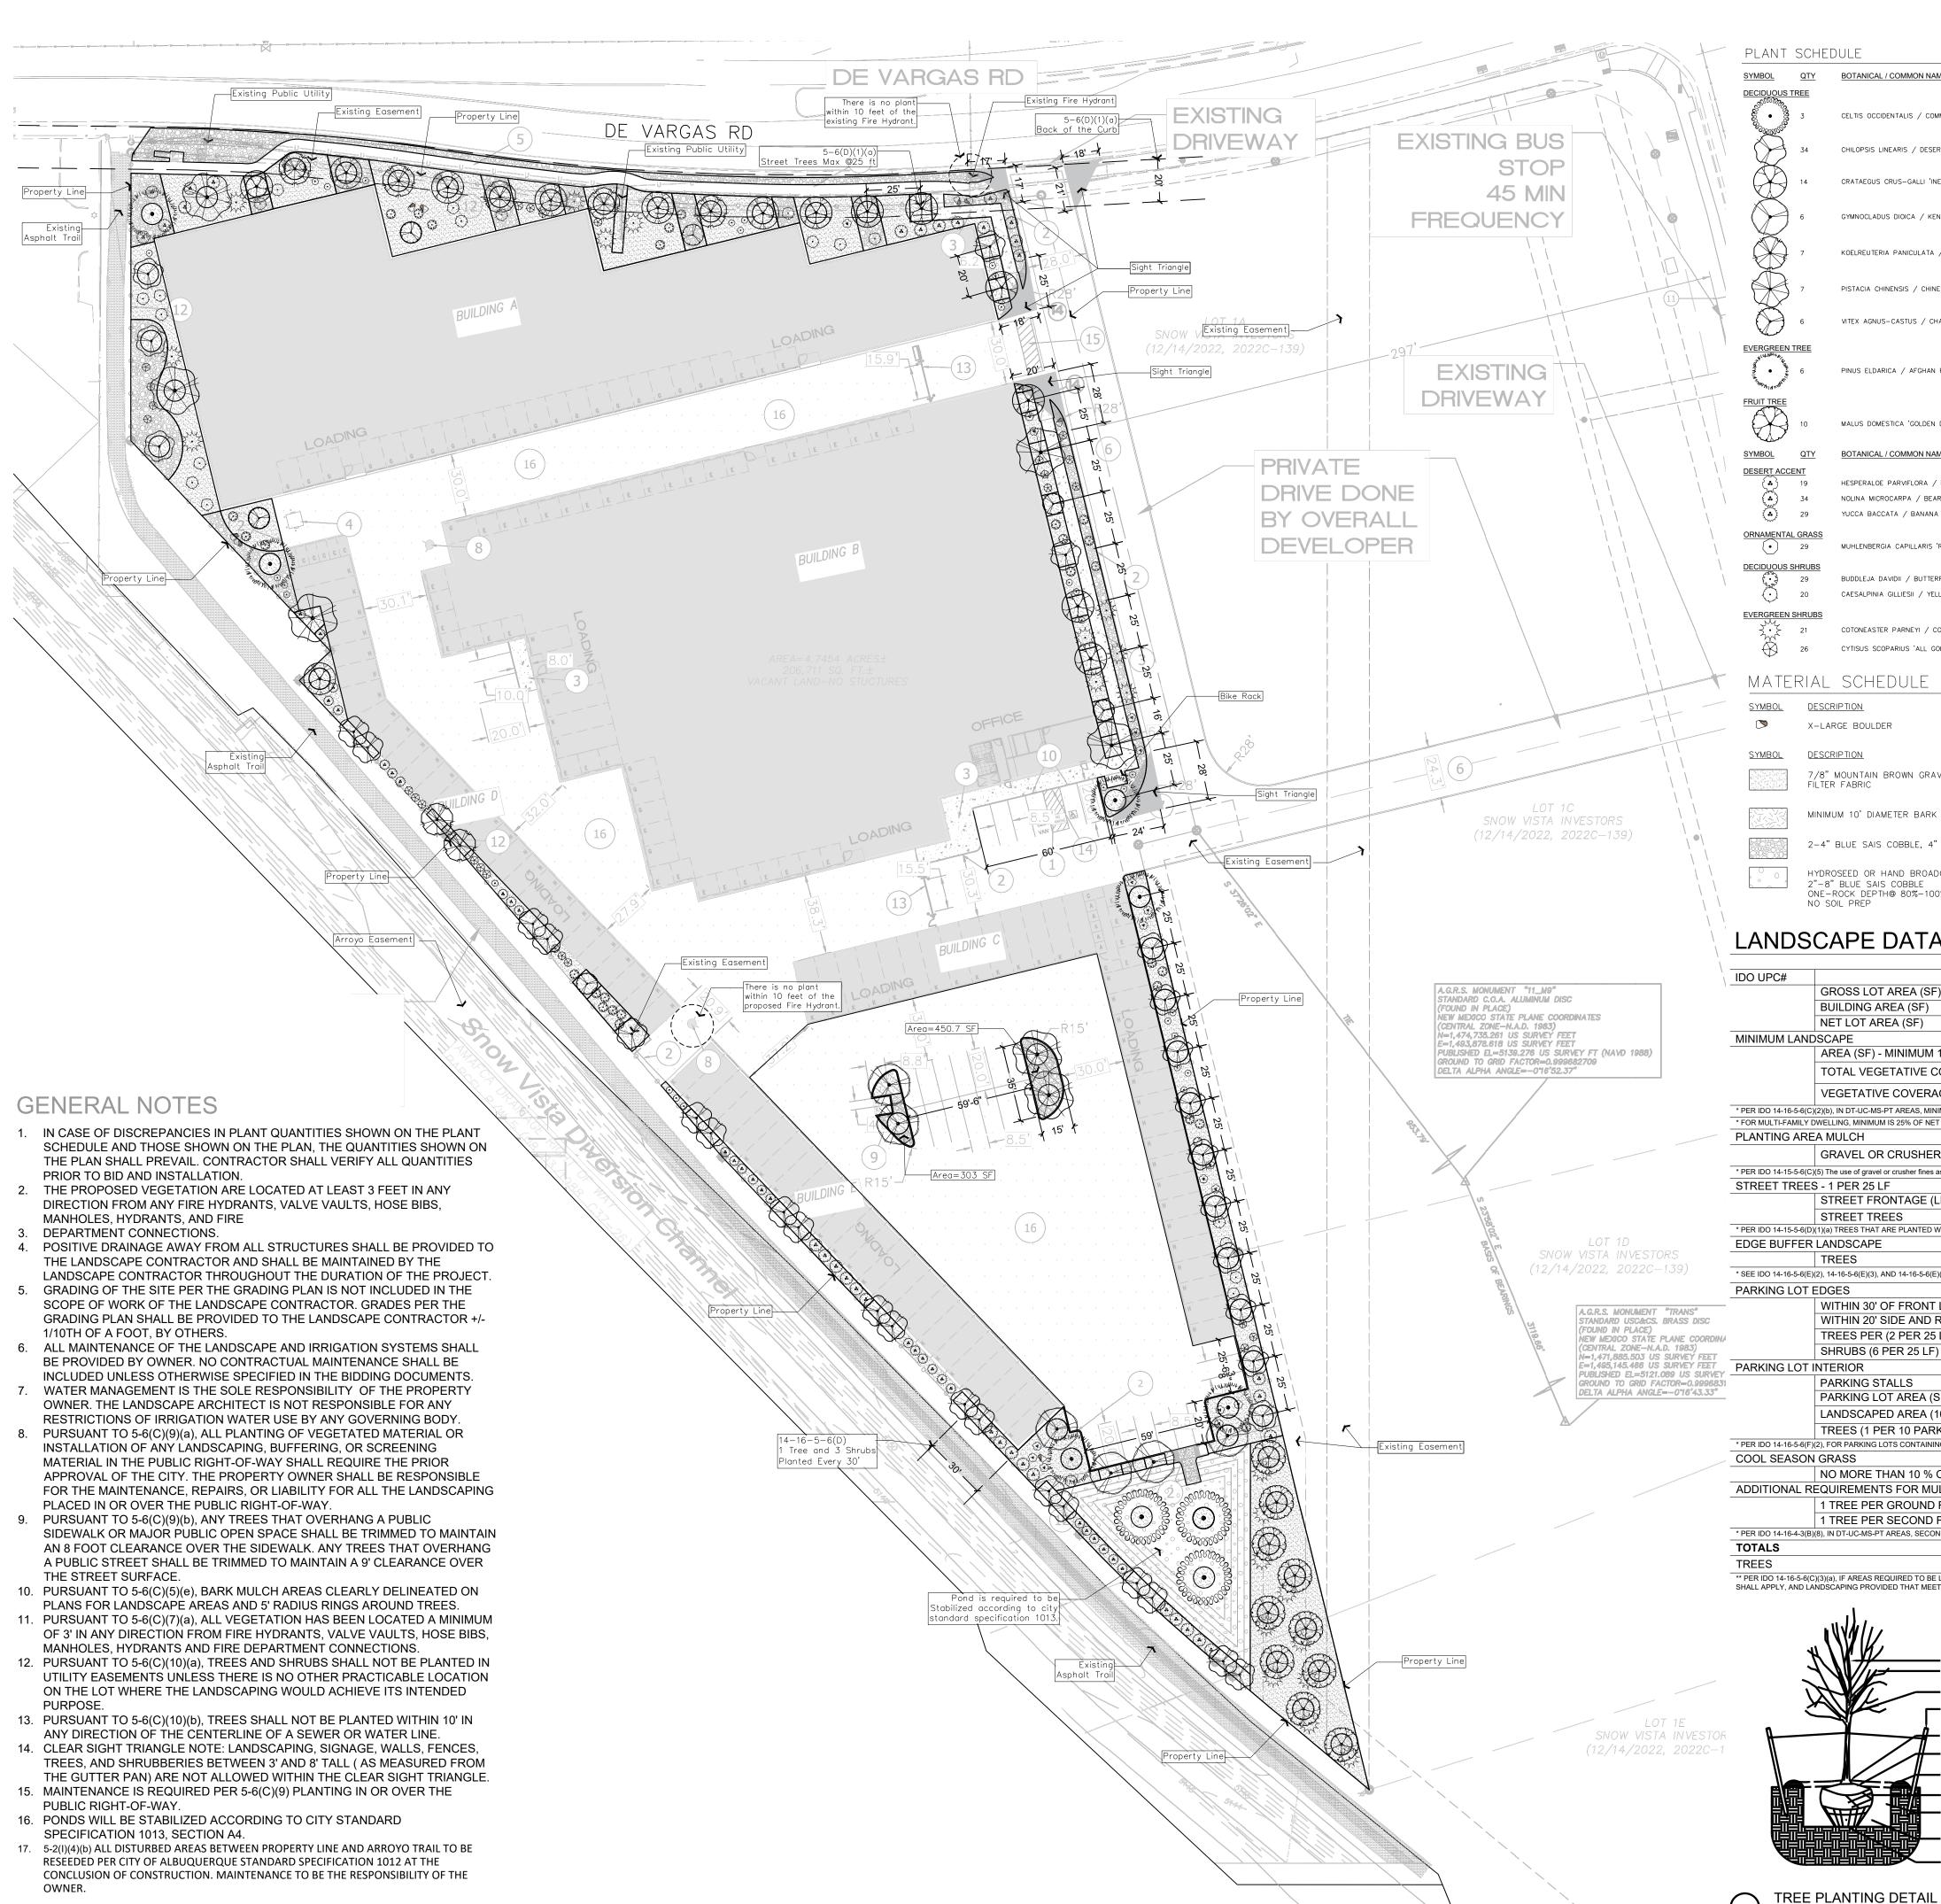


PLANT	SCHEE	JULE			2023-12	2-06 10:30	LEGEND
SYMBOL	QTY	BOTANICAL / COMMON NAME	SIZE	WATER	POINT	<u>H X W</u>	CURB & GUTTER
DECIDUOUS	TREE						BOUNDARY LINE
Section of the sectio	3	CELTIS OCCIDENTALIS / COMMON HACKBERRY	2" B&B	MEDIUM	35	40' X 40'	EASEMENT
S	3	SEE TO COOKE THE OWN THE SEE T	2 50.5		00	40 X 40	
	34	CHILOPSIS LINEARIS / DESERT WILLOW	25 GAL	RW	45	20' X 25'	BUILDING
$\mathcal{L}$	54	CHECK 313 EINEANS / DESERT MILEON	25 GAL	IX W	45	20 / 25	SIDEWALK
	14	CRATAEGUS CRUS-GALLI 'INERMIS' / THORNLESS HAWTHORN	2" B&B	MEDIUM	35	25' X 20'	SCREEN WALL
	17	CHAIREOUS CHOS CALE MENNIS / HIGHWEESS HAWHIGH	2 00.0	WIEDIOW	55	23 % 20	RETAINING WALL
		044400440400044444444444444444444444444					— — — EXISTING CURB & GUTTER
	6	GYMNOCLADUS DIOICA / KENTUCKY COFFEE TREE	2" B&B	MEDIUM	35	40' X 30'	EXISTING BOUNDARY LINE
~ ~ ~ ~ ~ ~ ~ ~ ~ ~ ~ ~ ~ ~ ~ ~ ~ ~ ~							
1	7	KOELREUTERIA PANICULATA / GOLDEN RAIN TREE	2" B&B	MEDIUM	40	30' X 30'	—s—s—s— PUBLIC SANITARY SEWER LINE
							—s—s—s— PRIVATE SANITARY SEWER LINE
	7	PISTACIA CHINENSIS / CHINESE PISTACHE	2" B&B	MEDIUM	45	60' X 60'	── v ── v ── WATERLINE
							── v ── v ── FIRE LINE
	6	VITEX AGNUS-CASTUS / CHASTE TREE	24"BOX	MEDIUM	35	20' X 20'	O SINGLE CLEAN OUT
مرکمیسم							∞ DOUBLE CLEAN OUT
EVERGREEN	TREE						EXISTING SD MANHOLE
· I Whate	6	PINUS ELDARICA / AFGHAN PINE	6'	MEDIUM	35	40' X 25'	EXISTING INLET
The Market							EXISTING SAS MANHOLE
FRUIT TREE							EXISTING FIRE HYDRANT
	10	MALUS DOMESTICA 'GOLDEN DELICIOUS' / GOLDEN DELICIOUS APPLE	1 1/2" B&B	MEDIUM +		20' X 25'	DA EXISTING WATER VALVE
	10	miles bomes now details believes y details believes in the	1 1/2 505	WIEDIOW		20 / 25	EXISTING WATER METER
SYMBOL	QTY	BOTANICAL / COMMON NAME	SIZE	WATER	HXW	HXW	EXISTING POWER POLE
DESERT ACC							© EXISTING GAS VALVE
<u>.</u>	19	HESPERALOE PARVIFLORA / RED YUCCA	5 GAL	LOW+	20	3' X 4'	EXISTING OVERHEAD UTILITIES
( <u>.</u> )	34	NOLINA MICROCARPA / BEARGRASS	5 GAL	RW	30	5' × 6'	EX. UGE EXISTING UNDERGROUND UTILITIES
•	29	YUCCA BACCATA / BANANA YUCCA	5 GAL	RW	30	4' X 5'	EX. 2" GAS
ORNAMENTA	L GRASS						
$\odot$	29	MUHLENBERGIA CAPILLARIS 'REGAL MIST' TM / MUHLY	1 GAL	MEDIUM	12	3' × 3'	
DECIDUOUS	SHRUBS						EXISTING STORM SEWER LINE
E	29	BUDDLEJA DAVIDII / BUTTERFLY BUSH	5 GAL	MEDIUM	20	4' X 4'	
$\odot$	20	CAESALPINIA GILLIESII / YELLOW BIRD OF PARADISE	5 GAL	RW	40	10' X 10'	KEYED NOTES
EVERGREEN	SHRUBS						1 PRIVATE 6' SANITARY SEWER LINE
3c	21	COTONEASTER PARNEYI / COTONEASTER	5 GAL	MEDIUM	30	10' X 15'	2) PRIVATE 4" SAS SERVICE LINE
Ã	26	CYTISUS SCOPARIUS 'ALL GOLD' / SCOTCH BROOM	5 GAL	MEDIUM	30	4' × 6'	(3) CONNECT TO EXISTING PUBLIC SAS MANHOLE
4							
MATE	RIAL	SCHEDULE					(4) 1.5" WATER SERVICE LINE AND METER BOX PER ABCWU
			0.737				5 PRIVATE 2" DOMESTIC WATER LINE
SYMBOL -		<u>RIPTION</u>	QTY				6 PRIVATE 8" FIRE LINE
	X-LAF	RGE BOULDER	10				7) PRIVATE 6' FIRE LINE
SYMBOL	DESCR	RIPTION_	<u>QTY</u>				
				_			(8) PRIVATE FIRE HYDRANT PAINTED ORANGE
		MOUNTAIN BROWN GRAVEL MULCH, 3" DEPTH OVER R FABRIC	19,488 SF	-			(9) CONNECT TO EXISTING 8" WATER MAIN
逐激	MINIMU	UM 10' DIAMETER BARK MULCH UNDER TREES	6,926 SF				
	2-4"	2-4" BLUE SAIS COBBLE, 4" DEPTH OVER FILTER FABRIC					
	2"-8" ONE-f	OSEED OR HAND BROADCAST SEED 'BLUE SAIS COBBLE ROCK DEPTH@ 80%—100% COVERAGE DIL PREP	4,830 SF				

## LANDSCAPE DATA

		ZONING DESIGN	NATION		
IDO UPC#		NR-C			
	GROSS LOT AREA (SF)	206,709 103,591 103,118			
	BUILDING AREA (SF)				
	NET LOT AREA (SF)				
MINIMUM LAN	IDSCAPE	REQUIRED	PROVIDED		
	AREA (SF) - MINIMUM 15 % OF NET LOT AREA*	15,468	38,023	37%	
	TOTAL VEGETATIVE COVERAGE (SF) @ PLANT MATURITY (75% OF LANDSCAPE AREA)	11,601	64,291	416%	
	VEGETATIVE COVERAGE (SF) OF GROUND-LEVEL PLANTS (25% OF TOTAL, MINIMUM)	2,900	5,765	50%	
	(C)(2)(b), IN DT-UC-MS-PT AREAS, MINIMUM IS 10% OF NET LOT AREA.		<u> </u>		
	Y DWELLING, MINIMUM IS 25% OF NET LOT AREA. SEE 14-16-4-3(B)(8) FOR DETAILS.				
PLANTING AR	REA MULCH	REQUIRED	PROVIDED		
	GRAVEL OR CRUSHER FINES (SF)	MAX. 75%	26,479	69%	
* PER IDO 14-15-5-6(	(C)(5) The use of gravel or crusher fines as ground cover is limited to a maximum 50 percent in DT-UC-MS areas.				
STREET TREE	ES - 1 PER 25 LF	REQUIRED	PROVIDED		
	STREET FRONTAGE (LF)	-	374		
	STREET TREES	15	15		
* PER IDO 14-15-5-6(	D)(1)(a) TREES THAT ARE PLANTED WITHIN 20 FEET OF THE BACK OF CURB OF THE ABUTTING STREET MAY FULFILL THIS REQUIREMENT.				
EDGE BUFFER LANDSCAPE		REQUIRED	PROVIDED		
	TREES				
* SEE IDO 14-16-5-6(	E)(2), 14-16-5-6(E)(3), AND 14-16-5-6(E)(4) FOR COMPLETE EDGE BUFFER STANDARDS.				
PARKING LOT	TEDGES				
	WITHIN 30' OF FRONT LOT LINE - CONTINUOUS 3' HT EVERGREEN SHRUBS	-	-		
	WITHIN 20' SIDE AND REAR LOT EDGES (LF)	-	-		
	TREES PER (2 PER 25 LF)	-	-		
	SHRUBS (6 PER 25 LF)	-	-		
PARKING LOT	INTERIOR	REQUIRED	PROVIDED		
	PARKING STALLS	-	34		
	PARKING LOT AREA (SF)	27349.7			
	LANDSCAPED AREA (10% OF PARKING LOT AREA)*	2,735	2897		
	TREES (1 PER 10 PARKING SPACES)	3.4	11		
* PER IDO 14-16-5-6(	(F)(2), FOR PARKING LOTS CONTAINING 50 OR FEWER SPACES, MINIMUM IS 10% OF PARKING LOT AREA.				
COOL SEASO	N GRASS	REQUIRED	PROVIDED		
	NO MORE THAN 10 % OF REQUIRED LANDSCAPE AREA	-	-	##	
ADDITIONAL	REQUIREMENTS FOR MULTI-FAMILY DWELLING	REQUIRED	PROVIDED		
	1 TREE PER GROUND FLOOR DWELLING UNIT				
	1 TREE PER SECOND FLOOR DWELLING UNIT*				
* PER IDO 14-16-4-3(	(B)(8), IN DT-UC-MS-PT AREAS, SECOND FLOOR DWELLING UNIT TREES ARE NOT REQUIRED.			-	
TOTALS		REQUIRED	PROVIDED		
TREES			93		

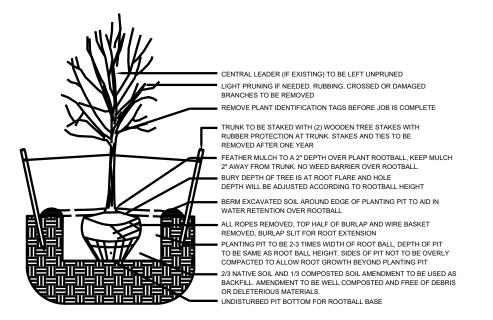


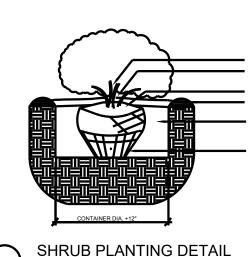

REMOVE PLANT IDENTIFICATION TAGS BEFORE JOB IS COMPLETE FEATHER MULCH TO A 2" DEPTH OVER PLANT ROOTBALL, KEEP MULCH 2" AWAY FROM CENTER OF SHRUB. NO WEED BARRIER OVER ROOTBAL SET SHRUB ON UNDISTURBED PIT BOTTOM PLUMB AND STRAIGHT BERM REMOVED SOIL AT EDGE OF PLANTING PIT TO AID IN
WATER RETENTION OVER ROOTBALL 2/3 NATIVE SOIL AND 1/3 COMPOSTED SOIL AMENDMENT TO BE USED AS BACKFILL. AMENDMENT TO BE WELL COMPOSTED AND FREE OF DEBRIS OR DELETERIOUS MATERIALS. IF EXCESSIVE ROOTS ARE PRESENT ON ROOTBALL SCORE THE SIDES OF ROOTBALL TO DISCOURAGE ROOT CIRCLING

YELLOWSTONE


www.yellowstonelandscape.com PO Box 10597 Albuquerque, NM 87184 505.898.9615 design@yellowstonelandscape.com

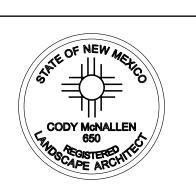


Date: 10.29.2023 Revisions: 12.06.2023

Drawn by: FB

Reviewed by: CM, MH

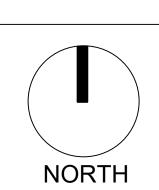

Scale: 1"=40'

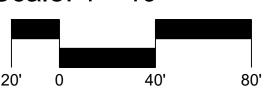

**Sheet Title:** 

Planting Plan

Sheet Number:



# **IRRIGATION LEGEND**

Item / Description Manufacturer / Model Rainbird ESP-Me Controller Controller -confirm location in field Rain/Freeze Sensor Ball Valve Spears Ball Valve -assumed point of connection Reduced Pressure Backflow Febco 825Y Preventer/Master Valve Rainbird PEB AEP 1320 Assembly in Valve Box Hunter Rainbird PEB Automatic Drip Valve with pressure regulating filter Rainbird PRF-100-RBY AEP 1320 Hunter Poly Drip Line w / Flush Cap 6 emitters per tree Agrifim TAE 2 emitters per shrub 1 emitter per perennial PVC Masterline Sch 40 18" depth bury **PVC Sleeve** Class 200 Valve Sequence

# **IRRIGATION NOTES**

GPM

Drip

Valve Size

- 1. THE LANDSCAPE CONTRACTOR SHALL FURNISH LABOR, MATERIALS AND EQUIPMENT TO INSTALL PROPOSED IRRIGATION SYSTEM AS SHOWN PER PLAN AND DETAILS.
- 2. IF ANY ERRORS OR DISCREPANCIES APPEAR ON THE PLAN, THEY MUST BE BROUGHT TO THE ATTENTION OF THE LANDSCAPE ARCHITECT BEFORE CONSTRUCTION OF THE IRRIGATION SYSTEM BEGINS.
- 3. LANDSCAPE INSTALLER SHALL PERFORM PRESSURE/GPM TEST AT POINT OF CONNECTION BEFORE INSTALLING IRRIGATION SYSTEM TO VERIFY PSI AND GPM FOR THE SITE.
- 4. IRRIGATION SYSTEM HAS BEEN DESIGNED TO A MINIMUM DYNAMIC PRESSURE OF 75 PSI AT 50 GPM. IF THE PSI/GPM ARE LOWER THAN 75/50 THE LANDSCAPE ARCHITECT MUST BE NOTIFIED IMMEDIATELY.
- 5. THE CONTRACTOR SHALL FIELD VERIFY UTILITY LOCATIONS AND MAKE ANY NECESSARY FIELD ADJUSTMENTS WITH GENERAL CONTRACTOR.
- 6. THE LOCATION OF IRRIGATION EQUIPMENT IS APPROXIMATE AND SHALL BE LOCATED IN THE LANDSCAPE AREAS. ANY IRRIGATION EQUIPMENT AND PIPING SHOWN OUTSIDE OF LANDSCAPE AREAS ARE FOR GRAPHIC CLARITY ONLY.
- 7. THE LANDSCAPE CONTRACTOR SHALL PROVIDE TO OWNER AN ACCURATE AS-BUILT IRRIGATION PLAN WHEN THE WORK IS COMPLETED. AS-BUILT DOCUMENTS SHOULD BE UPDATED WEEKLY FOR ACCURATE RECORDING OF IRRIGATION SYSTEM.
- 8. VALVE LOCATIONS TO BE APPROVED BY LANDSCAPE ARCHITECT. VALVE BOX LIDS TO BE TAN IN GRAVEL AREAS AND GREEN IN SOD/SEED AREAS.
- 9. ALL PLANTS WITHIN THE PROPERTY LINE SHALL BE IRRIGATED BY LOW FLOW POINT-SOURCE DRIP IRRIGATION SYSTEM.
- 10. ALL PLANTS WITHIN PUBLIC RIGHT-OF-WAY SHALL BE IRRIGATED BY BUBBLER IRRIGATION SYSTEM PER COA SPEC. ALL PLANTS WITHIN THE PUBLIC RIGHT-OF-WAY SHALL BE ZONED SEPARATELY FROM THE PLANTS WITHIN THE PROPERTY LINE.
- 11. POWER FOR IRRIGATION SYSTEM TO BE PROVIDED BY THE GENERAL CONTRACTOR. 110V POWER IS REQUIRED AT THE LOCATIONS OF THE IRRIGATION CONTROLLER AND BACKFLOW PREVENTER.
- 12. BACKFLOW PREVENTER MUST BE TESTED AND CERTIFIED BEFORE FINAL ACCEPTANCE OF THE JOB.
- 13. CONTROLLER LOCATION IS APPROXIMATE AND THE FINAL LOCATION WILL BE DETERMINED IN THE FIELD.
- 14. SLEEVES TO BE INSTALLED, AS SHOWN PER PLAN, BEFORE HARDSCAPE IS INSTALLED. THE LANDSCAPE CONTRACTOR MUST BE GIVEN A MINIMUM OF 72 HOUR NOTICE BEFORE SLEEVE LOCATIONS ARE PAVED OVER.
- 15. WATER METER TO BE PROVIDED BY OTHERS.



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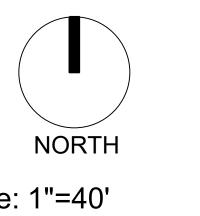
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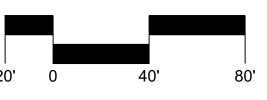
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Albuquerqu

Snow Vista Self Storage



Scale: 1"=40'



Sheet Title:

Irrigation Plan

Sheet Number:

LI-01