




DRAWN BY	BG
REVIEWED BY	MB
DATE	1/29/21
PROJECT NO.	19-0099.003
DRAWING NAME	

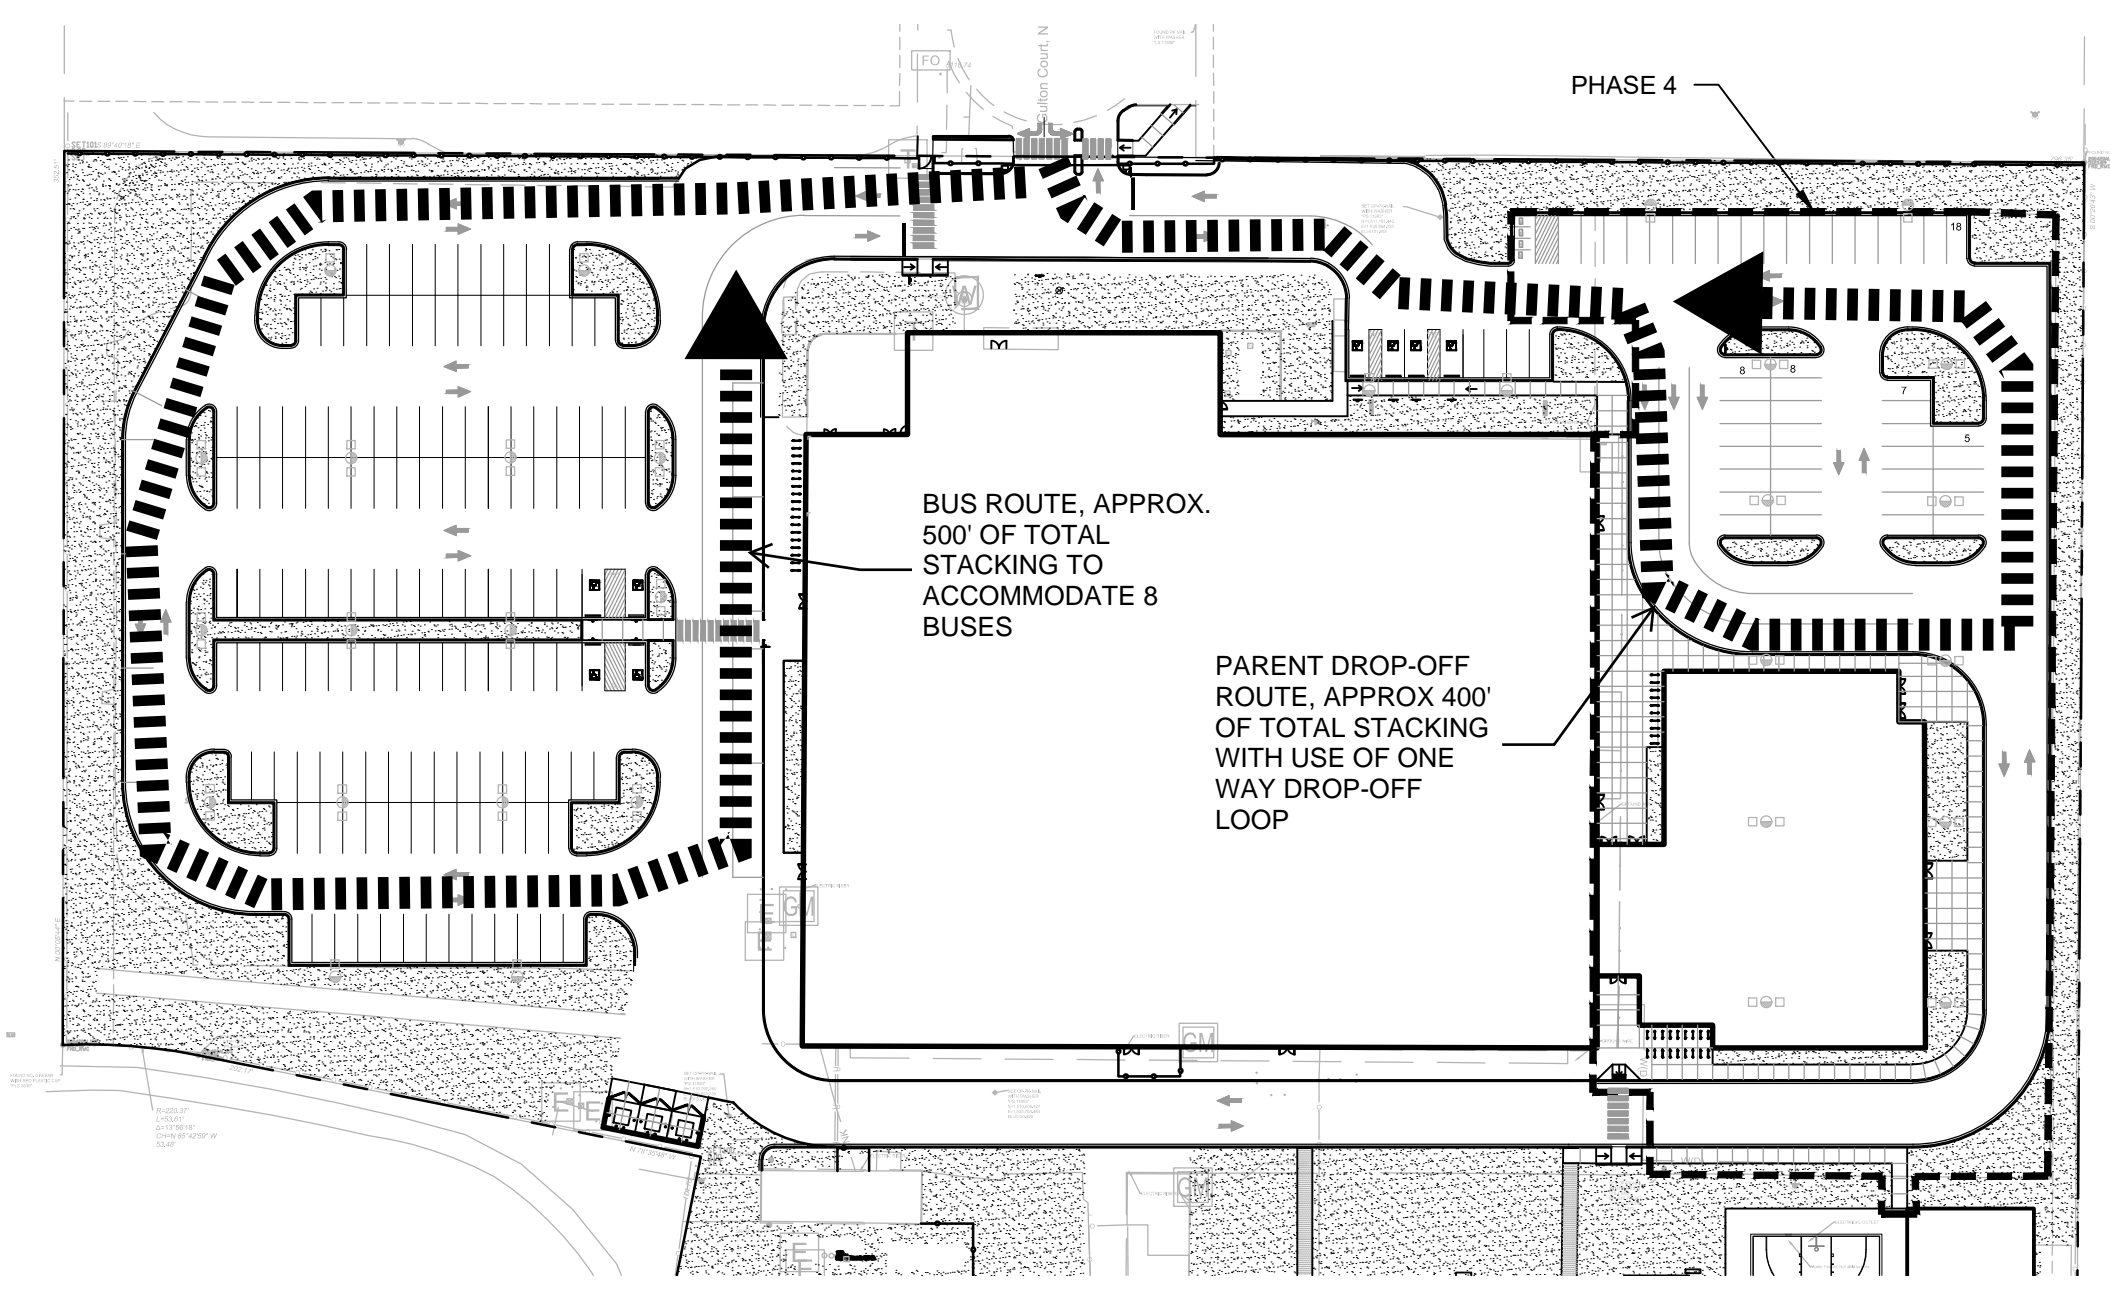


C4 PH4 CIRCULATION DIAGRAM
NTS

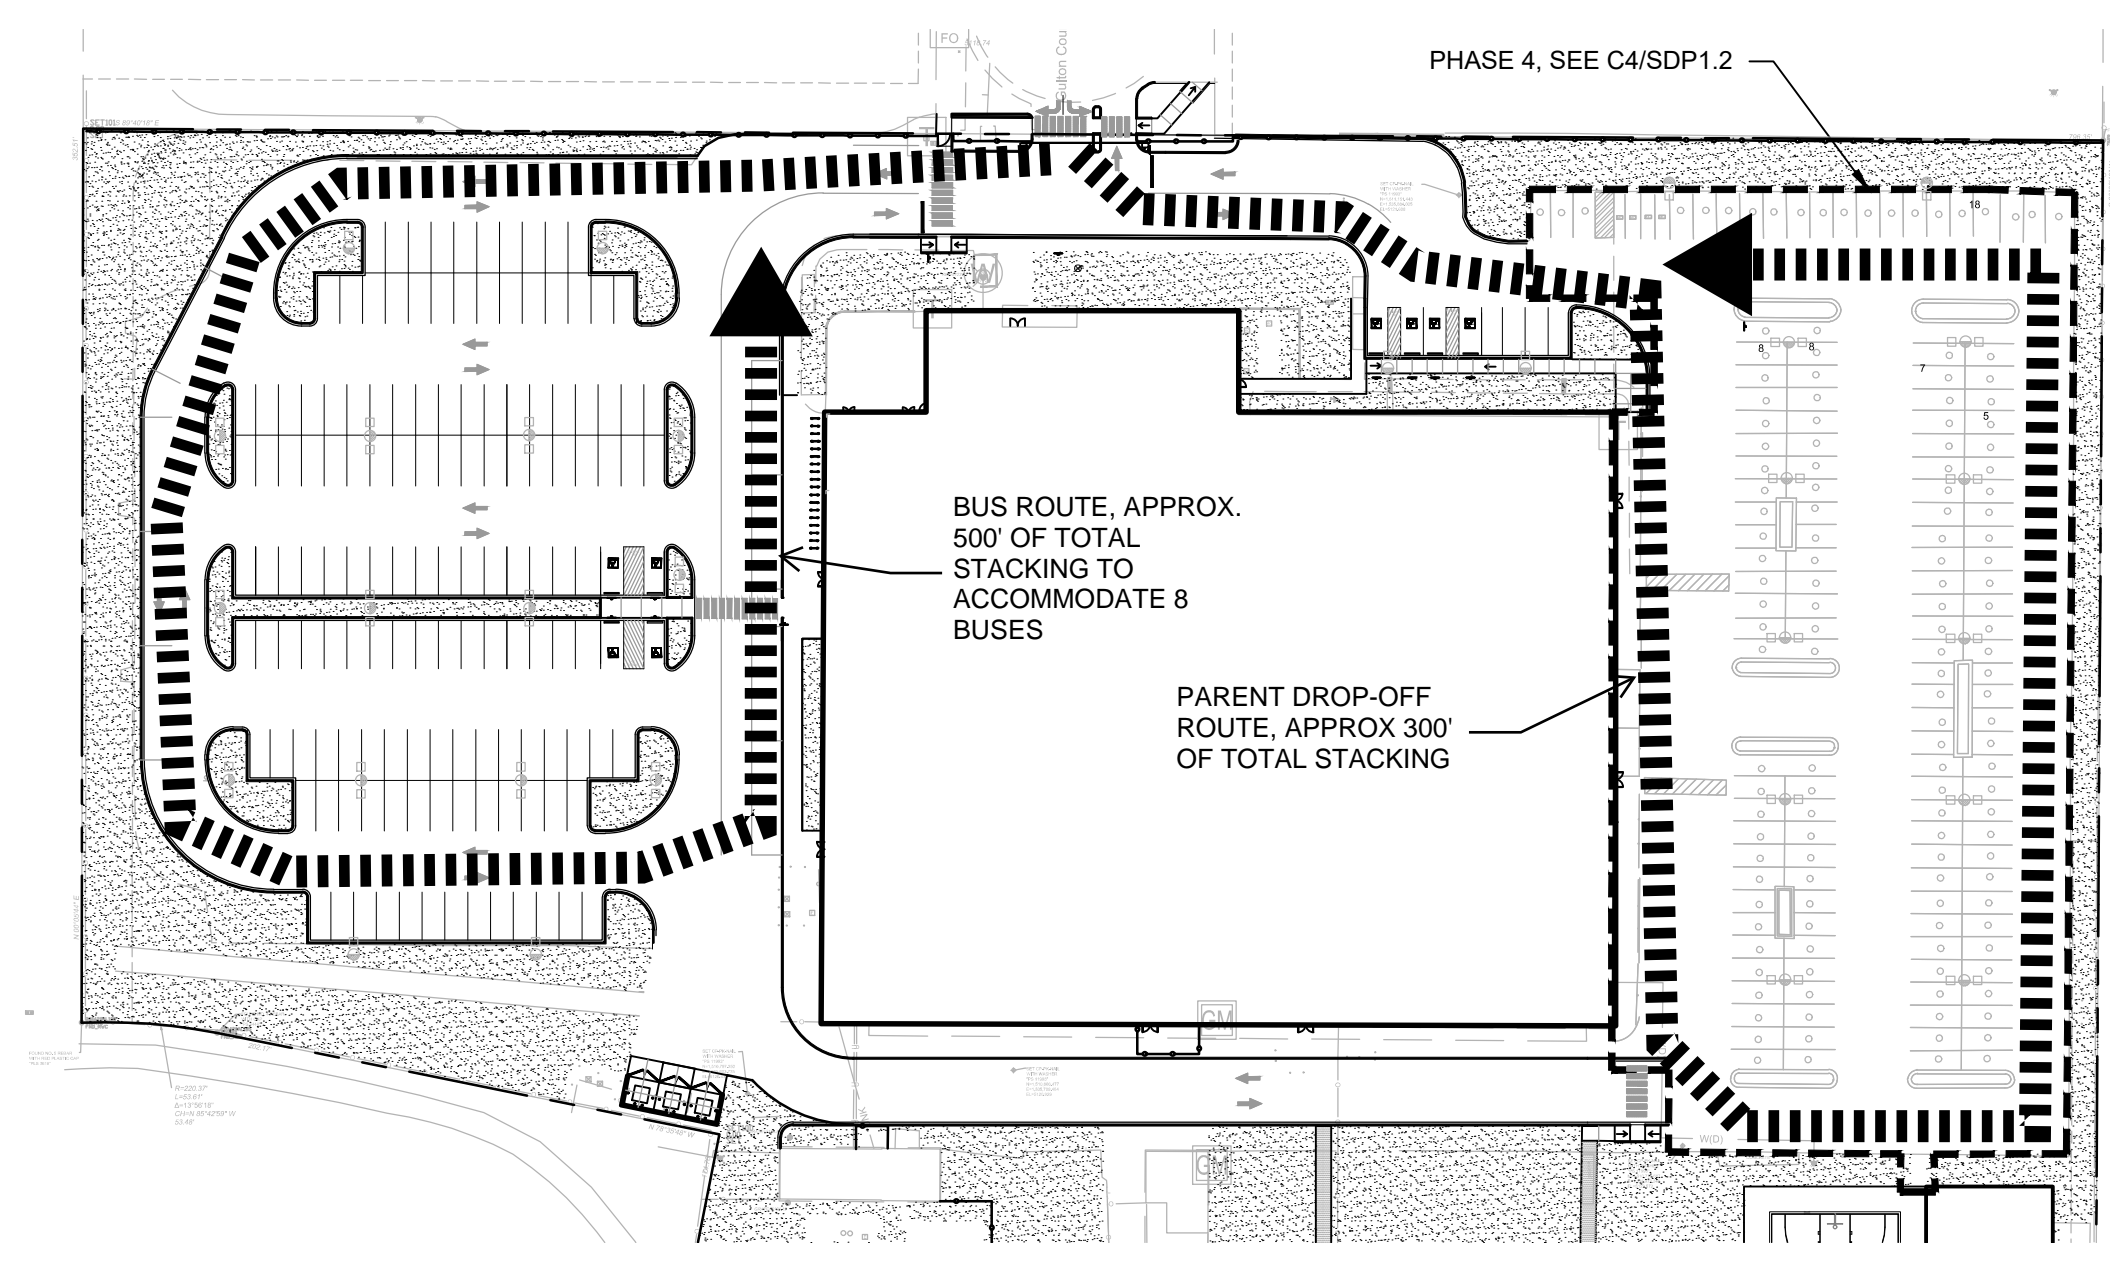


B4 PH3B CIRCULATION DIAGRAM
NTS

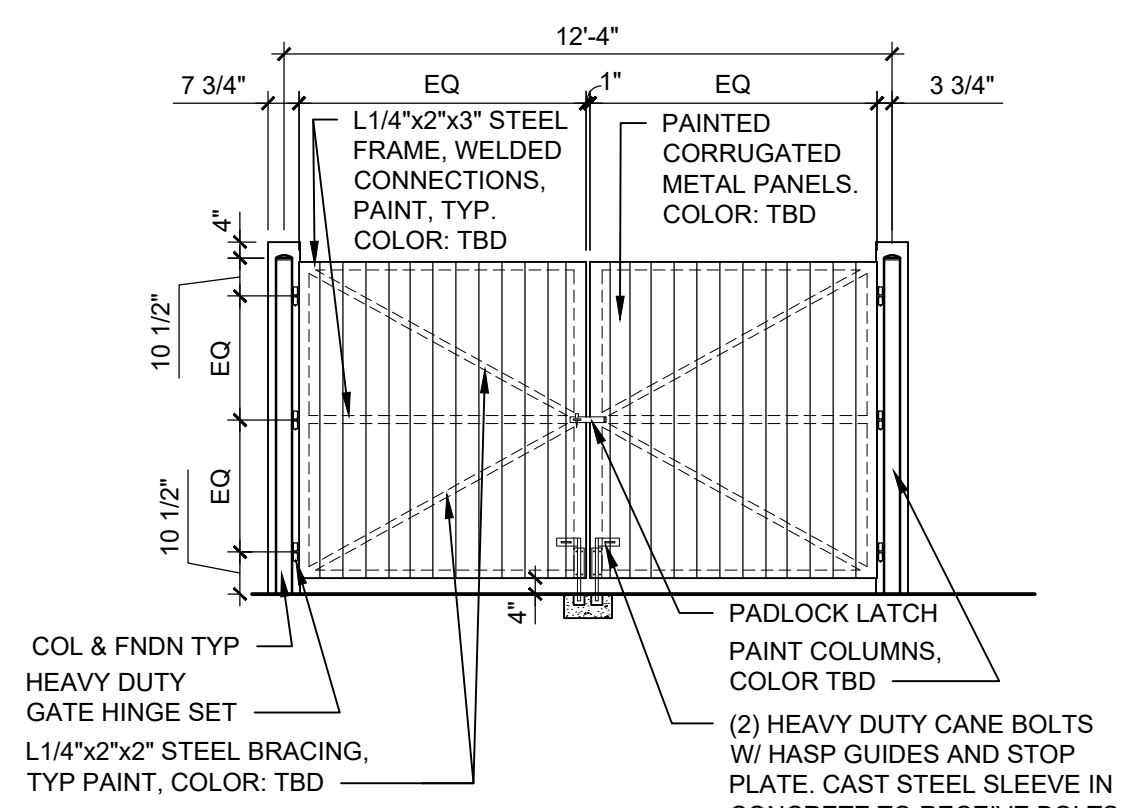


C2 REFUSE ENCLOSURE GATE
1/4" = 1'-0"

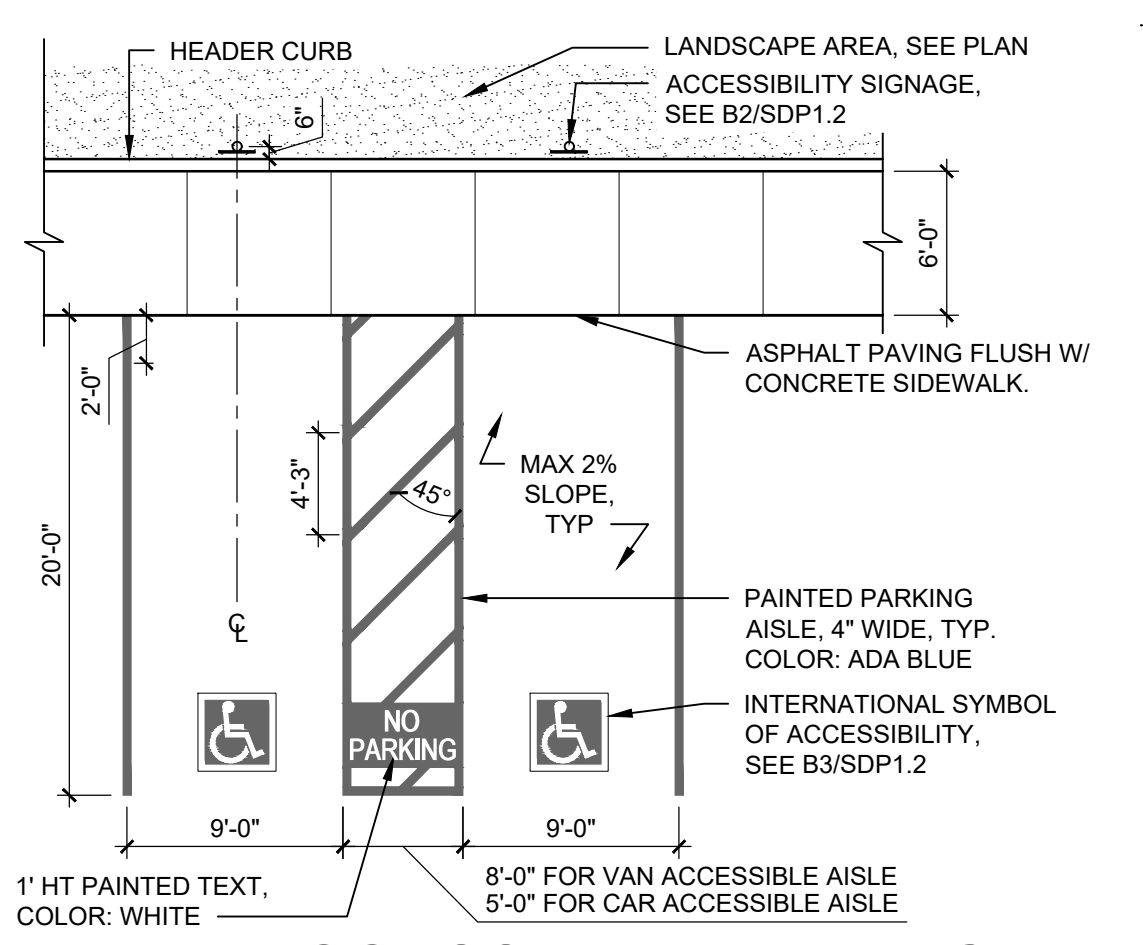


B2 ACCESSIBLE PARKING
1/8" = 1'-0"

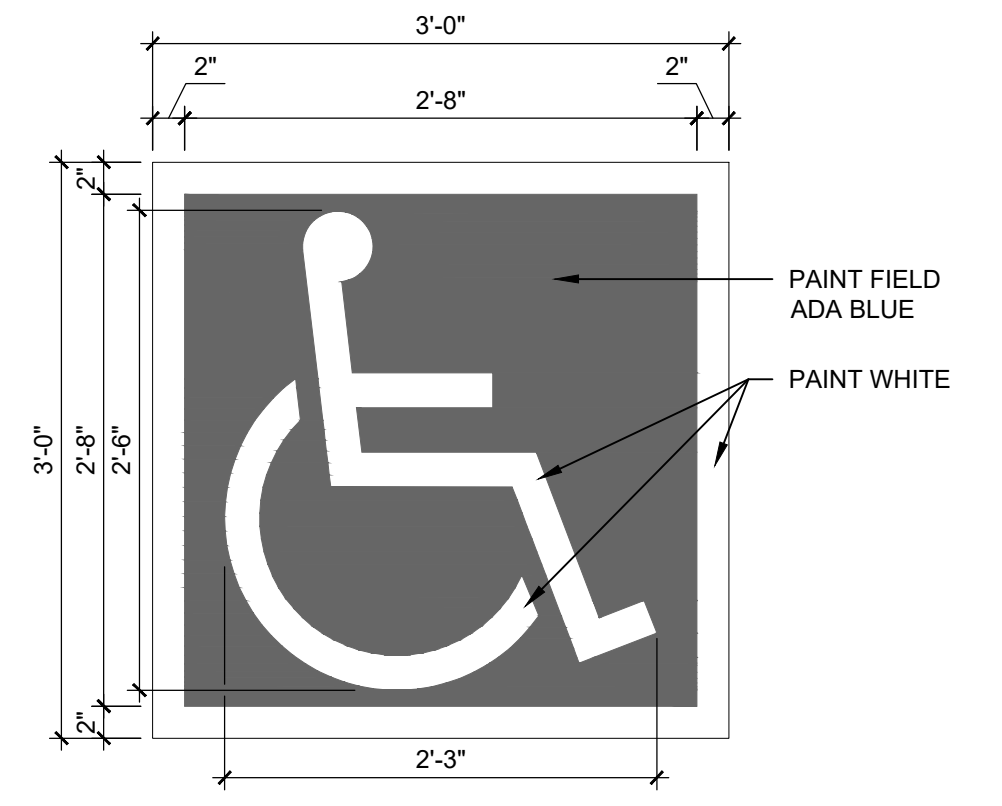


B3 ACCESSIBLE PAVEMENT MARKING
1" = 1'-0"

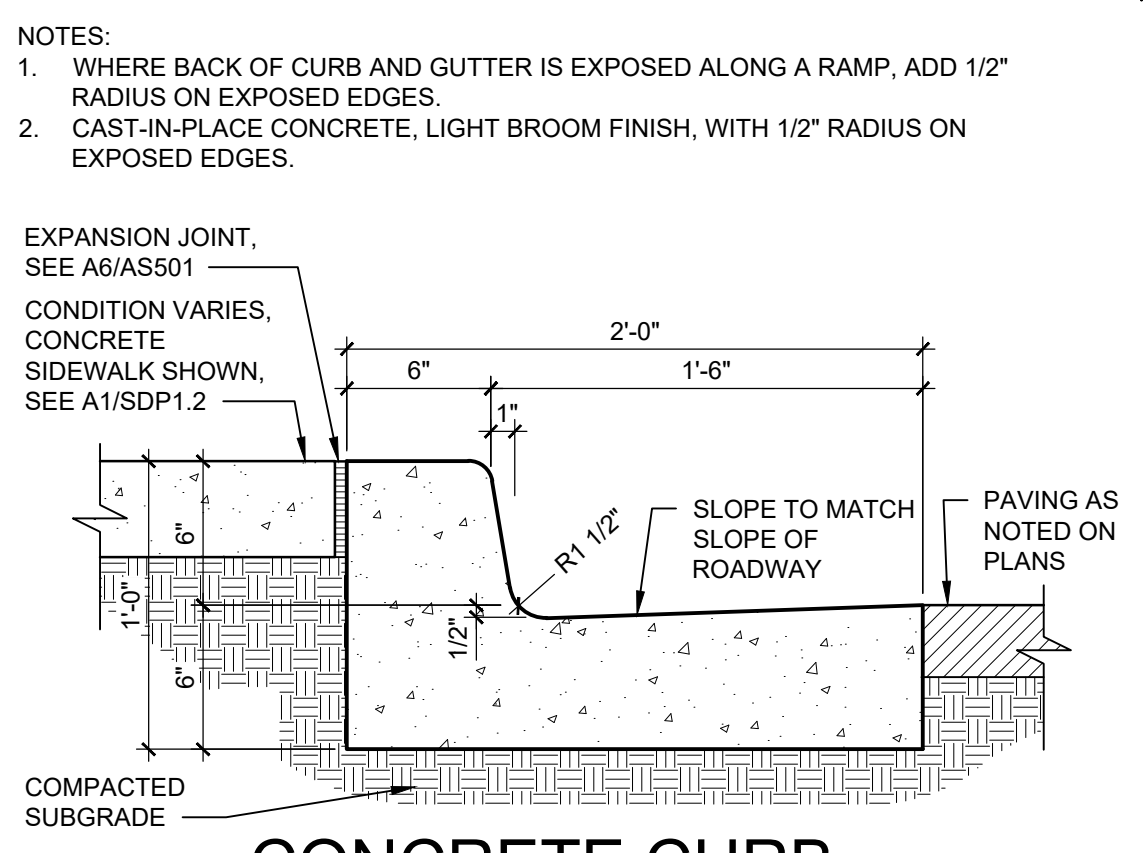

A2 CONCRETE CURB & GUTTER
1 1/2" = 1'-0"

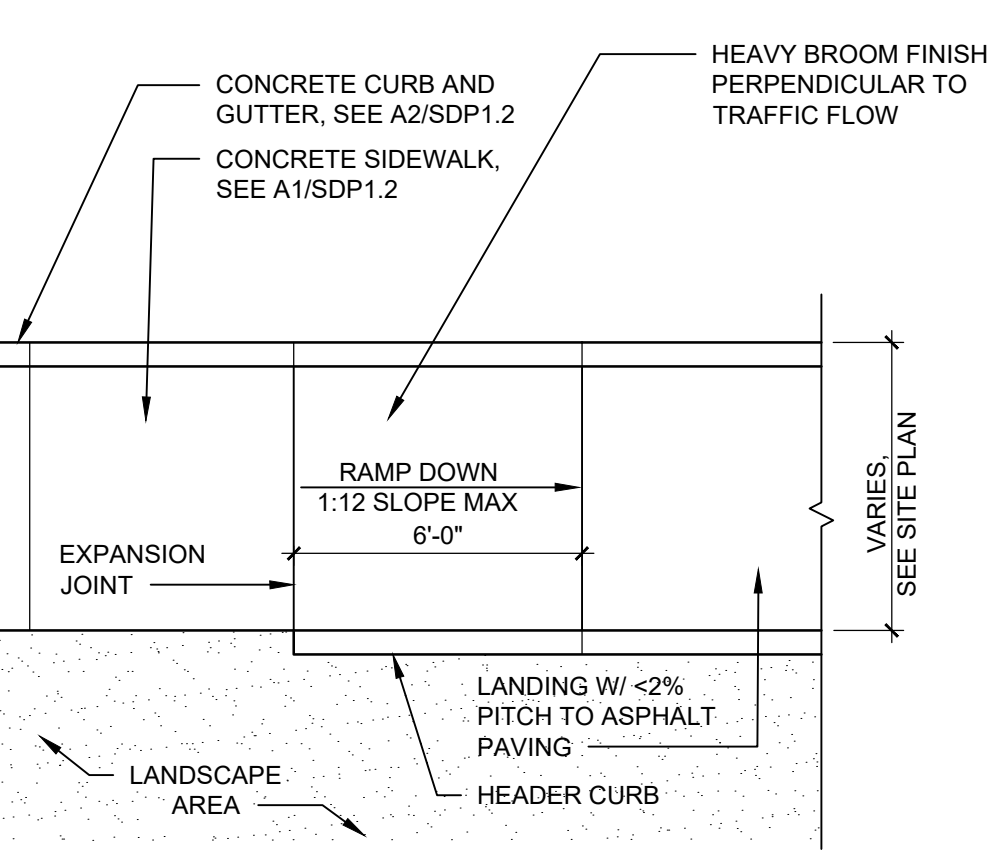


A3 CONCRETE CURB RAMP
1/4" = 1'-0"

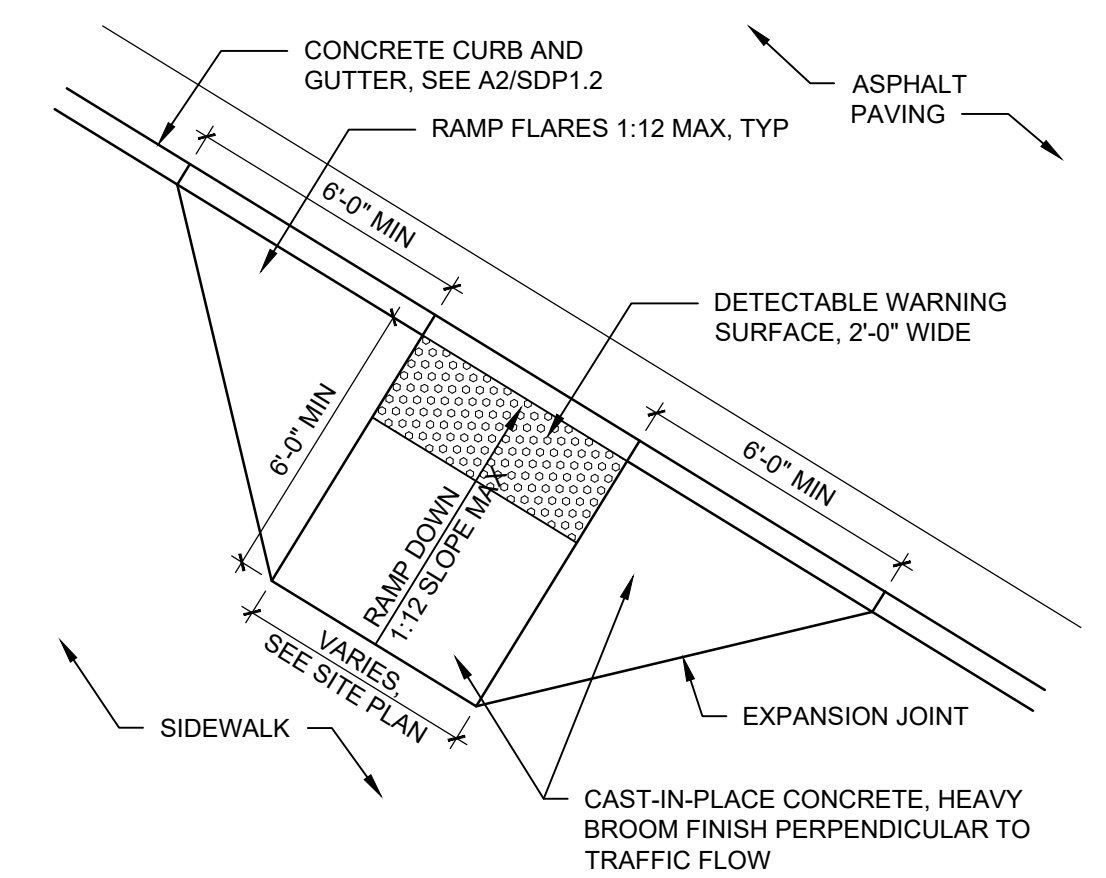


A4 ACCESSIBLE RAMP
1/4" = 1'-0"

C1 BICYCLE RACK
NTS

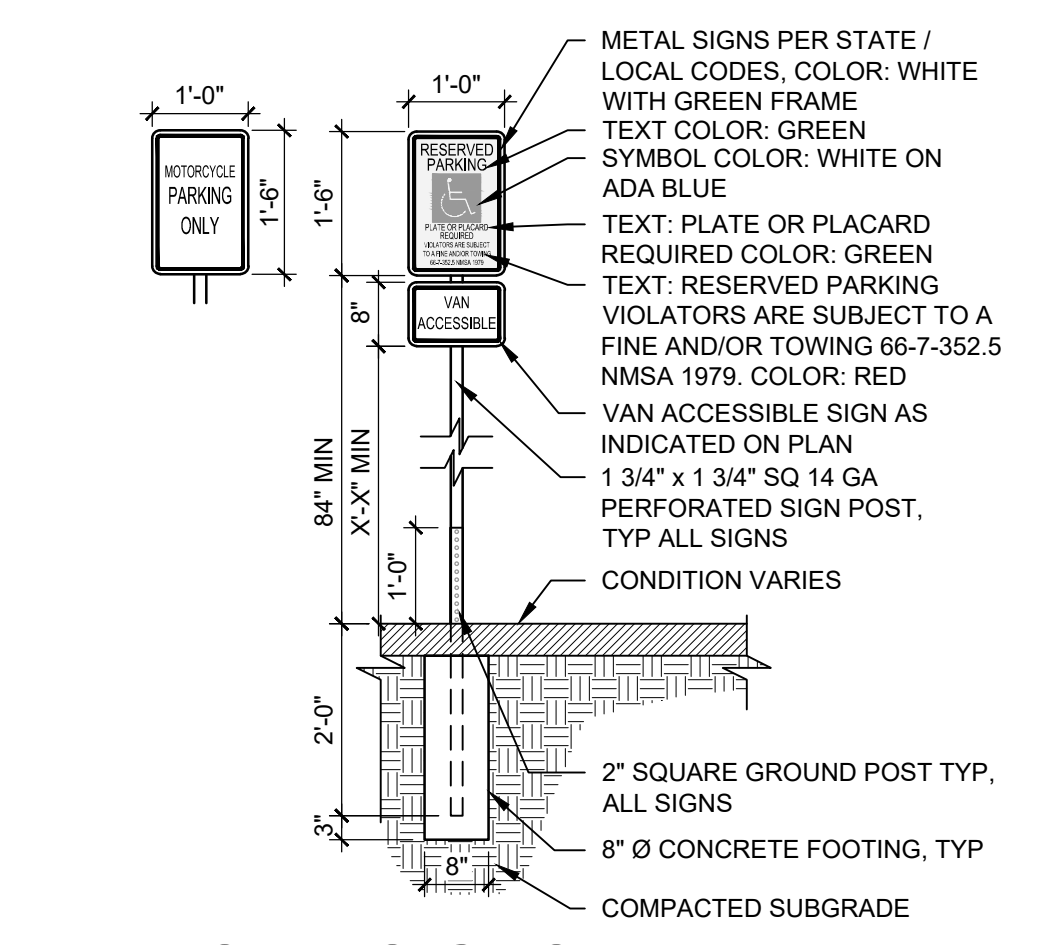

B1 SITE SIGNS
1/2" = 1'-0"

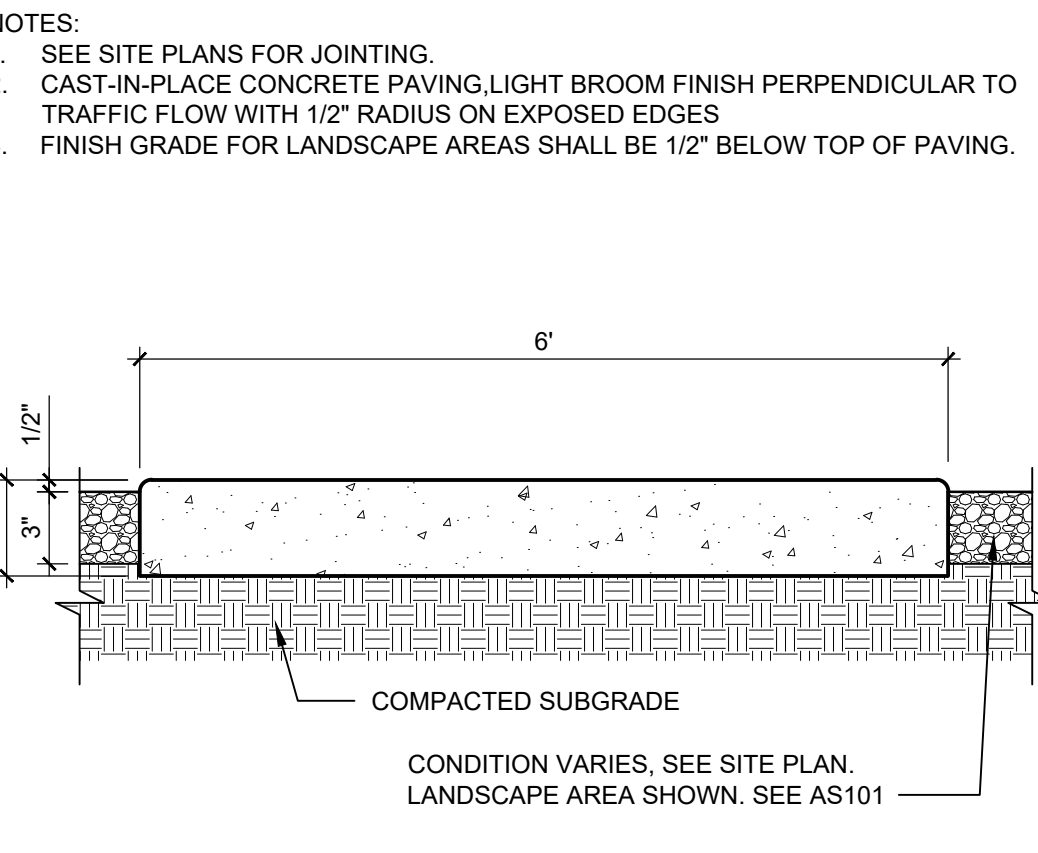

A1 CONCRETE SIDEWALK
1 1/2" = 1'-0"

- NOTES:
- SEE SITE PLANS FOR JOINING.
 - CAST-IN-PLACE CONCRETE PAVING, LIGHT BROOM FINISH PERPENDICULAR TO TRAFFIC FLOW WITH 1/2" RADIUS ON EXPOSED EDGES.
 - FINISH GRADE FOR LANDSCAPE AREAS SHALL BE 1/2" BELOW TOP OF PAVING.

- NOTES:
- WHERE BACK OF CURB AND GUTTER IS EXPOSED ALONG A RAMP, ADD 1/2" RADIUS ON EXPOSED EDGES.
 - CAST-IN-PLACE CONCRETE, LIGHT BROOM FINISH, WITH 1/2" RADIUS ON EXPOSED EDGES.

EXPANSION JOINT, SEE A6/AS501

CONDITION VARIES, CONCRETE SIDEWALK SHOWN, SEE A1/SDP1.2

PAVING AS NOTED ON PLANS

COMPACTED SUBGRADE

LANDSCAPE AREA

HEADER CURB

LANDSCAPE AREA

LANDSCAPE AREA

LANDSCAPE AREA

LANDSCAPE AREA