



DEVELOPMENT REVIEW APPLICATION

Effective 4/17/19

Please check the appropriate box and refer to s	upplemen	tal forms for sub	mittal requirements. All fe	es mu	st be paid at the time of appli	cation.		
Administrative Decisions	Decision	s Requiring a Pu	blic Meeting or Hearing	Polic	y Decisions			
☐ Archaeological Certificate (Form P3)	☐ Site Plan – EPC including any Variances – EPC (Form P1)				☐ Adoption or Amendment of Comprehensive Plan or Facility Plan (Form Z)			
☐ Historic Certificate of Appropriateness – Minor (Form L)	☐ Master Development Plan (Form P1)				☐ Adoption or Amendment of Historic Designation (Form L)			
☐ Alternative Signage Plan (Form P3)	☐ Historic Certificate of Appropriateness – Major (Form L)			ΠA	☐ Amendment of IDO Text (Form Z)			
☑ Minor Amendment to Site Plan (Form P3)	☐ Demol	ition Outside of H	PO (Form L)	□ Ai	☐ Annexation of Land (Form Z)			
☐ WTF Approval (Form W1)	☐ Historic Design Standards and Guidelines (Form L)			□ Ai	☐ Amendment to Zoning Map – EPC (Form Z)			
	☐ Wireless Telecommunications Facility Waiver (Form W2)			☐ Amendment to Zoning Map – Council (Form Z)				
					Appeals			
				☐ Decision by EPC, LC, ZHE, or City Staff (Form A)				
APPLICATION INFORMATION								
Applicant: Grady's Branch, LLC				P	Phone: 505-975-1502			
Address: PO Box 1443	Address: PO Box 1443			Email: rvsg7@rayleehomes.com				
City: Corrales			State: NM	Z	Zip: 87048			
Professional/Agent (if any): Mark Goodwin & Asse	ociates, PA	,		P	Phone: 505-828-2200			
Address: PO Box 90606		Phil Will			mail:			
City: Albuquerque			State: NM	2	Zip: 87199			
Proprietary Interest in Site: Owner	List <u>all</u> owners:							
BRIEF DESCRIPTION OF REQUEST			eron s					
Accelerated Expiration of Site Plan								
SITE INFORMATION (Accuracy of the existing I	egal descr	iption is crucial!	Attach a separate sheet if	neces	sary.)			
Lot or Tract No.: Tract H-12B			Block: Unit:		Jnit:			
Subdivision/Addition: Riverview		MRGCD Map No		UPC Code: 10130630105 1020301		301		
Zone Atlas Page(s): D-13	Existin	ng Zoning: MX	-L	Proposed Zoning: MX-L				
# of Existing Lots: 1	# of P	roposed Lots:	1	Т	Total Area of Site (acres): 2.15ac			
LOCATION OF PROPERTY BY STREETS								
Site Address/Street: Coors Blvd.	Betwe	Between: Paseo Del Norte		and: Montano Blvd.				
CASE HISTORY (List any current or prior project	ct and cas	e number(s) that	may be relevant to your n	equest.				
1002062 DRB-70355		200000						
Signature:	~		* * *	- 1	Date: 11/9/20			
Printed Name: Mark Goodwin, PE		10.000		[☐ Applicant or 图 Agent			
FOR OFFICIAL USE ONLY		X-1		×,		- 3		
Case Numbers Actio	n	Fees	Case Numbers		Action	Fees		
	in the second		18					
Meeting/Hearing Date:	Meeting/Hearing Date:					Fee Total:		
Staff Signature: Date			Date:	P	Project #			

FO	RM P3: ADMINISTRATIVE DECISIONS AND MINOR AMENDMENTS						
A single PDF file of the complete application including all plans and documents being submitted must be emailed to <u>PLNDRS@cabq.gov</u> prior to making a submittal. Zipped files or those over 9 MB cannot be delivered via email, in which case the PDF must be provided on a CD.							
	INFORMATION REQUIRED FOR ALL ADMINISTRATIVE DECISIONS OR AMENDMENTS ✓ Letter of authorization from the property owner if application is submitted by an agent ✓ Zone Atlas map with the entire site clearly outlined and labeled						
	ARCHEOLOGICAL CERTIFICATE Archaeological Compliance Documentation Form with property information section completed Only the information above is required unless the City Archaeologist determines that the application does not qualify for a Certificate of No Effect, in which case a treatment plan prepared by a qualified archaeologist that adequately mitigates any archeological impacts of the proposed development must be submitted and reviewed for a Certificate of Approval per the criteria in IDO Section 14-16-6-5(A)(3)(b)						
	MINOR AMENDMENT TO SITE PLAN – ADMIN, EPC, or DRB Justification letter describing, explaining, and justifying the request per the criteria in IDO Section 14-16-6-4(X)(2) Three (3) copies of all applicable sheets of the approved Site Plan being amended, folded Copy of the Official Notice of Decision associated with the prior approval Three (3) copies of the proposed Site Plan, with changes circled and noted Refer to the Site Plan Checklist for information needed on the proposed Site Plan.						
	Minor Amendments must be within the thresholds established in IDO TABLE 6-4-5. Any amendment beyond these thresholds is considered a Major Amendment and must be processed through the original decision-making body for the request.						
	MINOR AMENDMENT TO SITE DEVELOPMENT PLAN APPROVED PRIOR TO THE EFFECTIVE DATE OF THE IDO Justification letter describing, explaining, and justifying the request per the criteria in IDO Section 14-16-6-4(Y)(1)(a) Three (3) copies of all applicable sheets of the approved Site Development Plan being amended, folded Copy of the Official Notice of Decision associated with the prior approval Three (3) copies of the proposed Site Development Plan, with changes circled and noted Refer to the Site Plan Checklist for information needed on the proposed Site Plan.						
,	Minor Amendments must be within the thresholds established in IDO TABLE 6-4-5. Any amendment beyond these thresholds is considered a Major Amendment and must be processed through the original decision-making body for the request.						
	ACCELERATED EXPIRATION SITE PLAN / Justification letter describing, explaining, and justifying the request per the criteria in IDO Section 14-16-6-4(X)(2)(c) / Site Plan to be Expired						
	ALTERNATIVE SIGNAGE PLAN Proposed Alternative Signage Plan compliant with IDO Section 14-16-5-12(F)(5) Justification letter describing, explaining, and justifying the request per the criteria in IDO Section 14-16-6-5(F)(4)(c) Required notices with content per IDO Section 14-16-6-4(K)(6) Office of Neighborhood Coordination notice inquiry response and proof of emailed notice to affected Neighborhood Association representatives Sign Posting Agreement						
	ALTERNATIVE LANDSCAPE PLAN Justification letter describing, explaining, and justifying the request per the criteria in IDO Section 14-16-5-6(C)(16) Landscape Plan						
1, 1 \$C	ne applicant or agent, acknowledge that if any required information is not submitted with this application, the application will not be neduled for a public meeting or peering, if required, or otherwise processed until it is complete.						
_	ature: Date:						
	ed Name: Applicant or Agent						
FOR OFFICIAL USE ONLY Project Number: Case Numbers							
_	Topos transport						

-Staff Signature: Date:

Grady Branch, LLC PO BOX 1443 Corrales, NM 87048

October 23, 2018

Ms. Kym Dicome DRB Chair City of Albuquerque 600 2nd Street Albuquerque, NM 87102

Re: Team Radio #1002062

Dear Ms. Dicome

Please be advised that Mark Goodwin & Associates is hereby authorized to act on behalf of Grady Branch, LLC, a NM Limited Liability Company, for all applications made to DRB for the above referenced project.


Please contact our office if you have any questions.


Sincerely,

Scott Grady Name

Managing Member

Title

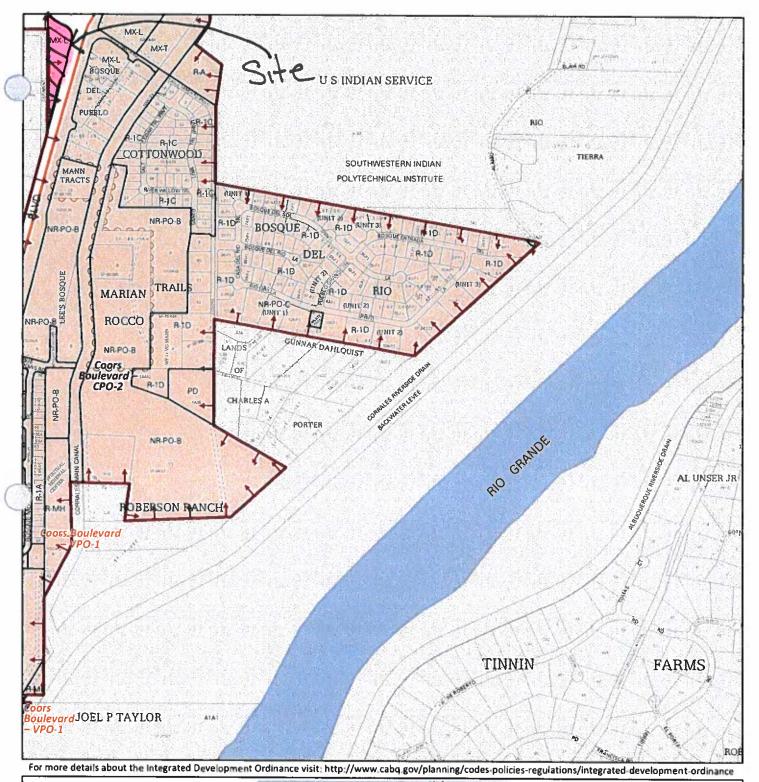

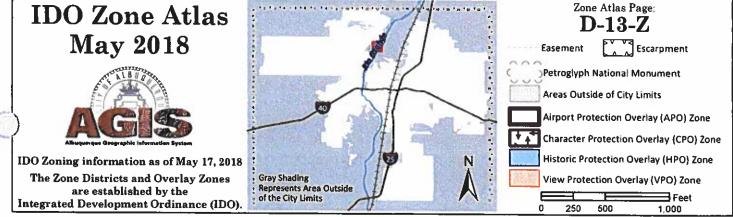



D. Mark Goodwin & Associates, P.A. Consulting Engineers

P.O. BOX 90606, ALBUQUERQUE, NM 87199 (505) 828-2200 FAX 797-9539

October 30, 2020

Mr. Shahab Biazar City of Albuquerque 600 2nd Street NW Albuquerque, NM 87102

Re: Project#1002062

Team Broadcasting, Inc.

Dear Mr. Biazar,

On behalf of the owner of the referenced project, we are requesting that the Site Plan and resulting Building Permit be declared null and void and that the Financial Guaranty in place to support said Building Permit be released.

Please feel free to contact our office with any questions.


Sincerely,

MARK GOODWIN & ASSOCIATES, PA

Mark Goodwin, PE

President

DMG/kb

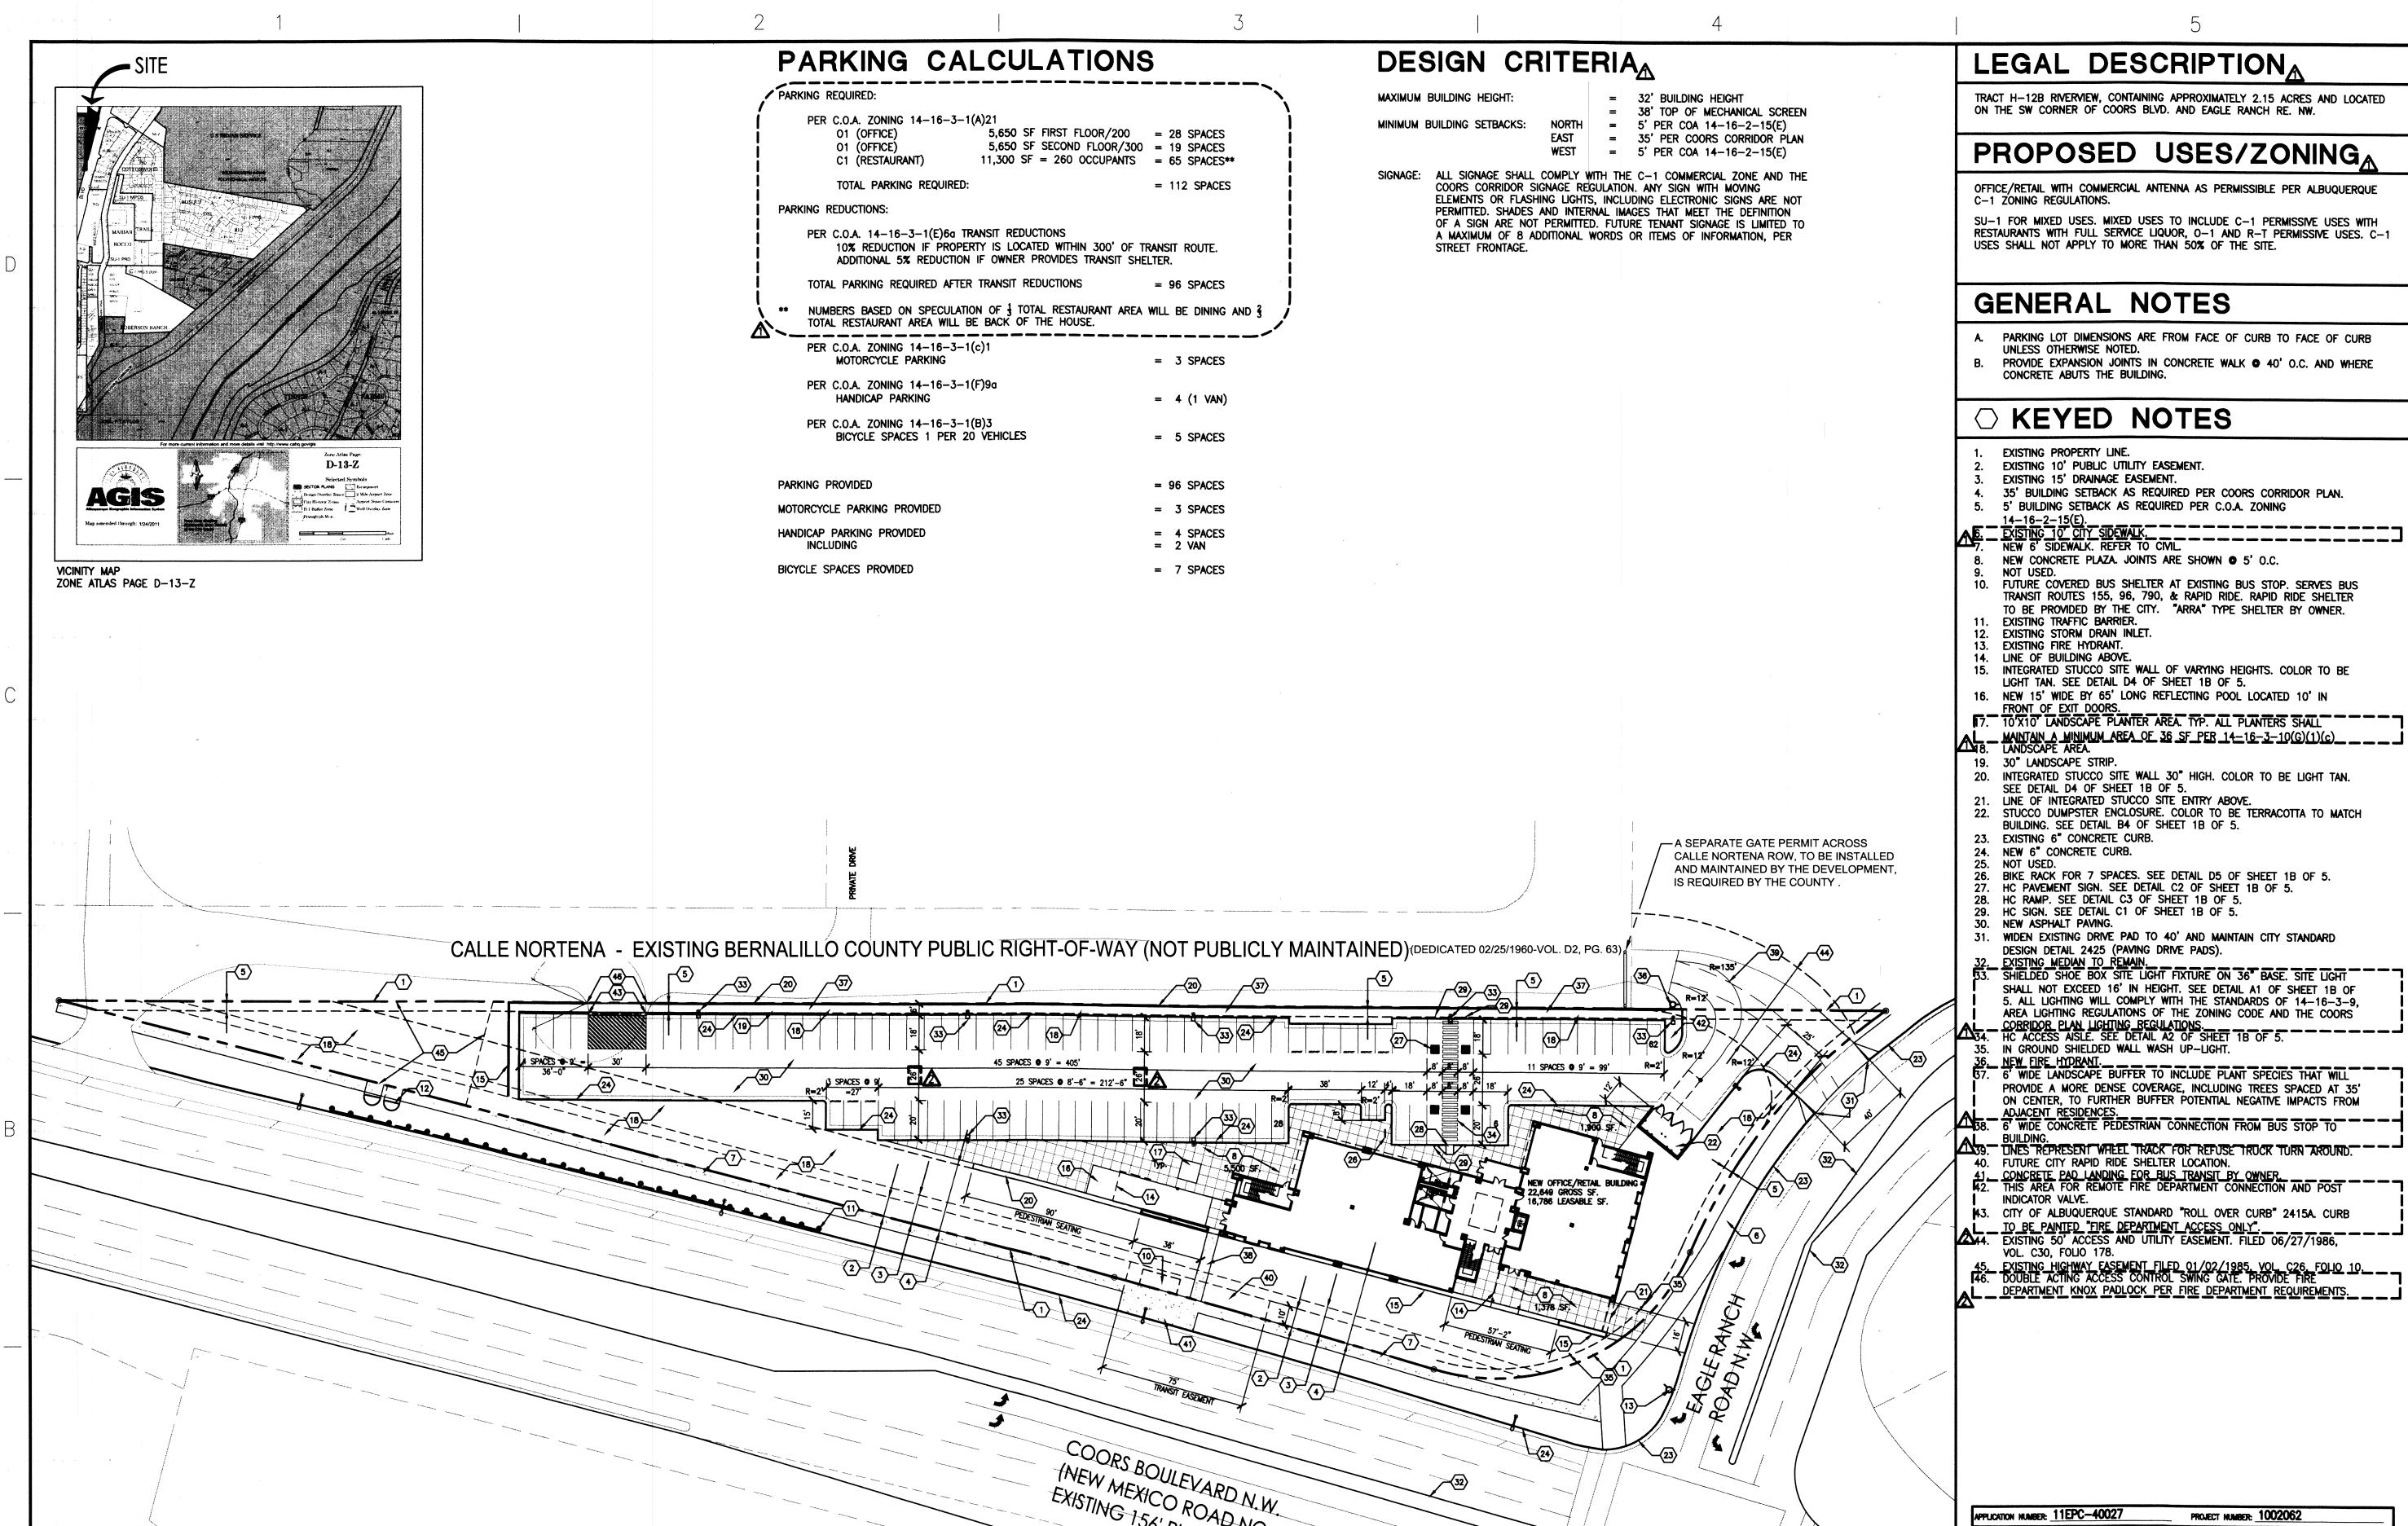

LEGAL DESCRIPTIONA

TRACT H-12B RIVERVIEW, CONTAINING APPROXIMATELY 2.15 ACRES AND LOCATED ON THE SW CORNER OF COORS BLVD. AND EAGLE RANCH RE. NW.

PROPOSED USES/ZONING

OFFICE/RETAIL WITH COMMERCIAL ANTENNA AS PERMISSIBLE PER ALBUQUERQUE

SU-1 FOR MIXED USES. MIXED USES TO INCLUDE C-1 PERMISSIVE USES WITH RESTAURANTS WITH FULL SERVICE LIQUOR, 0-1 AND R-T PERMISSIVE USES. C-1 USES SHALL NOT APPLY TO MORE THAN 50% OF THE SITE.

GENERAL NOTES

- PARKING LOT DIMENSIONS ARE FROM FACE OF CURB TO FACE OF CURB
- PROVIDE EXPANSION JOINTS IN CONCRETE WALK 40' O.C. AND WHERE

KEYED NOTES

- EXISTING 10' PUBLIC UTILITY EASEMENT.
- EXISTING 15' DRAINAGE EASEMENT.
- 35' BUILDING SETBACK AS REQUIRED PER COORS CORRIDOR PLAN.

- NEW CONCRETE PLAZA. JOINTS ARE SHOWN 5' O.C.
- FUTURE COVERED BUS SHELTER AT EXISTING BUS STOP. SERVES BUS
- TRANSIT ROUTES 155, 96, 790, & RAPID RIDE. RAPID RIDE SHELTER TO BE PROVIDED BY THE CITY. "ARRA" TYPE SHELTER BY OWNER.

- 15. INTEGRATED STUCCO SITE WALL OF VARYING HEIGHTS. COLOR TO BE LIGHT TAN. SEE DETAIL D4 OF SHEET 1B OF 5.
- 16. NEW 15' WIDE BY 65' LONG REFLECTING POOL LOCATED 10' IN
- FRONT OF EXIT DOORS.

 7. 10'X10' LANDSCAPE PLANTER AREA. TYP. ALL PLANTERS SHALL
- MAINTAIN A MINIMUM AREA OF 36 SF PER 14-16-3-10(G)(1)(c)

 8. LANDSCAPE AREA.
- 20. INTEGRATED STUCCO SITE WALL 30" HIGH. COLOR TO BE LIGHT TAN.
- 21. LINE OF INTEGRATED STUCCO SITE ENTRY ABOVE.
- 22. STUCCO DUMPSTER ENCLOSURE. COLOR TO BE TERRACOTTA TO MATCH BUILDING. SEE DETAIL B4 OF SHEET 1B OF 5.
- 26. BIKE RACK FOR 7 SPACES. SEE DETAIL D5 OF SHEET 1B OF 5.
- 28. HC RAMP. SEE DETAIL C3 OF SHEET 1B OF 5.
- WIDEN EXISTING DRIVE PAD TO 40' AND MAINTAIN CITY STANDARD DESIGN DETAIL 2425 (PAVING DRIVE PADS).
 EXISTING MEDIAN TO REMAIN.
 SHIELDED SHOE BOX SITE LIGHT FIXTURE ON 36" BASE. SITE LIGHT
- SHALL NOT EXCEED 16' IN HEIGHT. SEE DETAIL A1 OF SHEET 1B OF 5. ALL LIGHTING WILL COMPLY WITH THE STANDARDS OF 14–16–3–9,
 AREA LIGHTING REGULATIONS OF THE ZONING CODE AND THE COORS
 CORRIDOR PLAN LIGHTING REGULATIONS.

 134. HC ACCESS AISLE. SEE DETAIL A2 OF SHEET 1B OF 5.
- 34. HC ACCESS AISLE. SEE DETAIL AZ OF SHEET IB OF 5.
 35. IN GROUND SHIELDED WALL WASH UP-LIGHT.
 36. NEW FIRE HYDRANT.
 37. 6' WIDE LANDSCAPE BUFFER TO INCLUDE PLANT SPECIES THAT WILL
 PROVIDE A MORE DENSE COVERAGE, INCLUDING TREES SPACED AT 35'
 ON CENTER, TO FURTHER BUFFER POTENTIAL NEGATIVE IMPACTS FROM
- ADJACENT RESIDENCES.

 38. 6' WIDE CONCRETE PEDESTRIAN CONNECTION FROM BUS STOP TO

- 43. CITY OF ALBUQUERQUE STANDARD "ROLL OVER CURB" 2415A. CURB

 TO BE PAINTED "FIRE DEPARTMENT ACCESS ONLY".

 44. EXISTING 50' ACCESS AND UTILITY EASEMENT. FILED 06/27/1986,
 VOL. C30, FOLIO 178.
- 45. EXISTING HIGHWAY EASEMENT FILED 01/02/1985, VOL. C26, FOLIO 10.

 46. DOUBLE ACTING ACCESS CONTROL SWING GATE, PROVIDE FIRE
 DEPARTMENT KNOX PADLOCK PER FIRE DEPARTMENT REQUIREMENTS.

APPLICATION NUMBER: 11EPC-40027 PROJECT NUMBER: 1002062 12-24-14 06-06-12 06/06/12 6-6-12 12-16-14

ALBUQUERQUE, NM 87104 505-255-6400 505-268-6954 FAX WWW.NCA-ARCHITECTS.COM ARCHITECT

ARCHITECTS - PLANNERS - AIA

1306 RIO GRANDE BLVD NW

ROBERT CALVANI NO. 1053

CONSULTANT

PROJECT TITLE

101.7 THE TEAM OFFICE BUILDING

ALBUQUERQUE NEW MEXICO

REVISIONS:

02.21.12 PER FIRE DEPARTMENT 10.24.11 PER EPC CONDITIONS

MK DATE DESCRIPTION

PROJECT NUMBER

A1102 DATE:

March 2012 SHEET TITLE

SITE PLAN FOR

BUILDING PERMIT

SHEET NO


1 OF 5


SITE DEVELOPMENT PLAN FOR BUILDING PERMIT


(NEW MEXICO ROAD NO. 448)


EXISTING 156' RIGHT-OF-WAY


solid waste department

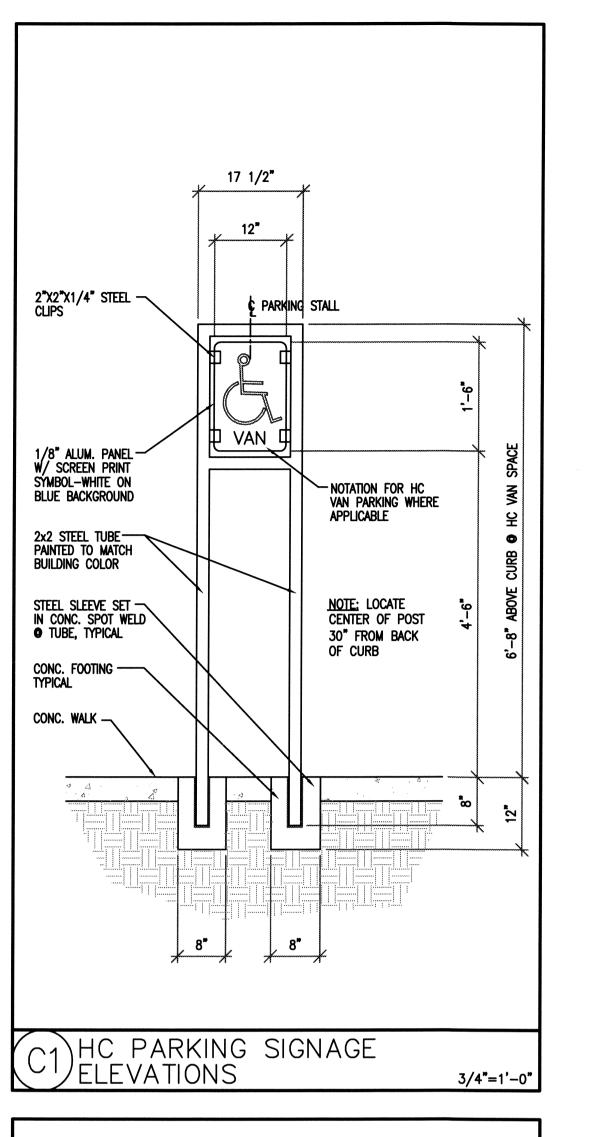


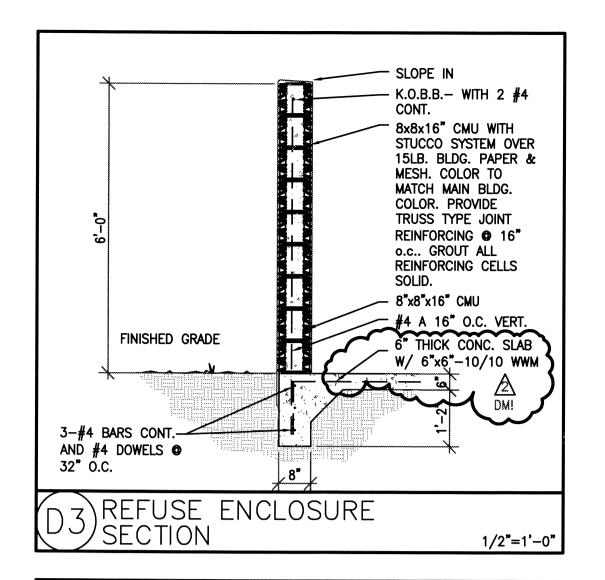


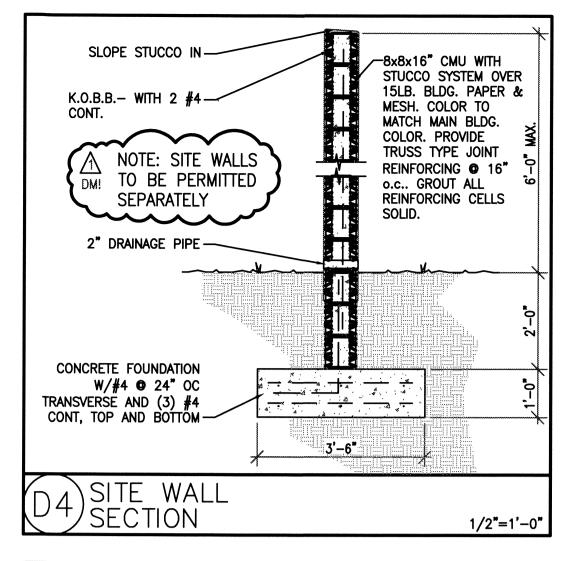


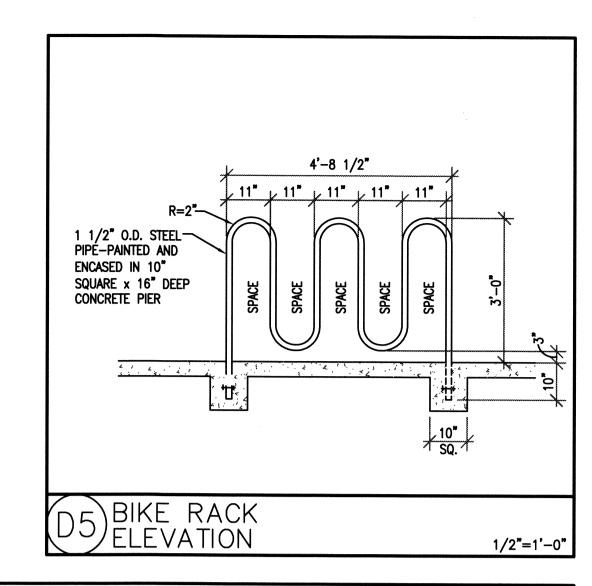


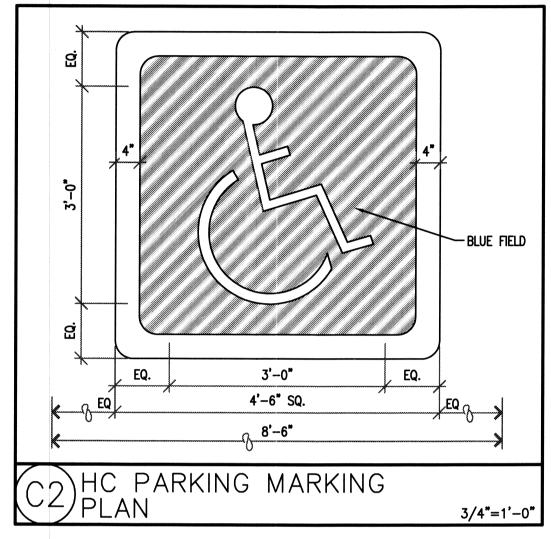

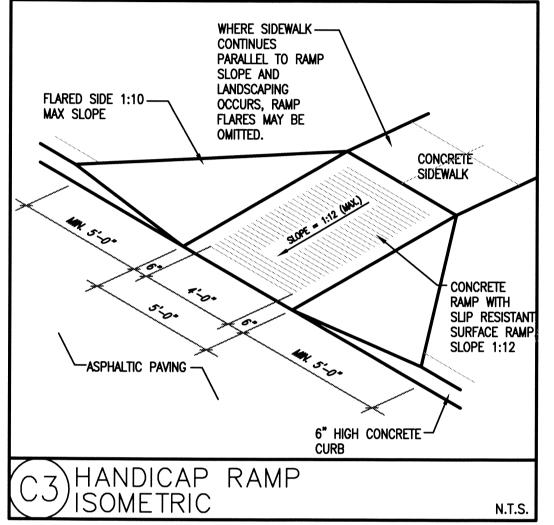

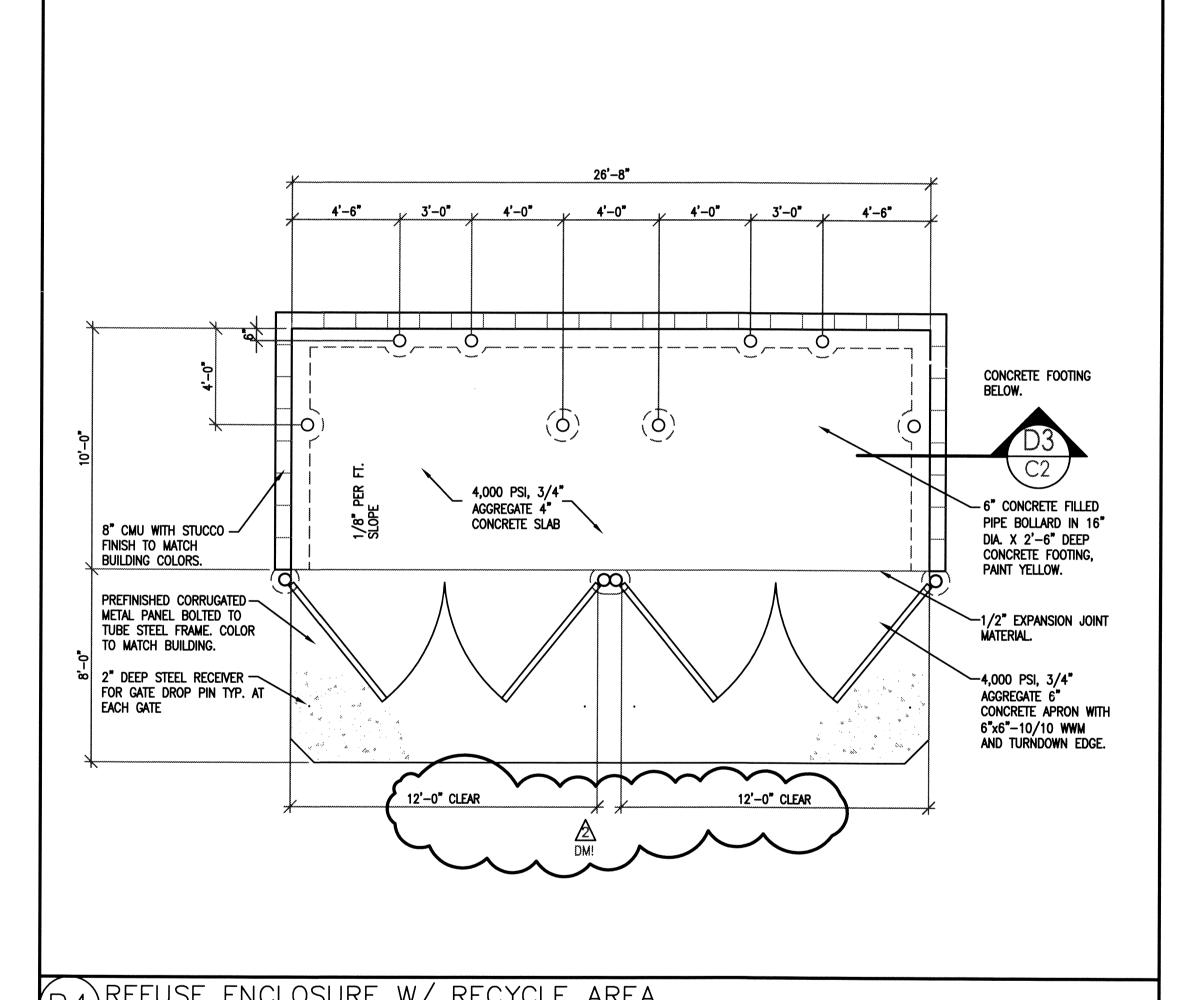

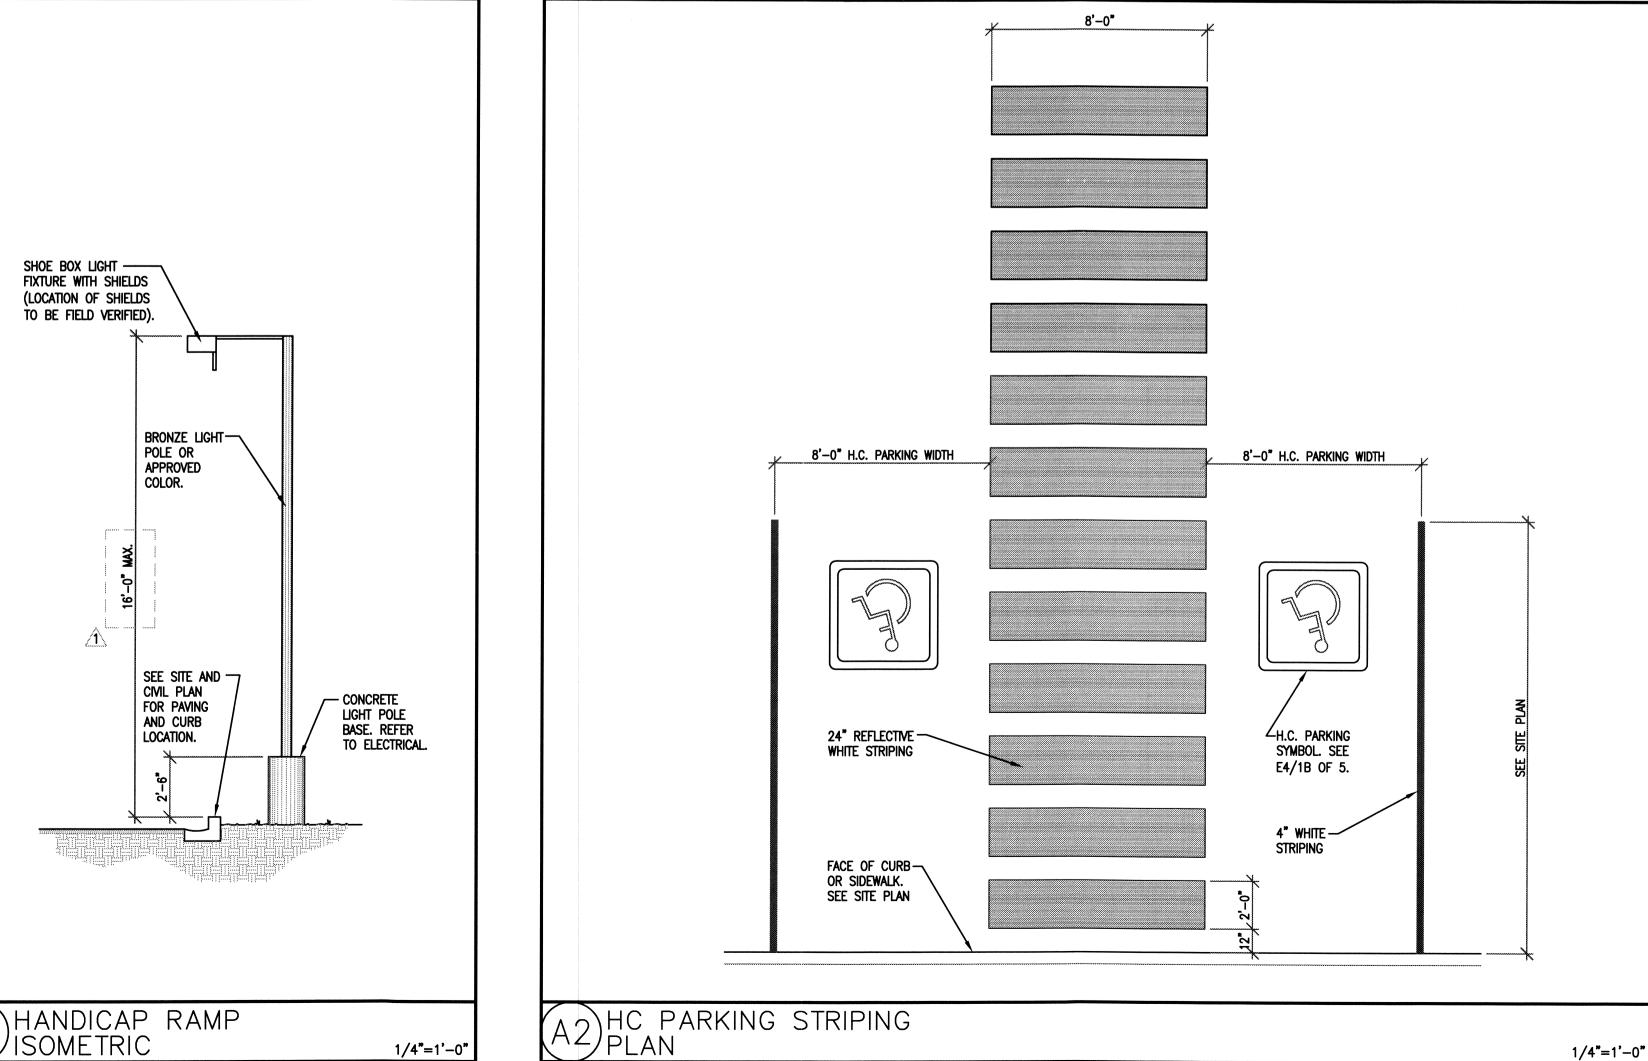

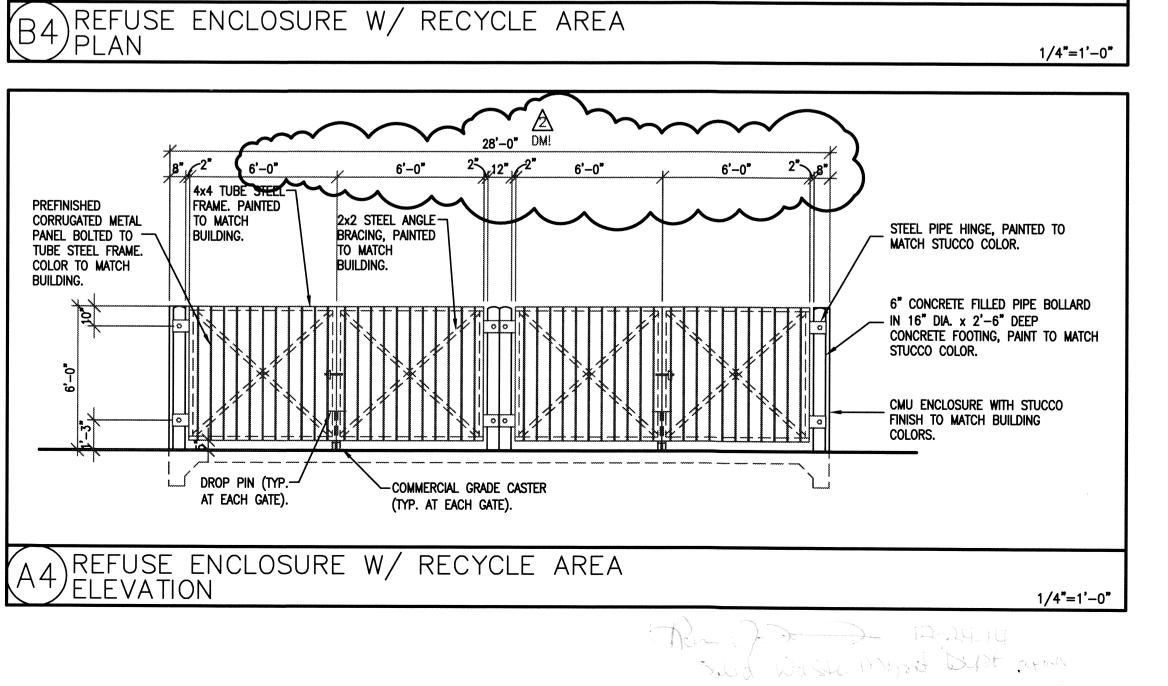




09-24-2014

C-2.0

Sheet Number

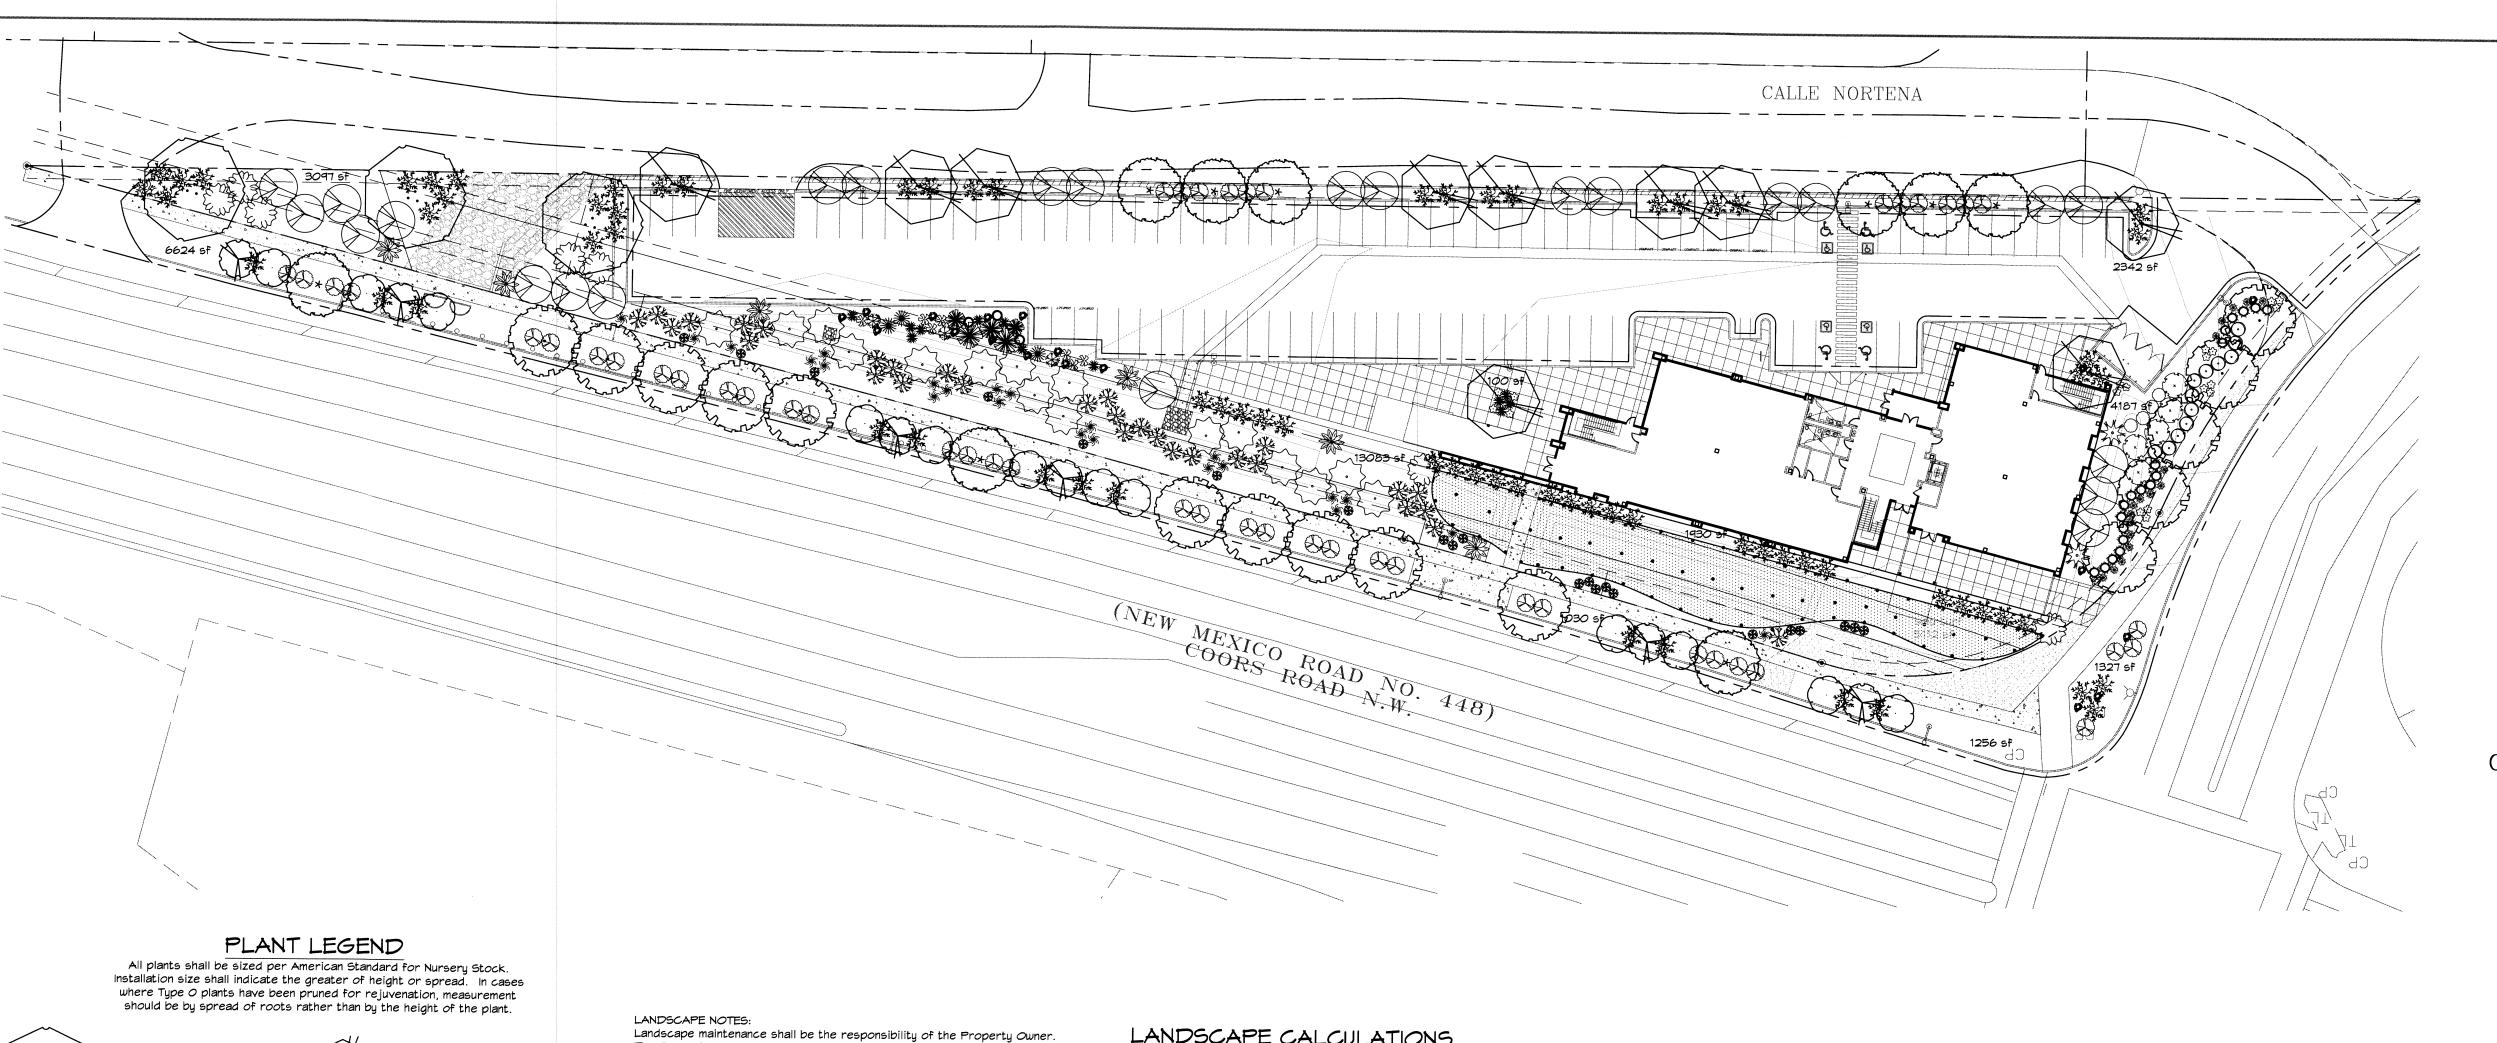

GRAPHIC SCALE

SCALE: 1"=30'

ARCHITECTS - PLANNERS - AIA 1306 RIO GRANDE BLVD NW ALBUQUERQUE, NM 87104 505-255-6400 505-268-6954 FAX WWW.NCA-ARCHITECTS.COM

ARCHITECT

CONSULTABLE

ANDSCAPE ARCHITECTS & CONTRACTO

Cont. Lic. #26458 7909 Edith" N.E. Albuquerque, NM 87184 Ph. (505) 898-9690 Fax (505) 898-7737 cmj@hilltoplandscaping.com All creative ideas contained Herein remains the property of The Hilltop Landscape Architects and Contractors and are protected by copyright laws. This an original design and must not be released or copie unless applicable fees have been paid or job order placed. All plants shall be sized per American Standa for Nursery Stock.

> PROJECT TITLE 101.7 THE TEAM OFFICE **BUILDING**

ALBUQUERQUE NEW MEXICO

REVISIONS OVERSIZED GRAVEL ACCENT 5-29-12 rev. siteplan/com AT EVERY BOULDER CLUSTER 4-26-12 rev. siteplan/comm 4-26-11 rev. siteplan

> DATE DESCRIPTION DRAWN BY: CHECKED BY: CNJ CNJ PROJECT NUMBER: A1102

DATE 03.31.11 SHEET TITLE:

LANDSCAPE PLAN

SHEET NO.

2 of 5

The Property Owner shall maintain street trees in a living, healthy, and attractive condition. It is the intent of this plan to comply with the City Of Albuquerque Mater Conservation Landscaping and Water Waste Ordinance planting restriction approach. Approval of this plan does not constitute or imply exemption from water waste provisions of the Water Conservation Landscaping and Water

Mater management is the sole responsibility of the Property Owner. All landscaping will be in conformance with the City of Albuquerque Zoning Code, Street Tree Ordinance, Pollen Ordinance, and Water Conservation Landscaping and Water Waste Ordinance. In general, water conservative, environmentally sound landscape principles will be followed in design and

Plant beds shall achieve 75% live ground cover at maturity.

Santa Fe Brown Gravel over Filter Fabric to a minimum depth of 3" shall be placed in all landscape areas which are not designated to receive native

IRRIGATION NOTES:

AUTUMN BLAZE MAPLE 10

Mater (M) Allergy (L) Osf

5 Gal., 18"-3' Inst./5' x 6' maturity Water (L+) Allergy (L) 36sf

14"-18" Inst./4' x 4' maturity Water (L+) Allergy (L) 165f

5 Gal., 18"-3' Inst./3' x 4' maturity Water (L+) Allergy (L) 16sf

WESTERN RED CEDAR 24

15 Ğal., 4'-10' Inst./40' x 15' maturitu

Rosa banksiae 5 Gal., 24"-4' Inst./8' x 10' maturity Mater (M) Allergy (L) 100sf

5 Gal., 18"-3' Inst./6' x 7' maturity Water (L) Allergy (L) 49sf

Miscanthus sinensis 5 Gal., 18"-3' Inst./5' x 5' maturity Mater (M+) Allergy (L) 25sf

5 Gal., 18"-3' Inst./4' x 4' maturity Water (M) Allergy (L) 16sf

Caryopteris clandonensis 5 Gal., 12"-3' Inst./3' x 3' maturity Mater (M) Allergy (L) 95f

POTENTILLA 20 Potentilla fruticosa 1 Gal., 3"-15" Inst./3' x 3' maturity Water (M+) Allergy (L) 9sf

Lonicera japonica 'Halliana' 1 Gal., 6''-15'' Inst./3' x 12' maturity Water (M) Allergy (L) 144sf Unstaked-Groundcover

SOD WITH POP UP SPRINKLER

* SCOTCH BROOM 19

BLUE MIST SPIREA 17

* HONEYSUCKLE 48

OVERSIZED GRAVEL

BOULDERS (18)

Thuja plicata 'Green Giant'

Mater (M) Allergy (L) 225sf

Prunus cerastifera

BRADFORD PEAR 12

* BEARGRASS 3 Nolina microcarpa

* RED YUCCA 12

Hesperaloe parviflora

PAMPAS GRASS 30

APACHE PLUME 4 Fallugia paradoxa

MAIDENGRASS 23

Cytisus scoparius

* AGAVE 7 Agave spp.

cer x freemanii 'Autumn Blaze'

2" Cal., 10'-12' Inst./20' x 20x maturity

Pyrus calleryana 2" Cal., 10'-12' Inst./25' x 15' maturity Water (M+) Allergy (L) Osf

Irrigation shall be a complete underground system with Trees to receive 1 Netafim spiral (50' length) with 3 loops at a final radius of 4.5' from tree trunk, pinned in place. Netafim shall have emitters 12" o.c. with a flow of .6 gph. Shrubs to receive (2) 1.0 GPH Drip Emitters. Drip and Bubbler systems to be tied to 1/2" polypipe with flush caps at each end. Trees and shrubs shall be on separate valves.

Run time per each shrub drip valve will be approximately 15 minutes per day. Tree drip valve shall run 1.5 hours, 3 times per week. Run time will be adjusted according to the season.

Point of connection for irrigation system is unknown at current time and will be coordinated in the field. Irrigation will be operated by automatic

Location of controller to be field determined and power source for controller to be provided by others.

Irrigation maintenance shall be the responsibility of the Property Owner. Mater and Power source shall be the responsibility of the Developer/Builder.

STREET TREE REQUIREMENTS - Minimum 2" Caliper

Street trees required under the City Of Albuquerque Street Tree Ordinance are as follows:

Name of Street: COORS Required 25 Provided 25

Name of Street: EAGLE RANCH Required 5 Provided 5

PARKING LOT TREE REQUIREMENTS - Minimum 2" Caliper

Shade trees required under the City Of Albuquerque Parking Lot Tree Ordinance are as follows:

1 Shade tree per 10 spaces Required 9 Provided 9


remain per plan.

Should The Hilltop not receive a Grading and Drainage plan during the design process or the on-site grades differ from the Grading and Drainage plan received, The Hilltop reserves the right to apply slope stabilization materials where the specified gravel will not be suitable. Gravel smaller than 2-4" cobblestone will not stay on a slope greater than 3:1. If the grades are greater than what was originally designed, we will request an infield change-order to lay cobblestone or rip-rap, in lieu of the specified

gravel, to stabilize the slope. All vegetative material shall

I ANDSCAPE CALCULATIONS

LANDSCAPE CALCULAT		
TOTAL LOT AREA	93654	— square fee
TOTAL BUILDING FOOTPRINT AREA	12354	- square fee
NET LOT AREA	81300	- square fee
LANDSCAPE REQUIREMENT	15%	-
TOTAL LANDSCAPE REQUIREMENT	12195	_ _ square fee
TOTAL BED PROVIDED	34976	_ square fee
GROUNDCOVER REQ.	75%	_ square fee
TOTAL GROUNDCOVER REQUIREMENT	26232	_ square fee
TOTAL GROUNDCOVER PROVIDED	29216 (83%)	_ square fee
TOTAL PONDING AREA	0	_ square feet
TOTAL SOD AREA (max. 20% of landscape required)	5112	_ square feet
TOTAL NATIVE SEED AREA	0	_ square feet
TOTAL LANDSCAPE PROVIDED	40088	square feet

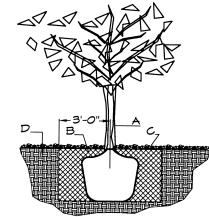


TREE PLANTING DETAIL

GENERAL NOTES:

1. ROOTBALL SHALL BE PLACED ON UNDISTURBED SOIL TO PREVENT TREE FROM SETTLING. 2. TOP OF ROOTCOLLAR INDICATED LEVEL AT WHICH TREE WAS GROWN AND DUG; THIS REPRESENTS THE LEVEL AT WHICH THE TREE SHOULD BE INSTALLED; THAT LEVEL MAY BE EXCEEDED BY ONLY A ONE INCH LAYER OF SOIL. 3. PRIOR TO BACKFILLLING TREE, ALL WIRE, ROPE AND SYNTHETIC MATERIALS SHALL BE REMOVED FROM THE TREE AND THE PLANTING PIT. 4. PRIOR TO BACKFILLING ALL BURLAP SHALL BE CUT AWAY EXCEPT FROM BOTTOM OF THE ROOTBALL.

CONSTRUCTION NOTES: A. TREE B. BACKFILL WITH EXISTING SOIL. C. 3" DEPTH OF GRAVEL MULCH. D. UNDISTRUBED SOIL.

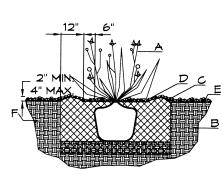


SHRUB PLANTING DETAIL

GENERAL NOTES: . THE OUTSIDE DIAMETER OF THE WATER RETENTION BASIN SHALL BE TWICE THE DIAMETER OF THE SHRUB PLANTING PIT. CONSTRUCTION NOTES:

B. BACKFILL WITH EXISTING SOIL. C. EARTH BERM AROUND WATER RETENTION BASIN. D. 3" DEPTH OF GRAVEL MULCH. E. FINISH GRADE. F. UNDISTURBED SOIL.


A. SHRUB.

) GALVANIZED ELBOW

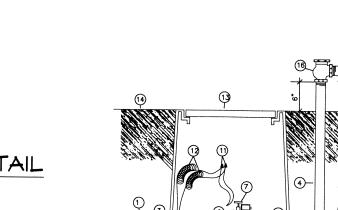


MAINLINE FITTING) CMU BLOCK) GALVANIZED NIPPLE WIRE EXPANSION LOOPS VALVE BOX 24" TO 36" GALVANIZED NIPPLE FINISH GRADE LATERAL PIPE REDUCER BUSHING
AUTOMATIC VALVE (SEE LEGEND) GALVANIZED STREET ELL GALVANIZED NIPPLE

AUTOMATIC VALVE W/ ATMOSPHERIC VACUUM BREAKER

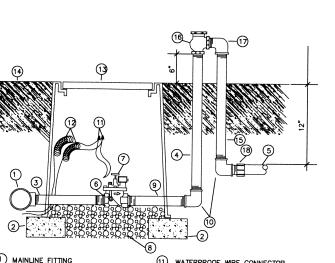

WATERPROOF WIRE CONNECTOR ATMOSPHERIC VACUUM BREAKER TOE NIPPLE OR MALE ADAPTER

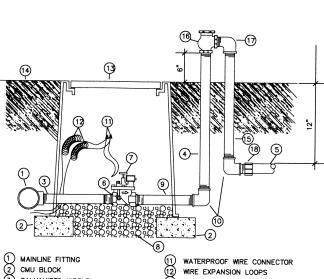

GALVANIZED NIPPLE - 18" TO 24" LENGTH

Netafim Spiral Detail

GRAVEL ACCENT DETAIL

GRAVEL TYPE PER PLAN

PLANTING PER PLAN

40-50 SQUARE FEET

Tree Trunk

Emitter-12" o.c.

Root Ball

BOULDER

* DENOTES EVERGREEN PLANT MATERIAL

LLEY COTTONWOOD 3

Mater (M) Allergy (L) Osf

EASTERN REDBUD 9

4'-8' Inst., 15' x 6' maturity Mater (L) Allergy (L) Osf

Pinus mugo 5 Gal., 12"-3' Inst./3' x 3' maturity Water (M) Allergy (L) 9sf

15 Gal., 4'-10' Inst./20' x 20' maturity Water (M) Allergy (L) 225sf

Hibiscus syriacus 5 Gal., 2'-4' Inst./10' x 10' maturity Water (M) Allergy (L) 100sf

5 Gal., 2'-4' Inst./10' x 10' maturity Water (M) Allergy (L) 100sf

Perovskia atriplicifolia 5 Gal., 18"-3' Inst./6' x 6' maturity Mater (M) Allergy (L) 36sf

Muhlenbergia capillaris 5 Gal., 12"-3' Inst./3' x 3' maturity Mater (M) Allergy (L) 9sf

5 Gal., 24"-4' Inst./2' x 8' maturity

* BUFFALO JUNIPER 74 Juniperus sabina 'Buffalo'

SANTA ANA TAN GRAVEL

MITH FILTER FABRIC TO A MINIMUM 3" DEPTH

Water (L+) Allergy (L) 64sf

MOCK ORANGE 6

RUSSIAN SAGE 12

REGAL MIST 21

COMMERCIAL GRADE STEEL EDGING

GROUNDCOVERS

HARDSCAPES

Philadelphus cultivars

* PALM YUCCA 5 Yucca faxonia

MUGO PINE 3

OCOTILLO 3

SHRUBS/ORNAMENTAL GRASSES

ouquieria splendens

4'-6' Inst./15' x 10' maturity

Mater (L) Allergy (L) Osf

DESERT ACCENTS

2" Cal., 12'-14' Inst./ 30' x 30' maturity

Cercis canadensis
2" Cal., 8'-10' Inst./30' x 30' maturity
Water (M) Allergy (L) Osf

