

LEGAL DESCRIPTION

TRACT NUMBERED 2-B OF AVALON SUBDIVISION UNIT 5, A SUBDIVISION OF A TRACT OF LAND LOCATED WITHIN PROJECTED SECTIONS 16 AND 21, TOWNSHIP 10 NORTH, RANGE 2 EAST, N.M.P.M. TOWN OF ATRISCO GRANT

SITE DATA

NR-BP ZONING

SITE AREA 253757 SF (5.83 AC)

PROPOSED USAGE COMMERCIAL BUILDING AREA 3173 SF OFFICE

6868 SF SERVICE AREA 7038 SF TRUCK BAYS 11223 SF WAREHOUSE

4100 SF COVERED DOCKS 32402 SF TOTAL

18 SPACES (1 PER 1000 OFFICE, SERVICE AREA, TRUCK BAY)

47 SPACES PARKING PROVIDED

HC PARKING REQUIRED 2 SPACES

2 SPACES (1 VAN ACCESSIBLE) HC PARKING PROVIDED TOTAL PARKING PROVIDED 49 SPACES

BICYCLE PARKING REQUIRED 3 SPACES (GREATER OF 3 OR 10% OF REQUIRED PARKING BICYCLE SPACES PROVIDED 3 SPACES

MOTORCYCLE SPACES REQUIRED 1 SPACES (1 PER 1-25 VEHICLES PARKING REQUIRED) MOTORCYCLE SPACES PROVIDED 2 SPACES

65330 SF

LANDSCAPE REQUIRED 38063 SF (15% OF LOT AREA)


LANDSCAPE PROVIDED SETBACKS

REAR

FRONT SIDE

> PROJECT NUMBER: PR-2020-004747 APPLICATION NUMBER: SI-2021-00484 This plan is consistent with the specific Site Development Plan approved by the Environmental Planning Commission (EPC), dated ______, and the Findings and Conditions in the Official Notification of Decision are satisfied. Is an Infrastructure List required? () Yes () No If Yes, then a set of approved DRC plans with a work order is required for any construction within Public Right—of—Way or for construction of public improvements. DRB SITE DEVELOPMENT PLAN APPROVAL: Jun 25, 2021 Jeanne Wolfenbarger Traffic Engineer, Transportation Division Date Blaine Carter Jun 25, 2021 ABCWUA Charfelot Date Jun 30, 2021 Parks & Recreation Department Date Einest armijo Jun 25, 2021 City Engineer/Hydrology Date Jun 28, 2021 Code Enforcement Date Date *Environmental Health Department (conditional) Herman Gallegos 06-10-21 Solid Waste Management Date Jul 7, 2021 DRB Chairperson, Planning Department Date

* Environment	al Health, if necessary	
ENGINEER'S SEAL	SOUTHERN TIRE MART ALBUQUERQUE, NM	DRAWN BY
ON METICO PZ	•	<i>DATE</i> 6-8-21
((7868)))	SITE PLAN ADMINISTRATIVE	<i>DRAWING</i> 2020031—SP
PROPERTY OF THE STATE OF THE ST		SHEET #
6-8-21	5571 MIDWAY PARK PL NE ALBUQUERQUE, NEW MEXICO 87109	SP-1
RONALD R. BOHANNAN P.E. #7868	(505) 858-3100 www.tierrawestllc.com	<i>JOB #</i> 2020031

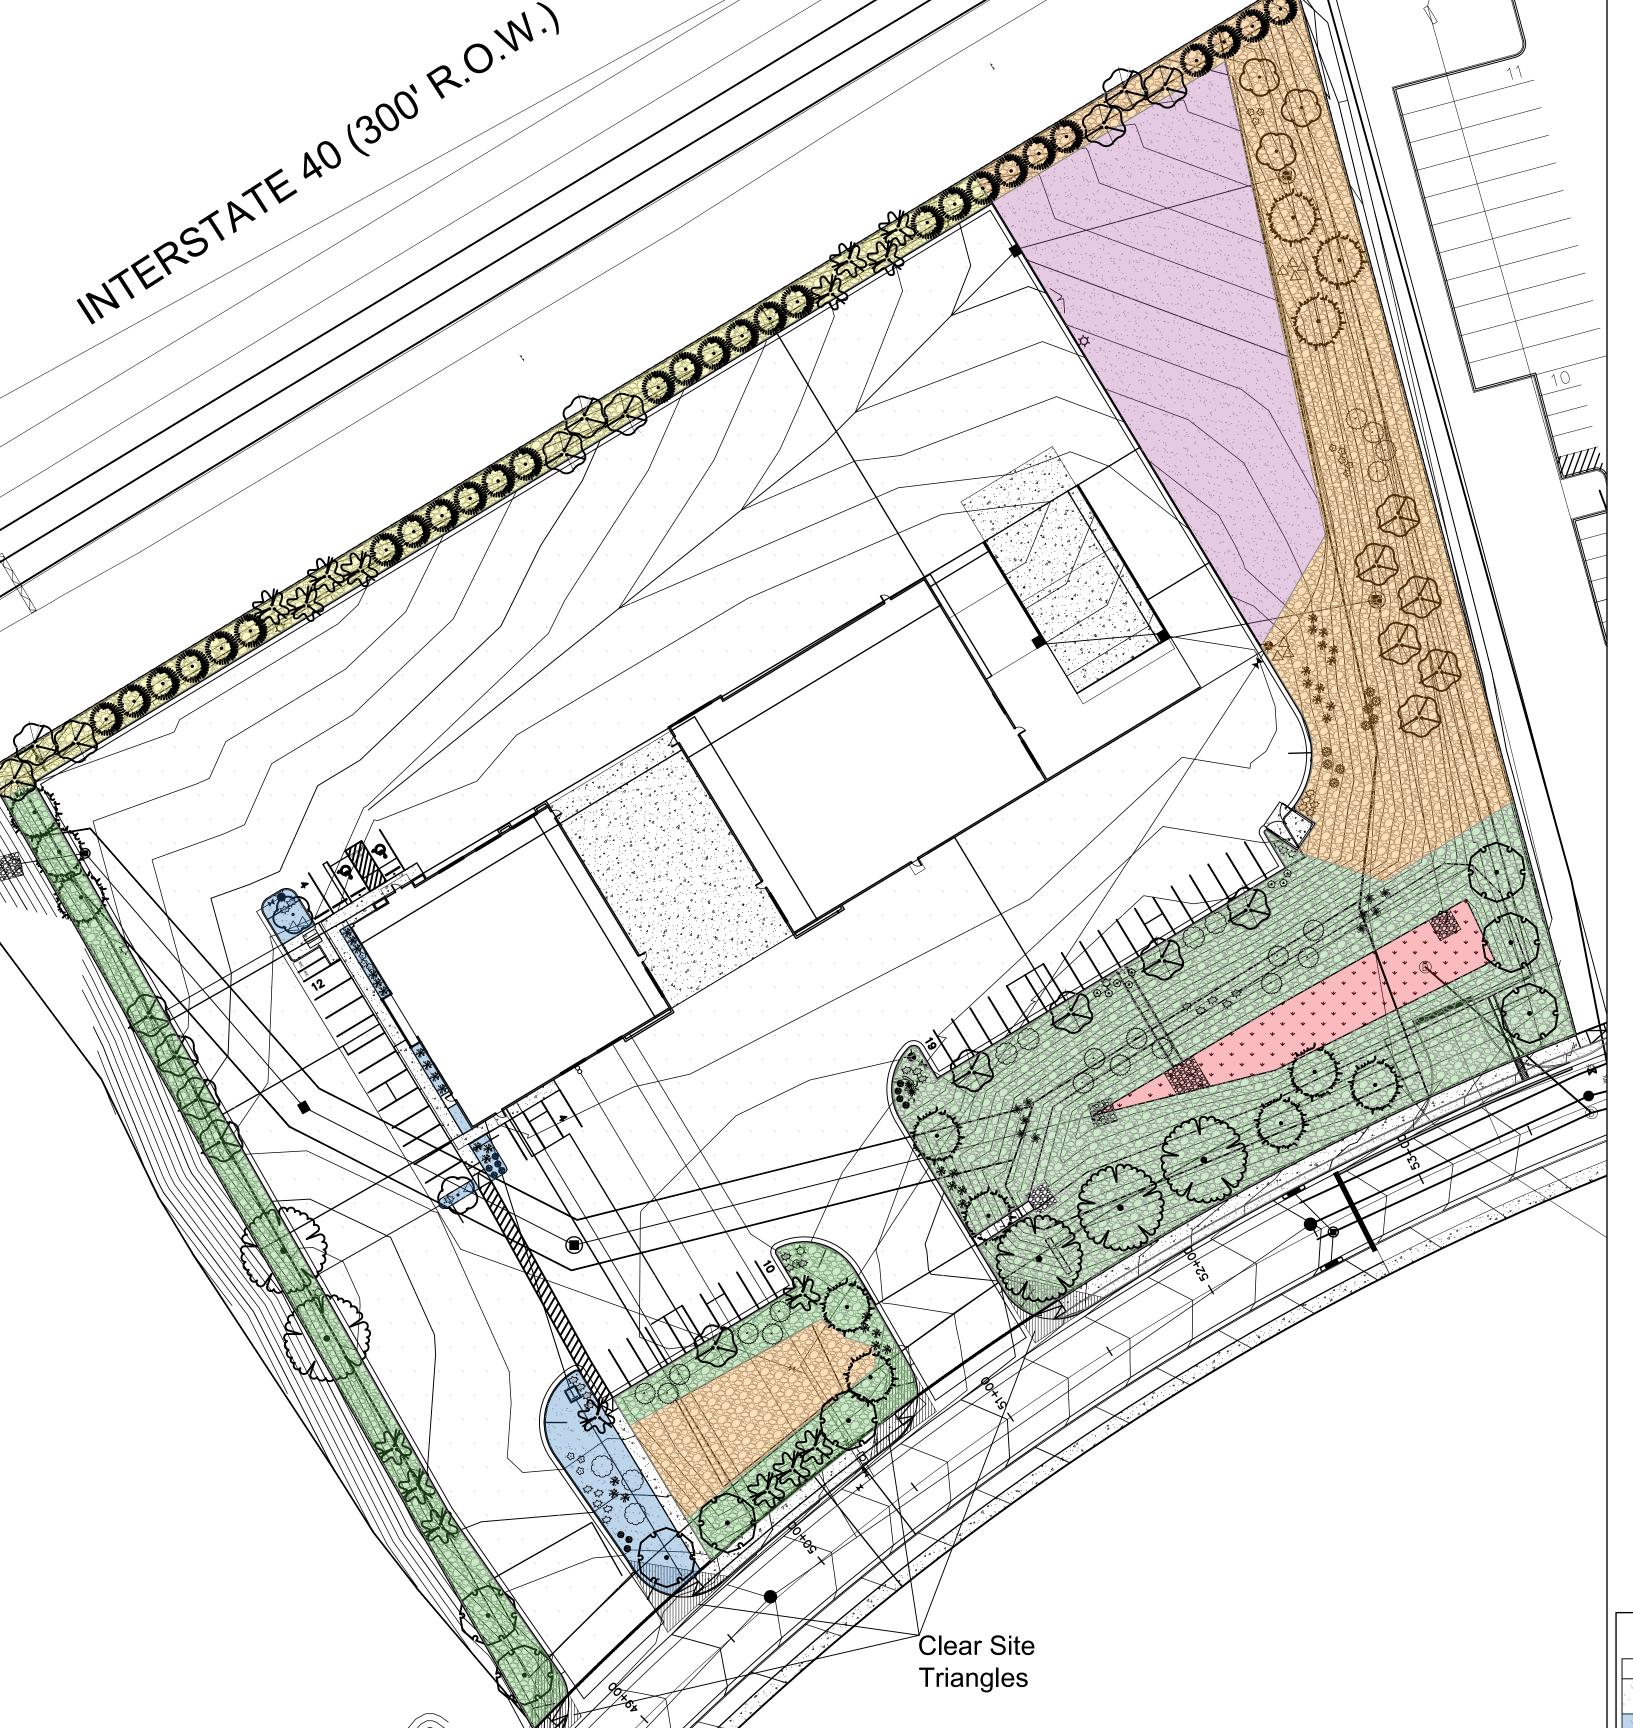

CONSTRUCTION NOTES:

seed growth.

Native seed mix for appropriate soil per city specifications 1012.2.1.

Gravel over seeded area shall be only one layer deep to promote native

MATURE HXW WATER USE COVER (EA.) TOTAL 8' x 15' Upright Juniper Total Tree Coverage: 54275 4' x 12' Total Shrub Coverage: 4095

ZONING	NR-BP: N	ON-RESIDENTIAL BUSINESS PARK	
APPLICABLE REGULATION(S)	IDO 14-16-5-6 AND PART 6-6-2 OF ROA 1994		
TOTAL LOT AREA (ACRES)	5.83	GROUNDCOVER (% - REQ)	18.75
TOTAL LOT AREA (SF)	253757	GROUNDCOVER (SF - REQ)	16913
BUILDING AREA (SF)	223 <i>00</i>	GROUNDCOVER (SF - PROV.)	4095
NET LOT AREA (SF)	231,457		
		PARKING LOT AREA (SF)	4500
REQUIRED LANDSCAPE (%)	15	REQ. PARKING LANDSCAPE 10% (SF)	450
REQUIRED LANDSCAPE (SF)	34719	PROV. PARKING LANDSCAPE (SF)	4500
LANDSCAPE PROVIDED (SF)	90203	REQ. PARKING TREES (1/10 SPOTS)	5
		PROV. PARKING TREES	9
VEGETATIVE COVER (% - REQ)	75.0		
VEGETATIVE COVER (SF - REQ)	67652	COOL SEASON GRASS (SF)	Ø
VEGETATIVE COVER (6F - PROV.)	5837Ø	COOL SEASON GRASS (% OF LANDSCAPE)	0.0
REQ. TREES - 1ST AND 2ND STORY UNITS	28		
PROVIDED UNIT TREES	71		

Other Materials				
SYMB.	atr		TYPE	
	1322	SF	Landscape Gravel A with Filter Fabric 3/4" Crushed Gray Gravel	
	3165	SF	Landscape Gravel A with Filter Fabric / Plantings 3/4" Crushed Gray Gravel	
	15892	SF	Landscape Gravel A / No Filter Fabric ¾" Crushed Gray Gravel	
	3 595 8	SF	Oversize Landscape Gravel / Plantings / Native Seed / No Filter Fabric 2-4" Angular Cobble/RipRap	
	24983	SF	Oversize Landscape Gravel / Native Seed / No Filter Fabric 2-4" Angular Cobble/RipRap	
	6694	SF	Oversize Landscape Gravel / Vegetative Sceen Plantings / Native Seed / No Filter Fabric 2-4" Angular Cobble/RipRap	
* * *	3511	SF	Native Seeding, No Gravel Native Seed (HYDROMULCH)	
4 4			Concrete See site plan	

PLANTING NOTES

ALL PLANTS TO CONTAIN BARK MULCH AROUND THE ROOTBALL, TO THE EXTENT TO COVER THE DRIP LINES.

GENERAL NOTES IT IS THE INTENT OF THIS PLAN TO COMPLY WITH APPLICABLE CITY WATER CONSERVATION LANDSCAPING AND WATER WASTE ORDINANCE PLANTING RESTRICTION APPROACH.

APPROVAL OF THIS PLAN DOES NOT CONSTITUTE OR IMPLY EXEMPTION FROM WATER

WASTE PROVISIONS OF THE WATER CONSERVATION LANDSCAPING AND WATER WASTE

LANDSCAPE MAINTENANCE SHALL BE THE RESPONSIBILITY OF THE PROPERTY OWNER. THE PROPERTY OWNER SHALL MAINTAIN STREET TREES IN A LIVING, HEALTHY, AND ATTRACTIVE CONDITION.

APPROVAL OF THIS PLAN DOES NOT CONSTITUTE OR IMPLY EXEMPTION FROM WATER WASTE PROVISIONS OF THE WATER CONSERVATION LANDSCAPING AND WATER WASTE ORDINANCE. WATER MANAGEMENT IS THE SOLE RESPONSIBILITY OF THE PROPERTY OWNER. ALL LANDSCAPING WILL BE IN CONFORMANCE WITH THE CITY OF ALBUQUERQUE ZONING CODES, LAND—USE ORDINANCES, AND WATER CONSERVATION LANDSCAPING AND WATER WASTE ORDINANCE. IN GENERAL, WATER CONSERVATIVE, ENVIRONMENTALLY SOUND LANDSCAPE PRINCIPLES WILL BE FOLLOWED IN DESIGN AND INSTALLATION.

GRAY GRAVEL OVER FILTER FABRIC TO A MINIMUM DEPTH OF 3" SHALL BE PLACED IN ALL LANDSCAPE AREAS WHICH ARE NOT DESIGNATED TO RECEIVE NATIVE SEED OR OTHER HATCHED GROUNDCOVER AREA. ALL GRAVEL SHALL BE PLACED .5"-1" LOWER THAN ADJACENT HARD SURFACES.

PRIOR TO CONSTRUCTION, LANDSCAPE CONTRACTOR SHALL VERIFY LOCATION OF ALL UTILITY LINES. IN CASE OF A DISCREPANCY BETWEEN UTILITIES INDICATED ON PLAN AND ACTUAL FIELD VERIFICATION, CONTRACTOR SHALL CEASE WORK AND NOTIFY LANDSCAPE ARCHITECT IMMEDIATELY FOR DIRECTIONS ON HOW TO PROCEED.

POSITIVE DRAINAGE AWAY FROM ALL STRUCTURES IS TO REMAIN AFTER ALL LANDSCAPE WORK IS COMPLETED.

IRRIGATION NOTES:

IRRIGATION SYSTEM MAINTENANCE AND OPERATION SHALL BE THE SOLE RESPONSIBILITY OF THE OWNER. IT SHALL BE THE OWNERS RESPONSIBILITY TO ENSURE THAT FUGITIVE WATER DOES NOT LEAVE THE SITE DUE TO OVERWATERING OR MALFUNCTIONING EQUIPMENT.


ALL ON-SITE PLANT MATERIAL, NEW AND EXISTING, SHALL BE IRRIGATED BY COMPLETE, AUTOMATIC DRIP IRRIGATION WITH SUBTERRANEAN LATERALS. TREES SHALL RECEIVE ONE (1) NETAFIM SPIRAL (50' LENGTH) WITH 3 LOOPS AT A FINAL RADIUS OF 4.5' FROM TREE TRUNK, PINNED IN PLACE. NETAFIM SHALL HAVE EMITTERS 12" O.C. WITH A FLOW OF .6 GPH. SHRUBS TO RECEIVE (2) 1.0 GPH DRIP EMITTERS. DRIP AND BUBBLER SYSTEMS TO BE TIED TO 1/2" POLYPIPE WITH FLUSH CAPS AT EACH END. RUN TIME PER EACH SHRUB DRIP VALVE WILL BE APPROXIMATELY 15 MINUTES PER DAY. TREE DRIP VALVE SHALL RUN 1.5 HOURS, 3 TIMES PER WEEK. RUN TIME WILL BE ADJUSTED ACCORDING TO THE SEASON.

POINT OF CONNECTION FOR IRRIGATION SYSTEM IS UNKNOWN AT CURRENT TIME AND WILL BE COORDINATED IN THE FIELD. IRRIGATION WILL BE OPERATED BY AUTOMATIC CONTROLLER.

LOCATION OF CONTROLLER TO BE FIELD DETERMINED AND POWER SOURCE FOR CONTROLLER TO BE PROVIDED BY OTHERS.

IRRIGATION MAINTENANCE SHALL BE THE RESPONSIBILITY OF THE PROPERTY OWNER.

WATER AND POWER SOURCE SHALL BE THE RESPONSIBILITY OF THE DEVELOPER/BUILDER.

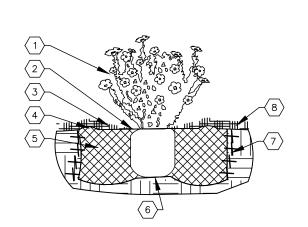

\bigcirc SHRUB PLANTING KEYED NOTES

- SHRUB LOCATION, SPECIES, AND CONDITION AS PER PLAN.
 INSTALL WITH TOP OF ROOT BALL FLUSH WITH SUBGRADE (BOTTOM OF MULCH)
 USE WOOD CHIP MULCH OVER ROOTBALL, FEATHERED TO A 2" DEPTH AND HELD BACK 2"
 FROM TRUNKS AND STEMS AND TO COVER DRIPLINE.
- 2. "HIGH X 8" UIDE BERM

 5. BACKFILL PER SPECIFICATIONS, LIGHTLY TAMP IN LIFTS AND WATER-IN TO ELIMINATE VOIDS AND AIR POCKETS.


 6. UNDISTURBED NATIVE SOIL.

 7. SCARIFY AND LOOSEN EDGES OF PLANTING PIT.

 8. MULCH SEE PLANTING PLAN. 3" DEPTH UNLESS OTHERWISE NOTED.

SHRUB PLANTING

SHRUB PLANTING DETAIL

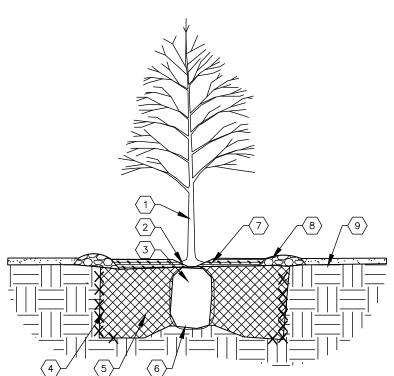

TREE PLANTING KEYED NOTES

- TREE LOCATION, SPECIES, AND CONDITION AS PER PLAN. REMOVING EXISTING SOIL (FROM NURSERY) AS NEEDED TO EXPOSE ROOT FLARE. INSTALL
- WITH ROOT FLARE FLUSH WITH SUBGRADE (BOTTOM OF MULCH)
 INSTALL TREE PLUMB. REMOVE WIRE BASKET, WOOD BOX, PLASTIC, TWINE, AND/OR ROPE
 PRIOR TO BACKFILL. REMOVE BURLAP EXCEPT FROM BOTTOM OF ROOT BALL.
- SCARIFY AND LOGEN EDGES OF PLANTING PIT.
 BACKFILL PER SPECIFICATIONS, LIGHTLY TAMP IN LIFTS AND WATER-IN TO ELIMINATE VOIDS
- AND AIR POCKETS.

 6. UNDISTURBED NATIVE SOIL UNDER ROOTBALL TO PREVENT SETTLING.


 7. INSTALL WOOD CHIP ORGANIC MULCH OVER ROOTBALL AND TO COVER DRIP LINE.
 GENERALLY, MULCH SHOULD BE HELD 4" BACK FROM TREE TRUNK

 8. 4" HIGH X 16" WIDE COBBLE BERM AT DRIP LINE.

 9. MULCH SEE PLANTING PLAN

02 TREE PLANTING TREE PLANTING DETAIL


SCALE: 1" = 40'-0"

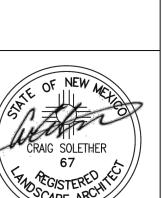



JUNE 9, 2021

TheHillep

SHEET #

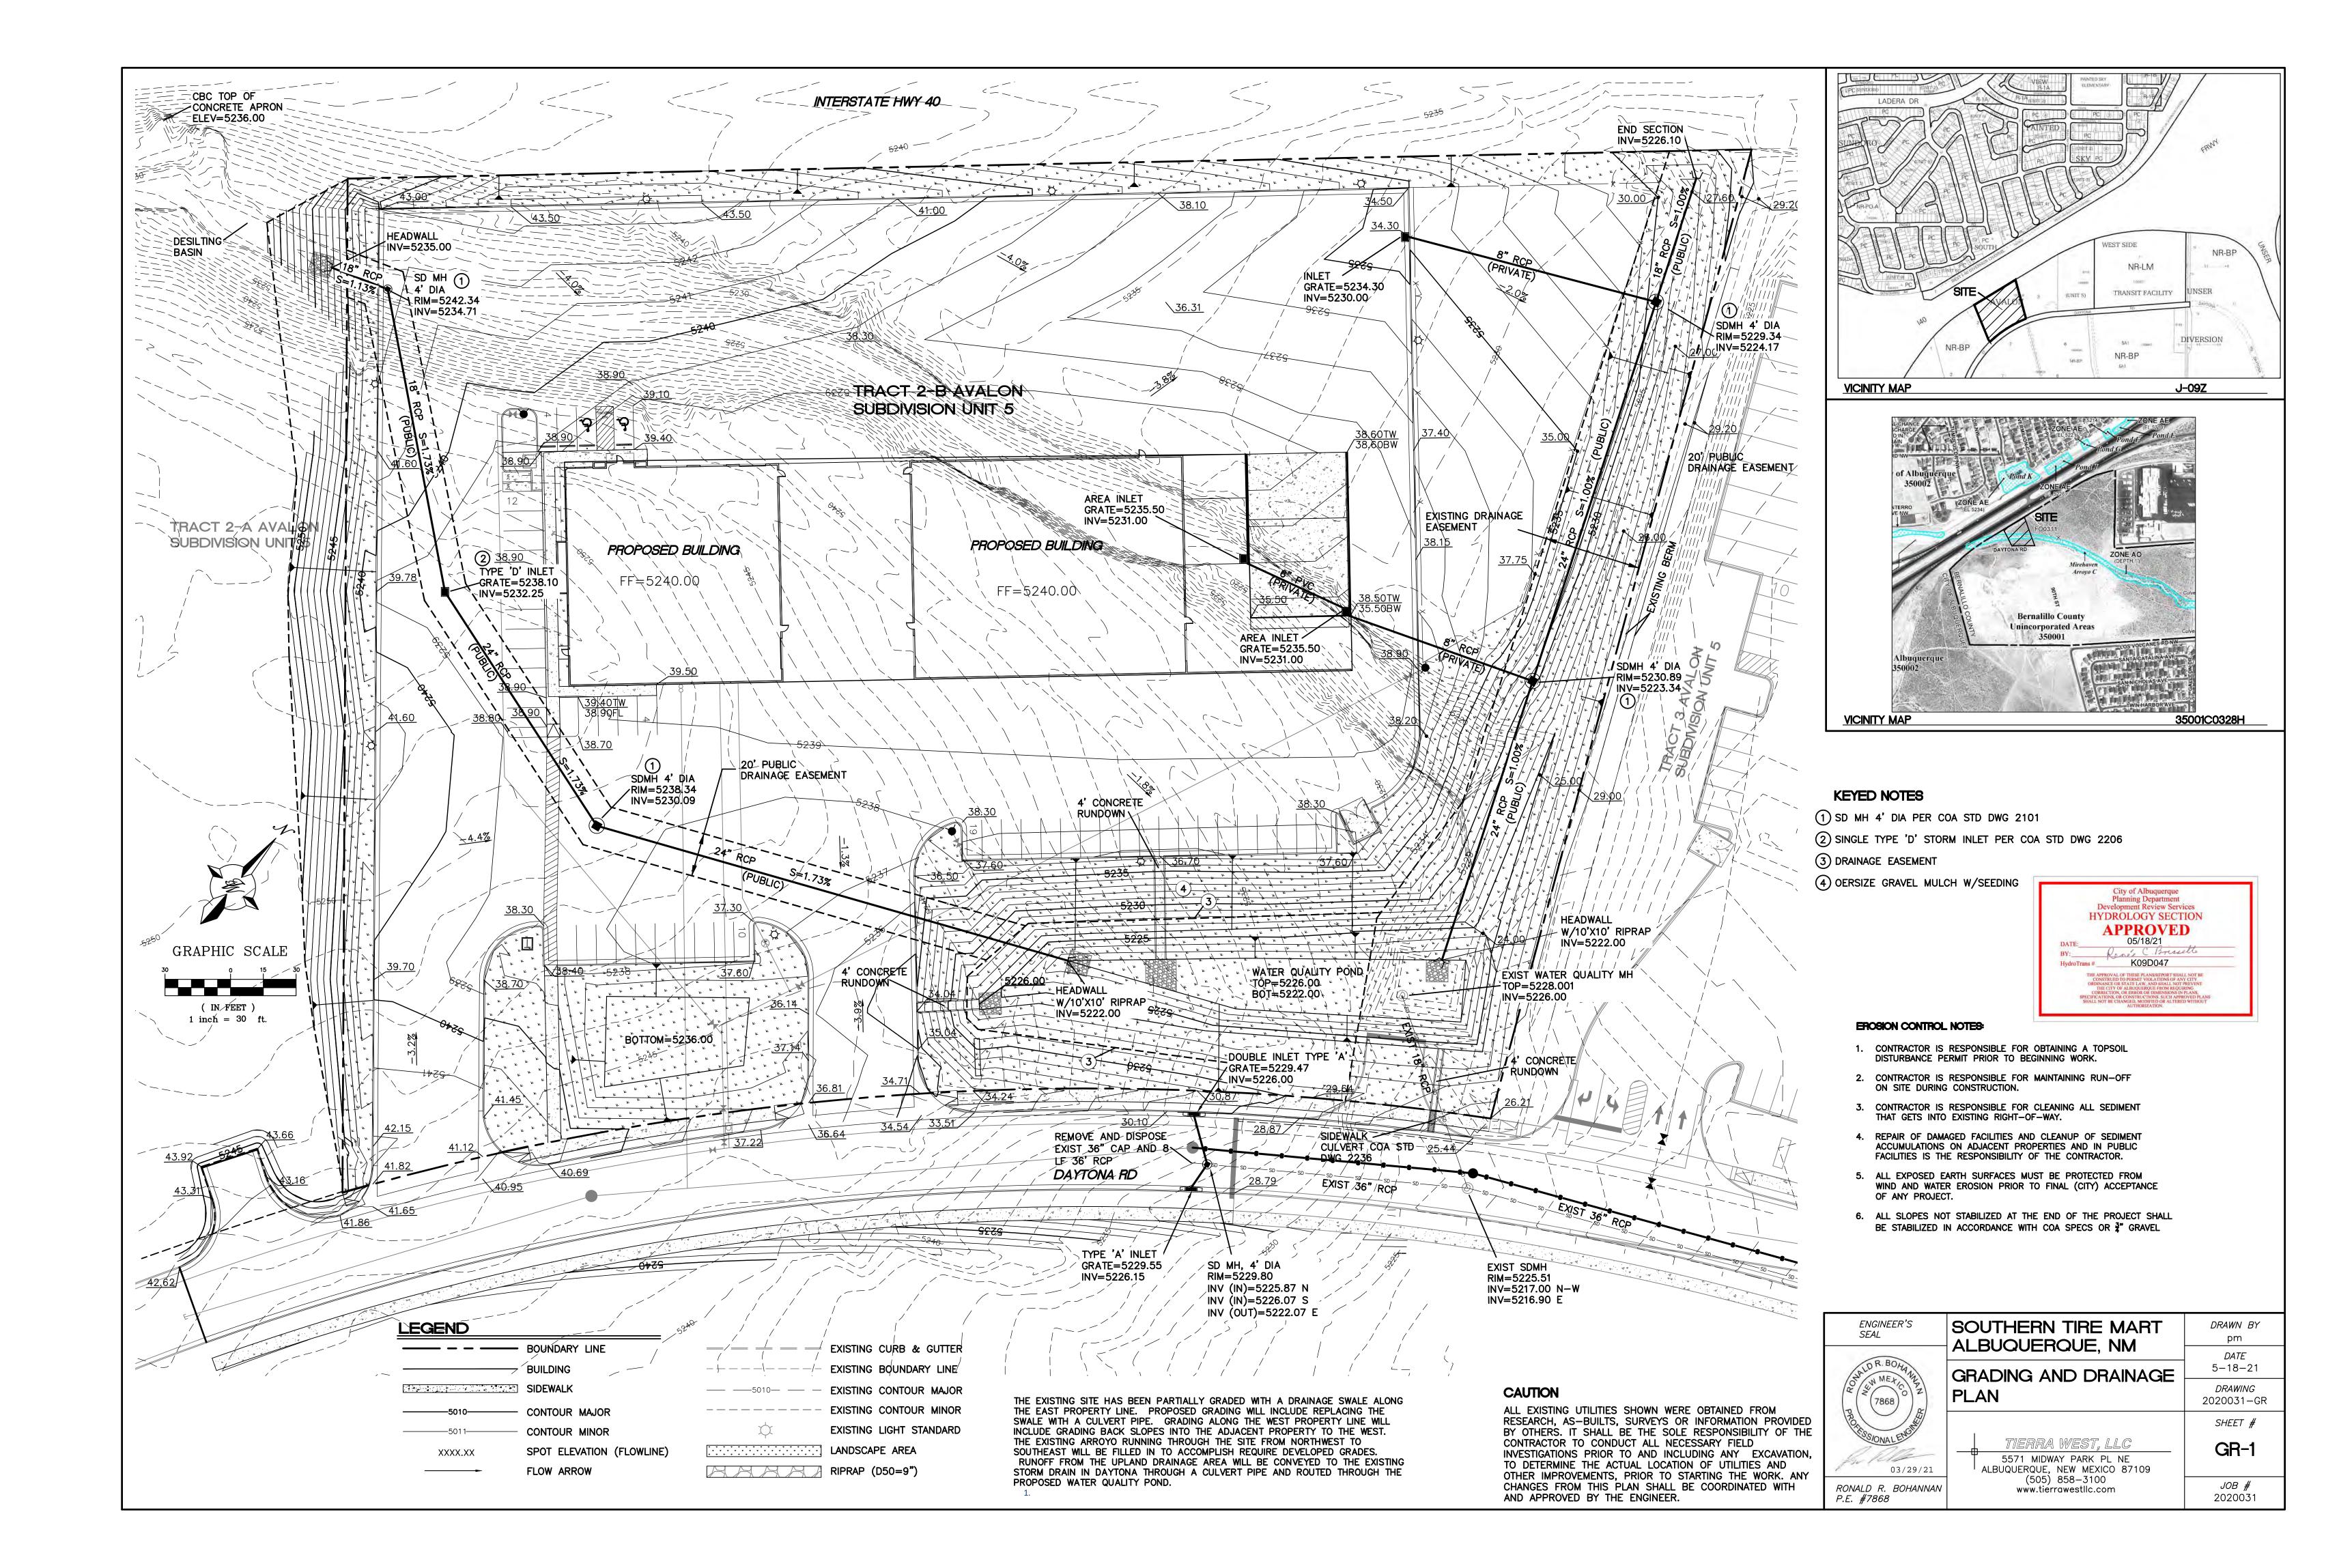

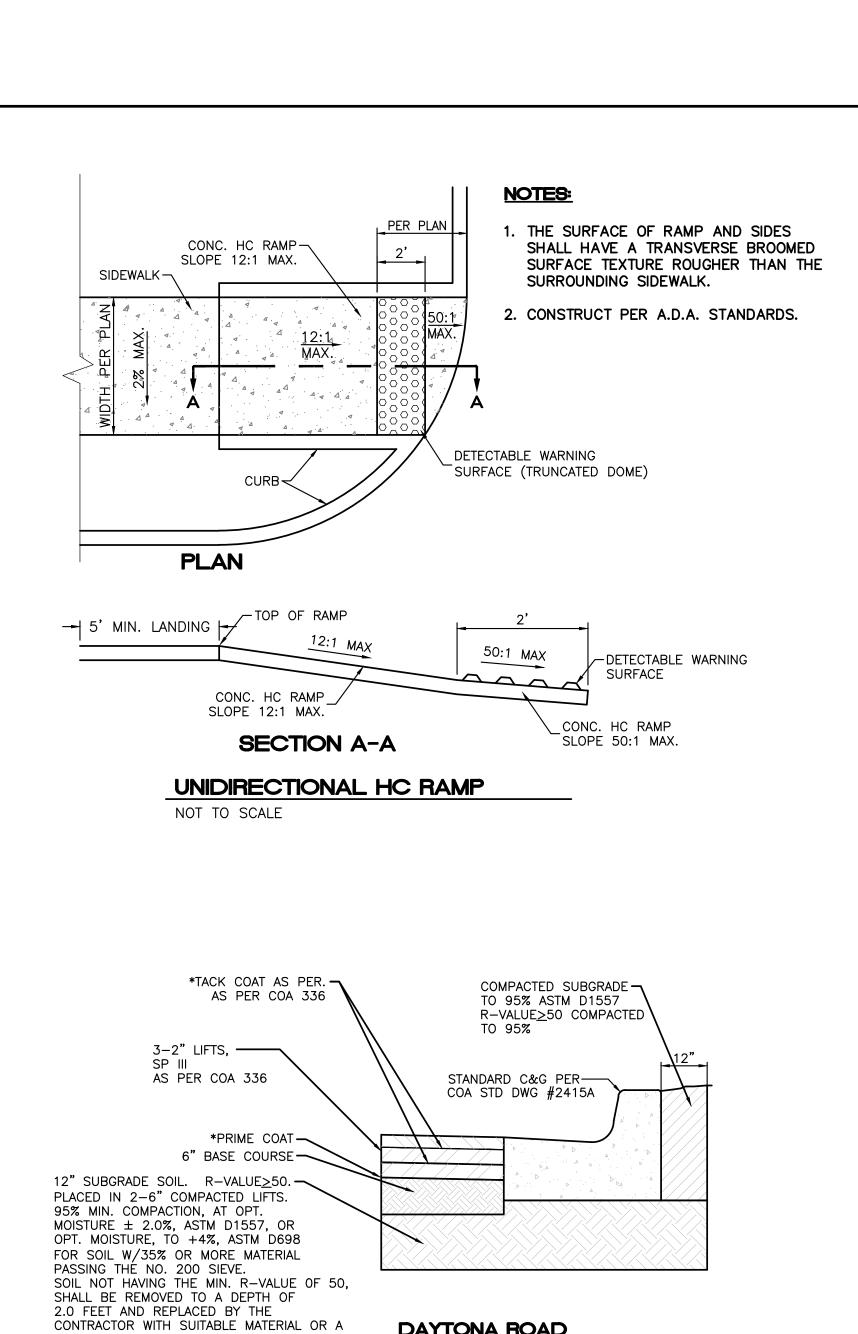

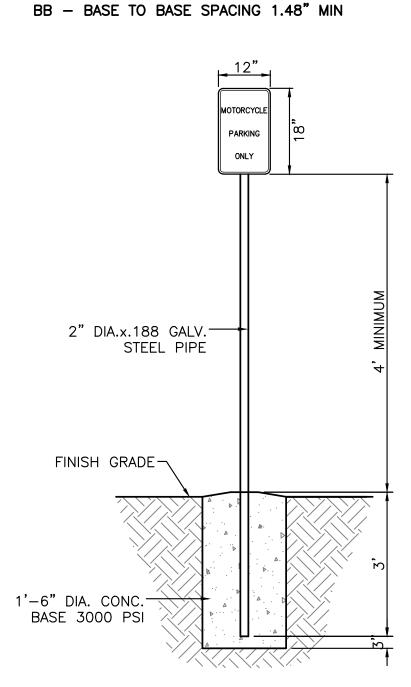

┌0.25" MAX

DOME SECTION

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+00000


DOME SPACING

→ |- BB

CC - CENTER TO CENTER SPACING 2.35"

BD - BASE DIAMETER 0.9" MIN

MOTORCYCLE PARKING SIGN

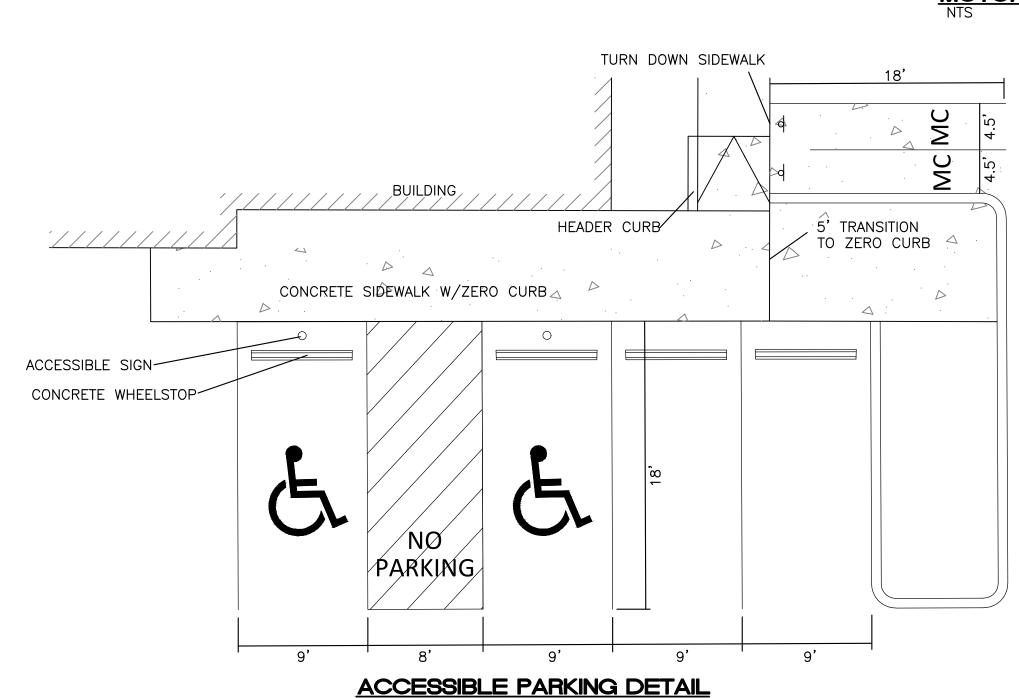

DAYTONA ROAD

PAVING SECTION


(PER COA STD DWG #2407 W/TRUCK TRAFFFIC>5%)

PAVEMENT SHALL BE DESIGNED BY TIERRA

WEST, LLC ACCOMMODATING THE EXISTING

R-VALUE (R≥50) PER C.O.A. STANDARD SPECIFICATIONS.


UNLESS WAIVED IN FIELD BY COA ENGINEERS REPRESENTATIVE

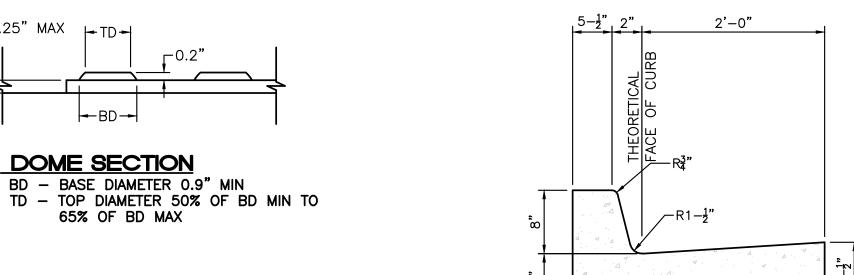


CURB GENERAL NOTES: 1. ALL CURBS TO BE CONSTRUCTED OF PORTLAND CEMENT CONCRETE, PER WAL-MART SPECIFICATIONS. 2. PROVIDE CONTRACTION JTS. 12' MAX., SPACING, 1/2" EXP. JTS. AT CURB RETURNS AND AT A MAX. SPACING OF 120' BETWEEN CURB RETURNS AND EACH SIDE OF SEPARATELY CONSTRUCTED DRIVEWAYS. CONTRACTION JTS., SHALL BE EITHER SAWED OR TOOLED A MINIMUM OF 1" DEEP AT FINISHED FACES. 3. ALL EDGES SHALL BE EDGED WITH A 3/8" RADUIS EDGING TOOL. 4. 1/4" ISOLATION JOINT SHALL BE PLACED BETWEEN

SIDEWALK AND CURB WHEN CAST ADJACENT TO EACH OTHER.

8' STANDARD CURB / GUTTER

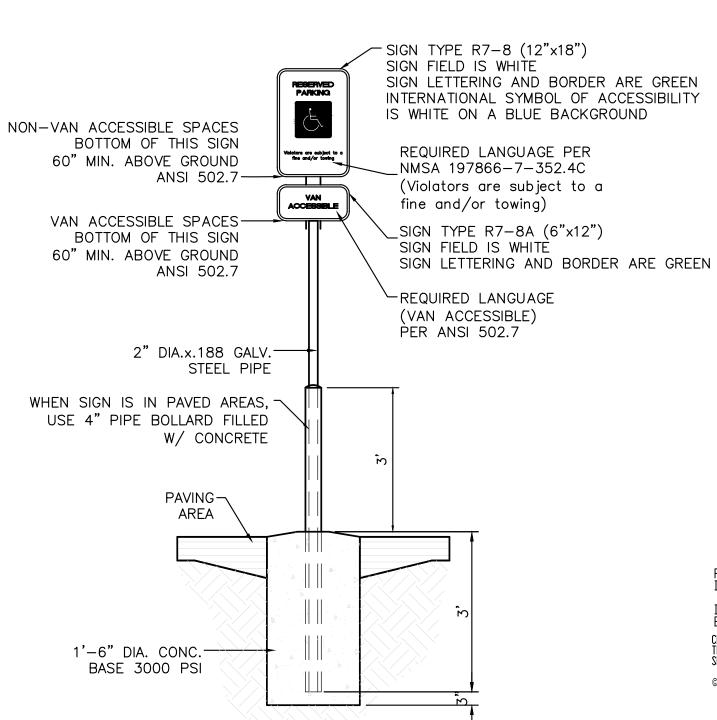

ACCESSIBLE PARKING SIGN

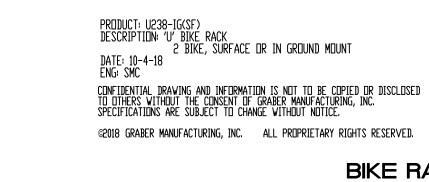

□ SURFACE FLANGE MOUNT (SF) INSTALL BIKE RACKS ACCORDING TO MANUFACTURER'S SPECIFICATIONS.
CONSULTANT TO SELECT COLOR (FINISH), SEE MANUFACTURER'S SPECIFICATIONS.
SEE SITE PLAN FOR LOCATION OR CONSULT OWNER.

 \triangle

PLAN VIEW

Ø 2 3/8" STEEL TUBING—

CHECK DESIRED MOUNT

3" X 6" X 3/8" THICK 2 Ea. 7/16" SQ. HDLE TYP. —

GRADE

-ANCHOR ROD

___CONCRETE


☐ IN GROUND MOUNT (IG)


MADRAX DIVISION

-CONCRETE

BIKE RACK DETAIL SCALE: NONE

ENGINEER'S SEAL	SOUTHERN TIRE MART ALBUQUERQUE, NM	<i>DRAWN BY</i> pm
DR. BOH	·	<i>DATE</i> 6–8–21
OWN MEXICO ZZ 7868)	CONSTRUCTION DETAILS	<i>DRAWING</i> 2020031—DET
PROTESSIONAL ENGINE		SHEET #
06/09/2021	TIERRA WEST, LLC 5571 MIDWAY PARK PL NE ALBUQUERQUE, NEW MEXICO 87109	DET-1
RONALD R. BOHANNAN P.E. #7868	(505) 858-3100 www.tierrawestllc.com	<i>JOB #</i> 2020031

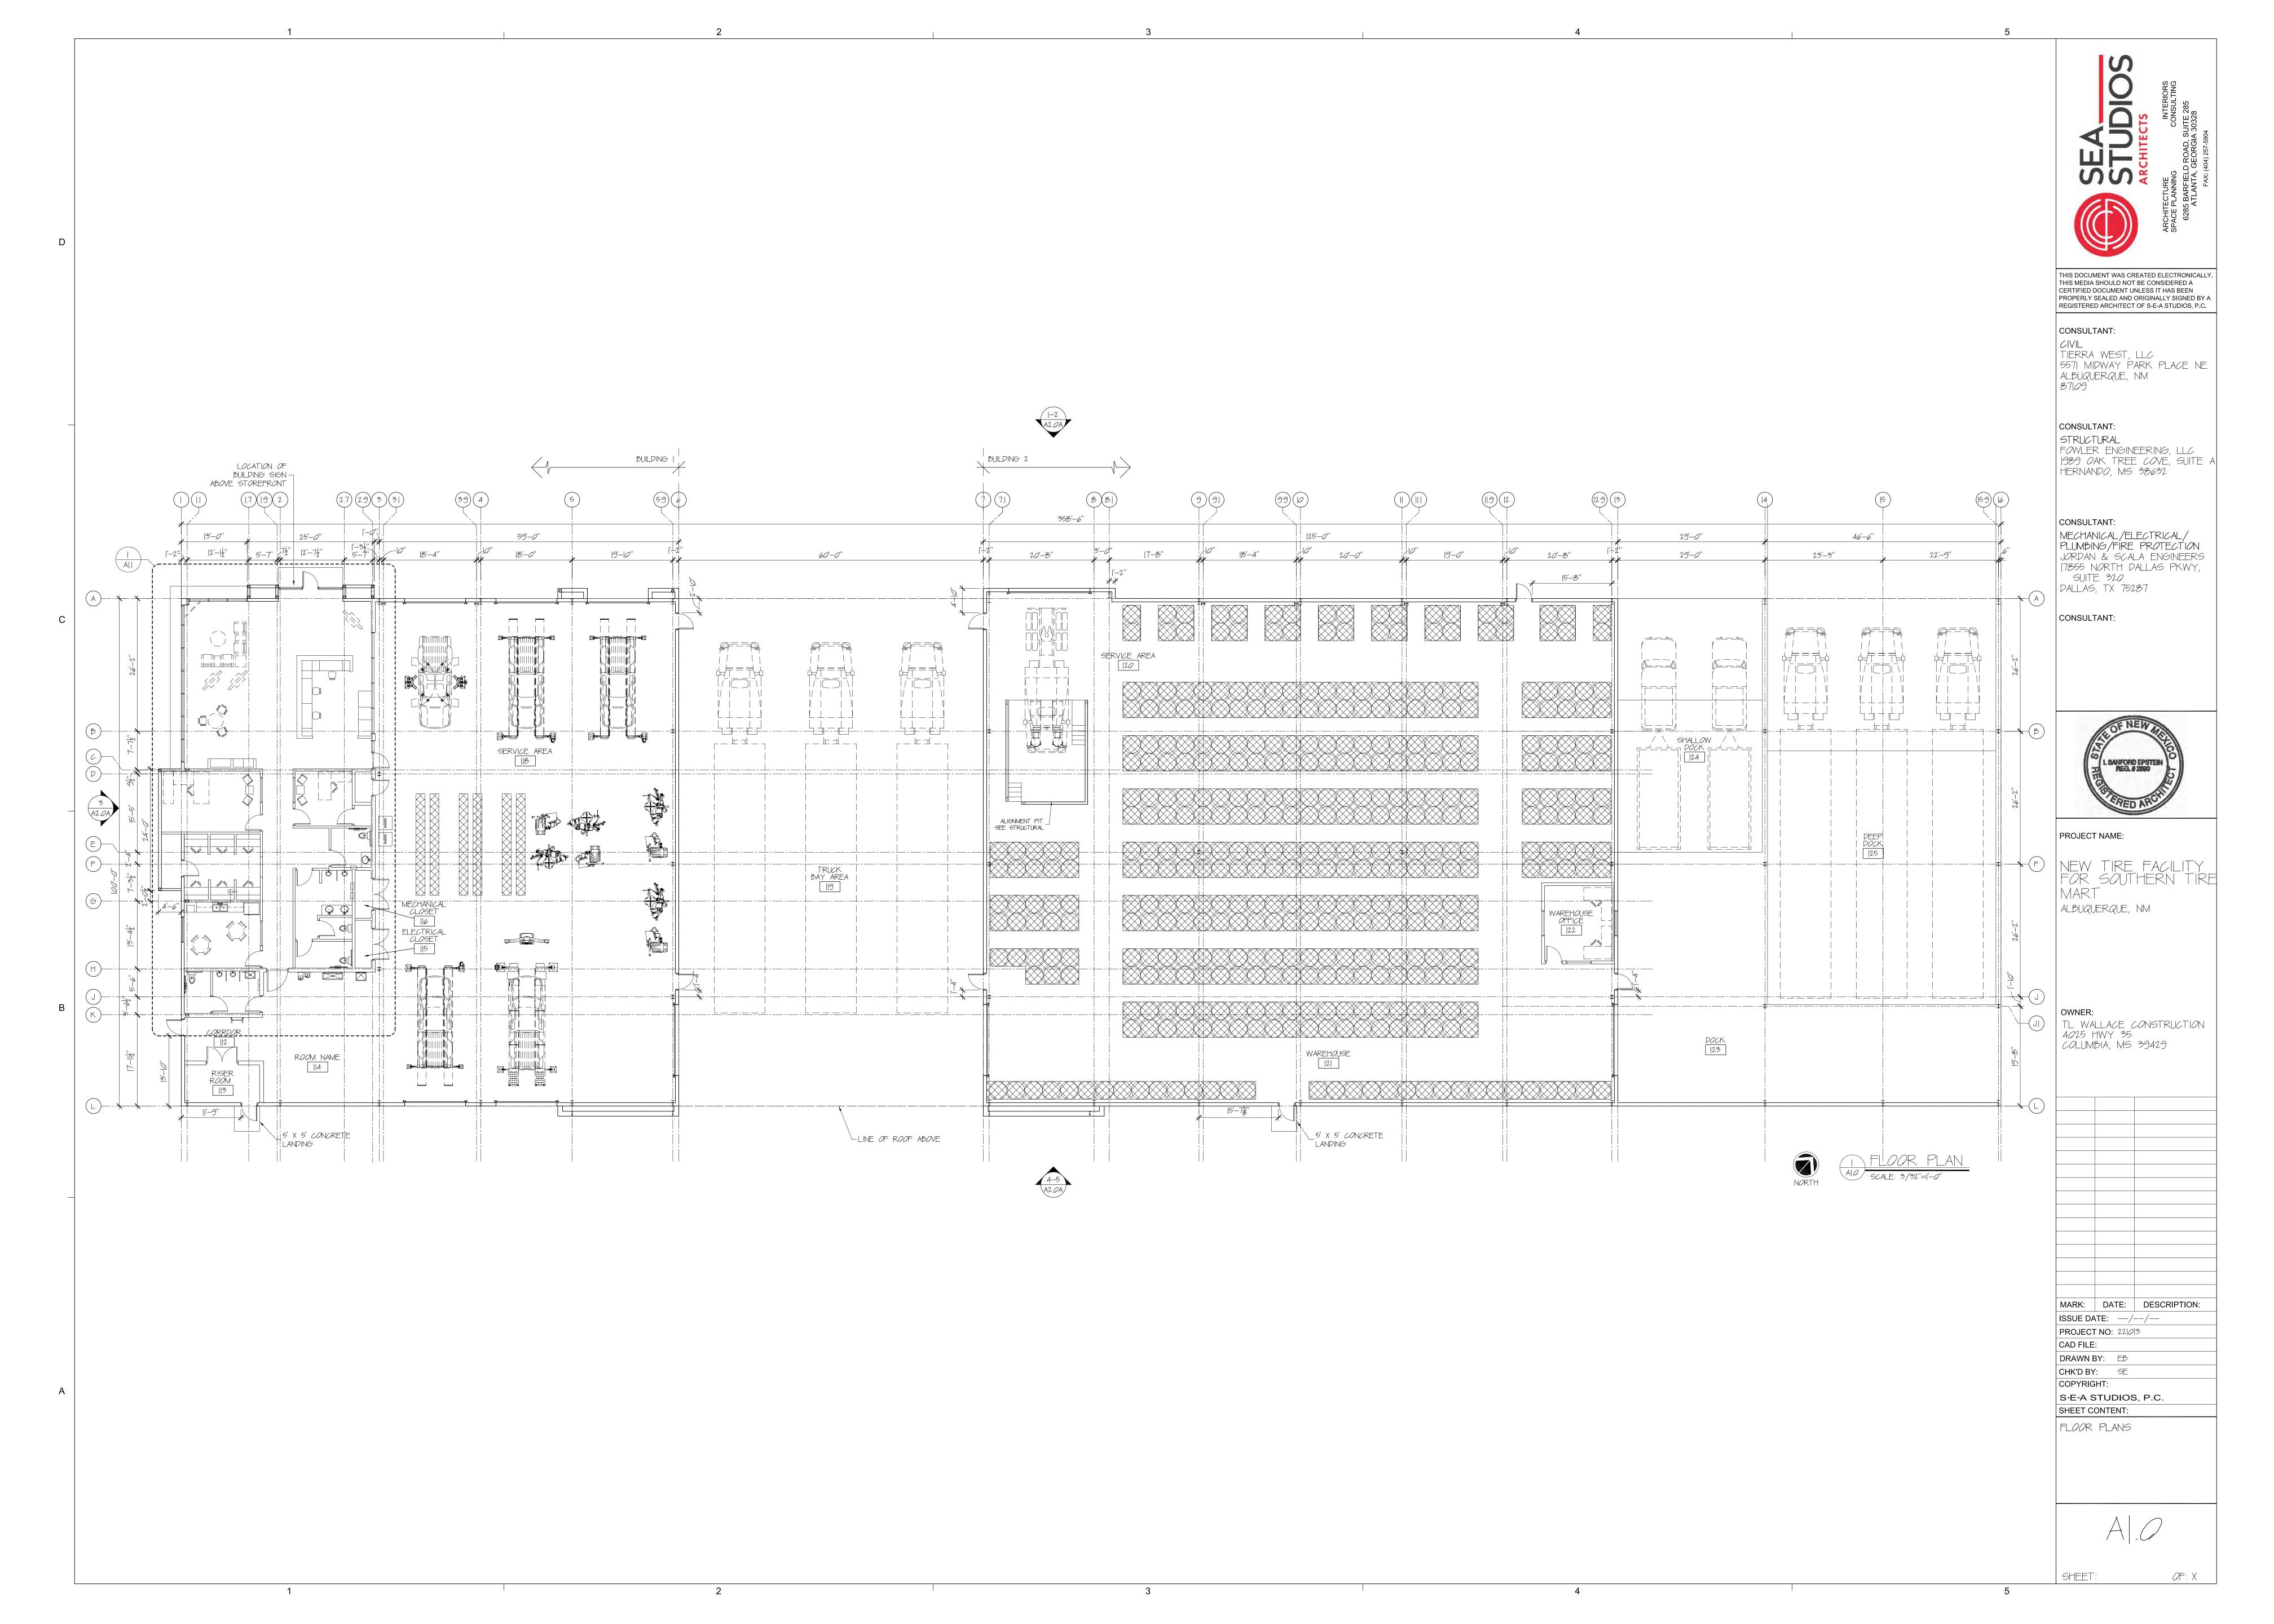

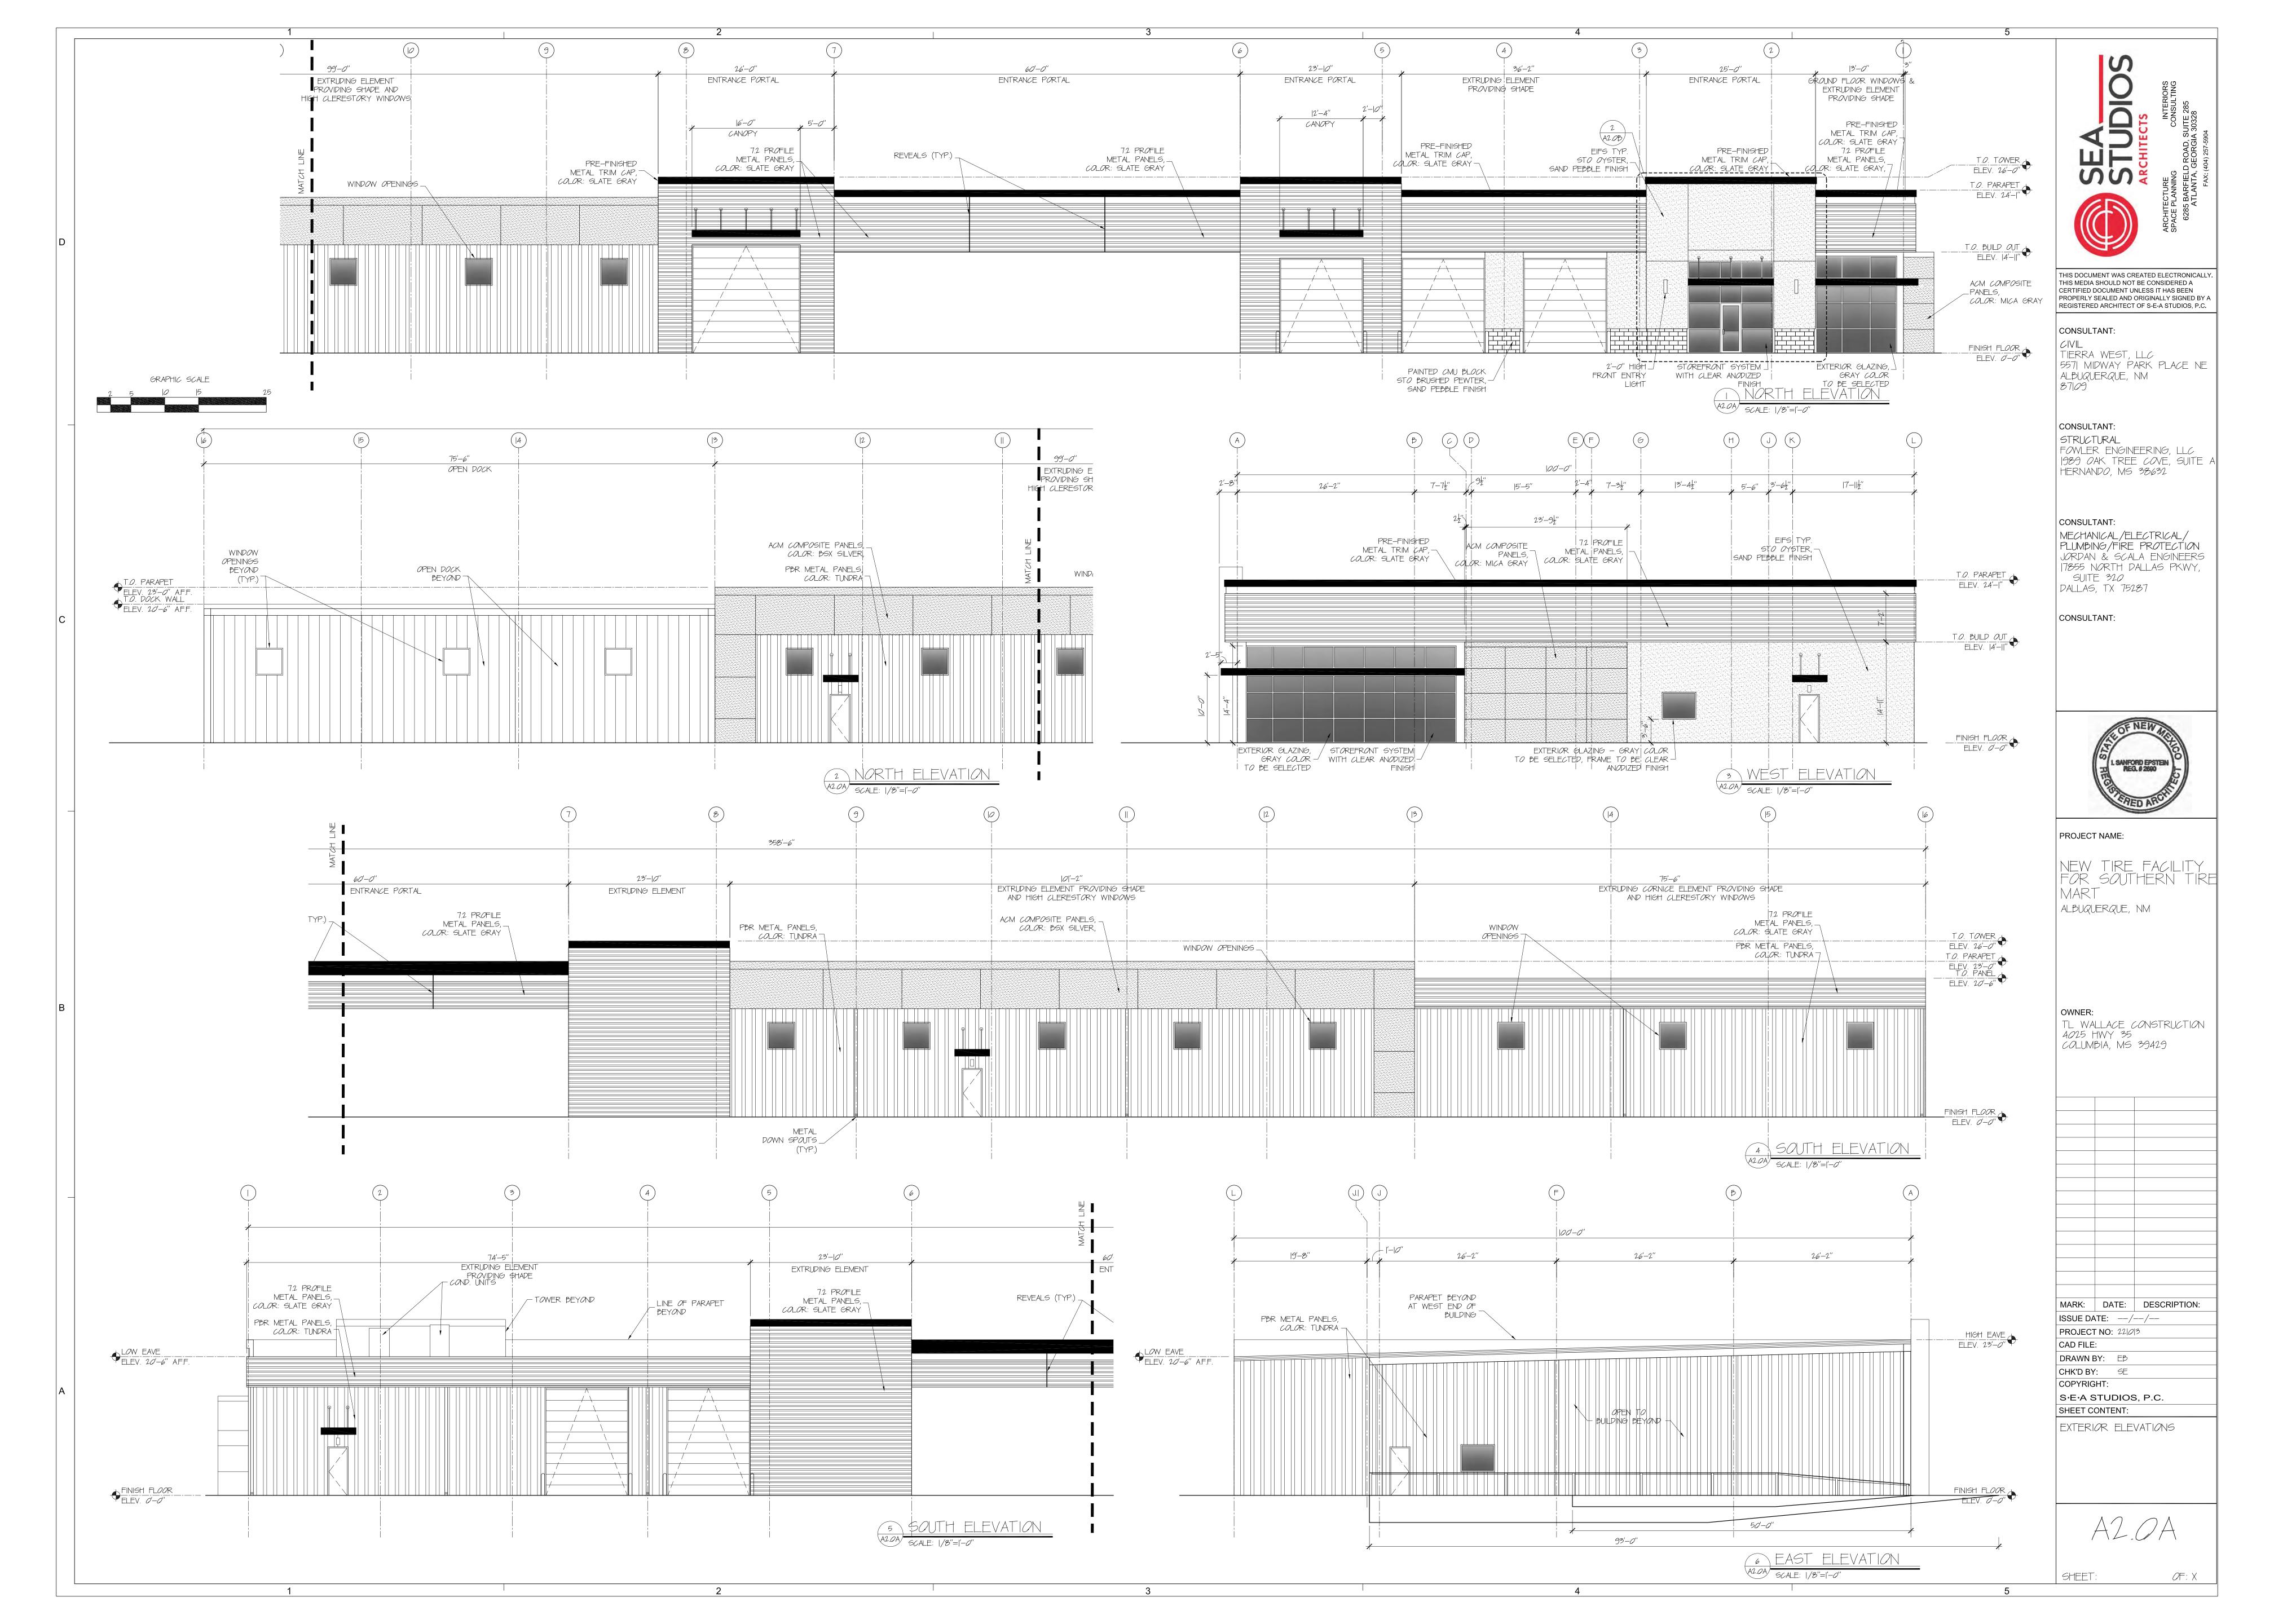

LIST OF APPLICABLE RESTRICTIONS PER THE INTEGRATED DEVELOPMENT ORDINANCE (IDO), CITY OF ALBUQUERQUE, NM. PROJECT LOCATED WITHIN ZONE NR-BP

<u>5-|2(E)(2) LOCATION:</u>

5-12(E)(2)(A): NO SIGN OR PART OF A SIGN SHALL BE LOCATED ON ANY PROPERTY WITHOUT CONSENT OF THE OWNER, HOLDER, LESSEE, AGENT, TRUSTEE OR OTHER PARTY CONTROLLING THE USE OF SUCH PROPERTY.

5-12(E)(2)(B): SIGNS SHALL NOT BE LOCATED WITHIN PUBLIC WATERLINE OR SANITARY SEWER EASEMENTS.

5-12(E)(4) DESIGN AND CONSTRUCTION:

5-12(E)(4)(A): ALL SIGNS SHALL BE CONSTRUCTED OF DURABLE MATERIAL AND MAINTAINED IN GOOD CONDITION AND REPAIR, SHALL BE SÉCURELY ANCHORED AND CONSTRUCTED TO PREVENT LATERAL MOVEMENT THAT WOULD CAUSE WEAR ON SUPPORTING CONNECTIONS, AND SHALL BE CONSTRUCTED TO WITHSTAND EXPECTED WIND LOADS APPROPRIATE TO DESIGN AND INSTALLATION.

5-12(E)(4)(B): NO SIGN MAY HAVE OVERHEAD WIRING TO SUPPLY ELECTRICAL POWER, EXCEPT FOR A FREESTANDING OFF-PREMISES SIGN WHERE UNDERGROUND POWER CANNOT BE ACCESSED FROM THE SITE. 5-12(E)(4)(D): BUILDING-MOUNTED SIGNS, WITH THE EXCEPTION OF WALL SIGNS, SHALL NOT EXTEND MORE THAN 2 FEET ABOVE THE WALL OF A BUILDING, EXCEPT IN THE FOLLOWING SMALL AREAS - EAST DOWNTOWN-CPO-4, EAST DOWNTOWN-HPO-1, NOB HILL/HIGHLAND-CPO-8, UPTOWN AREA.

5-12(E)(5) ILLUMINATION AND MOTION:

8 SECONDS.

5-|2(E)(5)(A): GENERAL I. SIGNS MAY BE INTERNALLY OR EXTERNALLY LIT, PROVIDED THAT THE LIGHT SOURCE IS NOT DIRECTLY VISIBLE FROM THE PUBLIC RIGHT-OF-WAY OR FROM ADJACENT PROPERTIES UNLESS SPECIFIED OTHERWISE IN THIS IDO.

2. NO PORTION OF AN ILLUMINATED SIGN SHALL HAVE A LUMINANCE GREATER THAN 200 FOOT LAMBERTS OR 685 NITS AT NIGHT 3. NO SIGN OR ANY PART OF ANY SIGN SHALL MOVE OR ROTATE AT A RATE OF MORE THAN ONCE EACH 10 SECONDS, WITH THE EXCEPTION OF WIND DEVICES, THE MOTION OF WHICH IS NOT RESTRICTED. 4. NO SIGN OR ANY PART OF ANY SIGN SHALL CHANGE ITS MESSAGE OR PICTURE AT A RATE OF MORE THAN ONCE EACH

5-12(E)(5)(C): MIXED-USE AND NON-RESIDENTIAL ZONE DISTRICTS

AN ILLUMINATED SIGN OR ILLUMINATED ELEMENT OF A SIGN IN ANY MIXED-USE OR NON-RESIDENTIAL ZONE DISTRICT MAY TURN ON OR OFF OR CHANGE ITS BRIGHTNESS, PROVIDED THAT THE FOLLOWING REQUIREMENTS ARE MET, UNLESS SUBSECTION 14-16-5-12(H)(4) (ILLUMINATION, BRIGHTNESS, AND IMAGES) APPLIES ANY MORE RESTRICTIVE STANDARD OR SUBSECTION

|4-|6-5-|2(F)(4)(A) (NEON SIGNS ALONG CENTRAL AVENUE) APPLIES ANY LESS RESTRICTIVE STANDARD TO ELIGIBLE SIGNS. I. THE SIGN IS NOT WITHIN 200 FEET IN ANY DIRECTION OF ANY RESIDENTIAL ZONE DISTRICT AND VISIBLE FROM THAT ZONE DISTRICT.

2. THE SIGN IS NOT WITHIN 330 FEET IN ANY DIRECTION OF MAJOR PUBLIC OPEN SPACE. 3. CHANGE OF ILLUMINATION DOES NOT PRODUCE ANY APPARENT MOTION OF THE VISUAL IMAGE, INCLUDING BUT NOT LIMITED TO ILLUSION OF MOVING OBJECTS, MOVING PATTERNS OR BANDS OF LIGHT, EXPANDING OR CONTRACTING SHAPES, OR ANY SIMILAR

EFFECT OF ANIMATION EXCEPT TWINKLING. 4. THERE IS NO CONTINUOUS OR SEQUENTIAL FLASHING IN WHICH MORE THAN 🕏 OF THE LIGHTS ARE TURNED ON OR OFF AT ONE TIME.

5-12(F)(2) SIGNS IN MIXED-USE AND NON-RESIDENTIAL ZONE DISTRICTS:


5-|2(F)(2)(A): GENERAL 1. THE PROVISIONS IN TABLE 5-12-2 AND THIS SUBSECTION 14-16-5-12(F)(2) APPLY TO ALL SIGNS THAT ARE NOT LOCATED WITHIN ANY RESIDENTIAL ZONE DISTRICT UNLESS SPECIFIED OTHERWISE IN THIS IDO.

	remises Signs in Mixed-use and Non-residential Zone Districts Zone District		
Sign Type	Mixed-use Zone Districts, NR-C, NR-LM, NR-GM	NR-BP, NR-SU, NR PO, PD, PC	
Wall Sign			
Number, maximum	N/A		
Area, maximum	Shall not exceed the following percentages of façade area, inclusive of door and window openings: MX-T, MX-FB-ID: 5% MX-L: 10% MX-M, MX-H, MX-FB-FX, MX-FB-AC, MX-FB-UD, NR-C: 15% NR-LM, NR-GM: 25%	Per approved plan ^{[2}	
Location	Where there is no side setback between 2 establishment frontages in the same or abutting buildings, no wall sign may extend closer than 2 feet to the shared edge of the frontage.		
Window Sign	No more than 15% of window and door areas may be cover	ed with signs.	
	On the ground floor, between 4 feet and 8 feet above ground level, limited to 25% of that area.	window signs shall b	
Canopy Sign		WARRY WILL 100 CO.	
Number, maximum	1 / establishment frontage MX-FB: 1 / entry/exit		
Width, maximum	50% of building frontage width MX-FB-AC, MX-FB-UD: full building frontage width	Per approved plan	
Height of message surface, maximum	Letters and images must be located on vertical surf which may not exceed 18 in. height	aces,	
Marquee Sign	e de la constitución de la const		
Number, maximum	A marquee sign is allowed in lieu of – not in addition to – an allowable wall sign. 1 / theater or performance venue frontage.	Per approved plan ^{[3}	
Area, maximum	Same as allowable maximum area of wall sign.		
Height of message surface, maximum	3 ft, MX-FB-AC, MX-FB-UD: 5 ft.		
Projection, maximum			
Projecting Sign			
Number, maximum ^[2]	1 / establishment MX-H and MX-FB: 1 / establishment frontage	Per approved plan	
Area, maximum	Same as allowable maximum size of freestanding sign.		
Projection, maximum	30 in. from the façade		
	In the DT area and North 4th Corridor — CPO-9, if the lower edge of sign is ≥12 ft. above sidewalk: • 50% of the distance over any abutting sidewalk • 75% of the distance over any abutting sidewalk on Central Avenue between 1st and 8th Streets		
Rooftop Sign		12 100 140 - 221 160 - 221 - 17	
Number, maximum	1 / building Rooftop signs are only allowed in small areas pursuant to Subsection 14-16-5-12(F)(3) (Standards Applicable in Small areas).	Per approved plan	
Area, maximum Height, maximum	75 sq. ft. 15 ft. or 25% of the height of the building, whichever is less.		

Revised and Updated Through November 2020

Integrated Development Ordinance

City of Albuquerque, New Mexico

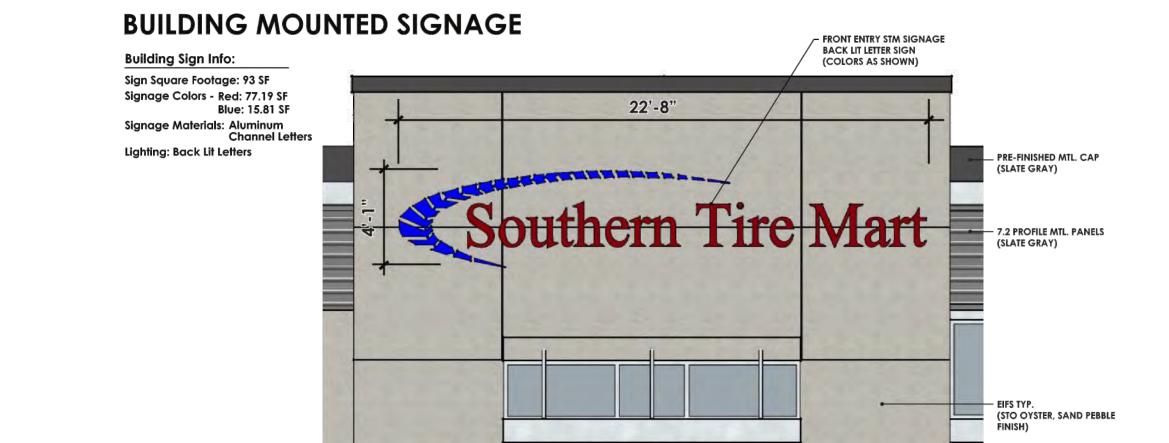

FRONT SIGNAGE ELEVATION A2.0B SCALE: 1/8"=1'-0"

- PAINTED CMU BLOCK (STO BRUSHED PEWTER, SAND PEBBLE FINISH)

Sign Type	Zone District		
	Mixed-use Zone Districts, NR-C, NR-LM, NR-GM	NR-BP, NR-SU, NR- PO, PD, PC	
Number, maximum ^[2]	1 / premises / street frontage. A freestanding sign is allowed only where there is at least 100 feet of street frontage. or 1 / Joint Sign Premises, pursuant to Subsection 14-16-5-12(F)(2)(b).		
Area, maximum	MX-T, MX-FB-ID: 50 sq. ft. MX-L: 100 sq. ft. Any other Mixed-use zone district, NR-C, NR-LM, NR-GM: 100 sq. ft. at allowable locations abutting a local or collector street. 200 sq. ft. at allowable locations abutting an arterial street or interstate highway. 300 sq. ft. at allowable locations within 200 feet of a through lane of an interstate highway and visible from the interstate highway.	Per approved plan ^{[1}	
Height, maximum ^[3]	MX-T, MX-FB-ID: 9 ft. MX-L: 18 ft. Any other Mixed-use zone district, NR-C, NR-LM, NR-GM: 26 ft.		

[2] For premises where freestanding signs are allowed, for each street frontage, either a freestanding sign or projecting signs are allowed, not

[3] For any freestanding sign that is within 200 feet of a through lane of an interstate highway, the maximum height is measured from the

both (i.e. projecting signs can be used on any street frontage where a freestanding sign is not used).

highway road grade at the closest point from the premises.



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CONSULTANT: TIERRA WEST, LLC 557| MIDWAY PARK PLACE NE ALBUQUERQUE, NM

CONSULTANT: STRUCTURAL FOWLER ENGINEERING, LLC 1989 OAK TREE COVE, SUITE A HERNANDO, MS 38632

CONSULTANT: MECHANICAL/ELECTRICAL/ PLUMBING/FIRE PROTECTION JORDAN & SCALA ENGINEERS 17855 NORTH DALLAS PKWY, SUITE 320

DALLAS, TX 75287

CONSULTANT:



PROJECT NAME:

ALBUQUERQUE, NM

TL WALLACE CONSTRUCTION 4025 HWY 35 COLUMBIA, MS 39429

MARK: DATE: DESCRIPTION: ISSUE DATE: --/--/--PROJECT NO: 22/0/3 CAD FILE: DRAWN BY: Eか

CHK'D BY: 5E COPYRIGHT: S·E·A STUDIOS, P.C. SHEET CONTENT:

EXTERIOR ELEVATIONS AND IDO RESTRICTIONS

SHEET:

OF: X



PR-2020-004747_SI-2021-00484_Site_Plan_Ap proved_6-23-21

Final Audit Report 2021-07-07

Created: 2021-06-25

By: Jay Rodenbeck (jrodenbeck@cabq.gov)

Status: Signed

Transaction ID: CBJCHBCAABAALwK3mw9f_8syOQ2jjfMnxZ04g3mYXHLi

"PR-2020-004747_SI-2021-00484_Site_Plan_Approved_6-23-21 "History

- Document created by Jay Rodenbeck (jrodenbeck@cabq.gov) 2021-06-25 7:18:57 PM GMT- IP address: 143.120.132.106
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