

DEVELOPMENT REVIEW BOARD SUPPLEMENTAL SUBMITTAL

(Deadline is Friday at noon unless noted on DRB calendar – late submittals will not be accepted unless approved by the DRB)

PROJECT NO. <u>PR-2020-004820</u> Application No. <u>SI-2020-001468</u>

TO:

- \underline{X} Planning Department/Chair
- \underline{X} Hydrology
- $\underline{\chi}$ Transportation Development
- <u>X</u> ABCWUA
- <u>X</u> Code Enforcement
- <u>X</u> Parks & Rec

*(Please attach this sheet with each collated set for each board member)

NOTE: ELECTRONIC VERSION (ie disk, thumbdrive) is Required. Submittal will not be accepted without.

DRB SCHEDULED HEARING DATE: 4/21/21

HEARING DATE OF DEFERRAL: 3/31/21

SUBMITTAL DESCRIPTION: Updated site plan set, comment response memo, current infrastructure list, and supporting exhibits.

CONTACT NAME: Michael Vos, AICP or Jim Strozier, FAICP

 TELEPHONE: (505) 764-9801
 EMAIL: vos@consensusplanning.com or cp@consensusplanning.com



Memorandum

To: Jolene Wolfley and DRB Members, City of Albuquerque

From: Michael Vos, AICP, Consensus Planning, Inc.

Date: April 15, 2021

Re: Hotel Circle Ramada Apartment Conversion DRB Update (PR-2020-004820)

This memo provides updates on the proposed apartment conversion based on the comments received at the March 31, 2021 DRB meeting. The comments are numbered, and responses are in bold italics.

<u>Hydrology</u>

1. All comments have been addressed. No objection.

a. Noted

Transportation Development

- 1. The sidewalk width waiver is approved.
 - a. Understood.
- 2. Include a shared access agreement with adjacent neighbor. Coordinate with neighbor on driveway prior to the work order.
 - a. Coordination with the neighbor is ongoing. The Applicant requests that final form and agreement be considered as delegation with Planning to check prior to final signature.
- 3. The required number of handicapped spaces is 8, but the number shown on the plan is 7. (On the details it implies that there is more than what is shown on the site plan at notes for A1/103.) Maybe this is where the discrepancy is. Clarify for both details.
 - a. The parking spaces were clarified to identify all 8 required spaces more clearly.
- 4. There is a B4 in the details but not on the site plan.
 - a. The detail reference for the ADA space on the east side of the site has been updated to correctly reflect this detail.
- 5. At A1/103, there needs to be header curb labeled where there is a grade difference in the sidewalk alongside the ramp. This also applies to detail B4.
 - a. Detail updated.
- 6. At B4/103, at the bottom of the ramp that is parallel to the aisle should have 2% maximum cross-slope labeled in both directions for wheelchair turning. Same applies for B2.
 - a. Detail updated.

<u>ABCWUA</u>

- PREVIOUS COMMENT: Availability statement #201213 is in holding as a fire one plan is required. UPDATE: The fire one plan has been received with this submittal and has been provided for inclusion in the availability statement review.
 - a. We understand that the availability statement has been researched and is under review.

- 2. The Building #6 and southeast building exhibit on the encroachment and additional easement have been received. This will be reviewed with ABCWUA Legal and Water Operations. An encroachment notice is possibly needed regardless of the additional easement.
 - a. We received further comment from Blain Carter via email regarding the encroachments and relationship between the easements on site and the proposed landscape plan. We have updated the landscape plan to relocate the trees within the courtyard out of the waterline easement and eliminate the trees that were proposed in the perimeter sewer easement at the south side of the site. The existing fence that is within the courtyard is not shown on the plan as it will be removed by this redevelopment. The only remaining encroachments are two existing trees and the buildings that have previously been discussed. The Applicant requests specific direction from the Water Authority regarding what is required regarding these longstanding site features that encroach in the easement, other than the previously discussed additional easement and notice of encroachment. Attached are additional exhibits prepared by the Civil Engineer, Isaacson & Arfman, regarding the location of the existing waterline and building encroachments.
- 3. Infrastructure list

The location of the fire lines has been revised as requested. Thank you. The private fire lines have been relocated outside of the public waterline easement. Thank you.

a. Noted.

4. PREVIOUS COMMENT: For information only.

Currently the single account for the property is for commercial. Given that the use is changing from hotel to multi-family residential, the account shall be adjusted to reflect the multi-family customer class.


Applicant acknowledged in response to comments and indicated this will take place in the redevelopment process.

With the removal of the restaurant from the plan, a separate account for the commercial class may still be required, depending on the use of the proposed space. Upon proposed use of this space, ABCWUA approval is required, and a separate account and metered connection may be required.

a. Understood.

Planning

No other new comments were received from Planning, Code Enforcement, or Parks and Recreation.

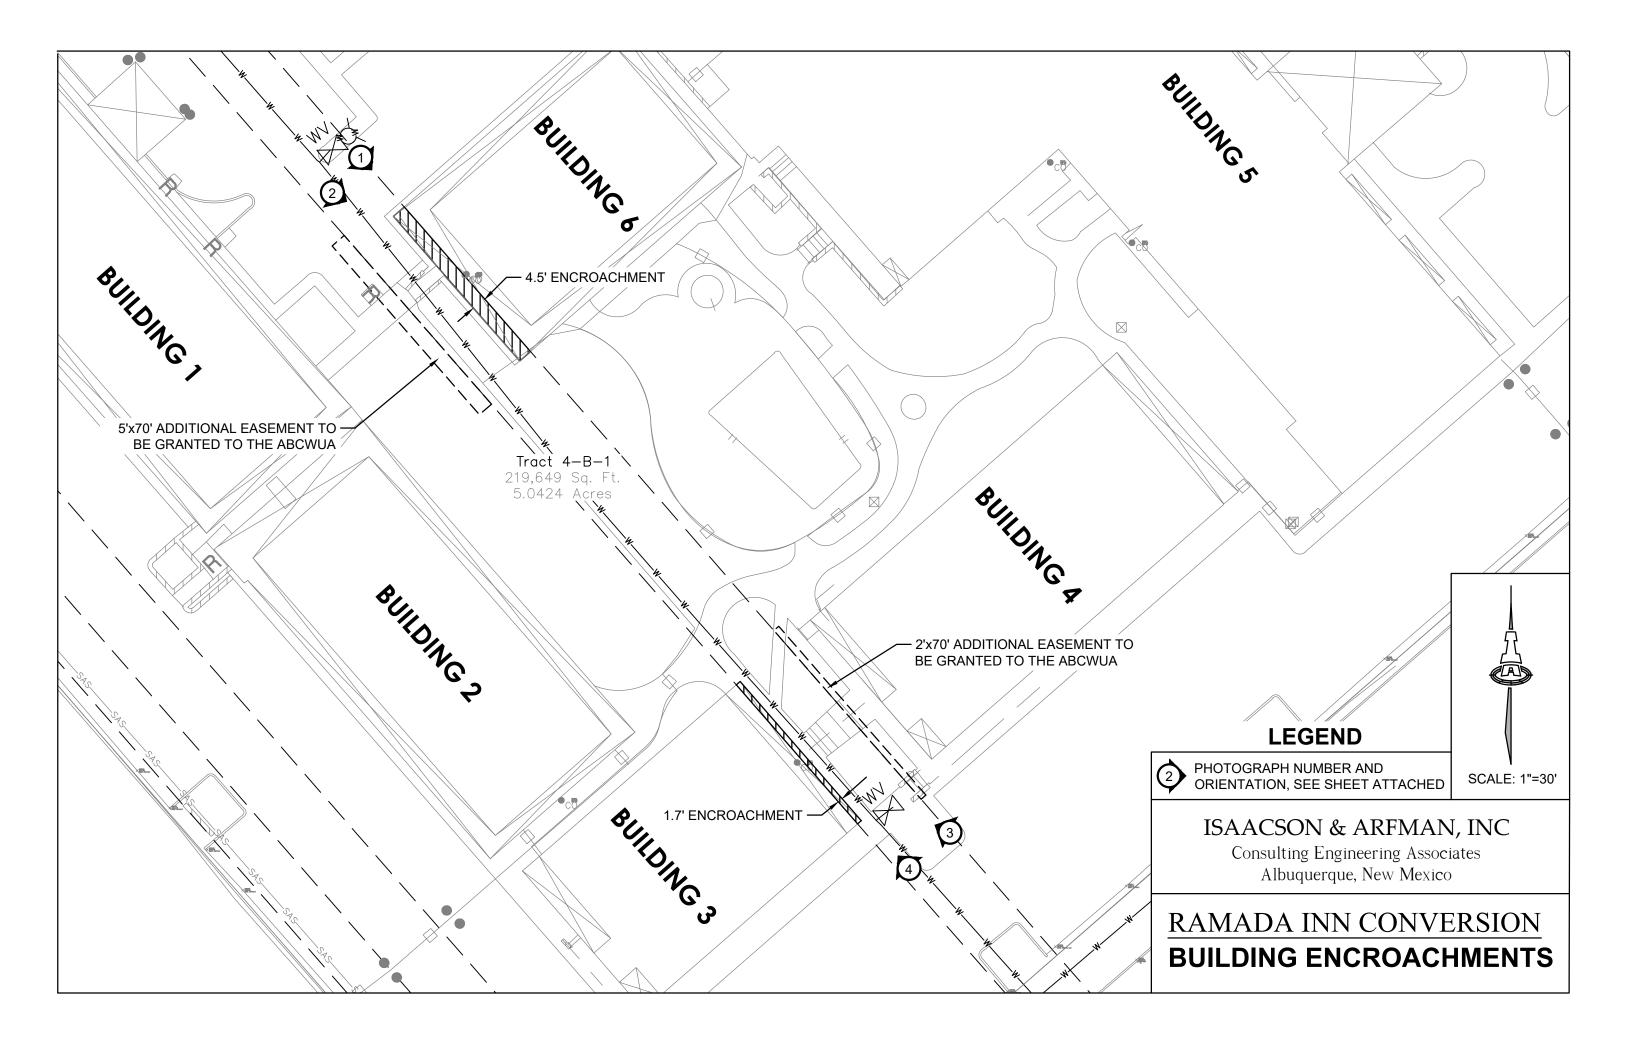



Ramada Inn Conversion

Exhibit - Building Encroachments Photos Attachment



PHOTO #1



PHOTO #2




РНОТО #3



РНОТО #4

128 Monroe St. N.E. * Albuquerque, NM 87108 * (505) 268-8828 * Fax: (505) 268-2632 * www.iacivil.com

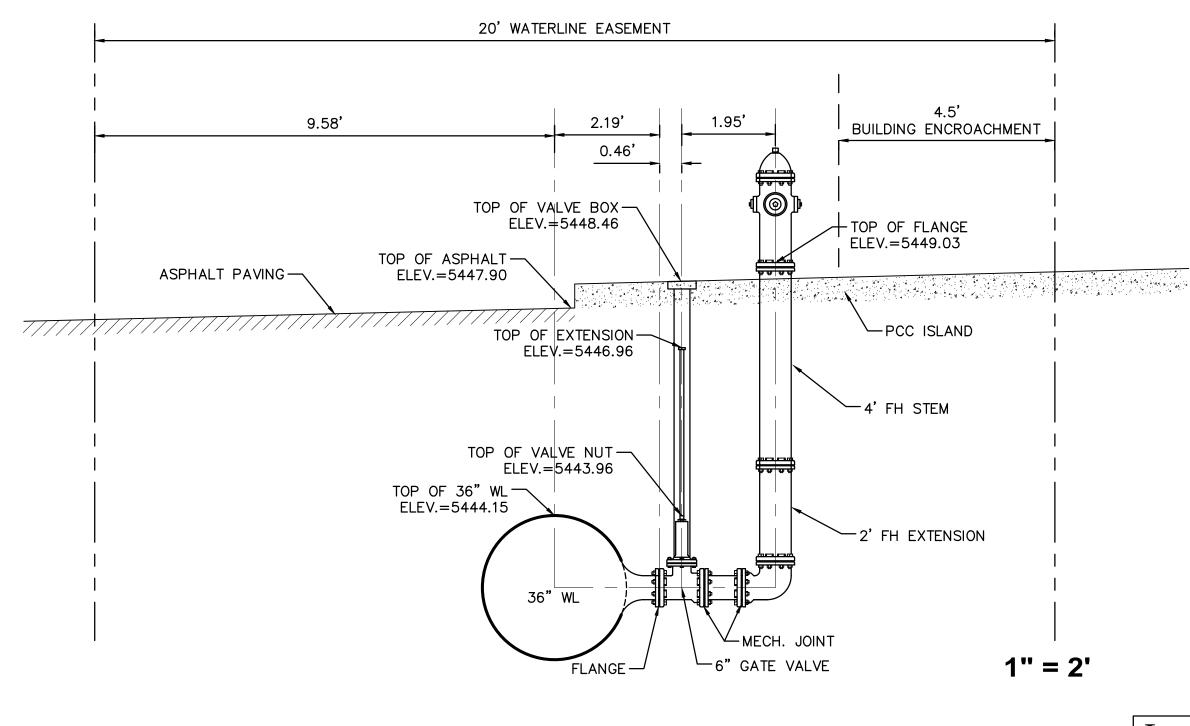


EXISTING FIRE HYDRANT NORTH WEST




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EXISTING WATERLINE STUB SOUTHEAST



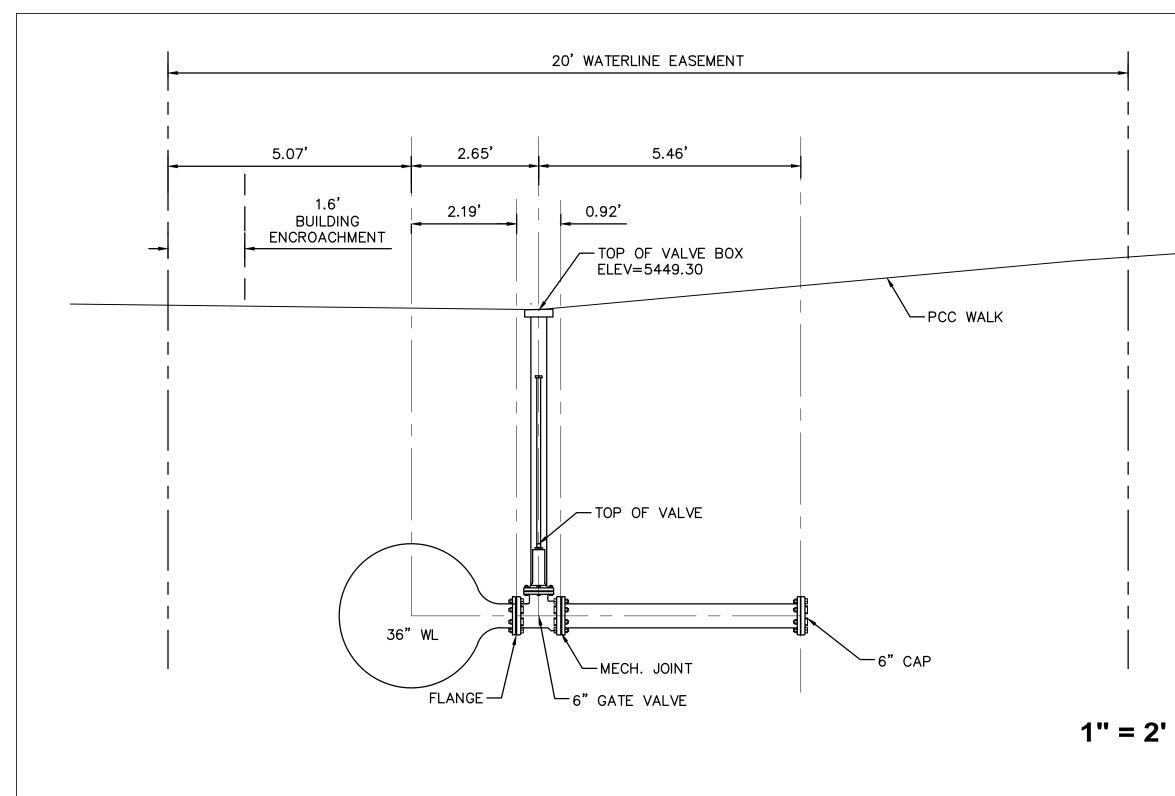

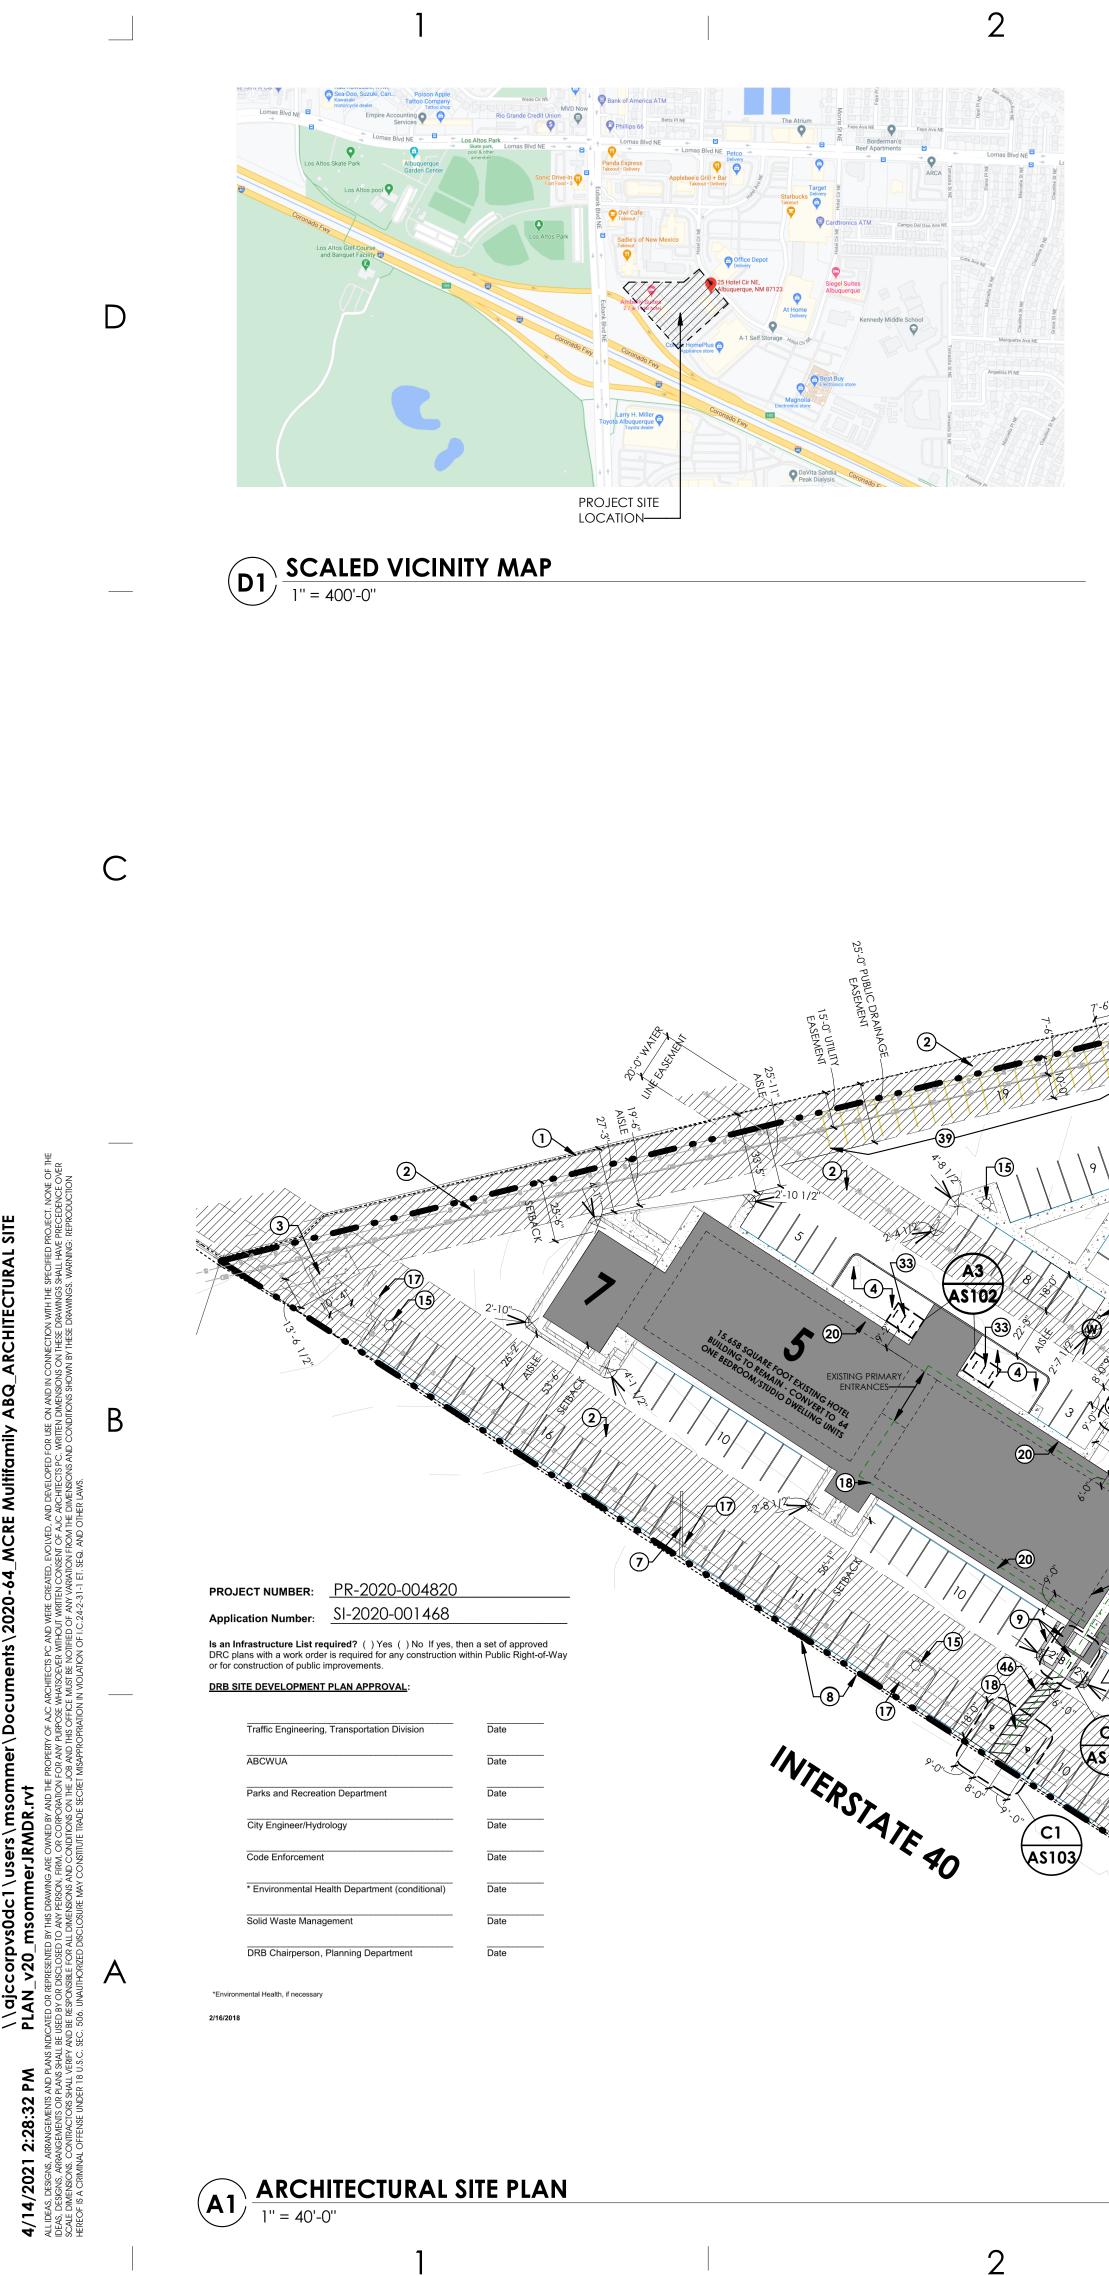

KEYED NOTES:

- EXISTING 6' TALL WHITE VINYL FENCE TO REMAIN
- EXISTING UTILITY EASEMENTS SHOWN HATCHED EXISTING DUMPSTER ENCLOSURE TO REMAIN
- NEW PLANTING BED
- NEW SIDE WALK
- EXISTING POLE SIGN TO REMAIN EXISTING PYLON SIGN TO REMAIN
- EXISTING 6' TALL CHAIN LINK FENCE TO REMAIN
- NEW PORTICO & PLANTING BEDS WITH NEW 1:20 MAX. SLOPED CONCRETE PATHWAY TO PROVIDE ACCESS FROM ADJACENT ACCESSIBLE PARKING SPOTS TO EXISTING PEDESTRIAN PATHS,
- EXISTING IN-GROUND POOL TO REMAIN
- EXISTING HOT TUB TO REMAIN
- EXISTING LOADING DOCK TO REMAIN
- EXISTING FLARED CURB CUT TO REMAIN NEW 4' (ADA) SIDEWALK WITH 1.5% CROSS SLOPE MAX TO BE INSTALLED ADJACENT TO EXISTING DRIVE ACCESS. REMOVE AND REPLACE EXISTING ASPHALT AS REQUIRED TO PROVIDE FOR A SMOOTH TRANSITION.
- EXISTING CONCRETE DRIVEWAY TO BE PARTIALLY DEMOLISHED AND RECONSTRUCTED TO PROVIDE NEW FLARED CURB CUT (EFFECTIVELY SEPARATE DRIVE ENTRANCES WITH ADJACENT PROPERTY) - PLEASE REFER TO PROVIDED INFRASTRUCTURE
- 15 EXISTING SITE POLE LIGHT TO REMAIN
- EXISTING BILLBOARD TO REMAIN 16

AS103/

TYPE 'A' UNITS

17 EXISTING 5' TALL PAINTED WHITE, STUCCO-COATED SITE WALL to remain

- 18 EXISTING ACCESSIBLE ROUTE FROM ADA PARKING TO BUILDING ENTRANCE
- EXISTING 4' TALL METAL PICKET FENCE PAINTED BLACK 19 AROUND POOL AREA TO REMAIN
- EXISTING CONCRETE PEDESTRIAN WAY PARTIALLY UNDER 20 COVER OF ROOF ABOVE
- EXISTING 6' TALL METAL PICKET FENCE PAINTED WHITE TO 21 REMAIN
- 22 EXISTING PARK STRIP TO REMAIN
- EXISTING CONCRETE PEDESTRIAN PATH TO REMAIN 23 EXISTING CONCRETE PEDESTRIAN WAY UNDER COVER OF 24
- **ROOF ABOVE**
- EXISTING STRIPED NO PARKING ZONE TO REMAIN 25
- 26 EXISTING CURB AND GUTTER TO REMAIN 27 EXISTING PUBLIC SIDEWALK TO REMAIN
- EXISTING STORM DRAIN INLETS TO REMAIN 28
- 29 EXISTING FIRE HYDRANT TO REMAIN

AS102

AS102

3

B2 AS102


- NEW FLARED CURB CUTS TO CONNECT EXISTING SIDEWALK 30 AND PORTE COCHERE CONCRETE PAD TO ESTABLISH AN ACCESSIBLE PATH CONNECTING EXISTING BUILDING TO THE EXISTING PUBLIC WAY. 6'-0" WIDE CROSSWALK STRIPING IS TO BE PAINTED ON EXISTING PAVEMENT CONNECTING EACH NEW FLARED CURBCUT. SEE TYPICAL FLARED CURB CUT DETAIL ON SHEET AS102.
- 6' WIDE ACCESSIBLE PATH TO BUILDING TO BE ESTABLISHED 31 AND MAINTAINED FROM EXISTING PUBLIC WAY TO PRIMARY ENTRANCE AS SHOWN.
- 3'-0" TALL SCREENING FENCE ALONG HOTEL CIRCLE 32 FRONTAGE - SEE SITE DETAILS ON SHEET AS 102

AS103/

- NEW BIKE RACKS (SUITABLE SPACE FOR 6 BIKES). 33 EXISTING CONCRETE PEDESTRIAN WALKWAY TO BE REMOVED 34
- FOR NEW TREE. SEE LANDSCAPE PLAN. MOTORCYCLE SPACES (4'X8') WITH SIGN 35
- EXISTING CRASH GATE AT SOUTH SITE ENTRANCE TO BE 36 REMOVED.
- MINI CLEAR SIGHT TRIANGLE AT EACH DRIVEWAY ONTO SITE 37 LANDSCAPING AND SIGNAGE WILL NOT INTERFERE WITH CLEAR SIGHT REQUIREMENTS. THEREFORE, SIGNS, WALLS, TREES, AND SHRUBBERY BETWEEN 3 AND 8 FEET TALL (AS MEASURED FROM THE GUTTER PAN) WILL NOT BE ACCEPTABLE IN THE AREA.
- EXISTING SECURITY FENCE & GATE TO BE REMOVED 38 NEWLY STRIPED COMPACT PARKING STALLS - REFER TO TYP. 39
- COMPACT PARKING SPOT DETAIL ON SHEET AS102 40 SAW-CUT AND REMOVE EXISTING CONCRETE TO ALLOW FOR NEW POURED CONCRETE SIDEWALK EXTENSION TO PROVIDE A NEW 5' CLEAR PATH TO ACCESS ADJUSTED PUBLIC RIGHT OF WAY
- 41 DEMOLISH AND POUR NEW CONCRETE SIDEWALK IN THIS
- LOCATION TO MAINTAIN MINIMUM 4' WIDTH EXISTING ACCESSIBLE PEDESTRIAN PATH TO PROVIDE EXTERIOR 42
- ENTRY TO TYPE 'A ' DWELLING UNITS IN THIS LOCATION. 43 NEW FLARED CURB CUT TO PROVIDE ACCESS TO ADJACENT
- ACCESSIBLE ROUTE FROM EXISTING STRIPED AISLE.
- EXISTING CURB RAMP AT ACCESSIBLE AISLE TO REMAIN 44 REMOVE EXISTING BOLLARDS AT EXISTING GATE OPENING 45
- NEW STRIPED CROSSING FOR ACCESSIBLE PARKING SPOTS TO 46 CONNECT TO RAMP DEMOLISH EXISTING ASPHALT RAMP ENCROACHING ON 47
- ACCESSIBLE PARKING SPOT PATCH AND REPAIR ASPHALT AS REQUIRED TO BLEND BACK TO ADJACENT PAVEMENT GRADING.

PROPERTY

SCALE : 1" = 40'-0"

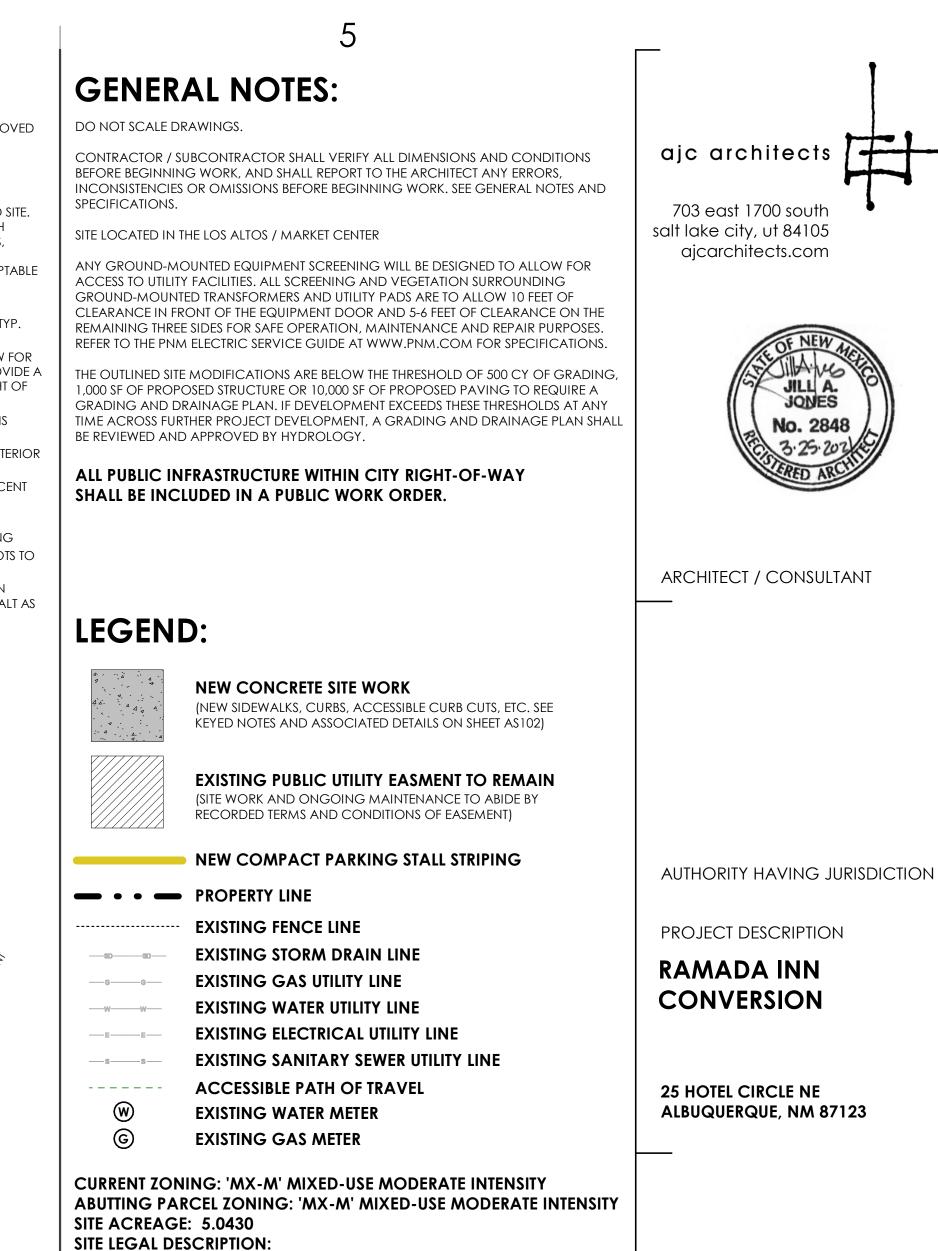

TR 4B1 PLAT FOR TRS 1B1, 1C1, 2A, 4B1, 4C1, 4C2 STA STE NO 3A SO 1/2 TR 3 & PAR 4A1A, 4A2, 4A3A, 4A4A HORNE DEV ADD W/ TRS 1A1 & 1B CONT 5.04 AC

LAND USE:

EXISTING - HOTEL PROPOSED - 206 ONE BED/STUDIO MULTI-FAMILY RESIDENTIAL DWELLING UNITS

REQUIRED USABLE OPEN SPACE

206 ONE BED/STUDIO DWELLING UNITS X 225 SQUARE FEET = 46,350 SQUARE FEET.

PROVIDED OPEN SPACE = 48,956 SQUARE FEET

BUILDING HEIGHT

ALLOWED: EXISTING/PROPOSED:

48'-0'' 27'-8" (TALLEST CURRENT)

PARKING CALCULATIONS:

PROPOSED PARKING TABULATION: 206 One Bed/Studio Dwelling Units X 1.5 Space/Dwelling Unit = 309 Spaces Adjustment for 20% Reduction Allowance within an Activity Center 309 X 0.8 = 248 Spaces

REQUIRED TOTAL: 248 PARKING SPACES

PROVIDED TOTAL: 269 (INCLUDING +3 FOR CARPOOL CREDIT) 233 Existing Parking Spaces (Includes 1 Carpool Space, Total Credit For 236) 20 Re-Striped Parking Spaces

11 On-Street Parking Credits 2 Motorcycle Parking Spaces

COMPACT PARKING ALLOWED = 62 PARKING STALLS (25% MAX) PROVIDED = 19 PARKING STALLS (8.2%)

ACCESSIBLE PARKING - NMBC 2015 TABLE 1106.1 REQUIRED: 8 ACCESSIBLE PARKING STALLS (6 CAR + 2 VAN) PROVIDED: 8 ACCESSIBLE PARKING STALLS (5 CAR + 3 VAN) ISSUE DATE: ISSUE TYPE: DRAWN BY: CHECKED BY: K. RIGBY PROJECT#:

SHEET NAME:

REVISIONS

MARK DATE


PLAN


ARCHITECTURAL SITE

3/26/2021 **DRB SUBMITTAL** MS/ZS/LT 2020-64

DESCRIPTION



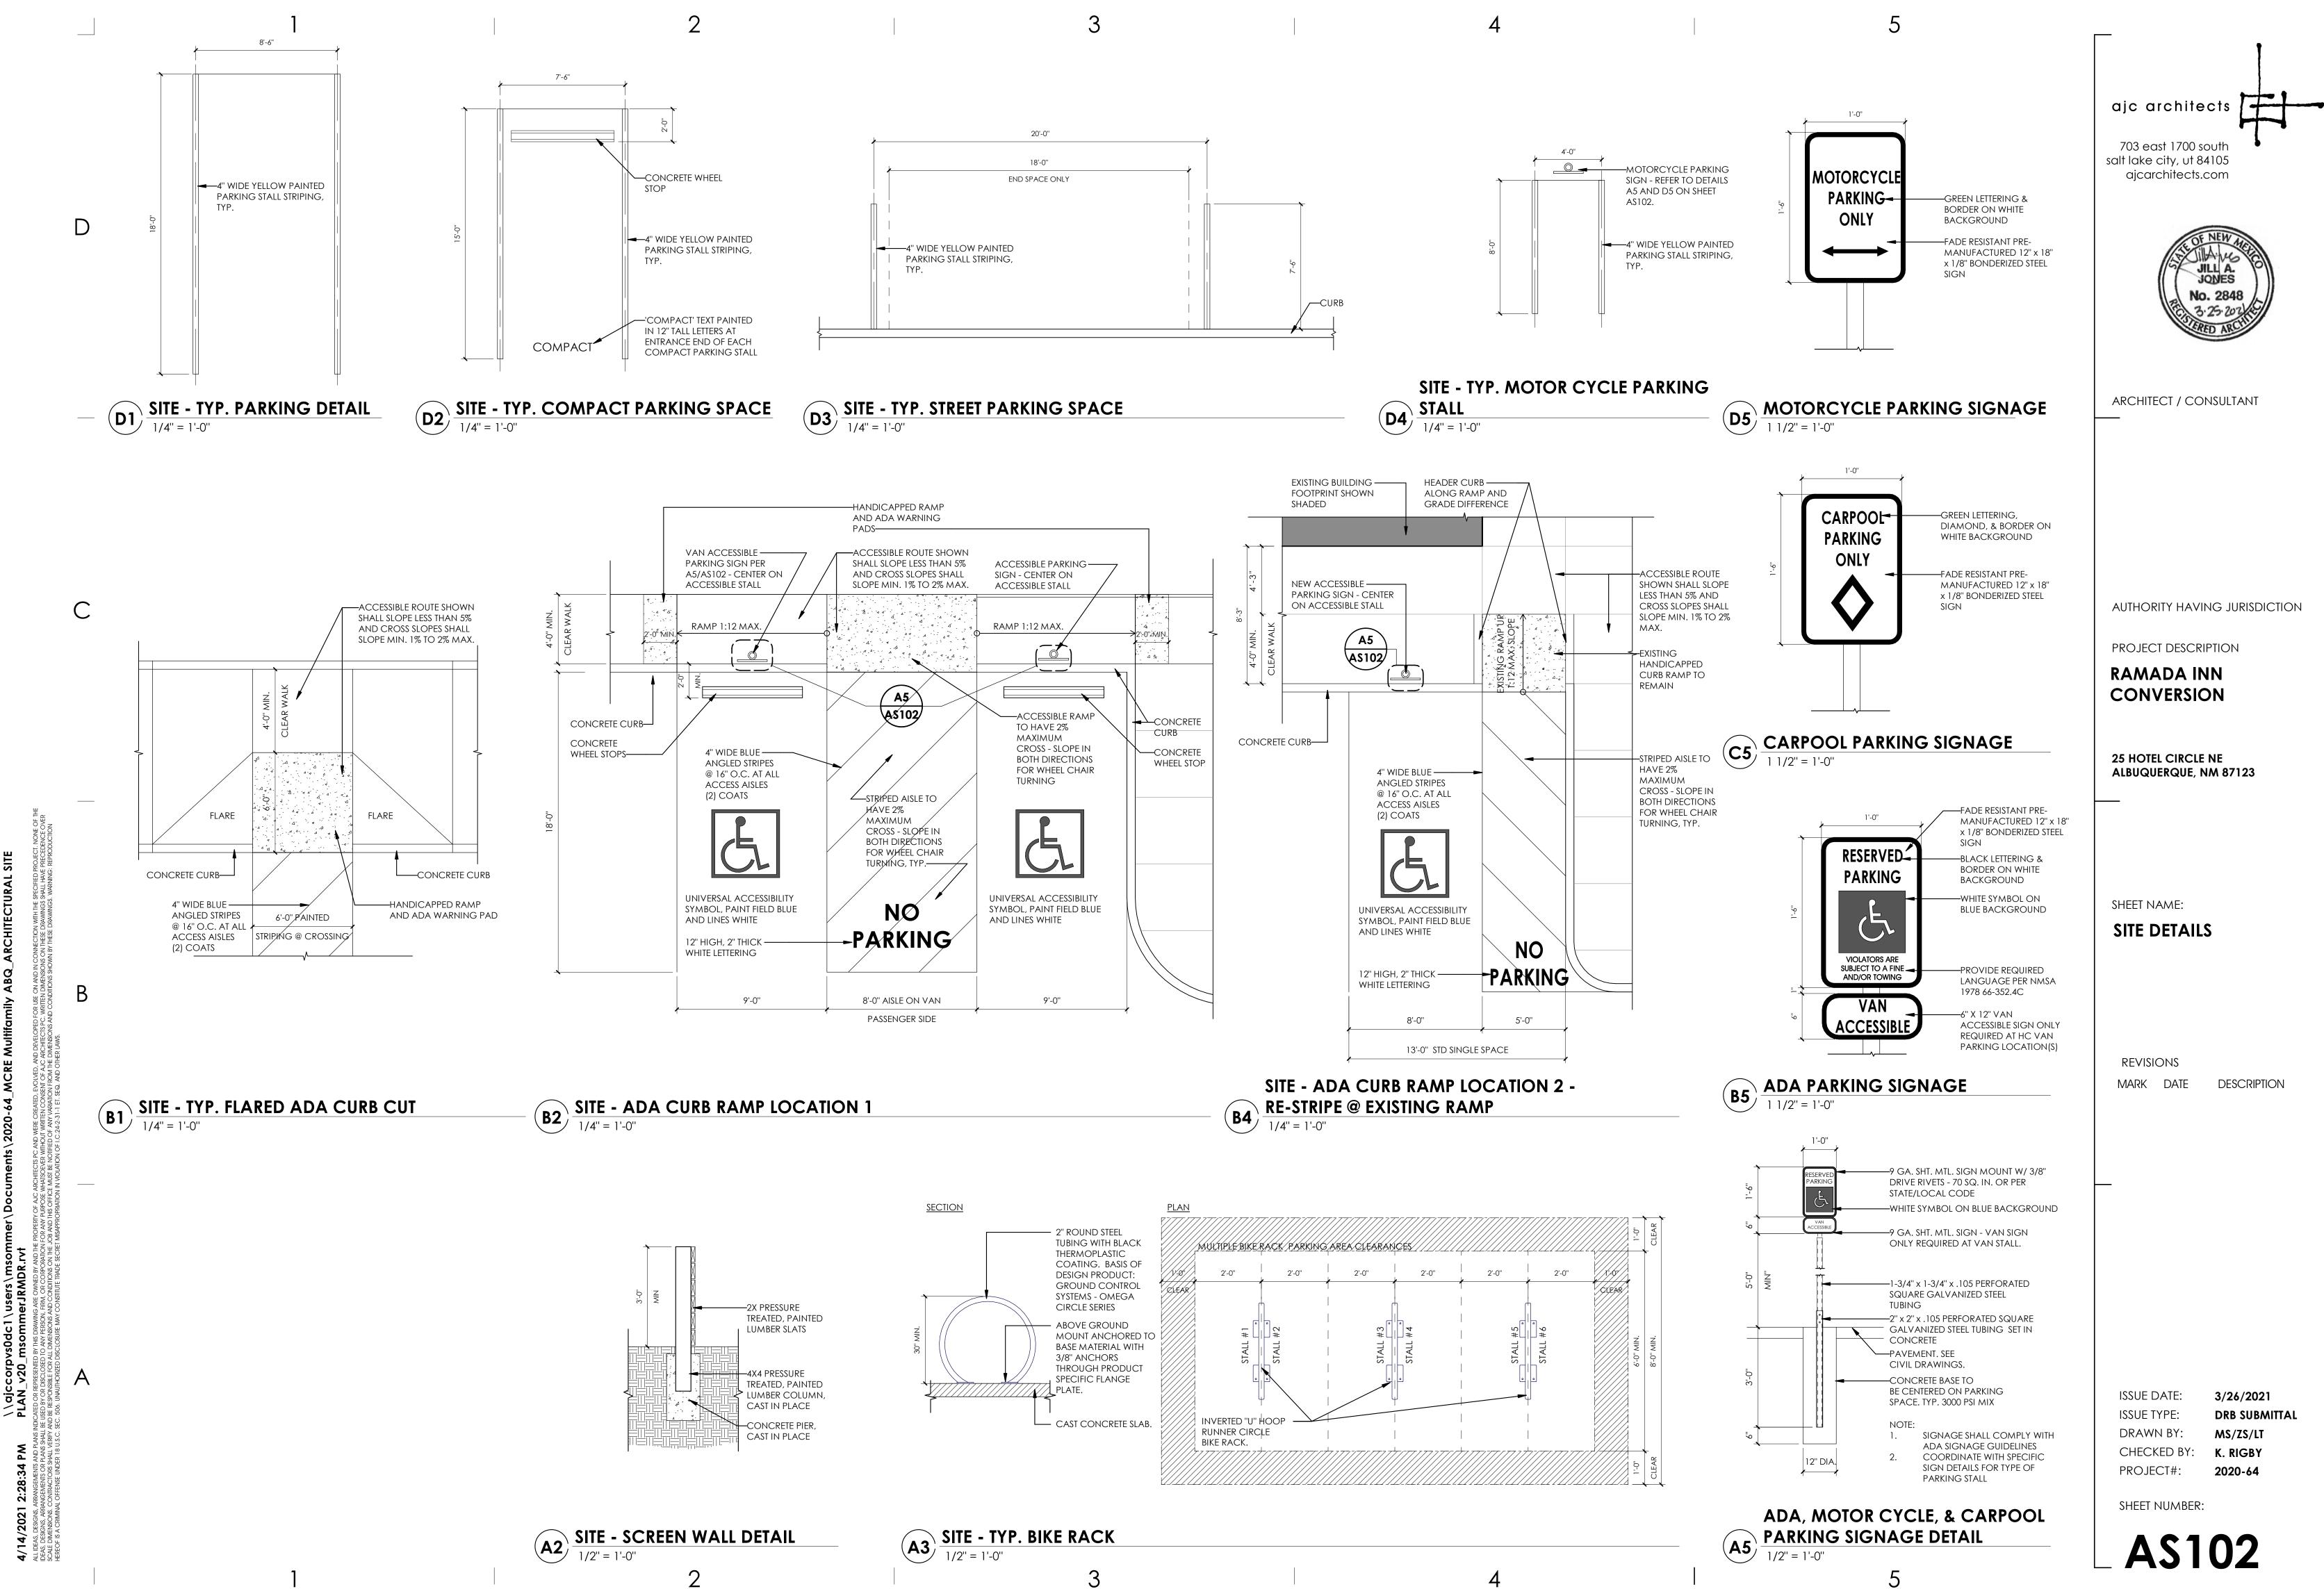

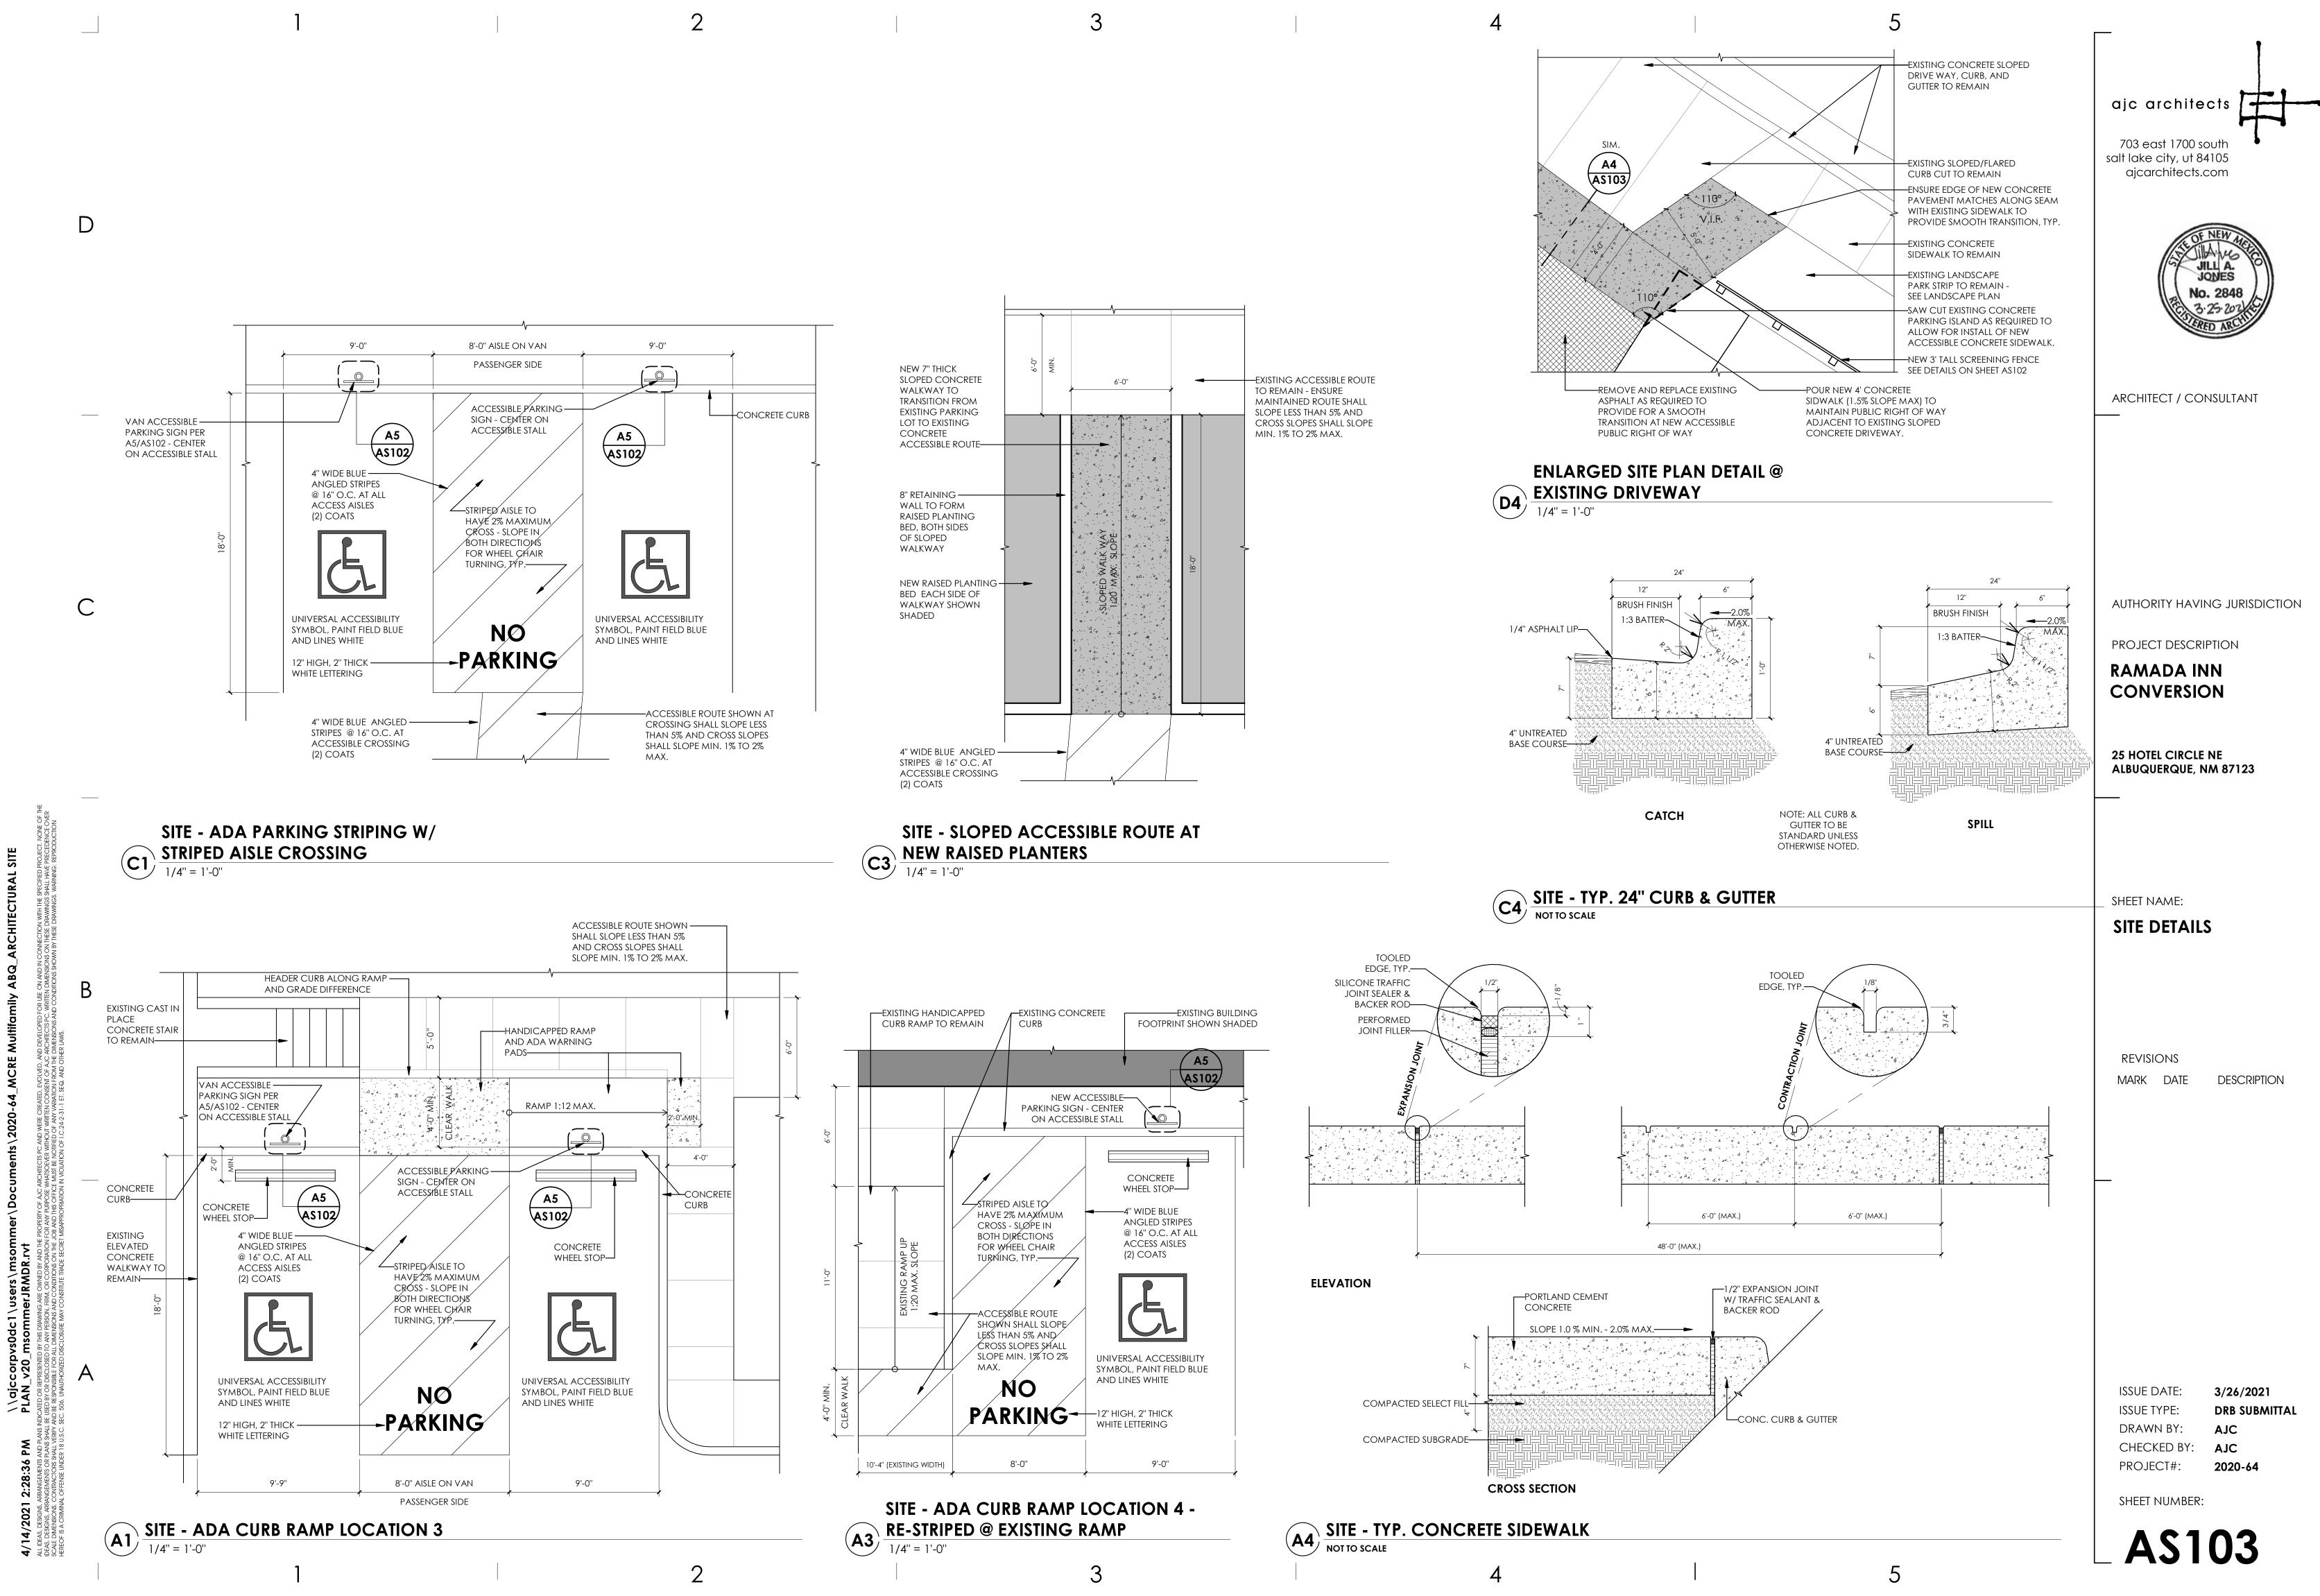

TYP.	LANDSCAPE AREA (784 SF) (784 S
	OHENDERSON
	6 TYP.
	LANDSCAPE / (4,966 SF
TER CONSERVATION LANDSCAPING AND ED TO. A FULLY AUTOMATED SHRUB AND GROUNDCOVER PLANTING TO ISOLATE PLANT MATERIAL P BY PLANT ZONES ACCORDING TO WITH (6) 2 GPH EMITTERS. WITH THE	INTERSTRATE CONSISTENT OF A CONSISTENCE

GENERAL LANDSCAPE NOTES

IRRIGATION IRRIGATION SYSTEM STANDARDS OUTLINED IN THE WATER WATER WASTE ORDINANCE SHALL BE STRICTLY ADHEREE IRRIGATION SYSTEM WILL BE USED TO IRRIGATE TREE, SH AREAS. THE IRRIGATION SYSTEM SHALL BE DESIGNED TO ACCORDING TO SOLAR EXPOSURE AND WILL BE SET UP WATER REQUIREMENTS. THE TREES WILL BE PROVIDED WITH (6) 2 GPH EMITTERS, WITH THE ABILITY TO BE EXPANDED TO ACCOMMODATE THE GROWTH OF THE TREE. SHRUBS AND GROUNDCOVERS WILL BE PROVIDED WITH (2) 1 GPH EMITTERS. TREES, SHRUBS AND GROUNDCOVERS WILL BE GROUPED ON THE SAME VALVE.

RESPONSIBILITY OF MAINTENANCE

MAINTENANCE OF ALL PLANTING AND IRRIGATION, INCLUDING THOSE WITHIN THE PUBLIC R.O.W., SHALL BE THE RESPONSIBILITY OF THE PROPERTY OWNER.

METHOD FOR COMPLYING WITH WATER CONSERVATION ORDINANCE THE PLANT PALETTE IS PREDOMINANTLY COMPRISED OF PLANTS WITH LOW TO MEDIUM WATER USE REQUIREMENTS, THEREBY MINIMIZING IRRIGATION NEEDS WHILE ENSURING THE VIABILITY OF THE PLANTS.

PNM COORDINATION

COORDINATION WITH PNM'S NEW SERVICE DELIVERY DEPARTMENT IS NECESSARY REGARDING PROPOSED TREE LOCATION AND HEIGHT, SIGN LOCATION AND HEIGHT, AND LIGHTING HEIGHT IN ORDER TO ENSURE SUFFICIENT SAFETY CLEARANCES. SCREENING WILL BE DESIGNED TO ALLOW FOR ACCESS TO ELECTRIC UTILITIES. IT IS NECESSARY TO PROVIDE ADEQUATE CLEARANCE OF TEN FEET IN FRONT AND AT LEAST 5 FEET ON THE REMAINING THREE SIDES SURROUNDING ALL GROUND-MOUNTED EQUIPMENT FOR SAFE OPERATION, MAINTENANCE AND REPAIR PURPOSES.

CLEAR SIGHT DISTANCE:

LANDSCAPING AND SIGNAGE WILL NOT INTERFERE WITH CLEAR SIGHT REQUIREMENTS. THEREFORE, SIGNS, WALLS, TREES, AND SHRUBBERY BETWEEN 3 AND 8 FEET TALL (AS MEASURED FROM THE GUTTER PAN) WILL NOT BE ACCEPTABLE IN THE AREA.

LANDSCAPE AREA COVERAGE	
TOTAL SITE AREA (5.04 AC.):	219,649 SF
BUILDING AREA:	- 65,645 SF
NET AREA	154,004 SF
REQUIRED LANDSCAPE AREA (15% OF NET AREA): PROVIDED LANDSCAPE AREA	23,101 SF 27,121 SF (17%)

LANDSCAPE LIVE VEGETATIVE COVERAGE

LANDSCAPE COVERAGE REQUIREMENTS SPECIFY TREE CANOPIES AND GROUND-LEVEL PLANTS SHALL COVER A MINIMUM OF 75%. A MINIMUM OF 25% SHALL BE PROVIDED AS GROUND-LEVEL PLANTS (SHRUBS, GRASSES, ETC.) OF THE REQUIRED VEGETATIVE COVERAGE.

REQUIRED LIVE VEGETATIVE MATERIAL COVERAGE	20,368 SF
PROVIDED LIVE VEGETATIVE MATERIAL COVERAGE	39,854 SF (96%)
REQUIRED GROUND-LEVEL PLANT COVERAGE	5,092 SF
PROVIDED GROUND-LEVEL PLANT COVERAGE	10,539 SF (51%)

LANDSCAPE TURF NO MORE THAN 10% OF REQUIRED LANDSCAPE AREAS SHALL BE TURF GRASS SPECIES REQUIRING IRRIGATION FOR SURVIVAL AFTER THE FIRST 2 GROWING SEASONS.

ALLOWABLE TURF	2,310 SF	
EXISTING TURF (NON CONFORMING SITE FEATURE)	10,539 SF	(46%)

PARKING LOT AREA AT LEAST 10% OF THE PARKING LOT AREA OF LOTS CONTAINING 50 OR FEWER SPACES, AND AT LEAST 15% OF THE PARKING LOT AREA OF LOTS CONTAINING 50 OR MORE SPACES, SHALL BE LANDSCAPED.


THE PROJECT IS PROVIDING 252 PARKING SPACES.	
TOTAL PARKING LOT AREA:	107,385 SF
REQUIRED LANDSCAPE AREA:	16,108 SF
PROVIDED LANDSCAPE AREA:	9,103 SF (9%)


PARKING LOT TREES PARKING LOT TREE REQUIREMENTS ARE BASED UPON 1 TREE PER 10 SPACES.

THE PROJECT IS PROVIDING 252 PARKING SPACES.	
PARKING LOT TREES REQUIRED: 26	

PARKING LOT TREES PROVIDED: 32 (NOT INCLUDING EXISTING 5)

CREDIT FOR	(PRESERV	/ING EXISTING TREES:	
SIZE (DIA.)	QTY.	CREDIT PER TREE	TOTAL
4" - 8"	4	2	8
8" - 13"	3	4	12
13" - 25"	13	6	78
TOTAL	20		98

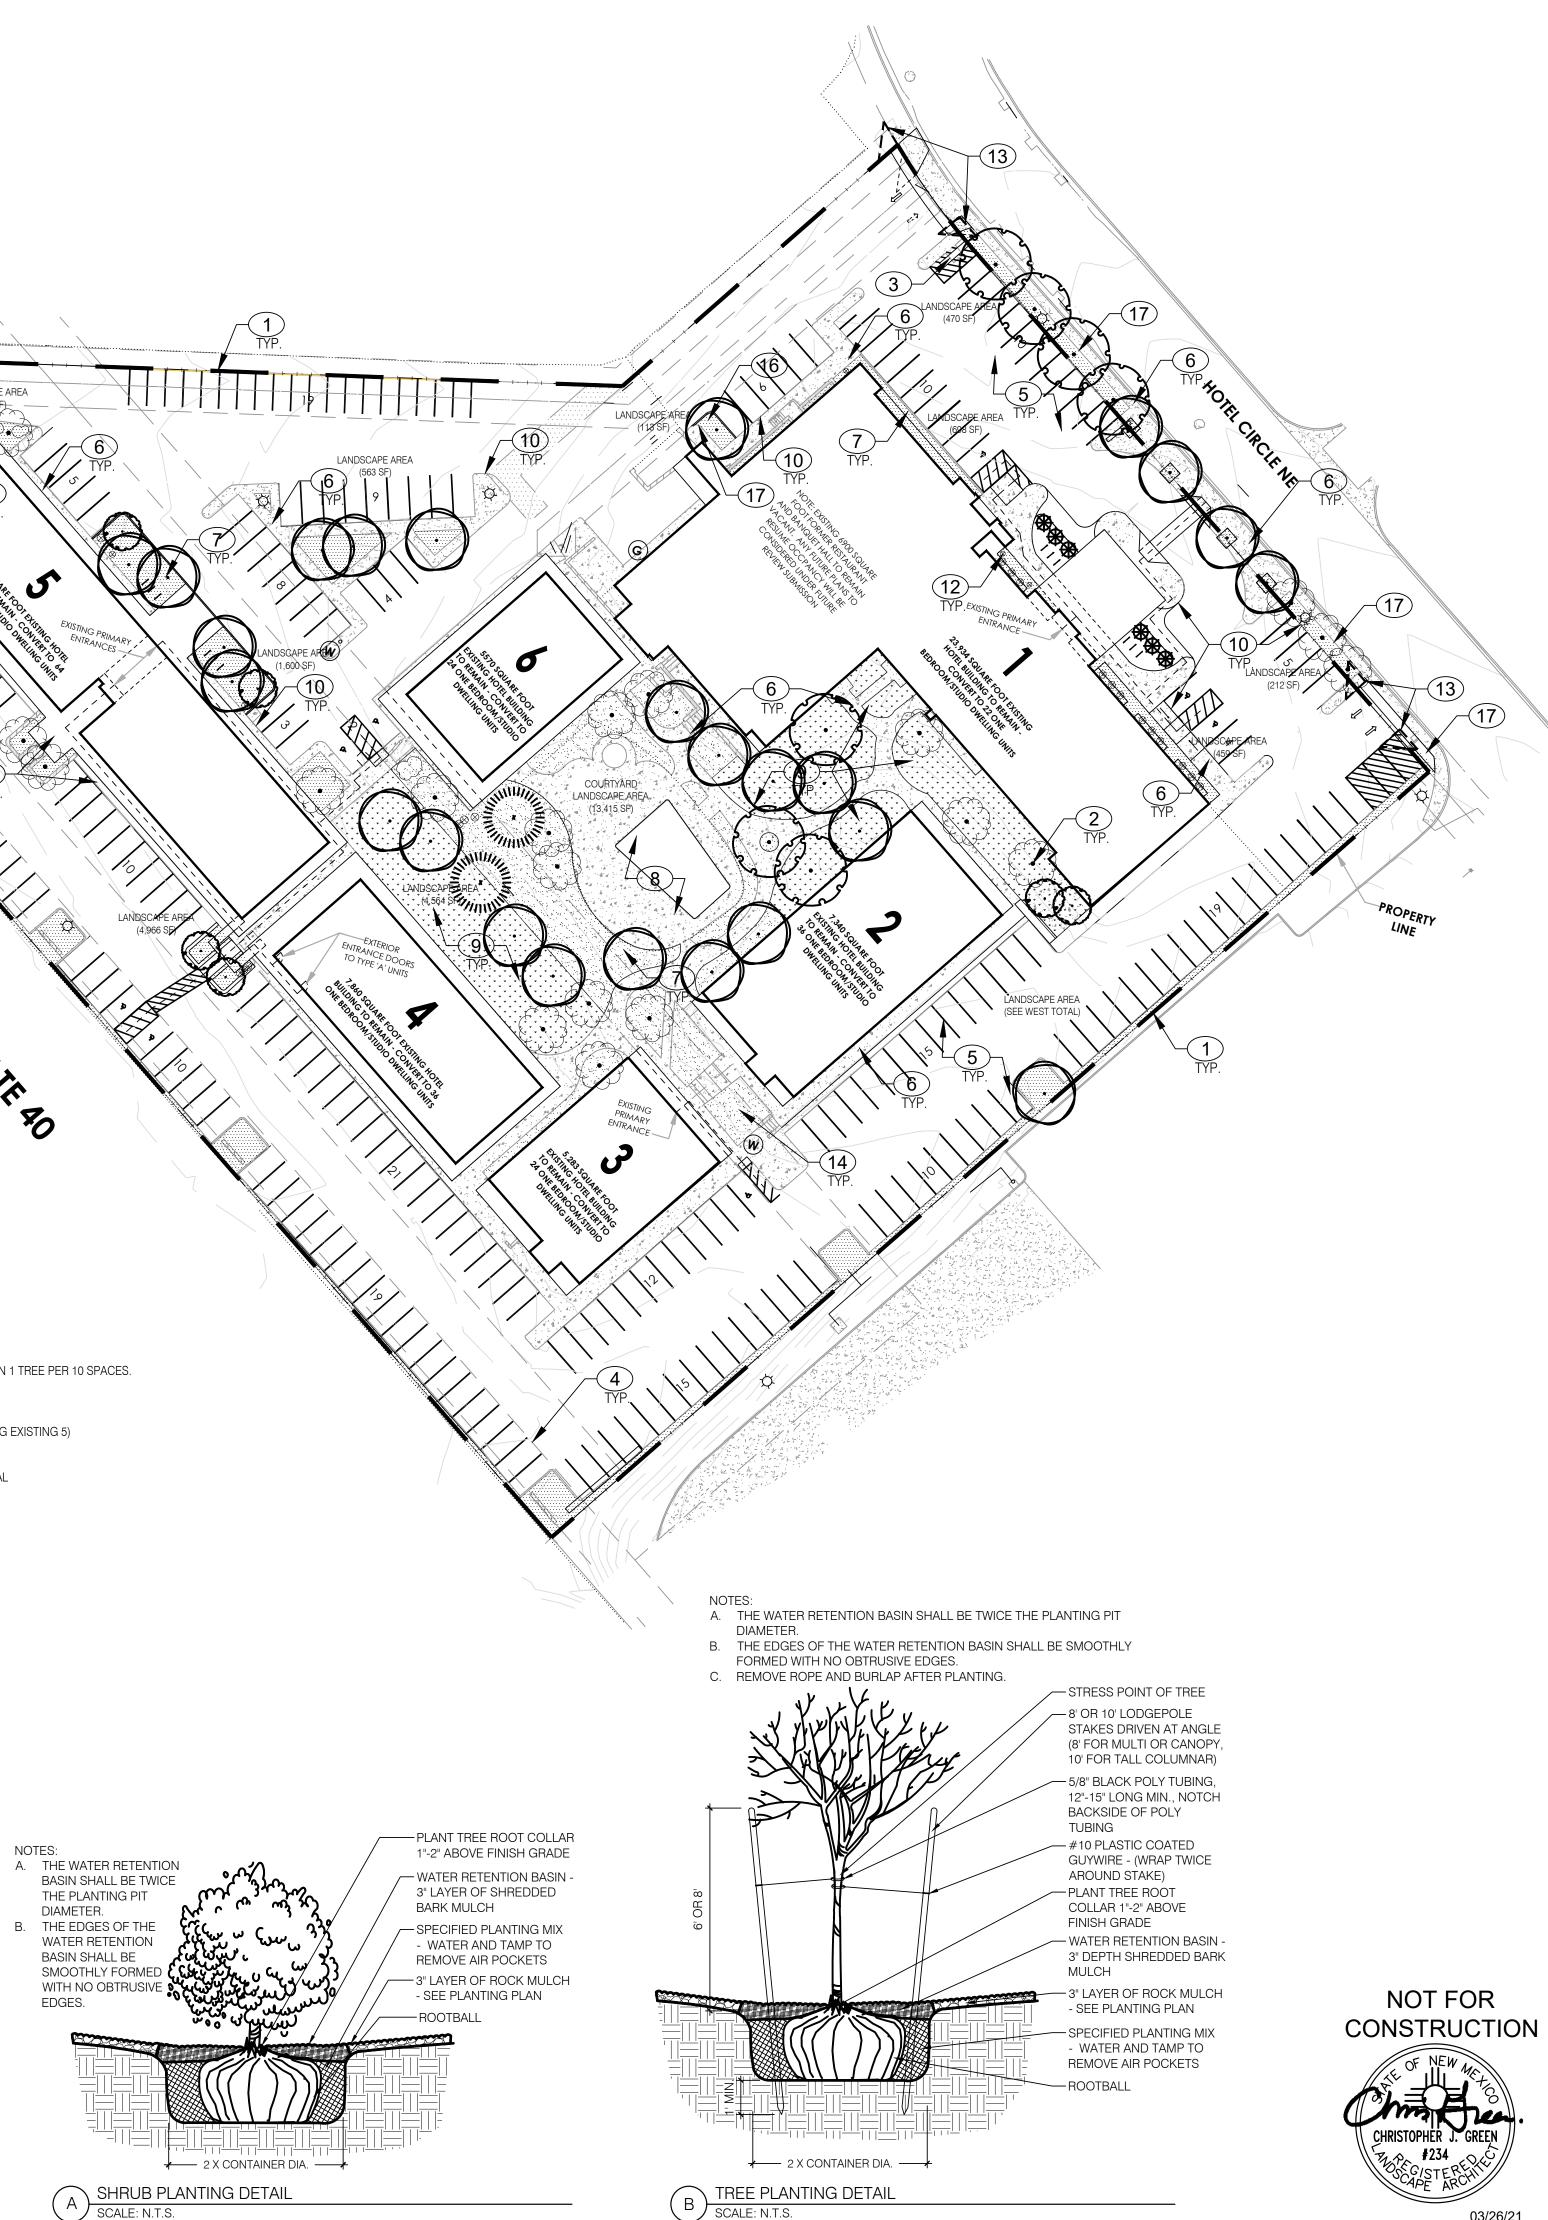

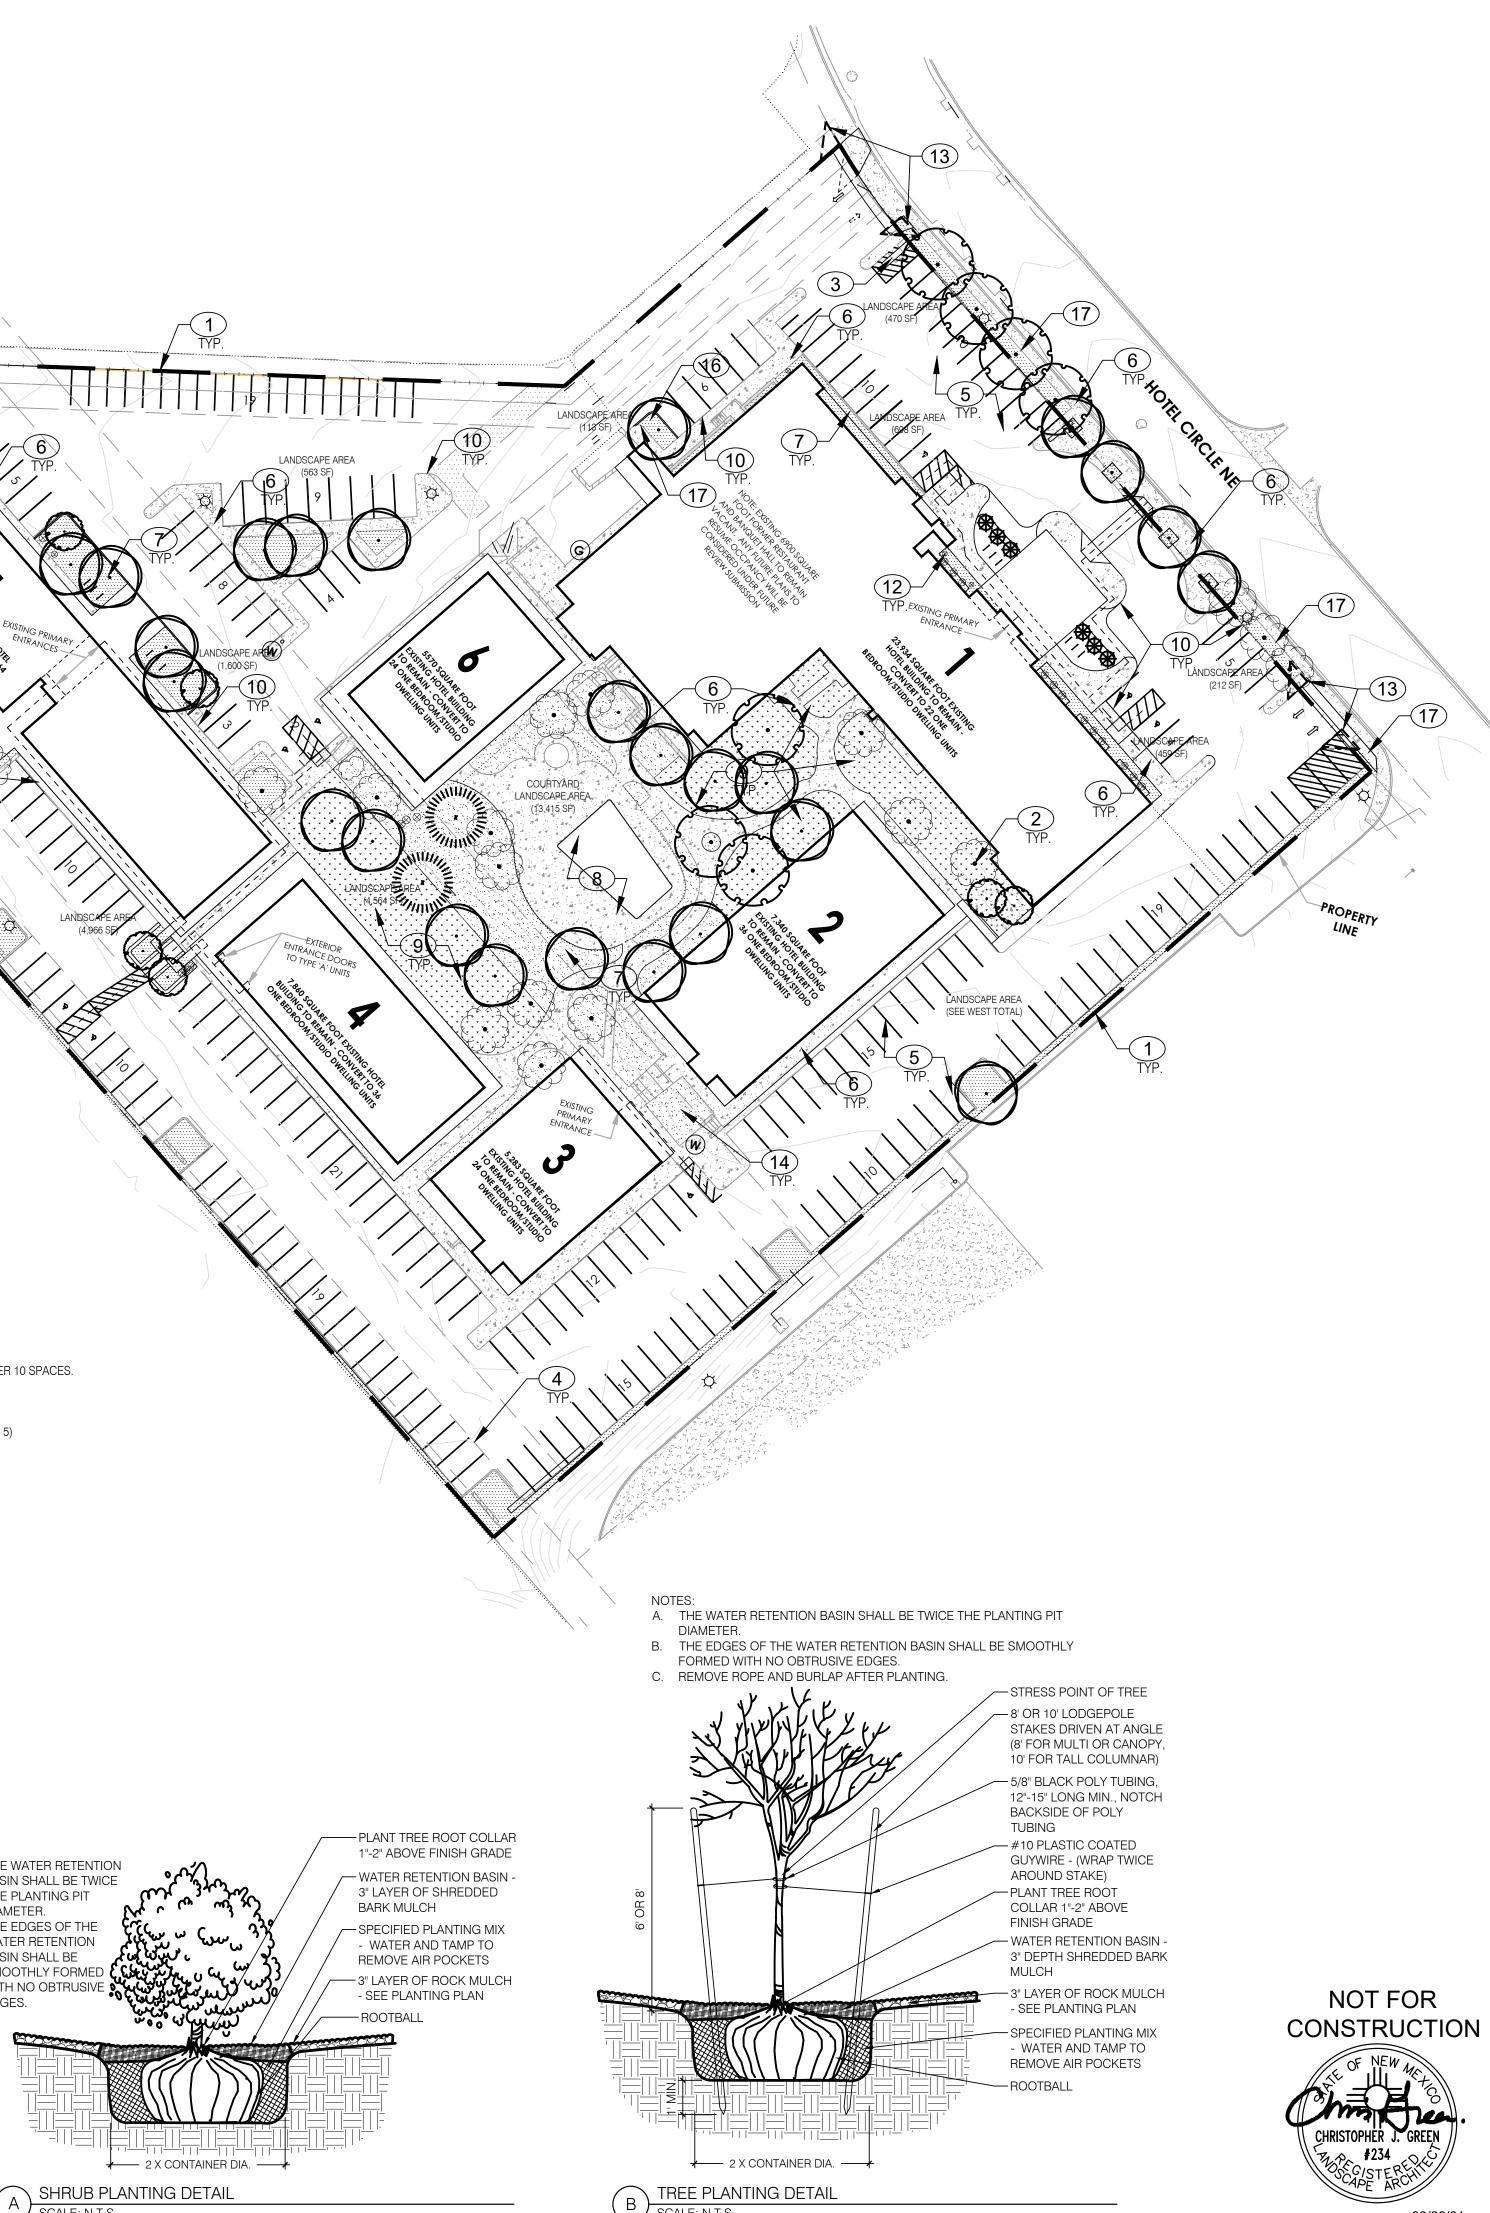

PLANT LEGEND

QTY.	SYMBOL	SCIENTIFIC NAME COMMON NAME (WATER USE)	SIZE	INSTALLED SIZE MATURE SIZE
		TREES		
	E.	EXISTING TREES TO REMAIN		
7		CERCIS RENIFORMIS 'OKLAHOMA' OKLAHOMA REDBUD (M)	2.5" B&B	8' HT. X 4' SPR. 15' HT. X 15' SPR.
7	$\left(\cdot \right)^{\sim}$	GLEDITSIA TRIACANTHOS IMPERIAL' SKYLINE HONEYLOCUST (M+)	2.5" B&B	8' HT. X 4' SPR. 45' HT. X 35' SPR.
13		JUNIPERUS SCOPULORUM 'SKYROCKET' SKYROCKET JUNIPER (L+)	B&B	6' HT. X 2' SPR. 12' HT. X 5' SPR.
2		PINUS NIGRA AUSTRIAN PINE (M+)	B&B	8' HT. X 4' SPR. 35' HT. X 25' SPR.
25		ULMUS PROPINQUA 'JFS-BIEBERICH' EMERALD SUNSHINE ELM (M)	2.5" B&B	8' HT. X 4' SPR. 35' HT. X 25' SPR.

MULCHES AND BOULDERS

17,485 SF		1" SANTA FE BROWN ROCK MULCH
		(3" DEPTH OVER FILTER FABRIC, DEWITT PRO-5 WEED CONTROL, OR EQUAL)

10,539 SF [.... EXISTING TURF TO REMAIN


- KEY NOTES:
- 1. PROPERTY BOUNDARY 2. EXISTING TREE TO REMAIN
- 3. EXISTING MONUMENT SIGN
- 4. EXISTING UTILITY EASEMENT
- 5. EXISTING ASPHALT PAVING
- 6. EXISTING CONCRETE WALK
- 7. EXISTING LANDSCAPE AREA 8. EXISTING FENCED POOL AND PATIO AREA
- 9. EXISTING TURF AREA
- 10. EXISTING CURB AND GUTTER
- 11. EXISTING DUMPSTER ENCLOSURE
- 12. EXISTING SHRUB TO REMAIN 13. CLEAR SITE TRIANGLES
- 14. SHADE TREES 25' O.C. ALONG WALKWAYS ON INTERIOR
- 15. CONNECTION TO PUBLIC SIDEWALK TBD.
- 16. NEW TREE ISLAND
- 17. NEW CONCRETE CURB AND WALK

MCRE MULTI-FAMILY CONVERSION

LANDSCAPE PLAN


ININIA.

Prepared for: Mountain Classic Real Estate. 461 East 200 South Suite 102, Salt Lake City, UT 84111-2138

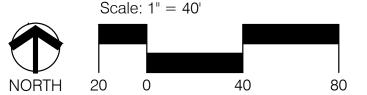

Prepared by: Consensus Planning, Inc. 302 Eighth Street SW Albuquerque, NM 87102

03/26/21

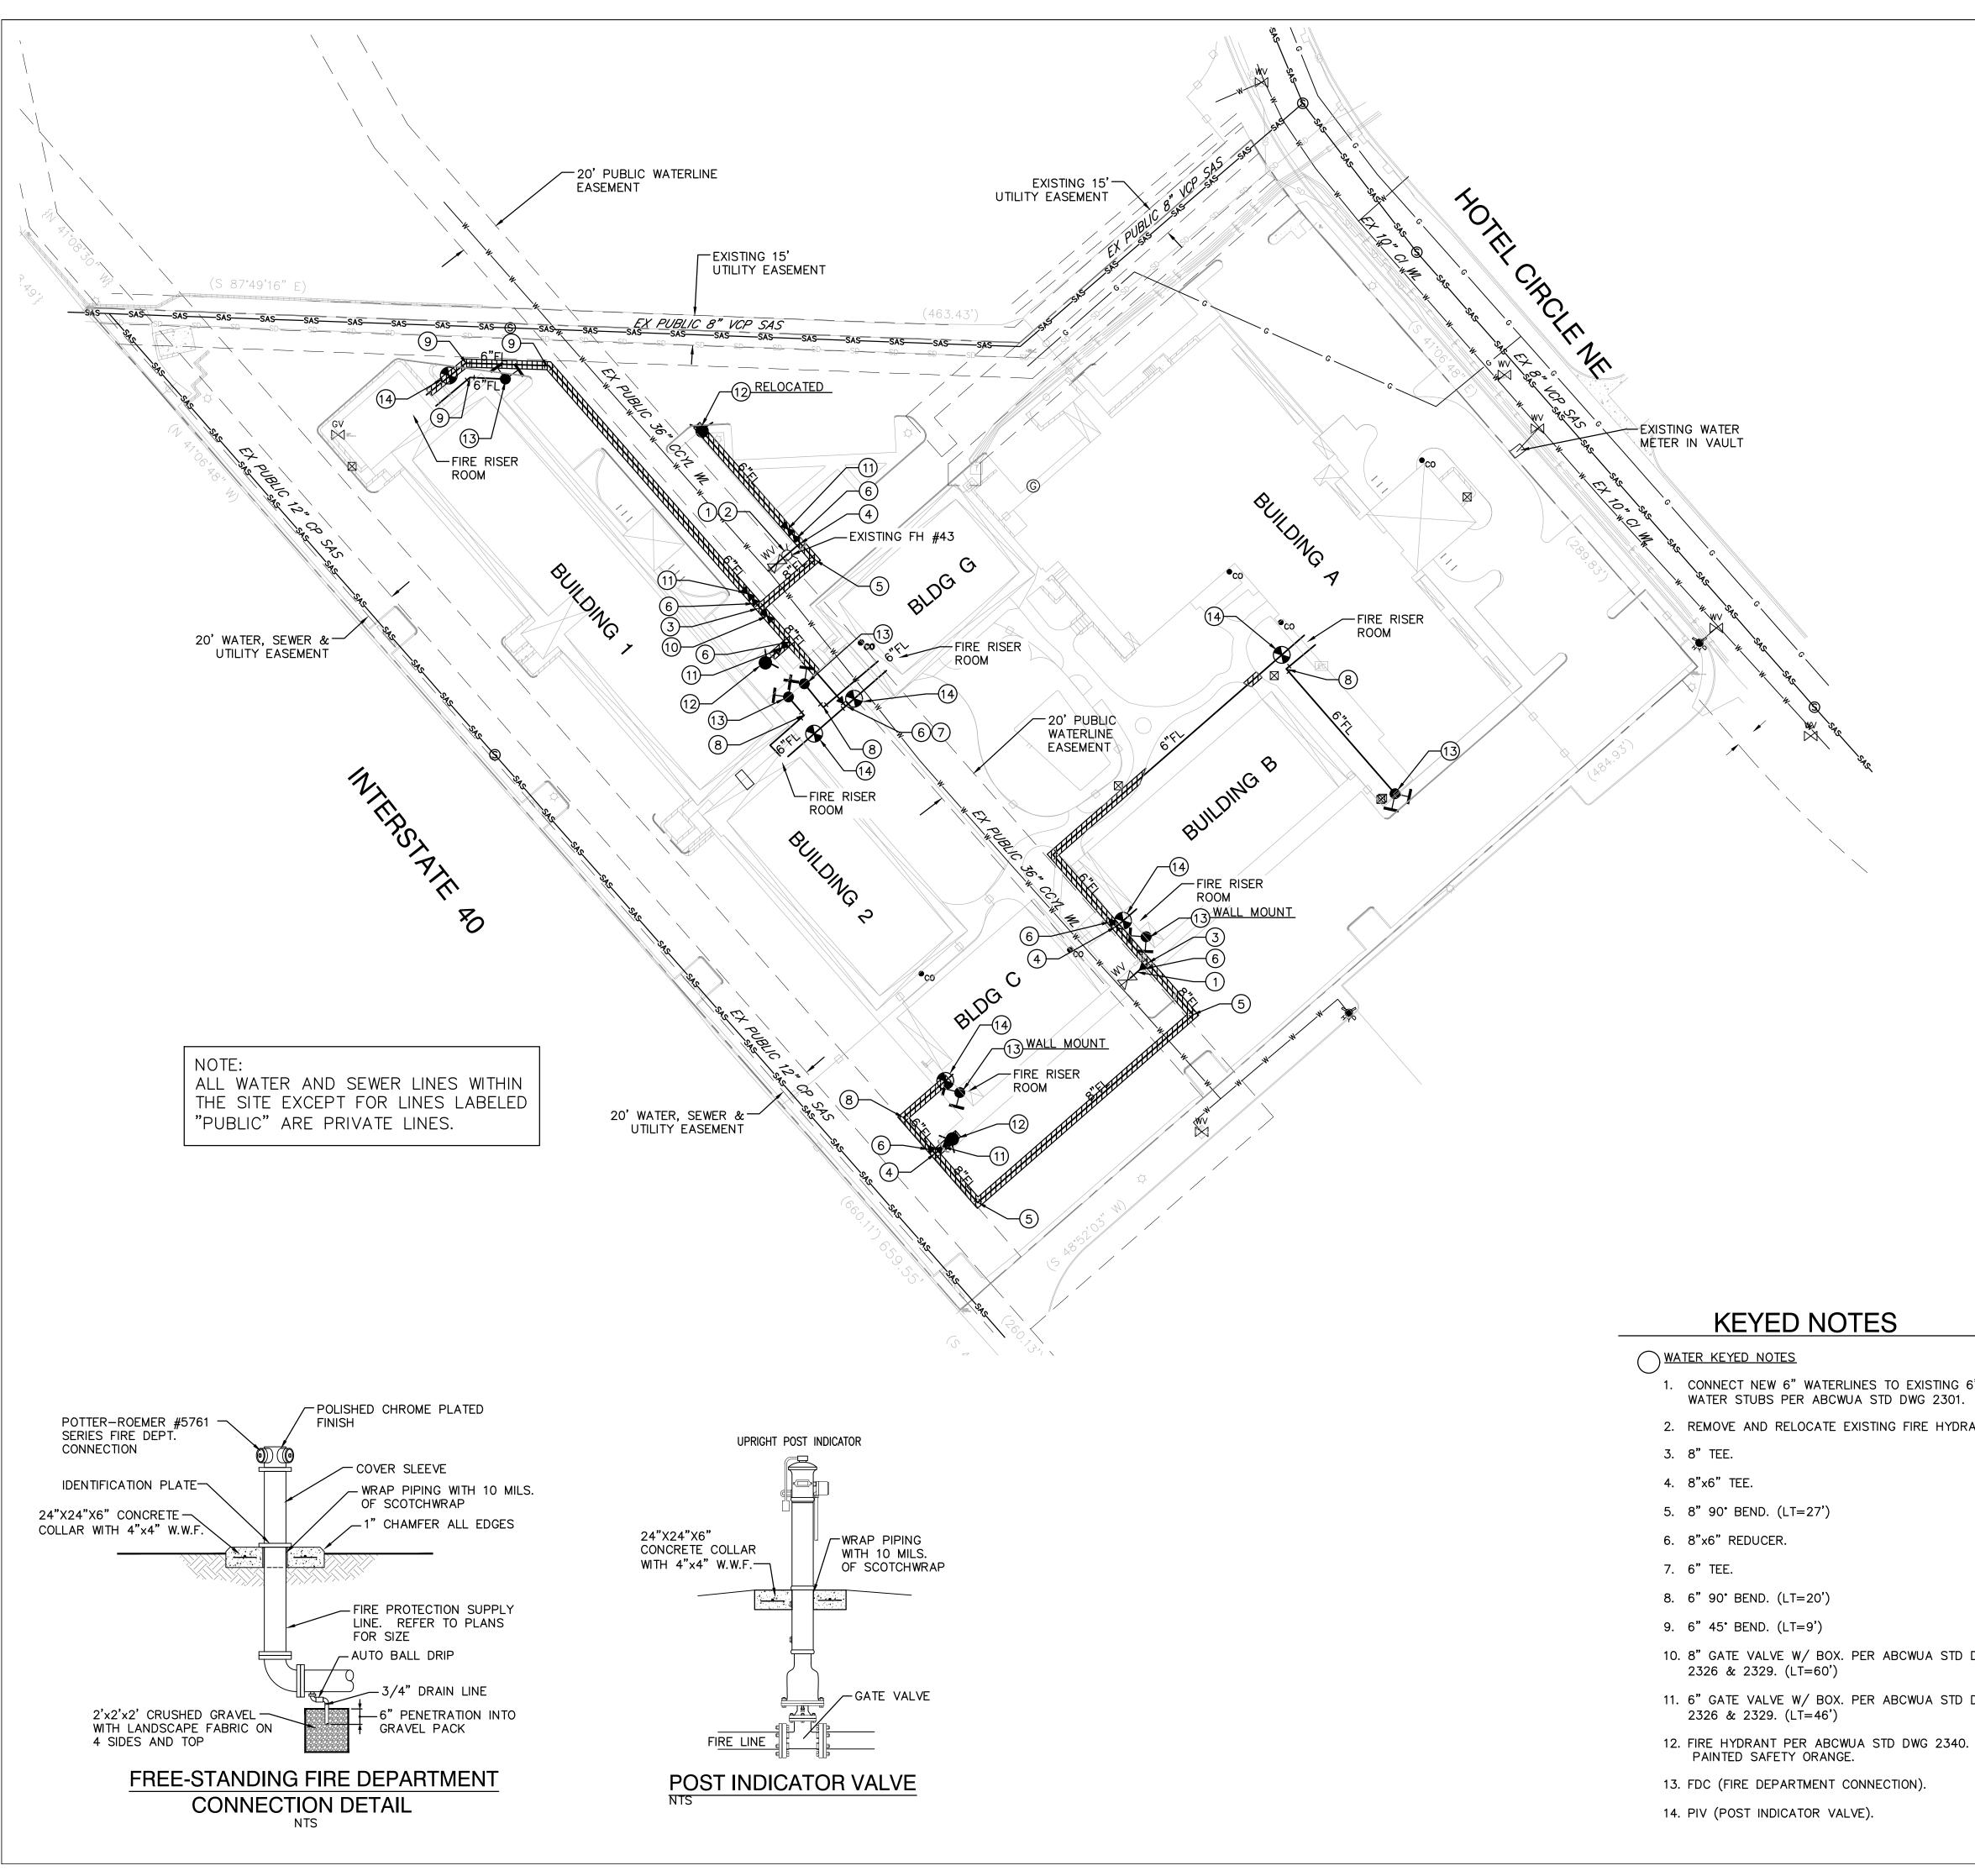

- 1. CONNECT NEW 6" WATERLINES TO EXISTING 6" WATER STUBS PER ABCWUA STD DWG 2301.
- 2. REMOVE AND RELOCATE EXISTING FIRE HYDRANT.

- 10. 8" GATE VALVE W/ BOX. PER ABCWUA STD DWG
- 11. 6" GATE VALVE W/ BOX. PER ABCWUA STD DWG
- 13. FDC (FIRE DEPARTMENT CONNECTION).

GENERAL NOTES

- 1. SEE SHEET C-100 FOR ALL CIVIL GENERAL NOTES.
- 2. EXISTING UTILITY LINES ARE SHOWN IN AN APPROXIMATE MANNER ONLY AND MAY BE INCOMPLETE OR OBSOLETE. SUCH LINES MAY OR MAY NOT EXIST WHERE SHOWN OR NOT SHOWN. ALL UTILITIES SHOULD BE FIELD VERIFIED AND LOCATED BY THE CONTRACTOR PRIOR TO COMMENCEMENT OF ANY CONSTRUCTION. THE CONTRACTOR IS FULLY RESPONSIBLE FOR ANY AND ALL DAMAGE CAUSED BY ITS FAILURE TO LOCATE, IDENTIFY AND PRESERVE ANY AND ALL EXISTING UTILITIES, PIPELINES, AND UNDERGROUND UTILITY LINES.
- 3. CONTRACTOR SHALL NOT USE VIBRATORY COMPACTION EQUIPMENT OR HEAVY VEHICLES OVER EXISTING UTILITIES.
- 4. SITE STORM DRAIN, ELECTRIC LINES & TRANSFORMERS AND GAS LINES ARE SHOWN FOR GENERAL INFORMATION ONLY TO PROVIDE AN OVERVIEW OF SITE UTILITIES AND POTENTIAL CONFLICTS. SEE MECHANICAL PLANS FOR GAS LINE SIZING. SEE CG-101 FOR STORM DRAIN DESIGN.
- 5. ALL ABOVE GROUND UTILITY EQUIPMENT AND FITTINGS SHALL BE PAINTED IN COLORS TO MATCH BUILDING COLORS.


RESTRAINED JOINT CRITERIA


FOR WATERLINE FITTINGS

- 1. ALL MECHANICAL JOINTS SHALL BE RESTRAINED AT THE FITTINGS PER KEYED NOTES THIS SHEET.
- 2. THE CONTRACTOR SHALL PROVIDE A MINIMUM PIPE LENGTH OF 20 LF FROM ALL MECHANICAL JOINTS. ALL PIPE JOINTS WITHIN 20 LF OF A MECHANICAL JOINT SHALL BE RESTRAINED AT THE CONTRACTOR'S EXPENSE.
- 3. THE CONTRACTOR SHALL RESTRAIN ALL PIPE JOINTS IN THE SPECIFIED DISTANCE LISTED IN THE KEYED NOTES.
- 4. THE CONTRACTOR SHALL RESTRAIN ALL FIRE HYDRANT JOINTS FROM THE TEE ON THE MAIN TO THE FIRE HYDRANT FLANGE.

DEPTH OF BURY: FACTOR OF SAFETY: MATERIAL: SOIL TYPE:	3.0 FT. MINIMUM 1.50 PVC GM/SM - SILTY GRAVELS AND SILTY SANDS, GRAVEL- SAND-SILT MIXTURES.
TEST PRESSURE:	150 PSI
TRENCH TYPE 4:	PIPE BEDDED IN SAND, GRAVEL, OR CRUSHED STONE TO DEPTH OF 1/8 PIPE DIAMETER, 4 INCH MINIMUM; BACKFILL COMPACTED TO TOP OF PIPE.

DIFFERENT CRITERIA, E.G., GREATER DEPTH OF BURY, ETC., WILL REQUIRE DIFFERENT RESTRAINED LENGTHS. THESE MUST BE CALCULATED BY A QUALIFIED PROFESSIONAL ENGINEER AND APPROVED BY ABCWUA.

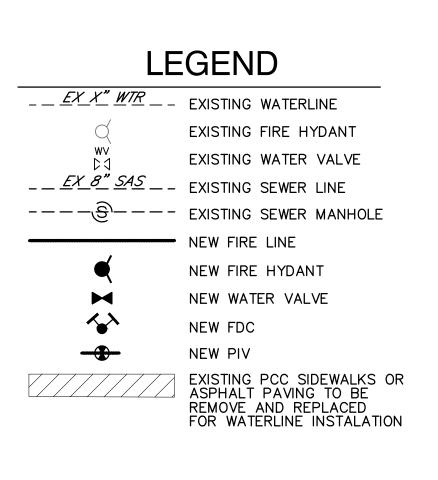

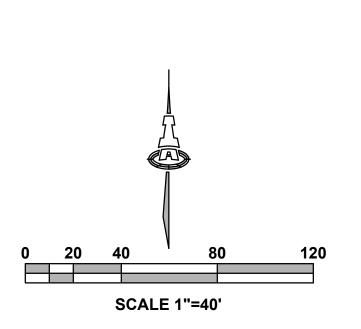

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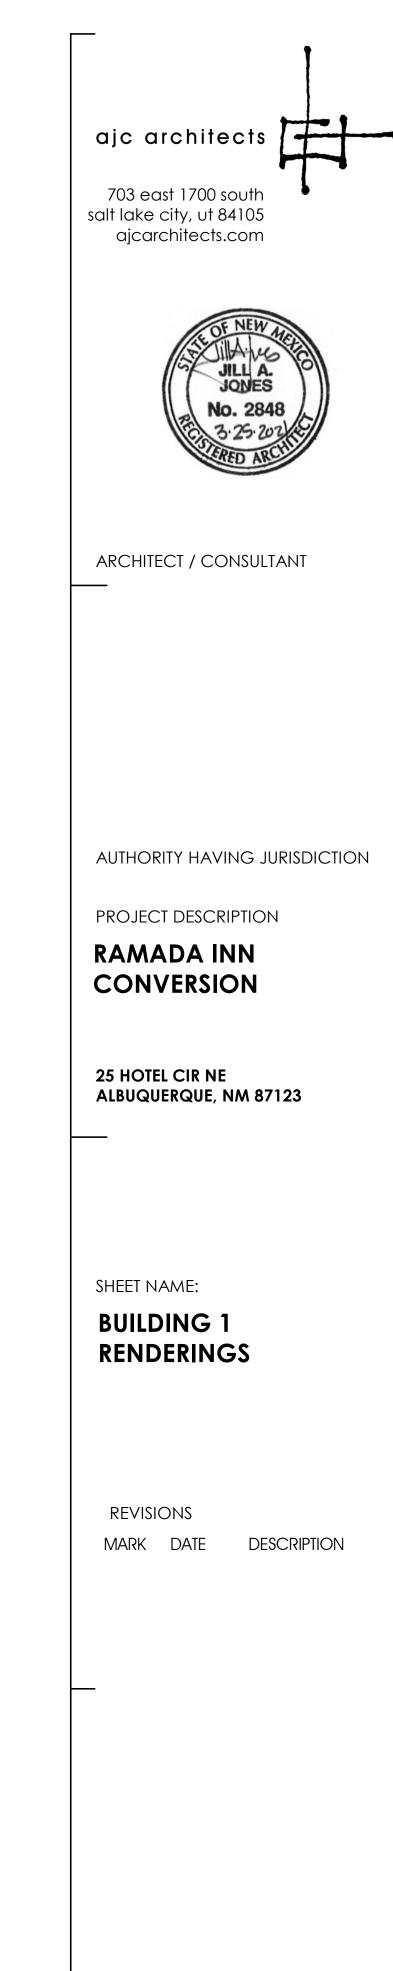


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ISSUE DATE: ISSUE TYPE: DRAWN BY: LT CHECKED BY: K. RIGBY PROJECT#: 2020-64

3/26/2021 DRB SUBMITTAL

SHEET NUMBER:



5





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4

GENERAL NOTES:

CONTRACTOR / SUBCONTRACTOR SHALL VERIFY ALL DIMENSIONS AND CONDITIONS BEFORE BEGINNING WORK, AND SHALL REPORT TO THE ARCHITECT ANY ERRORS, INCONSISTENCIES OR OMISSIONS BEFORE BEGINNING WORK. SEE GENERAL NOTES AND

5

ALL MECHANICAL EQUIPMENT VISIBLE FROM PUBLIC SIDEWALK TO BE SCREENED

ELEVATION FINISHES



P1



ARCHITECT / CONSULTANT

ajc architects

703 east 1700 south

ajcarchitects.com

salt lake city, ut 84105

AUTHORITY HAVING JURISDICTION

PROJECT DESCRIPTION

RAMADA INN CONVERSION

25 HOTEL CIR NE ALBUQUERQUE, NM 87123

Sheet Name:

BUILDING 1 ELEVATIONS


REVISIONS Mark date

DESCRIPTION

ISSUE DATE:
ISSUE TYPE:
DRAWN BY:
CHECKED BY
PROJECT#:

3/26/2021 DRB SUBMITTAL ZS/LT K. RIGBY 2020-64



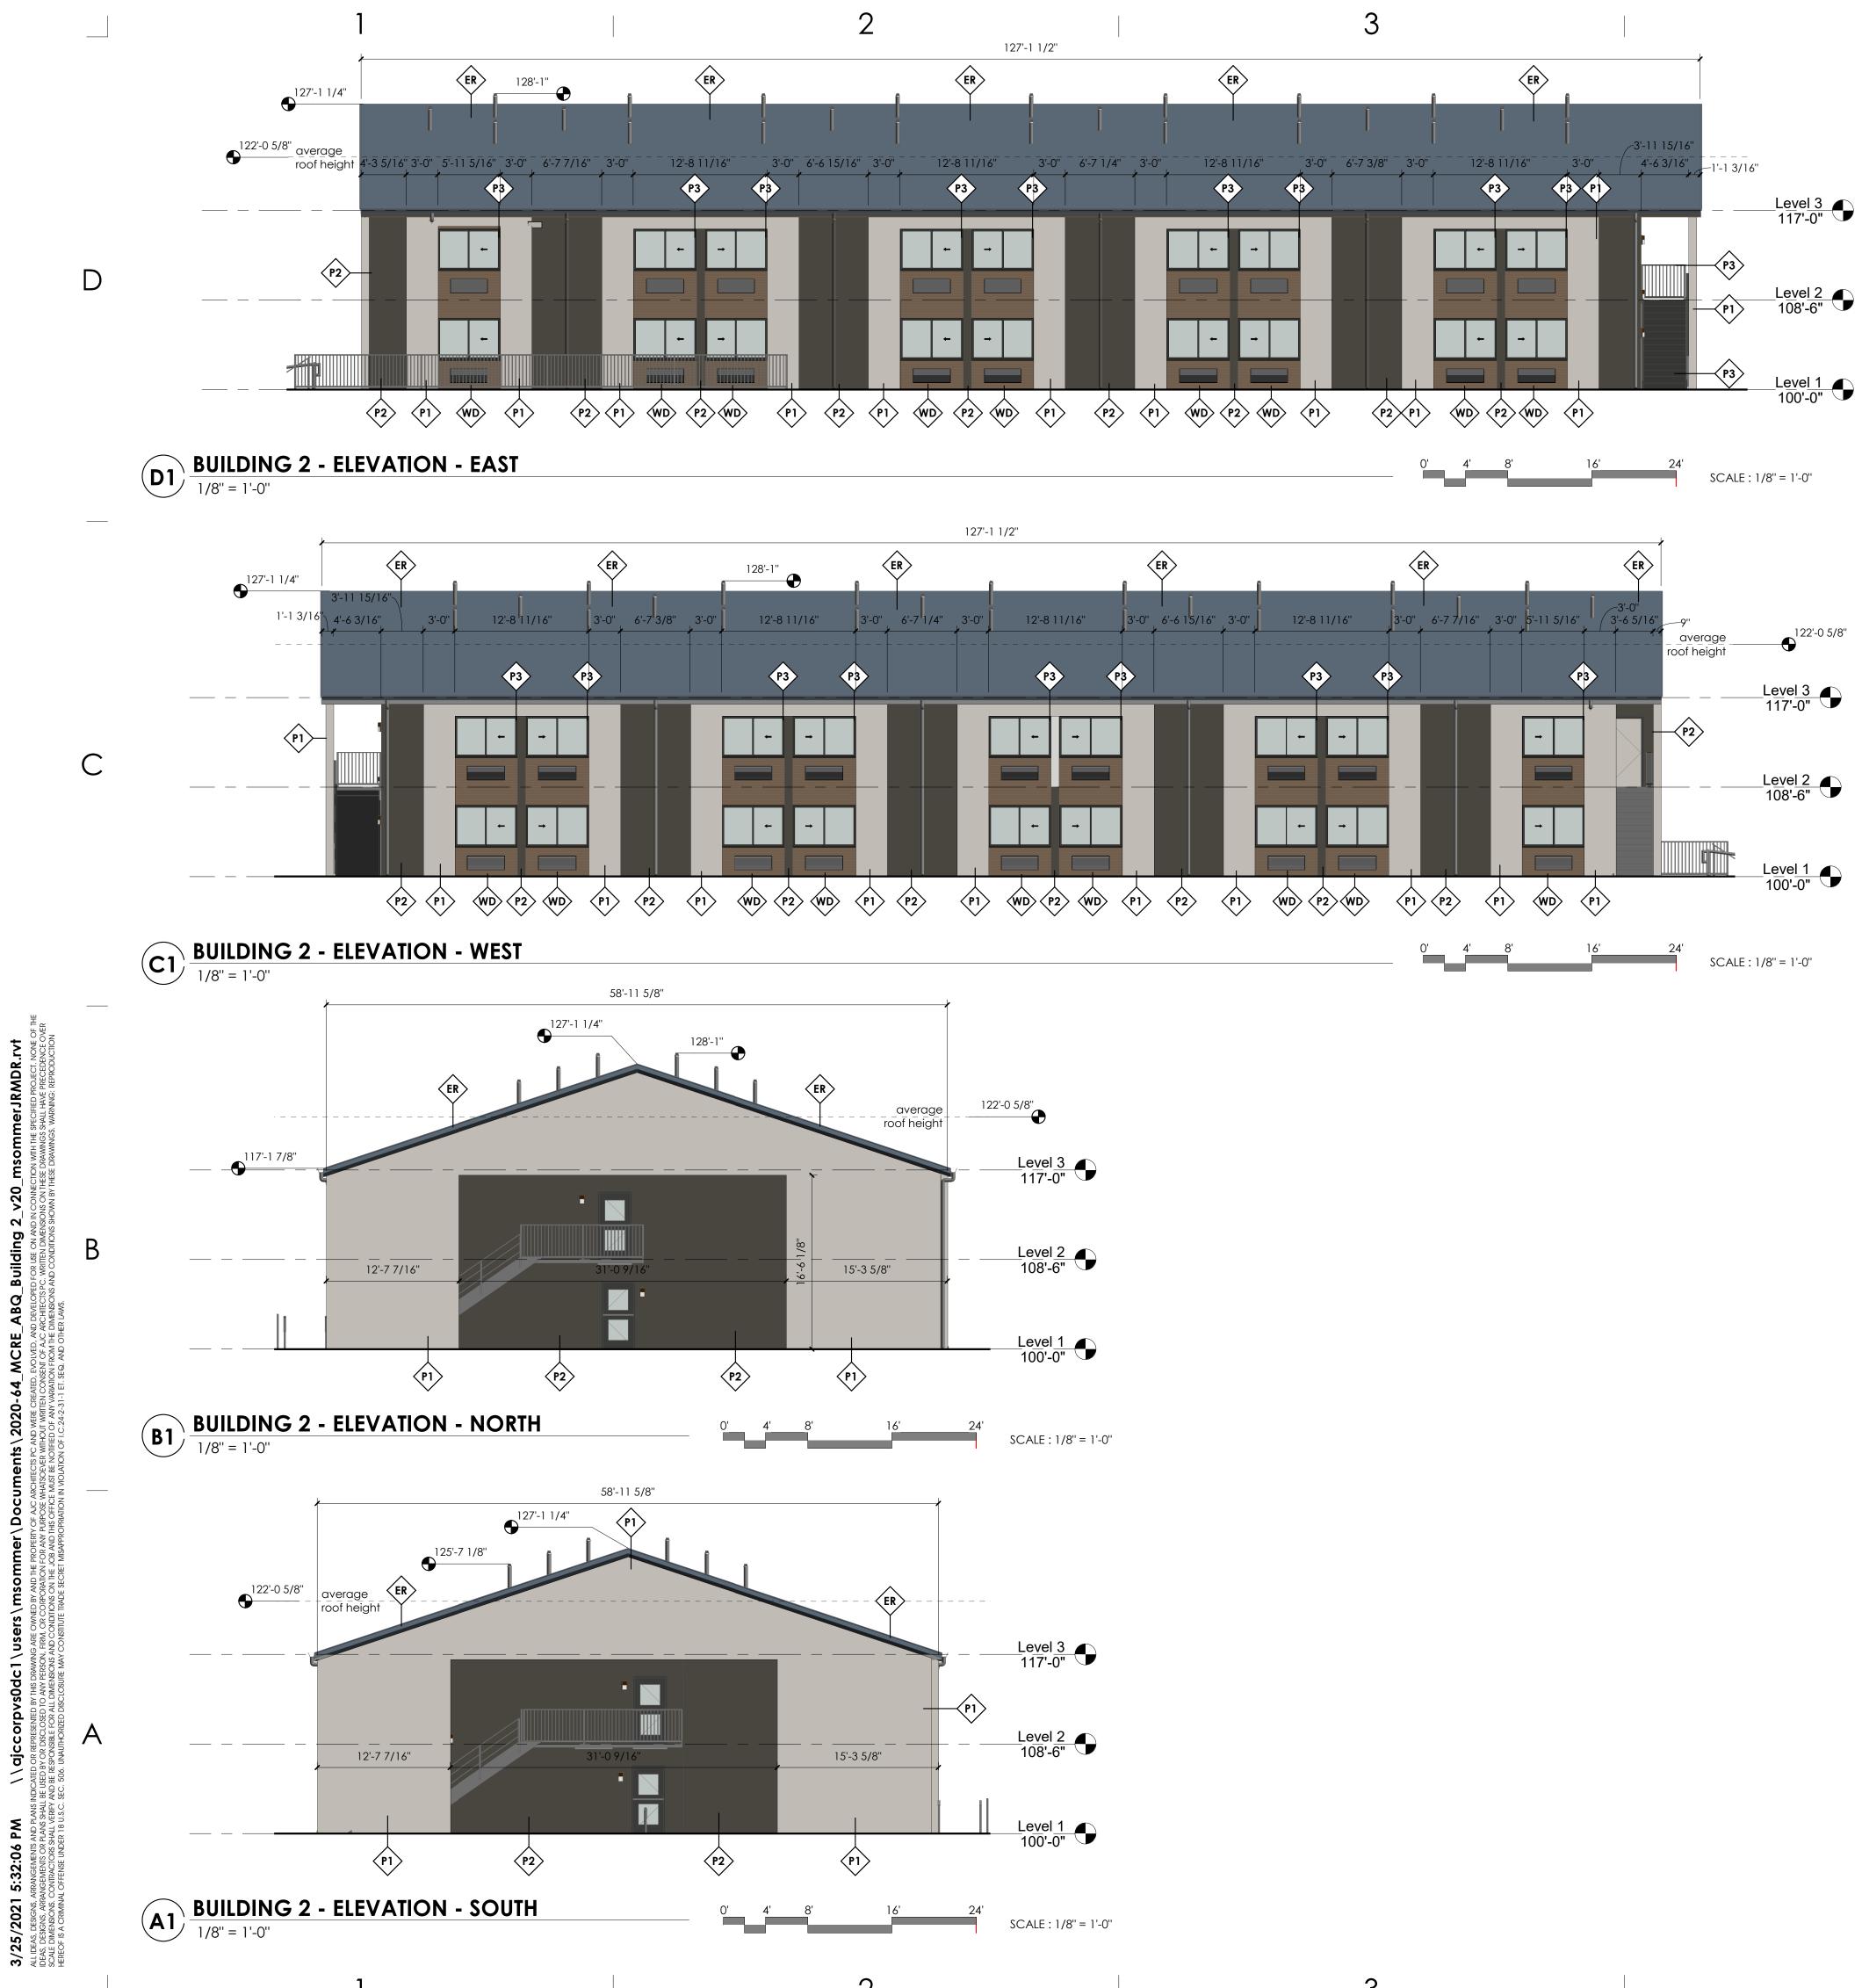

2

GENERAL NOTES:

DO NOT SCALE DRAWINGS.

CONTRACTOR / SUBCONTRACTOR SHALL VERIFY ALL DIMENSIONS AND CONDITIONS BEFORE BEGINNING WORK, AND SHALL REPORT TO THE ARCHITECT ANY ERRORS, INCONSISTENCIES OR OMISSIONS BEFORE BEGINNING WORK. SEE GENERAL NOTES AND SPECIFICATIONS.

ALL MECHANICAL EQUIPMENT VISIBLE FROM PUBLIC SIDEWALK TO BE SCREENED

ELEVATION FINISHES

NEW STUCCO FINISH - PAINTED	
NEW STUCCO FINISH - PAINTED	
NEW STUCCO/TRIM FINISH - PAINTED	
NEW HORIZONTAL LAP SIDING	
STONE VENEER CLADDING	
EXISITNG ROOF	

KEYED NOTES:

ajc architects

703 east 1700 south salt lake city, ut 84105 ajcarchitects.com

P1



ARCHITECT / CONSULTANT

AUTHORITY HAVING JURISDICTION

PROJECT DESCRIPTION

RAMADA INN CONVERSION

25 HOTEL CIR NE ALBUQUERQUE, NM 87123

SHEET NAME:

BUILDING 2 ELEVATIONS


REVISIONS Mark date


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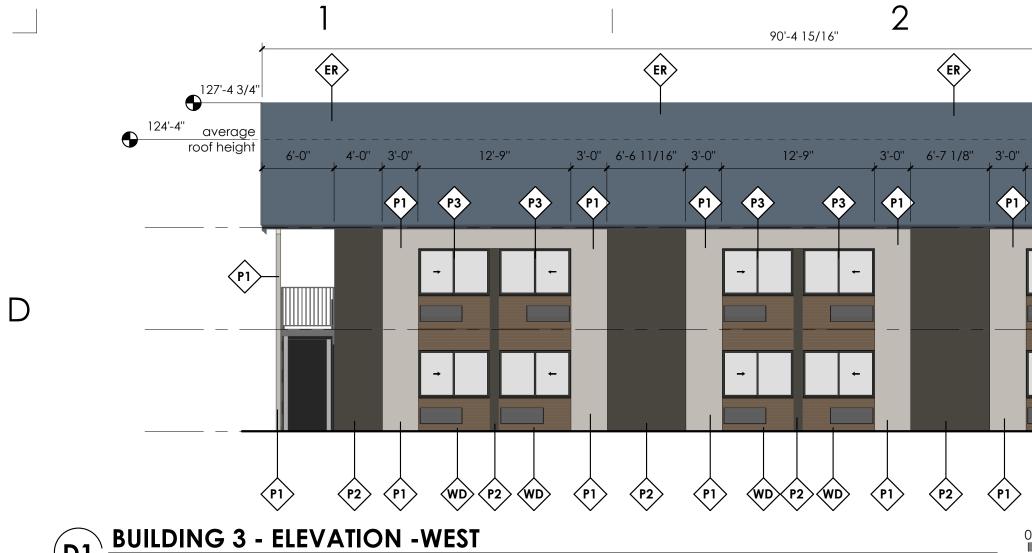
ISSUE DATE: ISSUE TYPE: DRAWN BY: CHECKED BY: K. RIGBY PROJECT#:


3/26/2021 DRB SUBMITTAL ZS/LT 2020-64





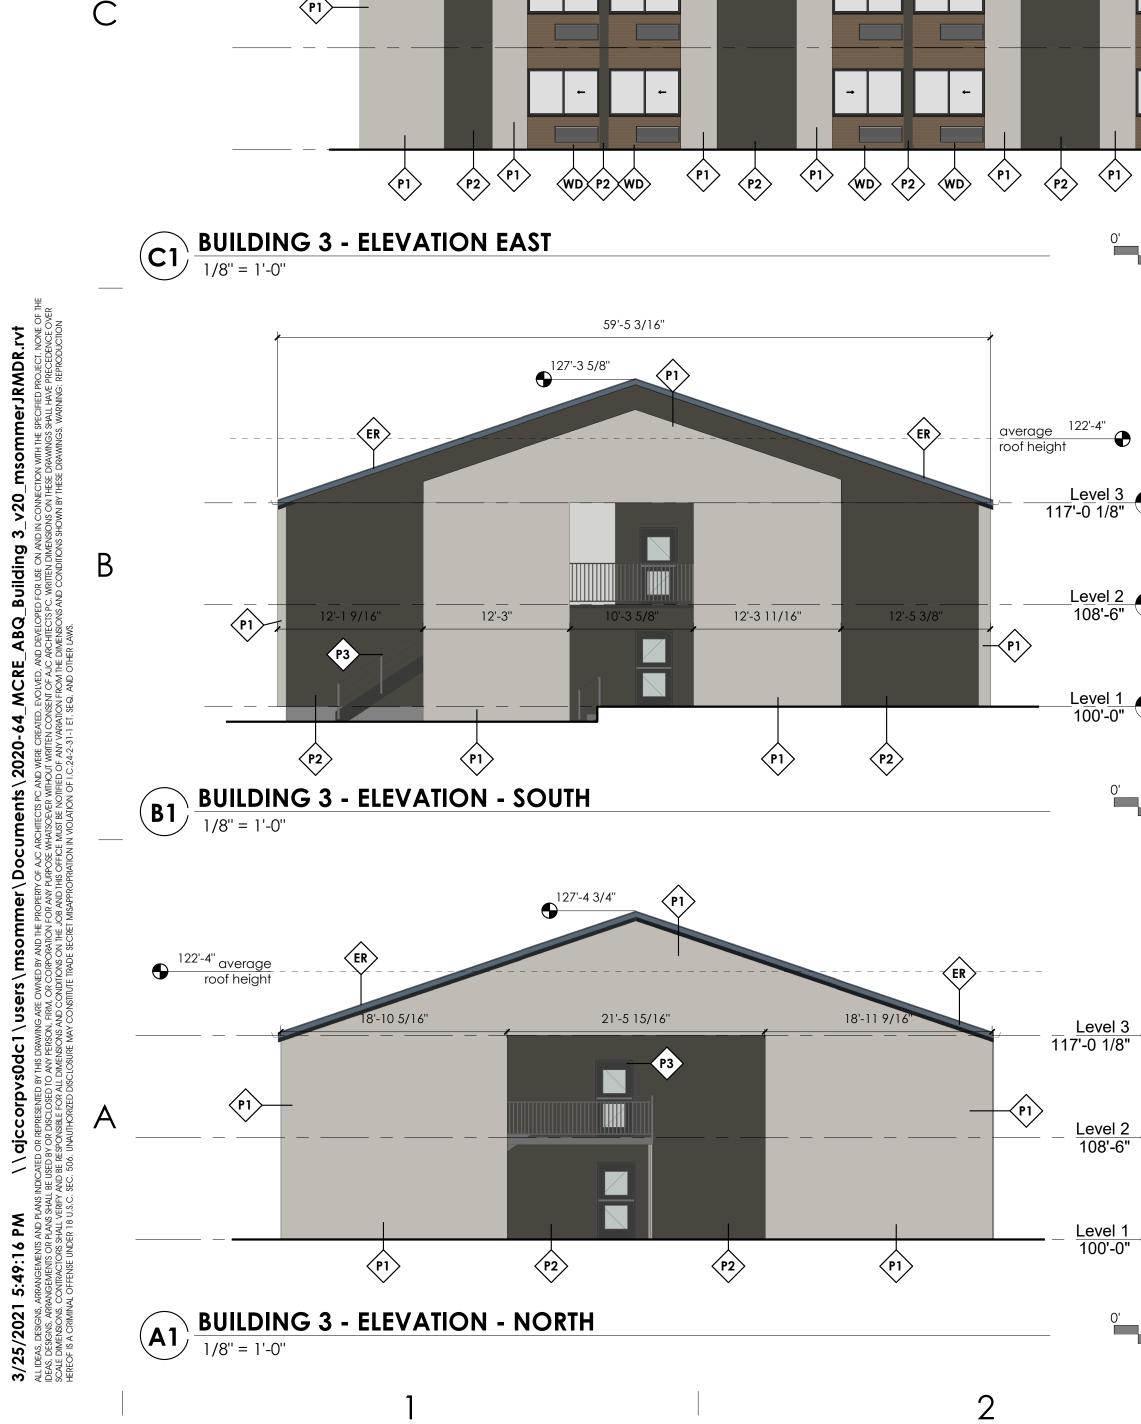

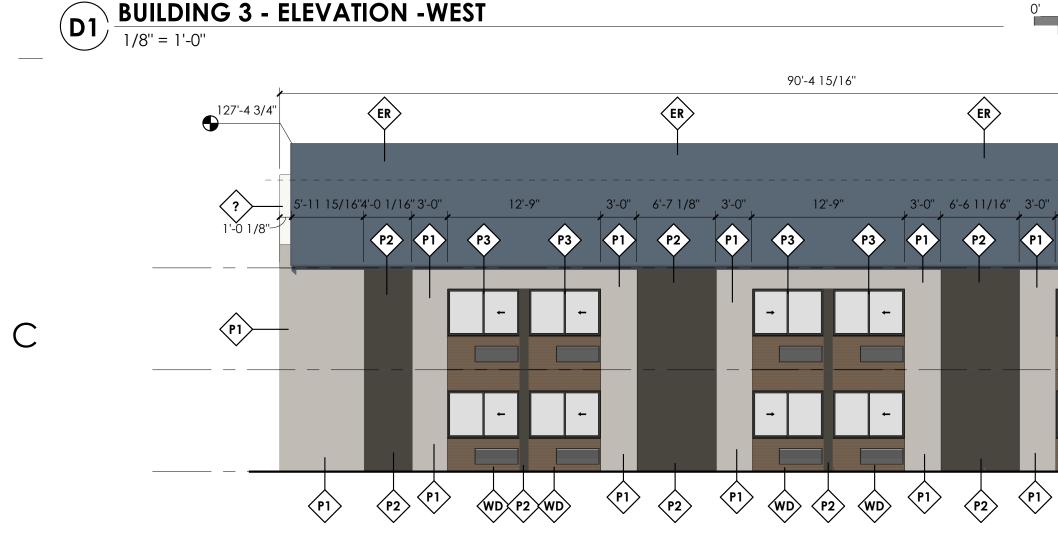

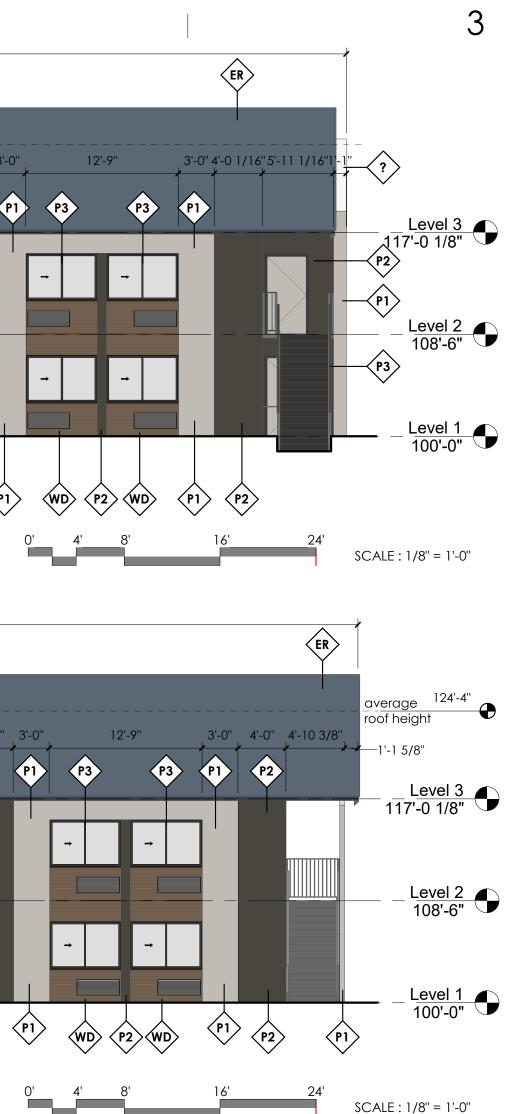

Level 3 117'-0 1/8"

Level 2 108'-6" Level 1 100'-0"

0' 4' 8' SCALE : 1/8" = 1'-0"

Level 3 117'-0 1/8"

Level 2 108'-6"

Level 1 100'-0"

0' 4' ŏ SCALE : 1/8" = 1'-0"

3

4

4

5 **GENERAL NOTES:** do not scale drawings. ajc architects CONTRACTOR / SUBCONTRACTOR SHALL VERIFY ALL DIMENSIONS AND CONDITIONS BEFORE BEGINNING WORK, AND SHALL REPORT TO THE ARCHITECT ANY ERRORS, INCONSISTENCIES OR OMISSIONS BEFORE BEGINNING WORK. SEE GENERAL NOTES AND SPECIFICATIONS. 703 east 1700 south salt lake city, ut 84105 ALL MECHANICAL EQUIPMENT VISIBLE FROM PUBLIC SIDEWALK TO BE SCREENED ajcarchitects.com **ELEVATION FINISHES** JONES NEW STUCCO FINISH - PAINTED No. 2848 P1 NEW STUCCO FINISH - PAINTED NEW STUCCO/TRIM FINISH - PAINTED ARCHITECT / CONSULTANT NEW HORIZONTAL LAP SIDING STONE VENEER CLADDING **EXISITNG ROOF**

AUTHORITY HAVING JURISDICTION

PROJECT DESCRIPTION

RAMADA INN CONVERSION

25 HOTEL CIR NE ALBUQUERQUE, NM 87123

SHEET NAME:

BUILDING 3 ELEVATIONS

REVISIONS Mark date

DESCRIPTION

ISSUE DATE: ISSUE TYPE: DRAWN BY: CHECKED BY: K. RIGBY PROJECT#:


3/26/2021 DRB SUBMITTAL ZS/LT 2020-64

SHEET NUMBER:



KEYED NOTES:

5

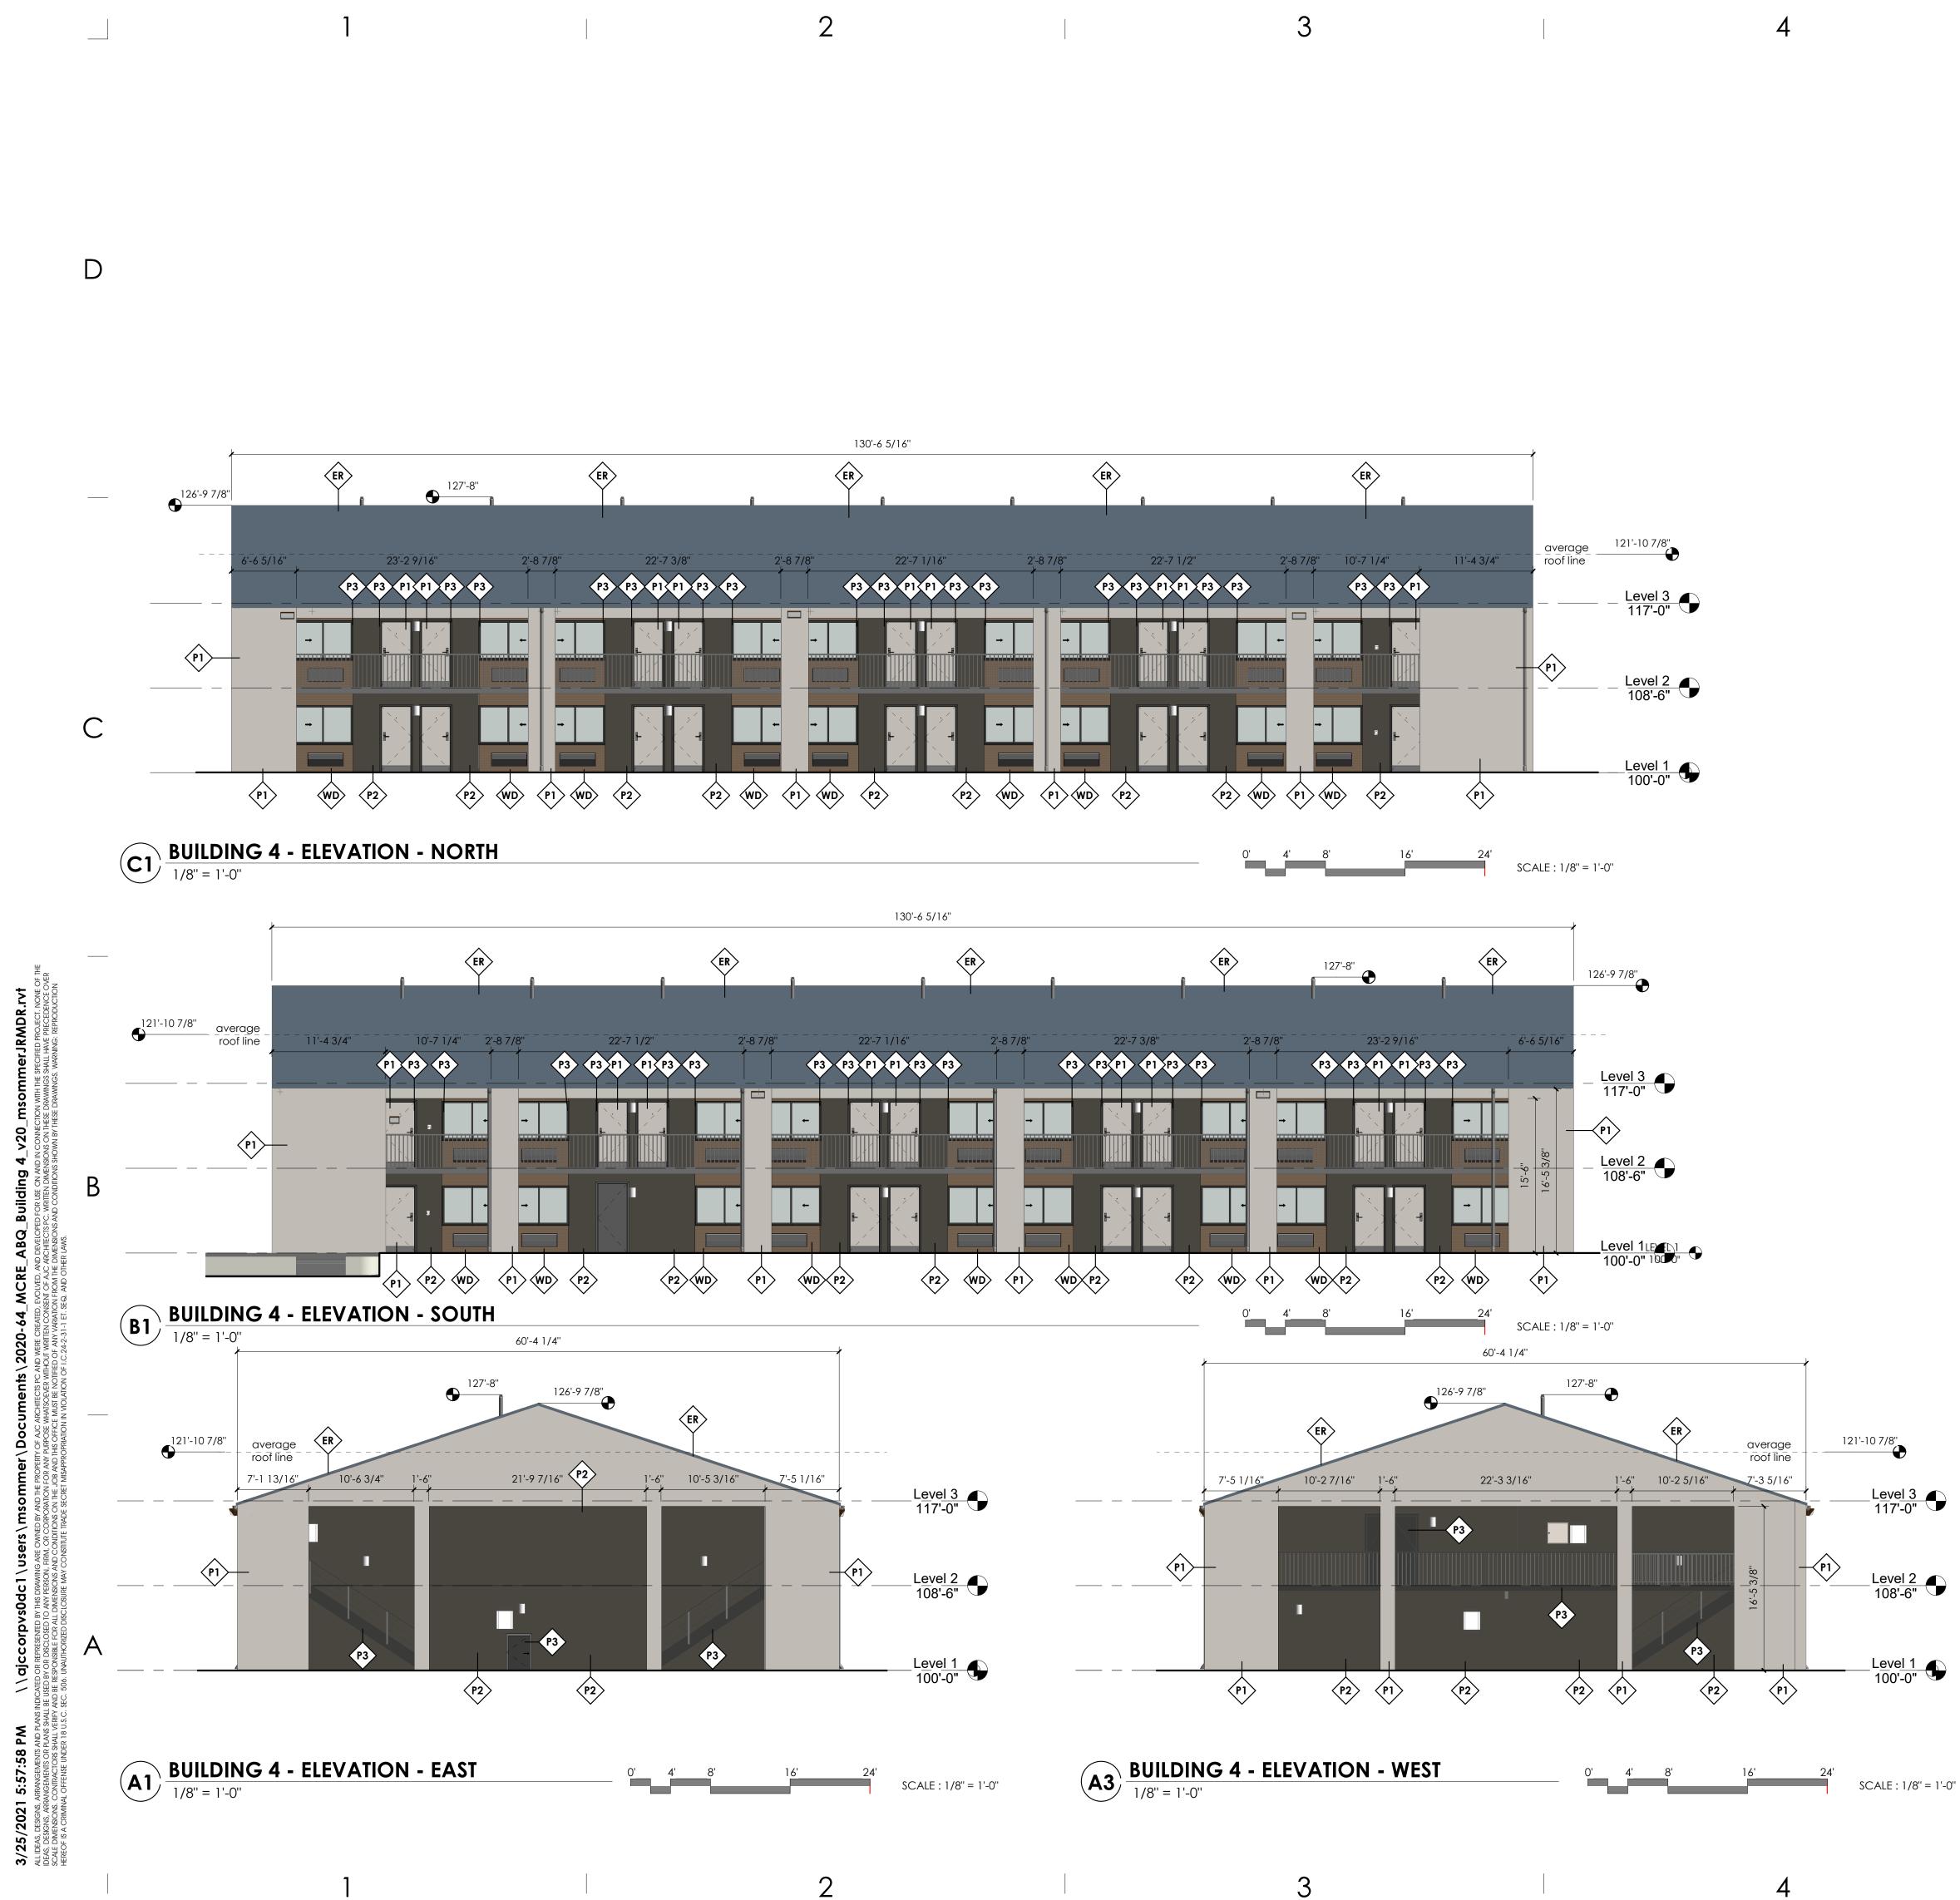

GENERAL NOTES:

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5

ALL MECHANICAL EQUIPMENT VISIBLE FROM PUBLIC SIDEWALK TO BE SCREENED

ELEVATION FINISHES

NEW STUCCO FINISH - PAINTED	
NEW STUCCO FINISH - PAINTED	
NEW STUCCO/TRIM FINISH - PAINTED	
HORIZONTAL LAP SIDING	
STONE VENEER CLADDING	

EXISITNG ROOF

KEYED NOTES:

ajc architects

703 east 1700 south salt lake city, ut 84105 ajcarchitects.com

P1



ARCHITECT / CONSULTANT

AUTHORITY HAVING JURISDICTION

PROJECT DESCRIPTION

RAMADA INN CONVERSION

ENTER PROJECT ADDRESS HERE

Sheet NAME:

BUILDING 4 ELEVATIONS


REVISIONS Mark date

DESCRIPTION


ISSUE DATE: ISSUE TYPE: DRAWN BY: CHECKED BY: K. RIGBY PROJECT#:

3/26/2021 DRB SUBMITTAL ZS/LT 2020-64



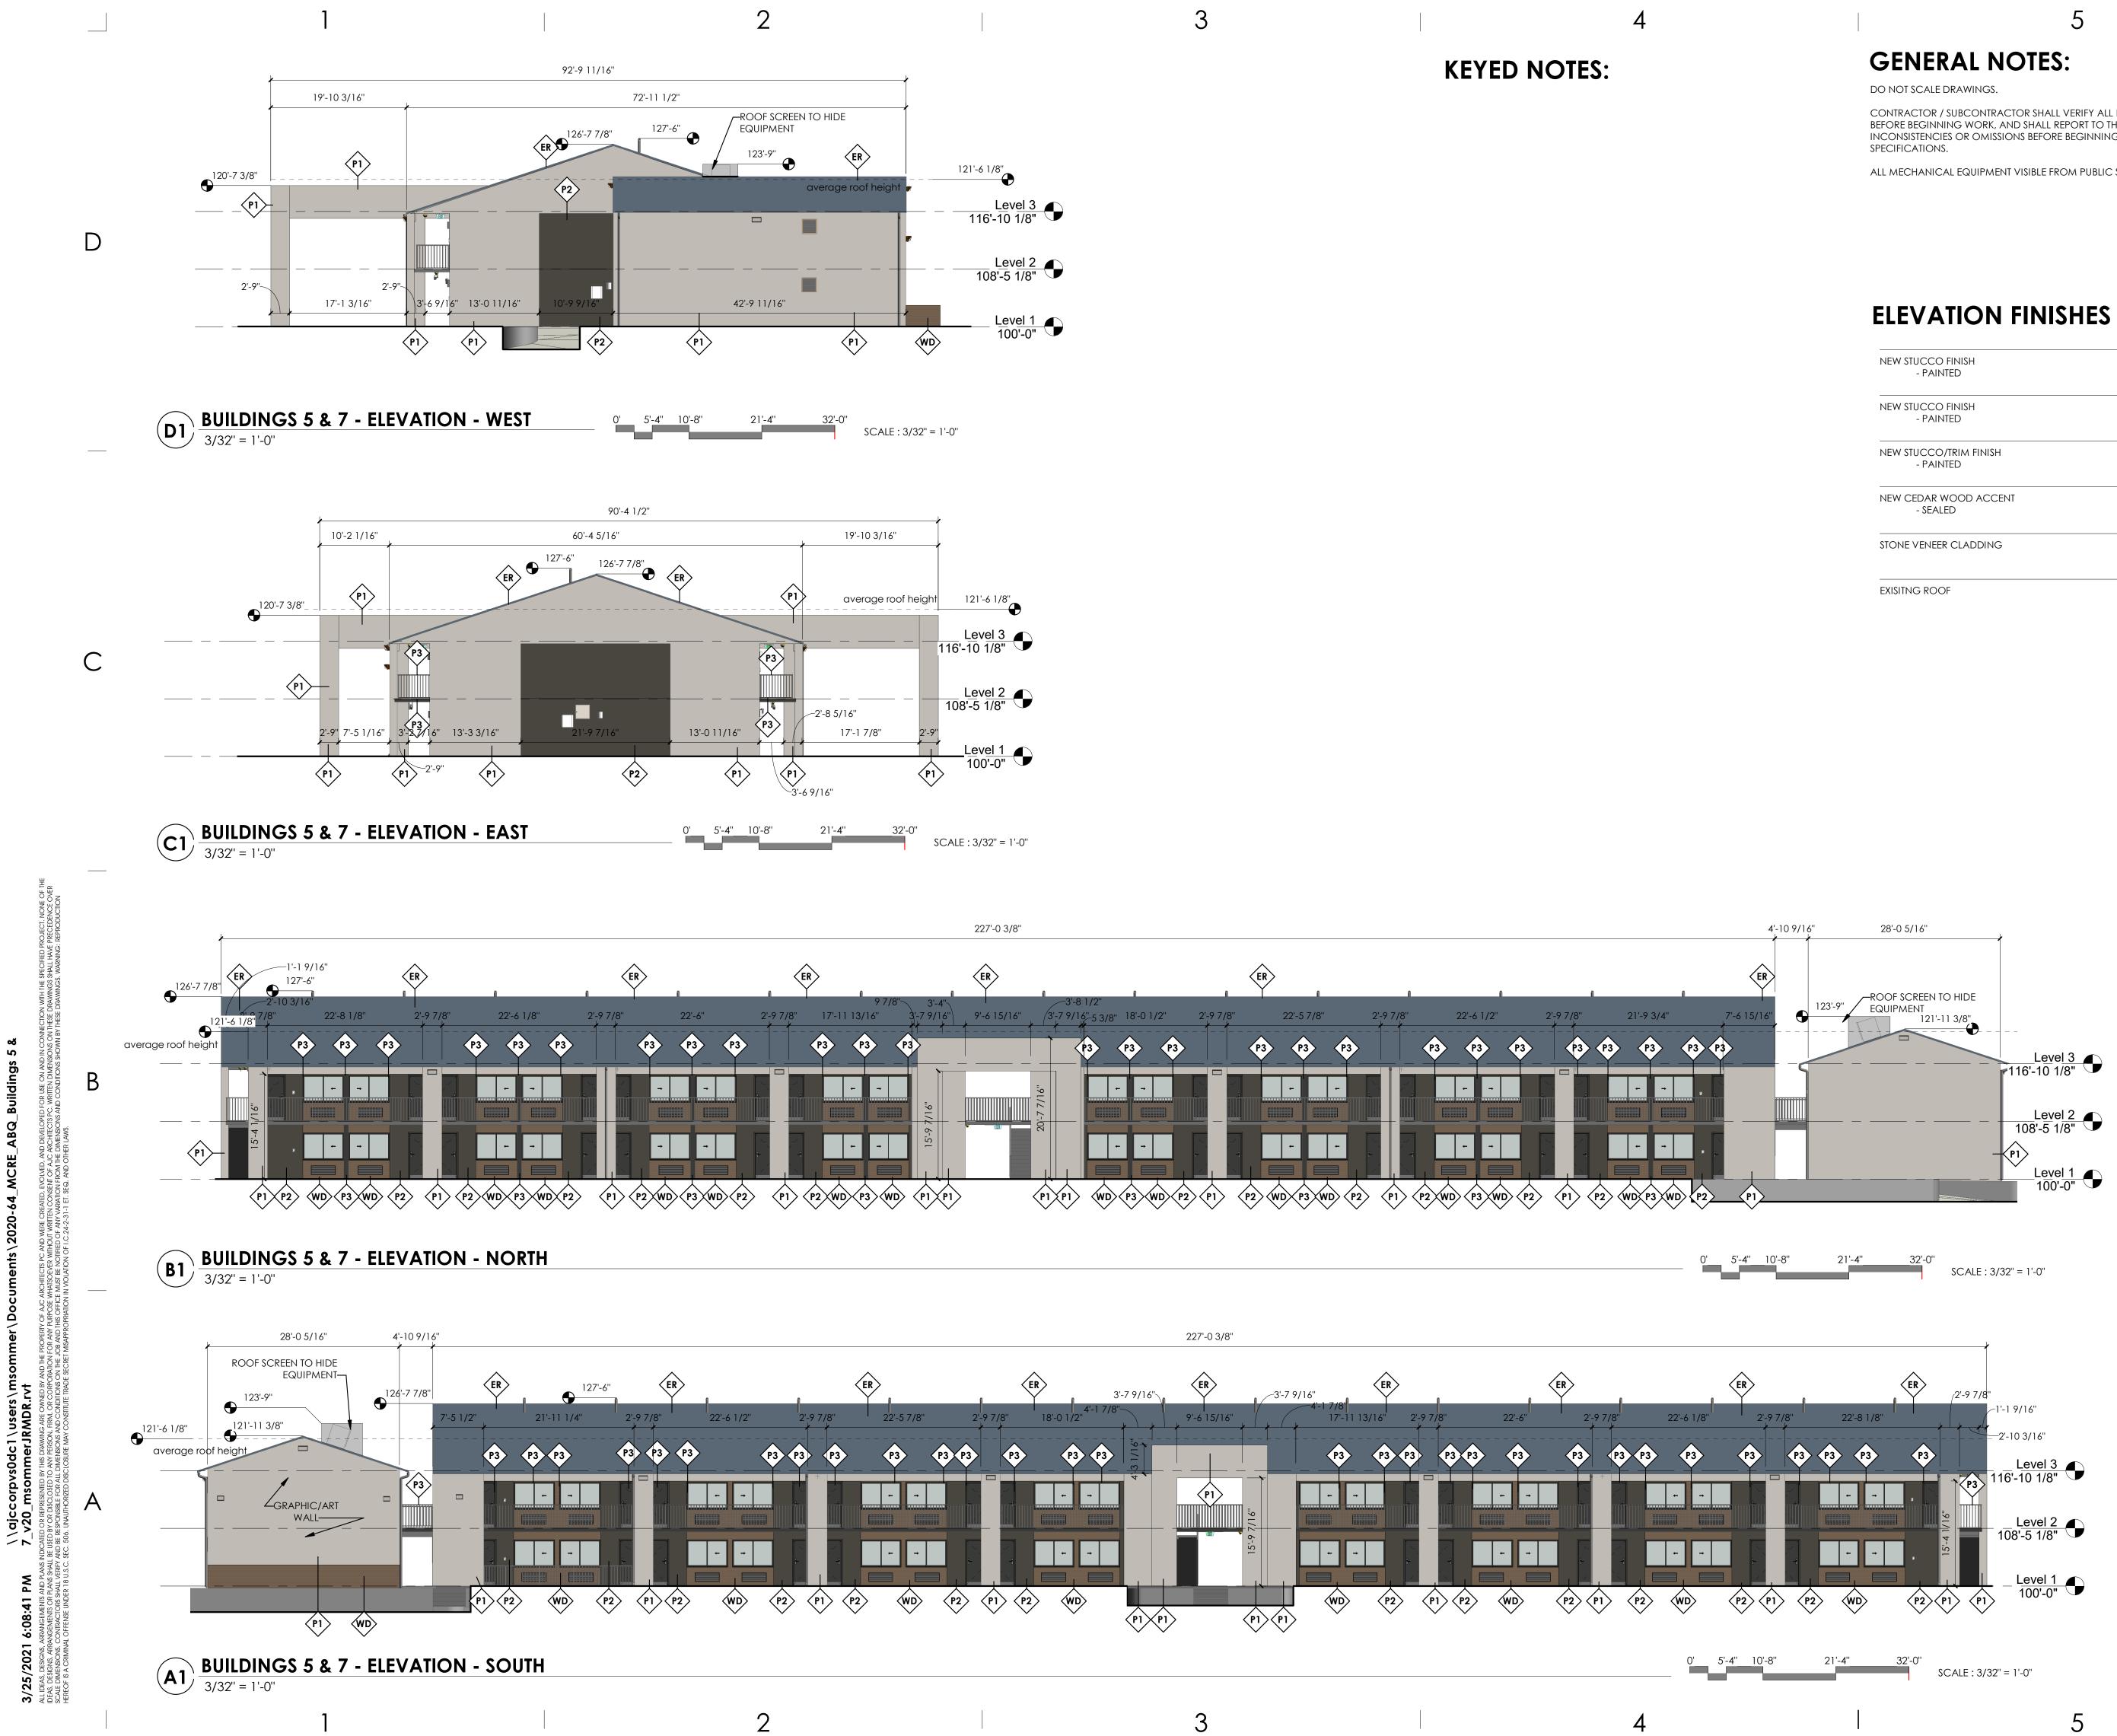



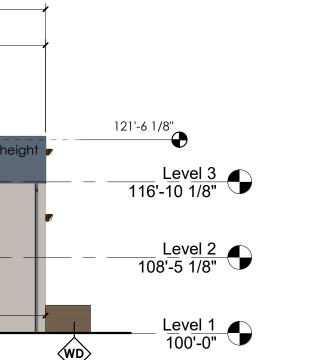



CONTRACTOR / SUBCONTRACTOR SHALL VERIFY ALL DIMENSIONS AND CONDITIONS BEFORE BEGINNING WORK, AND SHALL REPORT TO THE ARCHITECT ANY ERRORS, INCONSISTENCIES OR OMISSIONS BEFORE BEGINNING WORK. SEE GENERAL NOTES AND

ALL MECHANICAL EQUIPMENT VISIBLE FROM PUBLIC SIDEWALK TO BE SCREENED

NEW STUCCO FINISH - PAINTED	Pl
NEW STUCCO FINISH - PAINTED	P2
NEW STUCCO/TRIM FINISH - PAINTED	P3
NEW CEDAR WOOD ACCENT - SEALED	WD
STONE VENEER CLADDING	
EXISITNG ROOF	ER



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AUTHORITY HAVING JURISDICTION

PROJECT DESCRIPTION

RAMADA INN CONVERSION

25 HOTEL CIR NE ALBUQUERQUE, NM 87123

Sheet Name:

BUILDINGS 5 & 7 ELEVATIONS


REVISIONS Mark date

DESCRIPTION

ISSUE DATE: ISSUE TYPE: DRAWN BY: CHECKED BY: PROJECT#:

3/26/2021 **DRB SUBMITTAL** ZS/LT K. RIGBY 2020-64



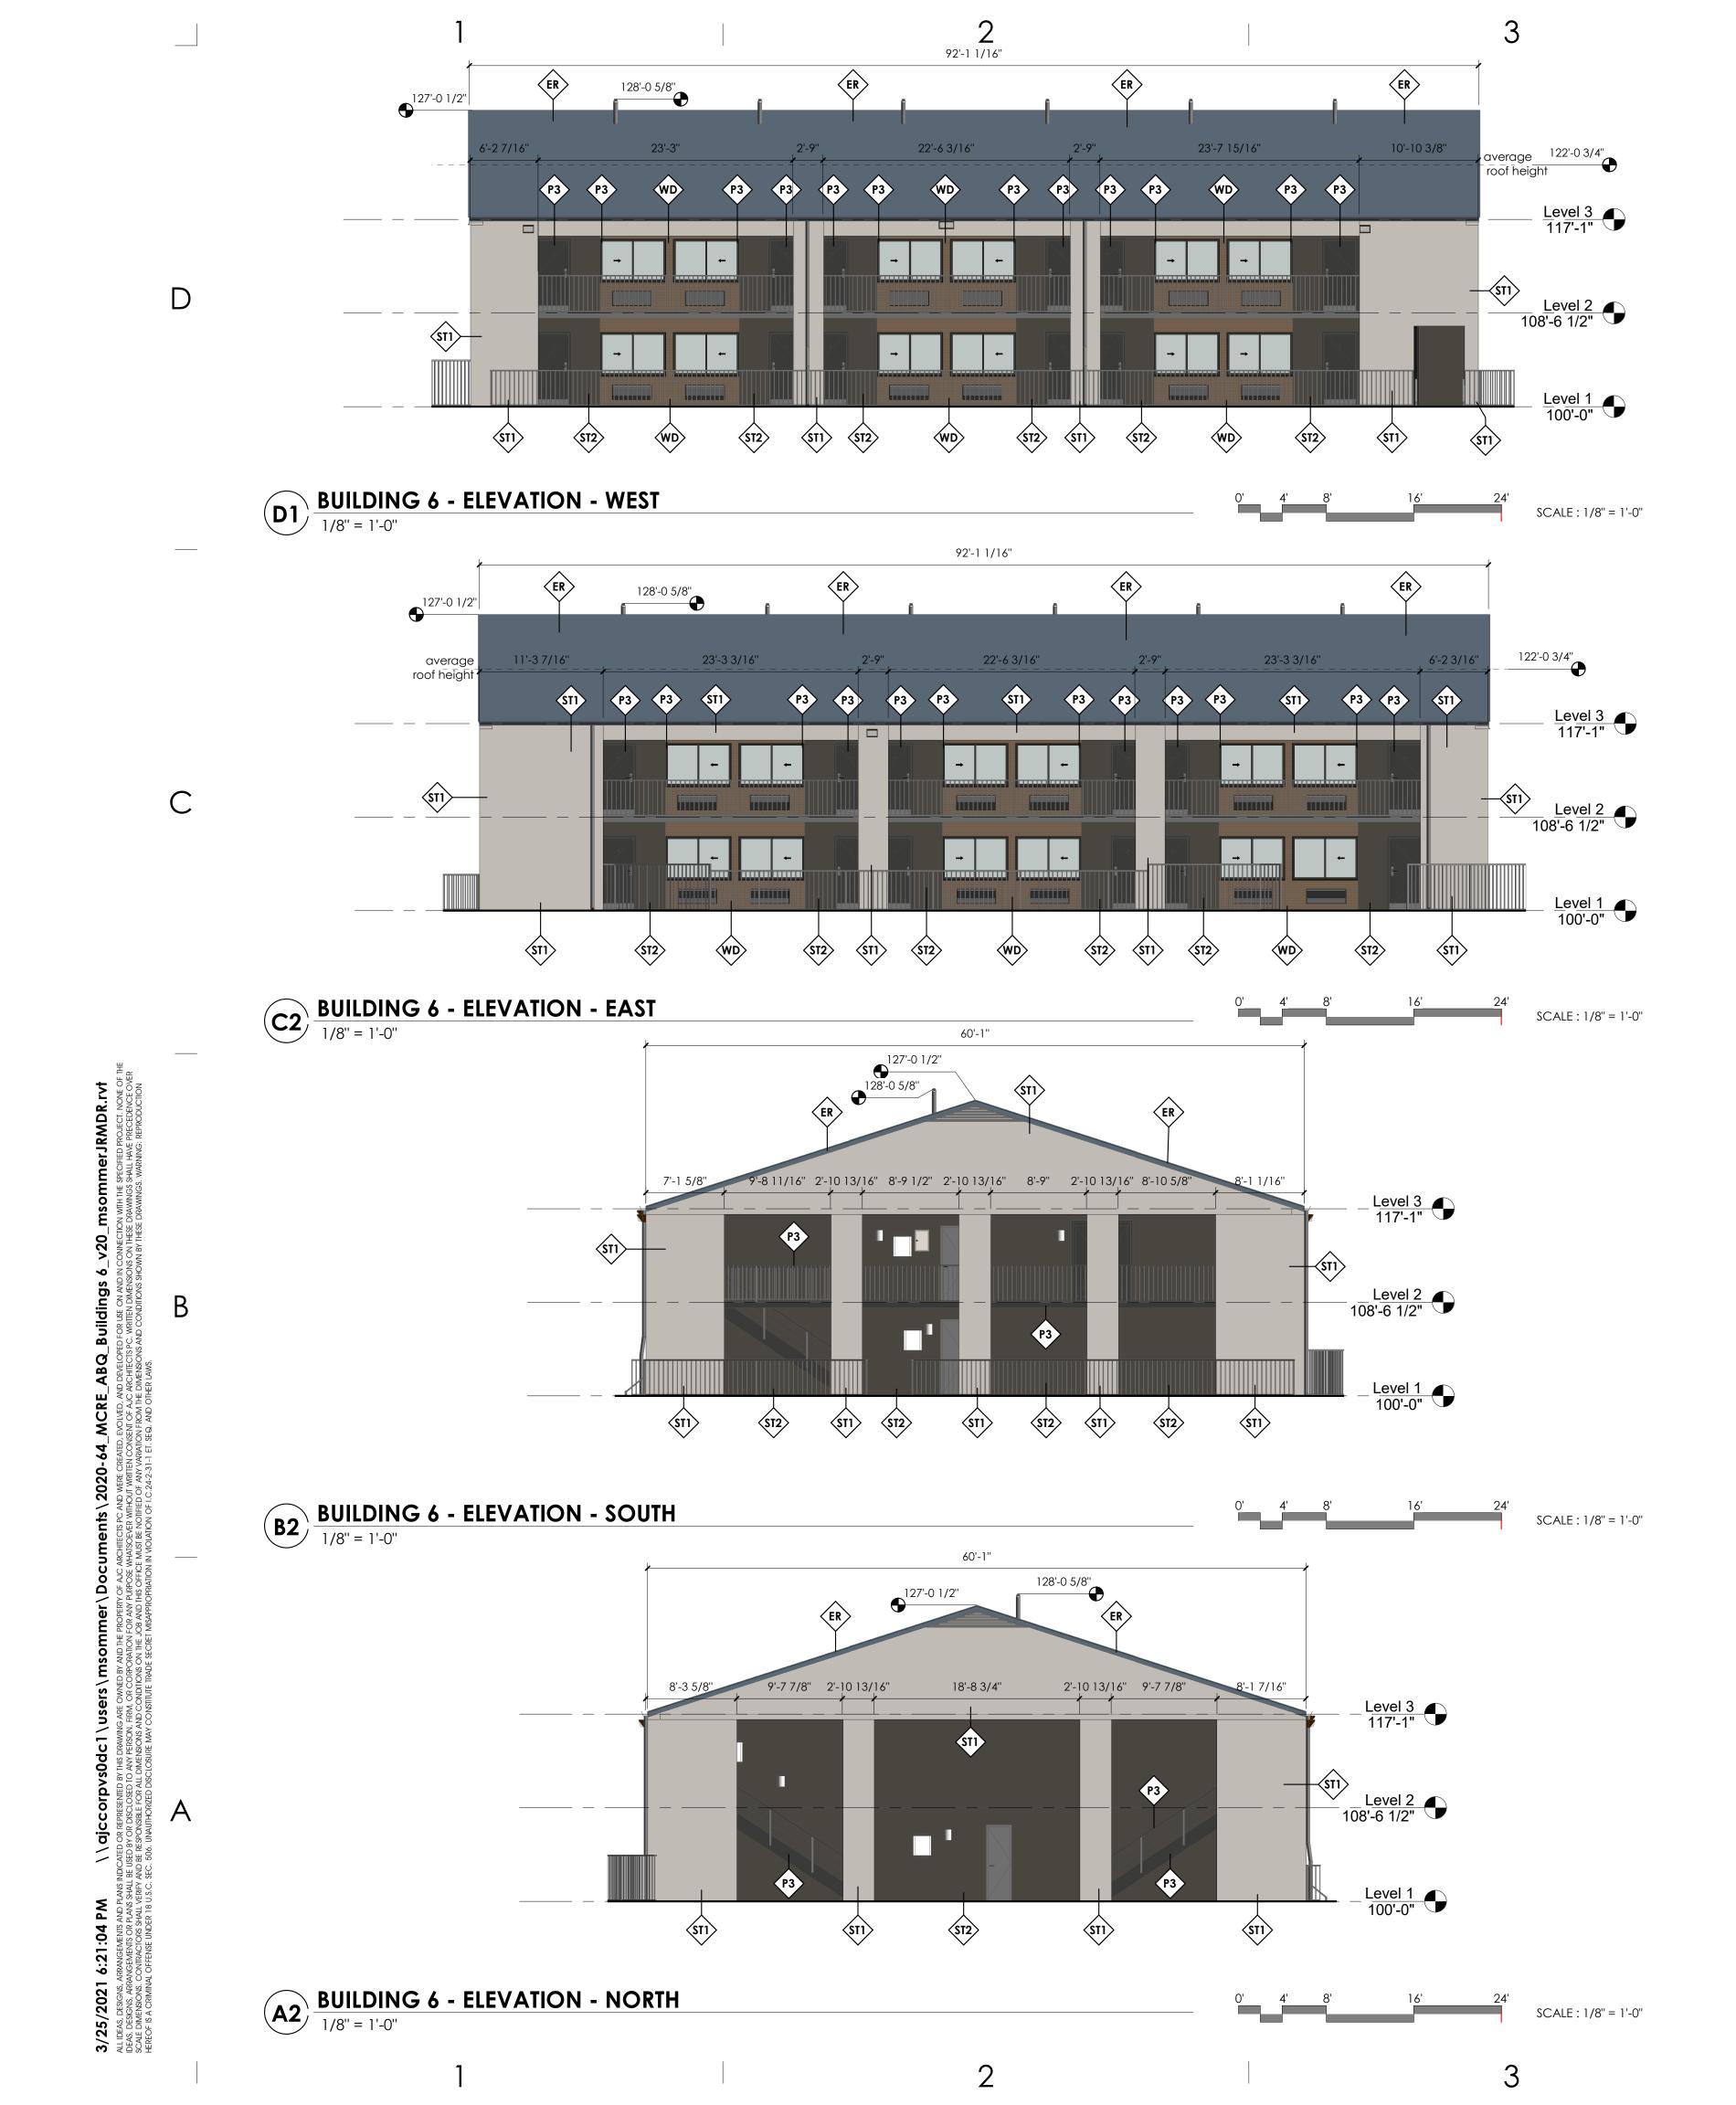

4

4

GENERAL NOTES:

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5

ALL MECHANICAL EQUIPMENT VISIBLE FROM PUBLIC SIDEWALK TO BE SCREENED

ELEVATION FINISHES

NEW STUCCO FINISH - PAINTED	
NEW STUCCO FINISH - PAINTED	
NEW STUCCO/TRIM FINISH - PAINTED	
NEW HORIZONTAL LAP SIDING	
STONE VENEER CLADDING	

EXISITNG ROOF

KEYED NOTES:

ajc architects

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AUTHORITY HAVING JURISDICTION

PROJECT DESCRIPTION

RAMADA INN CONVERSION

25 HOTEL CIR NE ALBUQUERQUE, NM 87123

Sheet NAME:

BUILDING 6 ELEVATIONS


REVISIONS Mark date

DESCRIPTION

ISSUE DATE: ISSUE TYPE: DRAWN BY: CHECKED BY: K. RIGBY PROJECT#:

3/26/2021 DRB SUBMITTAL ZS/LT 2020-64



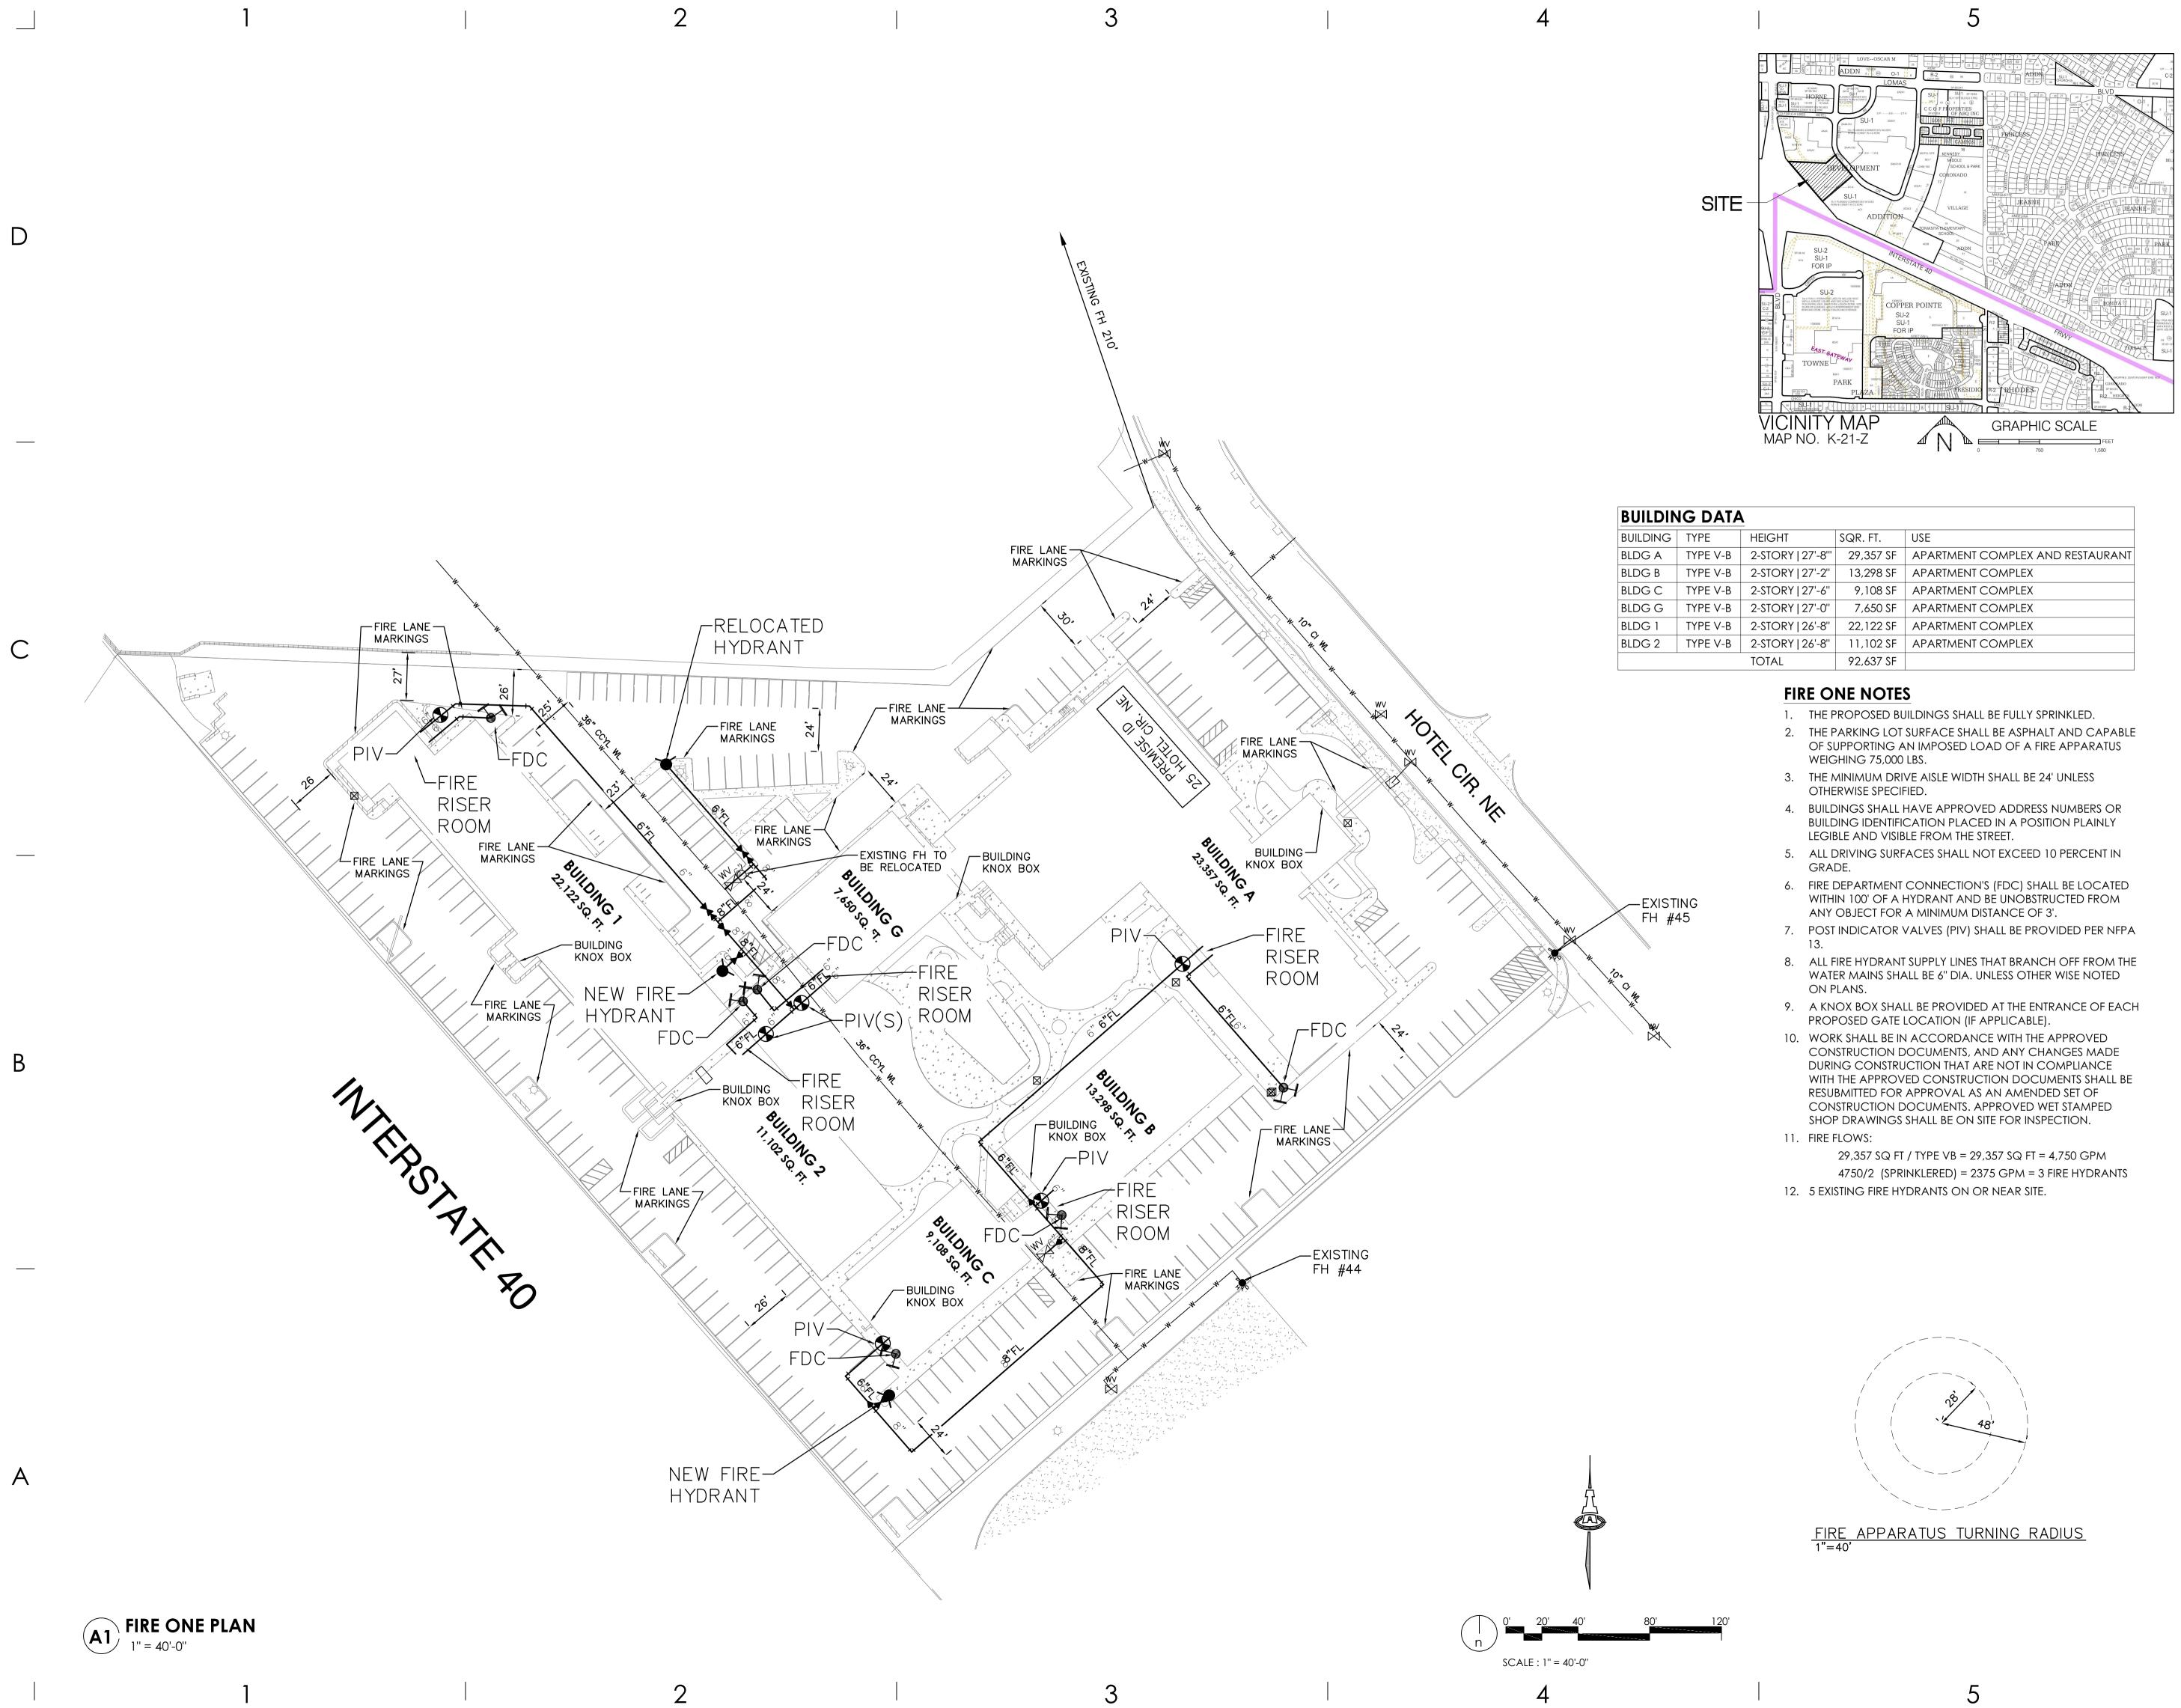

	_		
Ē	HEIGHT	SQR. FT.	USE
EV-B	2-STORY 27'-8'"	29,357 SF	APARTMENT COMPLEX AND RESTAURANT
EV-B	2-STORY 27'-2"	13,298 SF	APARTMENT COMPLEX
EV-B	2-STORY 27'-6''	9,108 SF	APARTMENT COMPLEX
EV-B	2-STORY 27'-0''	7,650 SF	APARTMENT COMPLEX
E V-B	2-STORY 26'-8''	22,122 SF	APARTMENT COMPLEX
E V-B	2-STORY 26'-8''	11,102 SF	APARTMENT COMPLEX
	TOTAL	92,637 SF	



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ARCHITECT / CONSULTANT



AUTHORITY HAVING JURISDICTION

PROJECT DESCRIPTION

RAMADA INN CONVERSION

25 HOTEL CIRCLE NE ALBUQUERQUE, NM 87123

Sheet NAME:

FIRE HYDRANT LOCATION AND ACCESS PLAN

revisions MARK DATE DESCRIPTION

ISSUE DATE: ISSUE TYPE: DRAWN BY: CHECKED BY: PROJECT#:

1/14/2021 DRB SUBMITTAL -2020-64

SHEET NUMBER:

FIRE1

Current DRC

Project Number:

FIGURE 12

Date Submitted: 5-Mar-21

Date Site Plan Approved: _____ Date Preliminary Plat Approved:

Date Preliminary Plat Expires:

INFRASTRUCTURE LIST

(Rev. 2-16-18)

EXHIBIT "A"

DRB Project No.: SI-2020-001468

DRB Application No.: PR-2020-004820

TO SUBDIVISION IMPROVEMENTS AGREEMENT DEVELOPMENT REVIEW BOARD (D.R.B.) REQUIRED INFRASTRUCTURE LIST

MCRE Multi-family Conversion

PROPOSED NAME OF PLAT AND/OR SITE DEVELOPMENT PLAN

Tract 4-B-1, Horne Development Addition

EXISTING LEGAL DESCRIPTION PRIOR TO PLATTING ACTION

Following is a summary of PUBLIC/PRIVATE Infrastructure required to be constructed or financially guaranteed for the above development. This Listing is not necessarily a complete listing. During the SIA process and/or in the review of the construction drawings, if the DRC Chair determines that appurtenant items and/or unforeseen items have not been included in the infrastructure listing, the DRC Chair may include those items in the listing and related financial guarantee. Likewise, if the DRC Chair determines that appurtenant or non-essential items can be deleted from the listing, those items may be deleted as well as the related portions of the financial guarantees. All such revisions require approval by the DRC Chair, the User Department and agent/owner. If such approvals are obtained, these revisions to the listing will be incorporated administratively. In addition, any unforeseen items which arise during construction which are necessary to complete the project and which normally are the Subdivider's responsibility will be required as a condition of project acceptance and close out by the City.

								ruction Cer	
Financially	Constructed	Size	Type of Improvement	Location	From	То	Priv		City Cnst
Guaranteed	Under						Inspector	P.E.	Engineer
DRC #	DRC #								
		4'	ADA Accessible Way	Hotel Circle	SE Entrance		/	/	/
		· · · ·	norrieococibie may			·	,	,	
		24'	PCC Drivepad Modifiations	Hotel Circle	NW Entrance		/	/	/
			(reduction from 39' wide drvpd.)						
		6"	Public FH to Prv't Fire Line	Interior Site - 6" WL leg	Exist FH Location		/	/	/
				off of 36" WL					
		6"	Add Public Valve to Exist 6" Stub	Interior Site - 6" WL stub	Exist. 6" stub - NE		/	1	/
				off of 36" WL		·		/	
				Off OF 36 WL					
		4"	Re-striping for a 150 feet storage length	Hotel Circle/Morris	Lomas Stop Bar	200'± South	/	/	/
			plus transition length						
							/	/	/
							/	/	/
						- <u> </u>	,		
						·	/	/	/
	· · · · · · · · · · · · · · · · · · ·								
							/	/	/

The items listed The Items listed	below are on the CC below are subject to	IP and approve the standard S	d for Impact Fee credits. Signatures fron IA requirements.	n the Impact Fee Adminis	trator and the City User Depa	rtment is required p	prior to DRB approval of t	his listing.
Financially	Constructed						Construction Cer	tification
Guaranteed	Under	Size	Type of Improvement	Location	From	То	Private	City Cnst
DRC #	DRC #						Inspector P.E.	Engineer
r	,							
							/ /	/
							/ /	/
					Approval of Creditable It	ems:	Approval of Creditable I	tems:
					Impact Fee Admistrator	Signature Date	City User Dept. Signat	ure Date
				NOTES	•	-		
		If the site is	s located in a floodplain, then the financi	al guarantee will not be r	eleased until the LOMR is app	proved by FEMA.		
			Street lig	ghts per City rquirements				
1								
2								
	AGENT / OWNER			DEVELOPMENT R	EVIEW BOARD MEMBER API	PROVALS		
Encl O Artes	DE							
Fred C. Arfm								
	NAME (print)		DRB CH	AIR - date	PARKS	& RECREATION - o	late	
ISAAC	SON & ARFMA	N. INC.						
	FIRM		TRANSPORTATION	DEVELOPMENT - date		AMAFCA - date		
Findle	6	3/5/2021						
Ind 6			<u> </u>					
	SIGNATURE - date	!	UTILITY DEVEL	LOPMENT - date	CODE	ENFORCEMENT - d	late	
			CITY ENGI	NEER - date		date		
			DESIGN REV	VIEW COMMITTEE REVIS	IONS			

REVISION	DATE	DRC CHAIR	USER DEPARTMENT	AGENT /OWNER

PAGE _____ OF _____ (Rev. 2-16-18)