

DEVELOPMENT REVIEW BOARD SUPPLEMENTAL SUBMITTAL

(Deadline is Friday at noon unless noted on DRB calendar – late submittals will not be accepted unless approved by the DRB)

PROJECT NO. PR-2020-004820
Application No. SI-2020-001468
TO: X Planning Department/Chair X Hydrology X Transportation Development X ABCWUA X Code Enforcement X Parks & Rec *(Please attach this sheet with each collated set for each board member)
NOTE: ELECTRONIC VERSION (ie disk, thumbdrive) is Required. Submittal will not be accepted without.
DRB SCHEDULED HEARING DATE: 1/13/21 and 2/3/21 HEARING DATE OF DEFERRAL: 2/24/21
SUBMITTAL DESCRIPTION: Updated plan set and comment response memo.
CONTACT NAME: Michael Vos, AICP or Jim Strozier, FAICP
TELEPHONE: (505) 764-9801 EMAIL: vos@consensusplanning.com or cp@consensusplanning.com



Memorandum

To: Jolene Wolfley and DRB Members, City of Albuquerque

From: Michael Vos, AICP, Consensus Planning, Inc.

Date: February 19, 2021

Re: Hotel Circle Ramada Apartment Conversion DRB Comment Responses (PR-2020-004820)

This memo outlines the responses and changes made to the site plan for the proposed apartment conversion based on the comments received and reviewed at the January 13, 2021 DRB meeting. The comments are numbered and followed by the response in bold italics.

Code Enforcement

- 1. Width of new sidewalks #5
 - a. The widths of existing and proposed sidewalks throughout the site have been dimensioned.
- 2. Please demonstrate that 4 ft clear pathway is met on all sidewalks.
 - a. Where existing walkways were narrower an extension will be added (see Keynote #40).

Hydrology

- 1. An approved Grading and Drainage Plan is required before Hydrology can sign.
 - a. Hydrology verbally clarified this comment at the DRB hearing that a G&D was only required if the project met their thresholds due to the existing site conditions. The proposed conversion does not currently meet any of the thresholds, so a G&D is not required at this time.

<u>Transportation Development</u>

- 1. The Traffic Study needs to be approved prior to site plan approval. Any infrastructure recommendations from the approved study shall be incorporated onto an infrastructure list.
 - a. Lee Engineering is completing the Traffic Study and it is our understanding it will be submitted for staff review this week. No infrastructure recommendations are anticipated from this study due to the existing roadway capacity surrounding this development.
- 2. Define what will be done with the existing gate at the southern entrance. Sufficient emergency access shall be provided; receive Fire Marshall approval.
 - a. The existing gate located at the back of sidewalk will be removed (Keynote #35). A Fire 1 plan is under review by the Fire Marshal.
- 3. Make a distinction between new and existing parking lot infrastructure by use of a separate legend for new versus existing.
 - a. Most parking lot infrastructure is existing. New striping along the northern boundary

has been identified separately in the legend along with new concrete work. See Keynote #4 for the addition of new landscape islands.

- 4. The minimum aisle width is 22 feet for an aisle that is not a main driving aisle. Label all driving aisle widths and show parking space dimensions. Call out curb and curb radii.
 - a. Aisle widths and radii have been dimensioned on the updated site plan.
- 5. Label clear sight triangles on the site plan. Provide standard note that defines limits of landscaping height on both the site plan and landscaping plan.
 - a. Clear sight triangles have been identified with the required note added (Keynote #36)
- 6. Show existing sidewalk width on Hotel Circle. The minimum sidewalk width required is 5 feet. Revise drive entrances to be ADA-compliant.
 - a. Drive entrances and sidewalk have been updated to be ADA-compliant and add width to meet the 5-foot requirement (see Keynotes #13 and #26).
- 7. Provide sidewalk widths between buildings, even if these are existing.
 - a. Widths of walkways throughout the site have been dimensioned.
- 8. Provide handicapped parking space calculations.
 - a. Accessible parking space calculations have been added.
- 9. Label any electrical charging stations on the plan.
 - a. No EV charging stations are required or provided.
- 10. Provide details for the new curb, curb ramp, and sidewalk, and indicate a maximum 2% slope on the sidewalk. Curb should separate parking from sidewalks and landscape islands. Also show doorways to establish adequacy of pedestrian paths and ADA access. With notes, verify that any existing walkways establish a 6-foot ADA pathway to building and to right-of-way.
 - a. See updated details on sheets AS102 and AS103, including sidewalk, curbs & gutter, and ramps. A 6-foot ADA pathway connecting the building to the public way is being created by this plan (see Keynote #30).
- 11. Provide the latest language for the handicapped sign and provide separate "Motorcycle Parking Only" sign detail.
 - a. Updated and new sign details have been added to Sheet AS102.
- 12. The van accessible aisle shall show "No Parking" at the back of the aisle.
 - a. Van accessible striping details, including the required "No Parking" text is shown on Sheet AS102.
- 13. Bike rack shall follow dimensioning specified in the IDO.
 - a. Bike racks throughout the site have been spaced according to the IDO and DPM and detailed on sheet AS102.

ABCWUA

- Request an availability/serviceability statement online at the following link: http://www.abcwua.org/Availability_Statements.aspx. Requests shall include fire marshal requirements. An executed statement must be obtained prior to approval.
 - a. An availability request was made with this application but is on hold pending the approved Fire 1 plan.
- 2. Currently the single account for the property is for commercial. Given that the use is changing from hotel to multi-family residential, the account shall be adjusted to reflect multi-family customer class. Additionally, a separate account (commercial class) will be required for the restaurant as each customer class needs its own account and water meter.


A new water and sanitary sewer service shall be installed for the restaurant. These can be accomplished by tapping permits.

The new service connections as well as establishment of new accounts is required prior to approval.

- Is the intent to use the existing 3" water meter for the proposed multi-family development?
- a. For various reasons, the restaurant use has been removed from the proposed site plan at this time, so additional services should not be necessary. The intent is for the multi-family development to utilize the existing 3" water meter and the customer class will be adjusted accordingly.
- 3. Please provide a utility plan.
 - Please show existing onsite public waterline and sanitary sewer.
 - a. Existing utility lines and easements are shown on the site plan. A separate utility plan is also included with the rest of the plan set.

Planning

- 1. Please verify existing tree sizes for tree credit.
 - a. We have created an exhibit that shows the measured caliper of each existing tree and translates that measurement to IDO Table 5-6-2 and the calculations shown on the landscape plan.
- 2. Confirm that all units are one bedroom, this what the open space calculations show.
 - a. All units are one bedroom/studio, and this has been clarified on the site plan where the unit counts are shown related to land use, usable open space, and parking calculations.
- 3. Provide dimensions for the pedestrian walkways.
 - Dimensions have been added to the pedestrian walkways throughout the site.
- 4. Walkways must meet the requirements of 5-3 (D)(3)(b) see table 5-3-1 for widths or a waiver DRB can be requested.
 - a. The proposed restaurant has been removed from the project for several reasons. Without the restaurant, the proposed project is considered a multi-family residential development. As such, the referenced IDO section no longer applies as it is for mixed-use and non-residential development only. However, where there is a walkway located along the street-facing façade it is at least 8 feet wide.
- 5. See section 5-6(B) for landscape applicability. if the site meets those criteria then additional landscaping in the form of ground level plants will be required- see 5-6(C)(2)(c).
 - a. The proposed landscape plan meets the required percentage of ground level plants through a combination of the existing grass turf areas and shrubs.
- 6. The applicant is not adding any square footage to the building therefore the provisions of 5-11 are not applicable.
 - a. Agreed.
- 7. Staff reviewed the parking reductions and agrees with the calculations.
 - a. The parking calculation has been updated based on the removal of the restaurant (and related shared parking reduction) while continuing to utilize the on-street and carpool credits
- 8. Staff may have additional comments based on any resubmittals.
 - a. Understood.

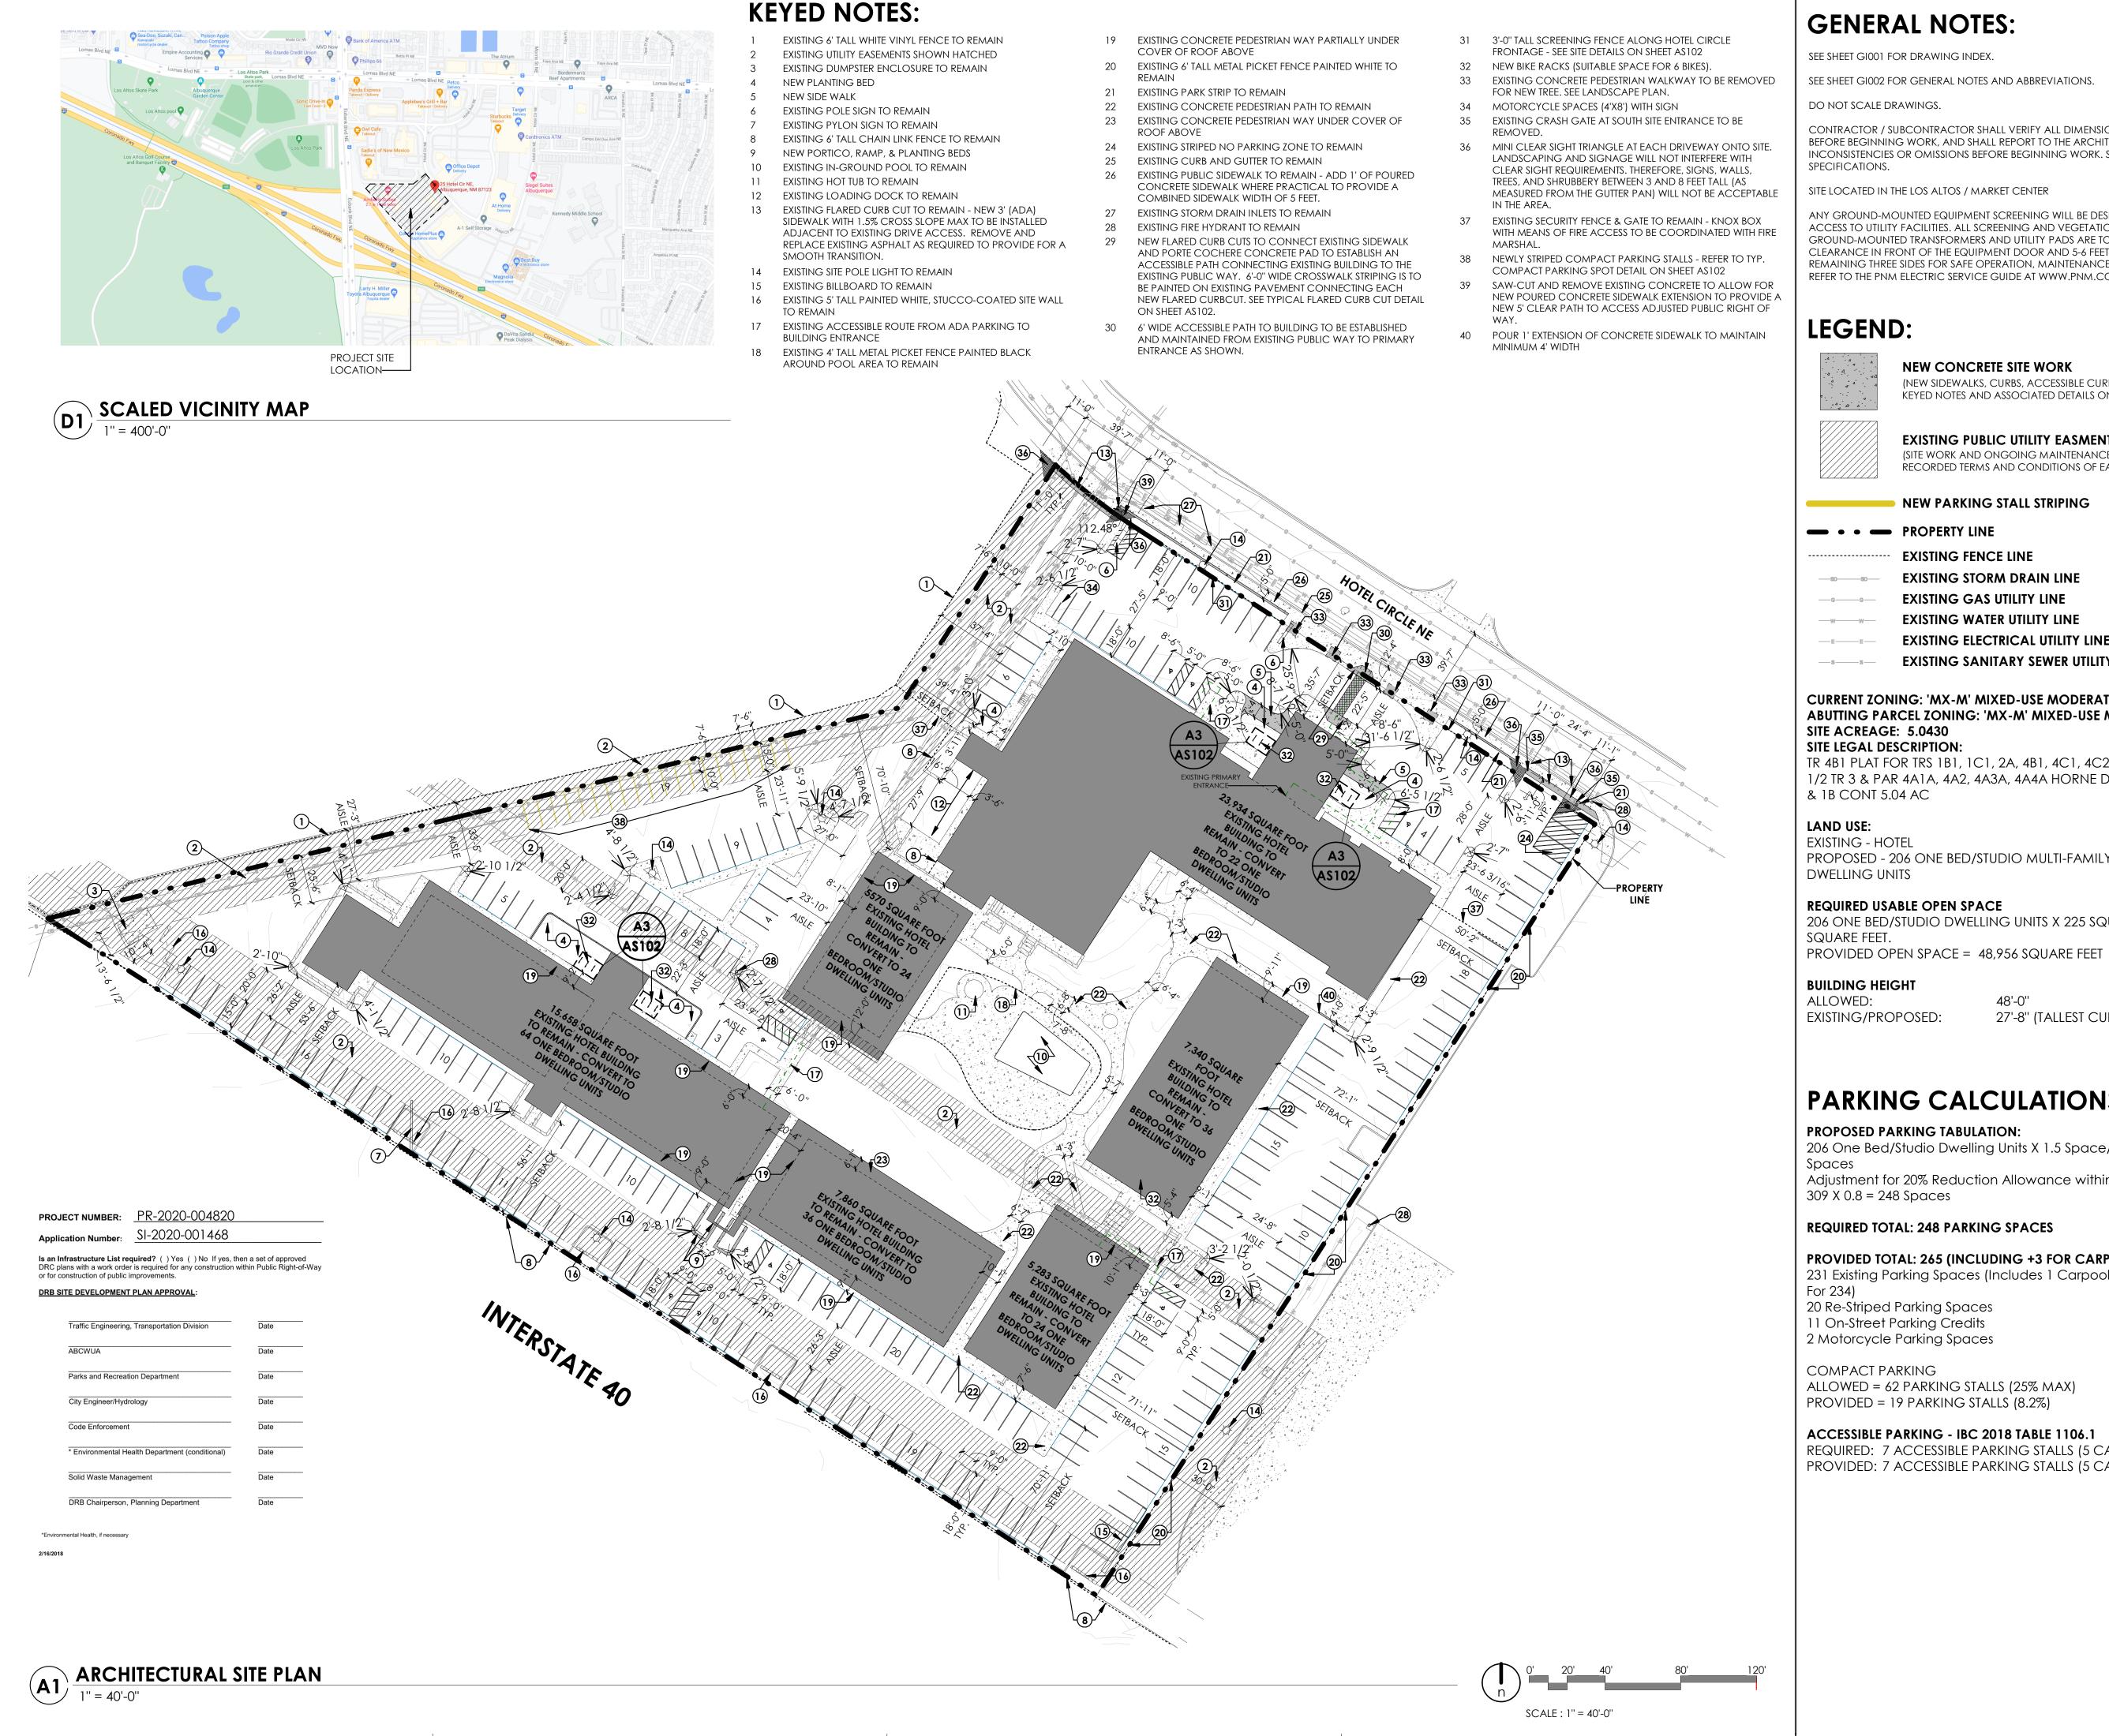

GENERAL NOTES:

SEE SHEET GI001 FOR DRAWING INDEX.

SEE SHEET GI002 FOR GENERAL NOTES AND ABBREVIATIONS.

CONTRACTOR / SUBCONTRACTOR SHALL VERIFY ALL DIMENSIONS AND CONDITIONS BEFORE BEGINNING WORK, AND SHALL REPORT TO THE ARCHITECT ANY ERRORS, INCONSISTENCIES OR OMISSIONS BEFORE BEGINNING WORK. SEE GENERAL NOTES AND

SITE LOCATED IN THE LOS ALTOS / MARKET CENTER

ANY GROUND-MOUNTED EQUIPMENT SCREENING WILL BE DESIGNED TO ALLOW FOR ACCESS TO UTILITY FACILITIES. ALL SCREENING AND VEGETATION SURROUNDING GROUND-MOUNTED TRANSFORMERS AND UTILITY PADS ARE TO ALLOW 10 FEET OF CLEARANCE IN FRONT OF THE EQUIPMENT DOOR AND 5-6 FEET OF CLEARANCE ON THE REMAINING THREE SIDES FOR SAFE OPERATION, MAINTENANCE AND REPAIR PURPOSES. REFER TO THE PNM ELECTRIC SERVICE GUIDE AT WWW.PNM.COM FOR SPECIFICATIONS.

KEYED NOTES AND ASSOCIATED DETAILS ON SHEET AS 102)

NEW CONCRETE SITE WORK (NEW SIDEWALKS, CURBS, ACCESSIBLE CURB CUTS, ETC. SEE

EXISTING PUBLIC UTILITY EASMENT TO REMAIN (SITE WORK AND ONGOING MAINTENANCE TO ABIDE BY

RECORDED TERMS AND CONDITIONS OF EASEMENT)

NEW PARKING STALL STRIPING ■ • • ■ PROPERTY LINE

EXISTING FENCE LINE EXISTING STORM DRAIN LINE EXISTING GAS UTILITY LINE EXISTING WATER UTILITY LINE

EXISTING SANITARY SEWER UTILITY LINE

CURRENT ZONING: 'MX-M' MIXED-USE MODERATE INTENSITY ABUTTING PARCEL ZONING: 'MX-M' MIXED-USE MODERATE INTENSITY SITE ACREAGE: 5.0430 SITE LEGAL DESCRIPTION:

EXISTING ELECTRICAL UTILITY LINE

TR 4B1 PLAT FOR TRS 1B1, 1C1, 2A, 4B1, 4C1, 4C2 STA STE NO 3A SO 1/2 TR 3 & PAR 4A1A, 4A2, 4A3A, 4A4A HORNE DEV ADD W/ TRS 1A1

EXISTING - HOTEL

PROPOSED - 206 ONE BED/STUDIO MULTI-FAMILY RESIDENTIAL

REQUIRED USABLE OPEN SPACE

206 ONE BED/STUDIO DWELLING UNITS X 225 SQUARE FEET = 46,350 SQUARE FEET.

BUILDING HEIGHT

27'-8" (TALLEST CURRENT)

PARKING CALCULATIONS:

PROPOSED PARKING TABULATION:

206 One Bed/Studio Dwelling Units X 1.5 Space/Dwelling Unit = 309

Adjustment for 20% Reduction Allowance within an Activity Center 309 X 0.8 = 248 Spaces

REQUIRED TOTAL: 248 PARKING SPACES

PROVIDED TOTAL: 265 (INCLUDING +3 FOR CARPOOL CREDIT)

231 Existing Parking Spaces (Includes 1 Carpool Space, Total Credit

20 Re-Striped Parking Spaces

2 Motorcycle Parking Spaces

ALLOWED = 62 PARKING STALLS (25% MAX)

PROVIDED = 19 PARKING STALLS (8.2%)

ACCESSIBLE PARKING - IBC 2018 TABLE 1106.1

REQUIRED: 7 ACCESSIBLE PARKING STALLS (5 CAR + 2 VAN) PROVIDED: 7 ACCESSIBLE PARKING STALLS (5 CAR + 2 VAN)

NOT FOR CONSTRUCTION

ajc architects

703 east 1700 south

ajcarchitects.com

salt lake city, ut 84105

ARCHITECT / CONSULTANT

AUTHORITY HAVING JURISDICTION

PROJECT DESCRIPTION

RAMADA INN CONVERSION

25 HOTEL CIRCLE NE ALBUQUERQUE, NM 87123

SHEET NAME:

ARCHITECTURAL SITE PLAN

REVISIONS

Mark date DESCRIPTION


ISSUE DATE: 12/18/2020 ISSUE TYPE: **DRB SUBMITTAL** DRAWN BY: MS/ZS/LT CHECKED BY: K. RIGBY


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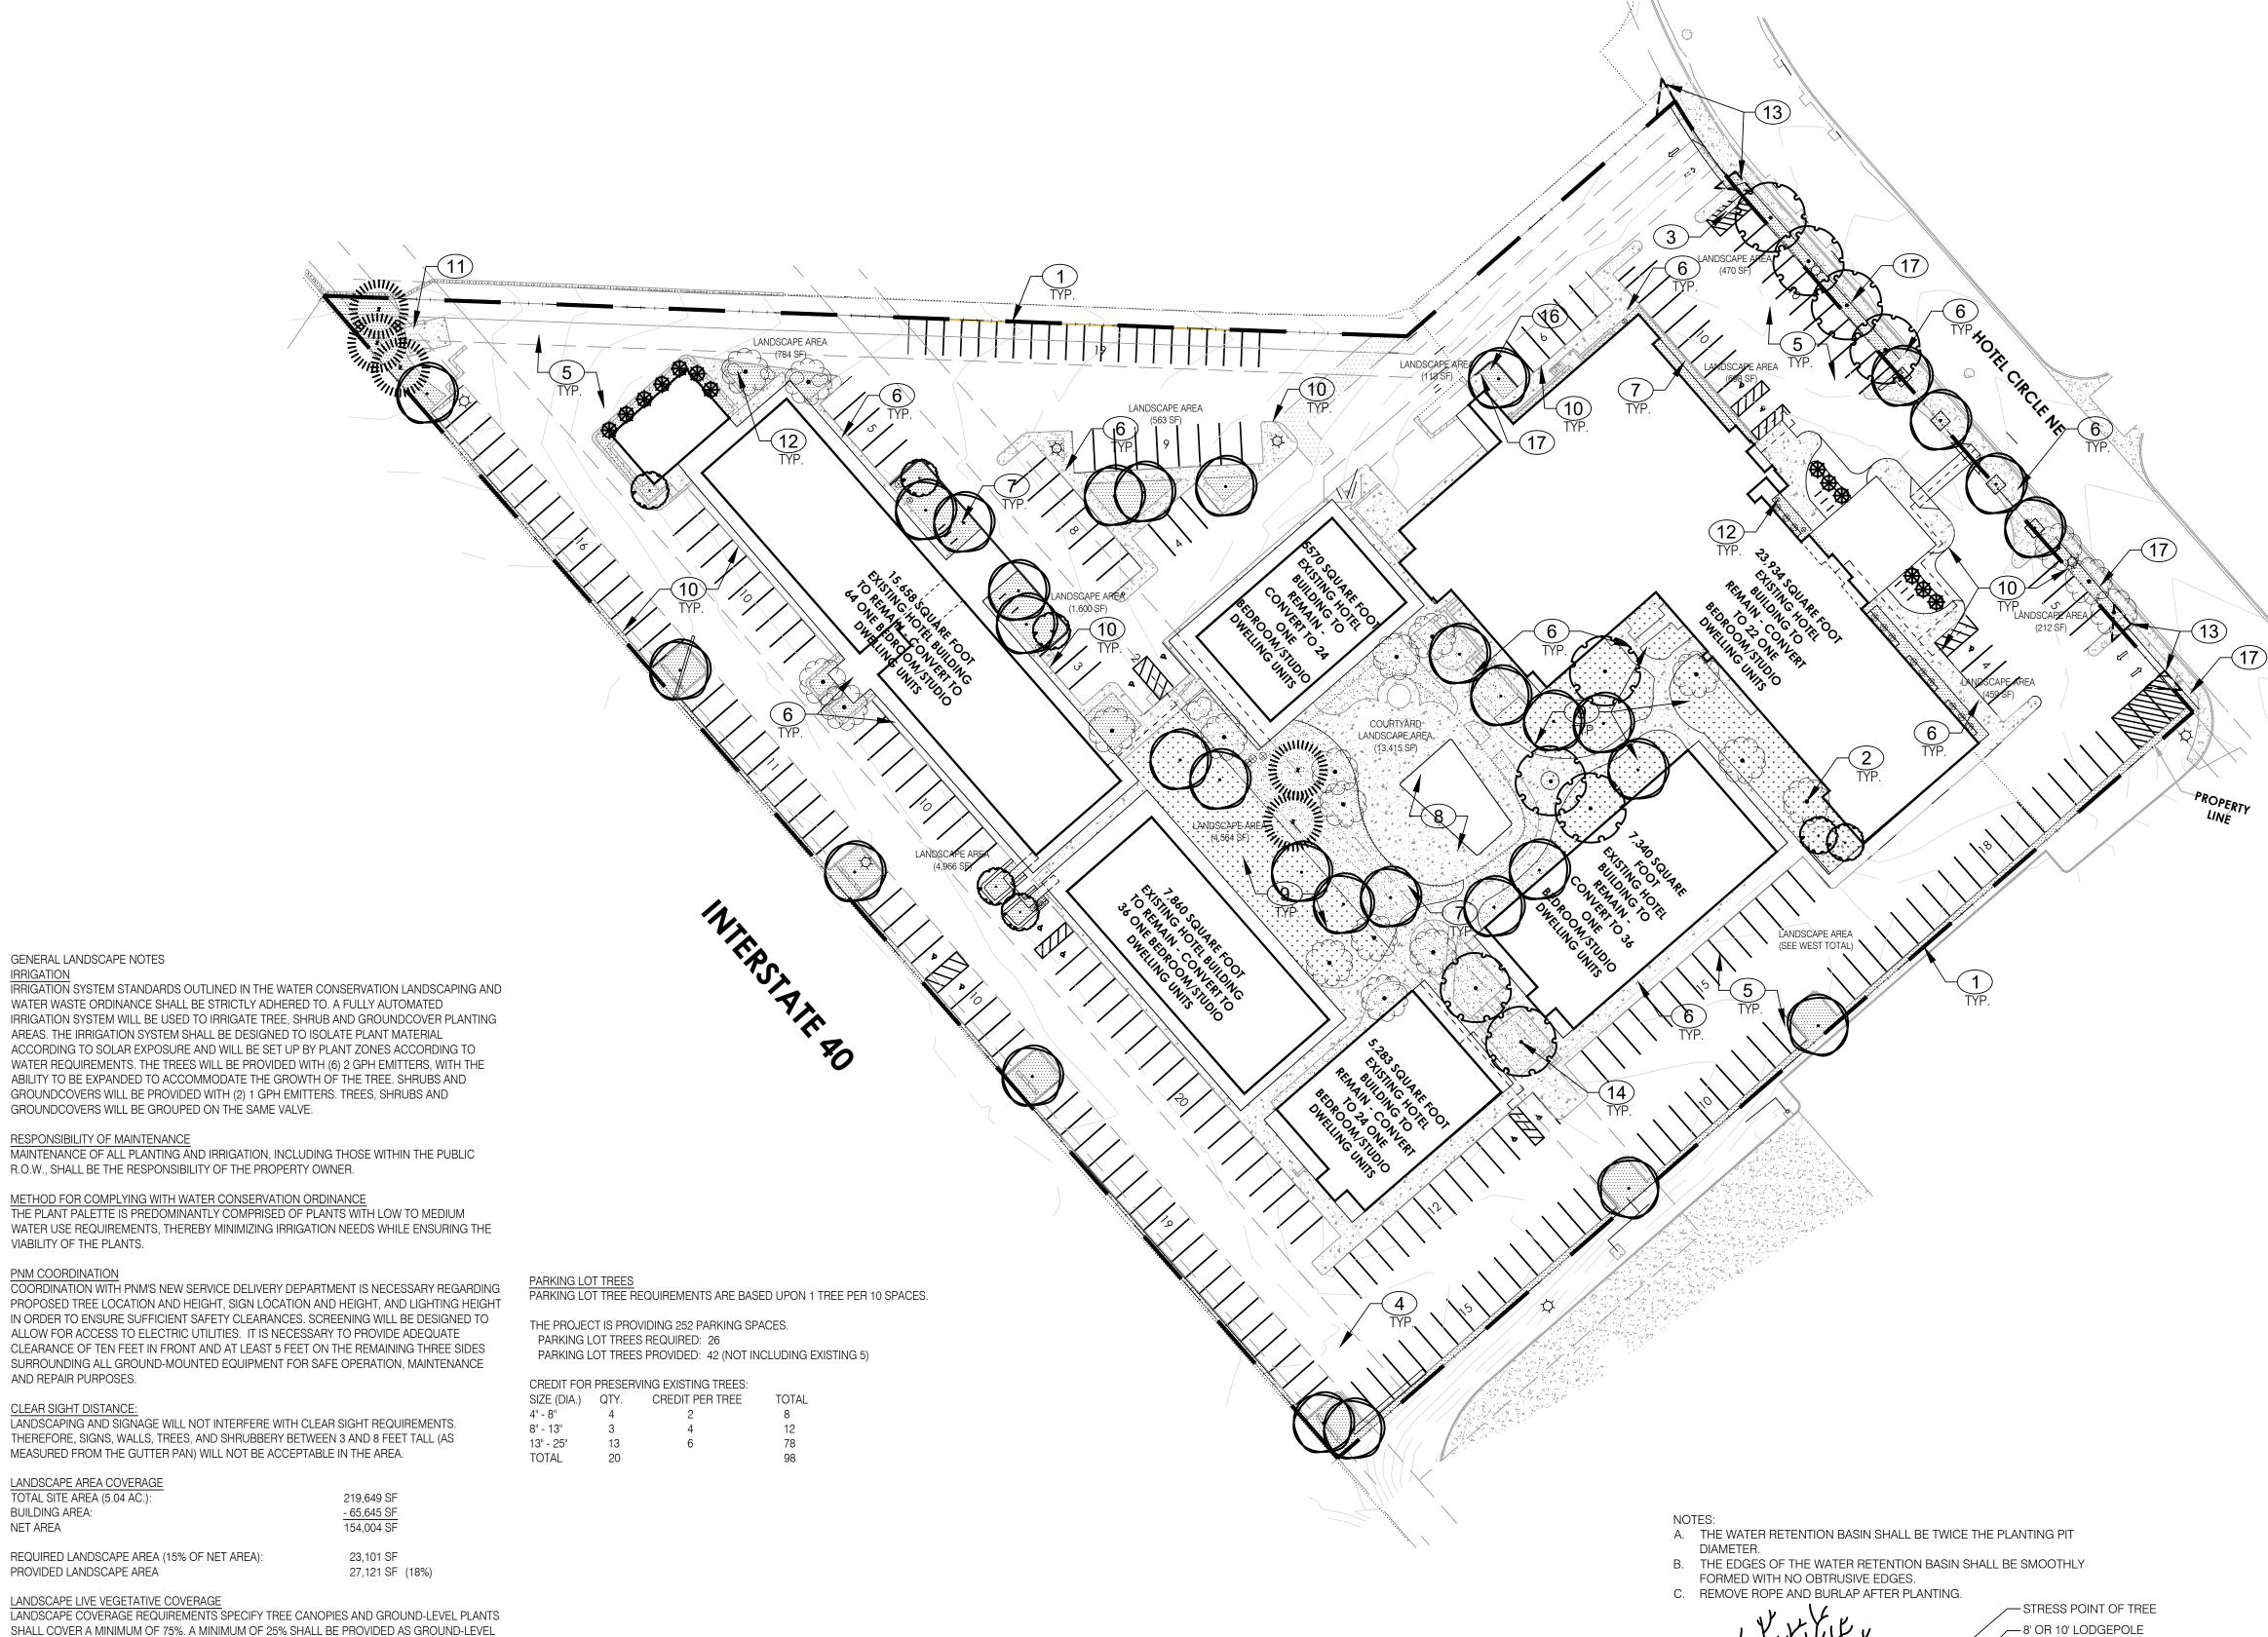
SHEET NUMBER:

PROJECT#:

AS101



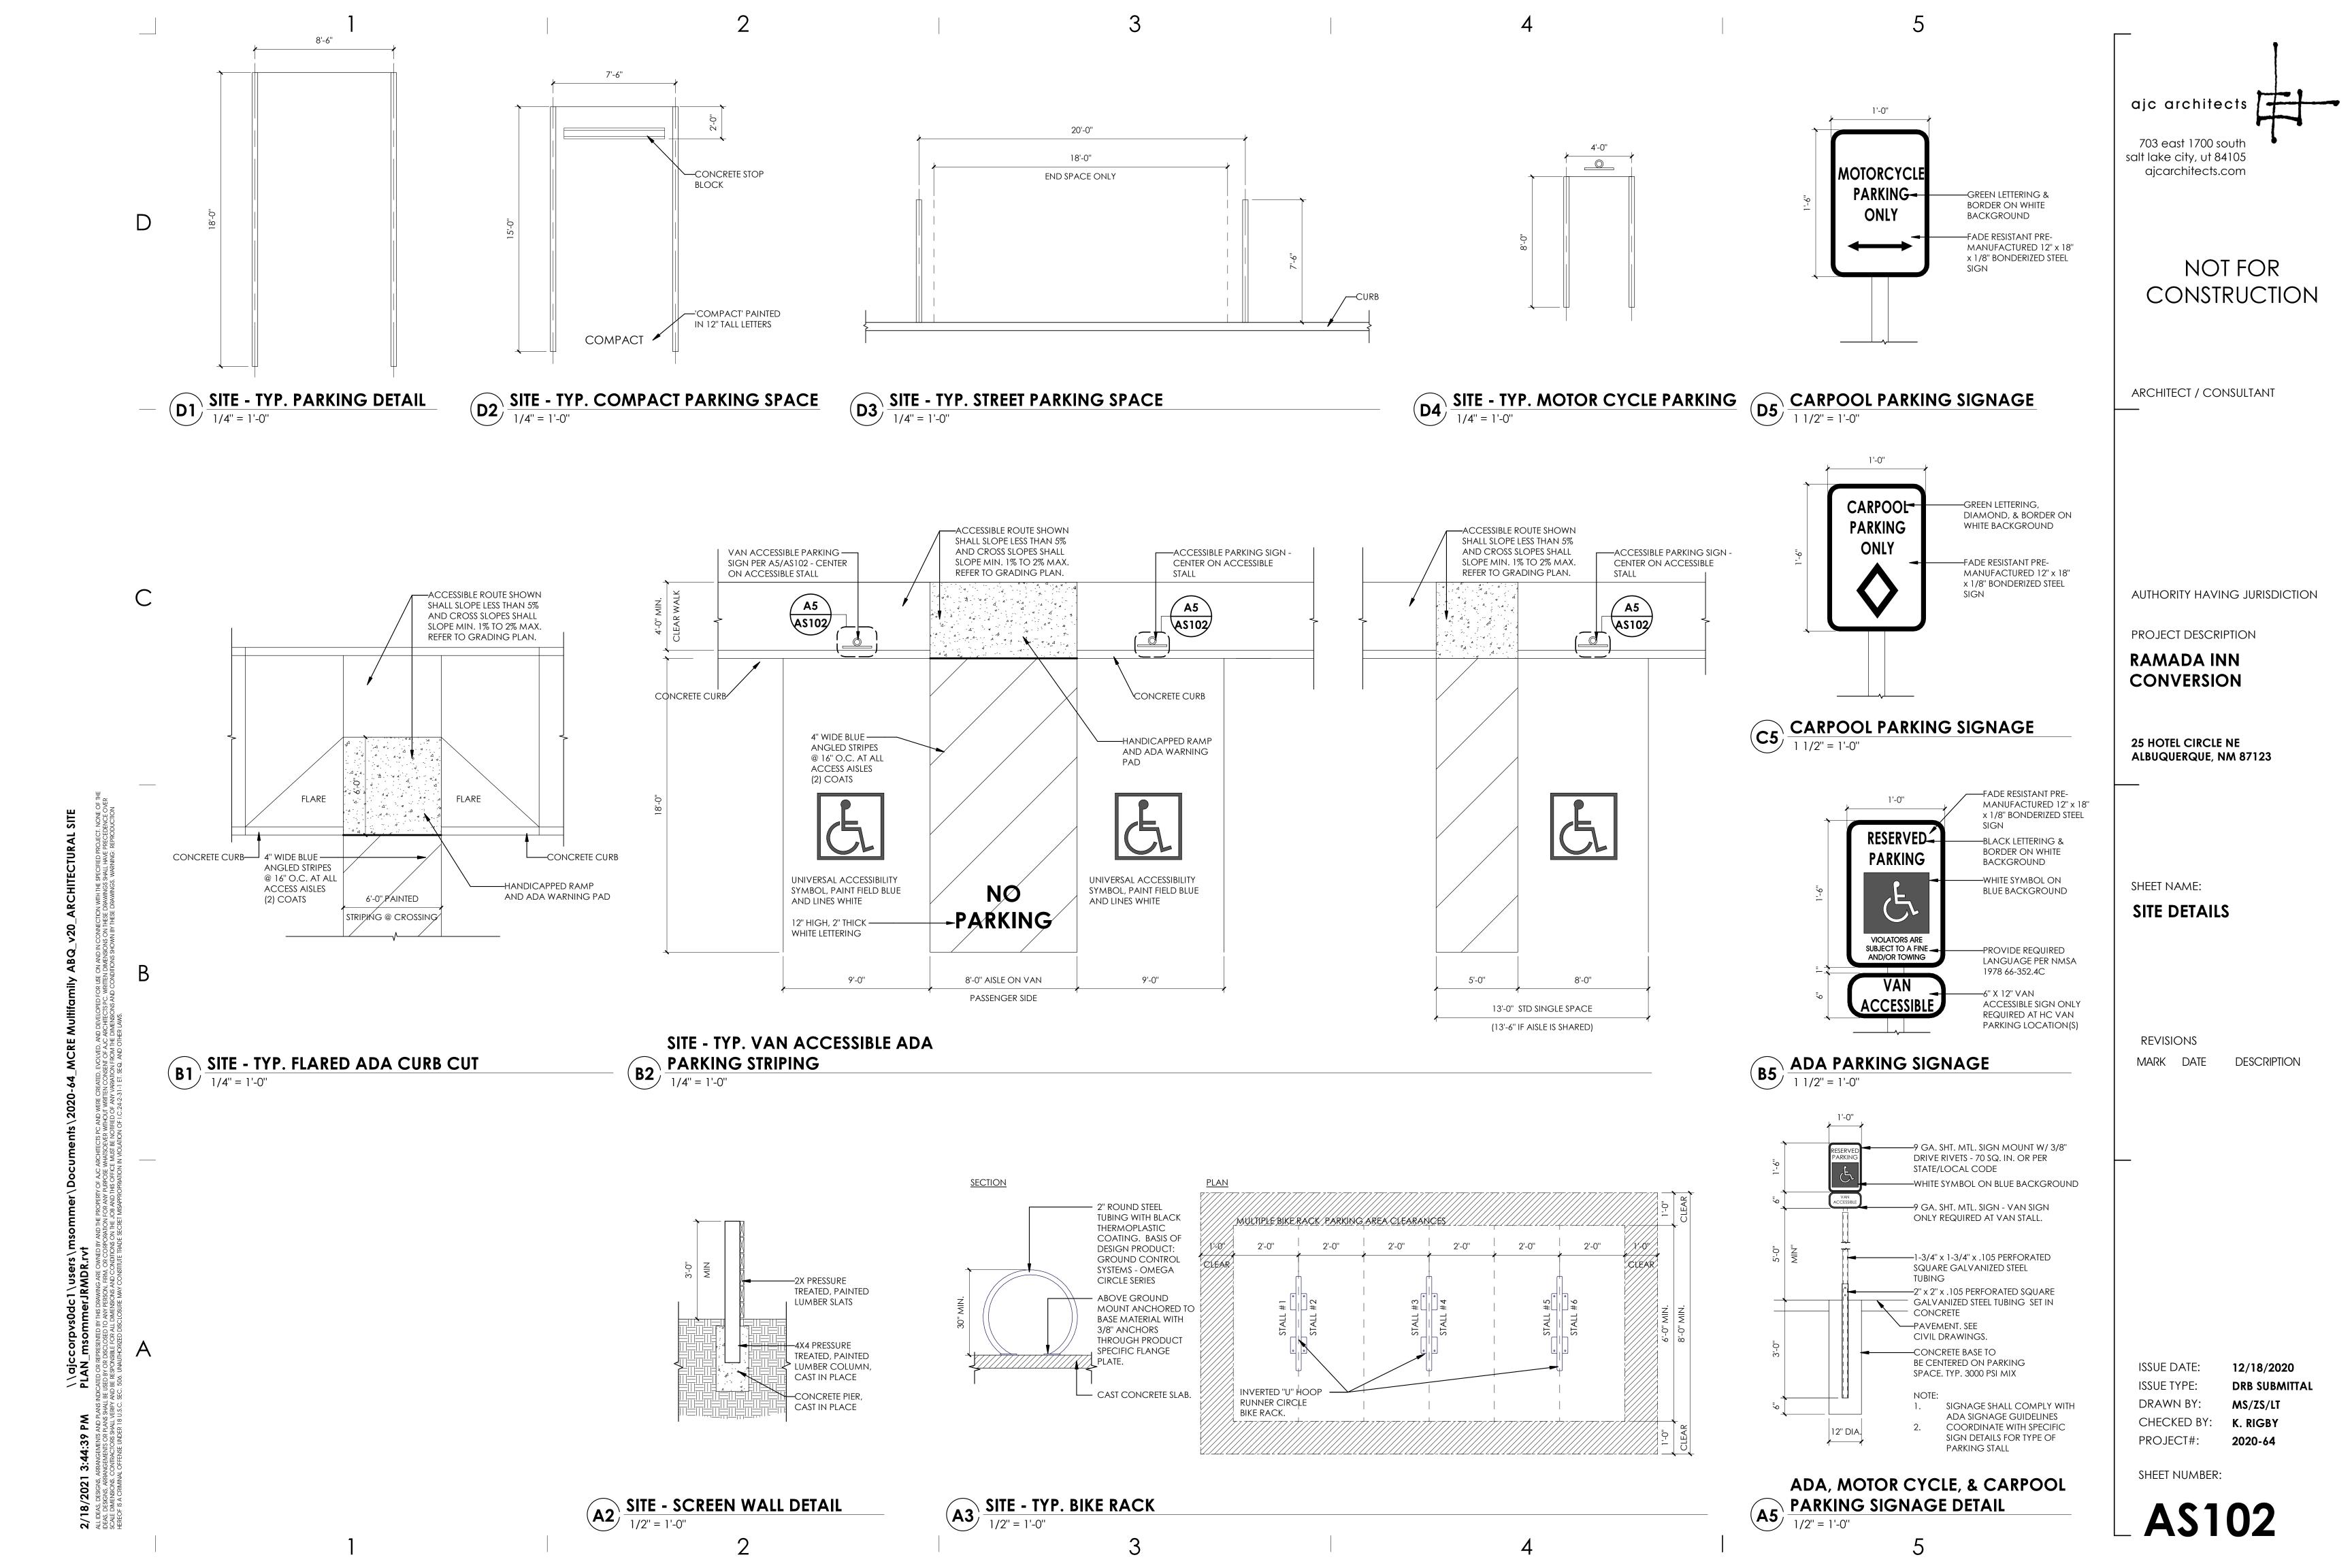

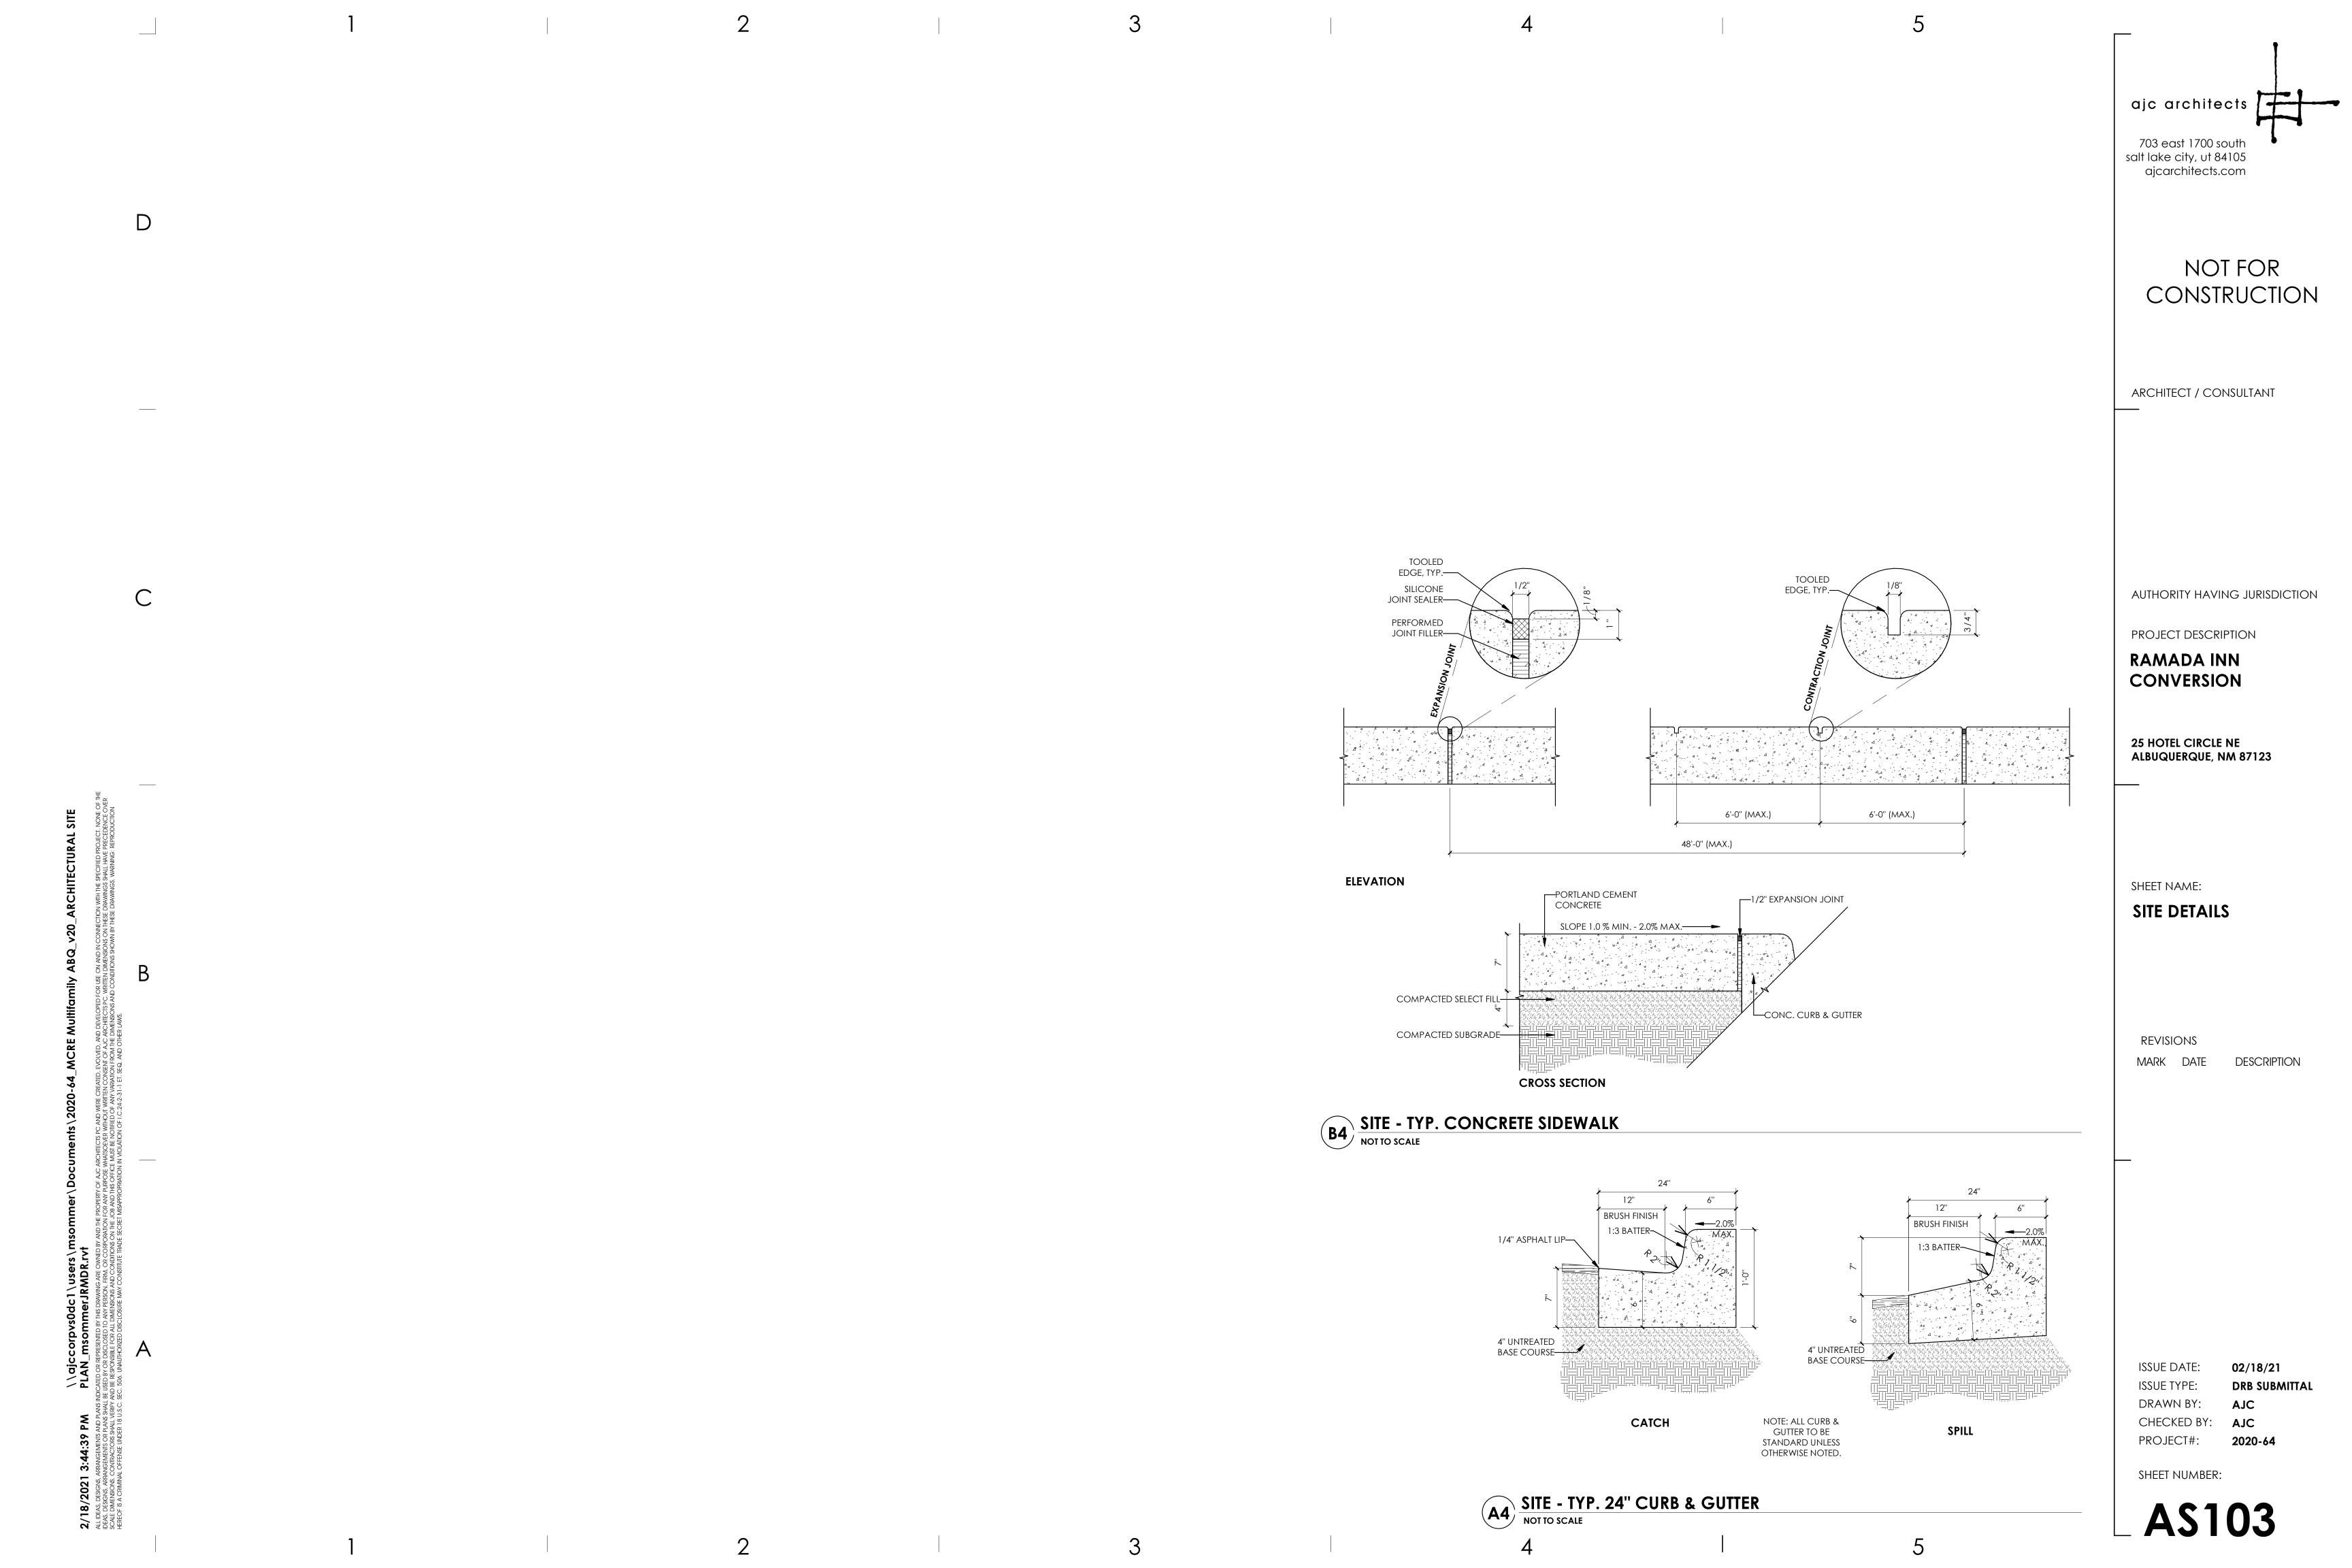

NOTES:

A. THE WATER RETENTION

THE PLANTING PIT

WATER RETENTION

BASIN SHALL BE

SMOOTHLY FORME

WITH NO OBTRUSIV

→ 2 X CONTAINER DIA. —

SHRUB PLANTING DETAIL

DIAMETER.

EDGES.

B. THE EDGES OF THE

BASIN SHALL BE TWICE

-PLANT TREE ROOT COLLAR

1"-2" ABOVE FINISH GRADE

- WATER RETENTION BASIN -

3" LAYER OF SHREDDED

- SPECIFIED PLANTING MIX

- WATER AND TAMP TO

— 3" LAYER OF ROCK MULCH

REMOVE AIR POCKETS

- SEE PLANTING PLAN

BARK MULCH

GENERAL LANDSCAPE NOTES

RESPONSIBILITY OF MAINTENANCE

VIABILITY OF THE PLANTS.

PNM COORDINATION

AND REPAIR PURPOSES.

CLEAR SIGHT DISTANCE:

LANDSCAPE AREA COVERAGE TOTAL SITE AREA (5.04 AC.):

PROVIDED LANDSCAPE AREA

ALLOWABLE TURF

TOTAL PARKING LOT AREA:

REQUIRED LANDSCAPE AREA:

PROVIDED LANDSCAPE AREA:

LANDSCAPED.

REQUIRED LANDSCAPE AREA (15% OF NET AREA):

REQUIRED LIVE VEGETATIVE MATERIAL COVERAGE

PROVIDED LIVE VEGETATIVE MATERIAL COVERAGE

EXISTING TURF (NON CONFORMING SITE FEATURE)

THE PROJECT IS PROVIDING 252 PARKING SPACES.

REQUIRED GROUND-LEVEL PLANT COVERAGE

PROVIDED GROUND-LEVEL PLANT COVERAGE

PLANTS (SHRUBS, GRASSES, ETC.) OF THE REQUIRED VEGETATIVE COVERAGE.

LANDSCAPE TURF
NO MORE THAN 10% OF REQUIRED LANDSCAPE AREAS SHALL BE TURF GRASS SPECIES

AT LEAST 10% OF THE PARKING LOT AREA OF LOTS CONTAINING 50 OR FEWER SPACES, AND AT

LEAST 15% OF THE PARKING LOT AREA OF LOTS CONTAINING 50 OR MORE SPACES, SHALL BE

REQUIRING IRRIGATION FOR SURVIVAL AFTER THE FIRST 2 GROWING SEASONS.

20,368 SF

5,092 SF

2,310 SF

107,385 SF

16,108 SF


9,103 SF (9%)

10,539 SF (46%)

44,859 SF (165%)

10,875 SF (114%)

BUILDING AREA: **NET AREA**

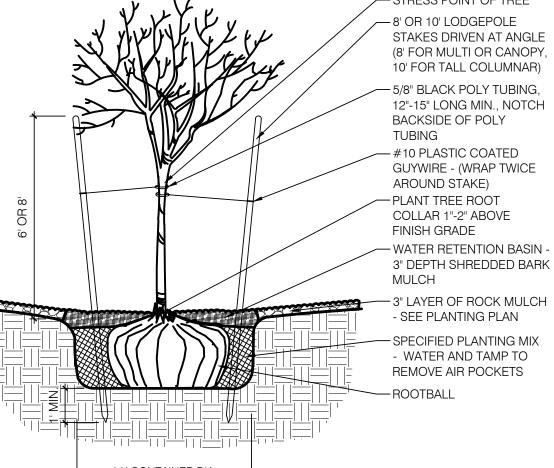

SCALE: N.T.S.

- WATER RETENTION BASIN -3" DEPTH SHREDDED BARK

TREE PLANTING DETAIL

MCRE MULTI-FAMILY CONVERSION

LANDSCAPE PLAN

Prepared for: Mountain Classic Real Estate. 461 East 200 South Suite 102, Salt Lake City, UT 84111-2138

PLANT LEGEND

COMMON NAME (WATER USE)

EXISTING TREES TO REMAIN

CERCIS RENIFORMIS 'OKLAHOMA' OKLAHOMA REDBUD (M)

SKYLINE HONEYLOCUST (M+)

AUSTRIAN PINE (M+)

MULCHES AND BOULDERS

10,539 SF [::::: EXISTING TURF TO REMAIN

8. EXISTING FENCED POOL AND PATIO AREA

15. CONNECTION TO PUBLIC SIDEWALK TBD.

17. NEW CONCRETE CURB AND WALK

14. SHADE TREES 25' O.C. ALONG WALKWAYS ON INTERIOR

KEY NOTES:

1. PROPERTY BOUNDARY 2. EXISTING TREE TO REMAIN 3. EXISTING MONUMENT SIGN 4. EXISTING UTILITY EASEMENT EXISTING ASPHALT PAVING 6. EXISTING CONCRETE WALK 7. EXISTING LANDSCAPE AREA

9. EXISTING TURF AREA

16. NEW TREE ISLAND

10. EXISTING CURB AND GUTTER 11. EXISTING DUMPSTER ENCLOSURE 12. EXISTING SHRUB TO REMAIN 13. CLEAR SITE TRIANGLES

17,485 SF 1" SANTA FE BROWN ROCK MULCH

GLEDITSIA TRIACANTHOS IMPERIAL

JUNIPERUS SCOPULORUM 'SKYROCKET' SKYROCKET JUNIPER (L+)

ULMUS PROPINQUA 'JFS-BIEBERICH' EMERALD SUNSHINE ELM (M)

(3" DEPTH OVER FILTER FABRIC, DEWITT PRO-5 WEED CONTROL, OR EQUAL)

INSTALLED SIZE

45' HT. X 35' SPR.

6' HT. X 2' SPR. 12' HT. X 5' SPR. 8' HT. X 4' SPR.


35' HT. X 25' SPR.


SIZE MATURE SIZE

2.5" B&B 8' HT. X 4' SPR. 15' HT. X 15' SPR.


2.5" B&B 8' HT. X 4' SPR.

2.5" B&B 8' HT. X 4' SPR. 35' HT. X 25' SPR.

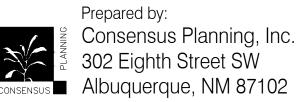

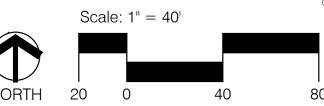

February 19, 2021

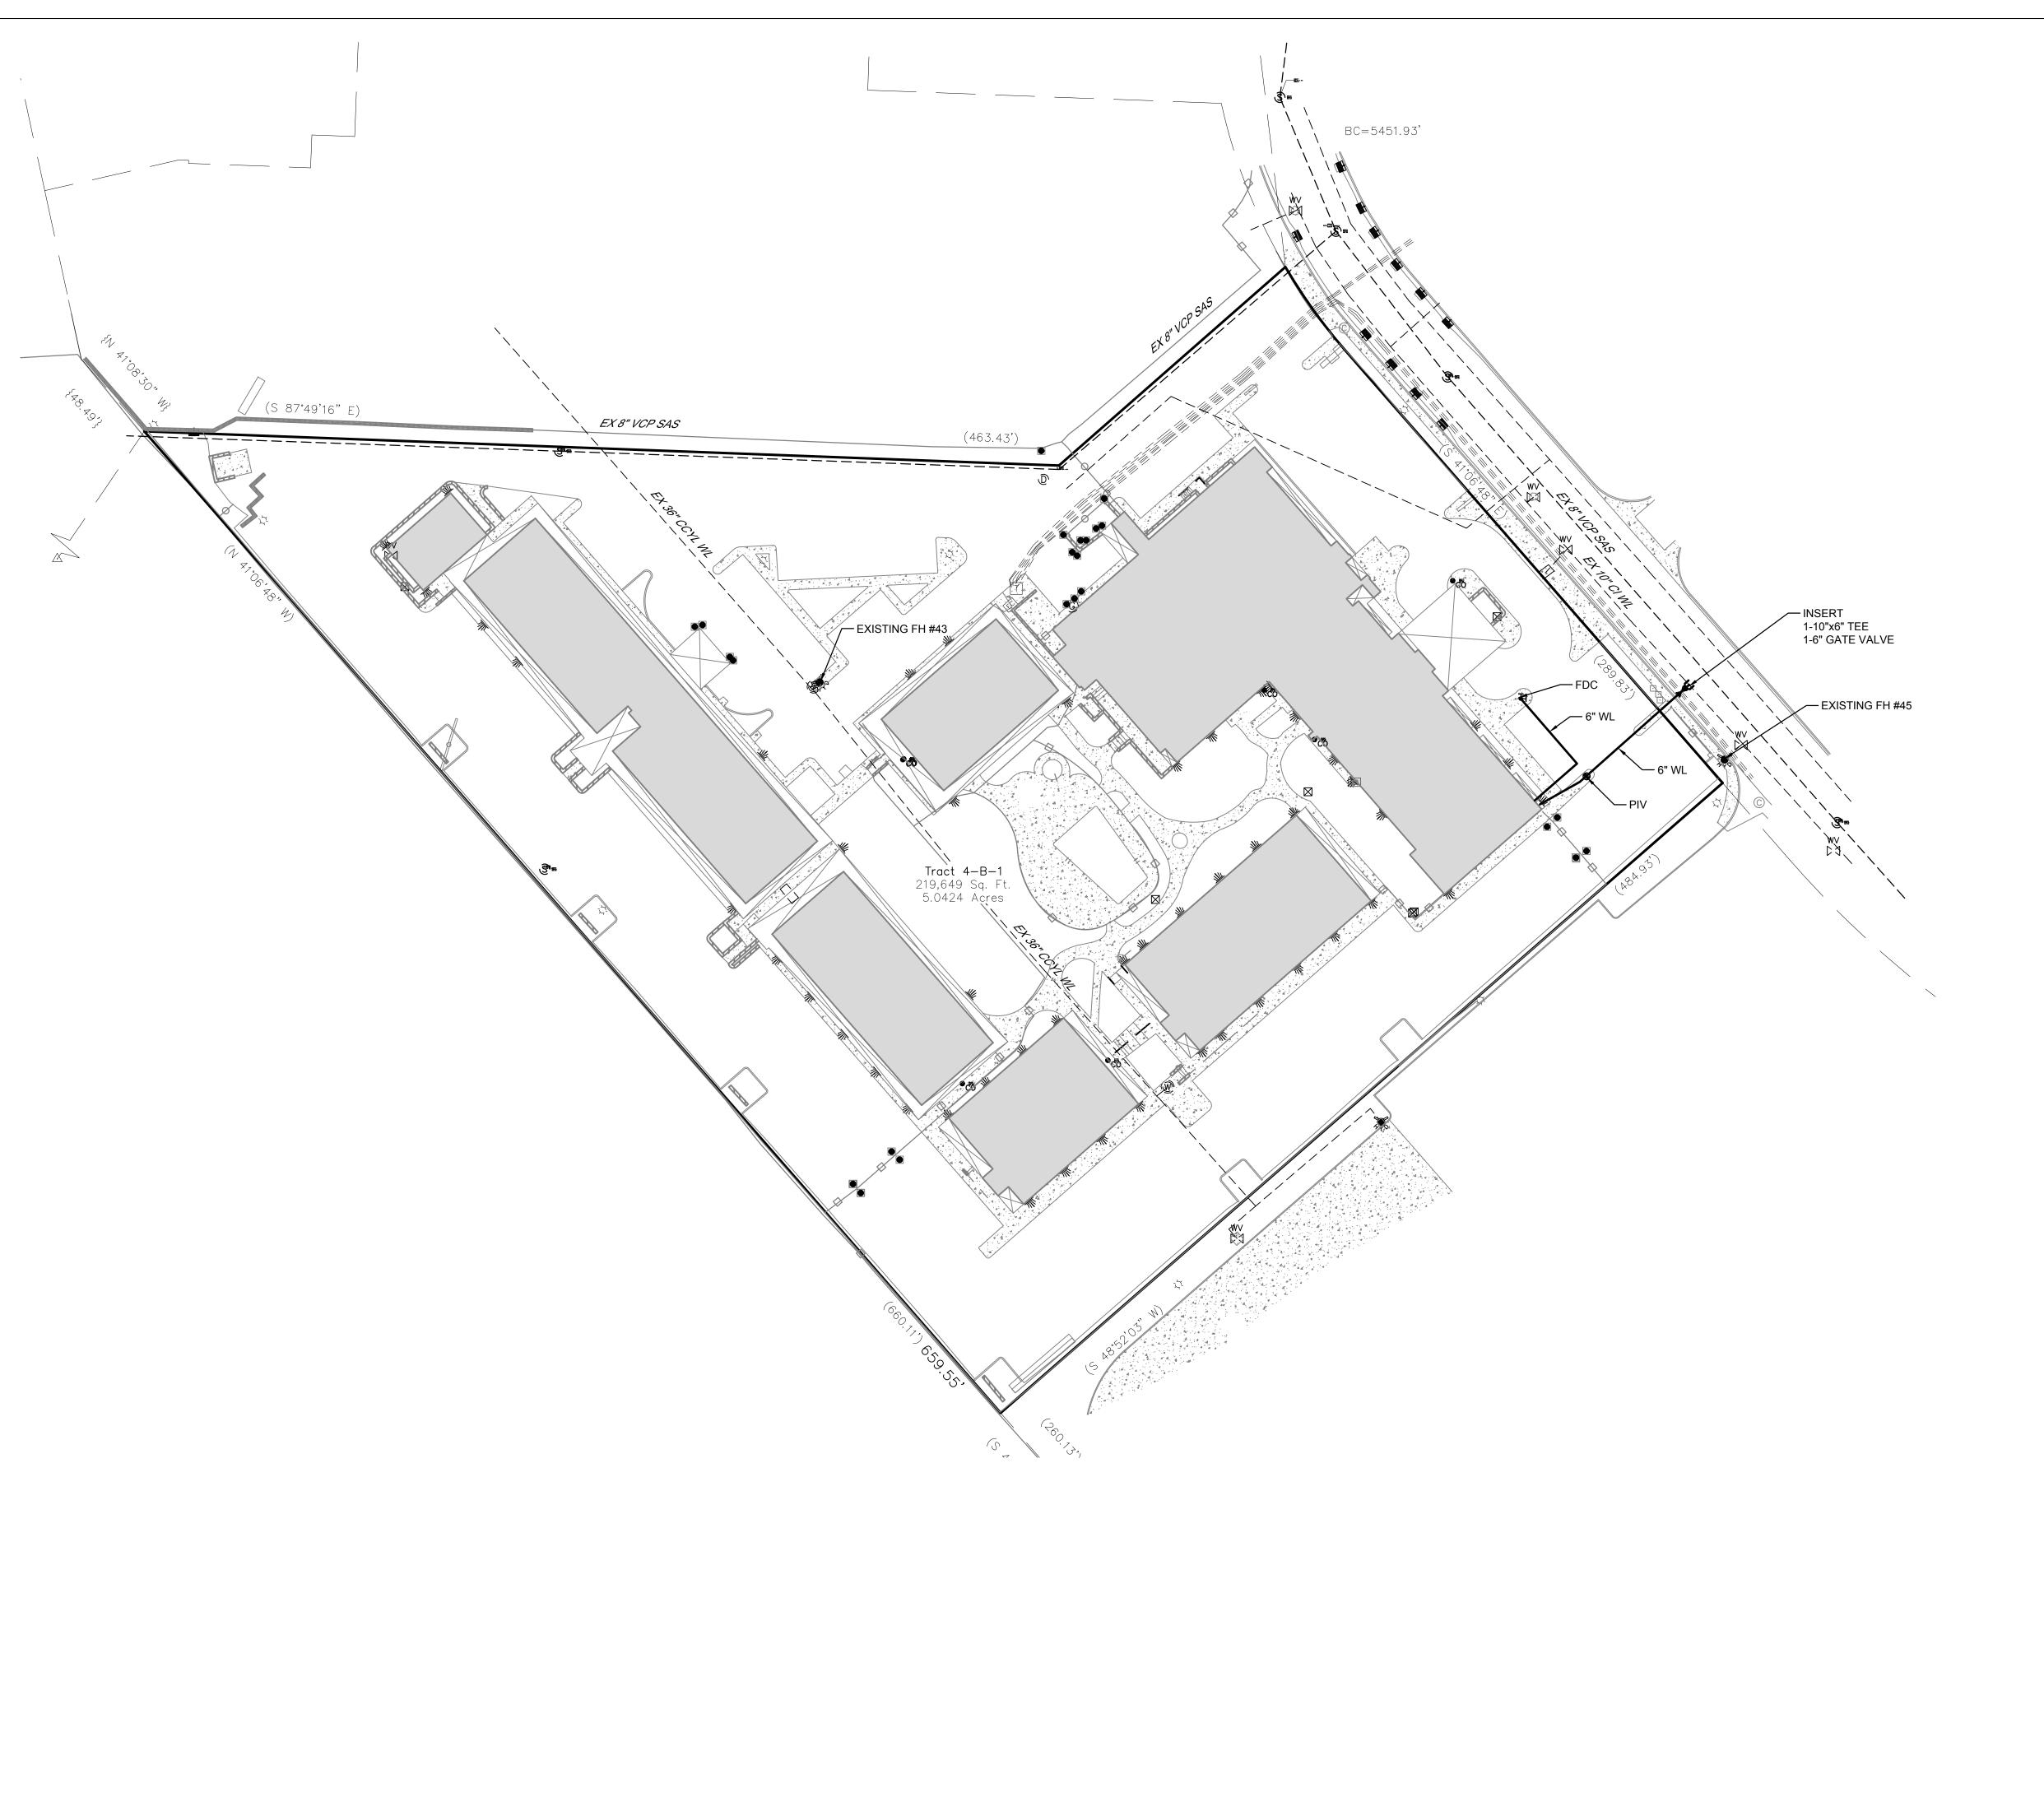

GENERAL NOTES

- 1. SEE SHEET C-100 FOR ALL CIVIL GENERAL NOTES.
- 2. EXISTING UTILITY LINES ARE SHOWN IN AN APPROXIMATE MANNER ONLY AND MAY BE INCOMPLETE OR OBSOLETE. SUCH LINES MAY OR MAY NOT EXIST WHERE SHOWN OR NOT SHOWN. ALL UTILITIES SHOULD BE FIELD VERIFIED AND LOCATED BY THE CONTRACTOR PRIOR TO COMMENCEMENT OF ANY CONSTRUCTION. THE CONTRACTOR IS FULLY RESPONSIBLE FOR ANY AND ALL DAMAGE CAUSED BY ITS FAILURE TO LOCATE, IDENTIFY AND PRESERVE ANY AND ALL EXISTING UTILITIES, PIPELINES, AND UNDERGROUND UTILITY LINES.
- 3. CONTRACTOR SHALL NOT USE VIBRATORY COMPACTION EQUIPMENT OR HEAVY VEHICLES OVER EXISTING UTILITIES.
- 4. SITE STORM DRAIN, ELECTRIC LINES & TRANSFORMERS AND GAS LINES ARE SHOWN FOR GENERAL INFORMATION ONLY TO PROVIDE AN OVERVIEW OF SITE UTILITIES AND POTENTIAL CONFLICTS. SEE MECHANICAL PLANS FOR GAS LINE SIZING. SEE CG-101 FOR STORM DRAIN DESIGN.
- 5. ALL ABOVE GROUND UTILITY EQUIPMENT AND FITTINGS SHALL BE PAINTED IN COLORS TO MATCH BUILDING COLORS.

RESTRAINED JOINT CRITERIA

FOR WATERLINE FITTINGS

- ALL MECHANICAL JOINTS SHALL BE RESTRAINED AT THE FITTINGS PER KEYED NOTES THIS SHEET.
- 2. THE CONTRACTOR SHALL PROVIDE A MINIMUM PIPE LENGTH OF 20 LF FROM ALL MECHANICAL JOINTS. ALL PIPE JOINTS WITHIN 20 LF OF A MECHANICAL JOINT SHALL BE RESTRAINED AT THE CONTRACTOR'S EXPENSE.
- 3. THE CONTRACTOR SHALL RESTRAIN ALL PIPE JOINTS IN THE SPECIFIED DISTANCE LISTED IN THE KEYED NOTES.
- 4. THE CONTRACTOR SHALL RESTRAIN ALL FIRE HYDRANT JOINTS FROM THE TEE ON THE MAIN TO THE FIRE HYDRANT FLANGE.

DEPTH OF BURY: 3.0 FT. MINIMUM FACTOR OF SAFETY: 1.50

MATERIAL: PVC
SOIL TYPE: GM/SM - SILTY GRAVELS AND
SILTY SANDS, GRAVEL-

SAND-SILT MIXTURES.
TEST PRESSURE: 150 PSI

TRENCH TYPE 4: PIPE BEDDED IN SAND, GRAVEL, OR

CRUSHED STONE TO DEPTH OF 1/8 PIPE DIAMETER, 4 INCH MINIMUM; BACKFILL COMPACTED TO TOP OF

DIFFERENT CRITERIA, E.G., GREATER DEPTH OF BURY, ETC., WILL REQUIRE DIFFERENT RESTRAINED LENGTHS. THESE MUST BE CALCULATED BY A QUALIFIED PROFESSIONAL ENGINEER AND APPROVED BY ABCWUA.

LEGEND

EXISTING WATERLINE

EXISTING FIRE HYDANT

EXISTING WATER VALVE

EXISTING SEWER LINE

EXISTING SEWER MANHOLE

NEW WATER SERVICE

NEW FIRE LINE

NEW FIRE HYDANT


NEW WATER VALVE

NEW FOC

NEW FIRE




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Engineer

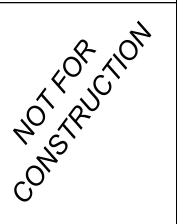RAMADA INN CONVERSION 25 HOTEL CIRCLE NE ALBUQUERQUE, NM 87123



PLAN

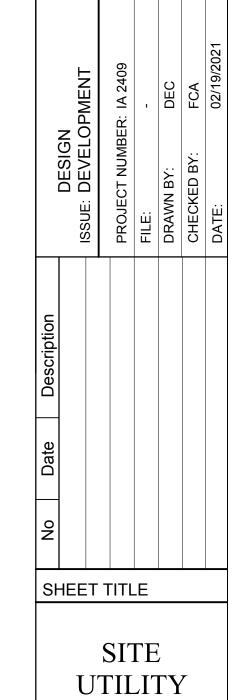CU-101

SHEET NUMBER

0 20 40 80 SCALE 1"=40'



D



ajc architects 703 east 1700 south salt lake city, ut 84105 ajcarchitects.com

> NOT FOR CONSTRUCTION

ARCHITECT / CONSULTANT

AUTHORITY HAVING JURISDICTION

PROJECT DESCRIPTION

RAMADA INN CONVERSION

25 HOTEL CIR NE ALBUQUERQUE, NM 87123

SHEET NAME:

BUILDING A RENDERINGS

REVISIONS

MARK DATE DESCRIPTION

12/18/2020 DRB SUBMITTAL DRAWN BY: LT CHECKED BY:


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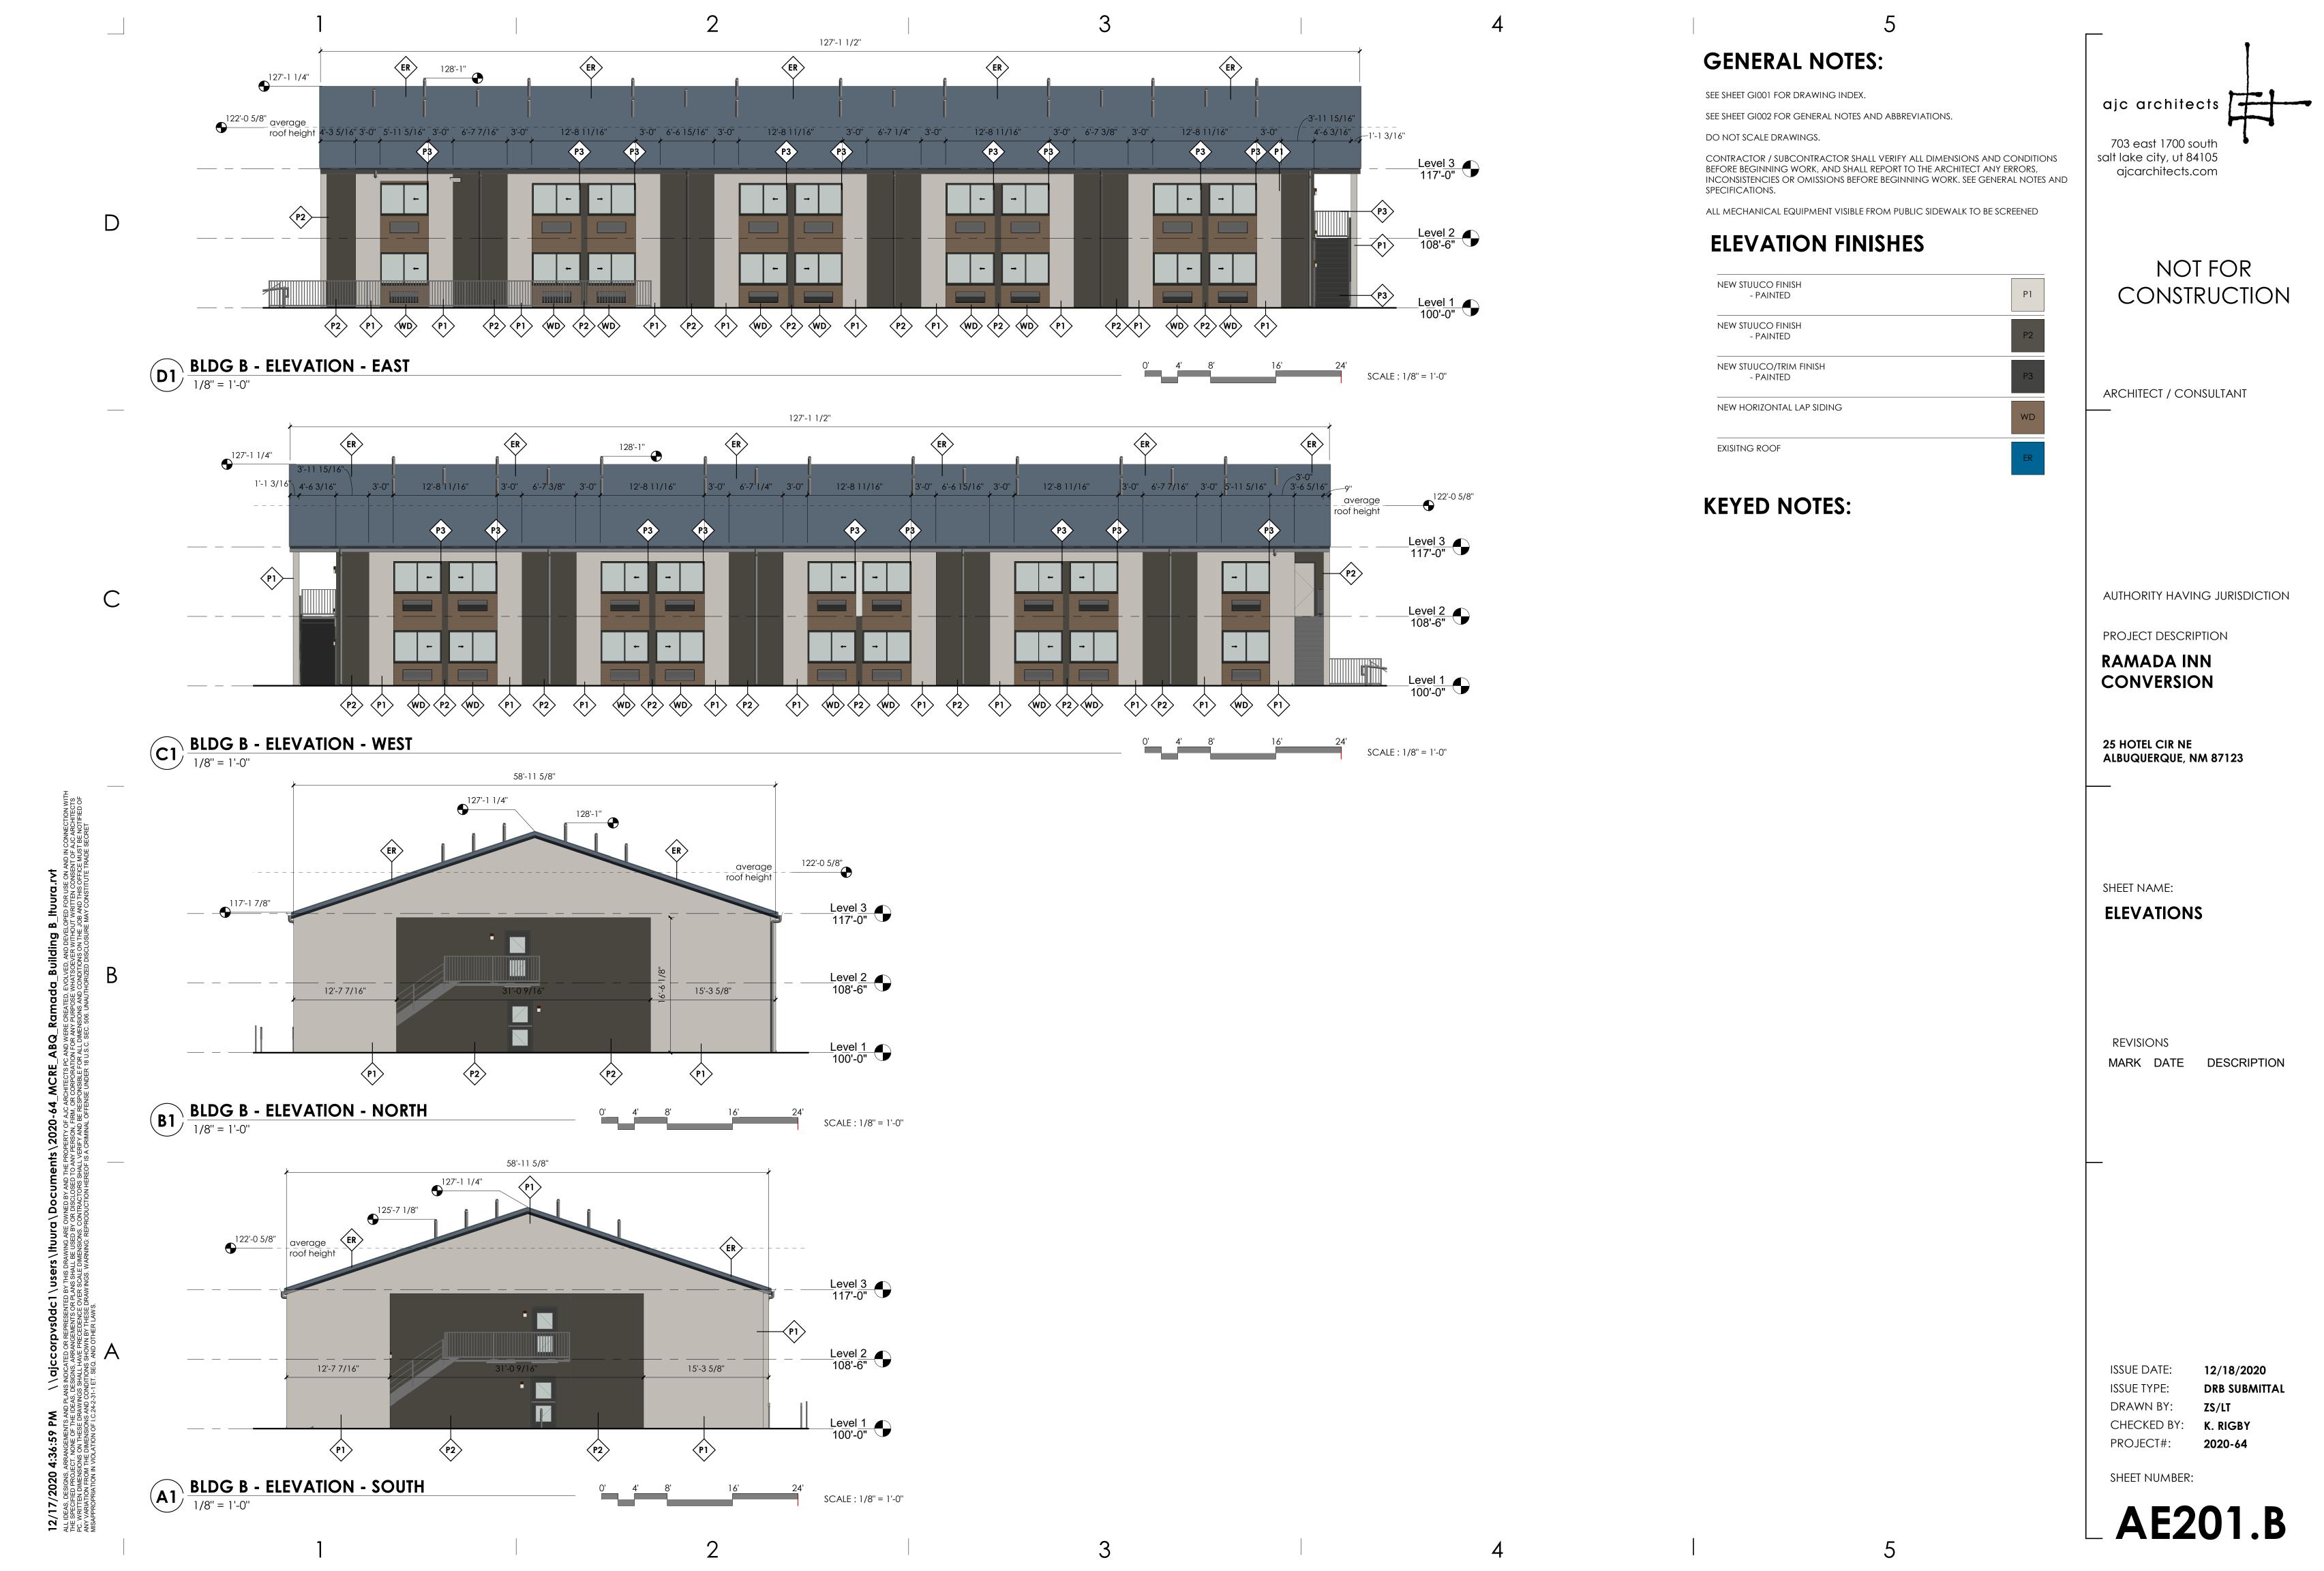
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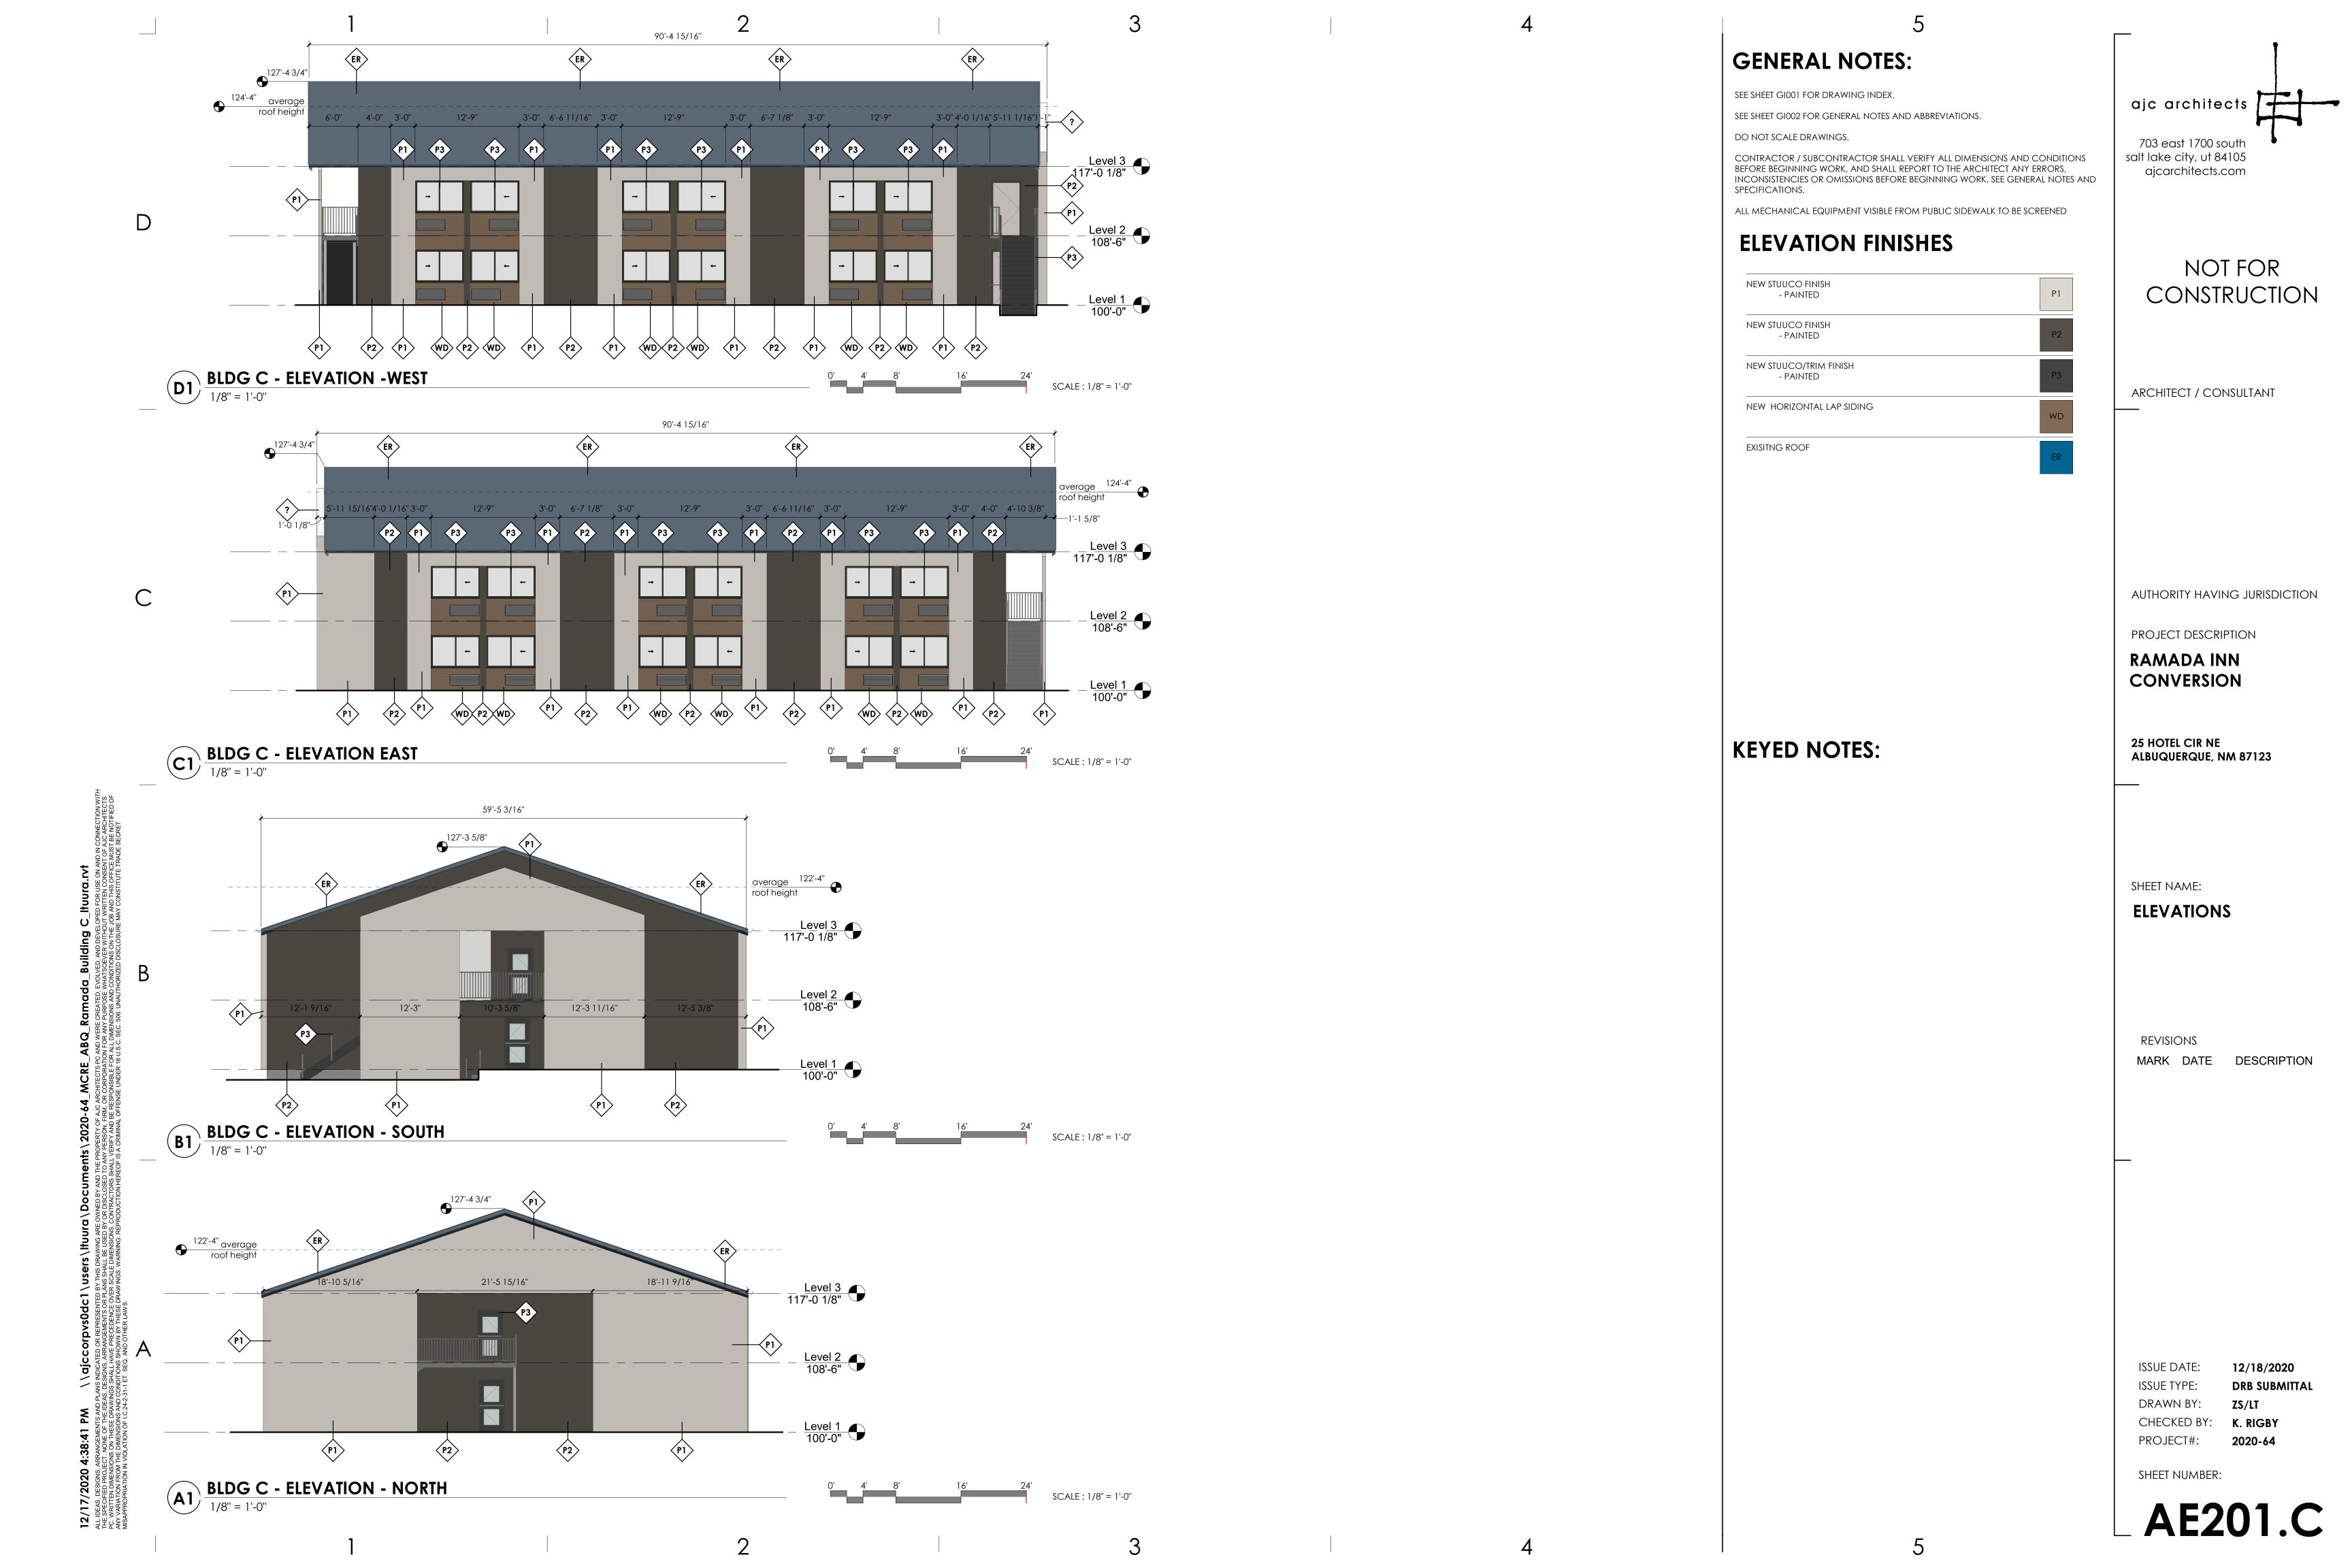
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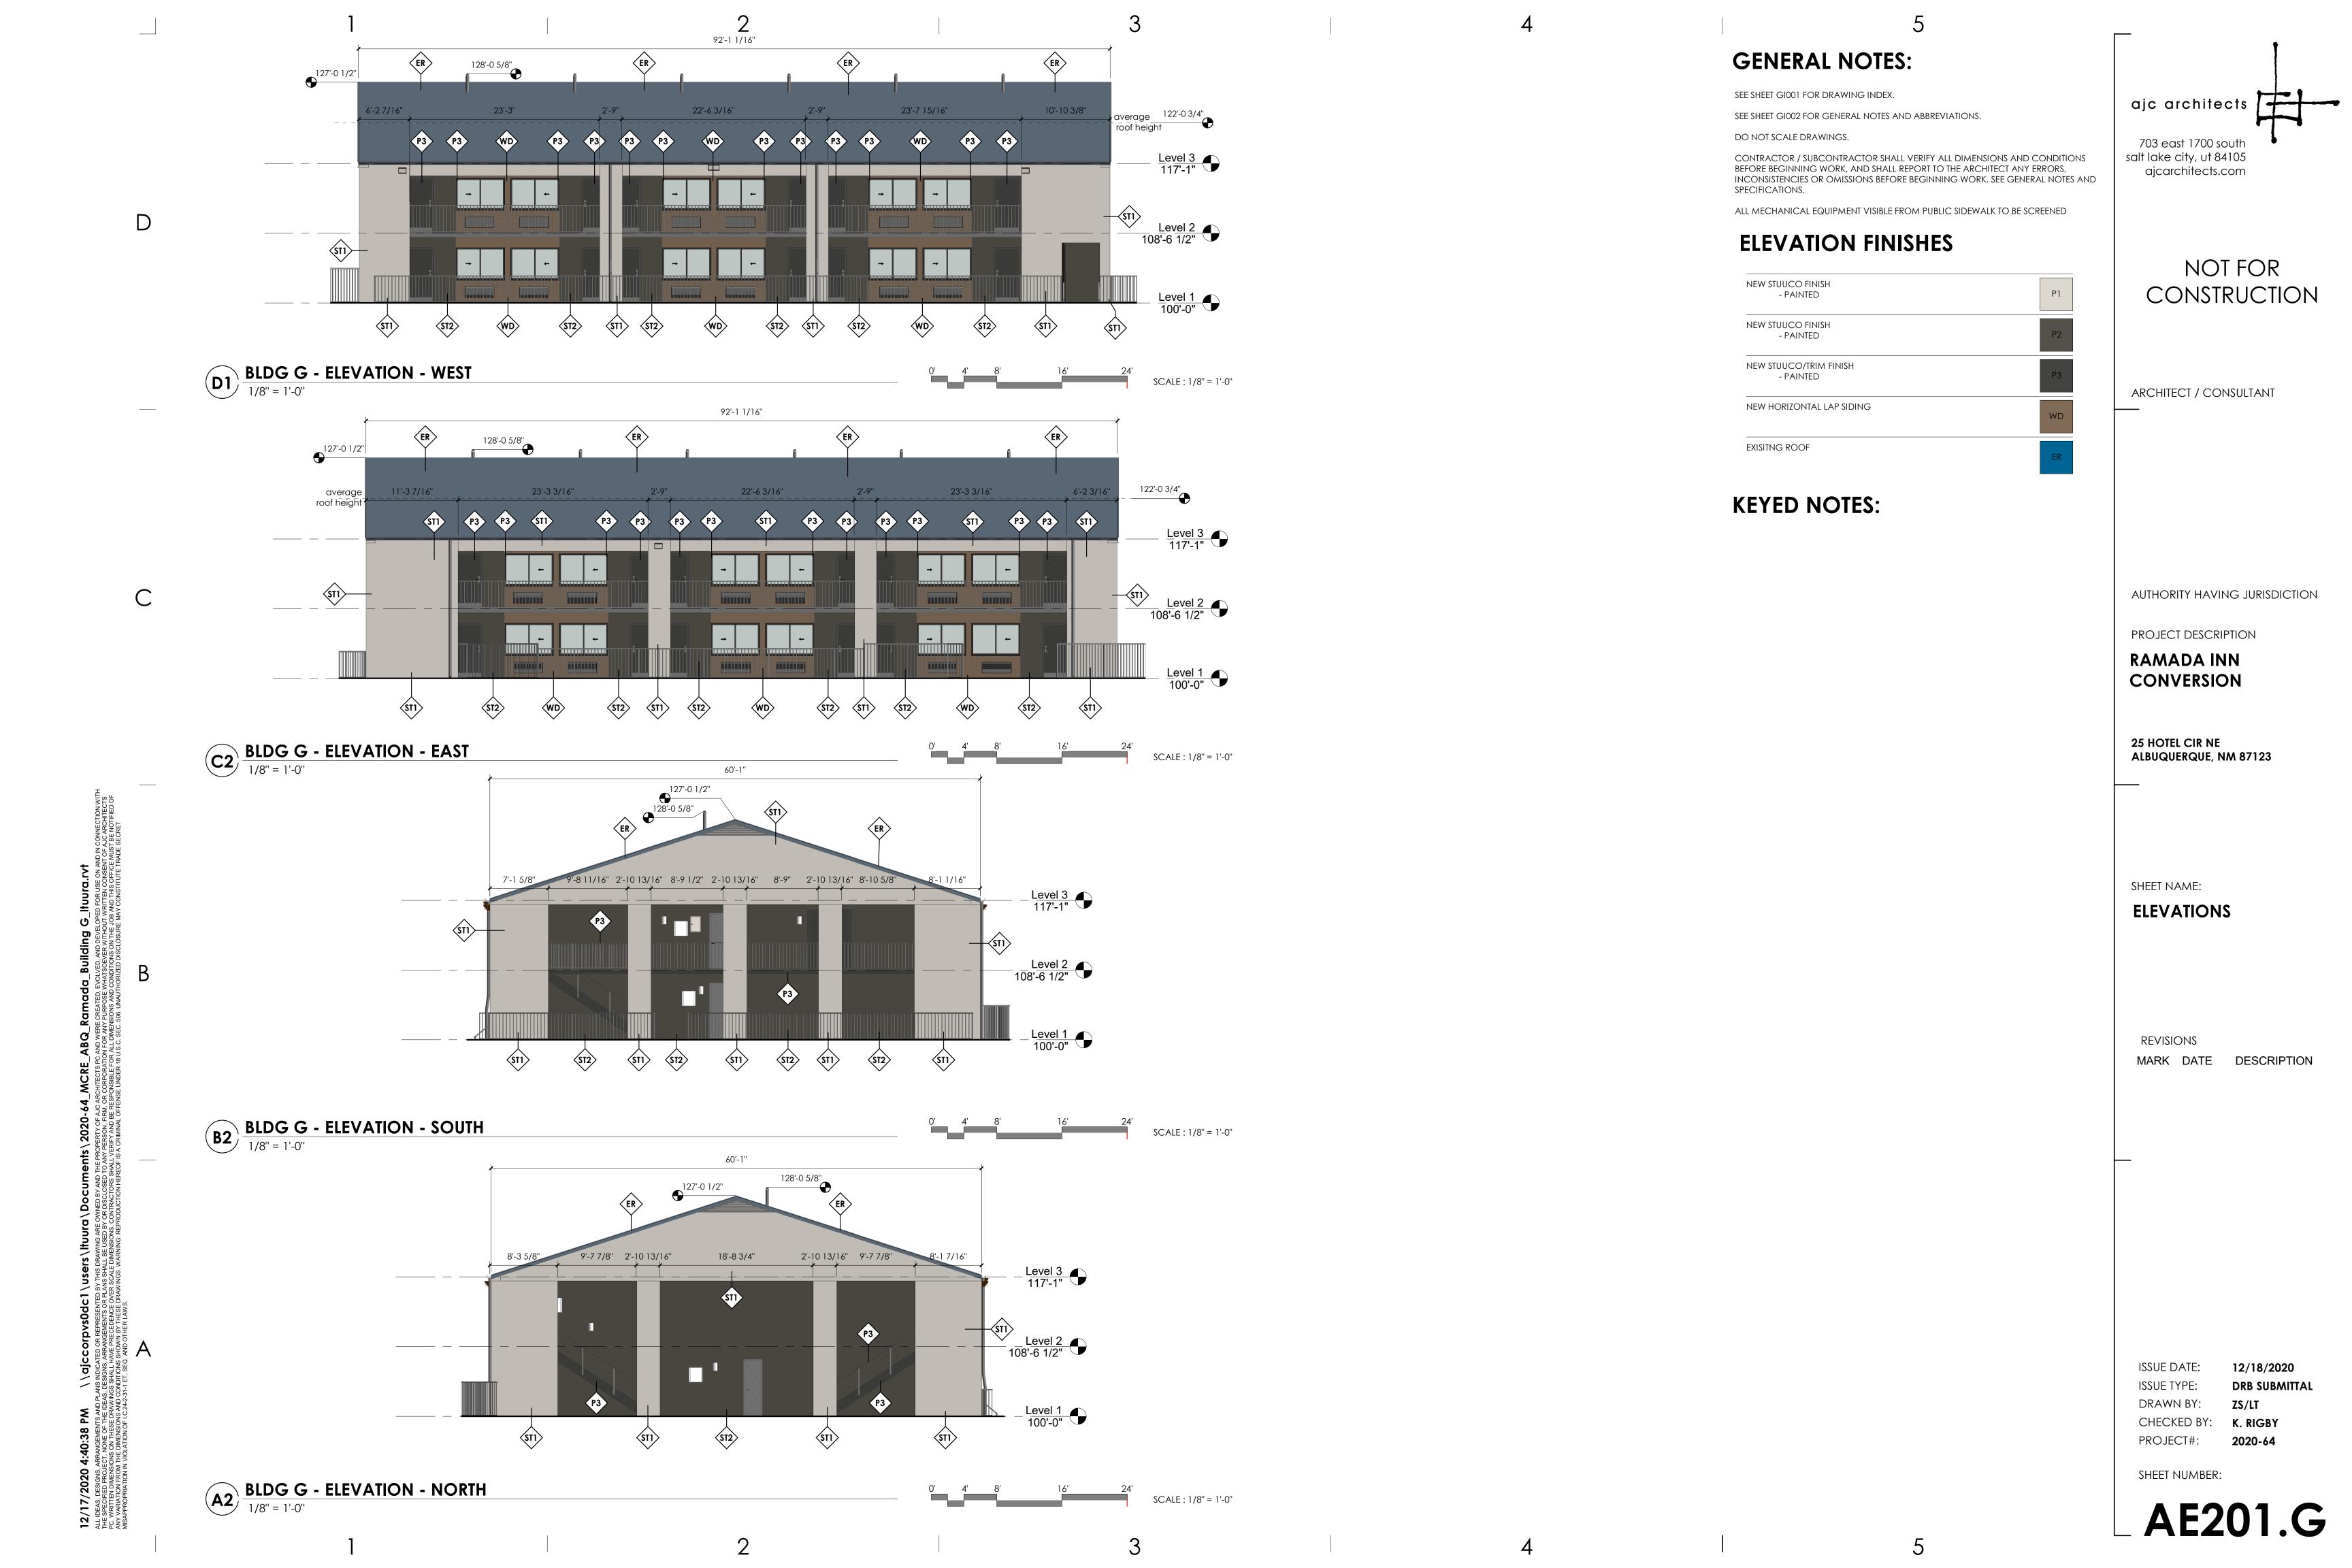












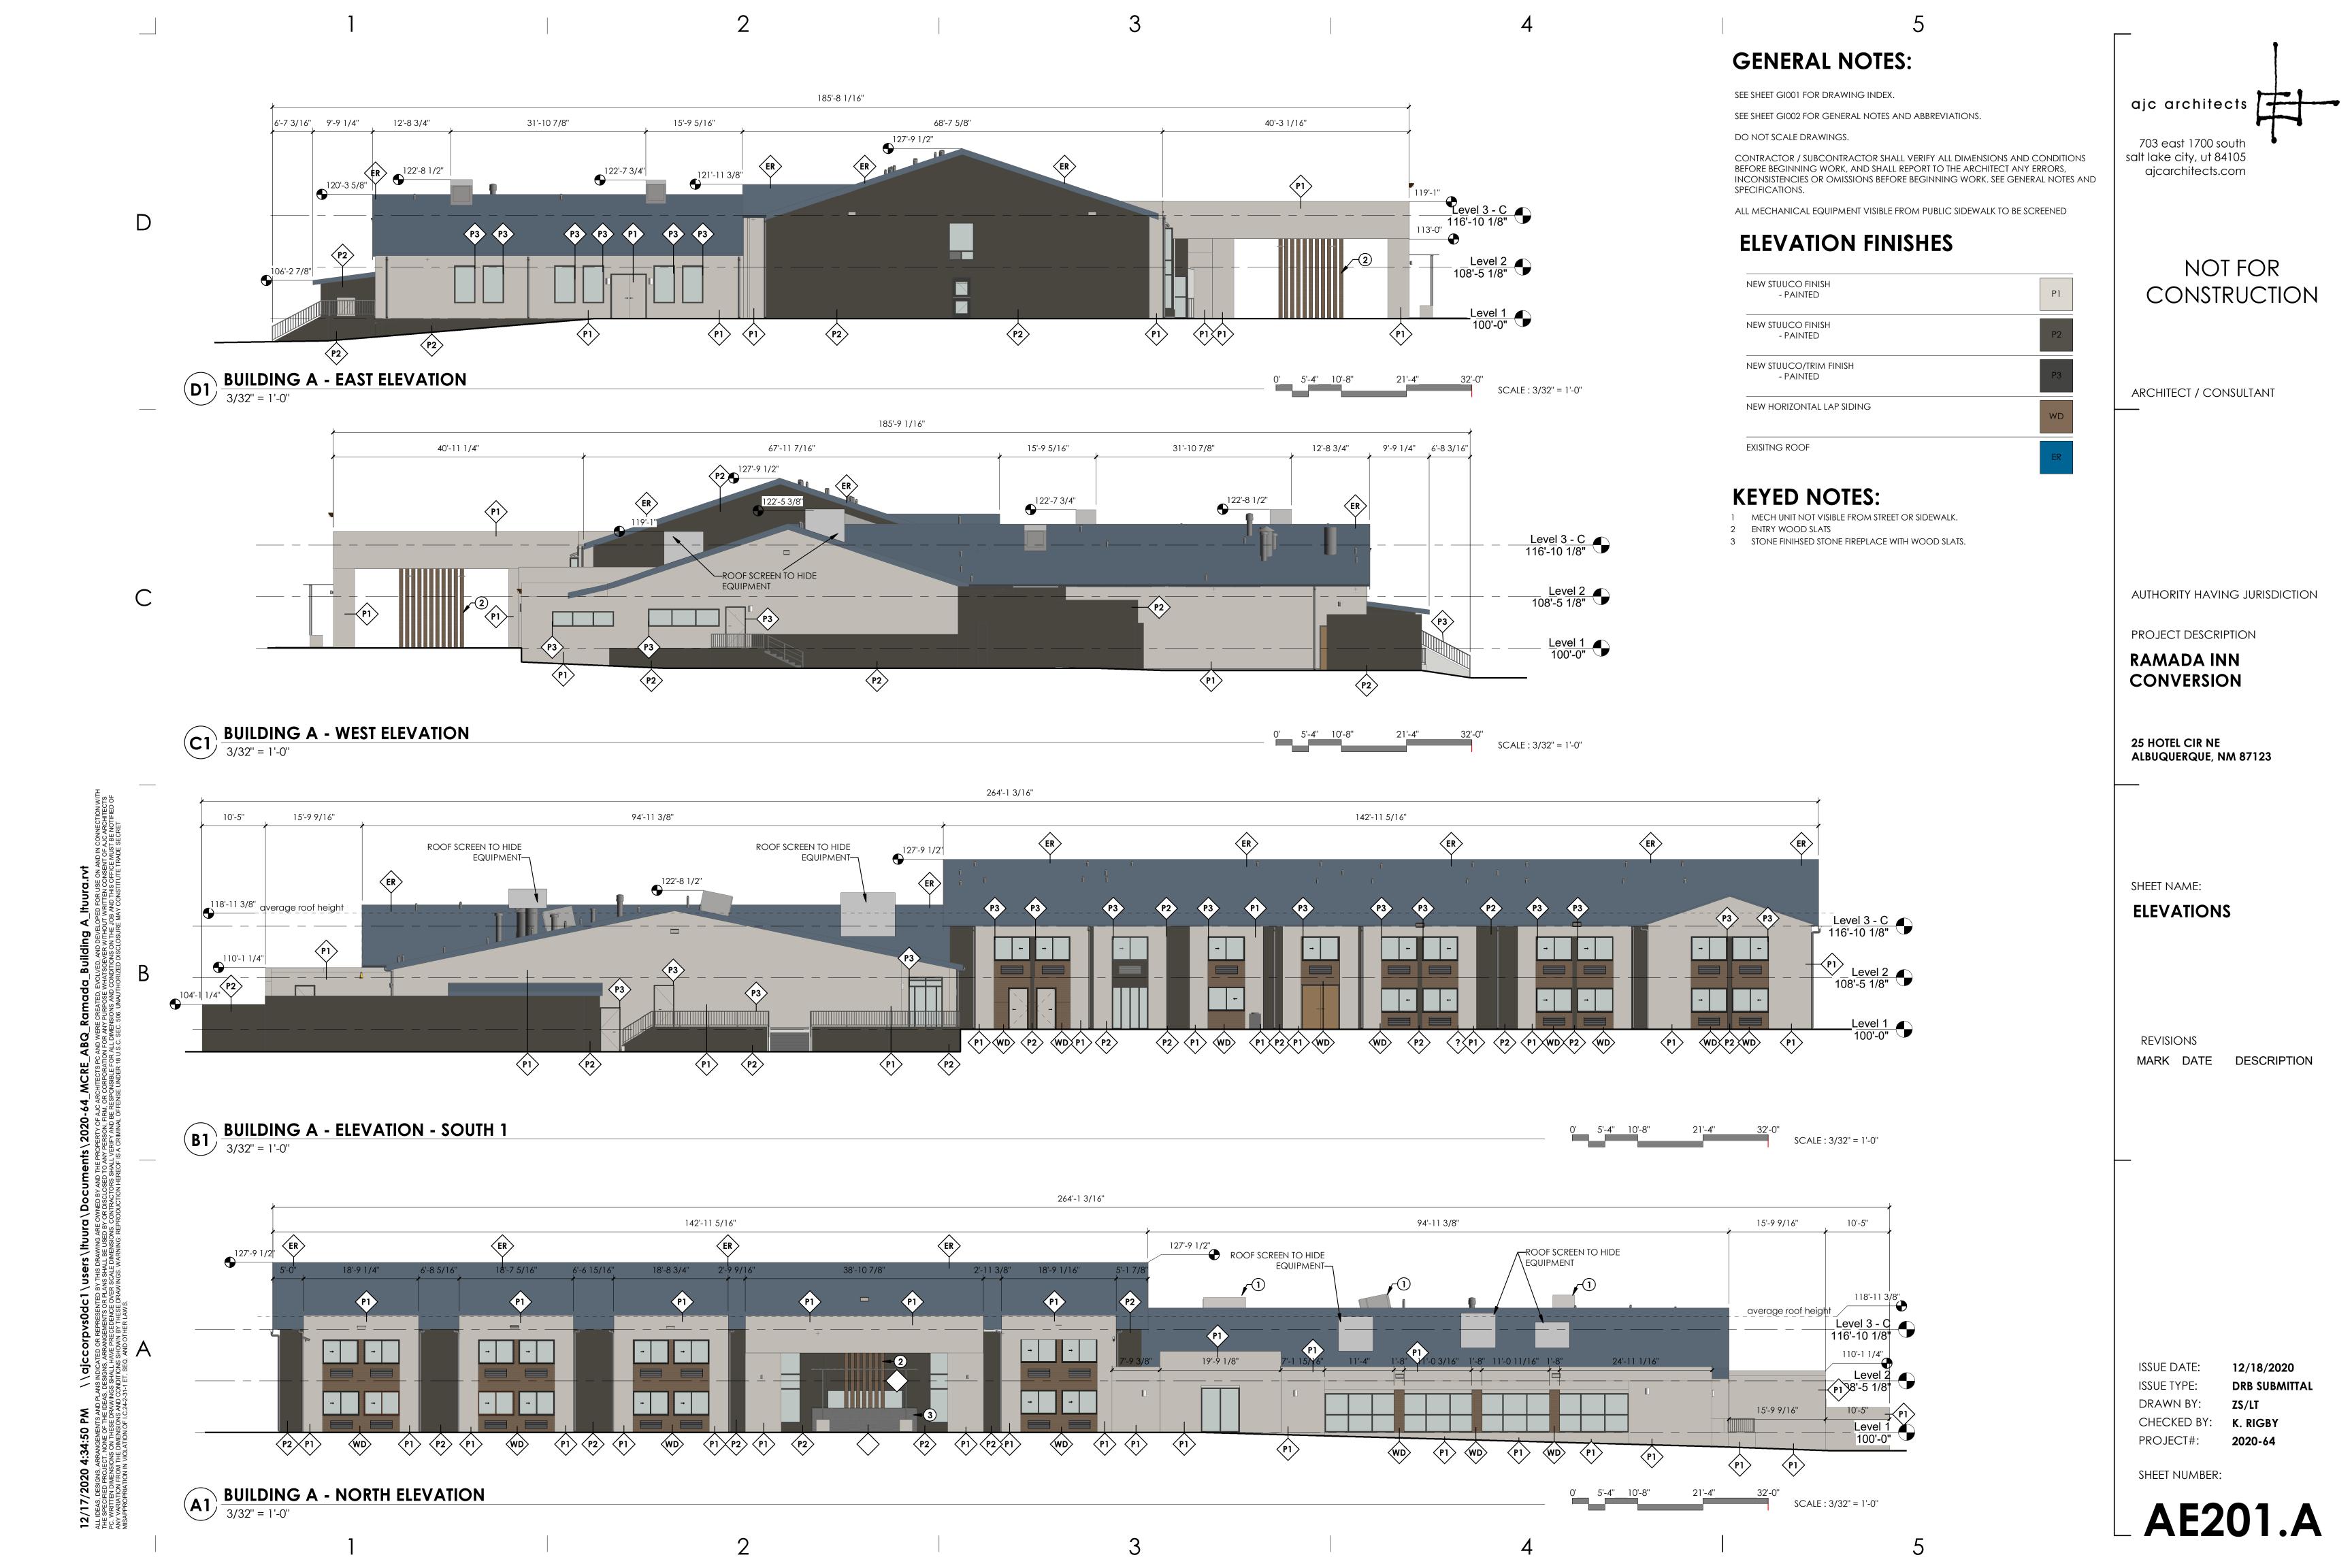

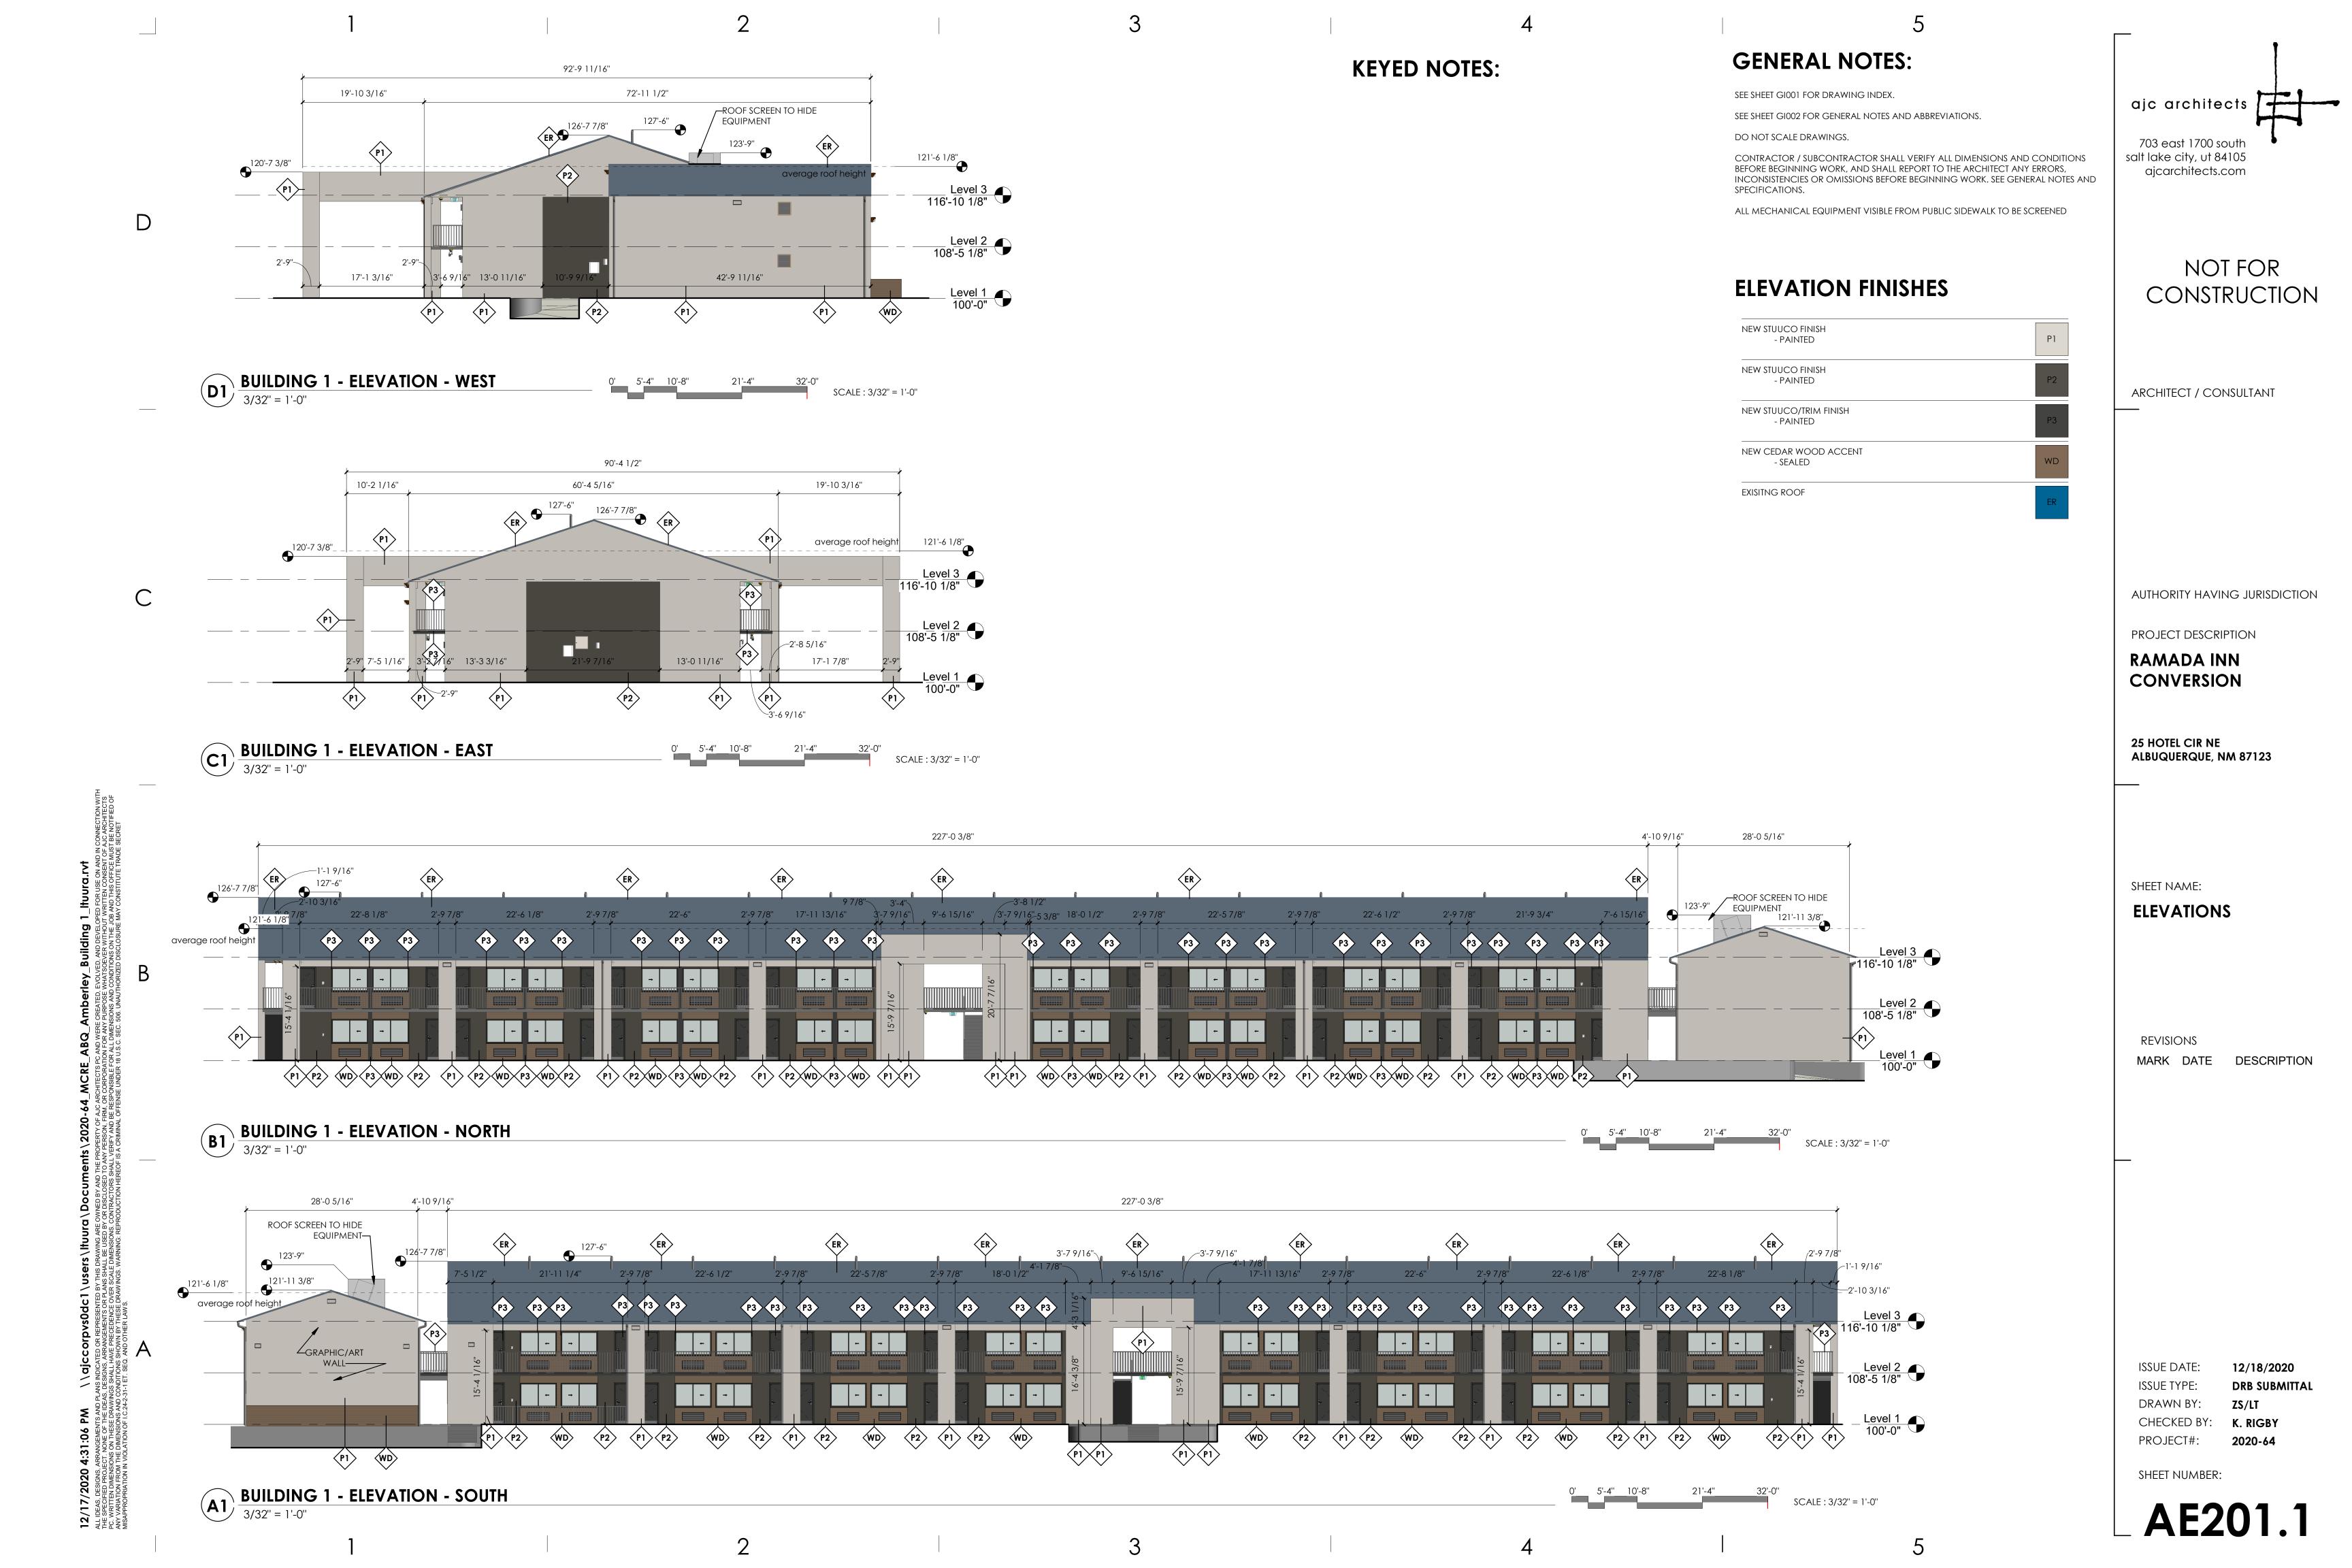

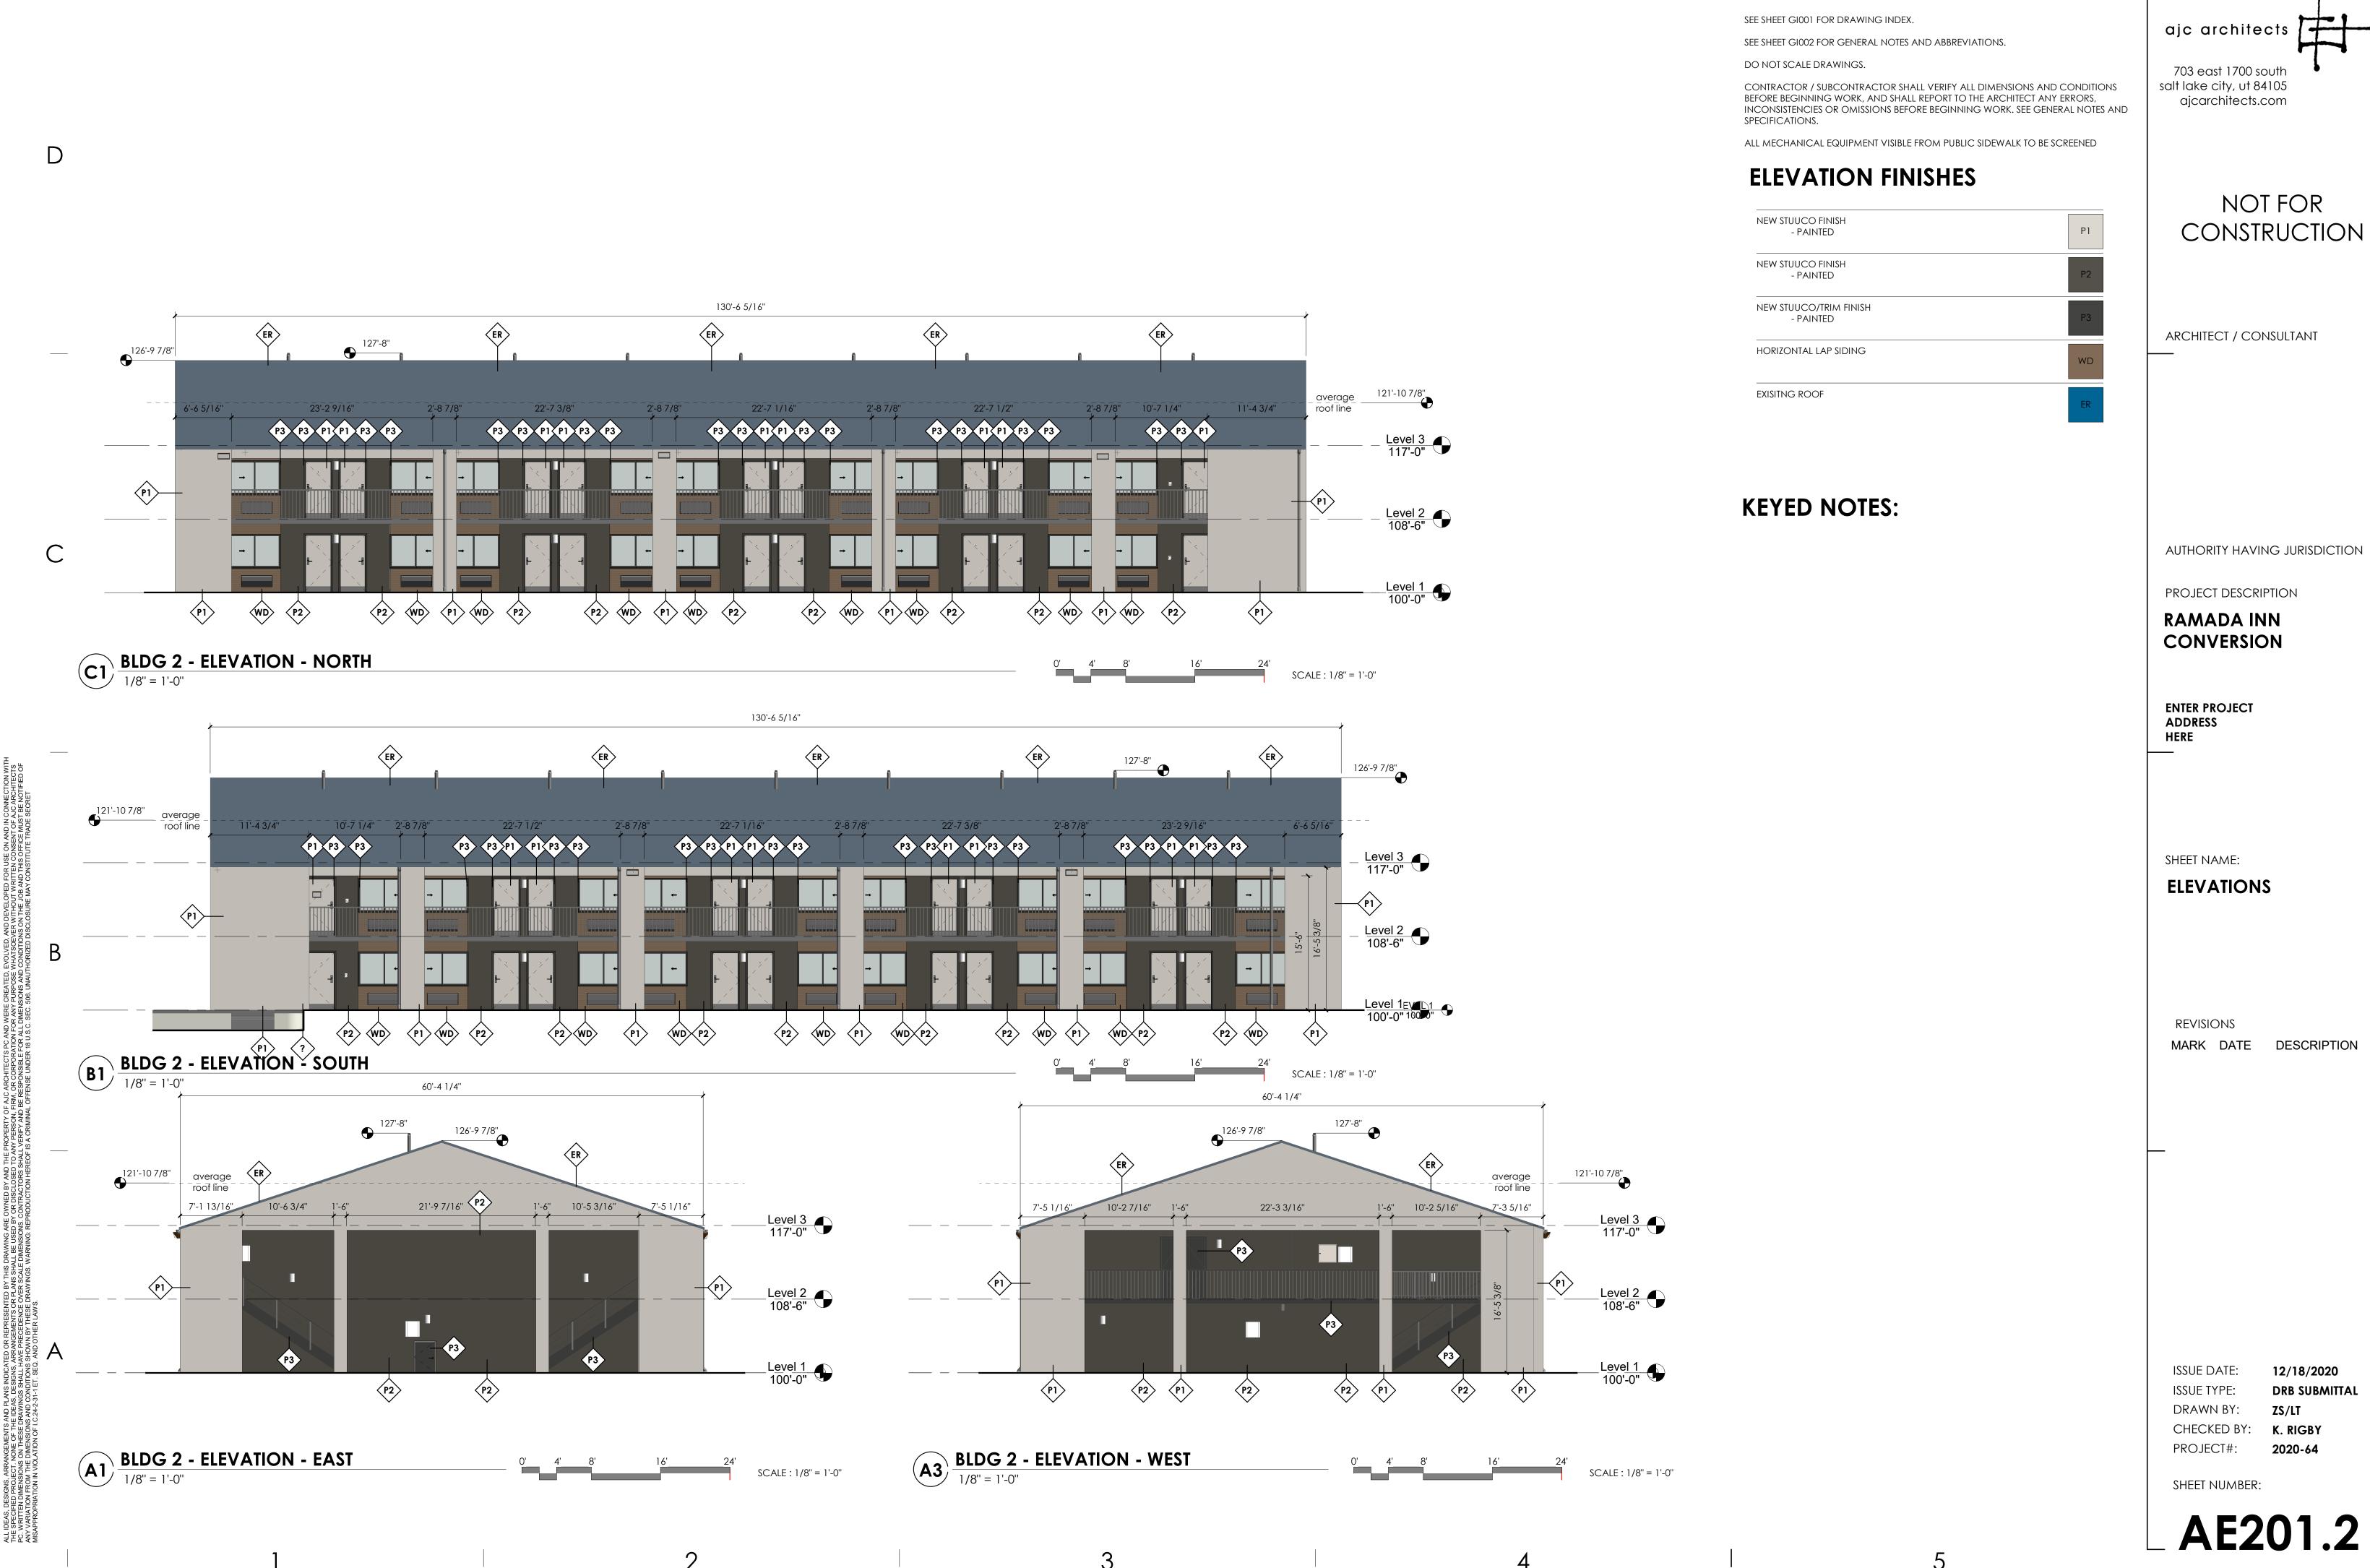

GENERAL NOTES:

