

ADMINISTRATIVE AMENDMENT		
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APPROVED BY	DATE	

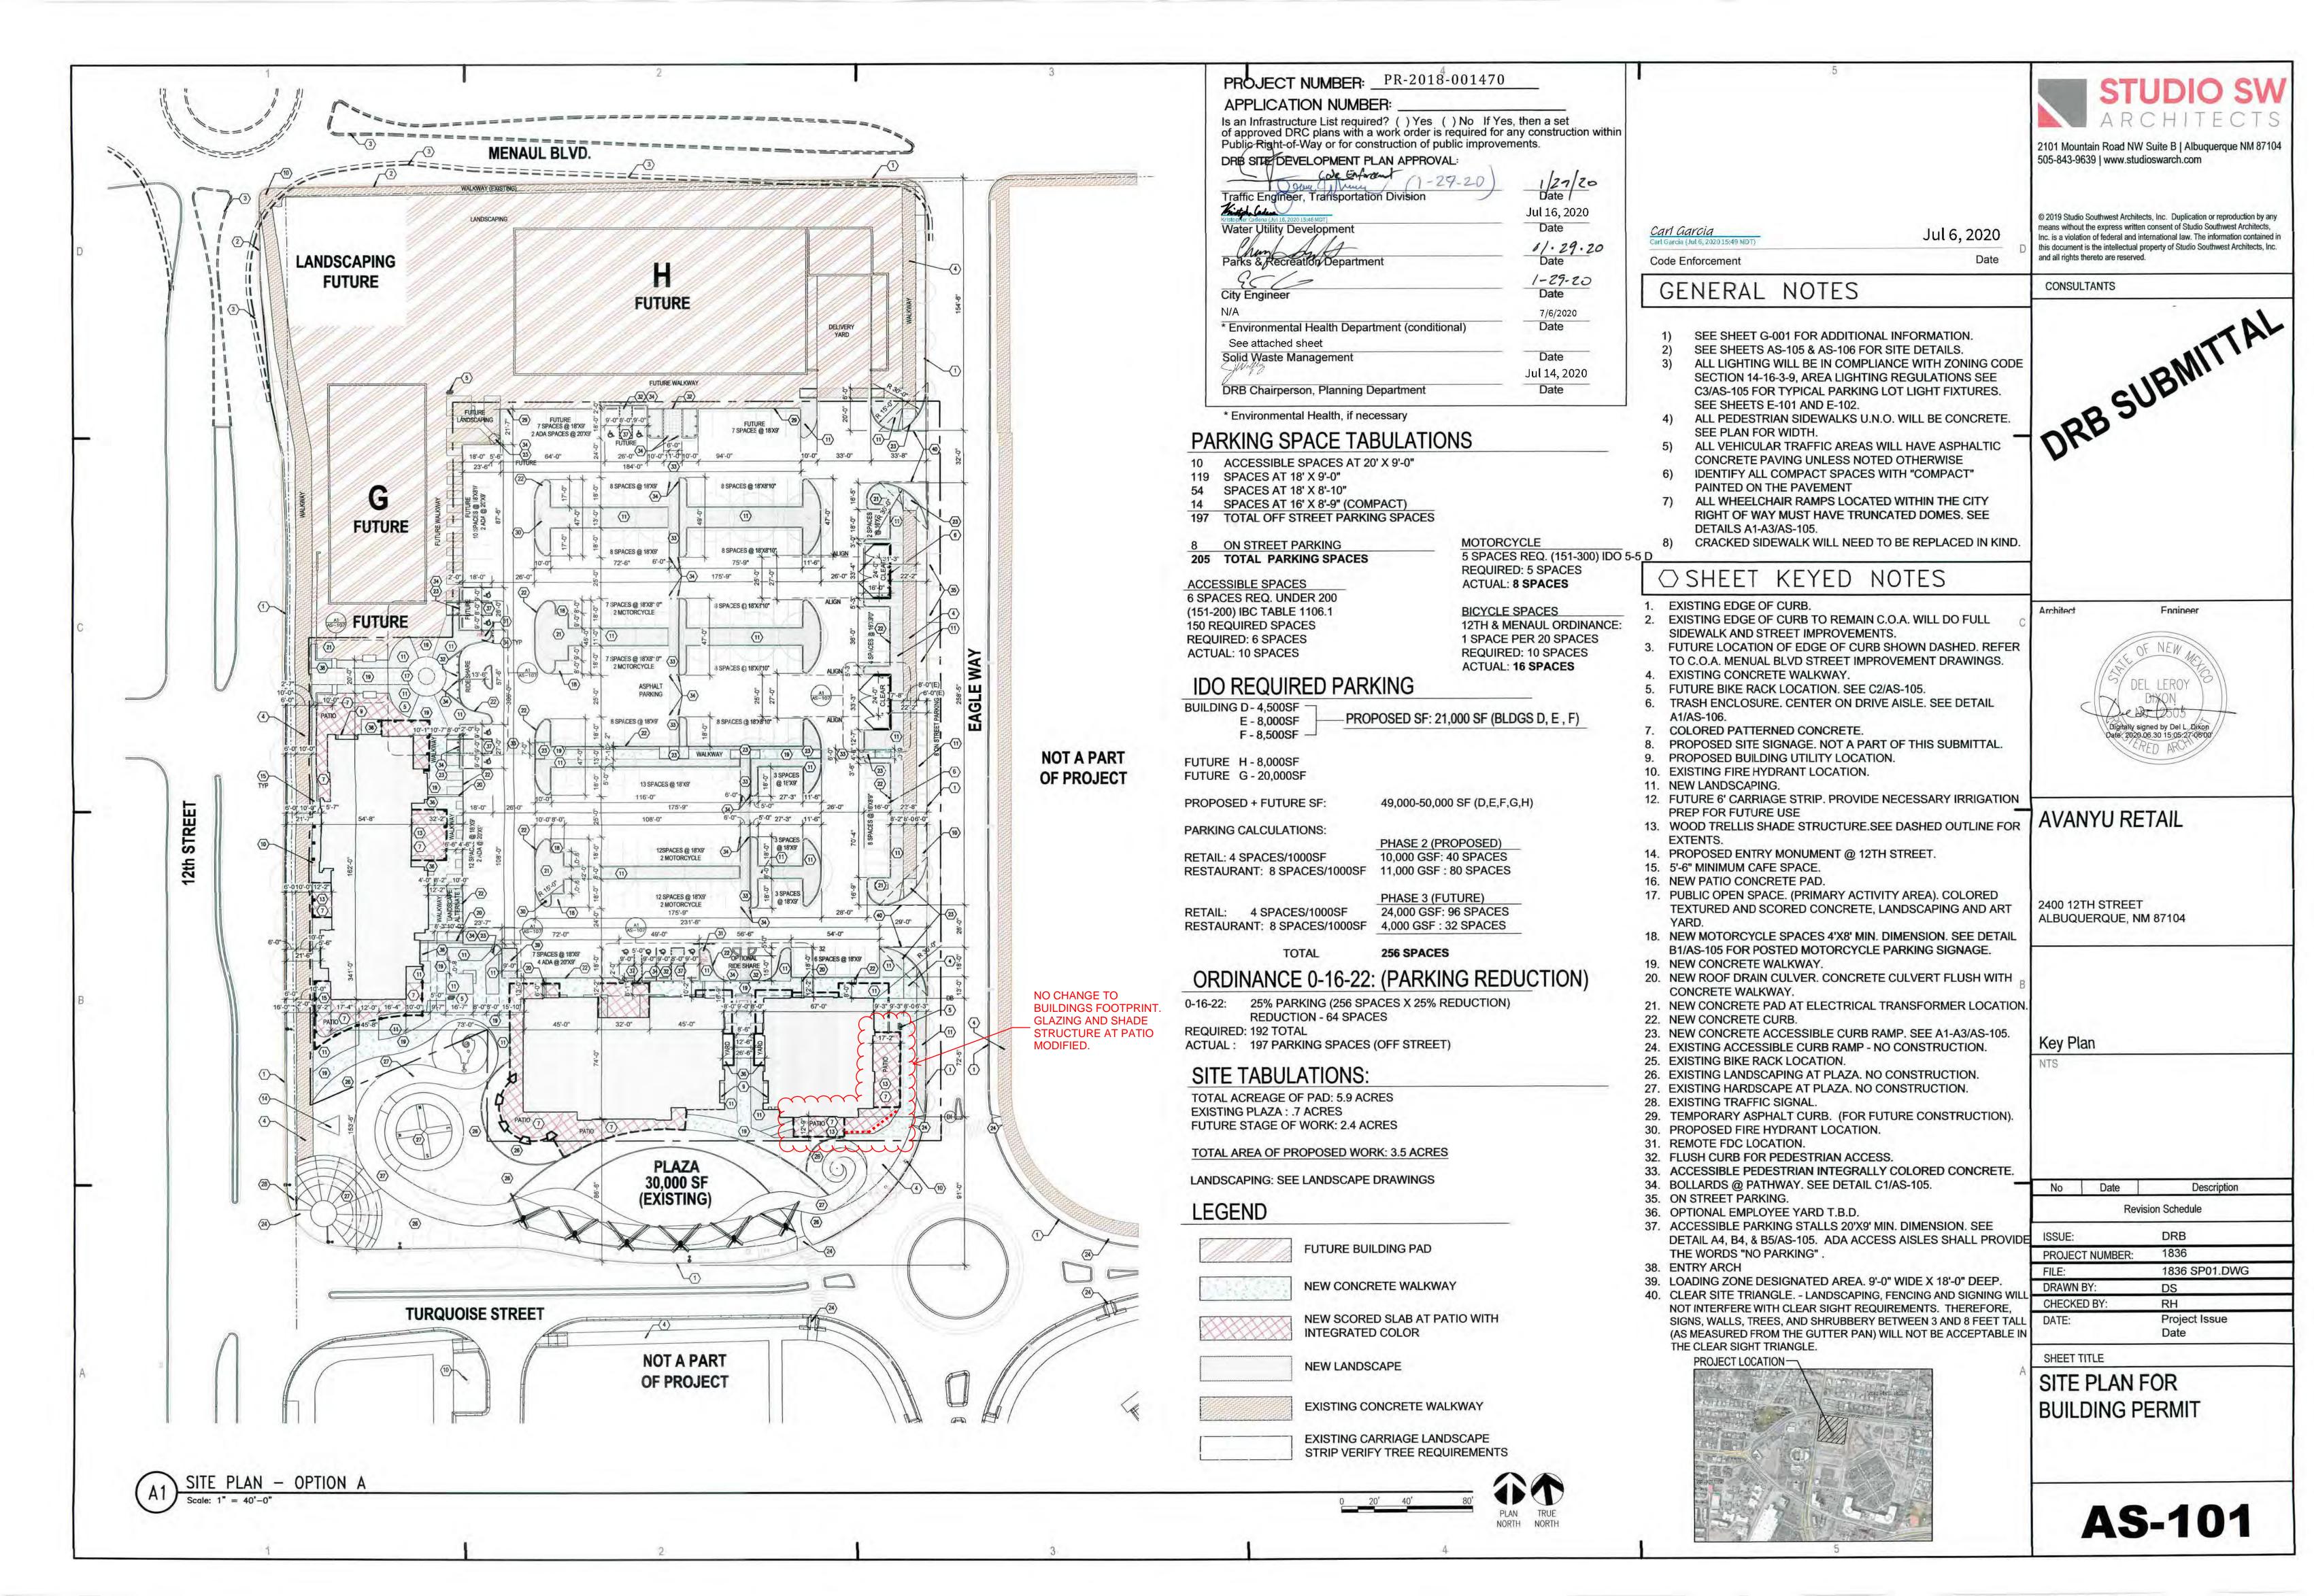

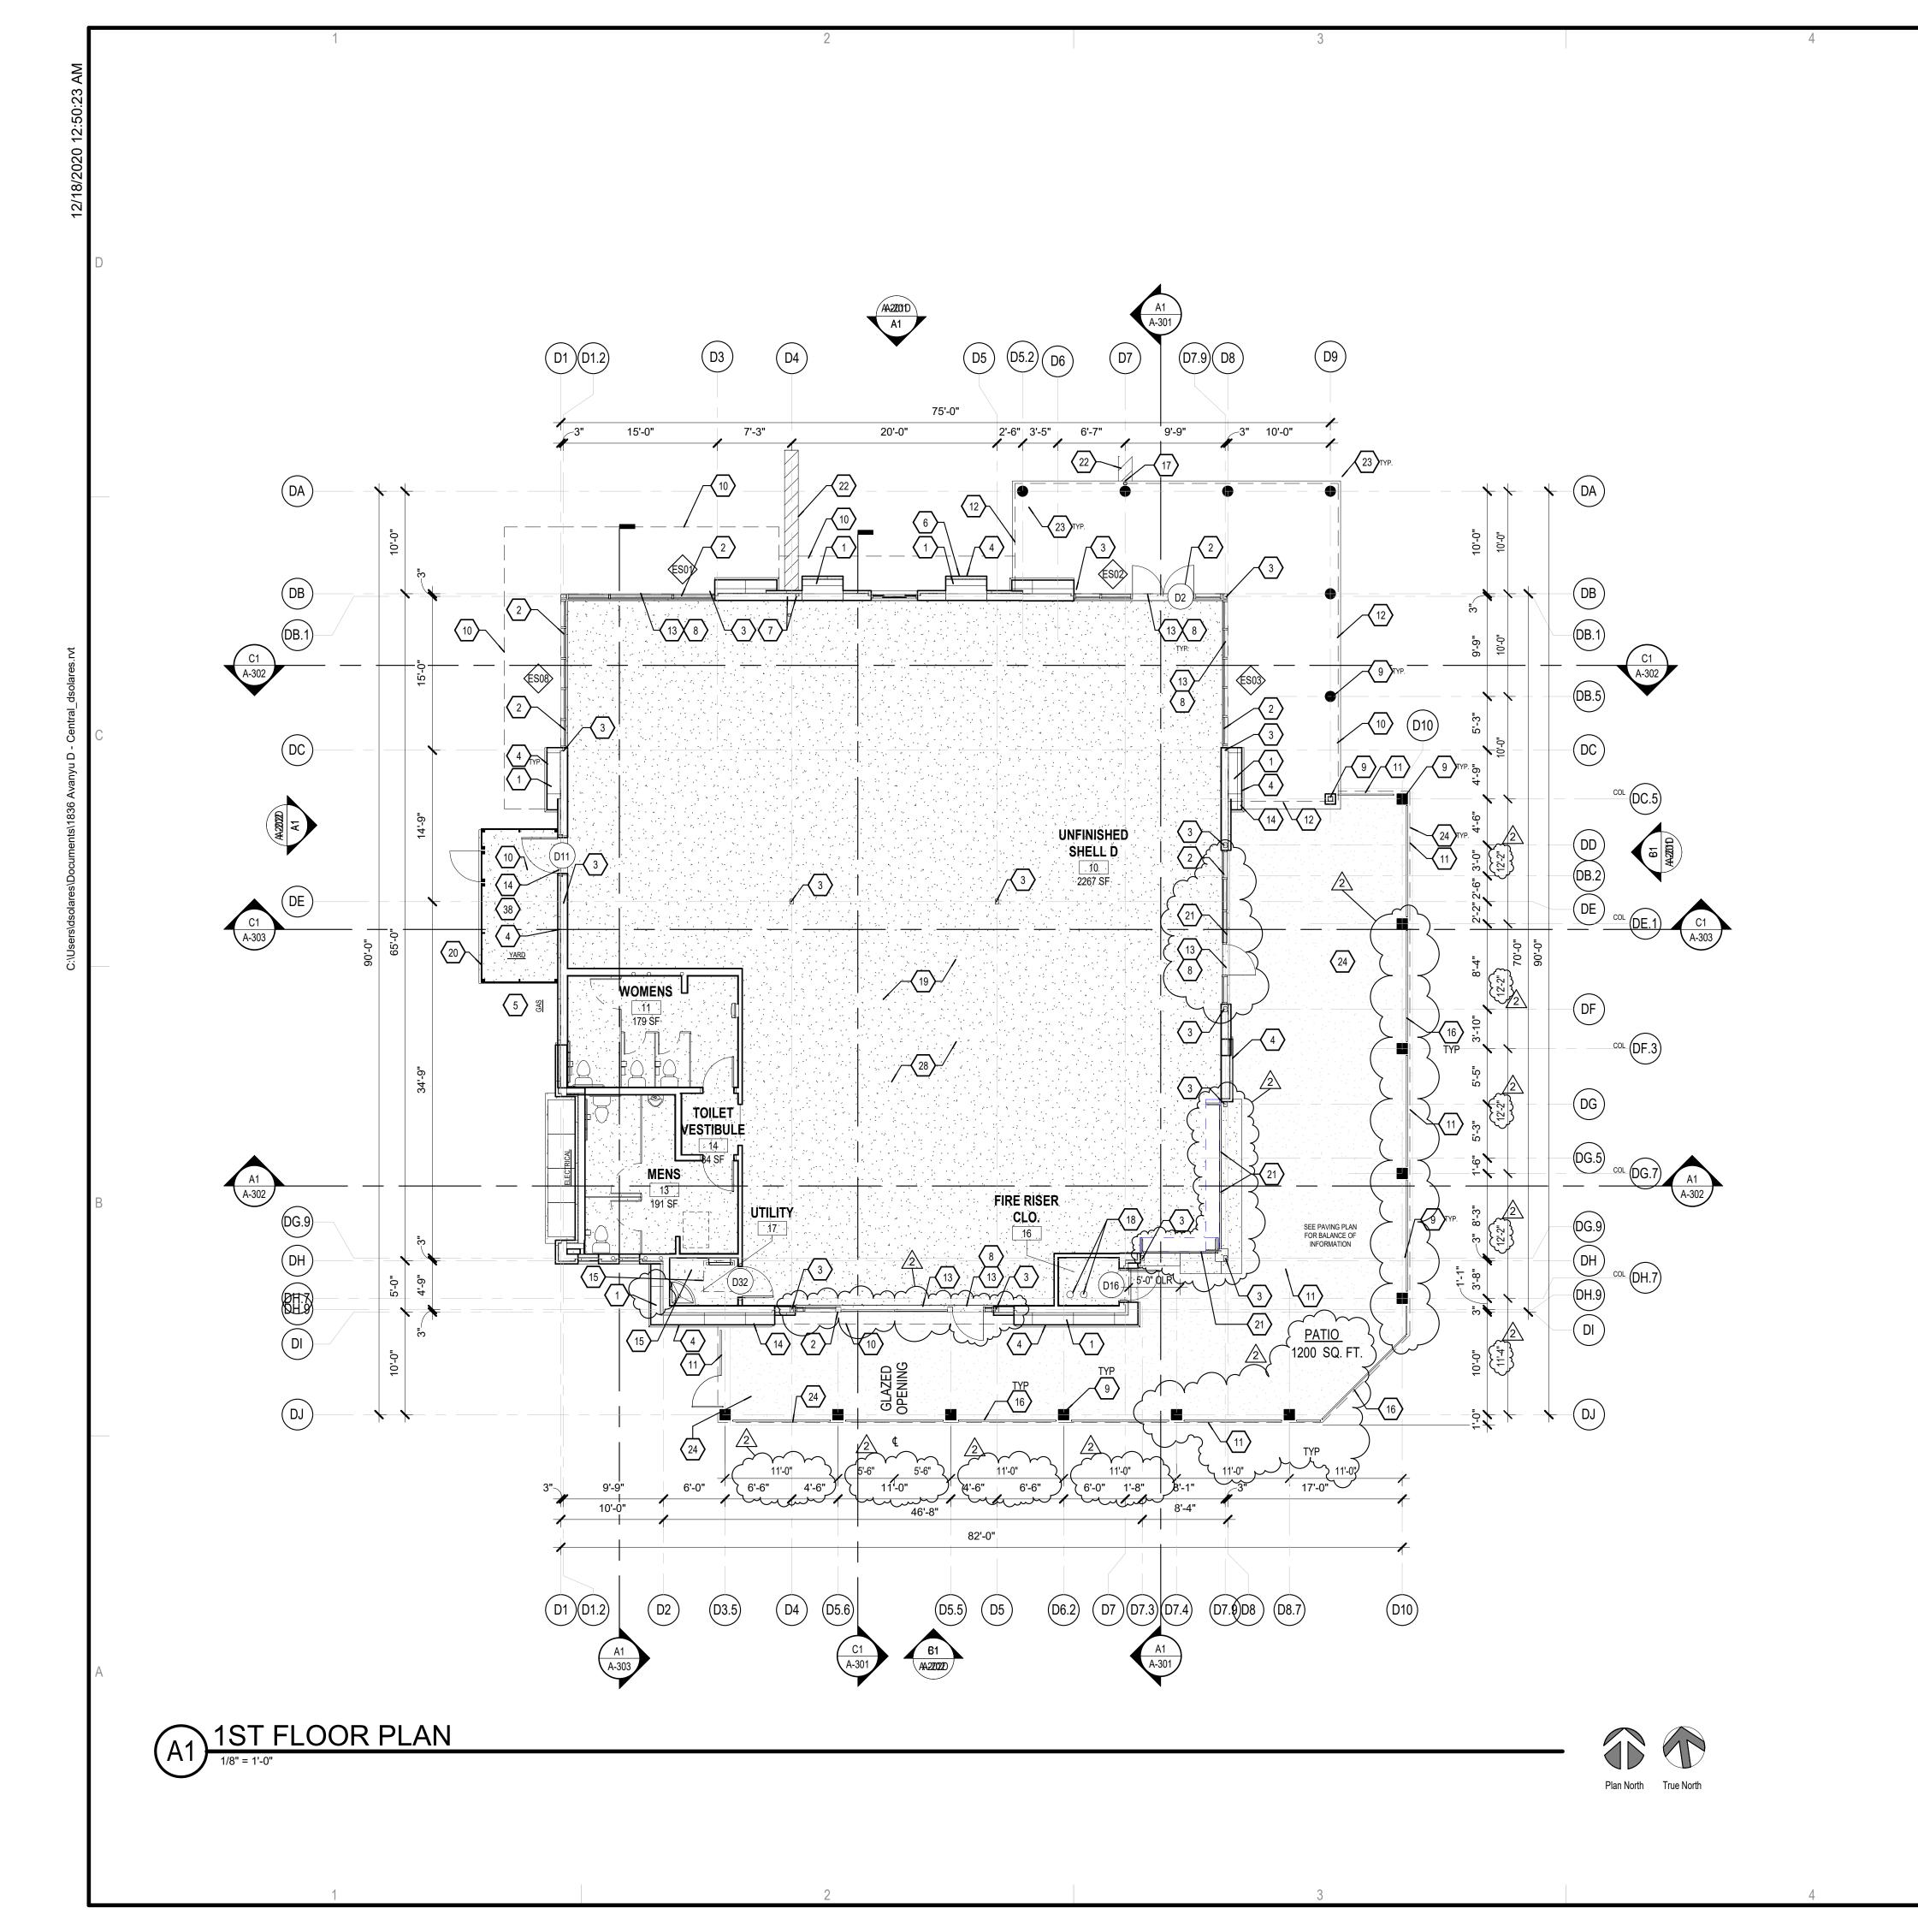



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GENERAL NOTES


- COORDINATE WITH MECHANICAL, ELECTRICAL & PLUMBING.
- B. UNLESS NOTED OTHERWISE, ALL INTERIOR DIMENSIONS ARE TO FACE OF STUD.
- UNLESS NOTED OTHERWISE, ALL EXTERIOR DIMENSIONS ARE TO FACE OF STUD.
- REFER TO ENLARGED PLANS FOR WALL TYPES AND DIMENSIONS WITHIN DETAILED AREAS
- COORDINATE FINAL LOCATION OF FIRE EXTINGUISHERS WITH FIRE MARSHAL.
- REFER TO A-601 FOR DOOR AND FRAME TYPES. FINAL DOOR LOCATIONS TBD WITH OCCUPANT.
- G. UNDER FLOOR UTILITIES COMPLETED IN TENANT IMPROVMENT.

KEYED NOTES (

- EXTERIOR WALL VARIES IN THICKNESS AND FORM REFER TO WALL SECTIONS AND ELEVATIONS FOR ADDL INFORMATION
- ALUMINUM STOREFRONT TYPICAL STEEL COLUMN TYPICAL , SEE STRUCTURAL.
- TWO COAT SYNTHETIC STUCCO W/CRACKMASTER OVER 1" RIGID INSULATION ADHERED TO 1/2" SHEATHING OVER 2X WOOD FURRING OVER WALL FRAMING (SEE WALL TYPES FOR ADDL. INFO.) GAS METER / UTILITY METER - SEE MECHANCIAL AND PLUMBING DRAWINGS
- KNOX BOX ROOF DRAIN AND OVERFLOW WITHIN WALL. TAKE ROOF DRAIN THROUGH STEM WALL TO CULVERT. COORDINATE CONCETE CULVERT TO ALIGN WITH OVERFLOW DRAIN. PROVIDE BRASS COW TONGUE AT OVERFLOW AND STEEL GRATE AND CULVERT.
- DOOR/GATE PER SCHEDULE WOOD COUMN - TYP
- OUTLINE OF ROOF STRUCTURE ABOVE
- OUTLINE OF SHADE STRUCTURE ABOVE. OUTLINE OF PORTAL ABOVE.
- PROVIDE ELECTRICAL AT ALL POTENTIAL EXITS FOR FUTURE EXIT SIGNAGE.
- KEY OPERATED TAMPER PROOF HOSE BIBB LOCATIN AT EXTERIOR WALL.
- OUTLINE OF ROOF ACCESS HATCH ABOVE. VERIFY FINAL LOCATION.
 PAINTED STEEL FENCE/ GUARDRAIL. REFER TO GUARDRAIL OPTIONS DETAILS C5, D5, E3, & E5 SHEET
- FACTORY PAINTED METAL DOWNSPOUT FIRE RISER LOCATION.COORDINATE.
- COORDINATE CONCRETE SLAB SAW CUT PATTERN, COLOR AND FINISH WITH ARCHITECT. SEE SLAB PLAN SHEET A-100 FOR ADDL. INFO.
- 6'-6" TALL YARDWALL .
- ROLL-UP DOOR TO MATCH ALUMINUM SF FINISH. CONCRETE CULVERT AND STEEL GRATE PER DETAIL
- CONCRETE FOOTING SEE STRUCTURAL. CONCRETE PATIO SLAB. SCORED W/INTERGRATED COLOR. SEE SHEET A-100 FOR ADDL. INFO.
- SANITARY PIPE PENETRATION TO TOILET FLOOR DRAIN AT TOILET ROOM - VERIFY WITH FUTURE T.I. TOILET ROOM PLAN
- EDGE OF PERIMETER STEM WALL SEE STRUCTURAL FOR BALANCE OF INFORMATION CONCRETE SLAB COORDINATE WITH TENANT IMPROVEMENTS DRAWINGS FOR FINAL PENETRATION

 BUILDING D
- LOCATIONS AND UNDERGROUND UTILITIES SEE STRUCTURAL FOR ADDITIONAL INFORMATION.
- POINT OF ORIGIN ALIGN WITH CENTER OF DOOR OPENING 10' X 10' SAW CUT CONTROL JOINT. REFER TO STRUCTURAL FOR DEPTH OF JOINT.
- RECESS AREA FOR FUTURE TILE.
- SLOPE TO DRAIN
 ELECTRICAL STUB UP PENETRATION
 PLUMBING STUB-UP PENETRATION
- FLOOR SINK LOCATION MOP SINK DRAIN. 38. OPTIONAL YARD

LEGEND

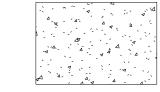

CONCRETE SLAB

Architect



Engineer

AVANYU NORTH -

2500 12th Street ALBUQUERQUE. NM AVANYU

Key Plan

12/1/2020 Modifications 08-31-2020 BD Comments Description

Revision Schedule

ISSUE: 1836 PROJECT NUMBER:

1836 Avanyu Bldg D R19 FILE: DRAWN BY: Author

CHECKED BY: Checker DATE: 07/08/2020

SHEET TITLE

BLDG D - FLOOR PLAN

A-101 D

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CONSULTANTS

Engineer

AVANYU

PLAZA

BUILDING MOUNTED SIGNS SHALL NOT EXCEED AN AREA OF 6 PERCENT OF THE FACADE. LOGO SIZE SHALL NOT EXCEED 5'X5' AND 2 FEET IN HEIGHT. 6 PERCENT OF THE AREA INCLUDES THE SIGNAGE AND THE LOGO. SIGNAGE IS NOT A PART OF THIS SUBMITTTAL. SEE DETAIL E6/A-501 FOR ADDL. INFO.

Architect

ADDRESS IDENIFICATION CENTERED ABOVE DOORWAY. LETTERING SHALL BE MINIMUM OF 12 INCHES HIGH WITH A MINIMUM BRUCH STOKE WIDTH OF 2 INCHES. STOREFRONT GLAZING SYSTEM.

BACK OF HOUSE EMPLOYEE ACESS. FUTURE SIGNAGE LOCATION. SEPARATE PERMIT REQUIRED. PROVIDE ELECTRICAL AT WALL.

KEYED NOTES

GENERAL NOTES

A. COORDINATE WITH MECHANICAL, ELECTRICAL & PLUMBING.

GRADE VARIES, REFER TO CIVIL FOR EXTERIROR FINISH GRADES.

FINAL DOOR LOCATIONS T.B.A. COORDINATE WITH FUTURE TENANT.

PAINTED DOWNSPOUT AND LEADER HEAD WITH OVERFLOW. SEE DETAIL METER LOCATION - EXPOSED LINES PAINTED TO MATCH EIFS COLOR CODE.

TRELLIS SHADE STRUCTURE. STEEL FENCE AT PATIO YARD PAINTED BLACK 42" TALL. EXIT ACCESS GATE ONLY WITH PANIC HARDWARE.

WOOD COLUMN. BRASS COW TONGUE AT WALL. FOR OVERFLOW DRAIN. ALUMINUM EYEBROW AT WINDOW

TWO COAT SYNTHETIC STUCCO W/CRACKMASTER OVER 1" RIGI ISNUALTIONA ADHERED TO 1/2" SHEATHING OVER 2X WOOD FURRING OVER WALL FRAMING (SEE WALL TYPES FOR ADDL. INFO.) EXTERIOR WALL VARIES IN THICKNESS AND FORM REFER TO WALL SECTIONS FOR ADDL

WOOD BEAM ROOF DRAIN AND OVERFLOW AT PORTAL - INSTALL SPLASH BLOCK BELOW. PAINTED METAL COPING.

(22.) OPERABLE GLAZING / ROLL UP - GARAGE DOOR TYPE

LEGEND



EXTERIOR INSULATING AND FINISH SYSTEM

EXTERIOR INSULATING

EL REY STUCCO COLOR -BUCKSKIN T020L (45)

AND FINISH SYSTEM

MATERIALS AND COLORS

REQUIRED GLAZING

TOTAL FACADE AREA FACING PLAZA: 1,020 SF

40% MIN. OF AREA REQUIRED TO BE GLAZED: 408 SF TOTAL PROPOSED AREA OF GLAZING

FACING PLAZA: 410 SF (40%)

EL REY STUCCO COLOR -

COLORS SHOWN ARE IPFDC AND SSWA APPROVED. FINISHES AND COLORS ON ELEVATIONS ARE FOR REFERENCE ONLY.

REFER TO ELEVATIONS FOR PANEL DIMENSIONS

CONCRETE

2500 12th Street ALBUQUERQUE. NM

BUILDING D

Key Plan

NTS

2 12/1/2020 Modifications Date Description Revision Schedule


ISSUE: BID 1836 PROJECT NUMBER: FILE: 1836 Avanyu Bldg D R19 DRAWN BY: Author

CHECKED BY: Checker 07/08/2020 DATE:

SHEET TITLE

EXTERIOR BUILDING **ELEVATIONS**

A-201D

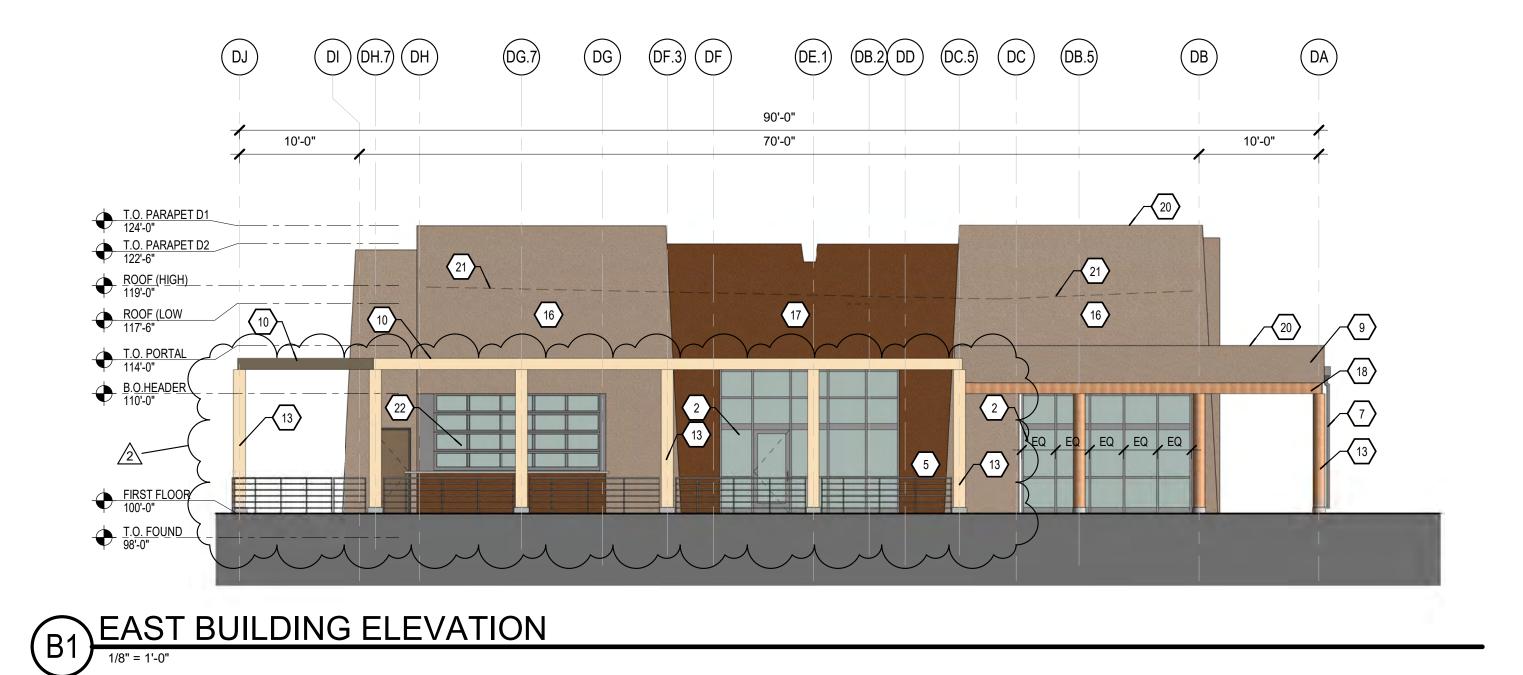



NORTH BUILDING ELEVATION

1/8" = 1'-0"

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CONSULTANTS

GENERAL NOTES

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- FINAL DOOR LOCATIONS T.B.A. COORDINATE WITH FUTURE TENANT.
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KEYED NOTES

- ADDRESS IDENIFICATION CENTERED ABOVE DOORWAY. LETTERING SHALL BE MINIMUM OF 12 INCHES HIGH WITH A MINIMUM BRUCH STOKE WIDTH OF 2 INCHES. STOREFRONT GLAZING SYSTEM.
- BACK OF HOUSE EMPLOYEE ACESS. FUTURE SIGNAGE LOCATION. SEPARATE PERMIT REQUIRED. PROVIDE ELECTRICAL AT WALL.
- PAINTED DOWNSPOUT AND LEADER HEAD WITH OVERFLOW. SEE DETAIL]
- METER LOCATION EXPOSED LINES PAINTED TO MATCH EIFS COLOR CODE. PORTAL TRELLIS SHADE STRUCTURE.
- EXIT ACCESS GATE ONLY WITH PANIC HARDWARE. WOOD COLUMN. BRASS COW TONGUE AT WALL. FOR OVERFLOW DRAIN.

STEEL FENCE AT PATIO YARD PAINTED BLACK 42" TALL.

- ALUMINUM EYEBROW AT WINDOW TWO COAT SYNTHETIC STUCCO W/CRACKMASTER OVER 1" RIGI ISNUALTIONA ADHERED TO 1/2" SHEATHING OVER 2X WOOD FURRING OVER WALL FRAMING (SEE WALL TYPES FOR ADDL. INFO.)
- EXTERIOR WALL VARIES IN THICKNESS AND FORM REFER TO WALL SECTIONS FOR ADDL INFORMATION WOOD BEAM
- ROOF DRAIN AND OVERFLOW AT PORTAL INSTALL SPLASH BLOCK BELOW. PAINTED METAL COPING.

(22.) OPERABLE GLAZING / ROLL UP - GARAGE DOOR TYPE

LEGEND



EXTERIOR INSULATING AND FINISH SYSTEM

EL REY STUCCO COLOR -RAWHIDE T022L (34)

BUCKSKIN T020L (45)

EXTERIOR INSULATING AND FINISH SYSTEM EL REY STUCCO COLOR - FOR PANEL DIMENSIONS

CONCRETE

MATERIALS AND COLORS

COLORS SHOWN ARE IPFDC AND SSWA APPROVED.
FINISHES AND COLORS ON ELEVATIONS ARE FOR REFERENCE ONLY.

REQUIRED GLAZING

TOTAL FACADE AREA FACING PLAZA: 1,020 SF 40% MIN. OF AREA REQUIRED TO BE GLAZED: 408 SF TOTAL PROPOSED AREA OF GLAZING FACING PLAZA: 410 SF (40%)

Architect Engineer



METAL PANEL REFER TO ELEVATIONS AVANYU NORTH -BUILDING D **AVANYU**

2500 12th Street ALBUQUERQUE. NM



Key Plan

NTS

No	Date	Description
Revision Schedule		
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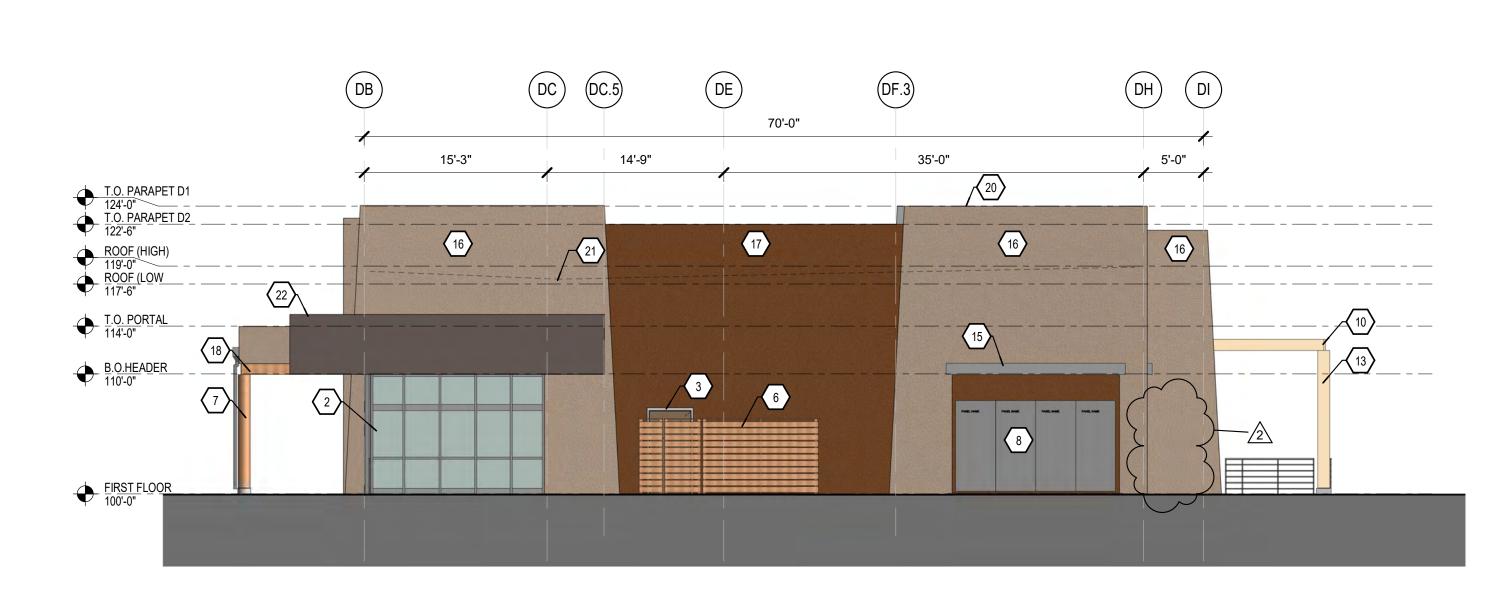
2 | 12/1/2020 | Modifications

ISSUE: BID 1836 PROJECT NUMBER: 1836 Avanyu Bldg D R19 FILE: DRAWN BY: Author CHECKED BY: Checker 07/08/2020 DATE:

SHEET TITLE

EXTERIOR BUILDING ELEVATIONS

A-202D



D4 D5.6

65'-0"

(D10)

13

WEST BUILDING ELEVATION

1/8" = 1'-0"

T.O. PARAPET D1 124'-0"

T.O. PARAPET D2 122'-6"

ROOF (HIGH) 119'-0"

ROOF (LOW _ _ -

FIRST FLOOR 100'-0" T.O. FOUND 98'-0"

SOUTH BUILDING ELEVATION

1/8" = 1'-0"