



DEVELOPMENT REVIEW APPLICATION

Effective 4/17/19

| Please check the appropriate box and re | fer to supple | mental forms for sub | mittal requirements. All fee | es must | be paid at the time of | application. |
|--|--|--|------------------------------|---|---------------------------|------------------------------|
| Administrative Decisions | Deci | sions Requiring a Pu | blic Meeting or Hearing | Policy | Decisions | |
| ☐ Archaeological Certificate (Form P3) | | te Plan – EPC includin n P1) | g any Variances – EPC | ☐ Adoption or Amendment of Comprehensive Plan or Facility Plan (Form Z) | | |
| ☐ Historic Certificate of Appropriateness – (Form L) | Minor | aster Development Pla | n <i>(Form P1)</i> | ☐ Adoption or Amendment of Historic Designation (Form L) | | |
| ☐ Alternative Signage Plan (Form P3) | □ Hi (Forr | storic Certificate of Appen 1.) | oropriateness – Major | □ Ame | endment of IDO Text (Fo | orm Z) |
| Minor Amendment to Site Plan (Form P3 | 3) 🗆 De | emolition Outside of HF | PO (Form L) | □ Ann | exation of Land (Form 2 | Z) |
| ☐ WTF Approval (Form W1) | □ Hi | storic Design Standard | ds and Guidelines (Form L) | □ Ame | endment to Zoning Map | – EPC (Form Z) |
| | | ireless Telecommunica m W2) | ations Facility Waiver | □ Ame | endment to Zoning Map | - Council (Form Z) |
| | | | | | | |
| | | | | Appea | ls | |
| | | | | □ Dec A) | ision by EPC, LC, ZHE | , or City Staff <i>(Form</i> |
| APPLICATION INFORMATION | | | | | | |
| Applicant: KMD Albuquerque LI | | | | | one:214.235.0367 | |
| Address: 2424 N. Federal Hw | y #101 | | | | nail: jake@9milein | vestments.com |
| City: Boca Raton | | | State: FL | Zip | : 33431 | |
| Professional/Agent (if any): CUMULUS | DESIGN | | | Phone: 214.235.0367 | | |
| Address: 2080 North Highwa | ıy 360 Su | iite #240 | | Em | usdesign.net | |
| City: Grand Prairie | | | State: Texas | Zip | _: 75050 | |
| Proprietary Interest in Site: | | | List all owners: | | | |
| BRIEF DESCRIPTION OF REQUEST | | | | | | |
| The current plan is to redeve | lop the si | te into a Financi | al Center with drive | -up atm | n. Made Site re-co | nfigurations. |
| Relocated dumpster and rotate | d ATM driv | e-up 180 degrees. | Remainder of site re | emained | d the same. | |
| SITE INFORMATION (Accuracy of the ex | isting legal d | escription is crucial! | Attach a separate sheet if | necessa | ıry.) | |
| Lot or Tract No.: TRACT 1-D-1A1 | | | Block: | Un | | |
| Subdivision/Addition: PARK SQUARE ADDI | TION | | MRGCD Map No.: | UP | C Code: 1018058507 | 751811622 |
| Zone Atlas Page(s): J-18 | Е | xisting Zoning: MX-H | | Proposed Zoning: MX-H | | |
| # of Existing Lots: 1 | # | of Proposed Lots: 1 | | Tot | tal Area of Site (acres): | 0.762 |
| LOCATION OF PROPERTY BY STREETS | • | | | - | | |
| Site Address/Street: 6670 INDIAN SCHOO | L RD NE B | Between: LOUISIAN | IA BLVD | and: A | MERICAS PKWY | |
| CASE HISTORY (List any current or prior | r project and | case number(s) that | may be relevant to your re | quest.) | | |
| EPC-1008660, 1008660, Z-14 | 161, V-8949 |) | | | | |
| Signature: Carlos Iglesias | Digitally signed by Carlos Iglesias DN: cn=Carlos Iglesias, o=Cumulus I Date: 2021.07.15 17:26:44-05'00' | Design, ou, email-carlos@cumulusdesign.net, c=US | | Da | te: 07/15/2021 | |
| Printed Name: CARLOS IGLESIA | S | | | | Applicant or 🗹 Agent | |
| FOR OFFICIAL USE ONLY | | | | | | |
| Case Numbers | Action | Fees | Case Numbers | | Action | Fees |
| SI-2021-01129 | AA | | | | | |
| | | | | | | |
| | | | | | | |
| Meeting/Hearing Date: | | • | ı | Fee | e Total: | |
| Staff Signature: | | | Date: | Project # PR-2020-004864 | | |

FORM P3: ADMINISTRATIVE DECISIONS AND MINOR AMENDMENTS

A single PDF file of the complete application including all plans and documents being submitted must be emailed to PLNDRS@cabq.gov prior to making a submittal. Zipped files or those over 9 MB cannot be delivered via email, in which case the PDF must be provided on a CD. INFORMATION REQUIRED FOR ALL ADMINISTRATIVE DECISIONS OR AMENDMENTS Letter of authorization from the property owner if application is submitted by an agent Zone Atlas map with the entire site clearly outlined and labeled ARCHEOLOGICAL CERTIFICATE Archaeological Compliance Documentation Form with property information section completed Only the information above is required unless the City Archaeologist determines that the application does not qualify for a Certificate of No Effect, in which case a treatment plan prepared by a qualified archaeologist that adequately mitigates any archeological impacts of the proposed development must be submitted and reviewed for a Certificate of Approval per the criteria in IDO Section 14-16-6-5(A)(3)(b) MINOR AMENDMENT TO SITE PLAN - ADMIN, EPC, or DRB Justification letter describing, explaining, and justifying the request per the criteria in IDO Section 14-16-6-4(X)(2) Three (3) copies of all applicable sheets of the approved Site Plan being amended, folded Copy of the Official Notice of Decision associated with the prior approval Three (3) copies of the proposed Site Plan, with changes circled and noted Refer to the Site Plan Checklist for information needed on the proposed Site Plan. Minor Amendments must be within the thresholds established in IDO TABLE 6-4-5. Any amendment beyond these thresholds is considered a Major Amendment and must be processed through the original decision-making body for the request. MINOR AMENDMENT TO SITE DEVELOPMENT PLAN APPROVED PRIOR TO THE EFFECTIVE DATE OF THE IDO ___ Justification letter describing, explaining, and justifying the request per the criteria in IDO Section 14-16-6-4(Y)(1)(a) Three (3) copies of all applicable sheets of the approved Site Development Plan being amended, folded Copy of the Official Notice of Decision associated with the prior approval Three (3) copies of the proposed Site Development Plan, with changes circled and noted Refer to the Site Plan Checklist for information needed on the proposed Site Plan. Minor Amendments must be within the thresholds established in IDO TABLE 6-4-5. Any amendment beyond these thresholds is considered a Major Amendment and must be processed through the original decision-making body for the request. **ALTERNATIVE SIGNAGE PLAN** Proposed Alternative Signage Plan compliant with IDO Section 14-16-5-12(F)(5) Justification letter describing, explaining, and justifying the request per the criteria in IDO Section 14-16-6-5(F)(4)(c) Required notices with content per IDO Section 14-16-6-4(K)(6) Office of Neighborhood Coordination notice inquiry response and proof of emailed notice to affected Neighborhood Association representatives Sign Posting Agreement **ALTERNATIVE LANDSCAPE PLAN** Justification letter describing, explaining, and justifying the request per the criteria in IDO Section 14-16-5-6(C)(16) Landscape Plan

| | at if any required information is not submitted with this a g, if required, or otherwise processed until it is complete. | |
|-------------------------------|---|------------------------|
| signature: Carlos Iglesias | Digitally signed by Carlos Iglesias Dit. cm-Carlos Iglesias, o-Camulus Design, ou, email-carlos@cumulusdesign.net, c=US Dite: 2011.01.3 17 323-11 - 2010 07 07 07 07 07 07 07 07 07 07 07 07 07 | Date: |
| Printed Name: CARLOS IGLESIAS | | □ Applicant or ☑ Agent |
| FOR OFFICIAL USE ONLY | | |
| Project Number: | Case Numbers | |
| PR-2020-004864 | SI-2021-01129 | |
| | - | |
| | - | 1706 |
| Staff Signature: | | MEX |
| Date: | | AAAAAA |

| Project #: | Application #: | |
|------------|----------------|--|
|------------|----------------|--|

This checklist will be used to verify the completeness of site plans submitted for review by the Planning Department. Because development proposals vary in type and scale, there may be submittal requirements that are not specified here. Also there may additional requirements if a site is located in CPO, HPO, and/or VPO or if located in DT-UC-MS or PT areas. See the IDO or AGIS for boundaries. Nonetheless, applicants are responsible for providing a complete submittal. Certification as specified below is required.

I CERTIFY THAT THE SUBMITTED SITE PLAN IS COMPLETE AND ACCURATE, AND THAT ALL APPLICABLE INFORMATION AS SPECIFIED IN THIS CHECKLIST IS PROVIDED. FURTHER. I UNDERSTAND THAT THIS APPLICATION IS BEING ACCEPTED PROVISIONALLY AND THAT INACCURATE AND/OR INCOMPLETE INFORMATION MAY RESULT IN THE SUBSEQUENT REJECTION OF THE APPLICATION OR IN

A DELAY OF ONE MONTH OR MORE IN THE DATE THE APPLICATION IS SCHEDULED FOR PUBLIC HEARING.

Digitally signed by Carlos Iglesias Carlos Iglesias DN: cn=Carlos Iglesias, o=Cumulus Design, ou, email=carlos@cumulusdesign.net, c=US Date: 2021.07.15 17:36:28 -05'00'

Applicant or Agent Signature / Date

Site plan packets shall be composed of the following plan sheets (unless otherwise approved in writing prior to submittal by the Planning Department):

- **Site Plan (**including utilities and easements)
- 2. Landscaping Plan
- **Grading and Drainage Plan** 3.
- **Utility Plan** 4.
- **Building and Structure Elevations** 5.
- Previously approved Development Plan (if applicable) 6

The electronic format must be organized in the above manner.

The following checklist describes the minimum information necessary for each plan element. The Applicant must include all checklist items on their site plan drawings and confirm inclusion by checking off the items below. Non-applicable items must be labeled "N/A." Each non-applicable designation must be explained by notation on the Checklist.

NOTE: There may be addition information required if site is located with a CPO, VPO or HPO and/or any other special areas as defined by the IDO.

NOTE: If there requests for deviations (Section 14-16-6-4(O), they must be clearly labelled on the site plan (Sheet 1) as well as addressed in the application letter made with the submittal.

SHEET #1 - SITE PLAN


A. General Information

Date of drawing and/or last revision Scale: 1.0 acre or less 1" = 10' 1" = 20' 1.0 - 5.0 acres Over 5 acres 1" = 50'

Over 20 acres 1" = 100

Bar scale ✓ 4. North arrow Legend <u>√</u> 6. Scaled vicinity map Property lines (clearly identify) ✓ 8. Existing and proposed easements (identify each) Phases of development, if applicable B. Proposed Development 1. Structural Location of existing and proposed structures (distinguish between existing & proposed) and include any accessory structures Square footage of each structure Proposed use of each structure Signs (freestanding) and other improvements √ E. Walls, fences, and screening: indicate height, length, color and materials √ √ √ G. Dimensions of all principal site elements or typical dimensions Loading facilities <u>√</u>H. Site lighting (indicate height & fixture type) √ I. Indicate structures within 20 feet of site ✓ J. Elevation drawing of refuse container and enclosure, if applicable. √_K. Existing zoning/land use of all abutting properties 2. Parking, Loading and Internal Circulation <u>√</u> A. Parking layout with spaces numbered per aisle and totaled. Location and typical dimensions, including motorcycle spaces, bicycle spaces, ADA accessible spaces, and compact spaces Calculations: spaces required and proposed (include any reduction calculations) for motorcycle, bicycle, compact and ADA spaces <u>√</u>_3. On street parking spaces Bicycle parking & facilities **√** 1. Bicycle racks – location and detail Other bicycle facilities, if applicable √ C. Vehicular Circulation (Refer to DPM and IDO) Ingress and egress locations, including width and curve radii dimensions Drive aisle locations, including width and curve radii dimensions End aisle locations, including width and curve radii dimensions Location & orientation of refuse enclosure, with dimensions Loading, service area, and refuse service locations and dimensions ✓ D. Pedestrian Circulation <u>√</u> 1. Location and dimensions of all sidewalks and pedestrian paths (including ADA

connection from ROW to building and from ADA parking to building)

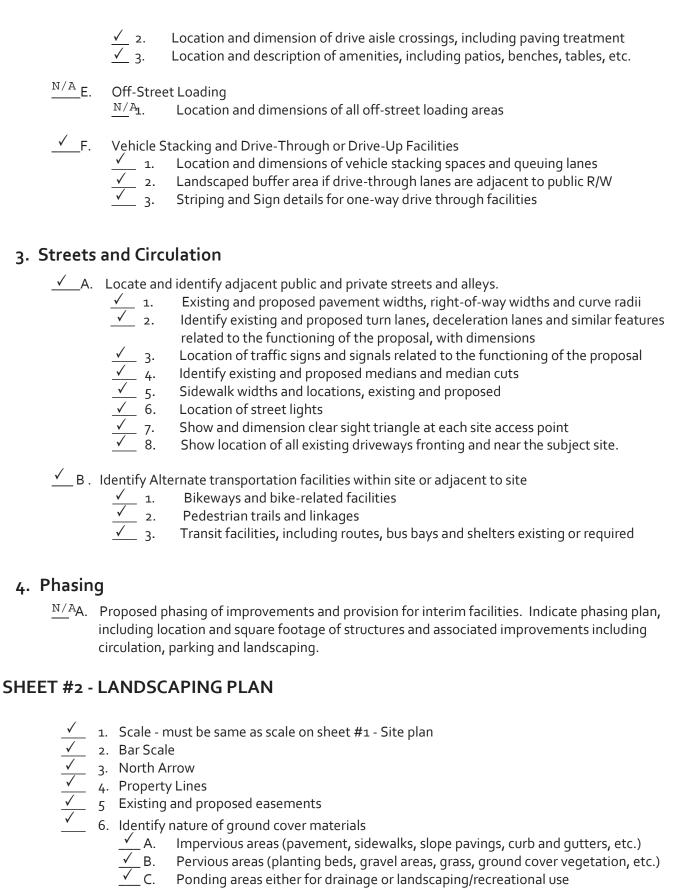

| <u> </u> | 7. Identify type, location and size of plantings (common and/or botanical names). |
|------------------|---|
| | ✓ A. Existing, indicating whether it is to preserved or removed. |
| | B. Proposed, to be established for general landscaping. |
| | A. Existing, indicating whether it is to preserved or removed. B. Proposed, to be established for general landscaping. C. Proposed, to be established for screening/buffering. |
| <u> </u> | B. Describe irrigation system – Phase I & II 9. Planting Beds, indicating square footage of each bed o. Turf Area - only 20% of landscaped area can be high water turf; provide square footage and |
| √ 9 | 9. Planting Beds, indicating square footage of each bed |
| | percentage. |
| 1 | Responsibility for Maintenance (statement) |
| <u>√</u> 1 | 2. Landscaped area requirement; square footage and percent (specify clearly on plan) |
| | Responsibility for Maintenance (statement) Landscaped area requirement; square footage and percent (specify clearly on plan) Landscaped buffer areas provided; dimensions, label clearly that it is a landscape buffer, square footage and percent (specify clearly on plan) |
| 1 | 4. Planting or tree well detail |
| 1 | 4. Planting or tree well detail 5. Street Trees (only trees from the Official Albuquerque Plant Palette and Sizing list or 8 inch caliper or larger will be counted) |
| <u> </u> | 6. Parking lot edges and interior – calculations, dimensions and locations including tree |
| | requirements |
| <u> </u> | 7. Show Edge Buffer Landscaping (14-16-5-6(D)) — location, dimensions and plant material |
| prior to the DRI | ling and drainage plan (and drainage report) must be submitted to the DRS Hydrology Section 3 submittal for a site plan (See DRWS Form). Information 1. Scale - must be same as Sheet #1 - Site Plan 2. Bar Scale 3. North Arrow 4. Property Lines 5. Existing and proposed easements 6. Building footprints 7. Location of Retaining walls |
| <u>√</u> | 7. Location of Retaining walls |
| | Information |
| ✓ | 1. On the plan sheet, provide a narrative description of existing site topography, proposed |
| | grading improvements and topography within 100 feet of the site. |
| ✓ | 2. Indicate finished floor elevation and provide spot elevations for all corners of the site (existing and proposed) and points of maximum cut or fill exceeding 1 foot. |
| ✓ | 3. Identify ponding areas, erosion and sediment control facilities. |
| \checkmark | 4. Cross Sections |
| | Provide cross section for all perimeter property lines where the grade change is greater than 4 feet at the point of the greatest grade change. Provide one additional cross section in each |

direction within no more than 100 feet of the reference point.

SHEET #4- UTILITY PLAN

✓ A. Fire hydrant locations, existing and proposed. (or submit signed off Fire One Plan) B. Distribution lines

C. Right-of-Way and easements, existing and proposed, on the property and adjacent to the boundaries, with identification of types and dimensions. _____ D. Existing water, sewer, storm drainage facilities (public and/or private). E. Proposed water, sewer, storm drainage facilities (public and/or private)

SHEET #5 - BUILDING AND STRUCTURE ELEVATIONS

A. General Information


Scale Bar Scale Detailed Building Elevations for each facade ✓ 1. Identify facade orientation Dimensions of facade elements, including overall height and v
 Location, material and colors of windows, doors and framing
 Materials and colors of all building elements and structures _ 2. Dimensions of facade elements, including overall height and width _4. Materials and colors of all building elements and structures Location and dimensions of mechanical equipment (roof and/or ground mounted)

B. Building Mounted Signage

✓ 1. Site location(s)
 ✓ 2. Sign elevations to scale
 ✓ 3. Dimensions, including height and width
 ✓ 4. Sign face area - dimensions and square footage clearly indicated
 ✓ 5. Lighting
 ✓ 6. Materials and colors for sign face and structural elements.
 ✓ 7. List the sign restrictions per the IDO



For more current information and details visit: www.cabq.gov/gis

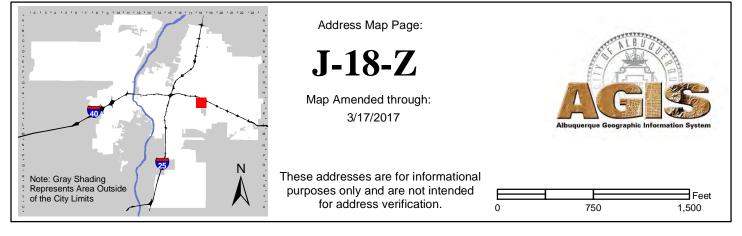



July 15, 2021

Planning Department City of Albuquerque 600 2nd Street NW Albuquerque NM 87102

RE: Justification Letter 6670 Indian School Rd NE Albuquerque, NM 87110

Dear Sir or Madam.

Please accept this letter as a request for approval of an Administrative Amendment to the Park Square Site Development Plan for Building Permit for the Construction of a Chase Bank at 6670 Indian School Rd NE Albuquerque, NM. As explained below and demonstrated with the submitted plans, we believe this request is within the thresholds of a minor amendment approval since the change meets all of the original requirements of the approved SDP for Park Square, the proposed bank building gross square footage is 63.9% less than the originally approved gross square footage for the Pier 1 Imports building, and the new bank building also meets the current design requirements of the Integrated Development Ordinance for Urban Centers and the Development Process Manual.

The intent is to redevelop the existing abandoned Pier 1 Imports retail store into a Financial Center with one drive-up ATM. The existing 0.762-acre site is fully developed and has a 9,332 S.F. one-story building, with 32 parking spaces to include two ADA accessible parking spaces.

The client intends to demolish the existing structure and convert the site into a 3,361 S.F. one-story Financial Center with one ATM drive-thru lane. The site will be modified to meet current codes for parking, ADA accessibility, lighting, etc. When completed, the site will provide 35 parking spaces with two ADA accessible space, two-motorcycle parking spaces and a bicycle rack that can accommodate six bicycles. The client is also adding an ADA access ramp along Indian School Road NE and Louisiana Boulevard.

The project has an approved Administrative Amendment to the Site Plan dated 4/19/2021. We have made some site modifications requested by the developer. The new site plan relocated the dumpster enclosure to the vicinity of the South-West corner of the building. We also modified and rotated the drive-up ATM 180-degrees. The city of Albuquerque Solid Waste and Planning Department has reviewed and approved the site modifications for Solid Waste, Traffic Circulation Layout and Hydrology.

The Administrative Amendment submittal seeks elevations approval for the proposed Chase Bank building. The façade elements meet or exceed original approved Site Plan for Pier 1 Imports and comply

with the URBAN CENTER (UC) regulation of the IDO. Additionally, we seek approval for signage elevations for the proposed Chase Bank.

Thank you in advance for your review and consideration. Should you have any questions or need additional information, contact me at carlos@cumulusdesign.net or by phone at 214.235.0367 ext:101.


| Sincerely, | | | | |
|------------|--|--|--------|-----------|
| Signature: | Carlos Iglesias DN: cn=Carlos Iglesias, o=Cumulus Design, ou, email=carlos@cumulusdesign.net, c=US Date: 2021.07.16 07:49:50 -05'00' | | Date:_ | 7/15/2021 |
| _ | Carlos J. Iglesias | | | |

A permit, license, or certificate inadvertently issued in conflict with the provisions of the Zoning Code or other City ordinances, rules or regulations is null and void. See, e.g., § 14-16-4-5, ROA 1994, § 6-5-3-6, ROA 1994, § 14-5-1-15, ROA 1994, § 14-6-5 (B), ROA 1004, and others. Also, a permit, license, or certificate issued based upon false or materially incorrect statement or omission in the application is null and void.

The undersigned has express authority from the owner to obtain this permit and is acting as the owner's agent in obtaining this permit:

I HAVE READ THE ABOVE AND HERE BY AGREE TO ACCEPT THE RESPONSIBILITY FOR ANY CHANGES IN CONSTRUCTION NECESSARY TO MEET ALL CITY OF ALBUQUERQUE CODE OR ORDINANCE REQUIREMENTS AFTER PLAN CHECKING HAS BEEN COMPLETED.

| PROJECT: CHASE BANK | |
|--|--|
| PROJECT ADDRESS: 2125 LOUIS JANA | BLYP, NE |
| OWNER: KMD ALBUQUERQUE LLC | |
| ARCHITECT: ROUCH ARCHITECTS | |
| CONTRACTOR: JMSTITT CONSTRUC | |
| SIGNATURE OF OWNER/AGENT Mack O. Threk | DATE: 2/26/2021 |
| STATE OF NEW MEXICO CITY OF ALBUQUERQUE | |
| SUBSCRIBED AND SWORN TO before me on this | |
| 26 day of February, 20 21 | |
| Notary Public | KARLA FERNANDEZ Notary ID #131304248 My Commission Expires October 4, 2021 |
| My commission expires: D/4/0021 | |

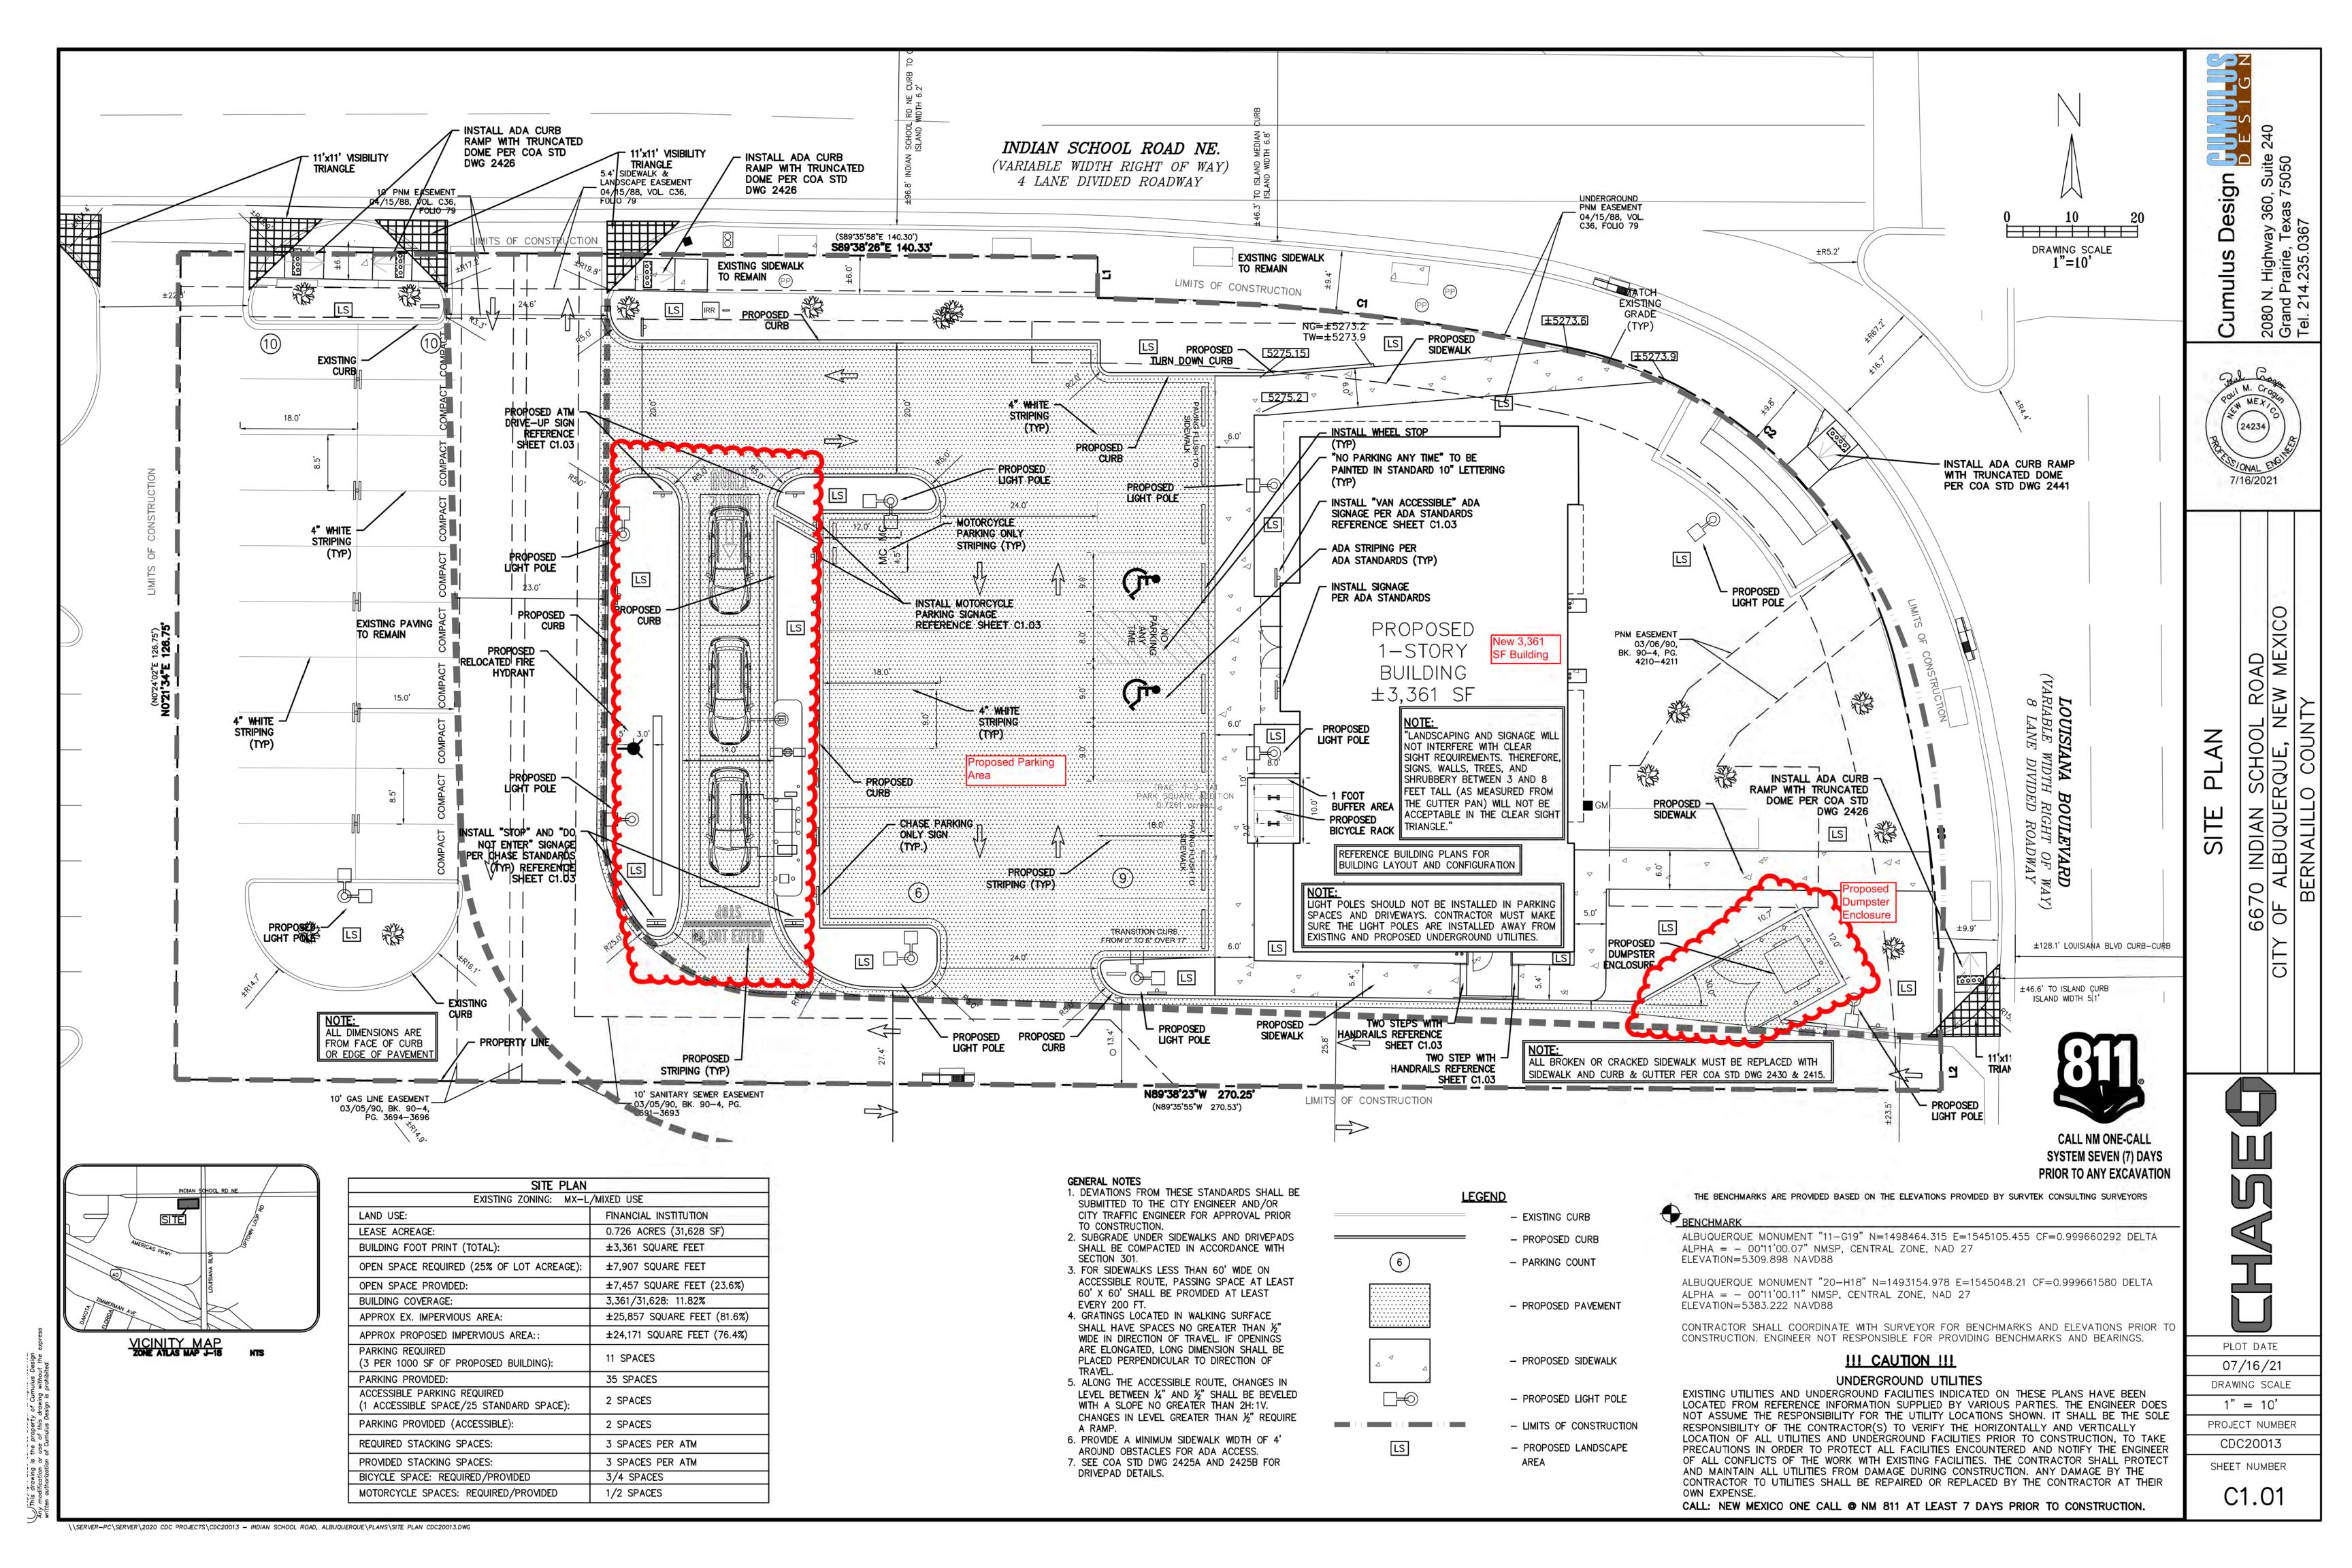



PLANT MATERIAL LIST


| VEV | OLIANITITY! | ORNAMENTAL TREES DESCRIPTION | CIZE | |
|------------|-------------|--|-------------------------------|--|
| <u>KEY</u> | QUANTITY | | SIZE | |
| DW | 2 | CHILOPSIS LINEARIS 'BUBBA' DESERT WILLOW | 30 GAL., 8' HT., 3' SPREAD | |
| | | | | |
| RB | 4 | CERCIS CANADENSIS 'OKLAHOMA' | 30 GAL., 8' HT., | |
| | | REDBUD | 3' SPREAD | |
| VAC | 1 1 | VITEX AGNUS-CASTUS 'SHOAL CREEK' | 30 GAL., 8' HT., | |
| | | SHOAL CREEK VITEX | 3' SPREAD | |
| 14514 | OLIANITITY! | SHRUBS | 6175 | |
| <u>KEY</u> | QUANTITY | DESCRIPTION | SIZE | |
| DS | 7 | DASYLIRION TEXANUM | 5 0 4 1 4 4 5 11 1 1 7 | |
| | | GREEN DESERT SPOON | 5 GAL., MIN. 15" HT. | |
| BM | 1 1 | CARYOPTERIS X CLANDONENSIS 'DARK | | |
| | - | KNIGHT' BLUE MIST | 5 GAL., MIN. 15" HT. | |
| GC | 25 | COTONEASTER BUXIFOLIUS | | |
| GC | | GRAY COTONEASTER | 5 GAL., MIN. 15" HT. | |
| NRS | 7 | ILEX X 'NELLIE R. STEVENS' | 30 GAL., 5' HT., | |
| INKO | ' | NELLIE R. STEVENS HOLLY | 3' SPREAD | |
| TC | | LEUCOPHYLLUM LANGMANIAE | | |
| TS | 11 | TEXAS SAGE 'LYNN'S LEGACY' | 5 GAL., MIN. 15" HT. | |
| | | HESPERALOE PARVIFOLIA | | |
| RY | 7 | RED YUCCA | 3 GAL., MIN. 10" HT. | |
| | | SCUTELLARIA SUFFRUTESCENS | | |
| SC | 33 | PINK SKULLCAP | 5 GAL., MIN. 15" HT. | |
| | | SALVIA X 'ULTRA VIOLET' | 3 37 (2.) (1111) | |
| SG | 14 | ULTRA VIOLET SAGE | 5 GAL., MIN. 15" HT. | |
| | | CAESALPINIA GILLIESII | J GAL., WIIIV. 13 TIT. | |
| YBP | 3 | YELLOW BIRD OF PARADISE | 10 GAL., MIN. 36" HT. | |
| | | AGAVE OVATIFOLIA | TO GAL., IVIIIN. 30 HT. | |
| WT | 2 | WHALE'S TONGUE | 10 CAL MINI 20" LIT | |
| | | | 10 GAL., MIN. 36" HT. | |
| YF | 12 | YUCCA FILAMENTOSA 'COLOR GUARD' | | |
| | | COLOR GUARD YUCCA | 5 GAL., MIN. 8" HT. | |
| | | GROUND COVER | | |
| <u>KEY</u> | QUANTITY | <u>DESCRIPTION</u> | SIZE | |
| SV | 120 | VERBENA RIGIDA | 1 GAL., FULL PLANT | |
| | | SANDPAPER VERBENA | 30" O.C. | |
| PG | 30 | TEUCRIUM CHAMAEDRYS 'PROSTRATUM' | I GAL., FULL PLANT 36" | |
| | | PROSTRATE GERMANDER | O.C. | |
| | | ORNAMENTAL GRASSES | | |
| <u>KEY</u> | QUANTITY | DESCRIPTION | <u>SIZE</u> | |
| ABM | 8 | MUHLENBERGIA CAPILLARIS 'REGAL MIST' | | |
| /\Divi | | AUTUMN BLUSH MUHLY | 3 GAL., FULL PLANT | |
| FRG | 10 | CALAMAGROSTIS ARUNDINACEA 'KARL | | |
| FNU | 10 | FOESTER' FEATHER REED GRASS | 3 GAL., FULL PLANT | |
| NALIC | 10 | MISCANTHUS SINENSIS 'ADAGIO' | | |
| MHG | 18 | ADAGIO GRASS | 3 GAL., FULL PLANT | |
| | | NASSELLA TENUISSIMA | 1 GAL., FULL PLANT | |
| MFG | 41 | MEXICAN FEATHER GRASS | 16" O.C. | |

 $\frac{\text{LANDSCAPE PLAN}}{\text{SCALE: 1"} = 10'-0"}$

GRAVEL KEY

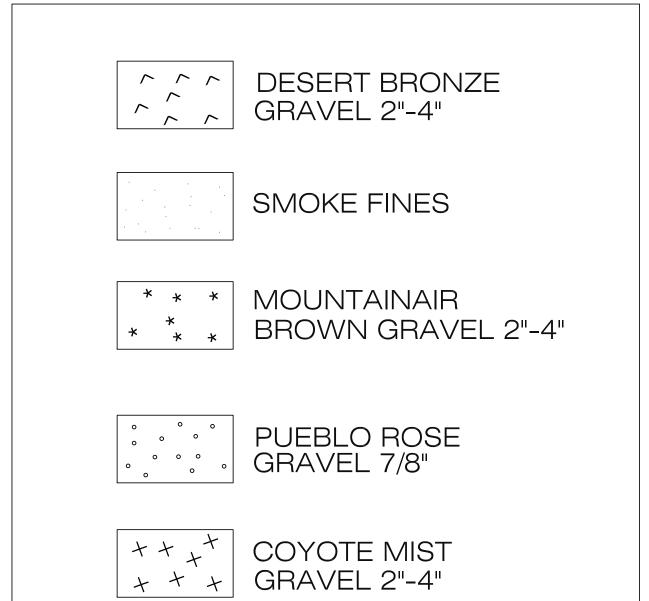

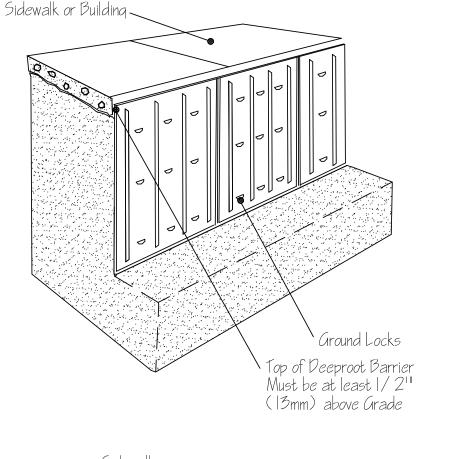

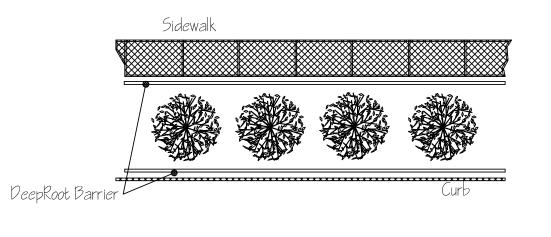

ROOT BARRIER DETAIL

SCALE: NTS

SHEET NOTES:

LANDSCAPE CONTRACTOR TO PROVIDE A COST FOR TREE PRUNING FOR EXISTING TREES TO REMAIN AS AN ALTERNATE TO THE BID.

REMOVE ALL EXISTING PLANTS AROUND MONUMENT SIGN

THE DRAWINGS AND SPECIFICATIONS ARE COMPLIMENTARY. ANYTHING CALLED FOR ON ONE AND NOT THE OTHER IS AS BINDING AS IF SHOWN AND CALLED FOR ON BOTH. THE PLANT SCHEDULE IS AN AID TO BIDDERS ONLY.

J. CAMILLE LA FOY

LANDSCAPE ARCHITECTURE CONSULTING

101C NORTH GREENVILLE AVENUE, #242
ALLEN, TEXAS 75002
214-502-4036

INDIAN SCHOOL RD NE & LOUISIANA RD
6670 INDIAN SCHOOL ROAD NE
ALBUQUERQUE, NEW MEXICO 87110

1445 ROSS AVENUE SUITE 5700 DALLAS, TEXAS 7520 214.997.6029

07/12/2021

REVISIONS

DATE ISSUED: SEPTEMBER 09, 2020

JOB #: 2020030

SHEET NAME:

LANDSCAPE PLAN

 Δ NIDOO2

CITY OF ALBUQUERQUE

Planning Department Brennon Williams, Director



July 15, 2021

Paul Cragun, P.E. Cumulus Design 2080 N. Highway 360, Suite 240 Grand Prairie, TX 75050

RE: Chase Bank – Indian School Rd. 6670 Indian School Rd. NE Revised Grading and Drainage Plans Engineer's Stamp Date: 06/30/21 Hydrology File: J18D001C

Dear Mr. Cragun:

PO Box 1293 Based upon the information provided in your submittal received 06/29/2021, the Revised Grading and Drainage Plans are approved for Building Permit and action by the DRB on Site

Grading and Drainage Plans are approved for Building Permit and action by the DRB on Site

Plan for Building Permit.

Albuquerque Please attach a copy of this approved plan in the construction sets for Building Permit processing

along with a copy of this letter. Prior to approval in support of Permanent Release of Occupancy

by Hydrology, Engineer Certification per the DPM checklist will be required.

NM 87103

As a reminder, if the project total area of disturbance (including the staging area and any work

within the adjacent Right-of-Way) is 1 acre or more, then an Erosion and Sediment Control (ESC) Plan and Owner's certified Notice of Intent (NOI) is required to be submitted to the Stormwater Quality Engineer (Doug Hughes, PE, jhughes@cabq.gov, 924-3420) 14 days prior to

any earth disturbance.

The Payment in Lieu payment of \$2,028.80 must be paid prior to Permanent Release of Occupancy approval. Please use the attached City of Albuquerque Treasury Deposit form and when ready please email this form to Shannon Cordero (sdcordero@cabq.gov). She will then produce and email back with a receipt and instructions on how to pay online. Once paid, please email me proof of payment. This will insure that Hydrology with be able to process Permanent

Release of Occupancy approval when officially submitted.

www.cabq.gov

CITY OF ALBUQUERQUE

Planning Department Brennon Williams, Director



Mayor Timothy M. Keller

If you have any questions, please contact me at 924-3995 or rbrissette@cabq.gov.

Sincerely, Renée C. Brissette Renée C. Brissette, P.E. CFM Senior Engineer, Hydrology


Planning Department

PO Box 1293

Albuquerque

NM 87103

www.cabq.gov

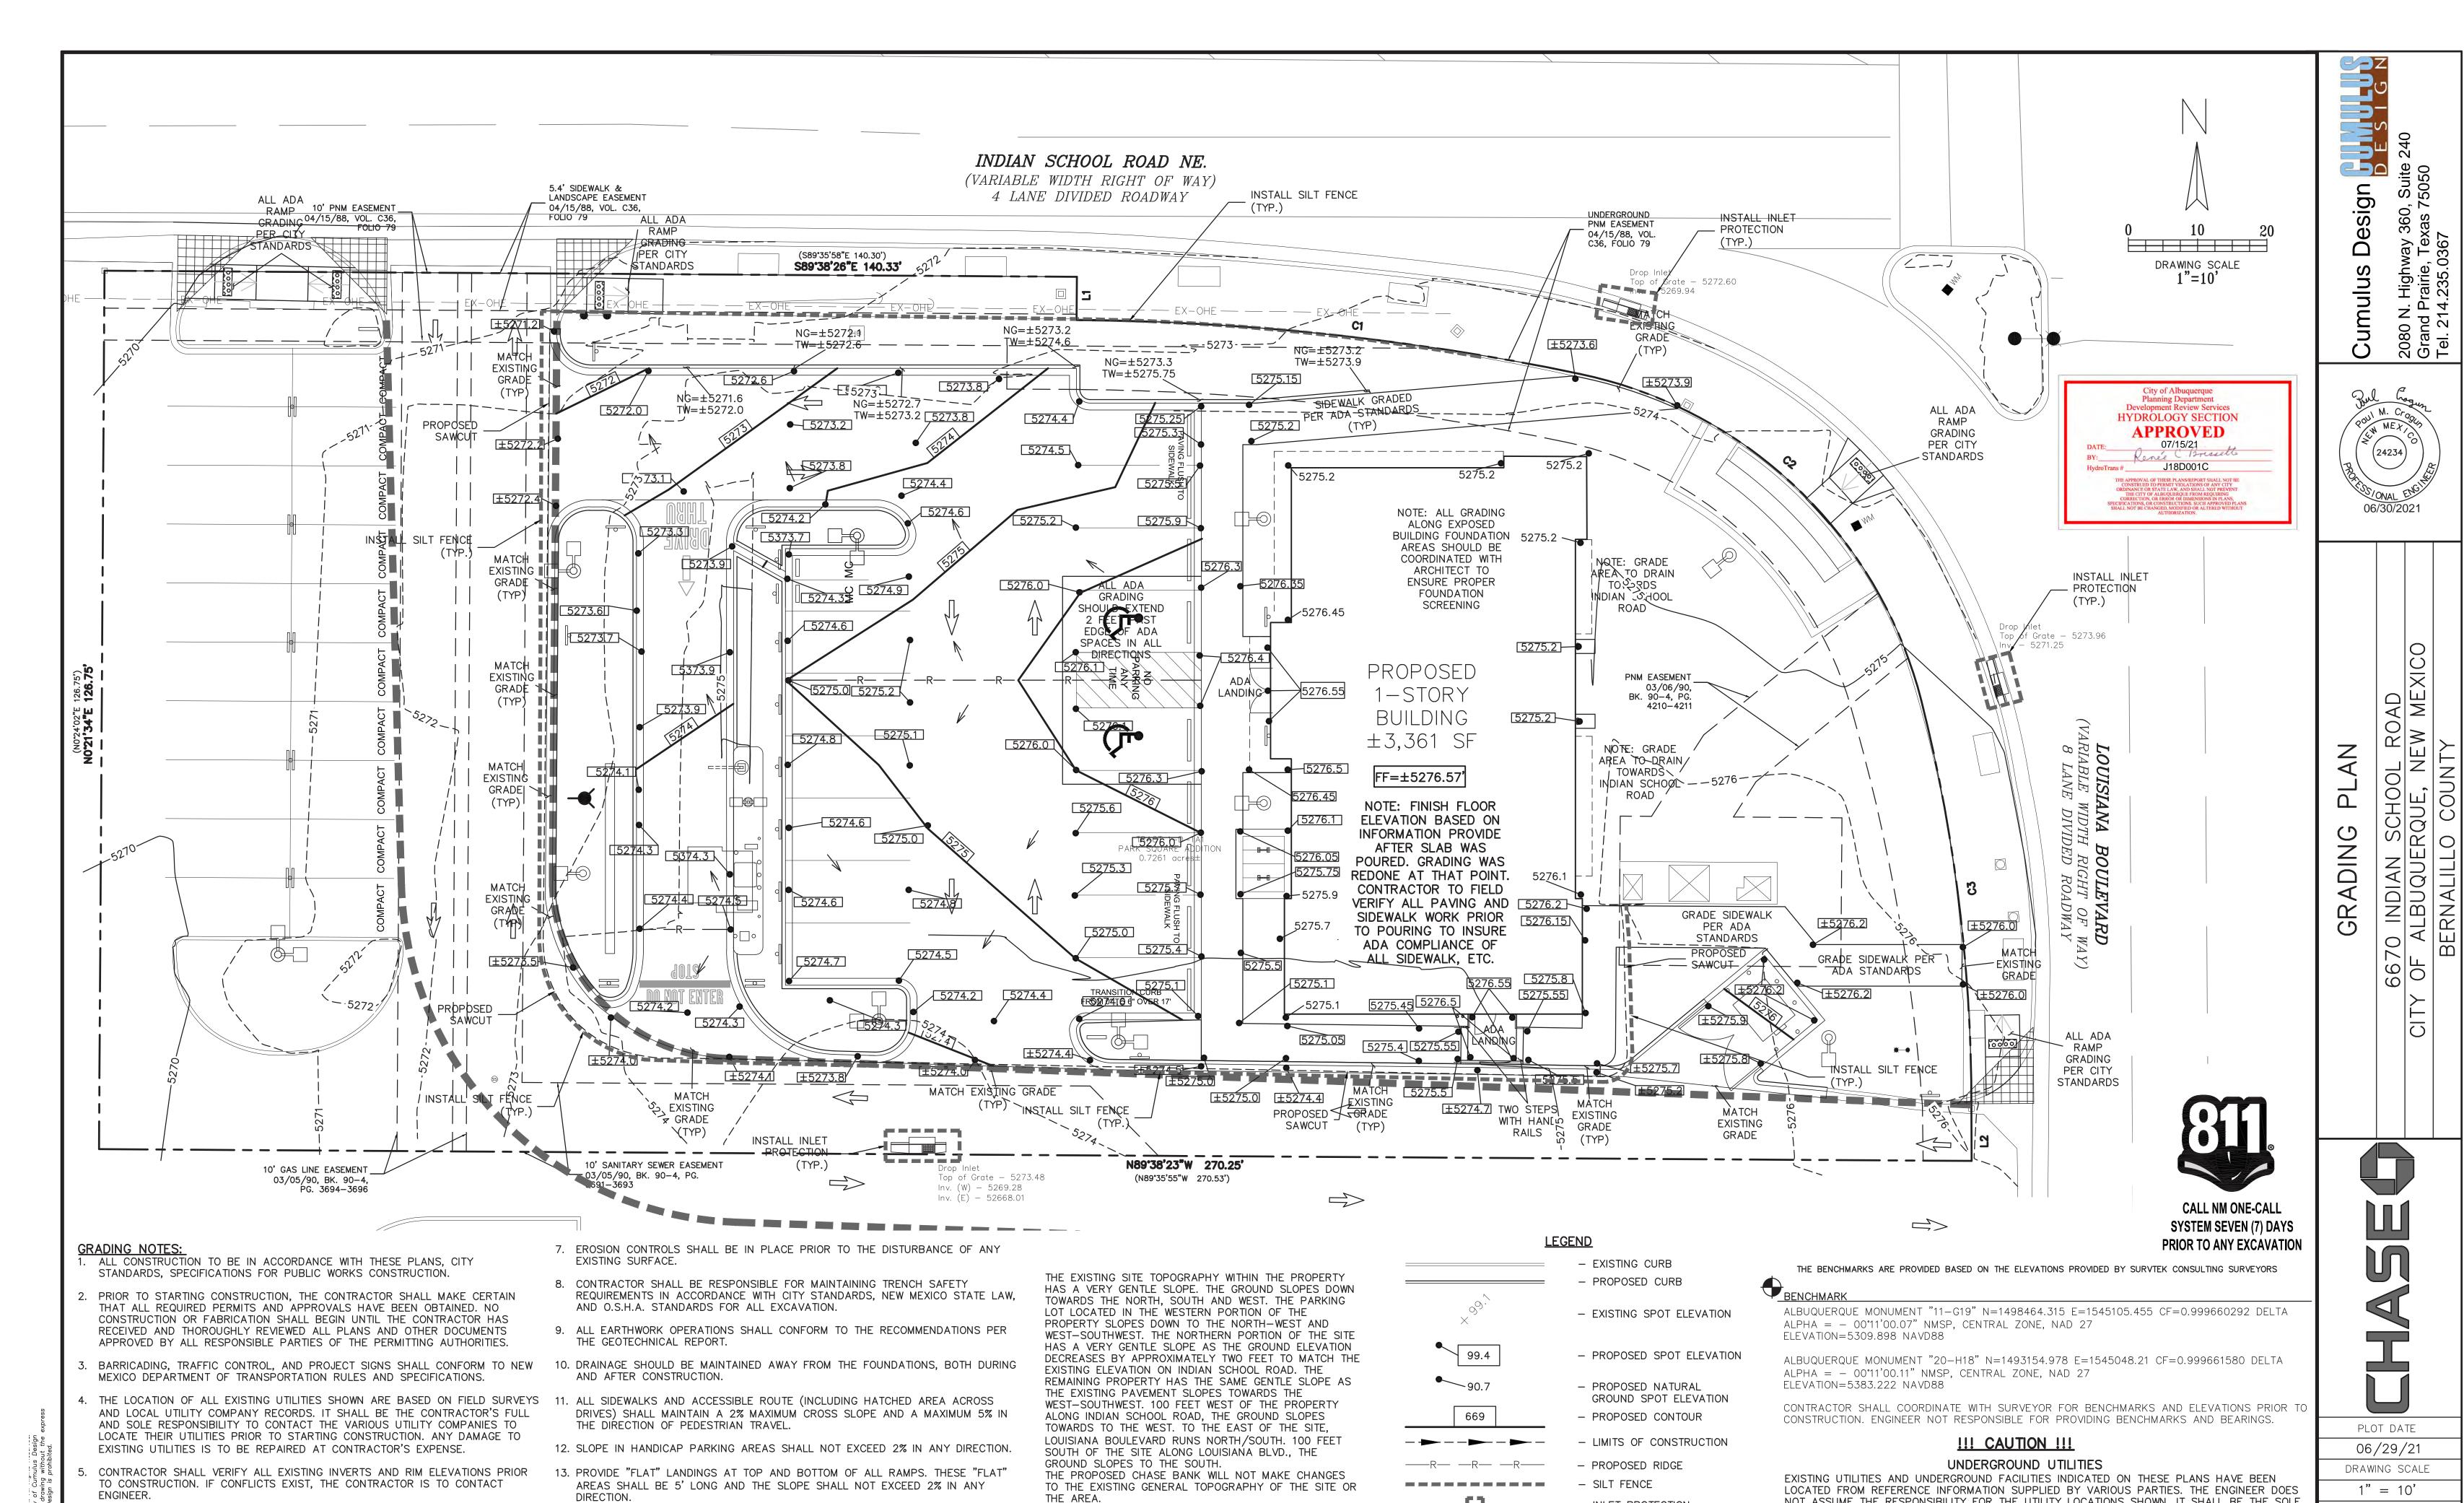

NOT ASSUME THE RESPONSIBILITY FOR THE UTILITY LOCATIONS SHOWN. IT SHALL BE THE SOLE

LOCATION OF ALL UTILITIES AND UNDERGROUND FACILITIES PRIOR TO CONSTRUCTION, TO TAKE

PRECAUTIONS IN ORDER TO PROTECT ALL FACILITIES ENCOUNTERED AND NOTIFY THE ENGINEER

OF ALL CONFLICTS OF THE WORK WITH EXISTING FACILITIES. THE CONTRACTOR SHALL PROTECT

CONTRACTOR TO UTILITIES SHALL BE REPAIRED OR REPLACED BY THE CONTRACTOR AT THEIR

AND MAINTAIN ALL UTILITIES FROM DAMAGE DURING CONSTRUCTION. ANY DAMAGE BY THE

CALL: NEW MEXICO ONE CALL @ NM 811 AT LEAST 7 DAYS PRIOR TO CONSTRUCTION.

RESPONSIBILITY OF THE CONTRACTOR(S) TO VERIFY THE HORIZONTALLY AND VERTICALLY

PROJECT NUMBER

CDC20013

SHEET NUMBER

INLET PROTECTION

PROPOSED SAWCUT

NATURAL GROUND

- TOP OF WALL/CURB

DIRECTIONAL FLOW ARROW

EXPENSE OF THE CONTRACTOR.

BENCHMARKS HAVE BEEN PROVIDED AS A REFERENCE. IT IS THE CONTRACTOR'S

RESPONSIBILITY TO LOCATE, VERIFY, AND/OR ESTABLISH A BENCHMARKS PRIOR

SURVEY STAKES AND MARKERS FOR THE DURATION OF THE PROJECT. IF ANY

TO BE REPLACED, SUCH REPLACEMENT SHALL BE BY THE SURVEYOR AT THE

CONSTRUCTION STAKES OR MARKERS ARE LOST OR DISTURBED AND ARE NEEDED

TO CONSTRUCTION. IT IS THE CONTRACTOR'S RESPONSIBILITY TO PRESERVE

\\SERVER-PC\SERVER\2020 CDC PROJECTS\CDC20013 — INDIAN SCHOOL ROAD, ALBUQUERQUE\PLANS\GRADING PLAN CDC20013.DWG


14. IT IS THE RESPONSIBILITY OF THE CONTRACTOR TO PROVIDE POSITIVE DRAINAGE

INDICATED. SURFACE WATER SHALL NOT BE RELEASED ONTO ADJACENT PRIVATE

15. SITE GRADING SHALL BE PERFORMED IN A MANNER TO DIRECT WATER AS

AWAY FROM BUILDING AND PARKING AT ALL TIMES.

PROPERTY.

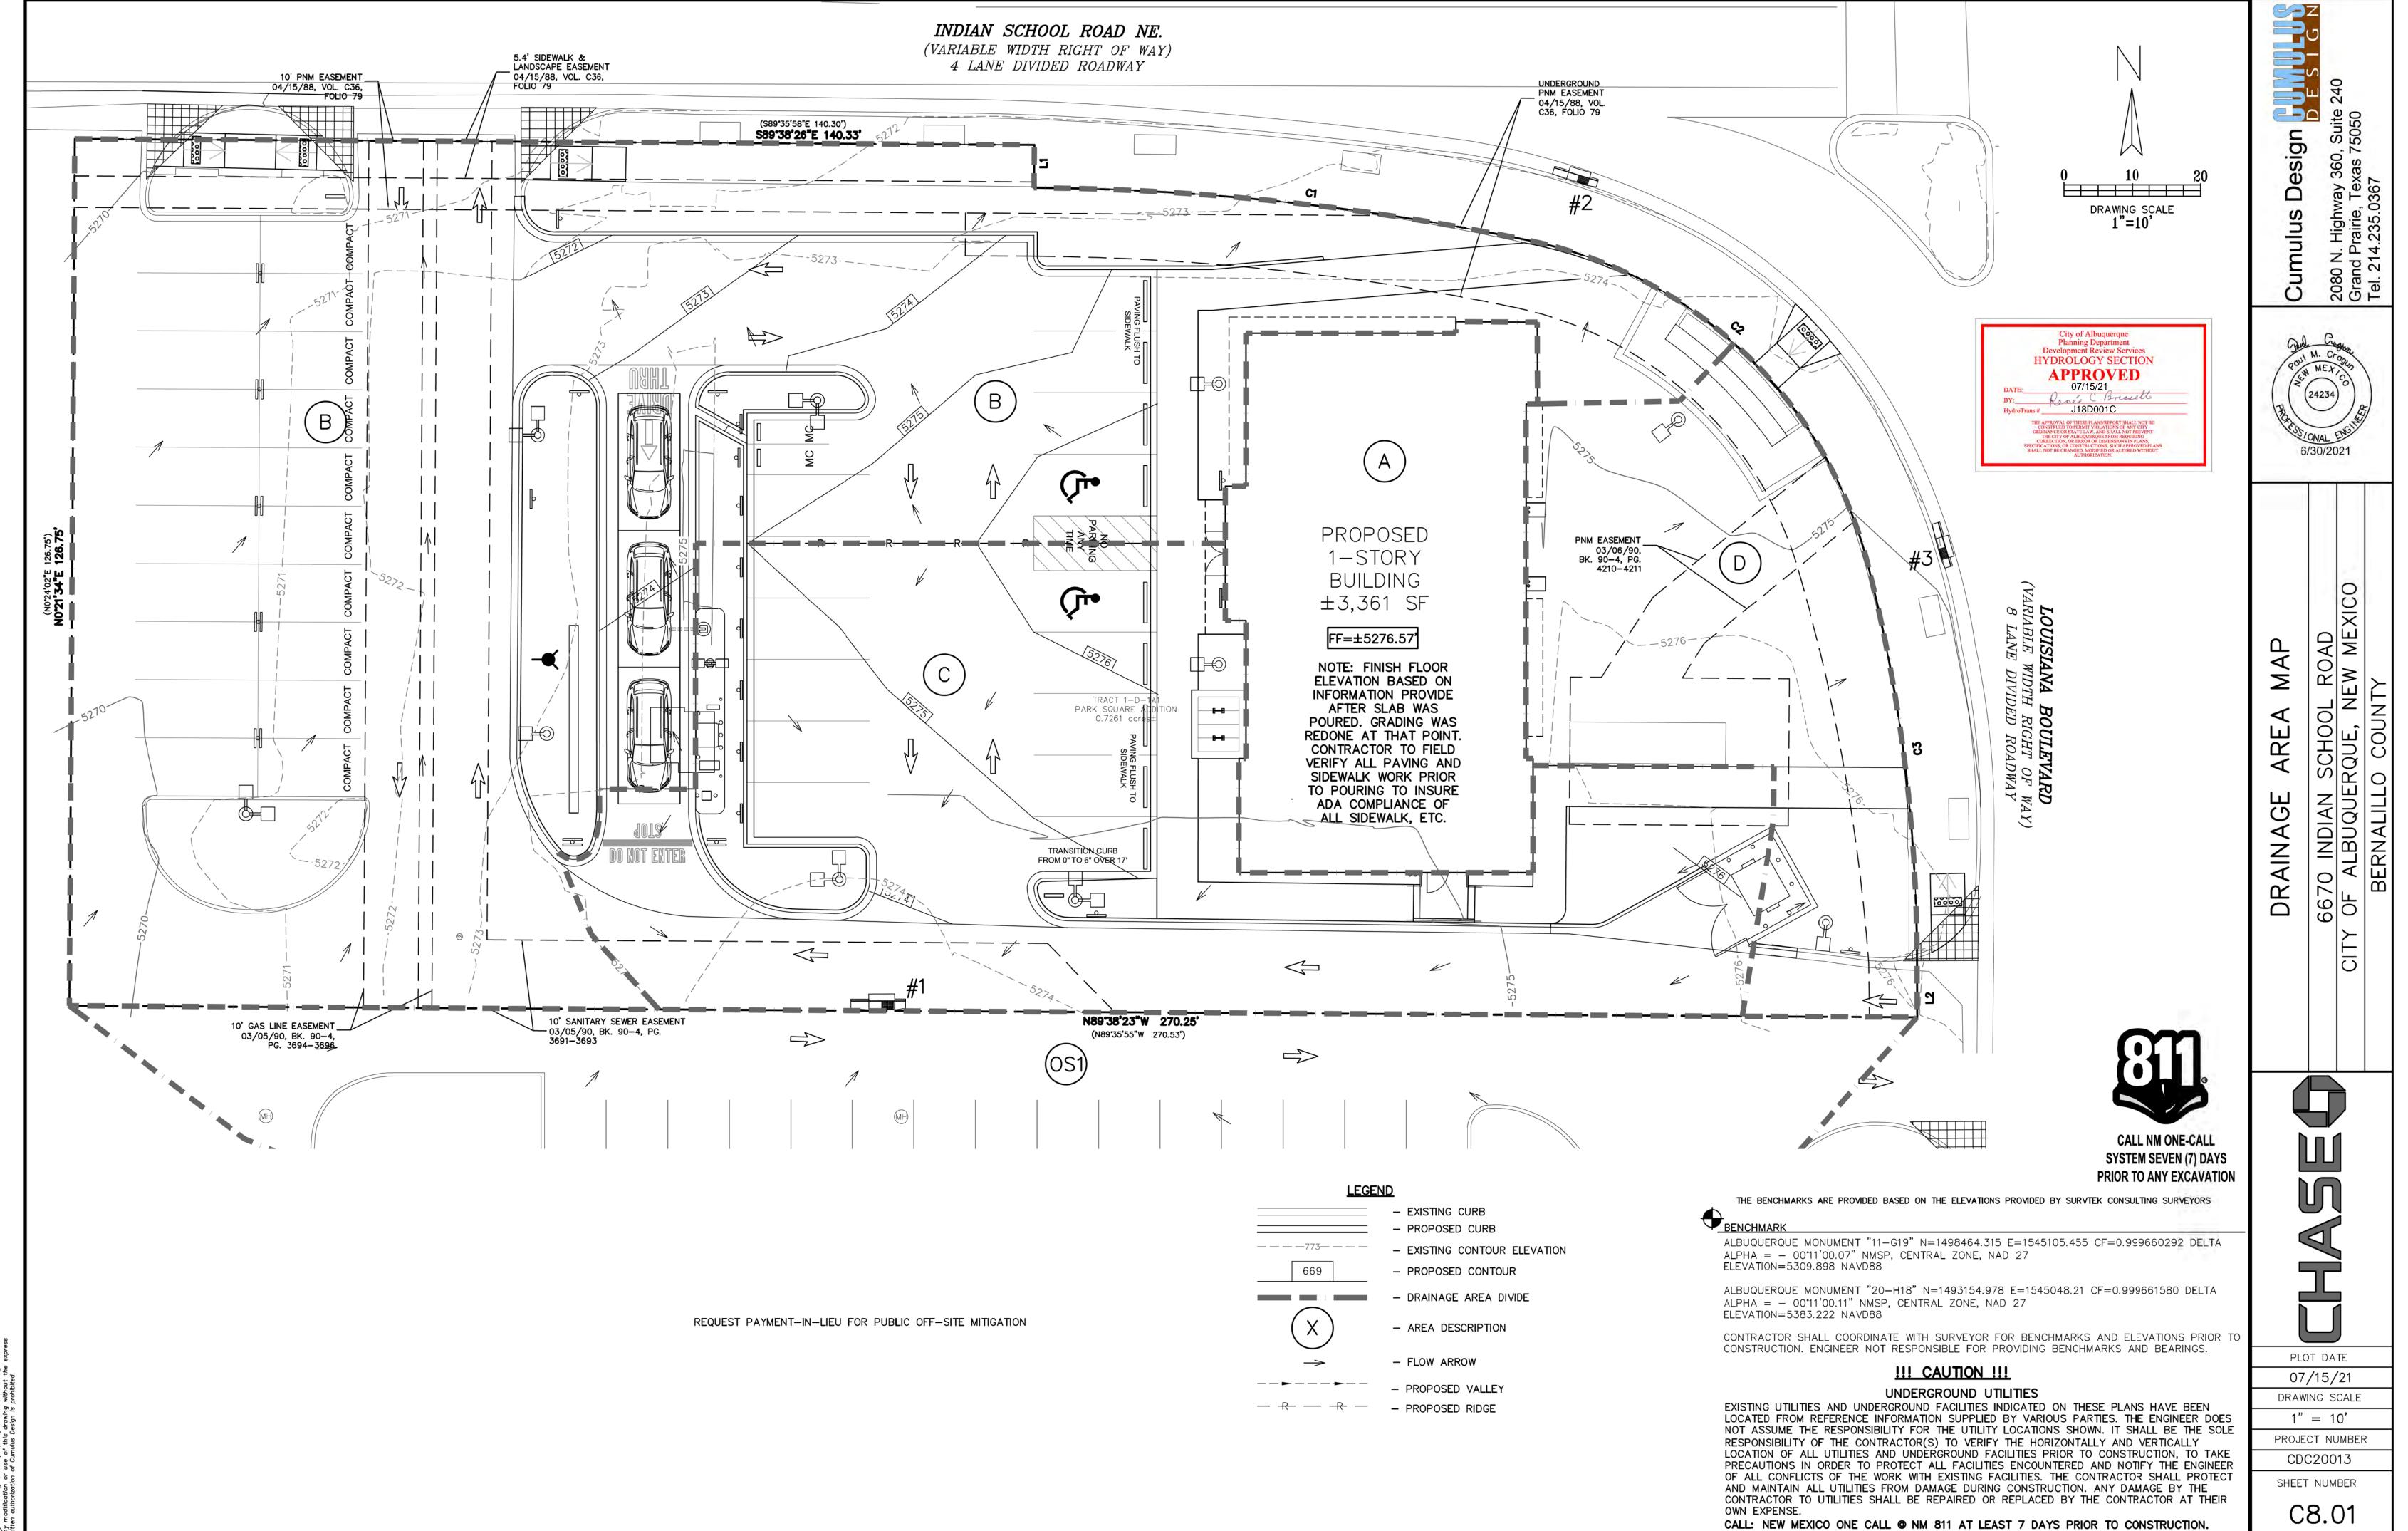

(())This grawing is the property of Cumulus Design

\\SERVER-PC\SERVER\2020 CDC PROJECTS\CDC20013 - INDIAN SCHOOL ROAD, ALBUQUERQUE\PLANS\PROPOSED DRAINAGE AREA MAP CDC20013.DWG



MAP

ARE,

AINAG

DR

70 INDIAN ALBUQUE SERNALILL

PLOT DATE 06/29/21

DRAWING SCALE

PROJECT NUMBER CDC20013

SHEET NUMBER

| | PROPOSED DRAINAGE DATA CHART | | | | | | | | | | | | |
|----------------|------------------------------|---------------|------|------|------|-------------|--------------|---------------|----------------|-------------|--------------|---------------|---|
| DRAINAGE ID | AREA (SQ. FT.) | AREA (AC.) | C2 | C10 | C100 | Tc (min) | 2 (in/hr) | 10 (in/hr) | 100 (in/hr) | Q2 (cfs) | Q10 (cfs) | Q100 (cfs) | COMMENT |
| Α | 3361.09 | 0.08 | 0.89 | 0.54 | 0.91 | 5.0 | 1.94 | 3.12 | 4.96 | 0.13 | 0.13 | 0.35 | ROOF DRAINS TO AREA "C" THEN TO INLET #1 |
| В | 16735.87 | 0.38 | 0.73 | 0.50 | 0.83 | 5.0 | 1.94 | 3.12 | 4.96 | 0.54 | 0.60 | 1.58 | DRAINS TO INDIAN SCHOOL RD THEN TO INLET #2 |
| С | 8006.12 | 0.18 | 0.79 | 0.51 | 0.86 | 5.0 | 1.94 | 3.12 | 4.96 | 0.28 | 0.29 | 0.78 | DRAINS TO INLET #1 |
| D | 3524.34 | 0.08 | 0.20 | 0.37 | 0.56 | 5.0 | 1.94 | 3.12 | 4.96 | 0.03 | 0.09 | 0.22 | DRAINS TO LOUISIANA BLVD THEN TO INLET #3 |
| OS1 | 7709.17 | 0.18 | 0.16 | 0.36 | 0.54 | 5.0 | 1.94 | 3.12 | 4.96 | 0.05 | 0.20 | 0.47 | DRAINS TO AREA "C" |
| TOTAL | 31627.41 | 0.73 | | | | | | | | 1.05 | 1.31 | 3.41 | |


CALCULATIONS ARE BASED ON THE RATIONAL METHOD FROM CITY OF ALBUQUERQUE DEVELOPMENT PROCESS MANUAL CHAPTER 6 - DRAINAGE, FLOOD CONTROL AND EROSION CONTROL. DATED 06/08/2020

| | COMPOSITE ANALYSIS FOR RUNOFF COEFFICIENT | | | | | | | | | | |
|----------------|---|---------------------|-----------------------------|---------------------------|------------------------------|----------------------------|-------------------------------|-----------------------------|------|-----------------------------|------------------------------|
| DRAINAGE ID | PERCENT IMPERVIOUS | PERCENT PERVIOUS | C IMPERVIOUS (2 year) | C PERVIOUS (2 year) | C IMPERVIOUS (10 year) | C PERVIOUS (10 year) | C IMPERVIOUS (100 year) | C PERVIOUS (100 year) | | COMPOSITE C (10 year) | COMPOSITE C (100 year) |
| Α | 100.0 | 0.0 | 0.89 | 0.08 | 0.54 | 0.34 | 0.91 | .50 | 0.89 | 0.54 | 0.91 |
| В | 79.8 | 20.2 | 0.89 | 0.08 | 0.54 | 0.34 | 0.91 | .50 | 0.73 | 0.50 | 0.83 |
| С | 87.2 | 12.8 | 0.89 | 0.08 | 0.54 | 0.34 | 0.91 | .50 | 0.79 | 0.51 | 0.86 |
| D | 14.3 | 85.7 | 0.89 | 0.08 | 0.54 | 0.34 | 0.91 | .50 | 0.20 | 0.37 | 0.56 |
| OS1 | 9.9 | 90.1 | 0.89 | 0.08 | 0.54 | 0.34 | 0.91 | .50 | 0.16 | 0.36 | 0.54 |

| 80TH PERCENTILE STORMWATER QUALITY VOLUME TABLE | | | | | | | | |
|---|-------------------------------------|------------------------------|--|--|--|--|--|--|
| DRAINAGE ID | NEW IMPERVIOUS AREA (SQ. FT.) | REDEVELOPMENT SITE FACTOR | 80TH PERCENTILE STORM VOLUME (CFS) | | | | | |
| A | 3362.0 | 0.26 | 72.8 | | | | | |
| В | 4980.0 | 0.26 | 107.9 | | | | | |
| С | 3362.0 | 0.26 | 72.8 | | | | | |
| D | 0.0 | 0.26 | 0.0 | | | | | |
| | | | 253.6 | | | | | |

REQUEST PAYMENT-IN-LIEU FOR PUBLIC OFF-SITE MITIGATION

| WEIGHTED ANALYSIS FOR 6-HOUR EXCESS PRECIPITATION, 'E' | | | | | | | | | |
|--|------------------------|------------------------|-----------------------------|-----------------------------|----------------------------------|-----------------------------------|--|--|--|
| DRAINAGE ID | LAND TREATMENT B | LAND TREATMENT D | AREA LAND TREATMENT B | AREA LAND TREATMENT D | WEIGHTED E (100 year) (IN) | VOLUME (100 year) (ACRE-FT) | | | |
| Α | 0.86 | 2.58 | 0.000 | 0.080 | 2.580 | 0.045 | | | |
| В | 0.86 | 2.58 | 0.077 | 0.303 | 2.233 | 0.007 | | | |
| С | 0.86 | 2.58 | 0.016 | 0.023 | 1.882 | 0.044 | | | |
| D | 0.86 | 2.58 | 0.011 | 0.0686 | 2.334 | 0.016 | | | |
| | | | | TOTAL \ | 0.112 | | | | |

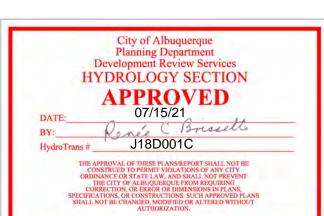



CALL NM ONE-CALL SYSTEM SEVEN (7) DAYS PRIOR TO ANY EXCAVATION

THE BENCHMARKS ARE PROVIDED BASED ON THE ELEVATIONS PROVIDED BY SURVIEK CONSULTING SURVEYORS

ALBUQUERQUE MONUMENT "11-G19" N=1498464.315 E=1545105.455 CF=0.999660292 DELTA $ALPHA = -00^{\circ}11'00.07"$ NMSP, CENTRAL ZONE, NAD 27 ELEVATION=5309.898 NAVD88

ALBUQUERQUE MONUMENT "20-H18" N=1493154.978 E=1545048.21 CF=0.999661580 DELTA ALPHA = - 00°11'00.11" NMSP, CENTRAL ZONE, NAD 27 ELEVATION=5383.222 NAVD88

CONTRACTOR SHALL COORDINATE WITH SURVEYOR FOR BENCHMARKS AND ELEVATIONS PRIOR TO CONSTRUCTION. ENGINEER NOT RESPONSIBLE FOR PROVIDING BENCHMARKS AND BEARINGS.

!!! CAUTION !!!

UNDERGROUND UTILITIES EXISTING UTILITIES AND UNDERGROUND FACILITIES INDICATED ON THESE PLANS HAVE BEEN LOCATED FROM REFERENCE INFORMATION SUPPLIED BY VARIOUS PARTIES. THE ENGINEER DOES NOT ASSUME THE RESPONSIBILITY FOR THE UTILITY LOCATIONS SHOWN. IT SHALL BE THE SOLE RESPONSIBILITY OF THE CONTRACTOR(S) TO VERIFY THE HORIZONTALLY AND VERTICALLY LOCATION OF ALL UTILITIES AND UNDERGROUND FACILITIES PRIOR TO CONSTRUCTION, TO TAKE PRECAUTIONS IN ORDER TO PROTECT ALL FACILITIES ENCOUNTERED AND NOTIFY THE ENGINEER OF ALL CONFLICTS OF THE WORK WITH EXISTING FACILITIES. THE CONTRACTOR SHALL PROTECT AND MAINTAIN ALL UTILITIES FROM DAMAGE DURING CONSTRUCTION. ANY DAMAGE BY THE CONTRACTOR TO UTILITIES SHALL BE REPAIRED OR REPLACED BY THE CONTRACTOR AT THEIR

CALL: NEW MEXICO ONE CALL @ NM 811 AT LEAST 7 DAYS PRIOR TO CONSTRUCTION.

\\SERVER-PC\\SERVER\2020 CDC PROJECTS\CDC20013 - INDIAN SCHOOL ROAD, ALBUQUERQUE\PLANS\PROPOSED DRAINAGE AREA MAP CDC20013.DWG

DRAINAGE CRITERIA

ZONE 3 Q=C*I*A

12=1.94 in/hr $I_{10}=3.12 \text{ in/hr}$ 1100=4.96 in/hr tc=12 min.

CITY OF ALBUQUERQUE

Planning Department Brennon Williams, Director



Mayor Timothy M. Keller

July 14, 2021

Carlos Iglesias Cumulus Design 2080 N. Highway 360, Ste. 240 Grand Pairie, TX 75050

e: Chase Bank – Indian School Road 6670 Indian School Road NE Traffic Circulation Layout Architect's Stamp 07-12-2021 (J18-D001C)

Dear Mr. Iglesias,

The TCL submittal received 07-13-2021 is approved for Building Permit with. A copy of the stamped and signed plan will be needed for each of the building permit plans. Please keep the original to be used for certification of the site for final C.O. for Transportation.

PO Box 1293

When the site construction is completed and an inspection for Certificate of Occupancy (C.O.) is requested, use the original City stamped approved TCL for certification. Redline any minor changes and adjustments that were made in the field. A NM registered architect or engineer must stamp, sign, and date the certification TCL along with indicating that the development was built in "substantial compliance" with the TCL. Submit this certification, the TCL, and a completed <u>Drainage and Transportation Information Sheet</u> to front counter personnel for log in and evaluation by Transportation.

Albuquerque

NM 87103

Once verification of certification is completed and approved, notification will be made to Building Safety to issue Final C.O. To confirm that a final C.O. has been issued, call Building Safety at 924-3690.

www.cabq.gov

Nilo Salgado-Fernandez, P.E. Senior Traffic Engineer, Plann


Senior Traffic Engineer, Planning Dept.

Development Review Services

C: CO Clerk, File

Sincerely.

Page 1 of 1

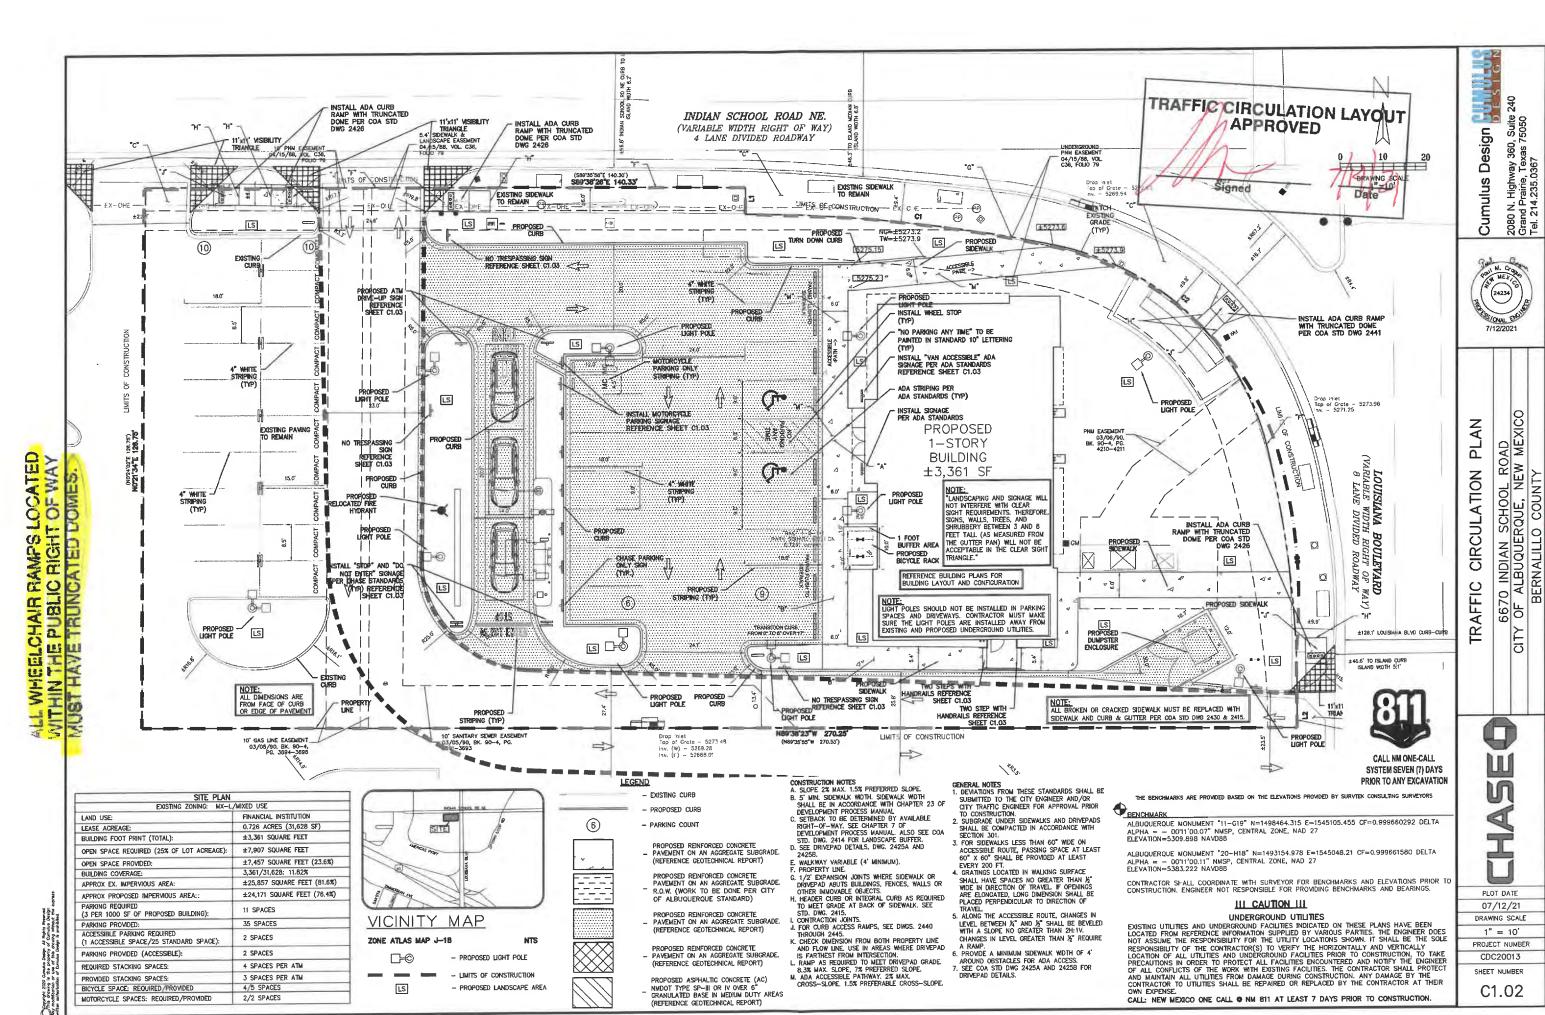

020 CDC PROJECTS\CDC20013 - IMDIAN SCHOOL ROAD, ALBUOUERQUE\PLANS\TRAFFIC CIRCULATION LAYOUT CDC20013.0R



TYPICAL ADA SIGNAGE FOR VAN ACCESSIBLE SPACES



TYPICAL ADA SIGNAGE



MOTORCYCLE PARKING SIGN N.T.S. NO TRESPASSIN


NO TRESPASSING SIGN N.T.S.




R5 - 1(SIZE: 30"x30") DO NOT ENTER SIGN



R1 - 1(SIZE: 30"X30") STOP SIGN

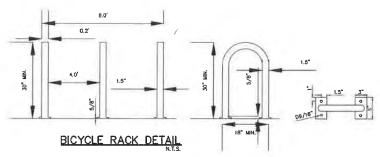


1. INSTALLATION TO BE COMPLETED IN ACCORDANCE WITH MANUFACTURER'S SPECIFICATIONS.

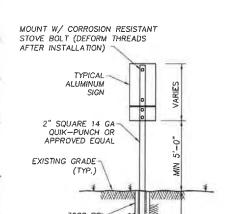


CONCRETE

2 1" 12 GA-


MOUNTING SLEEVE ADA DUAL SIGNAGE MOUNTING DETAIL

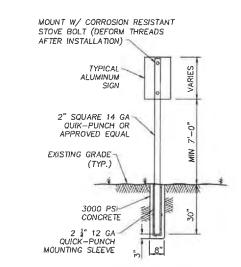


SINGLE ADA AND MOTORCYCLE SIGNAGE MOUNTING DETAIL

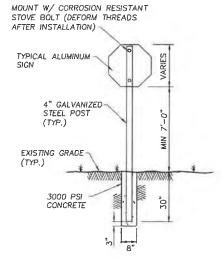

"STOP" AND "DO NOT ENTER" SIGNAGE MOUNTING DETAIL

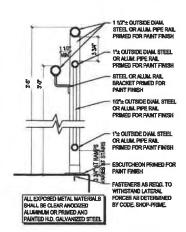

ADA RAMP HAND RAIL DETAIL

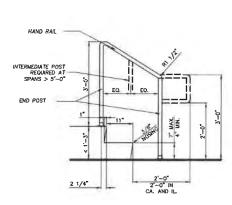


HANDRAIL DETAIL




TEXT DETAILS



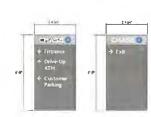

ENTRANCE SIGN #1 DETAIL

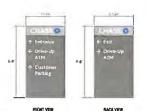

ENTRANCE SIGN #2 DETAIL



DRIVE-THRU ATM SIGNAGE DETAIL

CALL NM ONE-CALL SYSTEM SEVEN (7) DAYS PRIOR TO ANY EXCAVATION

THE BENCHWARKS ARE PROVIDED BASED ON THE ELEVATIONS PROVIDED BY SURVIEK CONSULTING SURVEYORS

BENCHMARK ALBUQUERQUE MONUMENT "11-G19" N=1498464.315 E=1545105.455 CF=0.999660292 DELTA ALPHA = - 00'11'00.07" NMSP, CENTRAL ZONE, NAD 27 ELEVATION=5309.898 NAVD88

ALBUQUERQUE MONUMENT "20-H18" N=1493154.978 E=1545048.21 CF=0.999661580 DELTA ALPHA = - 00"1" O0.11" NMSP. CENTRAL ZONE, NAD 27 ELEVATION=5383.222 NAVD88

CONTRACTOR SHALL COORDINATE WITH SURVEYOR FOR BENCHMARKS AND ELEVATIONS PRIOR TO CONSTRUCTION, ENGINEER NOT RESPONSIBLE FOR PROVIDING BENCHMARKS AND BEARINGS.

HI CAUTION HI

UNDERGROUND UTILITIES

EXISTING UTILITIES AND UNDERGROUND FACILITIES INDICATED ON THESE PLANS HAVE BEEN LOCATED FROM REFERENCE INFORMATION SUPPLIED BY VARIOUS PARTIES. THE ENGINEER DOES NOT ASSUME THE RESPONSIBILITY FOR THE UTILITY LOCATIONS SHOWN. IT SHALL BE THE SOLE RESPONSIBILITY OF THE CONTRACTOR(S) TO VERIFY THE HORIZONTALLY AND VERTICALLY LOCATION OF ALL UTILITIES AND UNDERGROUND FACILITIES PRIOR TO CONSTRUCTION. TO TAKE PRECAUTIONS IN ORDER TO PROTECT ALL FACILITIES ENCOUNTERED AND NOTIFY THE ENGINEER OF ALL CONFLICTS OF THE WORK WITH EXISTING FACILITIES. THE CONTRACTOR SHALL PROTECT AND MAINTAIN ALL UTILITIES FROM DAMAGE DURING CONSTRUCTION. ANY DAMAGE BY THE CONTRACTOR TO UTILITIES SHALL BE REPAIRED OR REPLACED BY THE CONTRACTOR AT THEIR OWN EXPENSE.

CALL: NEW MEXICO ONE CALL @ NM 811 AT LEAST 7 DAYS PRIOR TO CONSTRUCTION.

Design Figure 16

Cumulus

PLAN

CIRCULATION

TRAFFIC

2080 N. Highway 360, Suite 2 Grand Prairie, Texas 75050 Tel. 214.235.0367

70 INDIAN SCHOOL ROAD

ALBUQUERQUE, NEW MEXICO
BERNALILLO COUNTY

667 0F

CIT

60

PLOT DATE 07/12/21 DRAWING SCALE

PROJECT NUMBER


CDC20013 SHEET NUMBER


C1.03







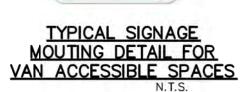

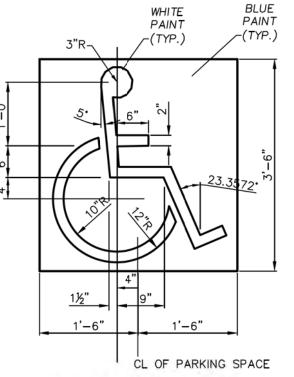

TYPICAL SIGNAGE MOUTING DETAIL FOR ACCESSIBLE SPACES

ACCESSIBLE PARKING SYMBOL DETAIL

ADA PARKING STALLS AND AISLE DETAIL

26.0' @ 2.0% MAX



(SIZE: 30"X30")


STOP SIGN




(SIZE: 30"x30")

DO NOT ENTER SIGN



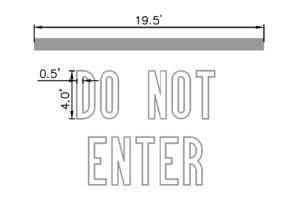

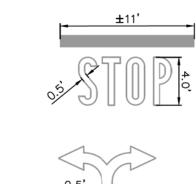

NO TRESPASSING

TEXT DETAILS




SIGN N.T.S.


PRECAST CONCRETE WHEEL STOP EDGE OF PAVEMENT, FACE OF CURB OR FACE OF WALL #4 STEEL REBAR, 18" LONG. SET 12" INTO PAVEMENT TWO REQUIRED (1.0' @ PAVEMENT EDGE 2.5' @ CURB 3.0' @ FENCE OR WALL

WHEEL STOP DETAIL


MOUNT W/ CORROSION RESISTANT STOVE BOLT (DEFORM THREADS AFTER INSTALLATION) TYPICAL-ALUMINUM 2" SQUARE 14 GA-QUIK-PUNCH OR APPROVED EQUAL EXISTING GRADE-(TYP.) CONCRETE 2 ¼" 12 GA QUICK-PUNCH MOUNTING SLEEVE


ADA DUAL SIGNAGE MOUNTING DETAIL

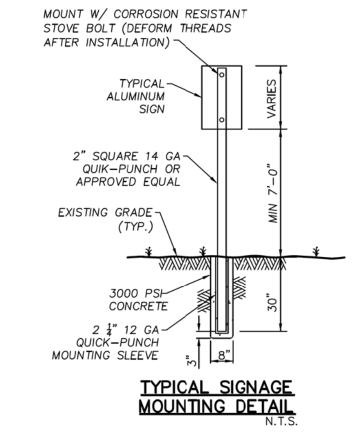


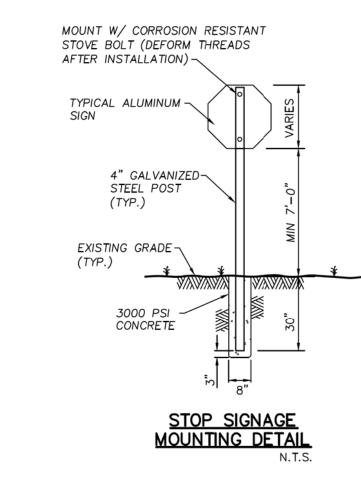

NOTE DETAILS ON THIS SHEET ARE PRIVATE. ALL WORK WITHIN PUBLIC EASEMENTS OR RIGHT-OF-WAY SHALL BE PER CITY (OR STATE, IF APPLICABLE) STANDARD DETAILS. THE CONTRACTOR IS REQUIRED TO HAVE ON—SITE, AT ALL TIMES, A COPY OF THE CITY'S CONSTRUCTION DETAILS.

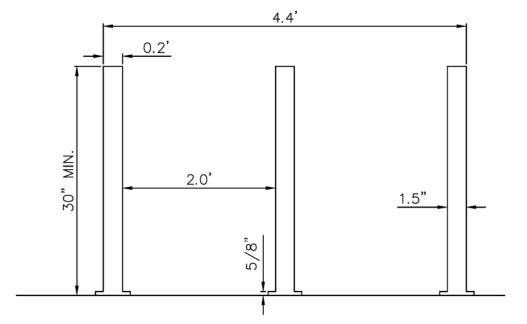

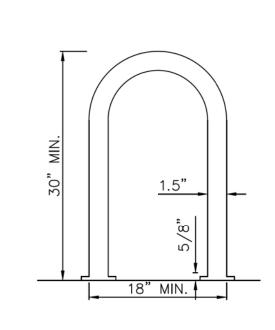


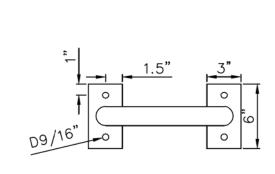


1. INSTALLATION TO BE COMPLETED IN ACCORDANCE WITH MANUFACTURER'S SPECIFICATIONS.


BICYCLE RACK DETAIL N.T.S.

MISCELLANEOUS DETAILS

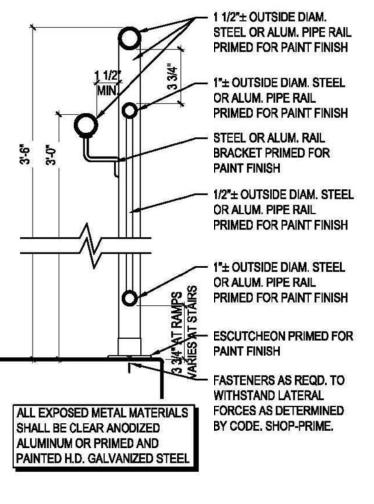





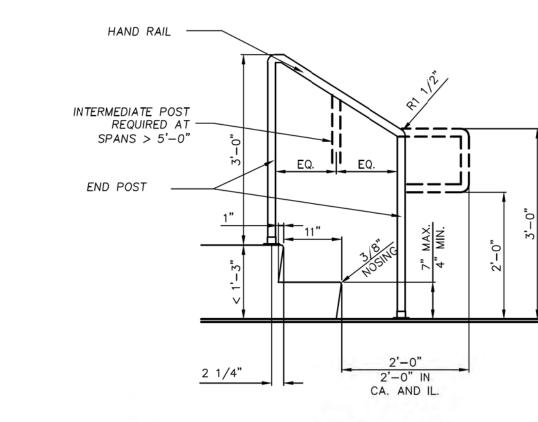


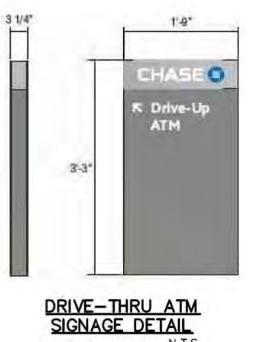



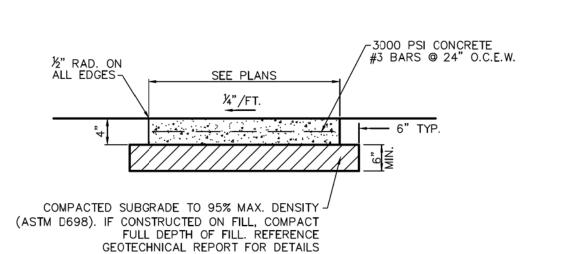

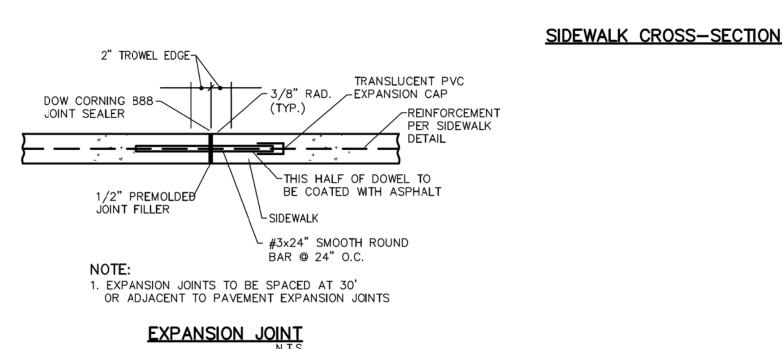

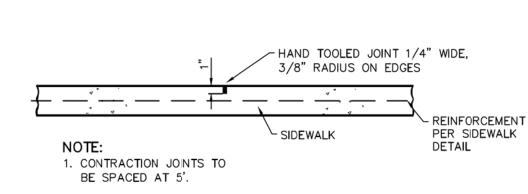

CONTRACTION JOINT

SIDEWALK DETAILS

PLOT DATE 07/16/21

esign

(24234)

(PRIVA)


TAIL


DE

DRAWING SCALE


PROJECT NUMBER CDC20013

SHEET NUMBER C13.02

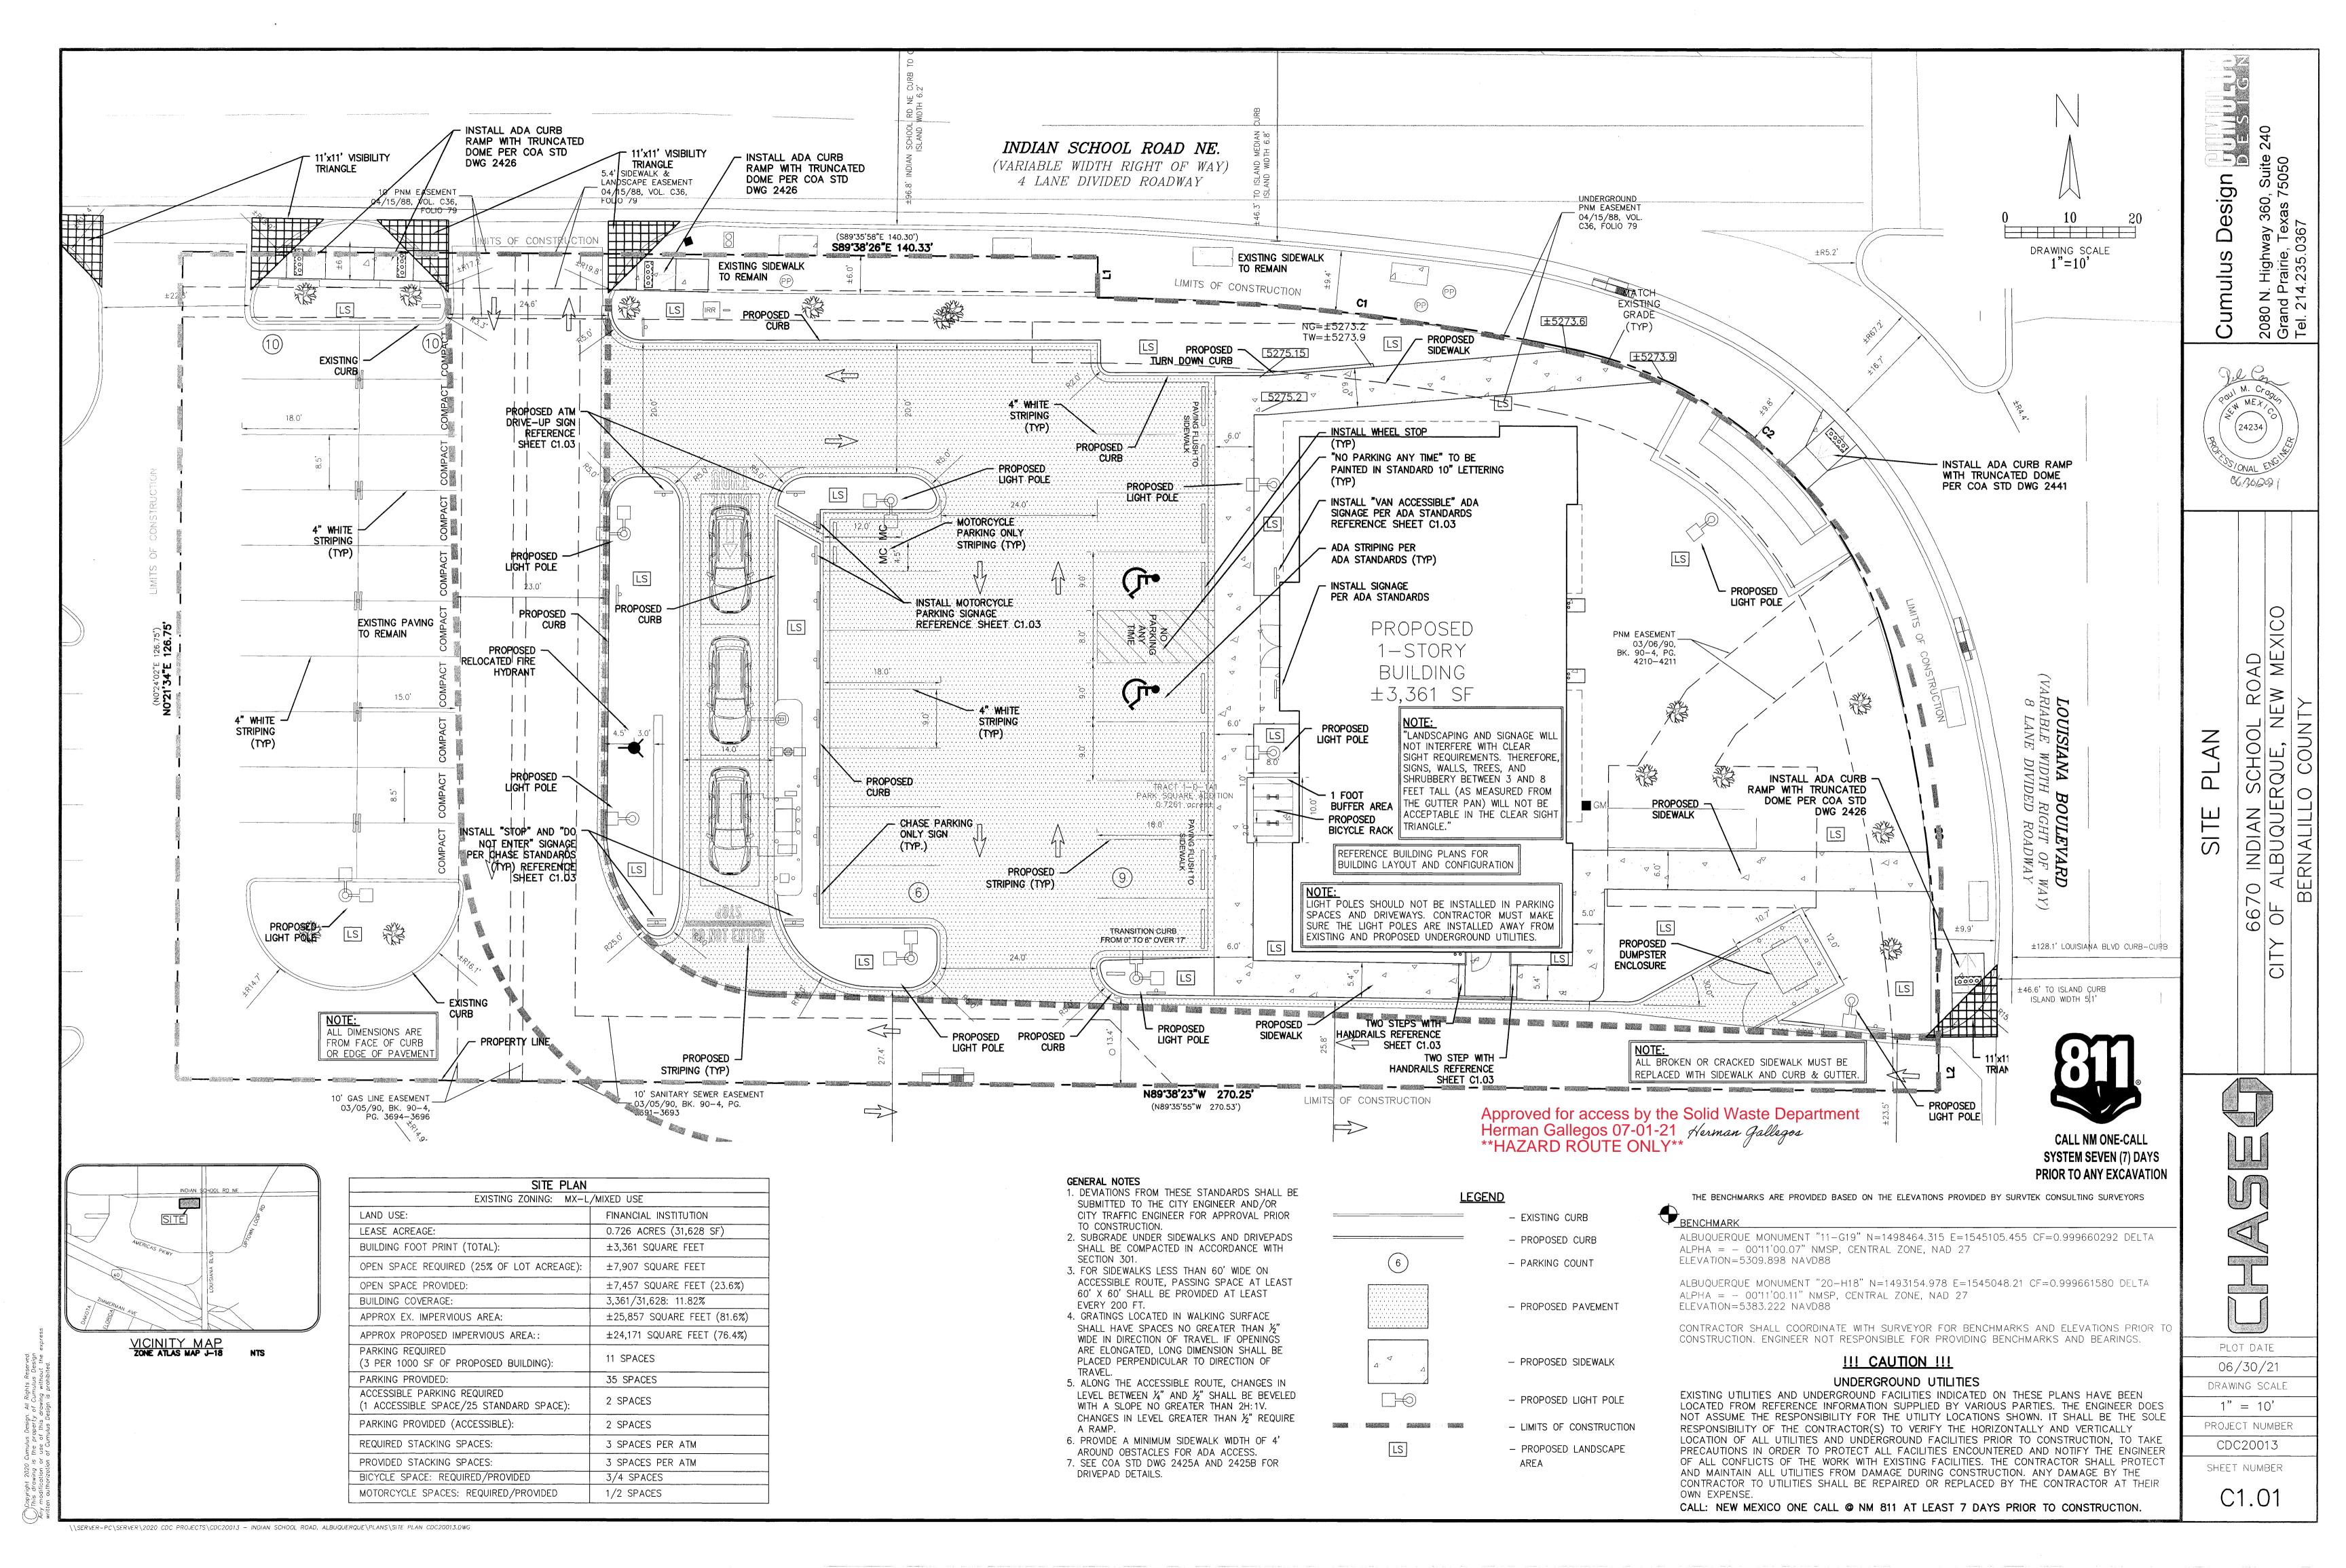

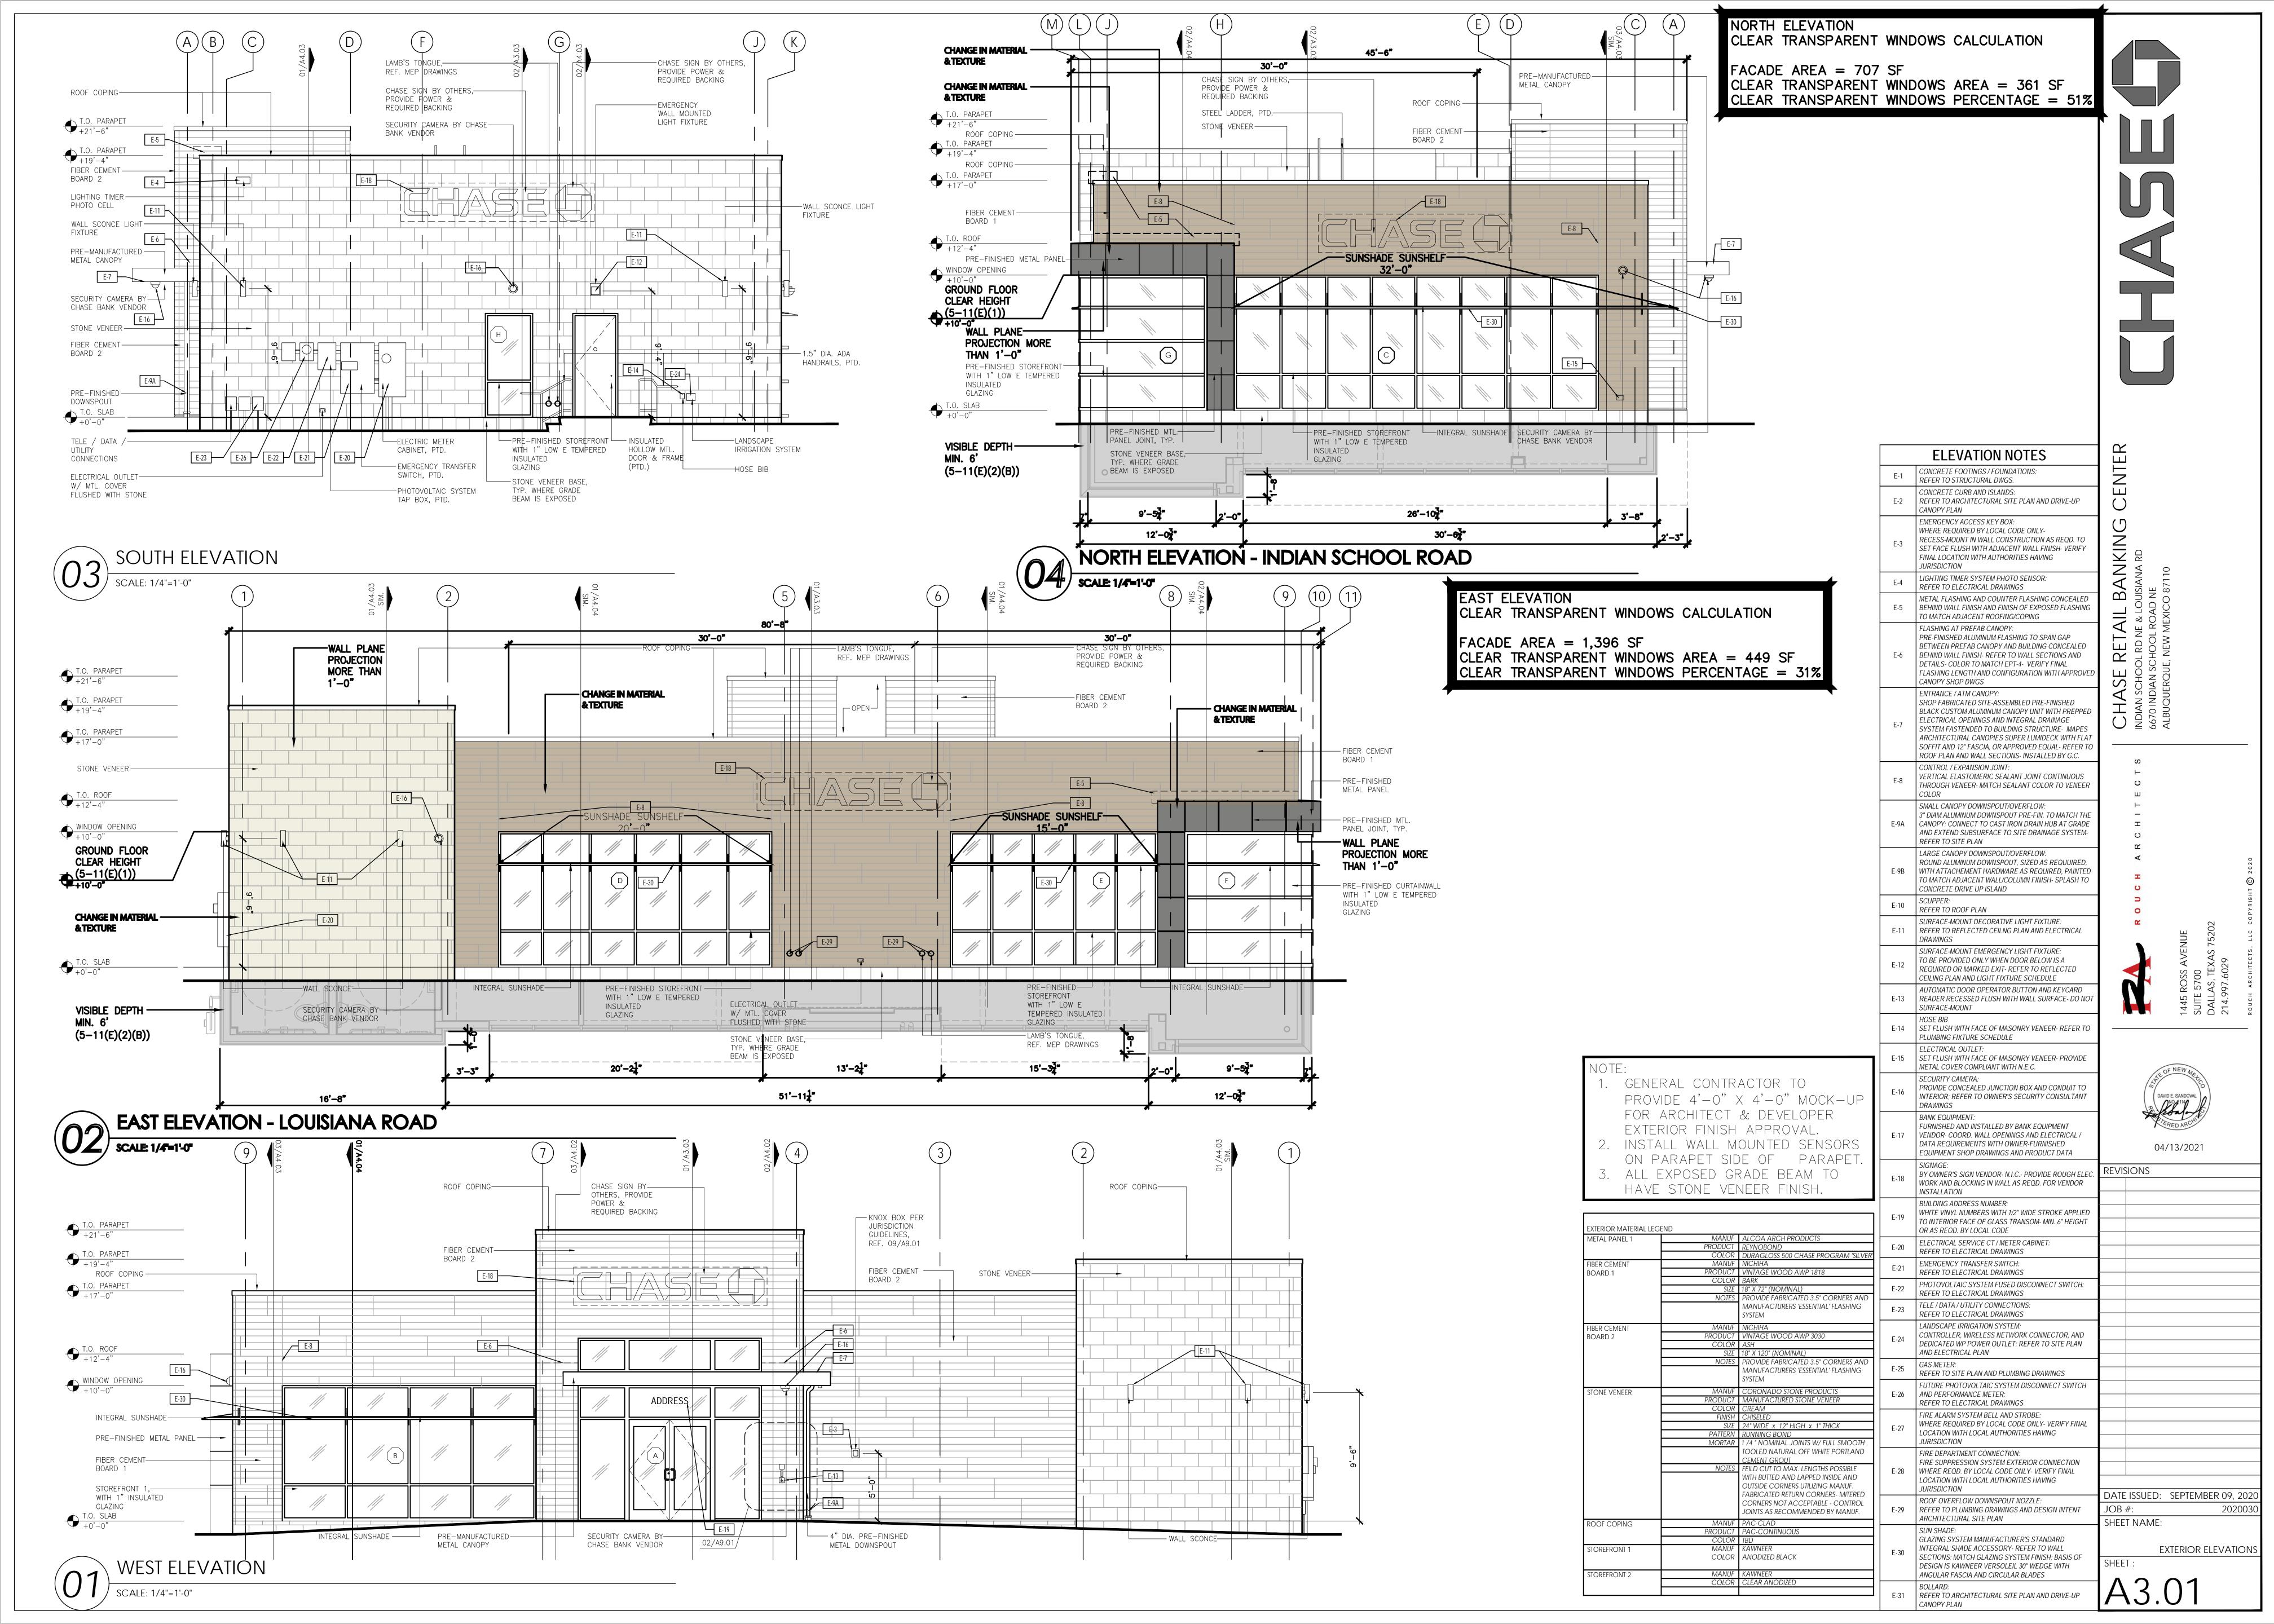



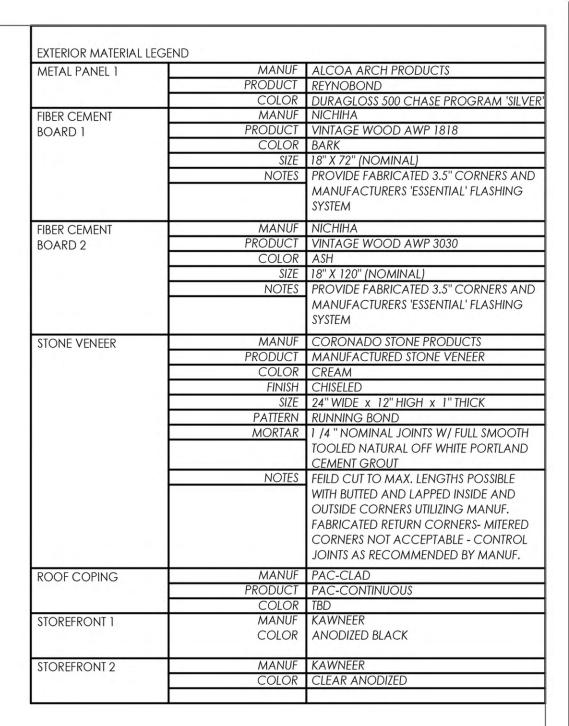

WEST ELEVATION












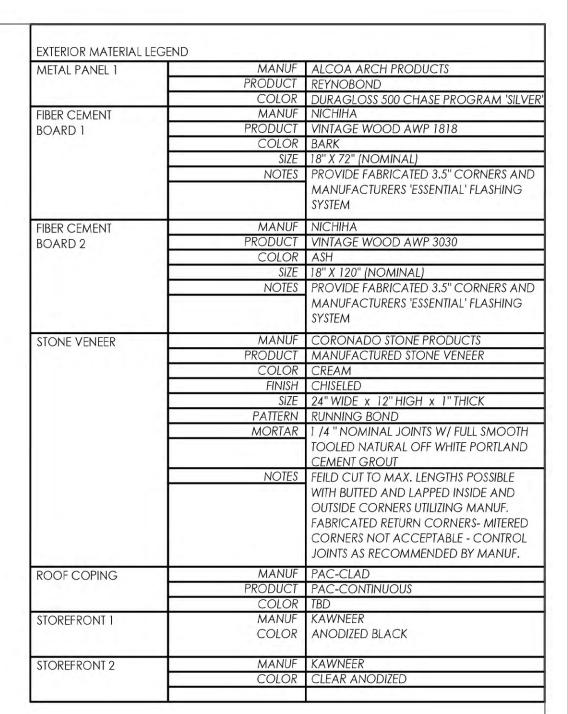

EAST ELEVATION

SCALE: 1/4"=1'-0



NORTH ELEVATION

SCALE: 1/4"=1'-0"





#38200P367111 Indian School Rd NE and Louisiana Rd 6670 Indian School Rd NE Albuquerque, NM 87110









JP Morgan Chase Bank #38200P367111

signtech.com

Indian School Rd NE & Louisiana Rd 6670 Indian School Rd NE Albuquerque, NM 87110

Initial Date: ___08/10/20 Salesperson: Arthur Navarro Coordinator: Lorena Leon **ASena** Designer:_ As noted

CUSTOMER APPROVAL

Customer Signature

COPY, COLORS & SIZES

Signtech does NOT provide primary electrical to sign location -

RESPONSIBILITY OF OTHERS!

Customer Signature

Date

This design is the exclusive property of Signtech and cannot be reproduced in whole or in part, without their prior written approval.

Drawing Number:

20-01032

CHASE 38000P123456 1 Project ID:

Revision:

R13 - 06.08.21

DRC Page

Page:

REVISION NOTES:

R1: Customer Drawing - add additional approval tenant panels - 08.13.20 - AS

R2: Customer Drawing - Added motorcycle post signs and updated site plan. - AS - 09/04/20
R5: Detail Drawing - E7 and 8 changed to stop dot sign. E9 and 10 changed to custom ada handicap signs. - AS - 10/02/20

R7: Detail Drawing - Added two coming soon signs. - AS - 10/15/20

R9: Detail Drawing - Removed signs E25,26,27,28 from scope of work. - AS -10/22/20

R11: Detail Drawing - New site plan updated, HB-U shown at drive-up entrance and added 6 TC-P-A signs. - AS - 06/03/21

R13: Detail Drawing - Added Replacement vinyl for existing D/F Temp Coming Soon signs and 2 coming soon banners. Removed BTWR from E1/4.


TC signs AFF heights updated per Civil engineering. - AS - 06/08/21
R15: Detail Drawing - Site plan updated, E5 location adjusted and copy on signs E11/E12 adjusted to new site plan layout. - AS - 07/20/21

EXTERIOR SIGN LEGEND - ALLOWED

| EXTERIOR SIGN LEGEND - ALLOWED | | | | | | | | | |
|--------------------------------|----------|-------------------------------|--|--------|--|--|--|--|--|
| Elevation | Sign No. | Sign Type | Description | Sq.Ft. | | | | | |
| North | E.1 | LIF-WB0-24 | 24" White Channel Letters and Logo | 36.9 | | | | | |
| West | E.2 | LIF-WBO-24-BTWR | 24" White Channel Letters and Logo - Behind the wall Raceway | 36.9 | | | | | |
| South | E.3 | LIF-WBO-24 | 24" White Channel Letters and Logo | 36.9 | | | | | |
| East | E.4 | LIF-WBO-24 | 24" White Channel Letters and Logo | 36.9 | | | | | |
| | E.5 | HB-U-R | Headache Bar - Right | | | | | | |
| | E.6 | CAN-ATM-SIG-OCT | ATM Signature Canopy w/ Octagon | | | | | | |
| | E.7 | TC-P-STOP-DNE-DOT-RE | Post Mount Do Not Enter Sign - STOP/DOT Standard | | | | | | |
| | E.8 | TC-P-STOP-DNE-DOT-RE | Post Mount Do Not Enter Sign - STOP/DOT Standard | | | | | | |
| | E.9 | CUSTOM TC-P-ADA-NM-V-RE | Post Mount Handicap Stall Sign - Van Accessible - City Specific | | | | | | |
| | E.10 | CUSTOM TC-P-ADA-NM-RE | Post Mount Handicap Stall Sign - City Specific | | | | | | |
| | E.11 | D-7.6-RE | Non-Illuminated Directional Monument | | | | | | |
| | E.12 | D-7.6-RE | Non-Illuminated Directional Monument | | | | | | |
| | E.25-28 | NONE | REMOVED FROM SCOPE OF WORK | | | | | | |
| | E.29 | TC-P-MOTORCYCLE | Post Mount Motorcycle Stall Sign | | | | | | |
| | E.30 | TC-P-MOTORCYCLE | Post Mount Motorcycle Stall Sign | | | | | | |
| | E.31 | COMING SOON | Temporary Construction Site Sign | | | | | | |
| | E.32 | COMING SOON | Temporary Construction Site Sign | | | | | | |
| | E.33-38 | TC-P-A-RE | Post Mount Parking for Bank Patrons Only | | | | | | |
| | E.39-42 | CHA-TEMP-CS-RF-DP-48x96-FALL | Replacement Vinyl for existing Temporary Construction Site Signs | | | | | | |
| | E.43-44 | CHA-TEMP-CS-48x96-BANNER-FALL | Temporary Coming Soon Banner - FALL | | | | | | |
| 147.6 | Total P | roposed Sq Ft | | | | | | | |



INDIAN SCHOOL RD NE

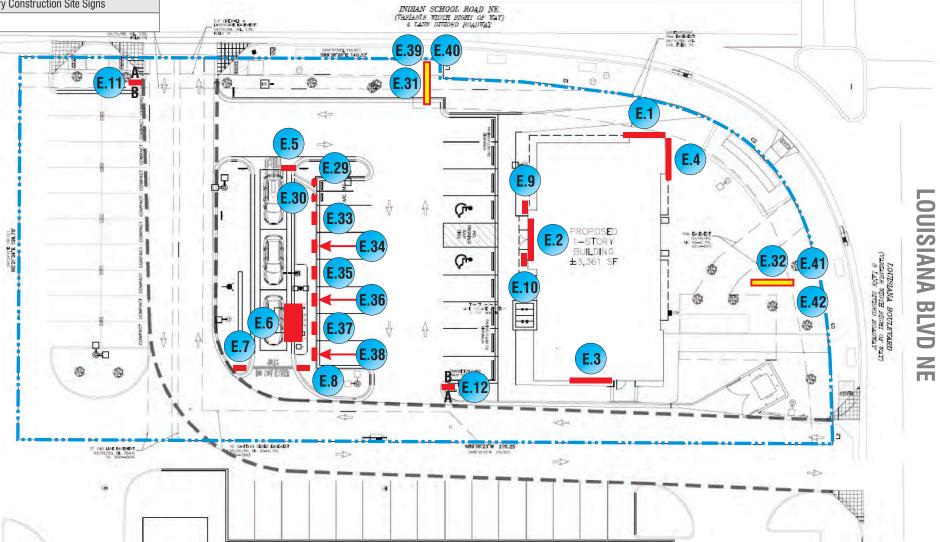

SITE PLAN SCALE: 1/32"=1'-0"

PROPERTY LINE









JP Morgan Chase Bank #38200P367111

Phone: (619) 527-6100 / Fax: (619) 527-6111

Indian School Rd NE & Louisiana Rd 6670 Indian School Rd NE Albuquerque, NM 87110

Initial Date: ____08/10/20
Salesperson: Arthur Navarro
Coordinator: Lorena Leon
Designer: ASena
Scale: As noted

CUSTOMER APPROVAL

Customer Signature

COPY, COLORS & SIZES

Signtech does NOT provide primary electrical to sign location -

RESPONSIBILITY OF OTHERS!

Customer Signature

Date

20-01032

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Drawing Number:

CHASE 38000P123456 1


Project ID:

R13 - 06.08.21

Revision:

Sign Legend / Site Plan

er DRC Page 2

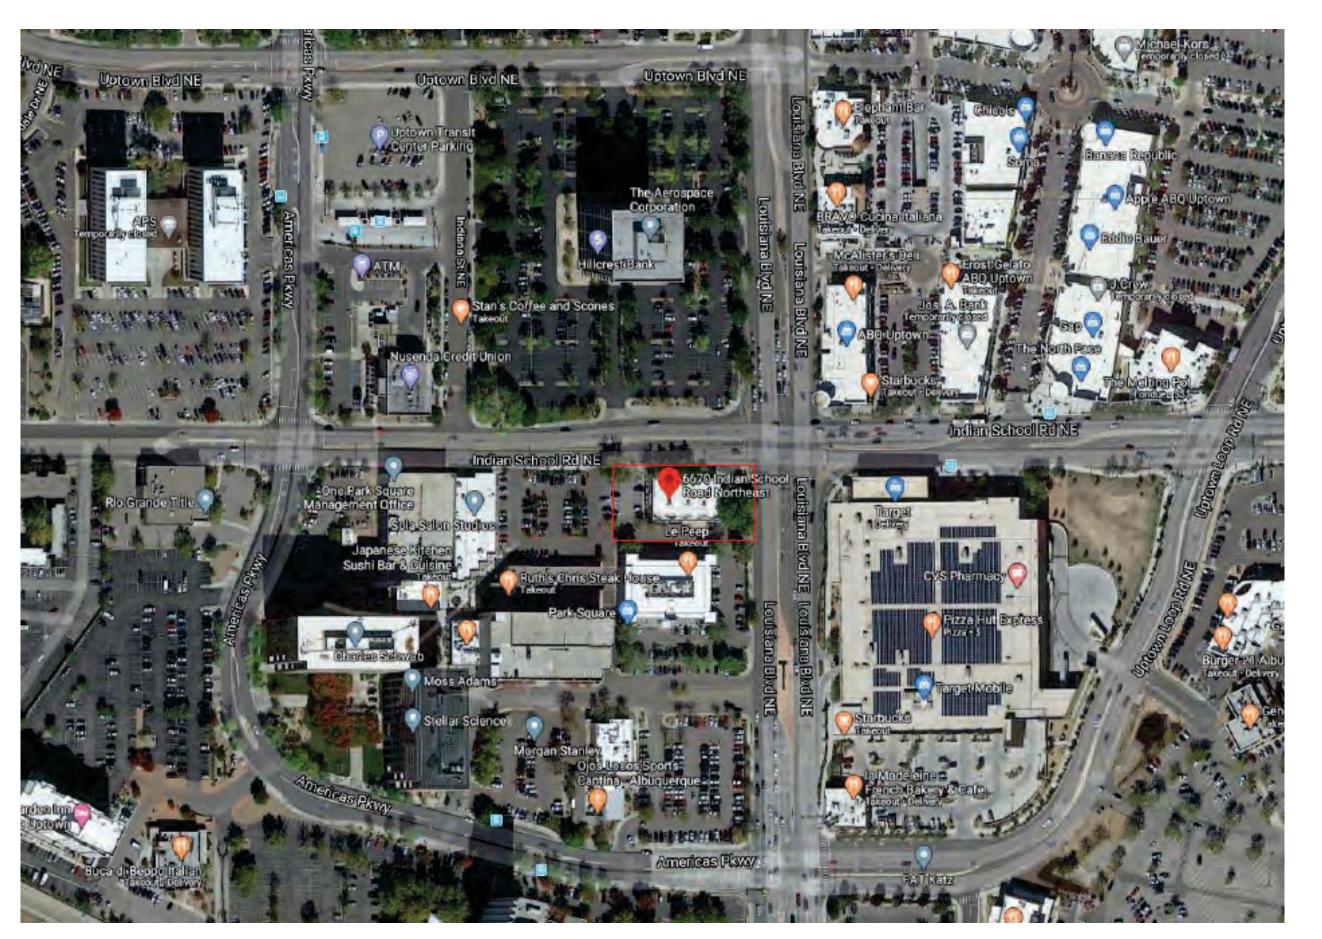



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JP Morgan Chase Bank #38200P367111

Indian School Rd NE & Louisiana Rd 6670 Indian School Rd NE Albuquerque, NM 87110

Initial Date: ___08/10/20 Salesperson: Arthur Navarro Coordinator: Lorena Leon

ASena Designer:_ As noted

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Revision:

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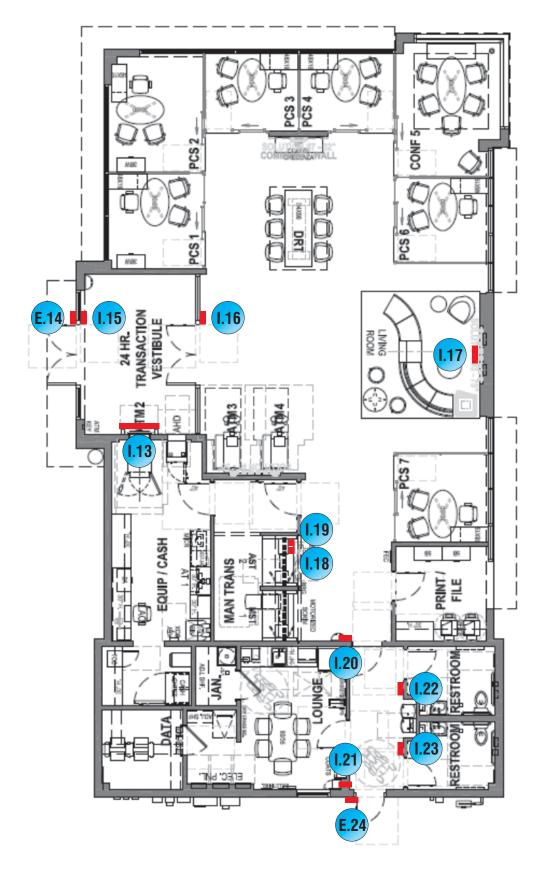
20-01032

Enlarged Aerial Site

DRC Page 3

INTERIOR SIGN LEGEND

| Elevation | Sign No. | Sign Type | Description | Sq.Ft. |
|-----------|----------|----------------|---|--------|
| | I.13 | SUR-TTW-U-4-TP | Universal Thin-Profile ATM Surround | |
| | E.14 | ADA-EP | ADA Accessible Entrance Plaque | |
| | I.15 | ADA-EX | ADA Exit Plaque | |
| | I.16 | ADA-EX | ADA Exit Plaque | |
| | 1.17 | OCT-24-INT | Illuminated Blue Bitro Interior Octagon | |
| | I.18 | ADA-TW | ADA Accessible Teller Window Plaque | |
| | l.19 | ADA-TW-ALS | ADA Assisted Listening System Plaque | |
| | 1.20 | ADA-EEX | ADA Emergency Exit Plaque | |
| | 1.21 | ADA-EEX | ADA Emergency Exit Plaque | |
| | 1.22 | ADA-RRAG-A-G | ADA Accessible All-Gender Restroom Plaque | |
| | 1.23 | ADA-RRAG-A-G | ADA Accessible All-Gender Restroom Plaque | |
| | E.24 | ADA-EO | ADA Exit Only Plaque | |



DESIGN STANDARDS 7B HARDINESS ZONE 20.2 OVERHEAD DOOR ACCEPTABLE *

(1) OFFICE SHALL RECEIVE DUAL MONITORS & ARMS FOR CPC OR FUTURE CPC.

FLOOR PLAN SCALE: 3/32"=1'-0"

DESIGNER DATE 07/02/2020 MJB



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CUSTOMER APPROVAL

As noted

Customer Signature

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Customer Signature

Date

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Drawing Number:

CHASE 38000P123456 1


Project ID: Revision:

R13 - 06.08.21


Sign Legend / Floor Plan

DRC Page 4 Page:


SIGNAGE OVERVIEW - ALLOWED

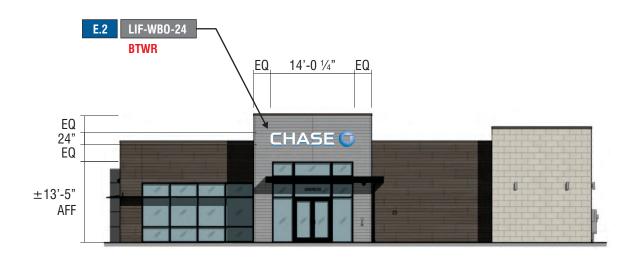


WEST ELEVATION SCALE: 1/16"=1'-0"

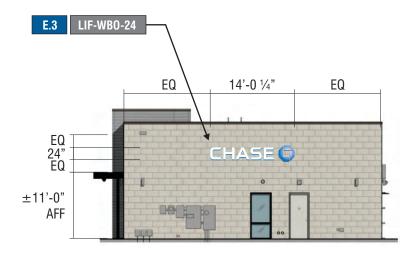

SOUTH ELEVATION SCALE: 1/16"=1'-0"

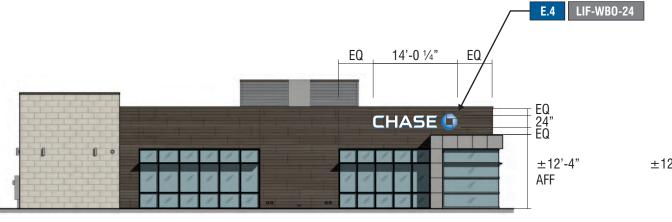

EAST ELEVATION SCALE: 1/16"=1'-0"

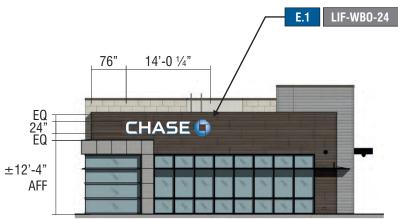

NORTH ELEVATION SCALE: 1/16"=1'-0"







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Scale: As noted

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Date

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Drawing Number:

20-01032


Project ID: CHASE_38000P123456_1

Revision:

R13 - 06.08.21

Exterior Elevations

DRC Page 5

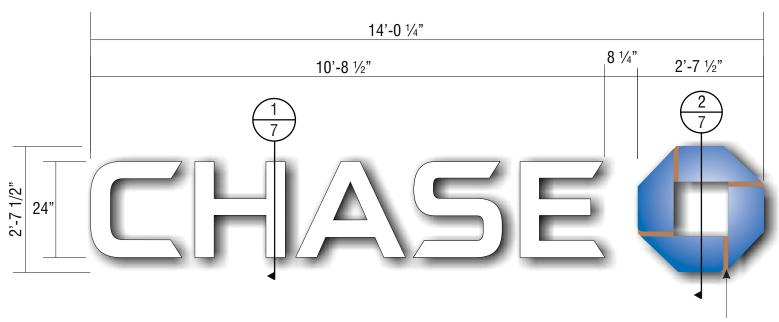


FRONT VIEW

SCALE: 1/2"=1'-0"

PAINT OCTAGON BRIDGE TO MATCH WALL COLOR SW - 7045 INTELLECTUAL GRAY



ENDVIEW
OF LETTER
SCALE: ½"=1'-0"

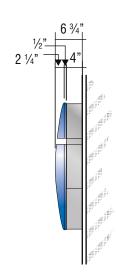

ENDVIEW

OF LOGO

SCALE: ½"=1'-0"

E.2

SIGN TYPE

LIF-WB0-24

BEHIND THE WALL RACEWAY

MANUFACTURE AND INSTALL ONE (1) SETS OF ILLUMINATED LETTERS & LOGO w/PLEX FACES & RETURNS

LETTERS:

FACE: .177" ARISTECH #7328 P-95 WHITE PLEX (MATTE SIDE TO BE 1ST SURFACE) CHEM WELDED TO RETURNS **RETURNS**: 0.118" x 4" DEEP ARISTECH #6046 BLUE WITH 3635-70 DIFFUSER VINYL ON 2ND (INTERIOR) SURFACE.

BACKS: .080" ALUM BACK WITH 3/4" x .080" OUTSIDE ALUM RETURN AND 1/2" x 1/8" ALUM ANGLE CLIPS ON INTERIOR OF LETTER FOR FACE ATTACHMENT

PAINT: EXTERIOR PAINTED MATTHEWS MP-00366 CHASE BLUE SEMI-GLOSS FINISH (60-70 UNITS) AND INTERIOR PAINTED SPRAY-LAT STAR BRITE WHITE LIGHT ENHANCEMENT PAINT.

ILLUMINATION: SLOAN PRISM 7100K #701269-7WSJ1-MB WHITE LEDS AND SLOAN POWER SUPPLY REQUIRED FOR PROPER EVEN ILLUMINATION.

LOGO:

BACKS: .080" ALUM BACK WITH STACK WELDED 4" x .080" ALUM RETURNS.

LOGO CAN FACE: .080" ALUM BRIDGE ELEMENTS WELDED TO INSIDE & OUTSIDE RETURNS

PLEX FACE: .118" THERMO FORMED ARISTECH #6046 BLUE LOGO ELEMENTS CHEM WELDED TO 3/4" CLEAR PLEX 2ND SURFACE FACES.

PAINT: EXTERIOR PAINT MATTHEWS "CHASE NICKEL" #MP-19891 GLOSS FINISH AND INTERIOR PAINTED SPRAY-LAT STAR BRITE WHITE LIGHT ENHANCEMENT PAINT.

ILLUMINATION: SLOAN PRISM #701269-BLSJ1-MB BLUE LEDS AND SLOAN POWER SUPPLY AS REQUIRED FOR PROPER EVEN ILLUMINATION



3D VIEW OF OCTAGON

ALL EXPOSED FASTENER HEADS SHALL BE PAINTED TO MATCH THE EXTERIOR SURFACE FINISH

ELECTRICAL REQUIREMENTS FOR LED ILLUMINATION

As required by standard #2161, Signtech Electrical Advertising, Inc., exclusively uses secondary Ground fault-Interrupted (GFI) transformers.

Each Sign MUST have: - A dedicated branch circuit

- Three wires : Line, Ground, and Neutral.

- Wire Size : Min 12 GA THHN Copper Wire.

NOTE: The gauge of the wire is dictated by the length of the run & amperage as per NEC Article 600.

- The ground wire must be continuous & go from the sign to the panelboard ground bus.



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JP Morgan Chase Bank #38200P367111

Indian School Rd NE & Louisiana Rd 6670 Indian School Rd NE Albuquerque, NM 87110

Initial Date: 08/10/20
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Coordinator: Lorena Leon
Designer: ASena

CUSTOMER APPROVAL

As noted

Customer Signature

Dat

COPY, COLORS & SIZES

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RESPONSIBILITY OF OTHERS!

Customer Signature

Date

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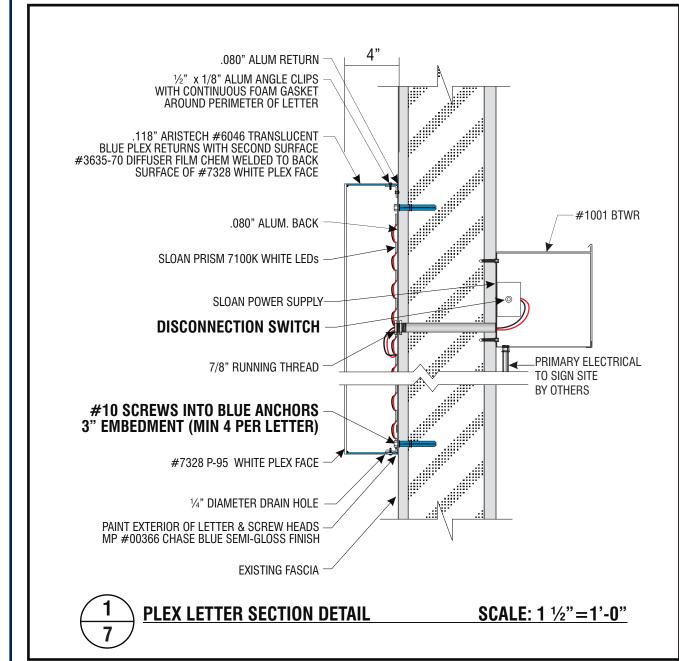
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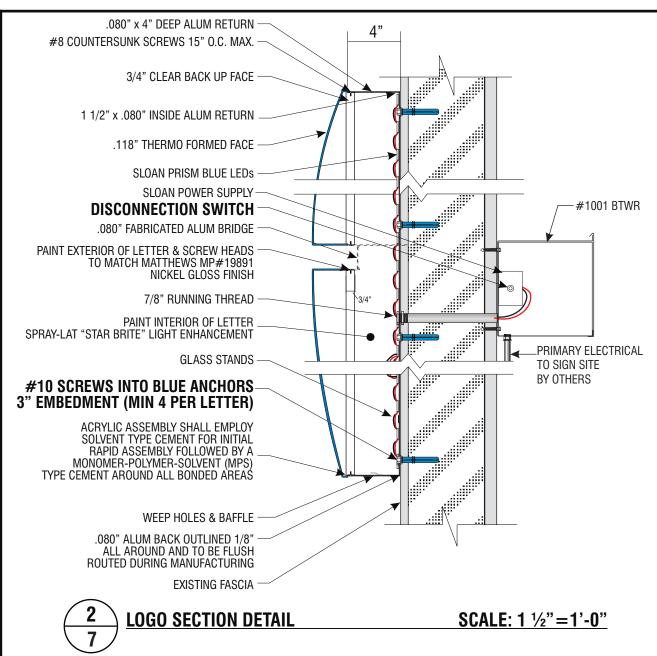
Revision:

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DRC Page 6

ATTACHMENT METHOD TO BE VERIFIED BY INSTALLER AT THE FIELD DEPENDING ON WALL TYPE AND ACCESS.











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JP Morgan Chase Bank #38200P367111

Indian School Rd NE & Louisiana Rd 6670 Indian School Rd NE Albuquerque, NM 87110

Initial Date: __08/10/20 Salesperson: Arthur Navarro Coordinator: Lorena Leon **ASena** Designer:_

CUSTOMER APPROVAL

As noted

Customer Signature

Scale:

COPY, COLORS & SIZES

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Customer Signature

Date

20-01032

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Drawing Number:


CHASE 38000P123456 1

Project ID:

Revision:

R13 - 06.08.21


DRC Page 7

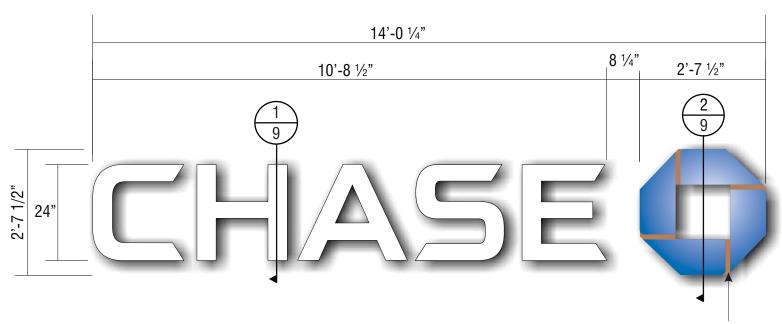


FRONT VIEW

SCALE: 1/2"=1'-0"

PAINT OCTAGON BRIDGE TO MATCH WALL COLOR E.1 AND E.4 - SW 7020 BLACK FOX E.3 SW 6119 ANTIQUE WHITE

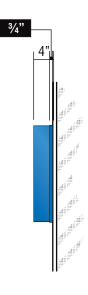

ENDVIEW
OF LETTER
SCALE: ½"=1'-0"

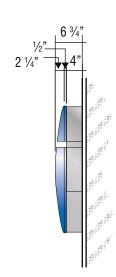

ENDVIEW

OF LOGO

SCALE: 1/2"=1'-0"

 E.1
 E.3
 E.4

 SIGN TYPE
 LIF-WBO-24

MANUFACTURE AND INSTALL THREE (3) SETS OF ILLUMINATED LETTERS & LOGO w/PLEX FACES & RETURNS

LETTERS:

FACE: .177" ARISTECH #7328 P-95 WHITE PLEX (MATTE SIDE TO BE 1ST SURFACE) CHEM WELDED TO RETURNS **RETURNS**: 0.118" x 4" DEEP ARISTECH #6046 BLUE WITH 3635-70 DIFFUSER VINYL ON 2ND (INTERIOR) SURFACE.

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PAINT: EXTERIOR PAINTED MATTHEWS MP-00366 CHASE BLUE SEMI-GLOSS FINISH (60-70 UNITS) AND INTERIOR PAINTED SPRAY-LAT STAR BRITE WHITE LIGHT ENHANCEMENT PAINT.

ILLUMINATION: SLOAN PRISM 7100K #701269-7WSJ1-MB WHITE LEDS AND SLOAN POWER SUPPLY REQUIRED FOR PROPER EVEN ILLUMINATION.

LOGO:

BACKS: .080" ALUM BACK WITH STACK WELDED 4" x .080" ALUM RETURNS.

LOGO CAN FACE: .080" ALUM BRIDGE ELEMENTS WELDED TO INSIDE & OUTSIDE RETURNS

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PAINT: EXTERIOR PAINT MATTHEWS "CHASE NICKEL" #MP-19891 GLOSS FINISH AND INTERIOR PAINTED SPRAY-LAT STAR BRITE WHITE LIGHT ENHANCEMENT PAINT.

ILLUMINATION: SLOAN PRISM #701269-BLSJ1-MB BLUE LEDs AND SLOAN POWER SUPPLY AS REQUIRED FOR PROPER EVEN ILLUMINATION



3D VIEW OF OCTAGON

ALL EXPOSED FASTENER HEADS SHALL BE PAINTED TO MATCH THE EXTERIOR SURFACE FINISH

ELECTRICAL REQUIREMENTS FOR LED ILLUMINATION

As required by standard #2161, Signtech Electrical Advertising, Inc., exclusively uses secondary Ground fault-Interrupted (GFI) transformers.

Each Sign MUST have: - A dedicated branch circuit

- Three wires : Line, Ground, and Neutral.

- Wire Size: Min 12 GA THHN Copper Wire.

NOTE: The gauge of the wire is dictated by the length of the run & amperage as per NEC Article 600.

- The ground wire must be continuous & go from the sign to the panelboard ground bus.







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Designer: ASena
Scale: As noted

CUSTOMER APPROVAL

Customer Signature

CIZEC

COPY, COLORS & SIZES

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Customer Signature

Date

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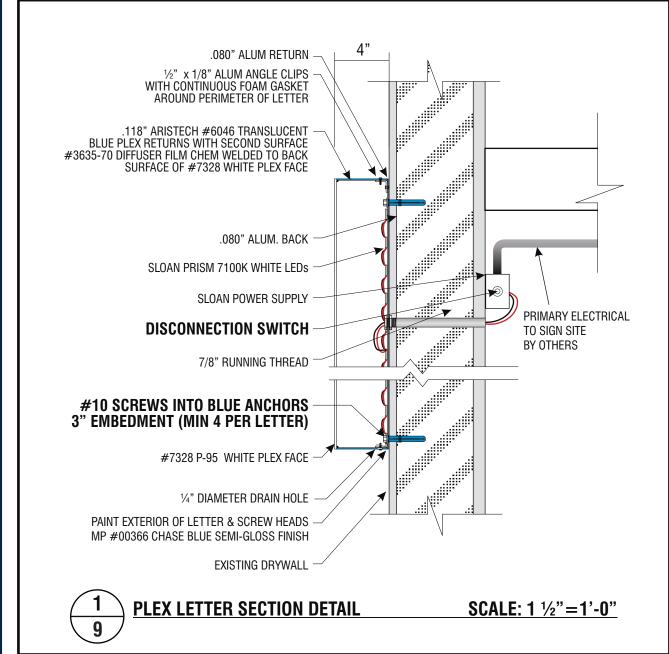
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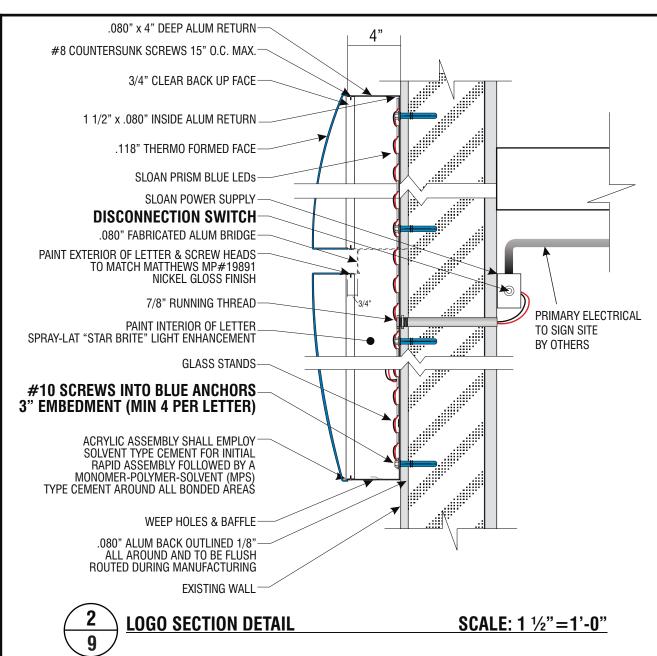
Revision:

R13 - 06.08.21

DRC Page 8

ATTACHMENT METHOD TO BE VERIFIED BY INSTALLER AT THE FIELD DEPENDING ON WALL TYPE AND ACCESS.











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CUSTOMER APPROVAL

As noted

Customer Signature

Scale:

Da

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Date

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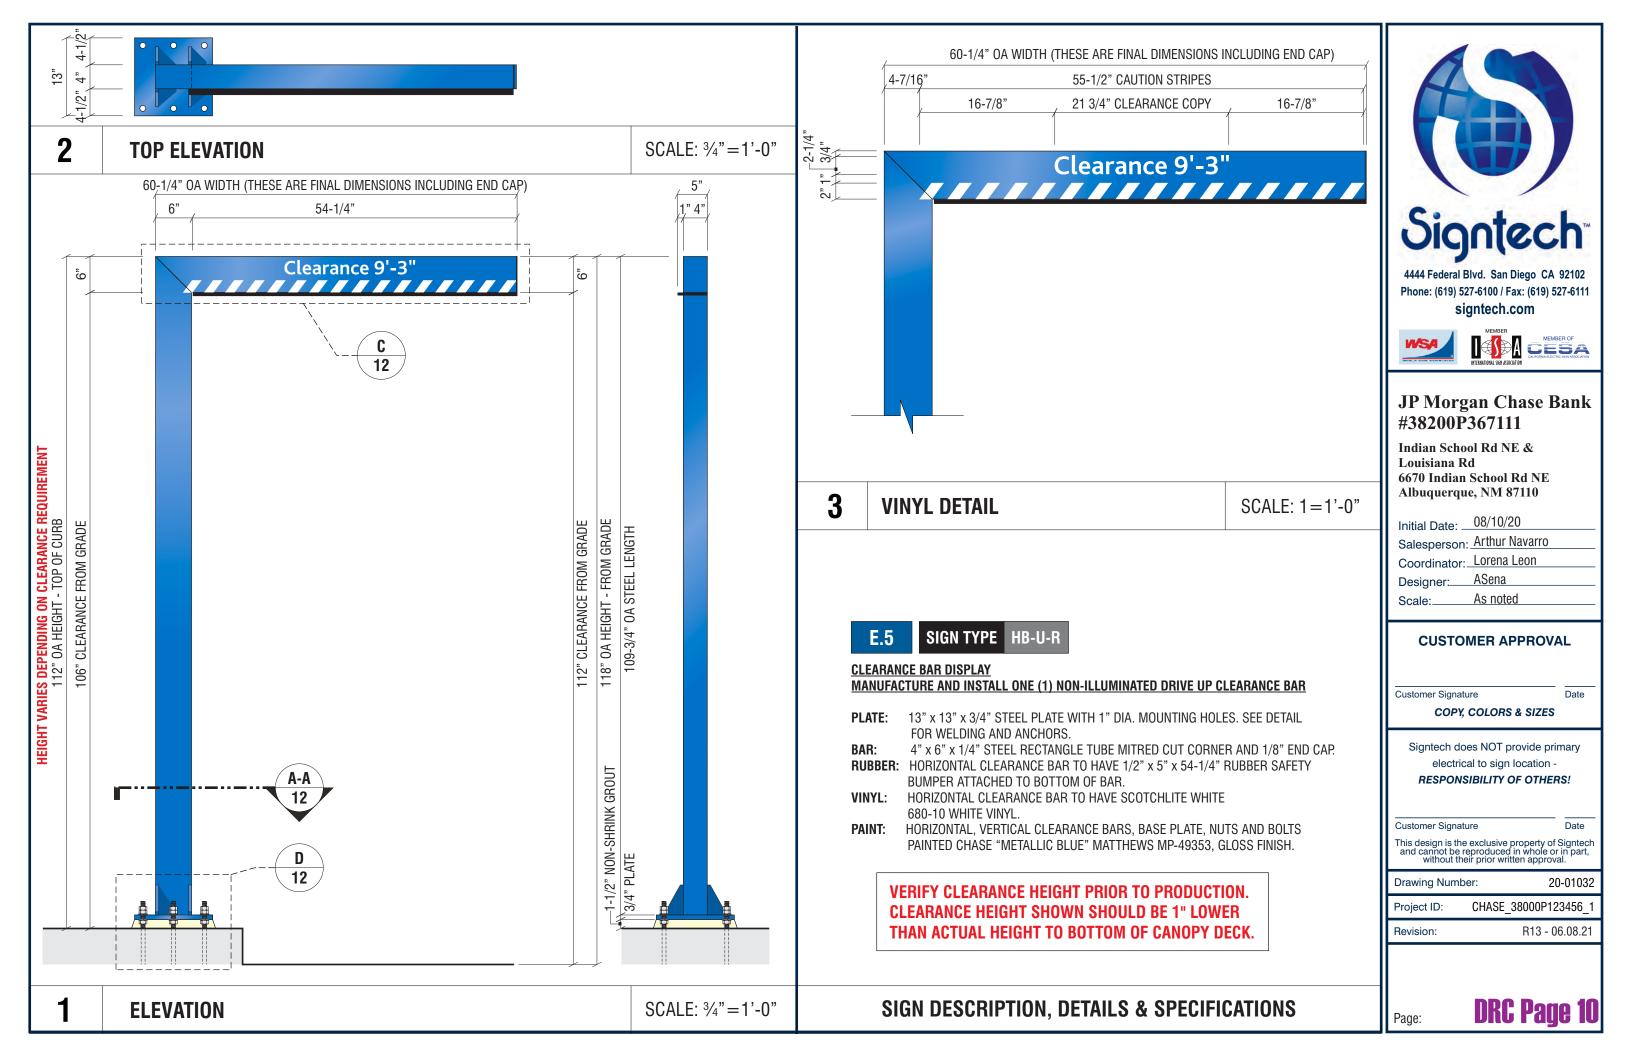
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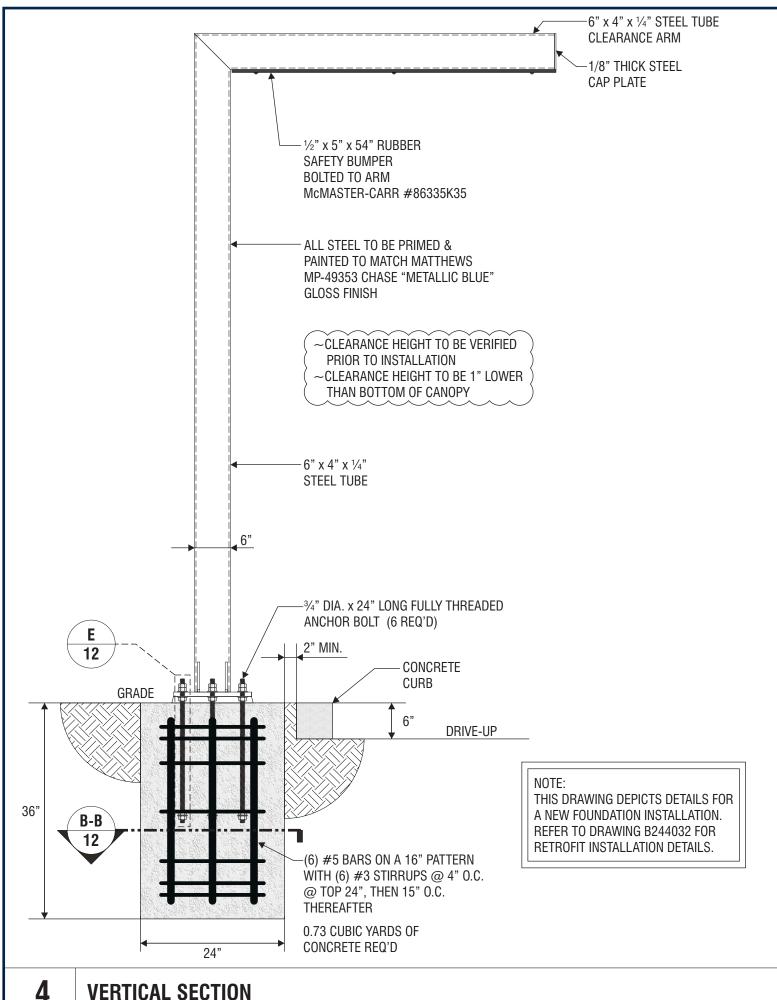
CHASE 38000P123456 1

Project ID: Revision:

R13 - 06.08.21

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NOTES:

- 1. Design is based on guidelines provided by the International Building Code 2006
- 2. Foundation is based on a safe lateral soil bearing pressure minimum of 300 psf per foot of depth. Soil report was not furnished. Allowable bearing pressure should be verified prior to placement of concrete. Do not place foundation in fill.
- 3. Concrete shall be mixed to attain a minimum compressive strength of 3000 psi in 28 days.
- 4. Support member shall be free from defects and shall meet ASTM A500 grade B with a minimum yield strength of 46000 psi for tube. Plate and angle shall meet ASTM A36.
- 5. Structural bolts shall be zinc coated A307 unless otherwise noted.
- 6. Anchor bolts shall be cut from A36 round stock. Exposed surfaces shall be galvanized or coated to prevent corrosion.
- 7. All voids between column base plate and foundation surface shall be completely filled with high strength, non-shrink grout.
- 8. Welds shall be made with E70xx electrodes by persons qualified in accordance with AWS standards within the past two years.
- 9. Steel reinforcing bars shall conform to ASTM 615 grade 60 with deformations in accordance with ASTM A-305. Welding of reinforcing bars is prohibited.
- 10. This design is prototypical and should not be used for site specific applications unless deemed suitable by a competent Professional Engineer.



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Customer Signature

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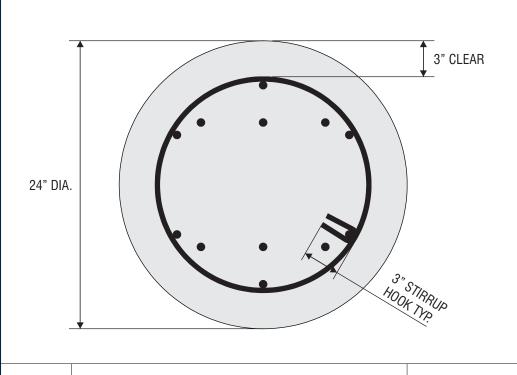
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Revision:


R13 - 06.08.21

DRC Page 11



B-B **SECTION THROUGH CAISSON**


SCALE: 1 ½"=1'-0"

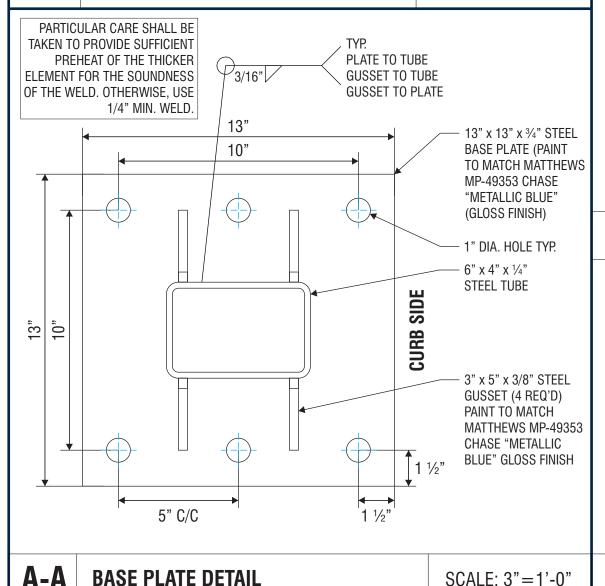


SCALE: 3"=1'-0"

E

PLATE TUBE TO 3/16" TO TUBE 3/16" TUBE 45° MITER 6" x 4" x 1/4" STEEL **JOINT** CLEARANCE ARM OPEN-END NUT-SERT FOR 1/8" THICK STEEL 1/4" DIA. BOLT (3 REQ'D) CAP PLATE · 1/2" x 5" x 54" RUBBER 1/4" DIA. x 1" ROUND SAFETY BUMPER HEAD S.S. BOLT WITH **BOLTED TO ARM** WASHER (3 REQ'D) McMASTER-CARR #86335K35 23" 23" 6" x 4" x 1/4" STEEL TUBE **CLEARANCE ARM DETAIL** SCALE: 1 ½"=1'-0"

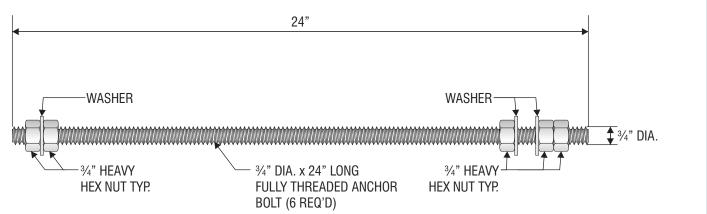

ANCHOR BOLT DETAIL SCALE: 3"=1'-0"

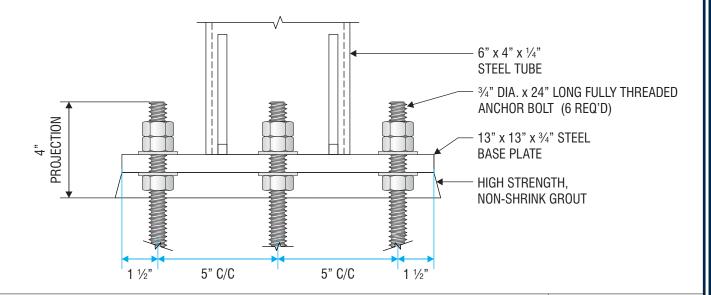







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Initial Date: __08/10/20 Salesperson: Arthur Navarro Coordinator: Lorena Leon **ASena** Designer: As noted

CUSTOMER APPROVAL

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Drawing Number:

CHASE 38000P123456 1

Date

20-01032

Revision:

R13 - 06.08.21

DRC Page 12

ANCHOR BOLT PROJECTION DETAIL SCALE: 3"=1'-0" **GRAPHICS DEPICTED ARE FOR ILLUSTRATIVE PURPOSES ONLY USE ONLY APPROVED** ARTWORK FOR PRODUCTION.

White Diffuser White Translucent Intense Blue Translucent Blue 3M 3632-20 3M 3635-70 3M 3632-127 Aristech 6046


Chase Metallic Blue Paint to match MP-49353 Metallic Gloss Finish

Chase Dark Nickel Paint to match MP-18248

ALL EXPOSED FASTENER HEADS SHALL BE PAINTED TO MATCH THE EXTERIOR CABINET FINISH

Matte Finish

ALL EXPOSED PAINTED SURFACES
SHALL BE COATED WITH MATTHEWS
#282-208SP VOC GLOSS CLEAR, WITH
MINIMUM 2 MILS DRY FILM THICKNESS
(DFT) PER MATTHEWS APPLICATION
SPECIFICATIONS SPECIFICATIONS.

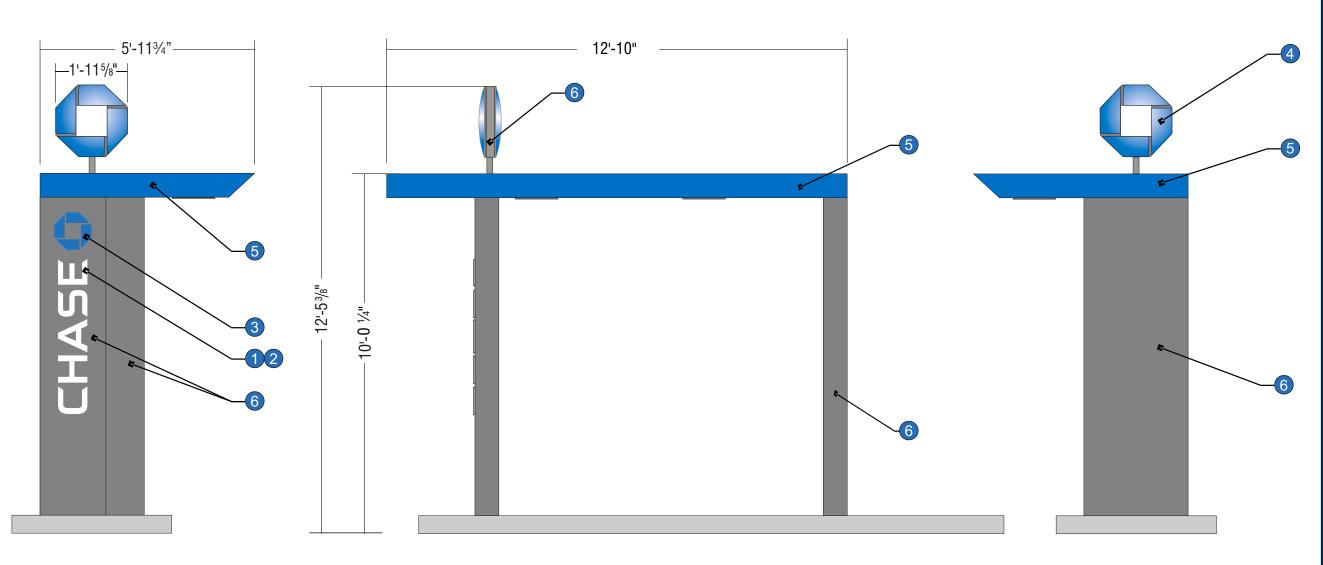

APPROACH ELEVATION

SCALE: 3/8" = 1'-0"

FRONT VIEW CAN-ATM

DEPARTURE ELEVATION SCALE: 3/8" = 1'-0"

SCALE: 3/8" = 1'-0"

SIGN TYPE CAN-ATM-SIG-OCT

MANUFACTURE AND INSTALL ONE (1) ILLUMINATED SIGNATURE ATM CANOPY w/ OCTAGON

2/24/20 MOVED CANOPY ELECT. TRR IK







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CUSTOMER APPROVAL

Customer Signature

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20-01032


Date

CHASE 38000P123456 1 Project ID:

Revision:


R13 - 06.08.21

DRC Page 13

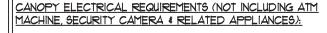

LEDS: (41) 1100°K WHITE SLOAN PRISM #101269-1WSJI-MB (43) BLUE SLOAN PRISM #701269-BLGJI-MB DOWNLIGHTS: (2) E-CONOLIGHT 5000K WHITE LED LIGHT FIXTURE *C-CP-B-SQ-4L-50K-WH @ 0.30A LED POWER SUPPLY: (3) SLOAN #701507-60C1 @ 0.70A TOTAL LOAD: 2.70 AMPS @ 120VAC CIRCUITS: (1) 20 AMP REQ'D.


ALL EXPOSED PAINTED SURFACES SHALL BE COATED WITH MATTHEWS *282-2086P VOC GLOSS CLEAR, WITH MINIMUM 2 MILS DRY FILM THICKNESS (DFT) PER MATTHEWS APPLICATION SPECIFICATIONS.

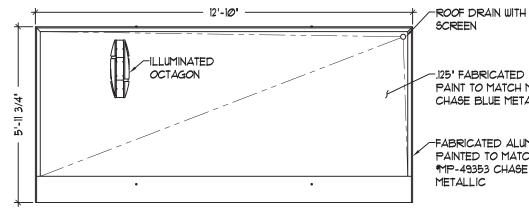

-.125" FABRICATED ALUM. ROOF PANEL PAINT TO MATCH MATTHEWS *MP-49353 CHASE BLUE METALLIC GLOSS FINISH

-FABRICATED ALUM. CANOPY PAINTED TO MATCH MATTEWS MP-49353 CHASE BLUE METALLIC

TOP VIEW

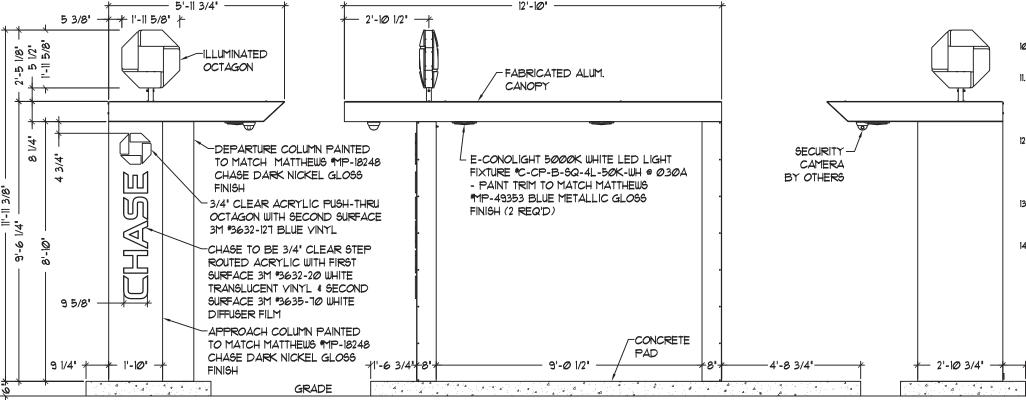

ELEVATION

General Notes:

- Design is based on a 115 mph, 3 second gust wind design per
- IBC 2015, Category II, Exposure C. 40ps Ground Snow Load. Spread foundation is based on a presumptive safe vertical soil bearing pressure minimum of 7
- A soil report was not provided. Foundation analysis assumes Soil Classification 4. Allowable bearing pressure should be verified prior to placement of concrete. In the event that the stated requirements are not met and conditions appear deleterious, cease and secure excavation and immediately contact the project manager.
 Foundation shall not be placed at the top of, or on the side
- of a slope exceeding 3:1, or adjacent to a fill slope unless re-evaluated by a competent Professional Engineer. Do not place foundation in fill."
- Concrete shall be mixed to attain a minimum 28 day compressive strength of 3000 psi.
- Steel reinforcing bars shall conform to ASTM A615, Grade 60 with deformations in accordance with ASTM A305. Welding of reinforcing bars is prohibited.
- All voids between column base plate and foundation surface shall be completely filled with high-strength, non-shrink grout.

 Anchor bolts shall meet ASTM F1554 Grade 36. Exposed
- surfaces shall be galvanized or coated to prevent corrosion.
- 9. All support members shall be free from defects. Steel tube shall meet ASTM A500 Grade B with a minimum yield strength of 46000 psi. Steel angle, channel and plate shall meet ASTM A36. Extruded aluminum shapes shall be 6061-76 alloy. Aluminum sheet shall be 3003-HI4 alloy. Aluminum plate shall be 5052-H34 alloy.

 Welds shall be made with E70xx low hydrogen electrodes for
- steel 4 with 5356 filler for aluminum by persons qualified in accordance with AWS standards within the past two years.
- All structural bolts shall conform to ASTM A325, and be zinc coated unless noted otherwise. When used with structural bolts, heavy hex nuts shall conform to ASTM A563, and washers shall conform to ASTM F436. Pretension all high strength bolts using the Turn-of-Nut method unless noted
- JP Morgan Chase will not be responsible for the safety on this job site before, during or after installation of this structure. It is the responsibility of the contractors and installers to ensure that the installation and erection of this structure is performed using methods that are in full compliance with OSHA regulations.
- Any deviation from this design or from any part of this drawing, including the General Notes, without prior written consent from JP Morgan Chase voids this drawing in its
- 14. This design is prototypical and should not be used for site specific applications unless reviewed and deemed suitible for use at that site by a competent Professional Engineer.

9 1/4"

DEPARTURE ELEVATION









JP Morgan Chase Bank #38200P367111

Indian School Rd NE & Louisiana Rd 6670 Indian School Rd NE Albuquerque, NM 87110

Initial Date: __08/10/20 Salesperson: Arthur Navarro Coordinator: Lorena Leon <u>ASena</u> Designer:_

As noted Scale:.

CUSTOMER APPROVAL

Customer Signature

COPY. COLORS & SIZES

Signtech does NOT provide primary electrical to sign location -

RESPONSIBILITY OF OTHERS!

Customer Signature

Date

20-01032

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Drawing Number:

CHASE 38000P123456 1


Project ID: Revision:

R13 - 06.08.21

6/5/20 - CHANGED #E-CSA04A-W50W LIGHT FIXTURE TO THE *C-CP-B-SQ-4L-50K-WH LIGHT FIXTURE

APPROACH ELEVATION

BOLLARDS TO BE MANUFACTURED / INSTALLED BY OTHERS

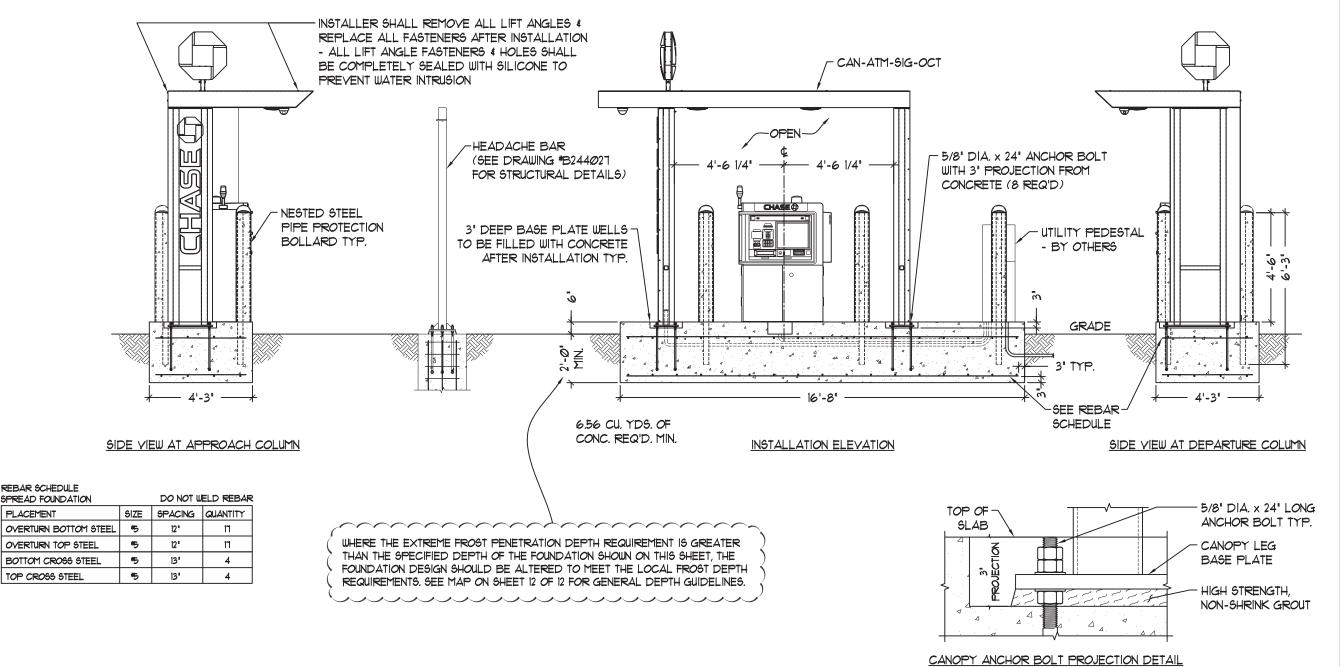







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JP Morgan Chase Bank #38200P367111

Indian School Rd NE & Louisiana Rd 6670 Indian School Rd NE Albuquerque, NM 87110

Initial Date: ___08/10/20 Salesperson: Arthur Navarro Coordinator: Lorena Leon **ASena** Designer:_ Scale:. As noted

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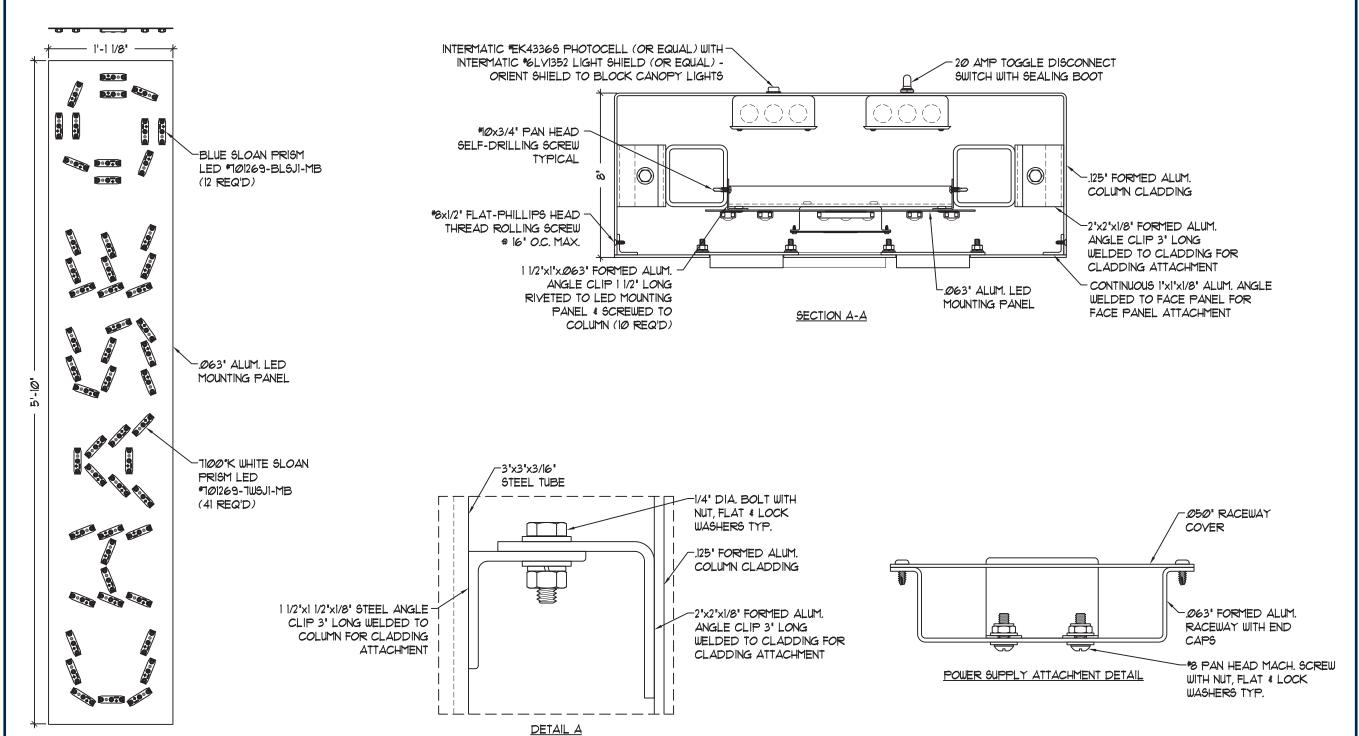
CHASE 38000P123456 1

Revision:

R13 - 06.08.21

DRC Page 15

6/5/20 - CHANGED #E-CSA04A-W50W LIGHT FIXTURE TO THE *C-CP-B-SQ-4L-50K-WH LIGHT FIXTURE





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JP Morgan Chase Bank #38200P367111

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CUSTOMER APPROVAL

As noted

Customer Signature

Scale:_

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Project ID:

Revision:


R13 - 06.08.21

6/5/20 - CHANGED *E-CSAO4A-W5OW LIGHT FIXTURE TO THE *C-CP-B-SQ-4L-50K-WH LIGHT FIXTURE

LED MOUNTING PANEL DETAIL

DRC Page 16

BOLLARDS TO BE MANUFACTURED / INSTALLED BY OTHERS

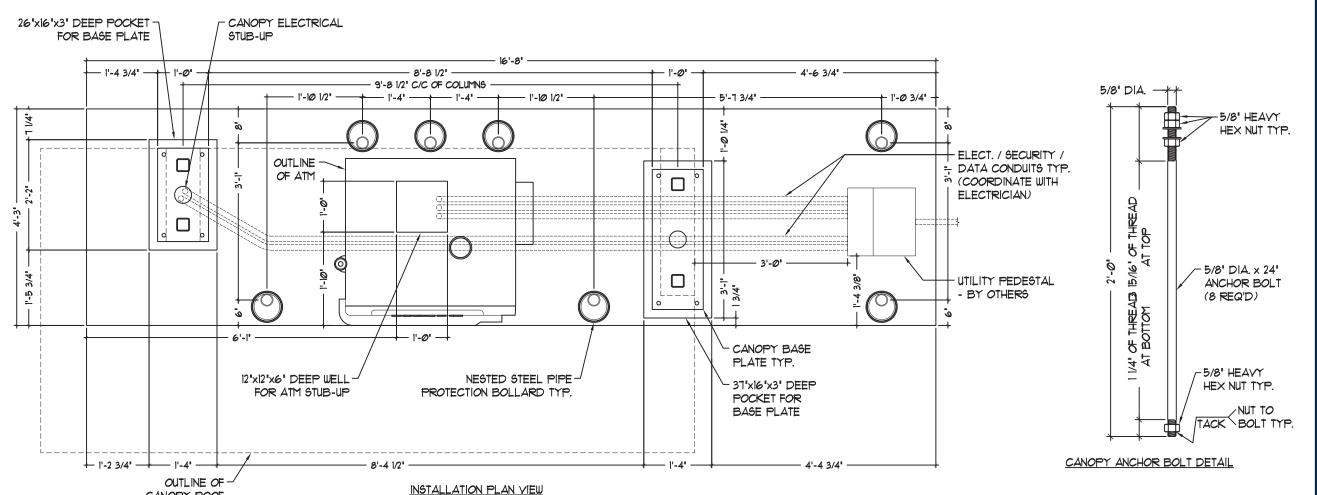

CONDUITS ARE TO BE PROVIDED & SET BY THE ELECTRICIAN PRIOR TO THE PLACEMENT OF CONCRETE







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JP Morgan Chase Bank #38200P367111

Indian School Rd NE & Louisiana Rd 6670 Indian School Rd NE Albuquerque, NM 87110

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CUSTOMER APPROVAL

Customer Signature

COPY, COLORS & SIZES

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Customer Signature

Date

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20-01032

Project ID: Revision:


Page:

R13 - 06.08.21

DRC Page 17

6/5/20 - CHANGED #E-CSA04A-W50W LIGHT FIXTURE TO THE *C-CP-B-5Q-4L-5ØK-WH LIGHT FIXTURE

CANOPY ROOF

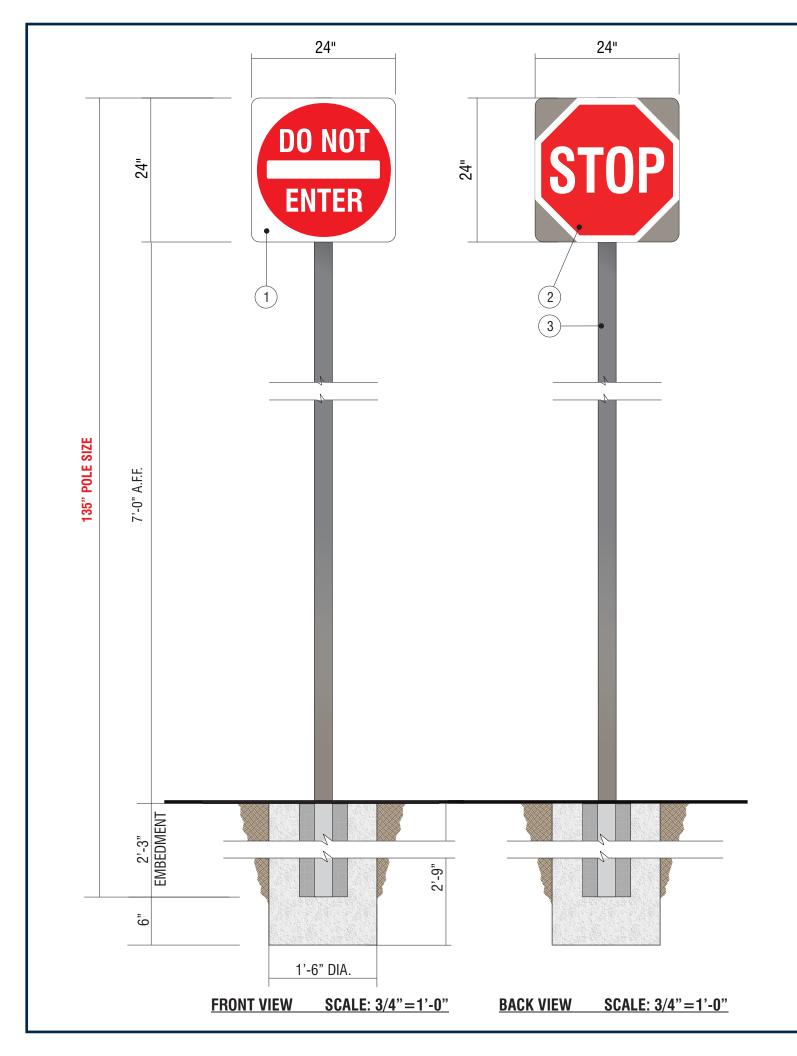


E.7 E.8

SIGN TYPE

CUSTOM TC-P-H DOT STOP/DO NOT ENTER

MANUFACTURE AND INSTALL TWO (2) D/F NON-ILLUMINATED SIGNS

- 1. .125" ALUMINUM SIGN FACE, D.O.T. STANDARD "DO NOT ENTER" PAINT FINISH BACK SIDE SURFACE DARK NICKEL MATTHEWS MP #18248, GLOSS FINISH.
- 2. .125" ALUMINUM SIGN FACE, D.O.T. STANDARD "STOP" PAINT FINISH BACK SIDE SURFACE DARK NICKEL MATTHEWS MP #18248, GLOSS FINISH.
- **3.** SQ. ALUM. TUBE POST, **3"** x **3"** x **1/8"** x **135"** LONG W/ .063" THICK ALUM. CAP PLATE @ TOP.

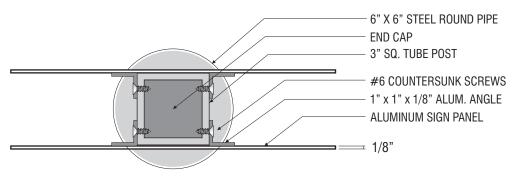

TOP SECTION SCALE: 1"=1'-0"







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JP Morgan Chase Bank #38200P367111

Indian School Rd NE & Louisiana Rd 6670 Indian School Rd NE Albuquerque, NM 87110

Initial Date: 08/10/20
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Coordinator: Lorena Leon
Designer: ASena
Scale: As noted

CUSTOMER APPROVAL

Customer Signature

COPY, COLORS & SIZES

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RESPONSIBILITY OF OTHERS!

Customer Signature

Date

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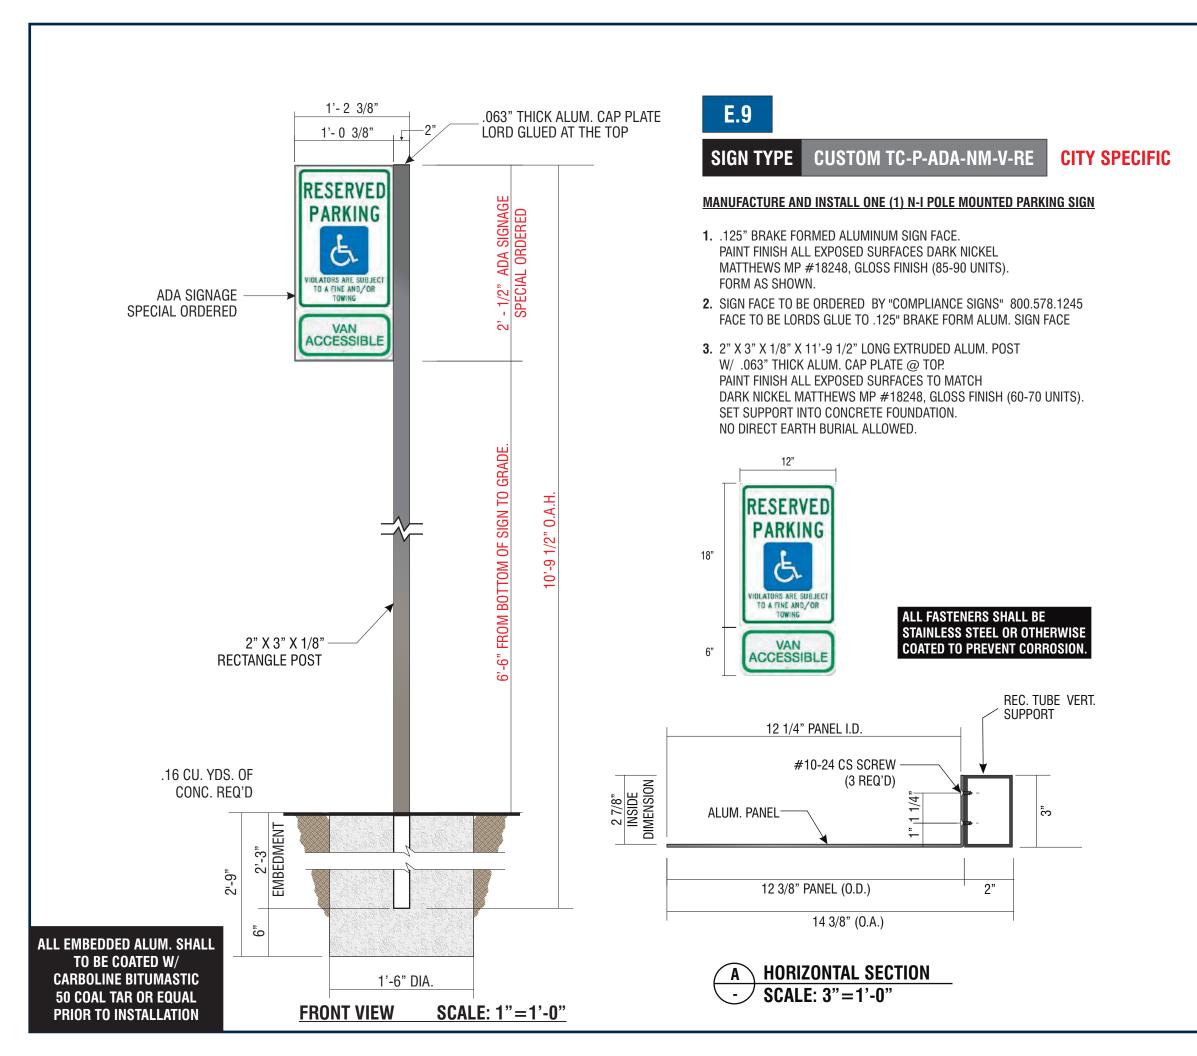
Project ID:

Revision:

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Page:

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JP Morgan Chase Bank #38200P367111

Indian School Rd NE & Louisiana Rd 6670 Indian School Rd NE Albuquerque, NM 87110

Initial Date: ___08/10/20 Salesperson: Arthur Navarro Coordinator: Lorena Leon **ASena** Designer:_ As noted

CUSTOMER APPROVAL

Customer Signature

COPY, COLORS & SIZES

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Customer Signature

Date

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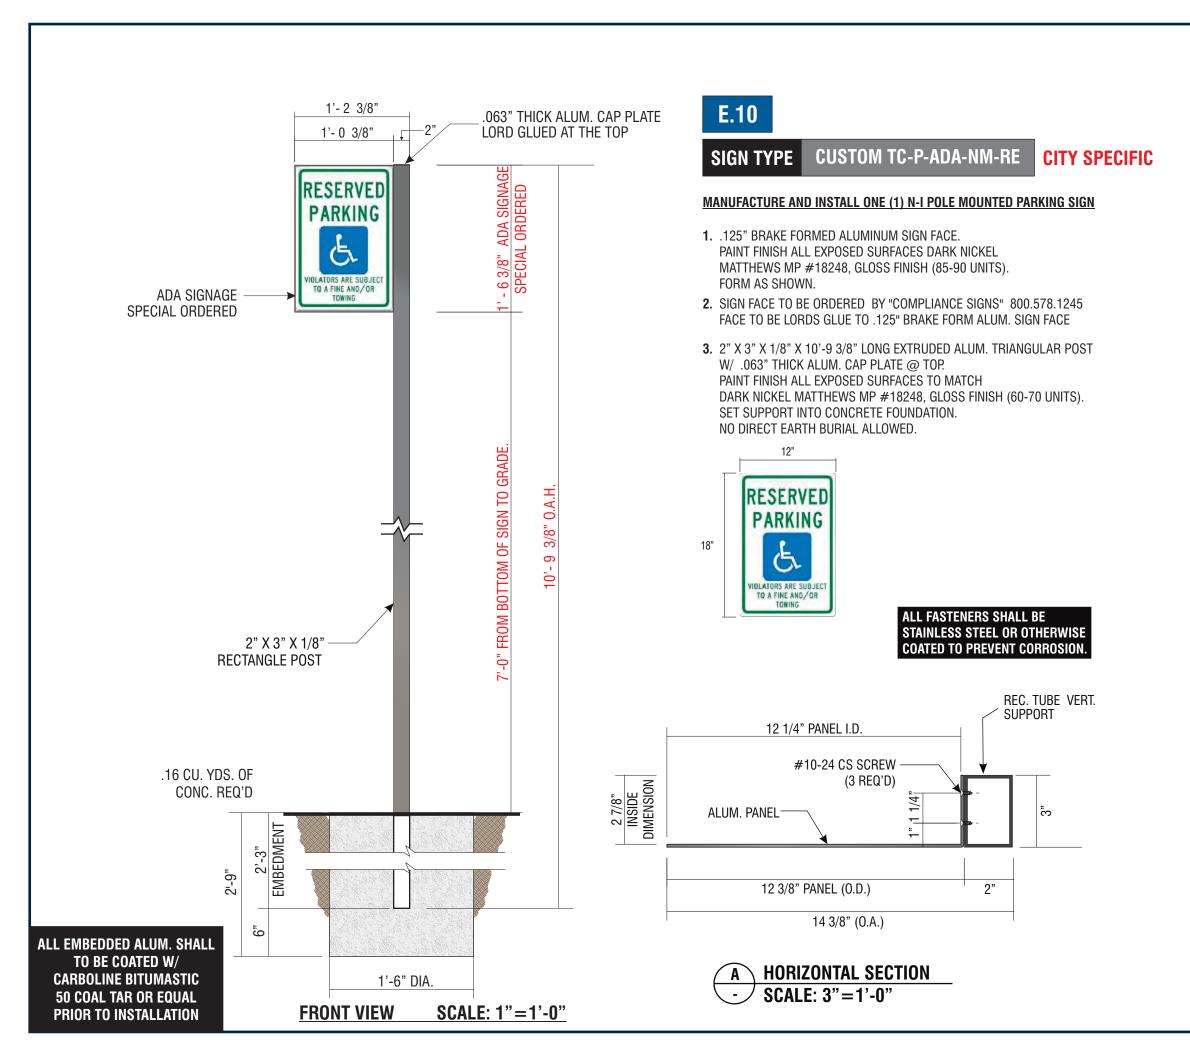
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Revision:

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CUSTOMER APPROVAL

As noted

Customer Signature

COPY, COLORS & SIZES

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Customer Signature

Date

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Drawing Number:

CHASE 38000P123456 1


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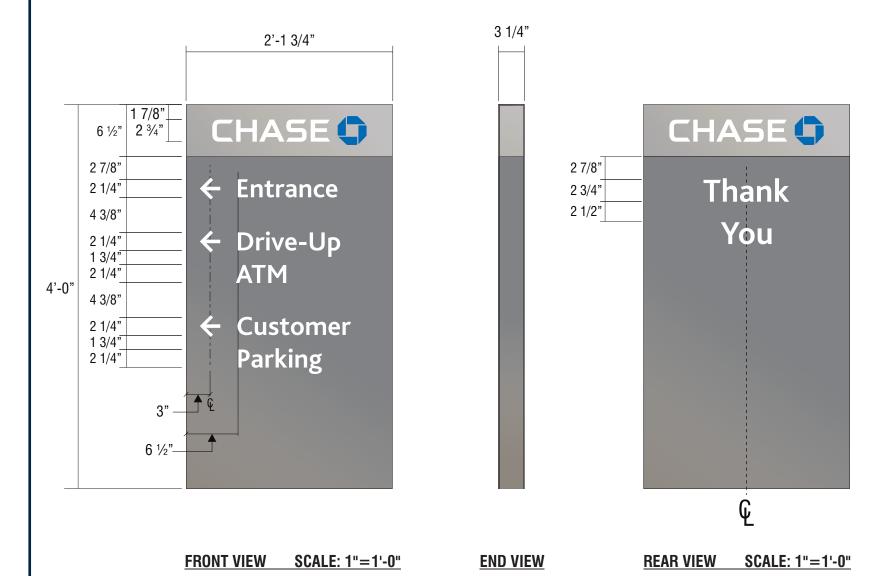
Revision:

R13 - 06.08.21

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TOP VIEW SCALE: 1"=1'-0"



SIGN TYPE D-7.6-RE

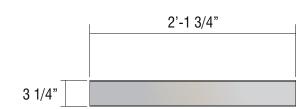MANUFACTURE & INSTALL ONE (1) NON-ILLUMINATED **DIRECTIONAL SIGN**

FACES: .125" THICK ALUMINUM FACES, QUARTER ROUNDED. TOP PORTION: PAINT CHASE NICKEL #19891, GLOSS FINISH. BOTTOM PORTION: PAINT CHASE DARK NICKEL #18248, GLOSS FINISH.

CHASE COPY: 3M #7725-10 WHITE VINYL.

OCTAGON: 3M #3632-127 BLUE OVER #7725-10 WHITE. SECONDARY COPY/ARROWS: TO BE 3M SCOTCHLITE #680-10

REFLECTIVE WHITE VINYL

POSTS: 2" X 3" X.125" RECTANGLE TUBE POSTS.

TOP PORTION: CONTINUOUS BAND TO BE PAINTED NICKEL

#19891, GLOSS FINISH.

BOTTOM PORTION: PAINT CHASE DARK NICKEL #18248,

GLOSS FINISH.

TOP CAP: .125" ALUMINUM PAINTED CHASE NICKEL #19891, GLOSS FINISH.







JP Morgan Chase Bank #38200P367111

Indian School Rd NE & Louisiana Rd 6670 Indian School Rd NE Albuquerque, NM 87110

Initial Date: __08/10/20 Salesperson: Arthur Navarro Coordinator: Lorena Leon **ASena** Designer:__ As noted Scale:_

CUSTOMER APPROVAL

Customer Signature

COPY, COLORS & SIZES

Signtech does NOT provide primary electrical to sign location -

RESPONSIBILITY OF OTHERS!

Customer Signature

Date

20-01032

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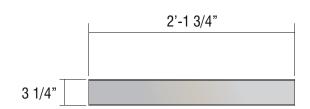
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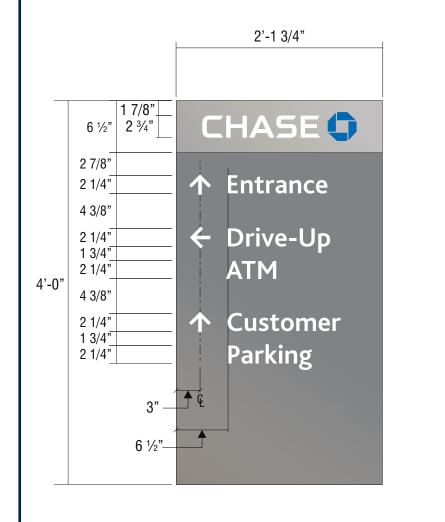
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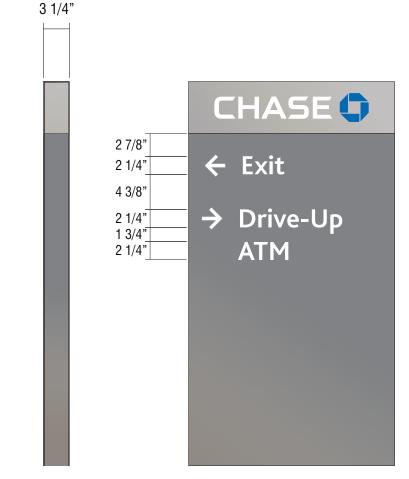
R13 - 06.08.21

DRC Page 2



TOP VIEW SCALE: 1"=1'-0"





FRONT VIEW SCALE: 1"=1'-0" END VIEW REAR VIEW SCALE: 1"=1'-0"

E.12 SIGN TYPE D-7.6-RE

MANUFACTURE & INSTALL ONE (1) NON-ILLUMINATED DIRECTIONAL SIGN

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GLOSS FINISH.

TOP CAP: .125" ALUMINUM PAINTED CHASE NICKEL

#19891, GLOSS FINISH.







JP Morgan Chase Bank #38200P367111

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Salesperson: Arthur Navarro
Coordinator: Lorena Leon
Designer: ASena
Scale: As noted

CUSTOMER APPROVAL

Customer Signature

COPY, COLORS & SIZES

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Customer Signature

Date

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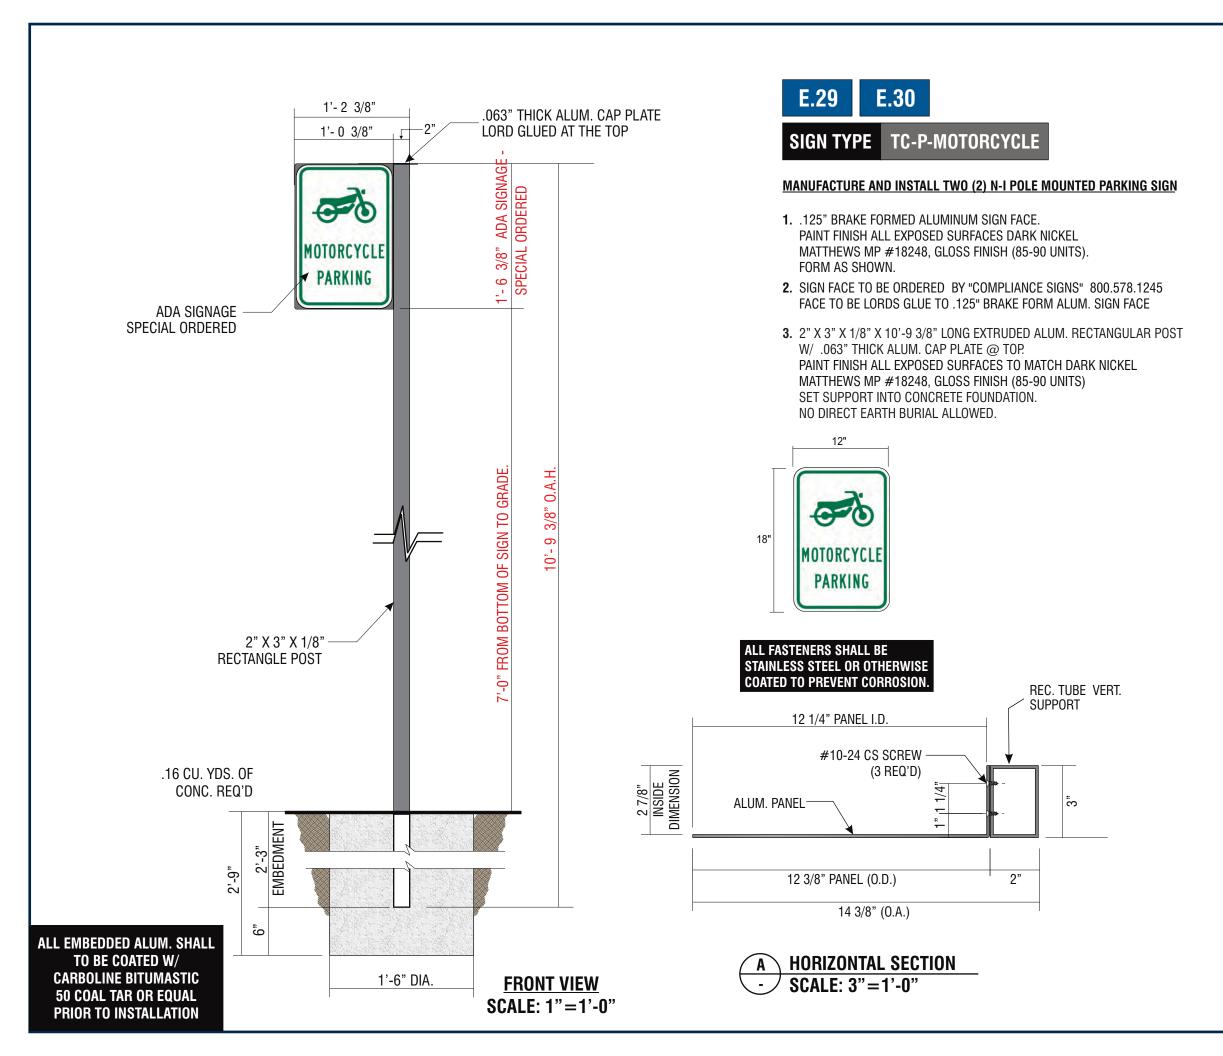
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CHASE_38000P123456_1

Revision:

R13 - 06.08.21

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JP Morgan Chase Bank #38200P367111

Indian School Rd NE & Louisiana Rd 6670 Indian School Rd NE Albuquerque, NM 87110

Initial Date: __08/10/20 Salesperson: Arthur Navarro Coordinator: Lorena Leon

ASena Designer:_ Scale: As noted

CUSTOMER APPROVAL

Customer Signature

COPY, COLORS & SIZES

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Customer Signature

Date

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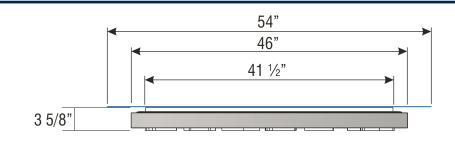
20-01032

CHASE 38000P123456 1 Project ID:

Revision:

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STIPPLE FINISH PAINT PROCESS FOR MATTHEWS #MP-18101 CHASE NICKEL: BASE COAT: * 3-4 MEDIUM COATS OF MAP SVOC2471 FOR BASE COAT. ALLOW TO AIR DRY 12-24 HRS OR FORCE DRY AT 200 DEG. F. FOR 15MIN

STIPPLE FINISH COAT:* MIX MAP SVOC1761 WITH CATALYST BUT *NO* REDUCER; SET PRESSURE POT AT 18-20 PSI TANK PRESSURE AND 20-25 PSI ATOMIZING AIR AT THE PAINT GUN USE 1.0 TO 1.2 FLUID NOZZLE.

STIPPLE FINISH PAINT PROCESS FOR MATTHEWS #MP-49353 CHASE BLUE METALLIC: BASE COAT:* 3-4 MEDIUM COATS OF SVOC2472 SP FOR BASE COAT. ALLOW TO AIR DRY 12-24 HRS OR FORCE DRY AT 200 DEG. F. FOR 15MIN STIPPLE FINISH COAT:* MIX MAP SVOC2049 SP WITH CATALYST BUT_*NO*_REDUCER; SET PRESSURE POT AT 18-20 PSI TANK PRESSURE AND 20-25 PSI ATOMIZING AIR AT THE PAINT GUN USE 1.0 TO 1.2 FLUID NOZZLE. APPLY 5-6 PASSES OF A FINE TIGHT STIPPLE

TOP VIEW SUR-TTW-U-4 SCALE: 3/4" = 1'-0"


NOTE: PUSH-THRU ACRYLIC SHALL HAVE A MILL FINISH ON ALL ROUTED EDGES


APPLY 5-6 PASSES OF A FINE TIGHT STIPPL

ALL EXPOSED FASTENER HEADS SHALL BE PAINTED TO MATCH THE **EXTERIOR CABINET FINISH**

SLOAN BLUE LED STRIPE AROUND PERIMETER TO PROVIDE HALO-LIT EFFECT AGAINST BACK PANEL

GRAPHICS DEPICTED ARE FOR I LLUSTRATIVE PURPOSES ONLY! USE ONLY APPROVED ARTWORK FOR PRODUCTION.

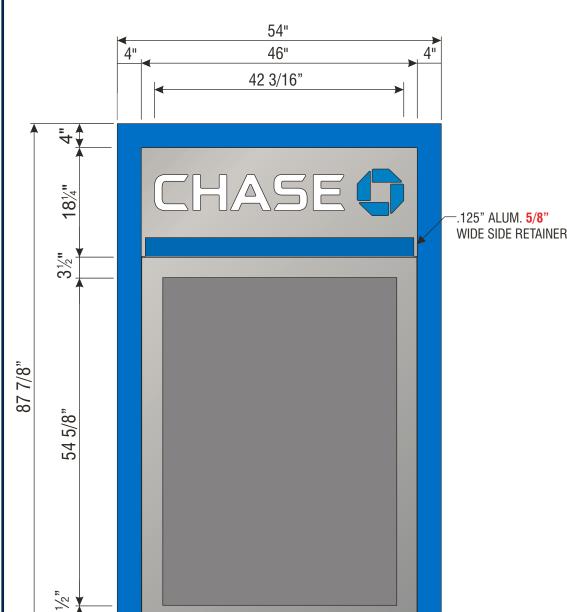

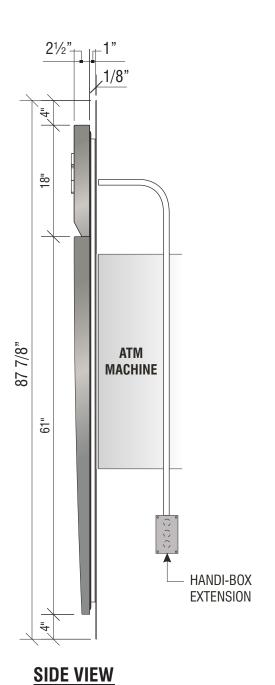



FRONT VIEW SCALE: 3/4"=1'-0"

 \Im

SIGN TYPE SUR-TTW-U-4-TP

MANUFACTURE AND INSTALL ONE (1) INTERNALLY ILLUMINATED THIN PROFILE ATM SURROUND

PERSPECTIVE VIEW



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JP Morgan Chase Bank #38200P367111

Indian School Rd NE & Louisiana Rd 6670 Indian School Rd NE Albuquerque, NM 87110

Initial Date: ___08/10/20 Salesperson: Arthur Navarro Coordinator: Lorena Leon **ASena** Designer:_ As noted

CUSTOMER APPROVAL

Customer Signature

COPY, COLORS & SIZES

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RESPONSIBILITY OF OTHERS!

Customer Signature

Date

20-01032

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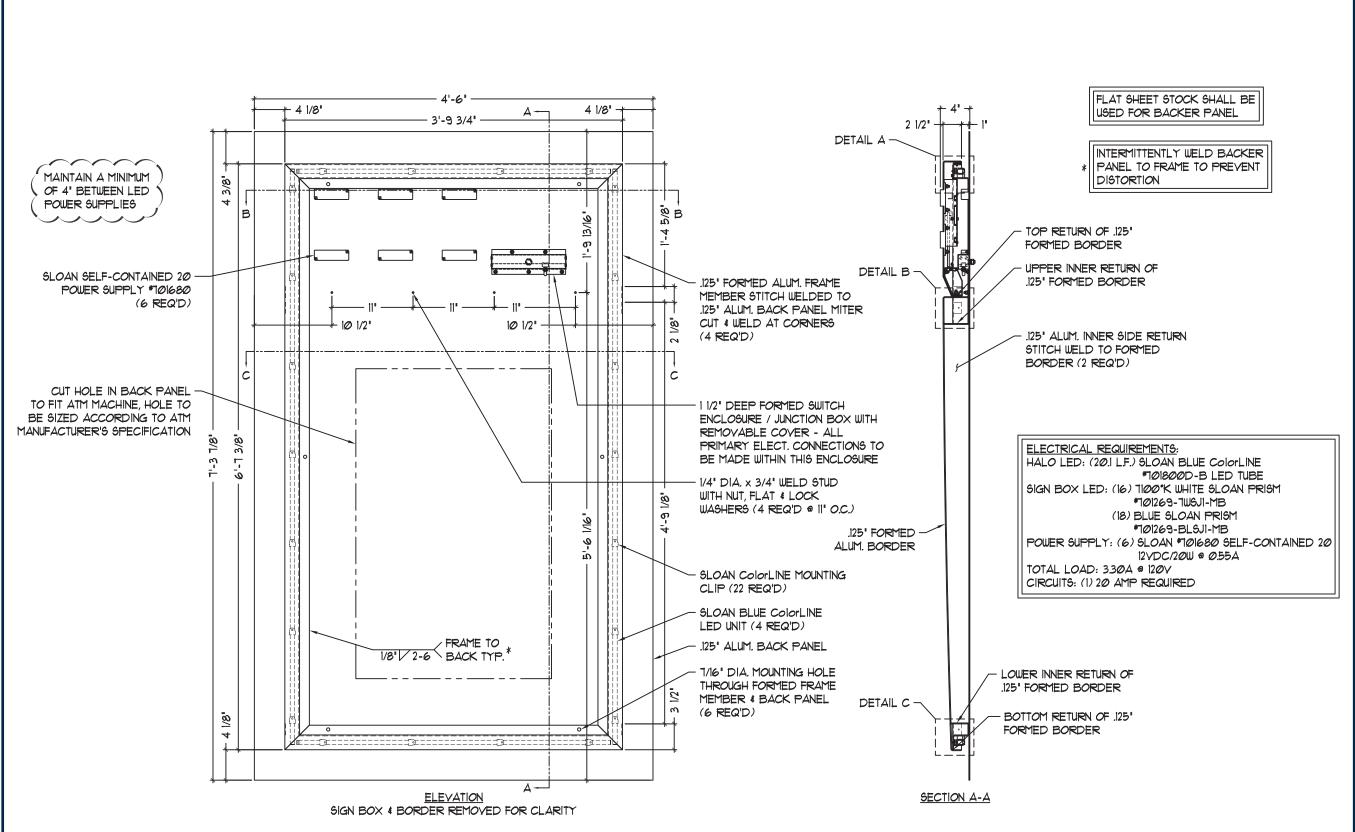
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As noted

Customer Signature

Scale:_

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ColorLINE

The Ultimate LED Border Tube








- · Super Bright
- · Profile Similar to Neon
- · Lit, Mitered Corners
- Fully Compatible with All SloanLED 12 VDC Products

COLORLINE SIZES AND CUT LENGTHS:

- (3) EA. #701800-COLOR-8 (96 ½" LONG)
- MAKE VERTICAL TUBES FROM (2) 96 1/2" PARTS.
- MAKE HORIZONTAL TUBES FROM (1) 96 1/2" PART.
- EACH PART MUST HAVE A FACTORY RUBBER END.
- ONCE PLASTIC CAP IS ATTACHED TO THE CUT SIDE, THE TUBE WILL FINISH AT 77 5/32" FOR VERTICAL IN LENGTH INCLUDING CAP.

THE TUBE WILL FINISH AT **45 3/16**" FOR HORIZONTAL IN LENGTH INCLUDING CAP.

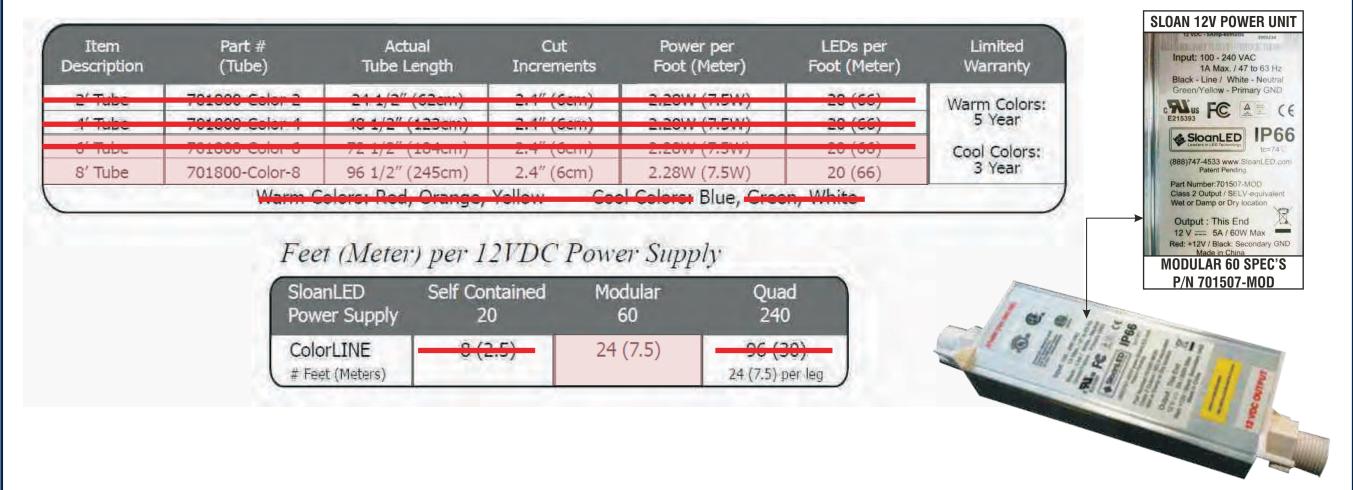



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Designer: ASena
Scale: As noted

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Customer Signature

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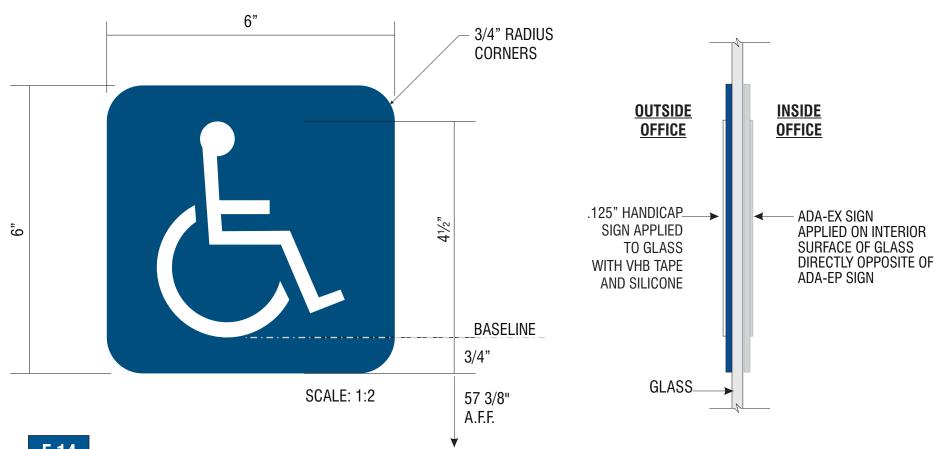
Project ID:

R13 - 06.08.21

CHASE 38000P123456 1

Revision:

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SIGN TYPE ADA-EP


ACCESSIBLE BUILDING ENTRANCE - A02


MANUFACTURE AND INSTALL ONE (1) ADA STANDARD ENTRANCE PLAQUE

FACE: 1/8" BLUE GRAVOTAC #341-501V, SATIN NON-GLARE FINISH.

ISA SYMBOL: 1/32" RAISED, BRIGHT WHITE GRAVOTAC. **BRAILLE:** 1/32" RAISED CLEAR BEAD, MAXIMUM 1/16" DIA.

INSTALL: MOUNT TO LATCH SIDE OF DOOR WITH VHB TAPE AND SILCONE.

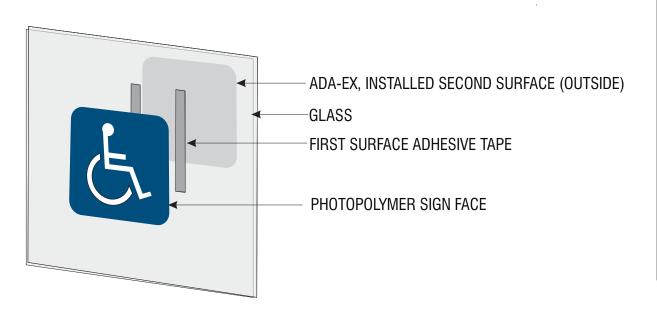

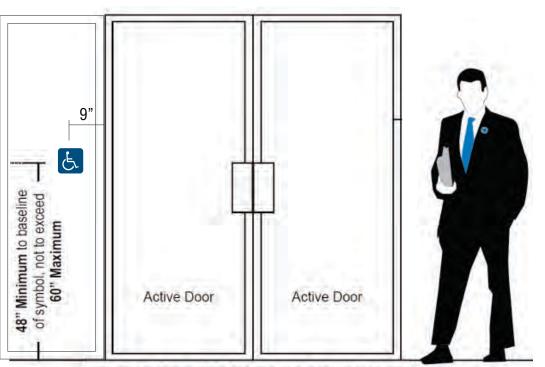

Double door with both doors active, sign is mounted to the left of the left side door



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Salesperson: Arthur Navarro

Coordinator: Lorena Leon **ASena** Designer:_

As noted

CUSTOMER APPROVAL

Customer Signature

COPY, COLORS & SIZES

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Date

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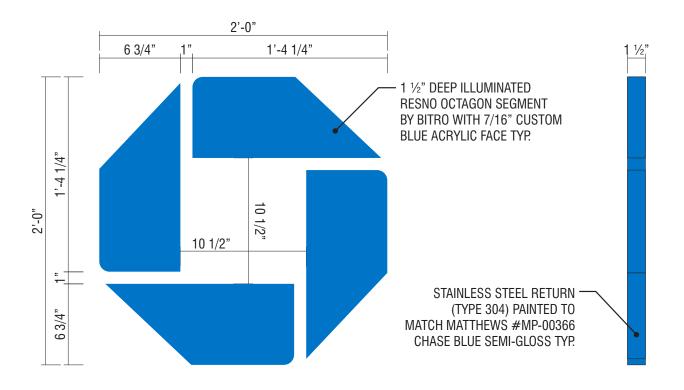
CHASE 38000P123456 1

Project ID:

Revision:

R13 - 06.08.21

DRC Page



FRONT VIEW SCALE: 1 1/2"=1'-0"

SIDE VIEW SCALE: 1 1/2"=1'-0"

1.17

SIGN TYPE

OCT-24-INT

BLUE BITRO

MANUFACTURE AND INSTALL ONE (1) INTERNALLY-ILLUMINATED OCTAGONS

GENERAL NOTES:

- 1. DESIGN IS BASED ON A 5 PSF LATERAL LOAD FOR INTERIOR APPLICATIONS PER IBC 2015. SEISMIC DESIGN CATEGORY D.
- 2. THE CUSTOMER'S BUILDING ENGINEER IS TO DETERMINE THE ADEQUACY OF THE SUPPORTING STRUCTURE.
- 3. ALL FASTENERS SHALL BE STAINLESS STEEL OR ZINC COATED TO PREVENT CORROSION.
- 4. J.P. MORGAN CHASE WILL NOT BE RESPONSIBLE FOR THE SAFETY ON THIS JOB SITE BEFORE, DURING OR AFTER INSTALLATION OF THIS STRUCTURE. IT IS THE RESPONSIBILITY OF THE CONTRACTORS AND INSTALLERS TO ENSURE THAT THE INSTALLATION AND ERECTION OF THIS STRUCTURE IS PERFORMED USING METHODS THAT ARE IN FULL COMPLIANCE WITH OSHA REGULATIONS.
- 5. ANY DEVIATION FROM THIS DESIGN OR FROM ANY PART OF THIS DRAWING, INCLUDING THE GENERAL NOTES, WITHOUT PRIOR WRITTEN CONSENT FROM J.P. MORGAN CHASE VOIDS THIS DRAWING IN ITS ENTIRETY.
- 6. THE STRUCTURE DESIGNED ON THIS DRAWING IS PROTOTYPICAL AND SHOULD NOT BE USED FOR SITE SPECIFIC APPLICATIONS UNLESS DEEMED SUITABLE BY A COMPETENT PROFESSIONAL ENGINEER.



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Indian School Rd NE & Louisiana Rd 6670 Indian School Rd NE Albuquerque, NM 87110

Initial Date: <u>08/10/20</u> Salesperson: Arthur Navarro

Coordinator: Lorena Leon

<u>ASena</u> Designer:_

As noted

CUSTOMER APPROVAL

Customer Signature

COPY, COLORS & SIZES

Signtech does NOT provide primary

electrical to sign location -**RESPONSIBILITY OF OTHERS!**

Customer Signature

Date

20-01032

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Drawing Number:

CHASE 38000P123456 1 Project ID:

Revision:


R13 - 06.08.21



TYPICAL INTERIOR ELEVATION

NOT TO SCALE


DRC Page 28

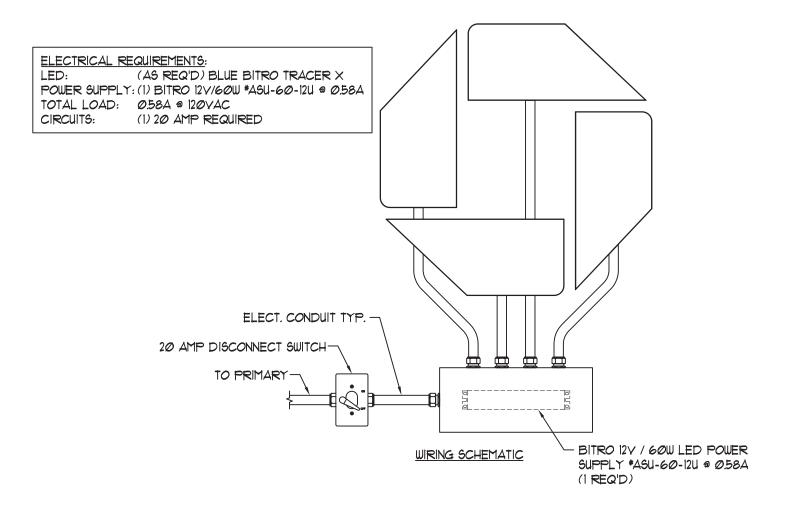




ALL EXPOSED FASTENER HEADS SHALL BE PAINTED TO MATCH THE EXTERIOR CABINET FINISH

OCTAGON SHALL BE WIRED TO A REMOTELY MOUNTED POWER SUPPLY

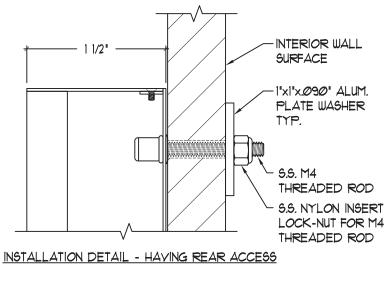

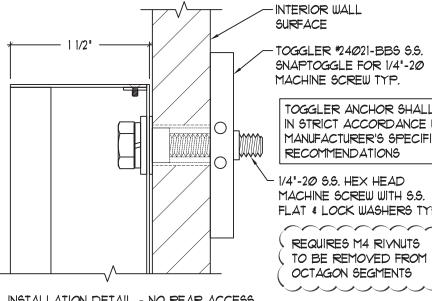

TOGGLER #24021-BBS S.S. SNAPTOGGLE FOR 1/4"-20 MACHINE SCREW TYP. TOGGLER ANCHOR SHALL BE INSTALLED IN STRICT ACCORDANCE WITH THE MANUFACTURER'S SPECIFICATIONS & RECOMMENDATIONS

- 1/4"-20 S.S. HEX HEAD MACHINE SCREW WITH S.S. FLAT & LOCK WASHERS TYP.

REQUIRES M4 RIVNUTS TO BE REMOVED FROM OCTAGON SEGMENTS

INSTALLATION DETAIL - NO REAR ACCESS



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JP Morgan Chase Bank #38200P367111

Indian School Rd NE & Louisiana Rd 6670 Indian School Rd NE Albuquerque, NM 87110

Initial Date: __08/10/20 Salesperson: Arthur Navarro Coordinator: Lorena Leon **ASena** Designer:__

Scale:_ As noted

CUSTOMER APPROVAL

Customer Signature

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Customer Signature

Date

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Drawing Number:

CHASE 38000P123456 1


Revision:

Project ID:

R13 - 06.08.21

20-01032

DRC Page 28

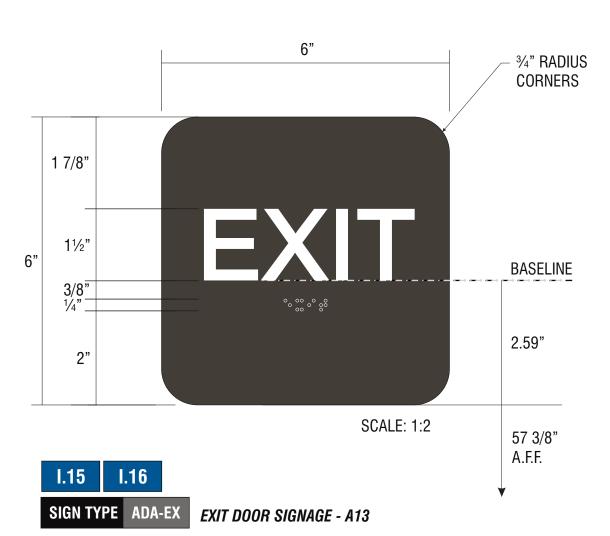


MANUFACTURE AND INSTALL TWO (2) ADA STANDARD EXIT PLAQUES

FACE: 1/8" GRAVOTAC CHARCOAL GREY, SATIN NON-GLARE FINISH.


COPY: 1/32" RAISED, BRIGHT WHITE GRAVOTAC. HELVETICA REGULAR TT FONT.


BRAILLE: 1/32" RAISED CLEAR BEAD, MAXIMUM 1/16" DIA.

INSTALL: MOUNT TO LATCH SIDE OF DOOR WITH VHB TAPE AND SILCONE.

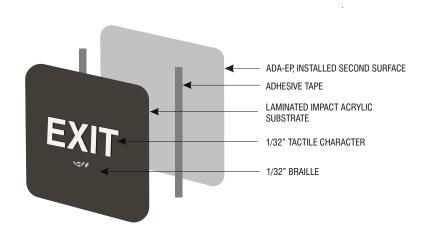

TYPICAL FABRICATION DETAIL NTS

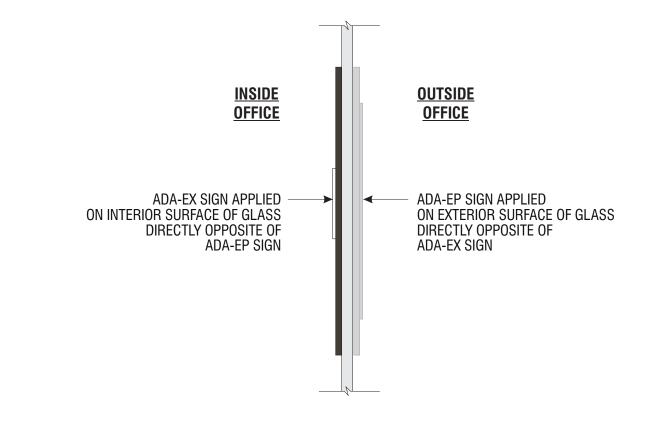

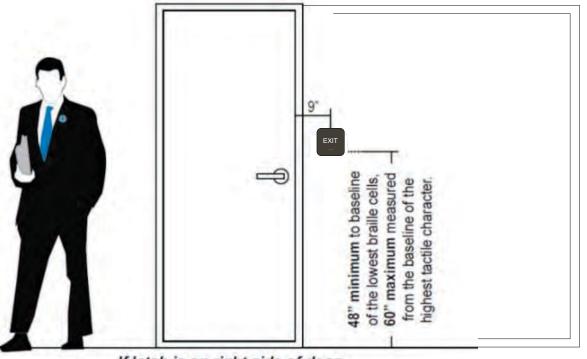

If latch is on right side of door, sign installed on right side









JP Morgan Chase Bank #38200P367111

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Designer: ASena

CUSTOMER APPROVAL

As noted

Customer Signature

COPY, COLORS & SIZES

001 1, 0020110 4 01220

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Customer Signature

Date

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Drawing Number:


CHASE 38000P123456 1

Project ID: UHASE_38000

Revision:

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DRC Page 30

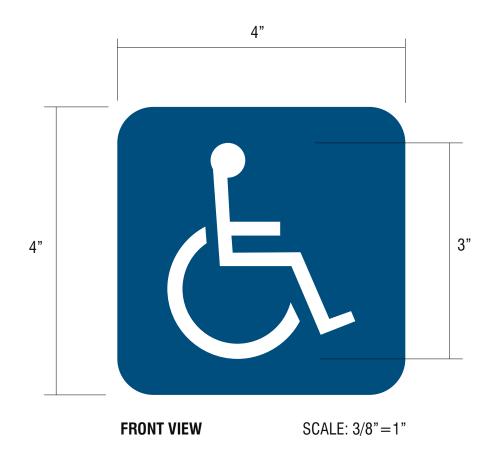

I.18

SIGN TYPE ADA-TW


ACCESSIBLE TELLER WINDOW - A14

MANUFACTURE AND INSTALL ONE (1) ADA ACCESSIBILITY PLAQUE

FACE: 1/8" BLUE GRAVOTAC #341-501V, SATIN NON-GLARE FINISH.

ISA SYMBOL: 1/32" RAISED, BRIGHT WHITE GRAVOTAC.

INSTALL: MOUNT AT ACCESSIBLE TELLER LINE, AS SHOWN, WITH VHB TAPE AND SILCONE.

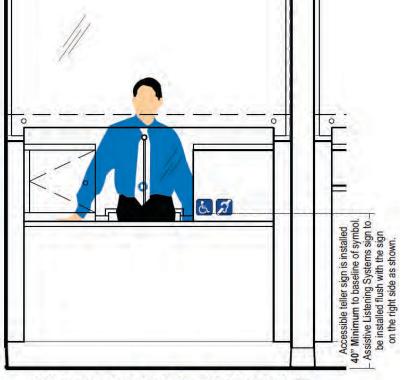

Placement at Modular Teller Stations : with Bullet-Resistant Glass

TYPICAL INSTALLATION - BULLET-RESISTANT GLASS

SCALE: 1/2"=1'-0"



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Initial Date: ___08/10/20
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Coordinator: Lorena Leon
Designer: ASena

CUSTOMER APPROVAL

As noted

Customer Signature

COPY, COLORS & SIZES

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Customer Signature

Date

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Drawing Number:


20-01032

Project ID:

CHASE_38000P123456_1 R13 - 06.08.21

Revision: R1

DRC Page 31

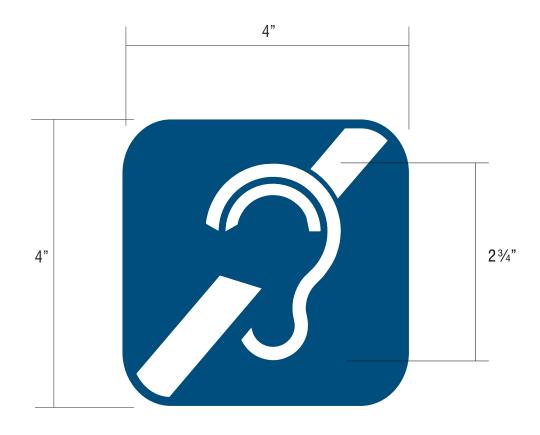

1.19


SIGN TYPE **ADA-TW-ALS**

FOR ACCESSIBLE WINDOW WHERE ASSISTED LISTENING SYSTEMS INSTALLED - A19

MANUFACTURE AND INSTALL ONE (1) ADA ASSISTED LISTENING SYSTEM PLAQUE

FACE: 1/8" BLUE GRAVOTAC #341-501V, SATIN NON-GLARE FINISH. **SYMBOL GRAPHICS:** 1/32" RAISED, BRIGHT WHITE GRAVOTAC.

INSTALL: MOUNT AT ACCESSIBLE TELLER LINE, AS SHOWN, WITH VHB TAPE AND SILCONE.

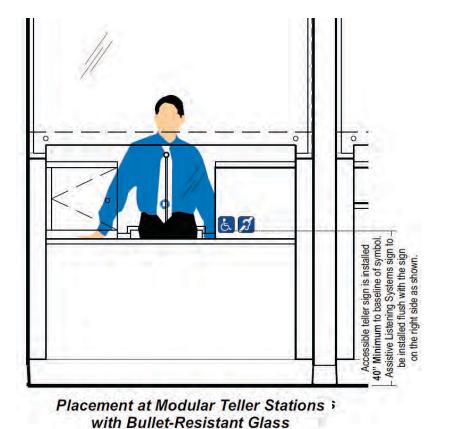



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JP Morgan Chase Bank #38200P367111

Indian School Rd NE & Louisiana Rd 6670 Indian School Rd NE Albuquerque, NM 87110

Initial Date: ___08/10/20 Salesperson: Arthur Navarro Coordinator: Lorena Leon

ASena Designer:_ As noted

CUSTOMER APPROVAL

Customer Signature

COPY, COLORS & SIZES

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RESPONSIBILITY OF OTHERS!

Customer Signature

Date

20-01032

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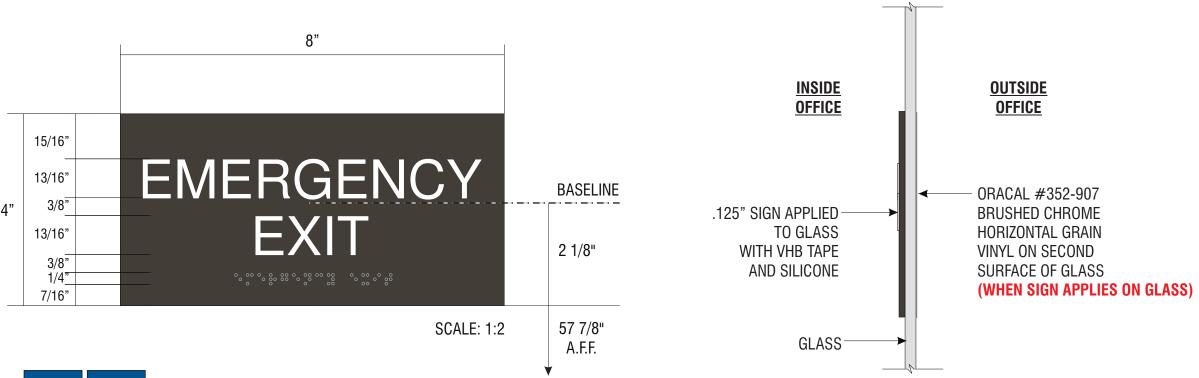
Drawing Number:

CHASE 38000P123456 1 Project ID:

Revision:

R13 - 06.08.21

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1.21

SIGN TYPE ADA-EEX EMERGENCY EXIT

PERMANENT EMERGENCY EXIT DOOR SIGNAGE - A13E


MANUFACTURE AND INSTALL TWO (2) DOOR IDENTIFICATION PLAQUES

FACE: 1/8" GRAVOTAC CHARCOAL GREY, SATIN NON-GLARE FINISH.


COPY: 1/32" RAISED, BRIGHT WHITE GRAVOTAC. HELVETICA REGULAR TT FONT. BRAILLE: GRADE II STANDARD, 1/32" RAISED CLEAR BEAD, MAXIMUM 1/16" DIA.

INSTALL: MOUNT TO LATCH SIDE OF DOOR WITH VHB TAPE AND SILCONE.

WHEN SIGN APPLIES ON GLASS: APPLY LAYER OF 6" X 6" ORACAL #352-907 BRUSHED CHROME HORIZONTAL GRAIN VINYL ON SECOND SURFACE OF GLASS (CUT SHAPE TO MATCH FRONT PLAQUE)

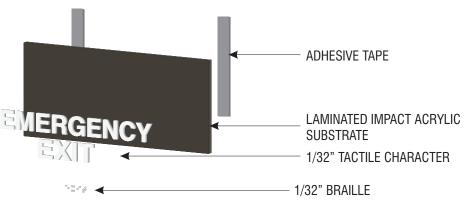

TYPICAL FABRICATION DETAIL

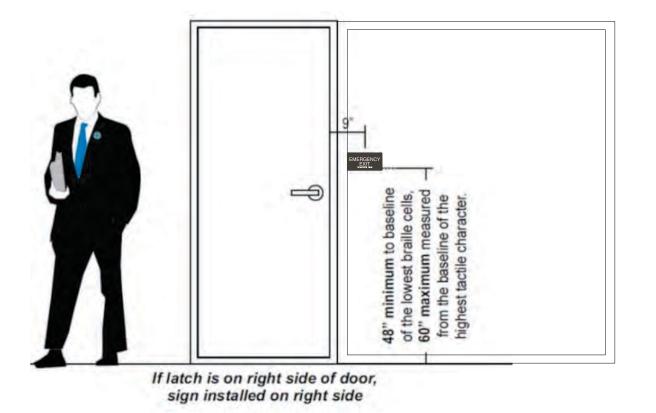







JP Morgan Chase Bank #38200P367111

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As noted

CUSTOMER APPROVAL

Customer Signature

COPY, COLORS & SIZES

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RESPONSIBILITY OF OTHERS!

Customer Signature

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Drawing Number:


CHASE 38000P123456 1

Revision:

R13 - 06.08.21

DRC Page 33



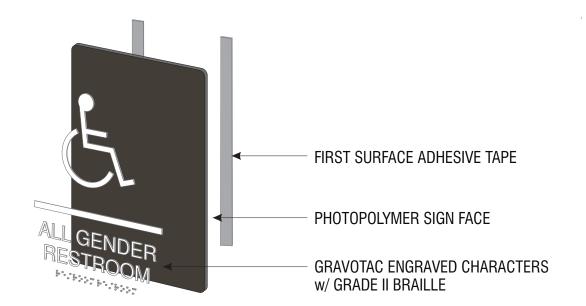



SIGN TYPE ADA-RRAG-A-G FOR ACCESSIBLE SINGLE-STALL RESTROOMS ACROSS U.S.A. (ex CA) - 109


MANUFACTURE AND INSTALL TWO (2) ADA ALL-GENDER RESTROOM SIGNS

FACE: 1/16" PHOTOPOLYMER (NOVACRYL PT-060M), CUT TO SHAPE

W/ PHOTO-ETCHED RAISED COPY & BRAILLE.

PAINT TO MATCH PANTONE BLACK 7C, SATIN FINISH.

COPY: 1/32" RAISED, SATIN WHITE FACES. TYPESTYLE: TT HELVETICA BOLD. **BRAILLE:** GRADE II ADA STANDARD, RAISED 1/32", MAXIMUM 1/10" DOT DIA. **INSTALL:** MOUNT TO LATCH SIDE OF DOOR WITH VHB TAPE AND SILCONE.

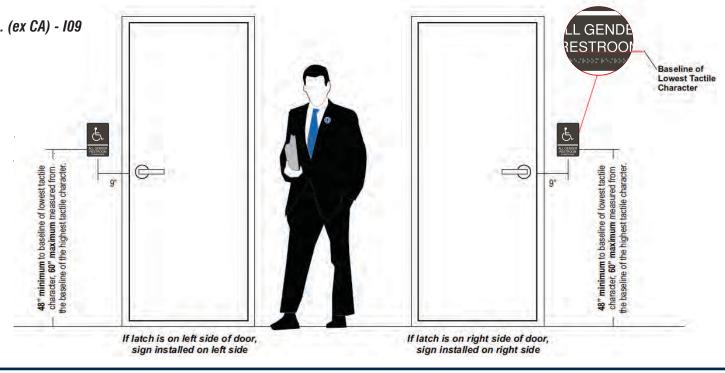







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Initial Date: ___08/10/20 Salesperson: Arthur Navarro Coordinator: Lorena Leon **ASena** Designer:_

CUSTOMER APPROVAL

As noted

Customer Signature

COPY, COLORS & SIZES

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RESPONSIBILITY OF OTHERS!

Customer Signature

Date

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CHASE 38000P123456 1

Project ID: Revision:

R13 - 06.08.21

DRC Page 34 Page:



SCALE: 1:2

E.24

SIGN TYPE ADA-EO

EXIT ONLY DOOR SIGNAGE - A13


MANUFACTURE AND INSTALL ONE (1) ADA STANDARD EXIT ONLY PLAQUE

FACE: 1/8" GRAVOTAC CHARCOAL GREY, SATIN NON-GLARE FINISH.


COPY: 1/32" RAISED, BRIGHT WHITE GRAVOTAC. HELVETICA REGULAR TT FONT.


BRAILLE: 1/32" RAISED CLEAR BEAD, MAXIMUM 1/16" DIA.

INSTALL: MOUNT TO LATCH SIDE OF DOOR WITH VHB TAPE AND SILCONE.

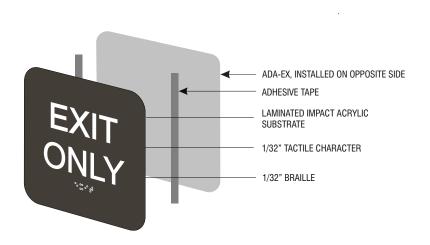

TYPICAL FABRICATION DETAIL NTS

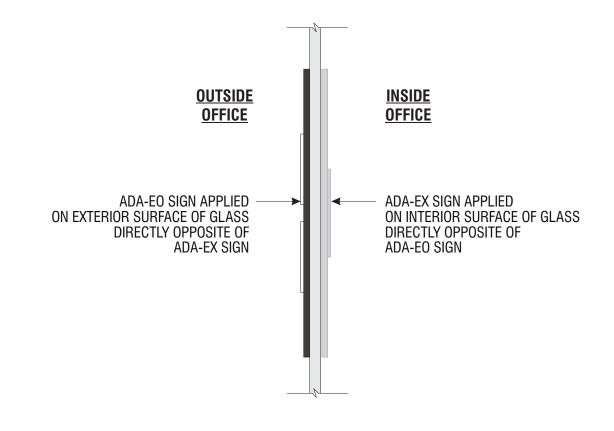

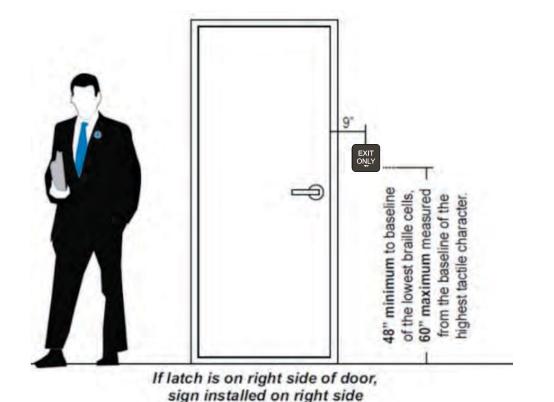









JP Morgan Chase Bank #38200P367111

Indian School Rd NE & Louisiana Rd 6670 Indian School Rd NE Albuquerque, NM 87110

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CUSTOMER APPROVAL

Customer Signature

COPY, COLORS & SIZES

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Date

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CHASE 38000P123456 1

Project ID: Revision:

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DRC Page 35



E.32

CHA-TEMP-CS-48X96-SKID **SIGN TYPE**

MANUFACTURE TWO (2) D/F CONSTRUCTION / TEMPORARY SITE SIGN

FACE: 4' x 8' x 1/2" MDO PLYWOOD, PRIMED AND PAINTED CHASE DARK NICKEL #MP18248 OVERLAY WITH DIGITALLY PRINTED GRAPHIC.

FRAME: 2" x 4" D.F. WOOD FRAMEWORK WITH 3/8" DEEP 9/16 DADO GROOVES FOR FOR FACE TO LOCK INTO. SEE DRAWING ON FOLLOWING PAGES FOR WHICH PARTS. PAINT CHASE DARK NICKEL #MP18248

FRAME ATTACHMENT: USE 3/8" DIA. S.S. MACHINE BOLT FOR BASE ATTACHMENT USE LAG SCREWS TO ATTACH FRAMING TOGETHER.

SAND BAGS: (4) ±40LB SAND BAGS AT EACH BASE CORNER AS SHOWN SIGN INSTALLER TO SUPPLY SAND BAGS.

#38200P367111 Designer:_

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Indian School Rd NE & Louisiana Rd 6670 Indian School Rd NE Albuquerque, NM 87110

Initial Date: __08/10/20 Salesperson: Arthur Navarro Coordinator: Lorena Leon **ASena** As noted

CUSTOMER APPROVAL

Customer Signature

COPY, COLORS & SIZES

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Customer Signature

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Drawing Number:

CHASE 38000P123456 1 Project ID:

Revision:

R13 - 06.08.21

Date


20-01032

ARTWORK PATH: P:\Design\2k20\C\Chase\Typicals\COMING SOON - WE'RE OPEN Construction Sign\~Coming Soon FULL PRINT 4x8-4C New Market 02.06.20


DRC Page 36 Page:


| ITEM NO. | QTY. | DESCRIPTION | LENGTH |
|----------|------|-------------|--------|
| 1 | 4 | 2x4 | 84 |
| 2 | 2 | 2x4 | 84 |
| 3 | 2 | 2x4 | 95.25 |
| 4 | 2 | 2x4 R | 42.78 |
| 5 | 4 | 2x4 R | 47.73 |


SIGN TYPE COMING SOON TEMP SIGN

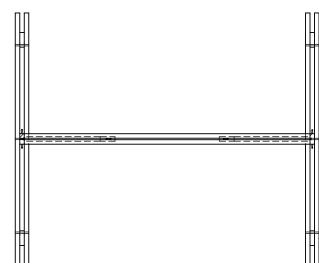

SECTION A-A

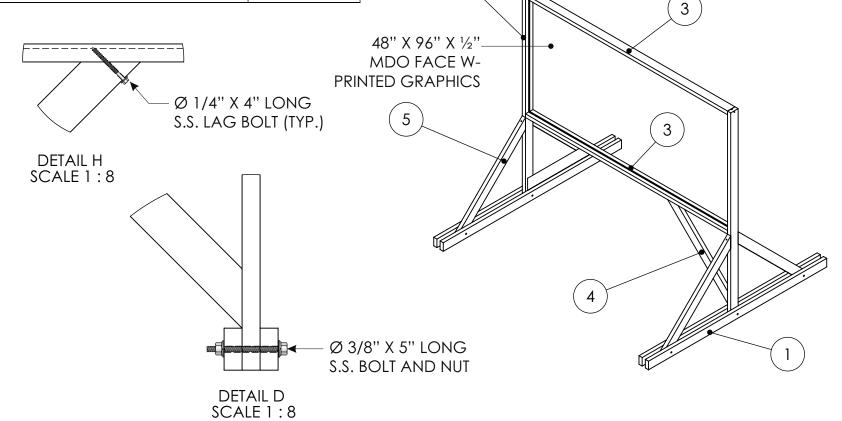

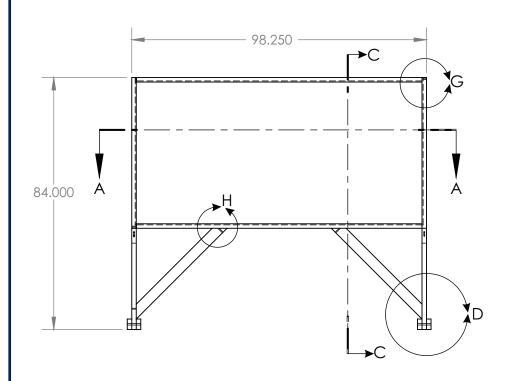

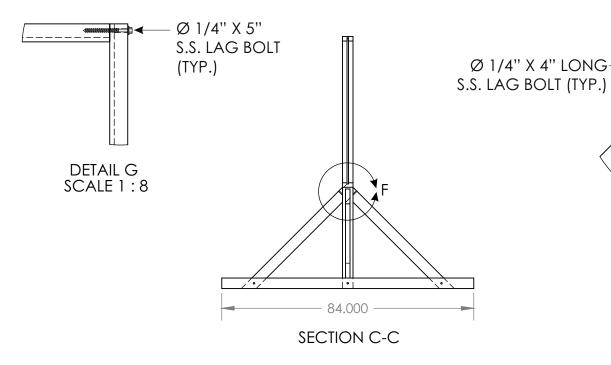



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Drawing Number:

CHASE 38000P123456 1


20-01032

Revision:

DETAIL F SCALE 1:8

R13 - 06.08.21

DRC Page 37

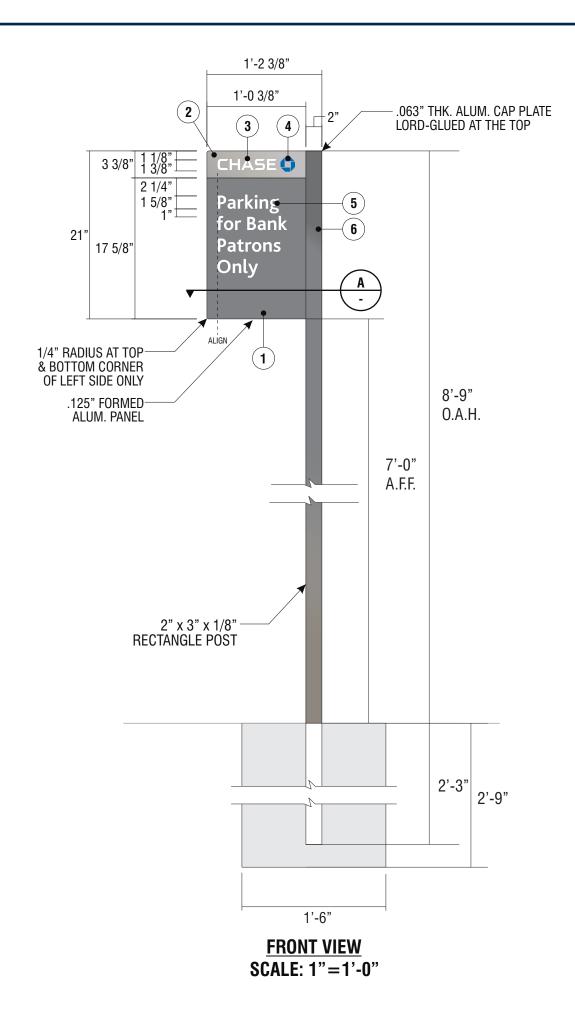


E.35 **E.36 E.37**

SIGN TYPE TC-P-A-RE

MANUFACTURE AND INSTALL SIX (6) NON-ILLUMINATED PARKING SIGNS

- 1. .125" BREAK-FORMED ALUMINUM SIGN FACE. PAINT FINISH ALL EXPOSED SURFACES DARK NICKEL MATTHEWS MP #18248, GLOSS FINISH . FORM AS SHOWN.
- 2. TOP BAND FIRST SURFACE APPLIED 3M #180C-220 LIGHT SILVER METALLIC VINYL.
- **3.** "CHASE" 3M FILM #7725-10 WHITE VINYL.
- 4. OCTAGON 3M FILM #3632-127 CHASE BLUE VINYL.
- 5. SUPPORT COPY TO BE 3M SCOTCHLITE #680-10 REFLECTIVE WHITE.
- 6. 2" X 3" X 1/8" X 132" LONG RECTANGLE ALUM. POST W/ .063" THICK ALUM. CAP PLATE @ TOP.

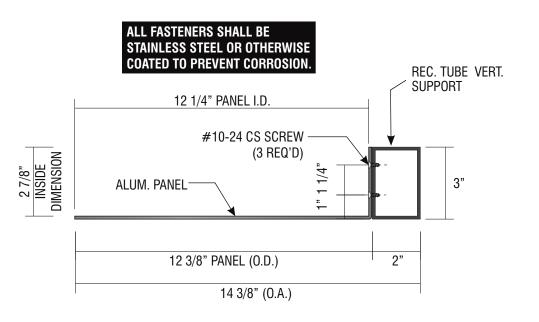





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JP Morgan Chase Bank #38200P367111

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Initial Date: ___08/10/20 Salesperson: Arthur Navarro Coordinator: Lorena Leon **ASena** Designer:_

As noted

CUSTOMER APPROVAL

Customer Signature

COPY, COLORS & SIZES

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Customer Signature

Date

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SCALE: 3/4"=1'-0"



CHA-TEMP-CS-RF-DP-48X96-FALL

SEASON

MANUFACTURE AND SHIP FOUR (4) REPLACEMENT DIGITALLY PRINTED VINYL FACES FOR EXISTING D/F CONSTRUCTION / TEMPORARY SITE SIGN GRAPHICS: DIGITALLY PRINTED GRAPHIC ON VINYL APPLIED FIRST SURFACE.

ARTWORK PATH: P:\Design\2k21\C\Chase Bank\~Typicals\COMING SOON - WE'RE OPEN Construction Sign\~2021 BANNER ARTWORK - Coming Soon-Fall-Spring-Summer-Winter\Opening Fall 2021 8x4.pdf



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Coordinator: Lorena Leon **ASena** Designer:_

As noted

CUSTOMER APPROVAL

Customer Signature

COPY, COLORS & SIZES

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Customer Signature

Date

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Drawing Number:

CHASE 38000P123456 1

Project ID: Revision:

R13 - 06.08.21

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SCALE: 3/4"=1'-0"

E.44

SIGN TYPE CHA-TEMP-CS-48x96-BANNER-FALL

SEASON

MANUFACTURE AND INSTALL TWO (2) TEMPORARY CONSTRUCTION BANNERS

BACKGROUND: 13 OZ. STANDARD WHITE BANNER MATERIAL W/ FULL-COLOR DIGITALLY PRINTED GRAPHICS, FIRST-SURFACE.

ATTACHMENT: TO WALL/FENCE SURFACE THROUGH BRASS GROMMETS WITH #10 SCREWS & ANCHORS, IF REQ'D...

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CHASE 38000P123456 1

Revision:

Project ID:

R13 - 06.08.21

DRC Page 40 Page:

DATE ISSUED: SEPTEMBER 09, 2020 2020030

SHEET NAME: LANDSCAPE PLAN

J. CAMILLE LA FOY

LANDSCAPE ARCHITECTURE CONSULTING

101C NORTH GREENVILLE AVENUE, #242
ALLEN, TEXAS 75002
214-502-4036

PLANT MATERIAL LIST

| <u>KEY</u> | QUANTITY | ORNAMENTAL TREES DESCRIPTION | SIZE | |
|------------|----------|--|--|--|
| DW | 2 | CHILOPSIS LINEARIS 'BUBBA' DESERT WILLOW | 30 GAL., 8' HT., 3' SPREAD | |
| RB | 4 | CERCIS CANADENSIS 'OKLAHOMA' REDBUD | 30 GAL., 8' HT., 3' SPREAD | |
| VAC | 1 | VITEX AGNUS-CASTUS 'SHOAL CREEK' SHOAL CREEK VITEX | 30 GAL., 8' HT., 3' SPREAD | |
| | | SHRUBS | 3 31 NEAD | |
| KEY | QUANTITY | DESCRIPTION | SIZE | |
| DS | 6 | DASYLIRION TEXANUM GREEN DESERT SPOON | 5 GAL., MIN. 15" HT. | |
| вм | 1 | CARYOPTERIS X CLANDONENSIS 'DARK KNIGHT' BLUE MIST | 5 GAL., MIN. 15" HT. | |
| GC | 22 | COTONEASTER BUXIFOLIUS GRAY COTONEASTER | 5 GAL., MIN. 15" HT. | |
| NRS | 4 | ILEX X 'NELLIE R. STEVENS' NELLIE R. STEVENS HOLLY | 30 GAL., 5' HT., 3' SPREAD | |
| TS | 15 | LEUCOPHYLLUM LANGMANIAE TEXAS SAGE 'LYNN'S LEGACY' | 5 GAL., MIN. 15" HT. | |
| RY | 6 | HESPERALOE PARVIFOLIA RED YUCCA | 3 GAL., MIN. 10" HT. | |
| SC | 33 | SCUTELLARIA SUFFRUTESCENS PINK SKULLCAP | 5 GAL., MIN. 15" HT. | |
| SG | 11 | SALVIA X 'ULTRA VIOLET' | | |
| YBP | 3 | ULTRA VIOLET SAGE CAESALPINIA GILLIESII | 5 GAL., MIN. 15" HT. | |
| WT | 2 | YELLOW BIRD OF PARADISE AGAVE OVATIFOLIA | 10 GAL., MIN. 36" HT. | |
| YF | 8 | WHALE'S TONGUE YUCCA FILAMENTOSA 'COLOR GUARD' | 10 GAL., MIN. 36" HT. | |
| | | COLOR GUARD YUCCA | 5 GAL., MIN. 8" HT. | |
| 14574 | | GROUND COVER | 0.75 | |
| KEY | QUANTITY | <u>DESCRIPTION</u> VERBENA RIGIDA | SIZE 1 GAL., FULL PLANT | |
| SV | 120 | SANDPAPER VERBENA | 30" O.C. | |
| PG | 30 | TEUCRIUM CHAMAEDRYS 'PROSTRATUM' PROSTRATE GERMANDER | I GAL., FULL PLANT 36 | |
| | | ORNAMENTAL GRASSES | 0.6. | |
| KEY | QUANTITY | DESCRIPTION | SIZE | |
| ABM | 8 | MUHLENBERGIA CAPILLARIS 'REGAL MIST' AUTUMN BLUSH MUHLY | 3 GAL., FULL PLANT | |
| FRG | 12 | CALAMAGROSTIS ARUNDINACEA 'KARL FOESTER' FEATHER REED GRASS | 3 GAL., FULL PLANT | |
| MHG | 11 | MISCANTHUS SINENSIS 'ADAGIO' ADAGIO GRASS | | |
| | | NASSELLA TENUISSIMA | 3 GAL., FULL PLANT 1 GAL., FULL PLANT | |
| MFG | 29 | MEXICAN FEATHER GRASS | 16" O.C. | |

(2)-DS STEEL EDGING _ (1)-WT DESERT | GRAVEL

- GRAVEL

√(1)-RY

BOULDER

- (1)-VAC

SHEET NOTES:

LANDSCAPE CONTRACTOR TO PROVIDE A COST FOR TREE PRUNING FOR EXISTING TREES TO REMAIN AS AN

REMOVE ALL EXISTING PLANTS AROUND MONUMENT

COMPLIMENTARY. ANYTHING CALLED FOR ON ONE AND

NOT THE OTHER IS AS BINDING AS IF SHOWN AND CALLED FOR ON BOTH. THE PLANT SCHEDULE IS AN AID

THE DRAWINGS AND SPECIFICATIONS ARE

ALTERNATE TO THE BID.

TO BIDDERS ONLY.

LANDSCAPE PLAN SCALE: 1" = 10'-0"

MOUNTAINAIR / BROWN GRAVEL 2"-4"

COYOTE MIST GRAVEL 2"-4"

-PUEBLO ROSE GRAVEL 7/8"

`(7)-FRG

– PUEBLO ROSE GRAVEL 7/8"

_/(11)-MFG

INDIAN SCHOOL ROAD NE.

(VARIABLE WIDTH RIGHT OF WAY) COYOTE MIST 4 LANE DIVIDED ROADWAY GRAVEL 2"-4"

(3)-MHG <u></u>

PUEBLO ROSE-

(1)-SG-

BOULDER-

(2)-MFG~

BOULDER-

BIKE RACK -

(1)-YBP<

0.7261 acres±

N89°38'23"W 270.25' (N89°35'55"W 270.53')

PUEBLO ROSE GRAVEL 7/8"

(1)-SG-

(1)-YF—

GRAVEL 7/8"

₁(8)-MFG

ROOT BARRIER APPROX. 215 L.F.

/ SMOKE FINES

(2)-MFG /

MOUNTAINAIR BROWN GRAVEL 2"-4" /

(5)-GC


DESERT BRONZE -GRAVEL 2"-4"

/(1)-YBP /(30)-PG

/BOULDER

, GRAVEL EDGE

/ SMOKE FINES

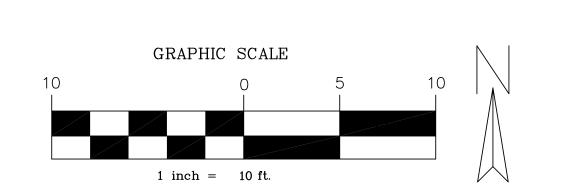

GRAVEL KEY

PROTECTIVE TREE FENCING

BOULDER

MOUNTAINAIR

BROWN GRAVEL 2"-4" \

MOUNTAINAIR BROWN GRAVEL 2"-4"

(1)-DS⁻

BOULDER-

(3)-MFG[/]

/PROTECTIVE TREE FENCING


CAN DESERT BRONZE
CAN GRAVEL 2"-4"

SMOKE FINES

* * * MOUNTAINAIR | * * * | BROWN GRAVEL 2"-4"


PUEBLO ROSE GRAVEL 7/8"

++++ COYOTE MIST +++ GRAVEL 2"-4"

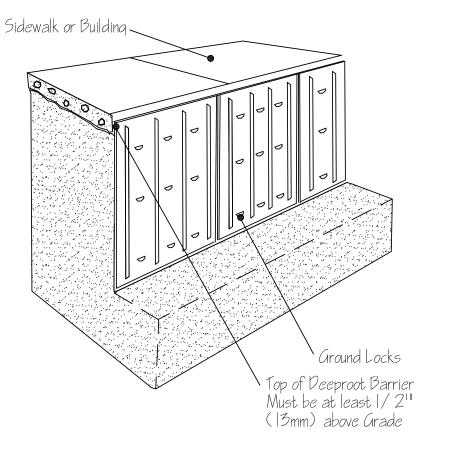

PUEBLO ROSE / GRAVEL 7/8"

FRONT LOT EDGE LANDSCAPE BUFFER

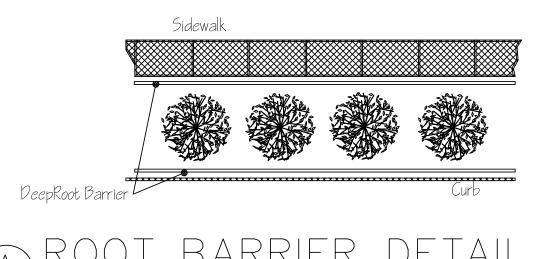

BARRIER DETAIL

CITY OF ALBUQUERQUE

Planning Department Brennon Williams, Director



November 19, 2020

Paul Cragun, P.E. Cumulus Design 2080 N. Highway 360, Suite 240 Grand Prairie, TX 75050

RE: Chase Bank – Indian School Rd. 6670 Indian School Rd. NE

Grading and Drainage Plans Engineer's Stamp Date: 11/09/20

Hydrology File: J18D001C

Dear Mr. Cragun:

Based upon the information provided in your submittal received 11/09/2020, the Grading and Drainage Plans are approved for Building Permit and action by the DRB on Site Plan for

Building Permit.

PO Box 1293

Albuquerque

www.cabq.gov

Please attach a copy of this approved plan in the construction sets for Building Permit processing along with a copy of this letter. Prior to approval in support of Permanent Release of Occupancy

by Hydrology, Engineer Certification per the DPM checklist will be required.

As a reminder, if the project total area of disturbance (including the staging area and any work within the adjacent Right-of-Way) is 1 acre or more, then an Erosion and Sediment Control

(ESC) Plan and Owner's certified Notice of Intent (NOI) is required to be submitted to the Stormwater Quality Engineer (Doug Hughes, PE, <u>jhughes@cabq.gov</u>, 924-3420) 14 days prior to

any earth disturbance.

The Payment in Lieu payment of \$2,028.80 must be paid prior to Permanent Release of Occupancy approval. Please use the attached City of Albuquerque Treasury Deposit form. Once the Owner paid the fee, please provide Hydrology with a copy of the receipt.


If you have any questions, please contact me at 924-3995 or rbrissette@cabq.gov.

Sincerely,

Renée C. Brissette, P.E. CFM Senior Engineer, Hydrology

Renée C. Brissette

Planning Department

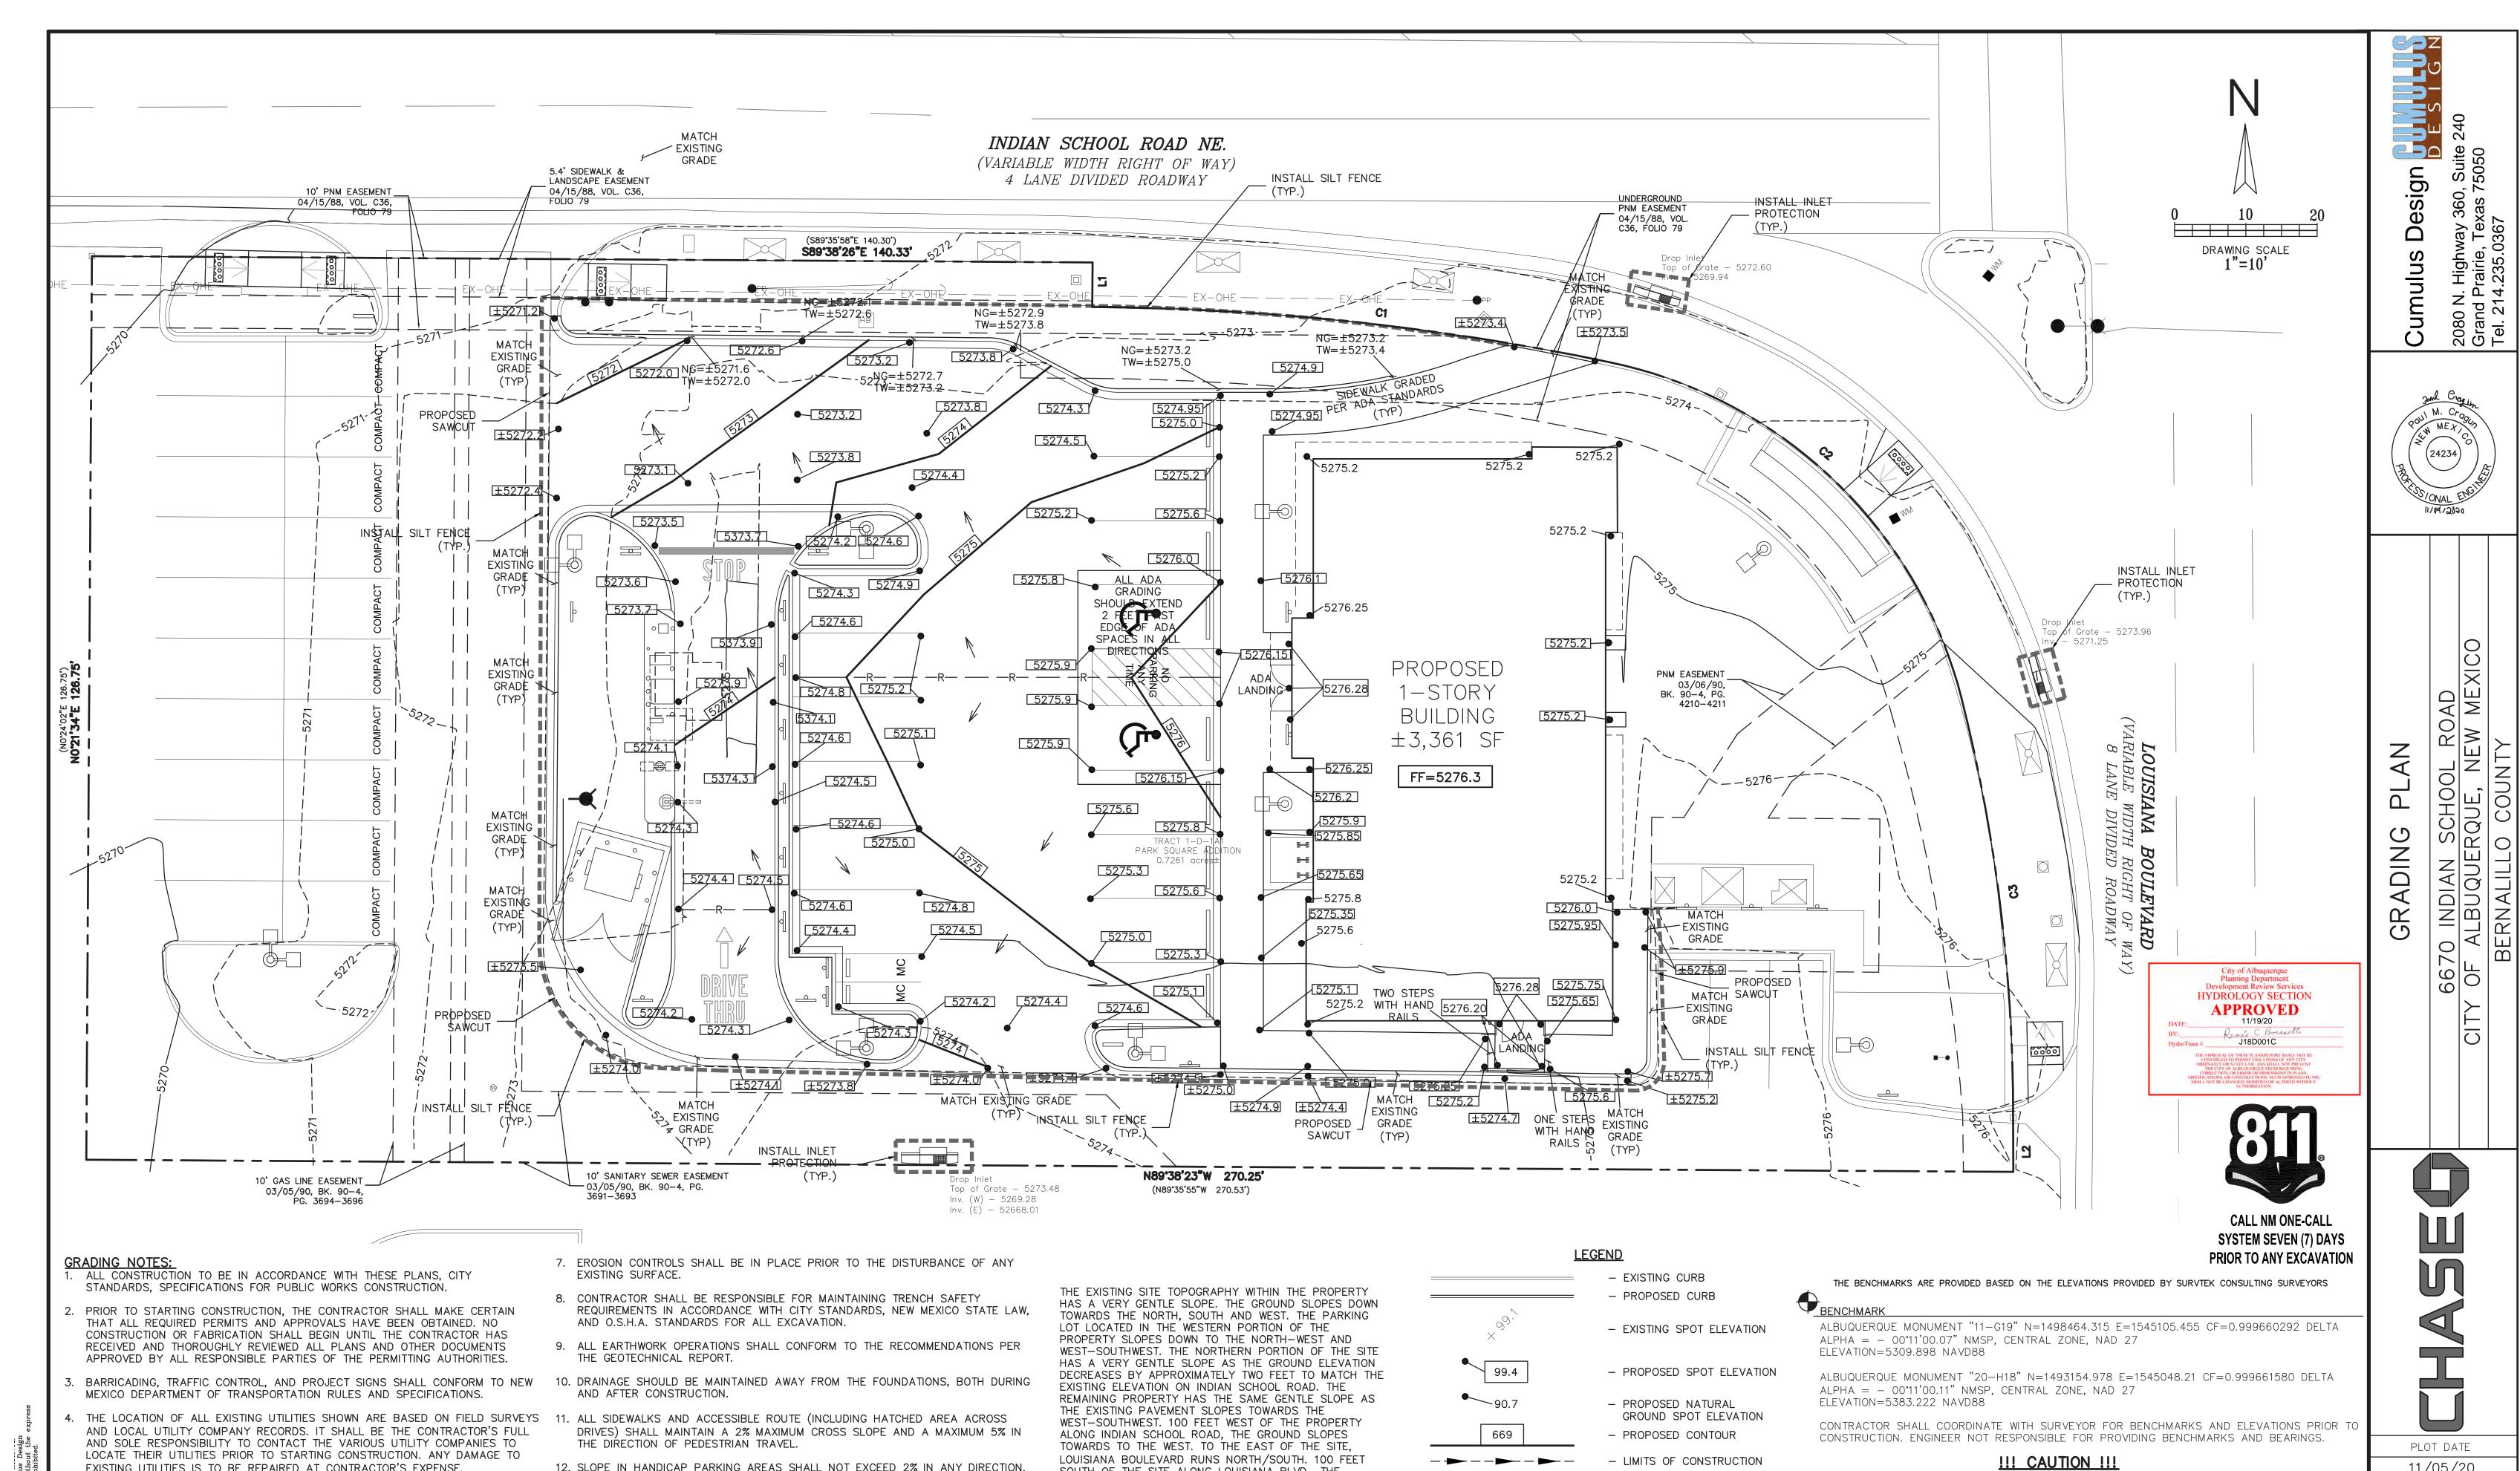

SOUTH OF THE SITE ALONG LOUISIANA BLVD., THE

THE PROPOSED CHASE BANK WILL NOT MAKE CHANGES

TO THE EXISTING GENERAL TOPOGRAPHY OF THE SITE OR

——R— —R— —R——

- PROPOSED RIDGE

INLET PROTECTION

PROPOSED SAWCUT

NATURAL GROUND

- TOP OF WALL/CURB

DIRECTIONAL FLOW ARROW

SILT FENCE

GROUND SLOPES TO THE SOUTH.

THE AREA.

11/05/20

DRAWING SCALE

1" = 10'

PROJECT NUMBER

CDC20013

SHEET NUMBER

UNDERGROUND UTILITIES

RESPONSIBILITY OF THE CONTRACTOR(S) TO VERIFY THE HORIZONTALLY AND VERTICALLY

EXISTING UTILITIES AND UNDERGROUND FACILITIES INDICATED ON THESE PLANS HAVE BEEN

LOCATED FROM REFERENCE INFORMATION SUPPLIED BY VARIOUS PARTIES. THE ENGINEER DOES

NOT ASSUME THE RESPONSIBILITY FOR THE UTILITY LOCATIONS SHOWN. IT SHALL BE THE SOLE

LOCATION OF ALL UTILITIES AND UNDERGROUND FACILITIES PRIOR TO CONSTRUCTION, TO TAKE

PRECAUTIONS IN ORDER TO PROTECT ALL FACILITIES ENCOUNTERED AND NOTIFY THE ENGINEER

OF ALL CONFLICTS OF THE WORK WITH EXISTING FACILITIES. THE CONTRACTOR SHALL PROTECT

CONTRACTOR TO UTILITIES SHALL BE REPAIRED OR REPLACED BY THE CONTRACTOR AT THEIR

AND MAINTAIN ALL UTILITIES FROM DAMAGE DURING CONSTRUCTION. ANY DAMAGE BY THE

CALL: NEW MEXICO ONE CALL @ NM 811 AT LEAST 7 DAYS PRIOR TO CONSTRUCTION.

12. SLOPE IN HANDICAP PARKING AREAS SHALL NOT EXCEED 2% IN ANY DIRECTION.

13. PROVIDE "FLAT" LANDINGS AT TOP AND BOTTOM OF ALL RAMPS. THESE "FLAT"

AREAS SHALL BE 5' LONG AND THE SLOPE SHALL NOT EXCEED 2% IN ANY

14. IT IS THE RESPONSIBILITY OF THE CONTRACTOR TO PROVIDE POSITIVE DRAINAGE

INDICATED. SURFACE WATER SHALL NOT BE RELEASED ONTO ADJACENT PRIVATE

15. SITE GRADING SHALL BE PERFORMED IN A MANNER TO DIRECT WATER AS

AWAY FROM BUILDING AND PARKING AT ALL TIMES.

DIRECTION.

PROPERTY.

ENGINEER.

EXPENSE OF THE CONTRACTOR. \\SERVER-PC\SERVER\2020 CDC PROJECTS\CDC20013 - INDIAN SCHOOL ROAD, ALBUQUERQUE\PLANS\GRADING PLAN CDC20013.DWG

EXISTING UTILITIES IS TO BE REPAIRED AT CONTRACTOR'S EXPENSE.

CONTRACTOR SHALL VERIFY ALL EXISTING INVERTS AND RIM ELEVATIONS PRIOR

BENCHMARKS HAVE BEEN PROVIDED AS A REFERENCE. IT IS THE CONTRACTOR'S

RESPONSIBILITY TO LOCATE, VERIFY, AND/OR ESTABLISH A BENCHMARKS PRIOR


SURVEY STAKES AND MARKERS FOR THE DURATION OF THE PROJECT. IF ANY

TO BE REPLACED, SUCH REPLACEMENT SHALL BE BY THE SURVEYOR AT THE


CONSTRUCTION STAKES OR MARKERS ARE LOST OR DISTURBED AND ARE NEEDED

TO CONSTRUCTION. IF CONFLICTS EXIST, THE CONTRACTOR IS TO CONTACT

TO CONSTRUCTION. IT IS THE CONTRACTOR'S RESPONSIBILITY TO PRESERVE

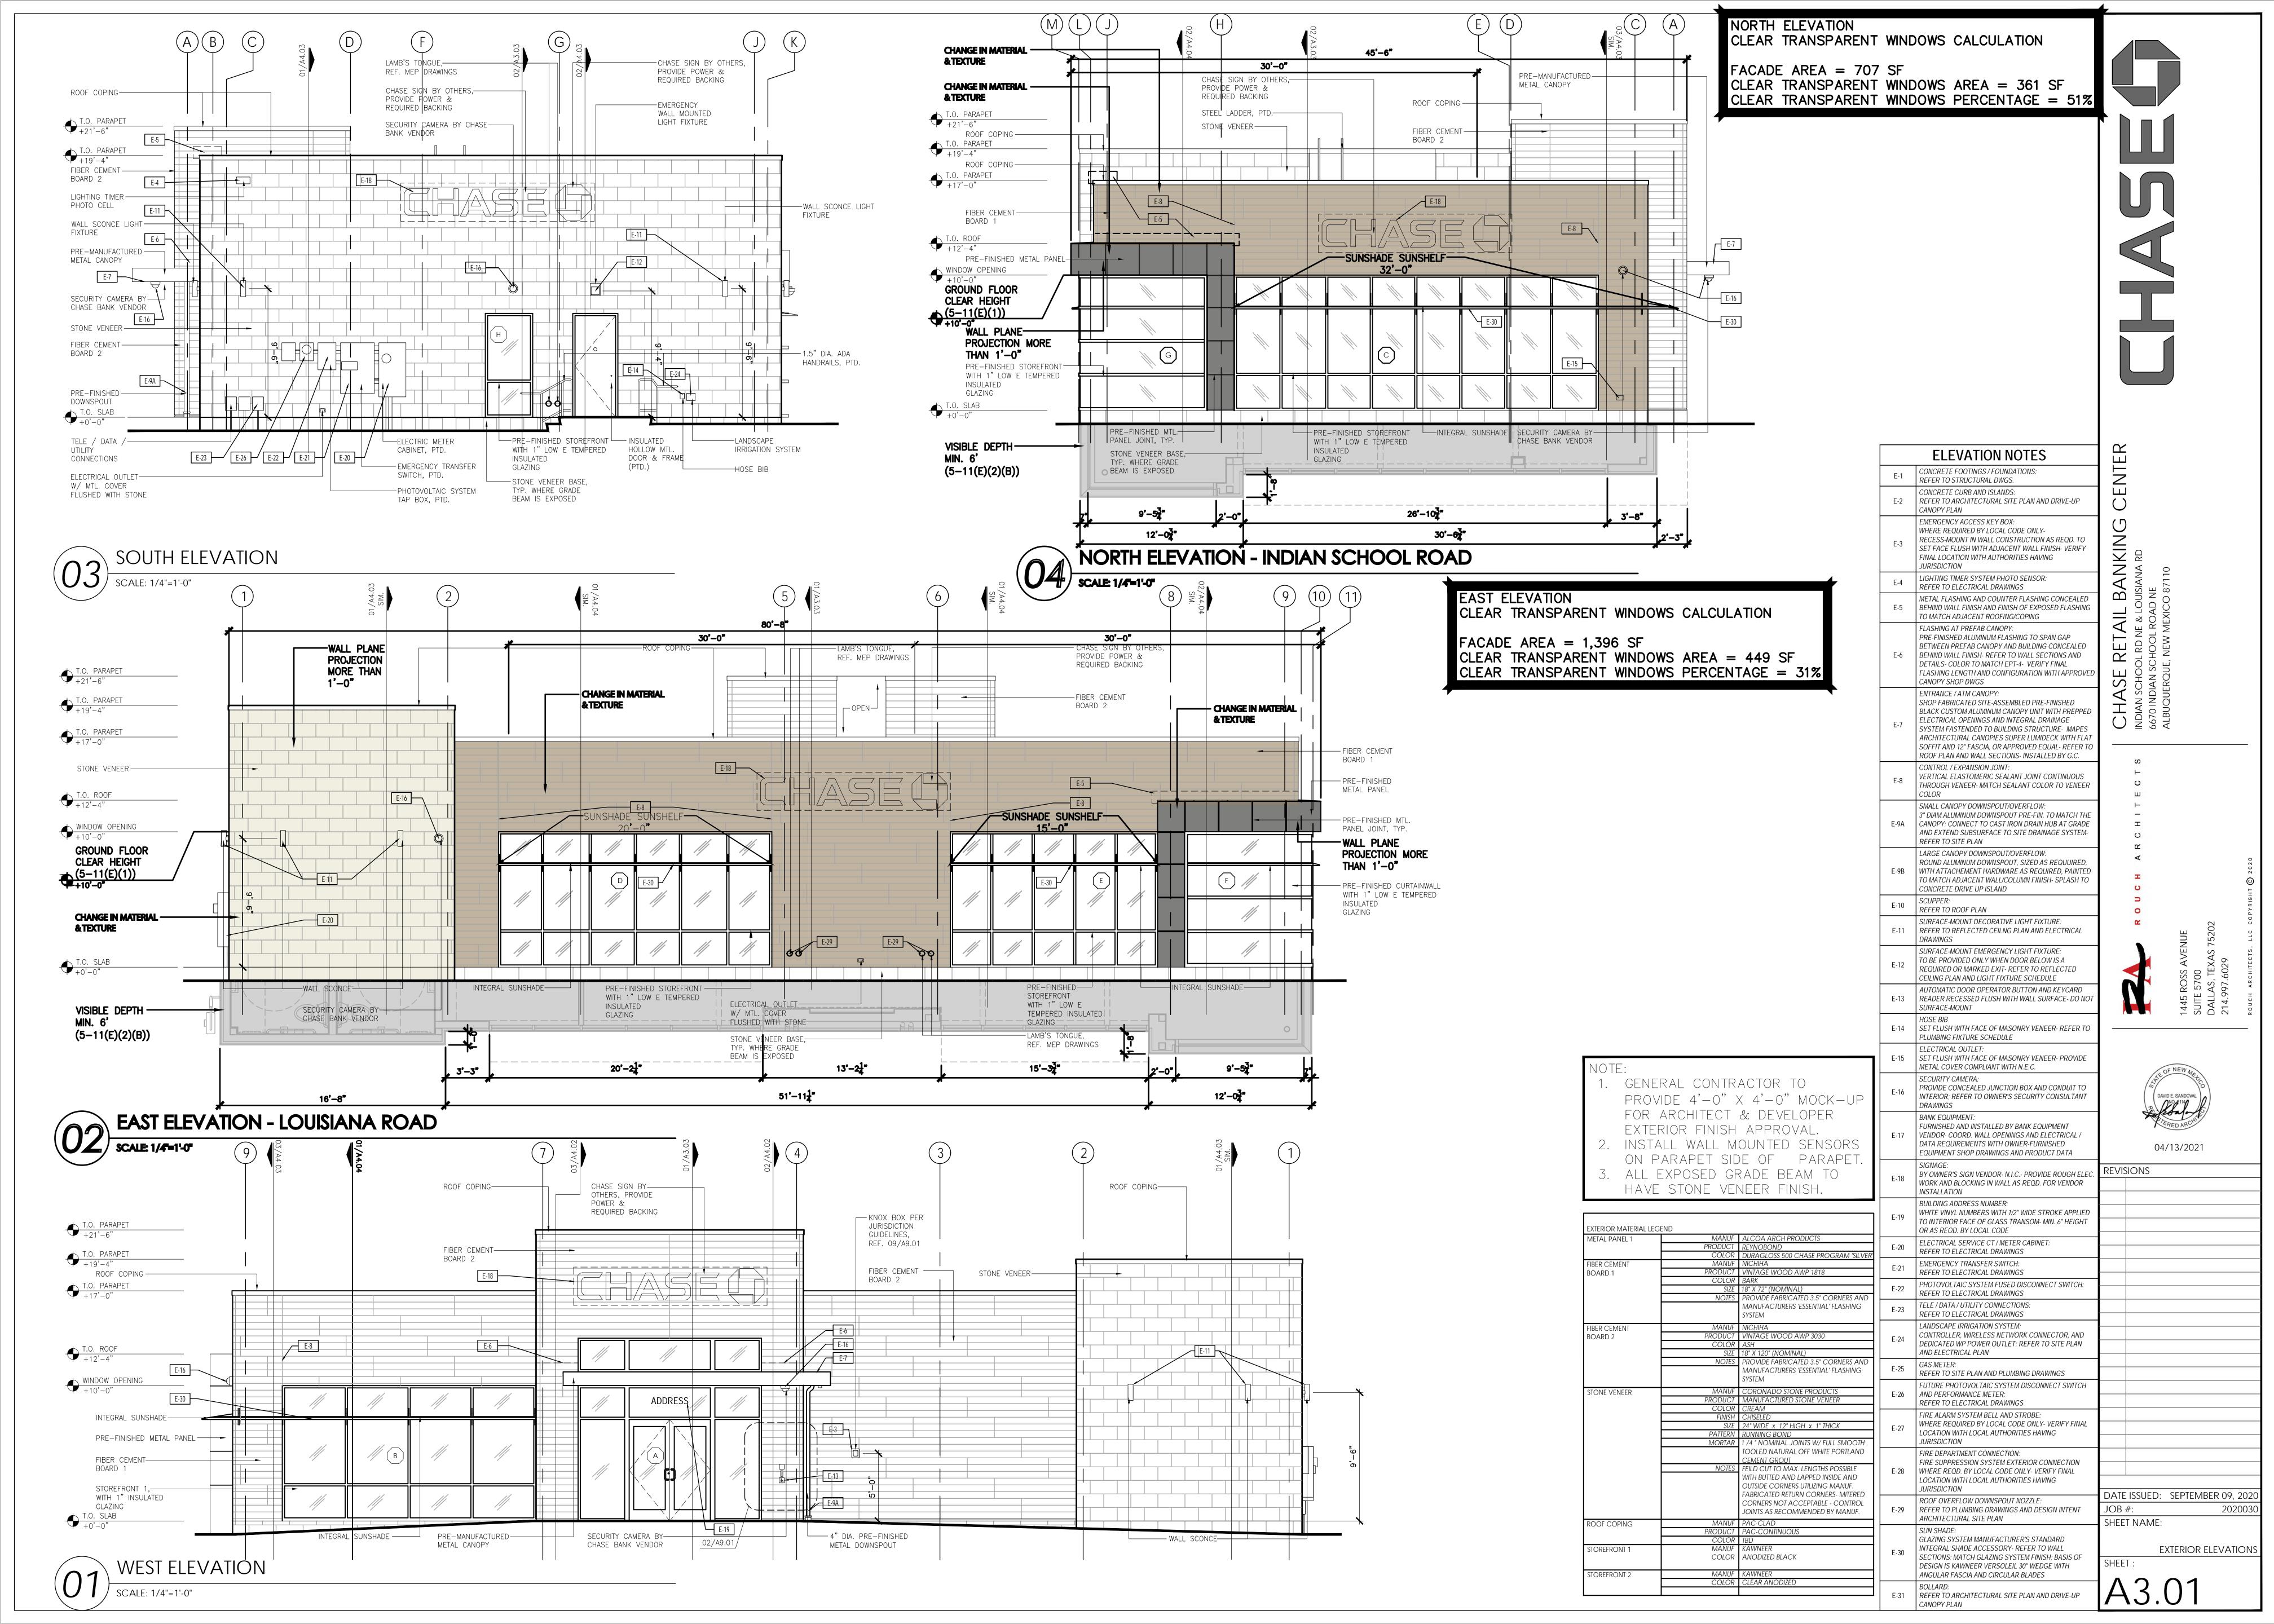



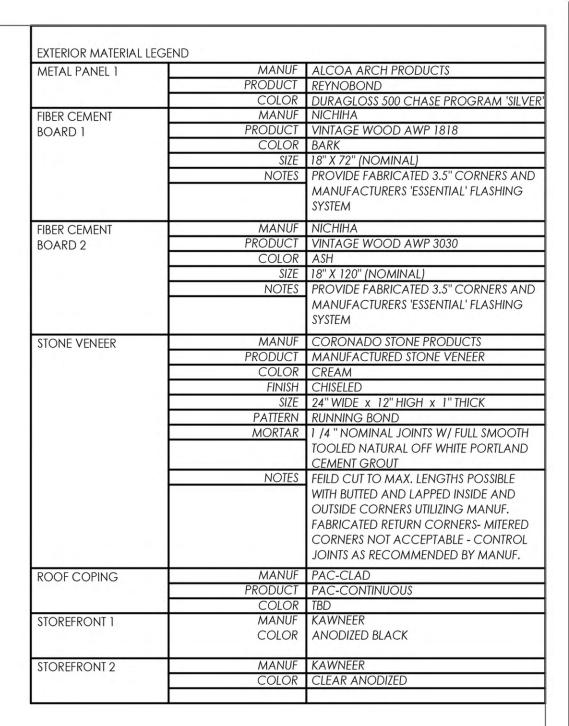

WEST ELEVATION












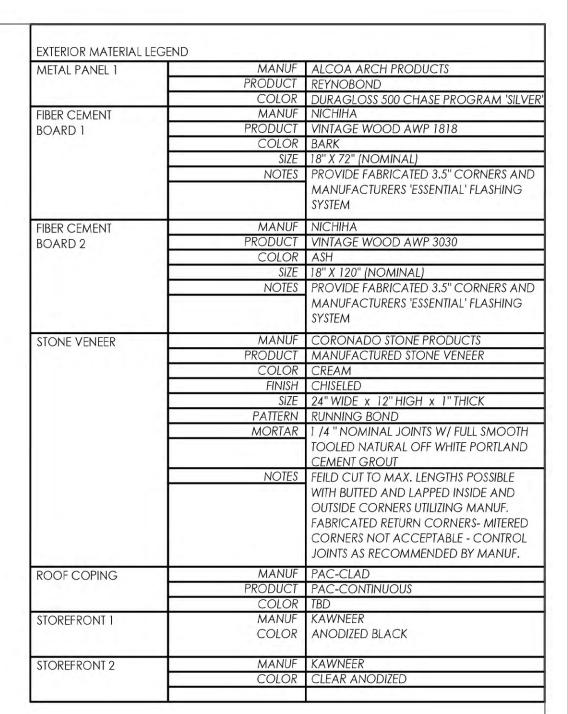

EAST ELEVATION

SCALE: 1/4"=1'-0




NORTH ELEVATION

SCALE: 1/4"=1'-0"





ROUCH ARCHITECTS

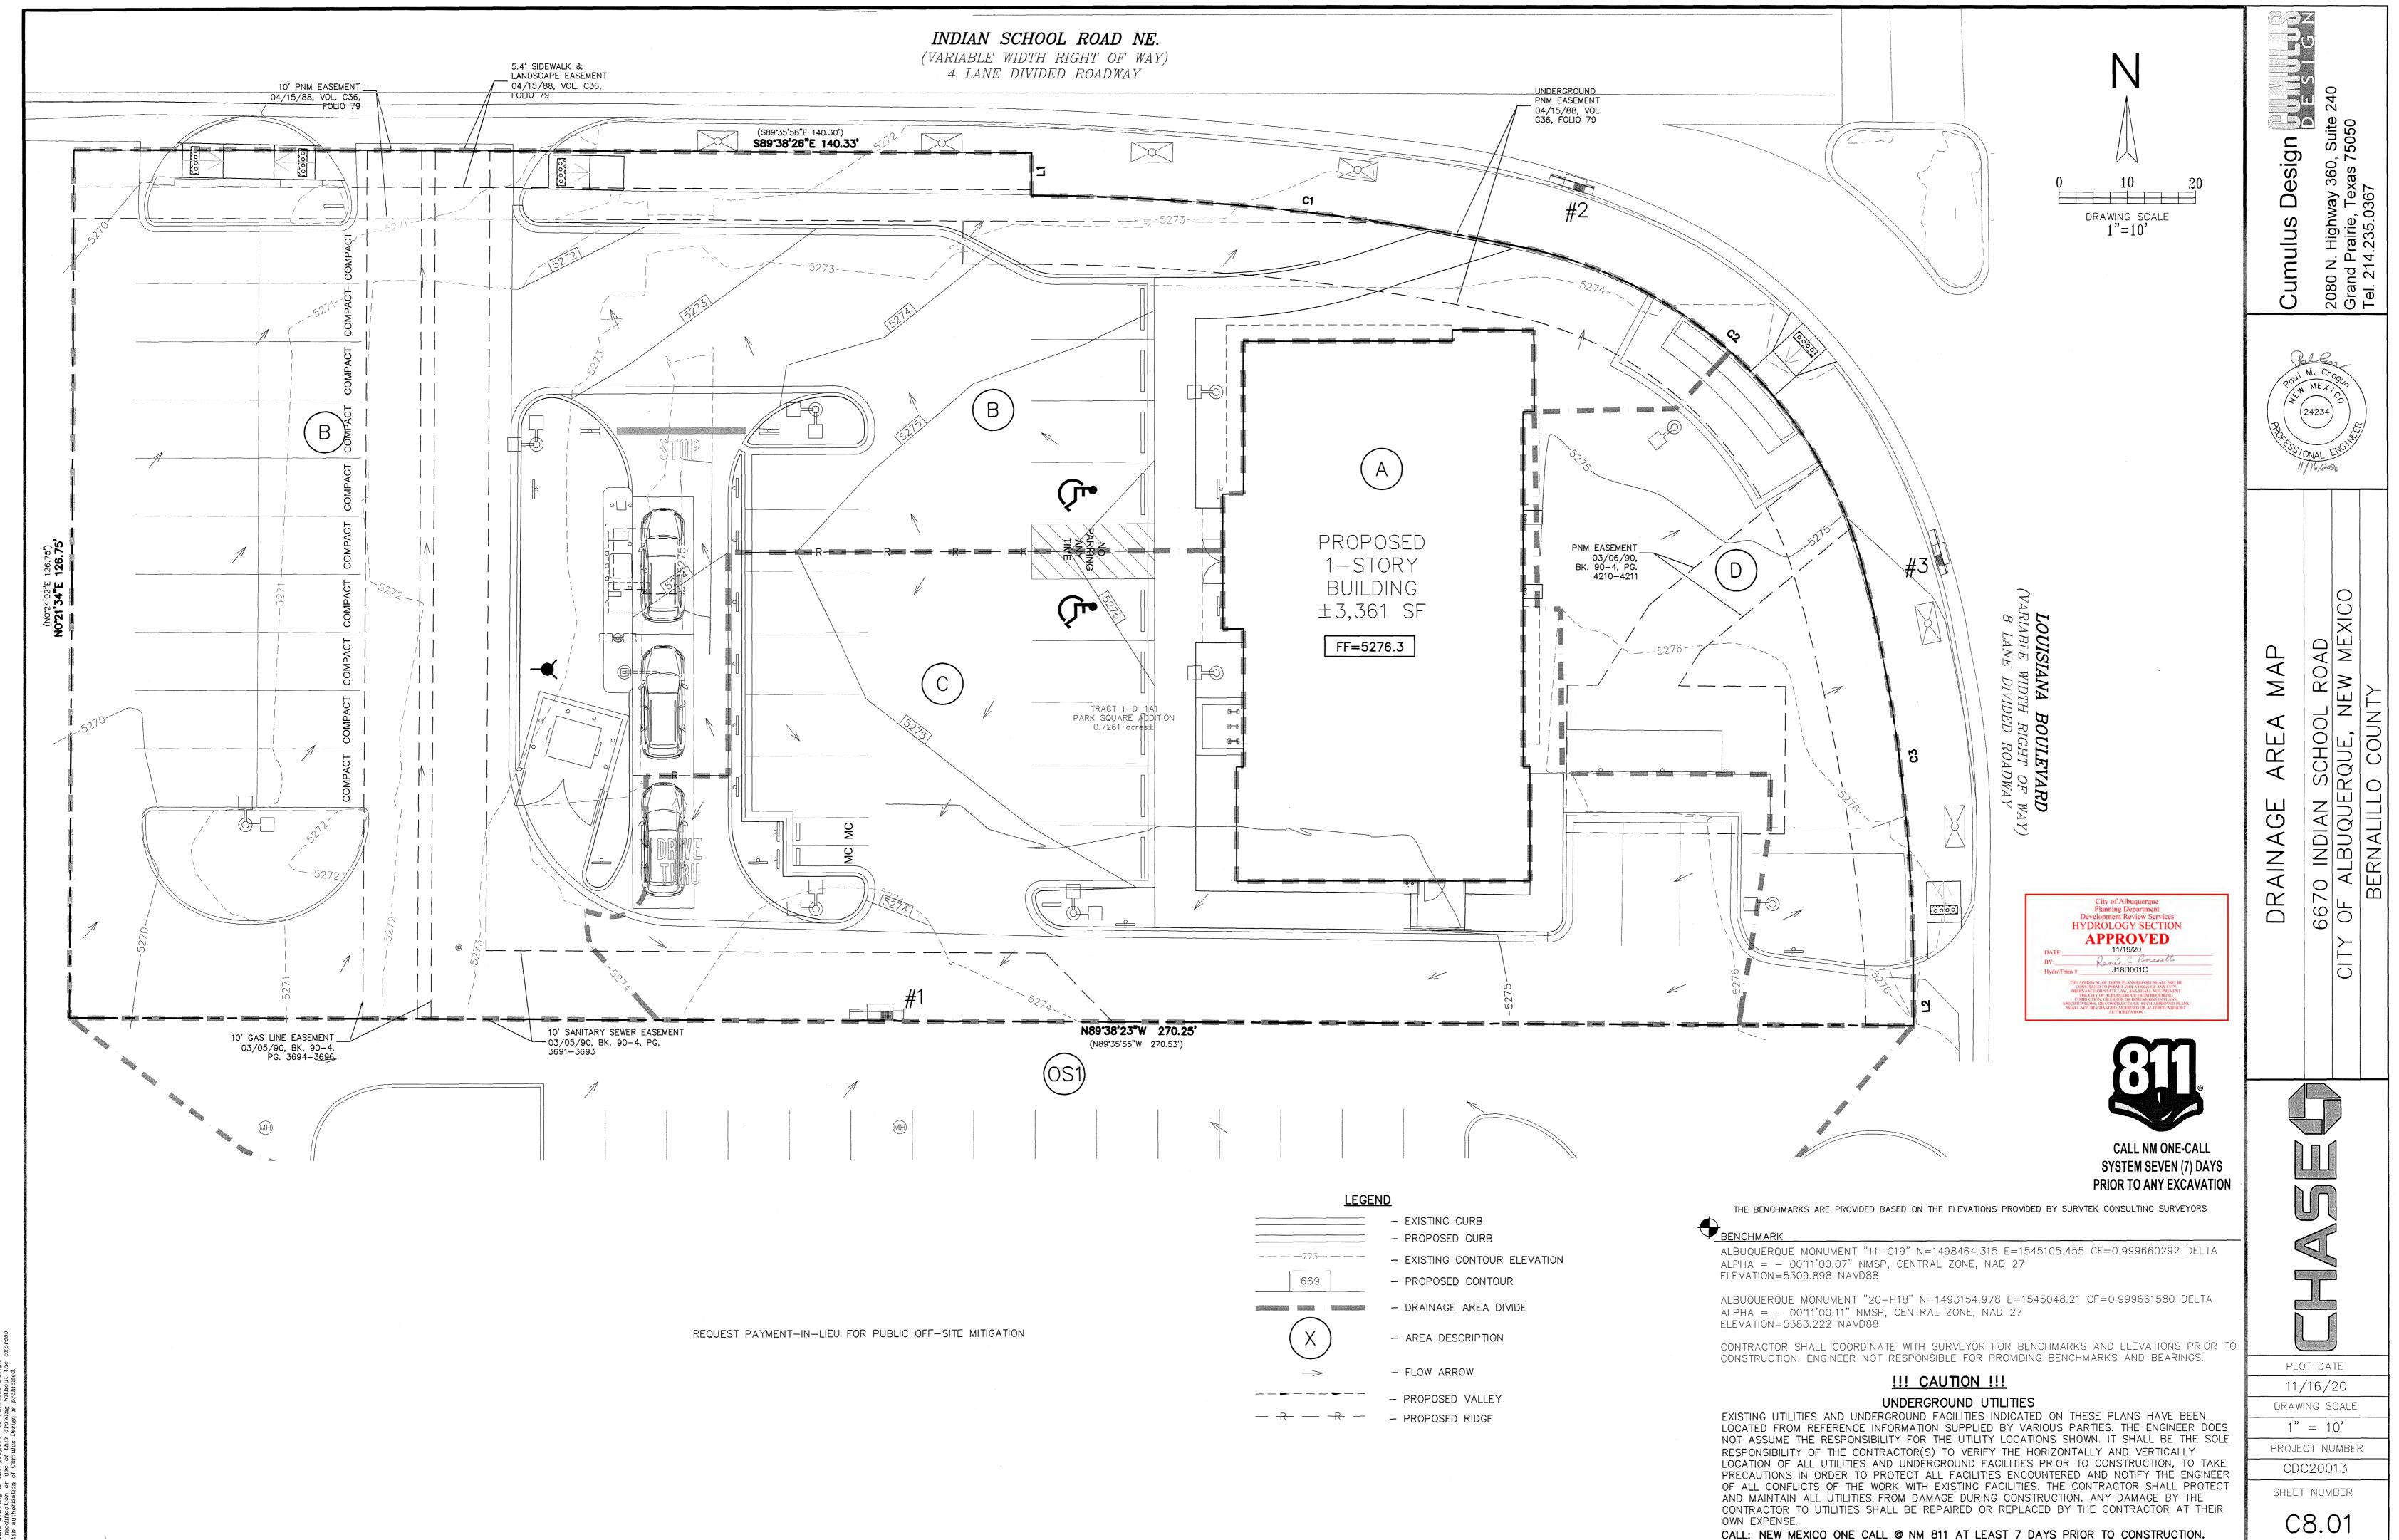

\\SERVER-PC\SERVER\2020 CDC PROJECTS\CDC20013 - INDIAN SCHOOL ROAD, ALBUQUERQUE\PLANS\PROPOSED DRAINAGE AREA MAP CDC20013.DWG

MAP

AREA

AGE

Z Z

DR

6670 INDIAN SCHOOL ROAD
OF ALBUQUERQUE, NEW MEXICO
BERNALILLO COUNTY

PLOT DATE 11/16/20

DRAWING SCALE

PROJECT NUMBER CDC20013

SHEET NUMBER

| | | | · | | | | PROPOS | SED DRA | AINAGE | DATA | CHART | | |
|----------------|-------------------|---------------|------|------|------|-------------|---------------|---------------|----------------|-------------------------|--------------|---------------|---|
| DRAINAGE ID | AREA (SQ. FT.) | AREA (AC.) | C2 | C10 | C100 | Tc (min) | 12 (in/hr) | 10 (in/hr) | 100 (in/hr) | Q ₂ (cfs) | Q10 (cfs) | Q100 (cfs) | COMMENT |
| А | 3361.09 | 0.08 | 0.89 | 0.54 | 0.91 | 5.0 | 1.94 | 3.12 | 4.96 | 0.13 | 0.13 | 0.35 | ROOF DRAINS TO AREA "C" THEN TO INLET #1 |
| В | 17024.66 | 0.39 | 0.74 | 0.50 | 0.83 | 5.0 | 1.94 | 3.12 | 4.96 | 0.56 | 0.61 | 1.61 | DRAINS TO INDIAN SCHOOL RD THEN TO INLET #2 |
| С | 7906.67 | 0.18 | 0.81 | 0.52 | 0.87 | 5.0 | 1.94 | 3.12 | 4.96 | 0.29 | 0.29 | 0.78 | DRAINS TO INLET #1 |
| D | 3335.81 | 0.08 | 0.16 | 0.36 | 0.54 | 5.0 | 1.94 | 3.12 | 4.96 | 0.02 | 0.09 | 0.21 | DRAINS TO LOUISIANA BLVD THEN TO INLET #3 |
| 0S1 | 7709.17 | 0.18 | 0.16 | 0.36 | 0.54 | 5.0 | 1.94 | 3.12 | 4.96 | 0.05 | 0.20 | 0.47 | DRAINS TO AREA "C" |
| TOTAL | 31628.23 | 0.73 | | | | | | | | 1.06 | 1.32 | 3.42 | |


CALCULATIONS ARE BASED ON THE RATIONAL METHOD FROM CITY OF ALBUQUERQUE DEVELOPMENT PROCESS MANUAL CHAPTER 6 - DRAINAGE, FLOOD CONTROL AND EROSION CONTROL. DATED 06/08/2020

| | | | COMPOS | SITE ANA | LYSIS FOF | R RUNOFF | COEFFICIE | NT | | | |
|----------------|-----------------------|---------------------|-----------------------------|---------------------------|------------------------------|----------------------------|-------------------------------|-----------------------------|------|-----------------------------|------------------------------|
| DRAINAGE ID | PERCENT IMPERVIOUS | PERCENT PERVIOUS | C IMPERVIOUS (2 year) | C PERVIOUS (2 year) | C IMPERVIOUS (10 year) | C PERVIOUS (10 year) | C IMPERVIOUS (100 year) | C PERVIOUS (100 year) | | COMPOSITE C (10 year) | COMPOSITE C (100 year) |
| А | 100.0 | 0.0 | 0.89 | 0.08 | 0.54 | 0.34 | 0.91 | .50 | 0.89 | 0.54 | 0.91 |
| В | 81.2 | 18.8 | 0.89 | 0.08 | 0.54 | 0.34 | 0.91 | .50 | 0.74 | 0.50 | 0.83 |
| С | 90.6 | 9.4 | 0.89 | 0.08 | 0.54 | 0.34 | 0.91 | .50 | 0.81 | 0.52 | 0.87 |
| D | 9.5 | 90.5 | 0.89 | 0.08 | 0.54 | 0.34 | 0.91 | .50 | 0.16 | 0.36 | 0.54 |
| OS1 | 9.9 | 90.1 | 0.89 | 0.08 | 0.54 | 0.34 | 0.91 | .50 | 0.16 | 0.36 | 0.54 |

| 80TH PERCENTILE STORMWATER QUALITY VOLUME TABLE | | | | | | | |
|---|-------------------------------------|------------------------------|--|--|--|--|--|
| DRAINAGE ID | NEW IMPERVIOUS AREA (SQ. FT.) | REDEVELOPMENT SITE FACTOR | 80TH PERCENTILE STORM VOLUME (CFS) | | | | |
| А | 3362.0 | 0.26 | 72.8 | | | | |
| В | 4980.0 | 0.26 | 107.9 | | | | |
| С | 3362.0 | 0.26 | 72.8 | | | | |
| D | 0.0 | 0.26 | 0.0 | | | | |
| | | | 253.6 | | | | |

REQUEST PAYMENT-IN-LIEU FOR PUBLIC OFF-SITE MITIGATION

| WEIGHTED ANALYSIS FOR 6-HOUR EXCESS PRECIPITATION, 'E' | | | | | | | |
|--|------------------------|------------------------|-----------------------------|-----------------------------|----------------------------------|-----------------------------------|--|
| DRAINAGE ID | LAND TREATMENT B | LAND TREATMENT D | AREA LAND TREATMENT B | AREA LAND TREATMENT D | WEIGHTED E (100 year) (IN) | VOLUME (100 year) (ACRE-FT) | |
| А | 0.86 | 2.58 | 0.000 | 0.080 | 2.580 | 0.045 | |
| В | 0.86 | 2.58 | 0.073 | 0.317 | 2.257 | 0.008 | |
| С | 0.86 | 2.58 | 0.017 | 0.163 | 2.418 | 0.056 | |
| D | 0.86 | 2.58 | 0.008 | 0.0724 | 2.417 | 0.016 | |
| TOTAL VOLUM | | | | VOLUME | 0.125 | | |

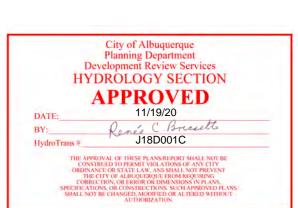



CALL NM ONE-CALL SYSTEM SEVEN (7) DAYS

PRIOR TO ANY EXCAVATION THE BENCHMARKS ARE PROVIDED BASED ON THE ELEVATIONS PROVIDED BY SURVTEK CONSULTING SURVEYORS

ALBUQUERQUE MONUMENT "11-G19" N=1498464.315 E=1545105.455 CF=0.999660292 DELTA $ALPHA = -00^{\circ}11'00.07"$ NMSP, CENTRAL ZONE, NAD 27 ELEVATION=5309.898 NAVD88

ALBUQUERQUE MONUMENT "20-H18" N=1493154.978 E=1545048.21 CF=0.999661580 DELTA ALPHA = - 00°11'00.11" NMSP, CENTRAL ZONE, NAD 27 ELEVATION=5383.222 NAVD88

CONTRACTOR SHALL COORDINATE WITH SURVEYOR FOR BENCHMARKS AND ELEVATIONS PRIOR TO CONSTRUCTION. ENGINEER NOT RESPONSIBLE FOR PROVIDING BENCHMARKS AND BEARINGS.

!!! CAUTION !!!

UNDERGROUND UTILITIES

EXISTING UTILITIES AND UNDERGROUND FACILITIES INDICATED ON THESE PLANS HAVE BEEN LOCATED FROM REFERENCE INFORMATION SUPPLIED BY VARIOUS PARTIES. THE ENGINEER DOES NOT ASSUME THE RESPONSIBILITY FOR THE UTILITY LOCATIONS SHOWN. IT SHALL BE THE SOLE RESPONSIBILITY OF THE CONTRACTOR(S) TO VERIFY THE HORIZONTALLY AND VERTICALLY LOCATION OF ALL UTILITIES AND UNDERGROUND FACILITIES PRIOR TO CONSTRUCTION, TO TAKE PRECAUTIONS IN ORDER TO PROTECT ALL FACILITIES ENCOUNTERED AND NOTIFY THE ENGINEER OF ALL CONFLICTS OF THE WORK WITH EXISTING FACILITIES. THE CONTRACTOR SHALL PROTECT AND MAINTAIN ALL UTILITIES FROM DAMAGE DURING CONSTRUCTION. ANY DAMAGE BY THE CONTRACTOR TO UTILITIES SHALL BE REPAIRED OR REPLACED BY THE CONTRACTOR AT THEIR CALL: NEW MEXICO ONE CALL @ NM 811 AT LEAST 7 DAYS PRIOR TO CONSTRUCTION.

DRAINAGE CRITERIA

ZONE 3 Q=C*I*A I₂=1.94 in/hr

l₁₀=3.12 in/hr l₁₀₀=4.96 in/hr tc=12 min.

\\SERVER-PC\SERVER\2020 CDC PROJECTS\CDC20013 - INDIAN SCHOOL ROAD, ALBUQUERQUE\PLANS\PROPOSED DRAINAGE AREA MAP CDC20013.DWG

CITY OF ALBUQUERQUE



September 28, 2020

Carlos Iglesias Cumulus Design 2080 NB Highway 360 #240 Grand Prairie, Texas

Re: Chase Bank-Indian School Rd 6670 Indian School Road ne Traffic Circulation Layout Architect's Stamp 09-25-2020 (J19-D087)

Dear Mr. Iglesias,

The TCL submittal received 09-25-2020 is approved for Building Permit with. A copy of the stamped and signed plan will be needed for each of the building permit plans. Please keep the original to be used for certification of the site for final C.O. for Transportation.

When the site construction is completed and an inspection for Certificate of Occupancy (C.O.) is requested, use the original City stamped approved TCL for certification. Redline any minor changes and adjustments that were made in the field. A NM registered architect or engineer must stamp, sign, and date the certification TCL along with indicating that the development was built in "substantial compliance" with the TCL. Submit this certification, the TCL, and a completed <u>Drainage and Transportation Information Sheet</u> to front counter personnel for log in and evaluation by Transportation.

Once verification of certification is completed and approved, notification will be made to Building Safety to issue Final C.O. To confirm that a final C.O. has been issued, call Building Safety at 924-3690.

Sincerely

Nilo Salgado-Fernandez, P.E. Senior Engineer, Planning Dept. Development Review Services


C: CO Clerk, File

PO Box 1293

Albuquerque

NM 87103

www.cabq.gov

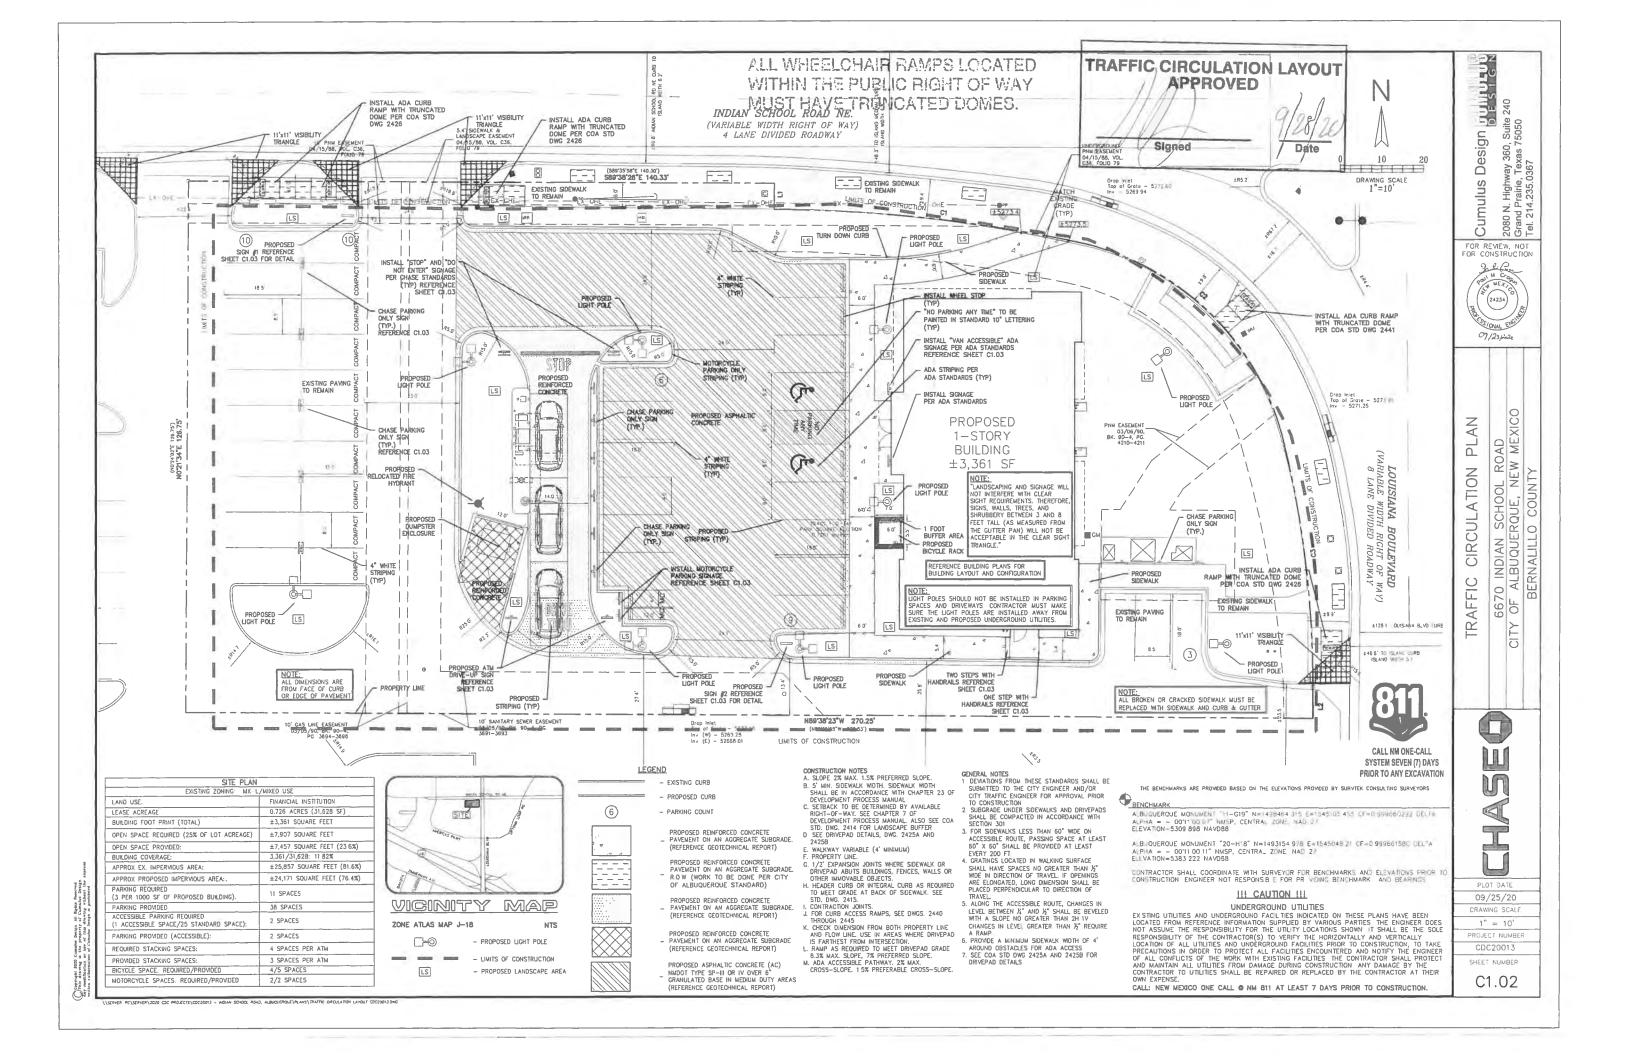



VAN **ACCESSIBLE**

TYPICAL ADA SIGNAGE FOR VAN ACCESSIBLE SPACES

MOUNT W/ CORROSION RESISTANT STOVE BOLT (DEFORM THREADS

ALUMINUN

2" SQUARE 14 GA-QUIK-PUNCH OR APPROVED EQUAL

CONCRETE

ADA DUAL SIGNAGE MOUNTING DETAIL

2 1" 12 GA-QUICK PUNCH

MOUNTING SLEEVE

EXISTING GRADE-

AFTER INSTALLATION)



TYPICAL ADA SIGNAGE N.T.S.



MOTORCYCLE PARKING SIGN

MOUNT W/ CORROSION RESISTANT STOVE BOLT (DEFORM THREADS

TYPICAL

2" SQUARE 14 GA-QUIK-PUNCH OR APPROVED EQUAL

(TYP.)

CONCRETE 2 🖟 12 GA-QUICK-PUNCH

SINGLE ADA AND

MOTORCYCLE SIGNAGE MOUNTING DETAIL

EXISTING GRADE-

MOUNTING SLEEVE

SIGN

AFTER INSTALLATION)



CHASE PARKING ONLY SIGN




R5 - 1(SIZE: 30"×30") DO NOT ENTER SIGN



R1 - 1(SIZE. 30"X30")

STOP SIGN



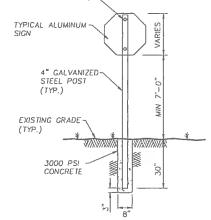


SIGNAGE MOUNTING DETAIL

TRAFFIC CIRCULATION LAYOUT

APPROVED

Signed

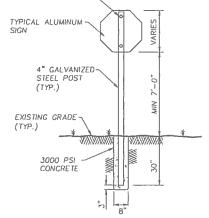


"STOP" AND "DO NOT ENTER"



Date

ADA RAMP HAND RAIL DETAIL


ALL EXPOSED METAL MATERIALS SHALL BE CLEAR ANODIZED ALUMINUM OR PRIMED AND PAINTED H.D. GALVANIZED STEEL

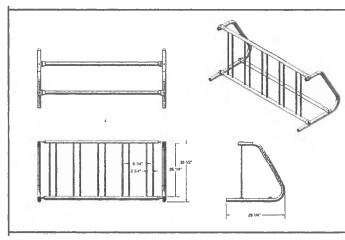

HOTEL

1 PRINCIPATION TO BE COMPLETED IN ACCORDANCE WITH MANUFACTURITY SPECIFICATIONS

BICYCLE RACK DETAIL

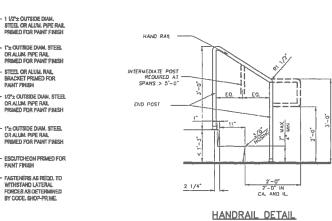

ALL WHEELCHAIR RAMPS LOCATED WITHIN THE PUBLIC RIGHT OF WAY MUST HAVE TRUNCATED DOMES.



CALL NM ONE-CALL SYSTEM SEVEN (7) DAYS PRIOR TO ANY EXCAVATION

THE BENCHMARKS ARE PROVIDED BASED ON THE ELEVATIONS PROVIDED BY SURVIEK CONSULTING SURVEYORS

BENCHMARK

ALBUQUERQUE MONUMENT "11-G19" N=1498464.315 E=1545105.455 CF=0.999660292 DELTA ALPHA = - 00"11"00.07" NMSP, CENTRAL ZONE, NAD 27 ELEVATION=5309.898 NAVD88

ALBUQUERCUE MONUMENT "20-H18" N=1493154 978 E=1545048 21 CF=0 999661580 DELTA ALPHA = - 0011'00.11" NMSP, CENTRAL ZONE, NAD 27 ELEVATION=5383 222 NAVD88

CONTRACTOR SHALL COORDINATE WITH SURVEYOR FOR BENCHMARKS AND ELEVATIONS PRIOR TO CONSTRUCTION ENGINEER NOT RESPONSIBLE FOR PROVIDING BENCHMARKS AND BEARINGS

III CAUTION III

UNDERGROUND UTILITIES


UNDERGROUND UTILITIES


EXISTING UTILITIES AND UNDERGROUND FACILITIES INDICATED ON THESE PLANS HAVE BEEN LOCATED FROM REFERENCE INFORMATION SUPPLIED BY VARIOUS PARTIES. THE ENGINEER DOES NOT ASSUME THE RESPONSIBILITY FOR THE UTILITY LOCATIONS SHOWN. IT SHALL BE THE SOLE RESPONSIBILITY OF THE CONTRACTOR(S) TO VERIFY THE HORIZONTALLY AND VERTICALLY LOCATION OF ALL UTILITIES AND UNDERGROUND FACILITIES PRIOR TO CONSTRUCTION, TO TAKE PRECOLUTIONS IN ORDER TO PROTECT ALL FACILITIES ENCOUNTERED AND NOTIFY THE ENGINEER OF ALL CONTRACTOR SHALL PROTECT AND MAINTAIN ALL UTILITIES FROM DAMAGE DUTING CONSTRUCTION. ANY DAMAGE BY THE CONTRACTOR TO UTILITIES SHALL BE REPAIRED OR REPLACED BY THE CONTRACTOR AT THEIR CONTRACTOR TO UTILITIES SHALL BE REPAIRED OR REPLACED BY THE CONTRACTOR AT THEIR CONTRACTOR. OWN EXPENSE

CALL: NEW MEXICO ONE CALL O NM 811 AT LEAST 7 DAYS PRIOR TO CONSTRUCTION

19.5

TEXT DETAILS

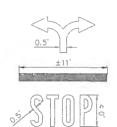

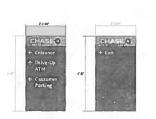

ENTRANCE SIGN #1 DETAIL



ENTRANCE SIGN #2 DETAIL



DRIVE-THRU ATM SIGNAGE DETAIL

drawing is the property of Cusy Wasten, at use of the drawing withoutsolven of Cornels Design as

SHEET NUMBER C1.03

Q

PLOT DATE

09/25/20

TRAWING SCALE

CDC20013

Design

Cumulus

PLAN

CIRCULATION

TRAFFIC

FOR REVIEW, NOT

, Suite 75050

e, Texas 75

2080 N. F Grand Pra Tel. 214.2

70 INDIAN SCHOOL ROAD
- ALBUQUERQUE, NEW MEXICO
BERNALILLO COUNTY


667 OF











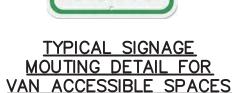

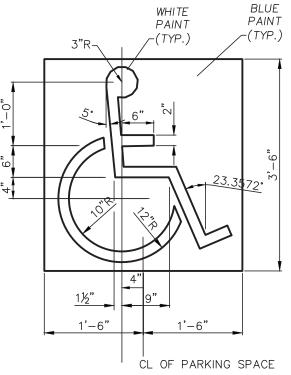

ACCESSIBLE PARKING SYMBOL DETAIL

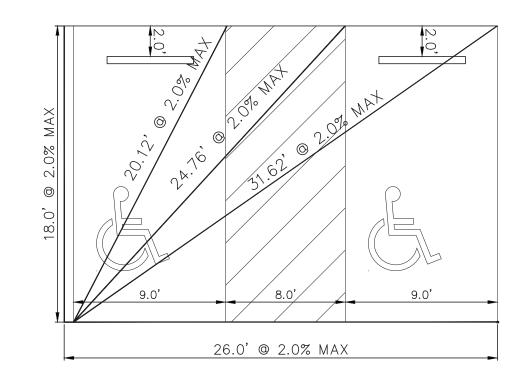

ADA PARKING STALLS AND AISLE DETAIL




TYPICAL SIGNAGE MOUTING DETAIL FOR


ACCESSIBLE SPACES

(SIZE: 30"X30") STOP SIGN




R5 - 1(SIZE: 30"x30") DO NOT ENTER SIGN

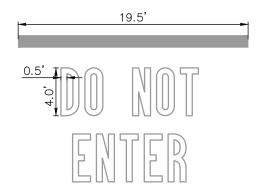

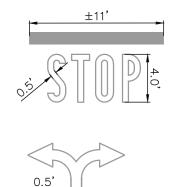



TEXT DETAILS

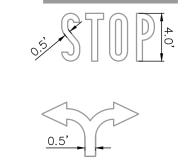


MOUNT W/ CORROSION RESISTANT STOVE BOLT (DEFORM THREADS STOVE BÓLT (DEFORM THREADS AFTER INSTALLATION) AFTER INSTALLATION) TYPICAL-TYPICAL-ALUMINUM ALUMINUM SIGN 2" SQUARE 14 GA \ QUIK-PUNCH OR 2" SQUARE 14 GA— QUIK—PUNCH OR APPROVED EQUAL APPROVED EQUAL EXISTING GRADE -EXISTING GRADE 7 3000 PSI CONCRETE CONCRETE QUICK-PUNCH QUICK-PUNCH MOUNTING SLEEVE MOUNTING SLEEVE ADA DUAL SIGNAGE MOUNTING DETAIL


MOUNT W/ CORROSION RESISTANT TYPICAL SIGNAGE MOUNTING DETAIL

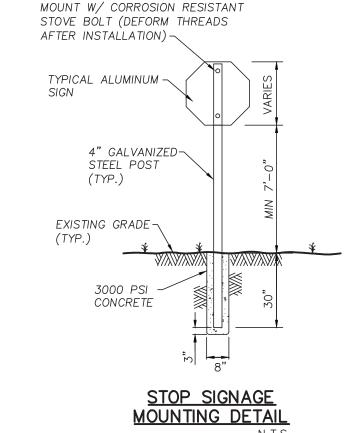


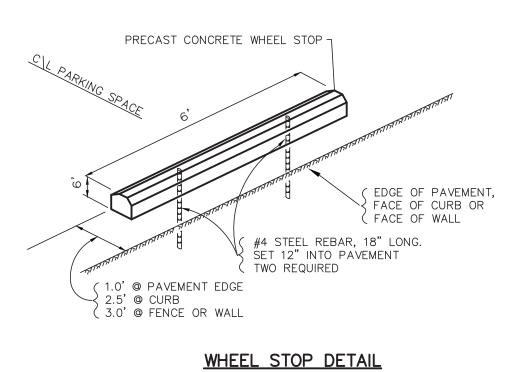

DETAILS ON THIS SHEET ARE PRIVATE. ALL WORK WITHIN PUBLIC EASEMENTS OR RIGHT-OF-WAY SHALL BE PER CITY (OR STATE, IF APPLICABLE) STANDARD DETAILS. THE CONTRACTOR IS REQUIRED TO HAVE ON—SITE, AT ALL TIMES, A COPY OF THE CITY'S CONSTRUCTION DETAILS.

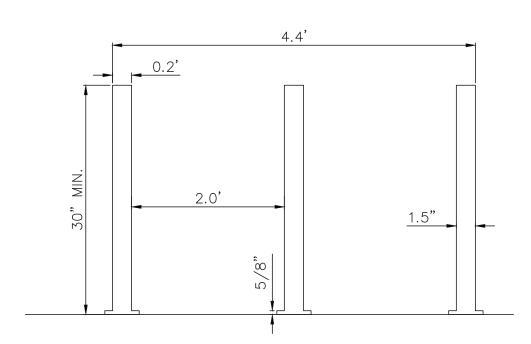

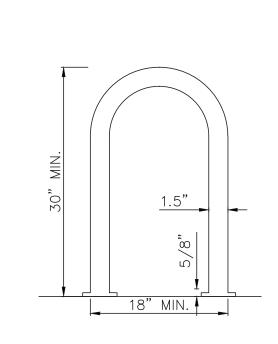


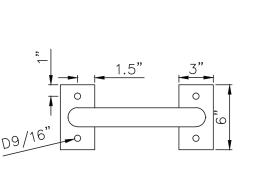


1. INSTALLATION TO BE COMPLETED IN ACCORDANCE WITH MANUFACTURER'S SPECIFICATIONS.

BICYCLE RACK DETAIL N.T.S.

MISCELLANEOUS DETAILS

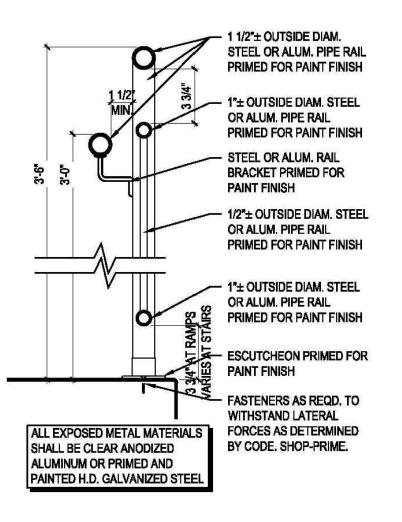



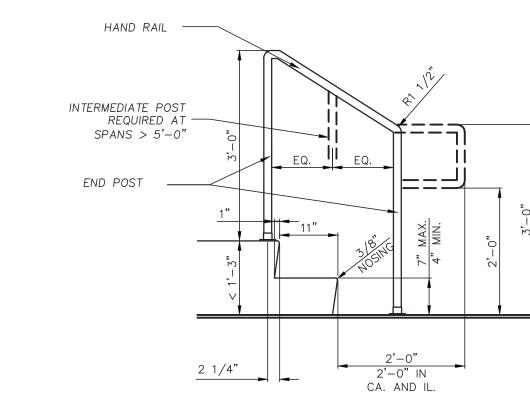


1.0. DRIVE-THRU ATM SIGNAGE DETAIL

MOTORCYCLE PARKING


HANDRAIL DETAIL



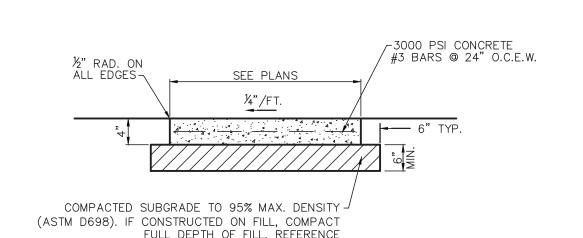


SIDEWALK CROSS-SECTION

GEOTECHNICAL REPORT FOR DETAILS

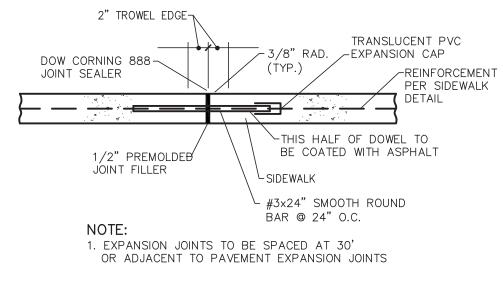

EXPANSION JOINT

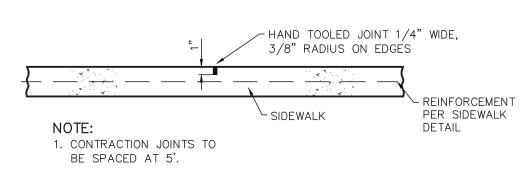

CONTRACTION JOINT

SIDEWALK DETAILS



esign

AD MEXICO

70 INDIAN - ALBUQU BERNALIL

(PRIVA)

TAIL

02/18/21 DRAWING SCALE

PROJECT NUMBER CDC20013

SHEET NUMBER

C13.02


\\SERVER-PC\\SERVER\\2020 CDC PROJECTS\\CDC20013 - INDIAN SCHOOL ROAD, ALBUQUERQUE\\PLANS\\DETAILS (PRIVATE) CDC20013.DWG



SYSTEM SEVEN (7) DAYS
PRIOR TO ANY EXCAVATION

| EXISTING ZONING: MX-L | /MIXED USE |
|---|-----------------------------|
| LAND USE: | FINANCIAL INSTITUTION |
| LEASE ACREAGE: | 0.726 ACRES (31,628 SF) |
| BUILDING FOOT PRINT (TOTAL): | ±3,361 SQUARE FEET |
| OPEN SPACE REQUIRED (25% OF LOT ACREAGE): | ±7,907 SQUARE FEET |
| OPEN SPACE PROVIDED: | ±7,457 SQUARE FEET (23.6%) |
| BUILDING COVERAGE: | 3,361/31,628: 11.82% |
| APPROX EX. IMPERVIOUS AREA: | ±25,857 SQUARE FEET (81.6%) |
| APPROX PROPOSED IMPERVIOUS AREA:: | ±24,171 SQUARE FEET (76.4%) |
| PARKING REQUIRED (3 PER 1000 SF OF PROPOSED BUILDING): | 11 SPACES |
| PARKING PROVIDED: | 39 SPACES |
| ACCESSIBLE PARKING REQUIRED (1 ACCESSIBLE SPACE/25 STANDARD SPACE): | 2 SPACES |
| PARKING PROVIDED (ACCESSIBLE): | 2 SPACES |
| REQUIRED STACKING SPACES: | 4 SPACES PER ATM |
| PROVIDED STACKING SPACES: | 3 SPACES PER ATM |
| BICYCLE SPACE: REQUIRED/PROVIDED | 4/5 SPACES |

SITE PLAN

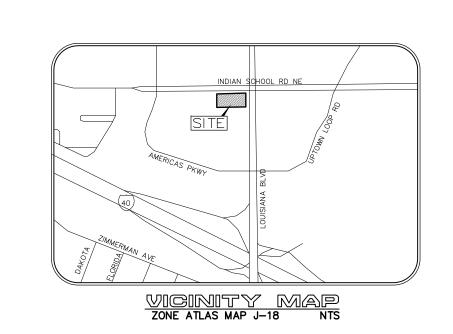


| SPACES SURE | POLES SHOULD NOT BE INSTALLED IN PARKING AND DRIVEWAYS. CONTRACTOR MUST MAKE THE LIGHT POLES ARE INSTALLED AWAY FROM G AND PROPOSED UNDERGROUND UTILITIES. |
|----------------|---|
| | NOTF: |
| | ALL DIMENSIONS ARE FROM FACE OF CURB OR EDGE OF PAVEMENT |
| | NOTE: ALL DIMENSIONS ARE FROM FACE OF CURB OR EDGE OF PAVEMENT |

NOTE: All broken or cracked sidewalk must be replaced with sidewalk and curb & gutter.

| - EXISTING CURB |
|---------------------|
| - PROPOSED CURB |

<u>LEGEND</u>

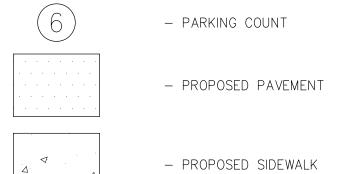

— _ ⊿ − PROPOSED LIGHT POLE

- LIMITS OF CONSTRUCTION

THE BENCHMARKS ARE PROVIDED BASED ON THE ELEVATIONS PROVIDED BY SURVTEK CONSULTING SURVEYORS

ALBUQUERQUE MONUMENT "11-G19" N=1498464.315 E=1545105.455 CF=0.999660292 DELTA ALPHA = - 00°11'00.07" NMSP, CENTRAL ZONE, NAD 27 ELEVATION=5309.898 NAVD88

ALBUQUERQUE MONUMENT "20-H18" N=1493154.978 E=1545048.21 CF=0.999661580 DELTA ALPHA = - 00°11'00.11" NMSP, CENTRAL ZONE, NAD 27 ELEVATION=5383.222 NAVD88

CONTRACTOR SHALL COORDINATE WITH SURVEYOR FOR BENCHMARKS AND ELEVATIONS PRIOR TO CONSTRUCTION. ENGINEER NOT RESPONSIBLE FOR PROVIDING BENCHMARKS AND BEARINGS.

!!! CAUTION !!!

UNDERGROUND UTILITIES

EXISTING UTILITIES AND UNDERGROUND FACILITIES INDICATED ON THESE PLANS HAVE BEEN LOCATED FROM REFERENCE INFORMATION SUPPLIED BY VARIOUS PARTIES. THE ENGINEER DOES NOT ASSUME THE RESPONSIBILITY FOR THE UTILITY LOCATIONS SHOWN. IT SHALL BE THE SOLE RESPONSIBILITY OF THE CONTRACTOR(S) TO VERIFY THE HORIZONTALLY AND VERTICALLY LOCATION OF ALL UTILITIES AND UNDERGROUND FACILITIES PRIOR TO CONSTRUCTION, TO TAKE PRECAUTIONS IN ORDER TO PROTECT ALL FACILITIES ENCOUNTERED AND NOTIFY THE ENGINEER OF ALL CONFLICTS OF THE WORK WITH EXISTING FACILITIES. THE CONTRACTOR SHALL PROTECT AND MAINTAIN ALL UTILITIES FROM DAMAGE DURING CONSTRUCTION. ANY DAMAGE BY THE CONTRACTOR TO UTILITIES SHALL BE REPAIRED OR REPLACED BY THE CONTRACTOR AT THEIR OWN EXPENSE.

CALL: NEW MEXICO ONE CALL @ NM 811 AT LEAST 48 HRS PRIOR TO CONSTRUCTION.

F ALBUQU BERNALIL

FOR REVIEW, NOT FOR CONSTRUCTION

THIS DOCUMENT IS RELEASED FOR INFORMATION

PURPOSES UNDER THE AUTHORITY OF PAUL

CRAGUN, P.E. NO. 112767 ON

9/1/20.

PLAN

PLOT DATE

09/01/20

DRAWING SCALE

1" = 20'

PROJECT NUMBER

CDC20013

SHEET NUMBER

\\SERVER-PC\SERVER\2020 CDC PROJECTS\CDC20013 - INDIAN SCHOOL ROAD, ALBUQUERQUE\PLANS\REFUSE SITE PLAN CDC20013.DWG

1/2 SPACES

MOTORCYCLE SPACES: REQUIRED/PROVIDED

CHASE (

#38200P367111
Indian School Rd NE and Louisiana Rd
6670 Indian School Rd NE
Albuquerque, NM 87110



REVISION NOTES:

R1: Customer Drawing - add additional approval tenant panels - 08.13.20 - AS R2: Customer Drawing - Added motorcycle post signs and updated site plan. - AS - 09/04/20

R4: Customer Drawing - E7 and 8 changed to stop dot sign. E9 and 10 changed to custom ada handicap signs. - AS - 10/02/20



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JP Morgan Chase Bank #38200P367111

Indian School Rd NE & Louisiana Rd 6670 Indian School Rd NE Albuquerque, NM 87110

Initial Date: ___08/10/20
Salesperson: Arthur Navarro
Coordinator: Lorena Leon
Designer: ASena

CUSTOMER APPROVAL

As noted

Customer Signature

COPY, COLORS & SIZES

Signtech does NOT provide primary electrical to sign location -

RESPONSIBILITY OF OTHERS!

Customer Signature

Date

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Drawing Number:

CHASE 38000P123456 1

20-01032

Project ID: Revision:

R4 - 10.02.20

age: 1

EXTERIOR SIGN LEGEND - ALLOWED

| Elevation | Sign No. | Sign Type | Description | Sq.Ft. |
|-----------|----------|-------------------------|--|--------|
| North | E.1 | LIF-WBO-24-BTWR | $24\ensuremath{^{"}}$ White Channel Letters and Logo - Behind the wall Raceway | 36.9 |
| West | E.2 | LIF-WB0-24-BTWR | $24\ensuremath{^{"}}$ White Channel Letters and Logo - Behind the wall Raceway | 36.9 |
| South | E.3 | LIF-WBO-24 | 24" White Channel Letters and Logo | 36.9 |
| East | E.4 | LIF-WB0-24-BTWR | 24" White Channel Letters and Logo - Behind the wall Raceway | 36.9 |
| | E.5 | HB-U | Headache Bar | |
| | E.6 | CAN-ATM-SIG-OCT | ATM Signature Canopy w/ Octagon | |
| | E.7 | TC-P-STOP-DNE-DOT-RE | Post Mount Do Not Enter Sign - STOP/DOT Standard | |
| | E.8 | TC-P-STOP-DNE-DOT-RE | Post Mount Do Not Enter Sign - STOP/DOT Standard | |
| | E.9 | CUSTOM TC-P-ADA-NM-V-RE | Post Mount Handicap Stall Sign - Van Accessible - City Spe | cific |
| | E.10 | CUSTOM TC-P-ADA-NM-RE | Post Mount Handicap Stall Sign - City Specific | |
| | E.11 | D-7.6-RE | Non-Illuminated Directional Monument | |
| | E.12 | D-7.6-RE | Non-Illuminated Directional Monument | |
| | E.29 | TC-P-MOTORCYCLE | Post Mount Motorcycle Stall Sign | |
| | E.30 | TC-P-MOTORCYCLE | Post Mount Motorcycle Stall Sign | |
| | | | Total Proposed Sq Ft | 147.6 |

CHASE 🔘

INDIAN SCHOOL RD NE

468

320.4

Total Allowable Sq Ft

Difference

LOUISIANA JARD SIDE EI +/- 3,361 S.F. BLVD Z

SCALE: 1/32"=1'-0"

SITE PLAN



signtech.com





JP Morgan Chase Bank #38200P367111

Indian School Rd NE & Louisiana Rd 6670 Indian School Rd NE Albuquerque, NM 87110

Initial Date: ___08/10/20 Salesperson: Arthur Navarro Coordinator: Lorena Leon **ASena** Designer:_ As noted

CUSTOMER APPROVAL

Customer Signature

COPY, COLORS & SIZES

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RESPONSIBILITY OF OTHERS!

Customer Signature

Date

20-01032

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Drawing Number:

CHASE 38000P123456 1

Revision:

Project ID:

R4 - 10.02.20

Sign Legend / Site Plan

EXTERIOR SIGN LEGEND - REQUIRES ADDITIONAL APPROVAL

| Elevation | Sign No. | Sign Type | Description | Sq.Ft. |
|-----------|----------|--------------|--|--------|
| | E.25 | TENANT PANEL | Pylon Tenant Panel w/ Blue Plex Face and Vinyl | |
| | E.26 | TENANT PANEL | Pylon Tenant Panel w/ Blue Plex Face and Vinyl | |
| | E.27 | TENANT PANEL | Pylon Tenant Panel w/ Blue Plex Face and Vinyl | |
| | E.28 | TENANT PANEL | Pylon Tenant Panel w/ Blue Plex Face and Vinyl | |





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JP Morgan Chase Bank #38200P367111

Indian School Rd NE & Louisiana Rd 6670 Indian School Rd NE Albuquerque, NM 87110

Initial Date: 08/10/20
Salesperson: Arthur Navarro
Coordinator: Lorena Leon

Designer: ASena

Scale: As noted

CUSTOMER APPROVAL

Customer Signature

CIZEC

COPY, COLORS & SIZES

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Customer Signature

Date

20-01032

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Drawing Number:

Project ID:


CHASE_38000P123456_1

Revision:

R4 - 10.02.20

DRC Page 3

aue.

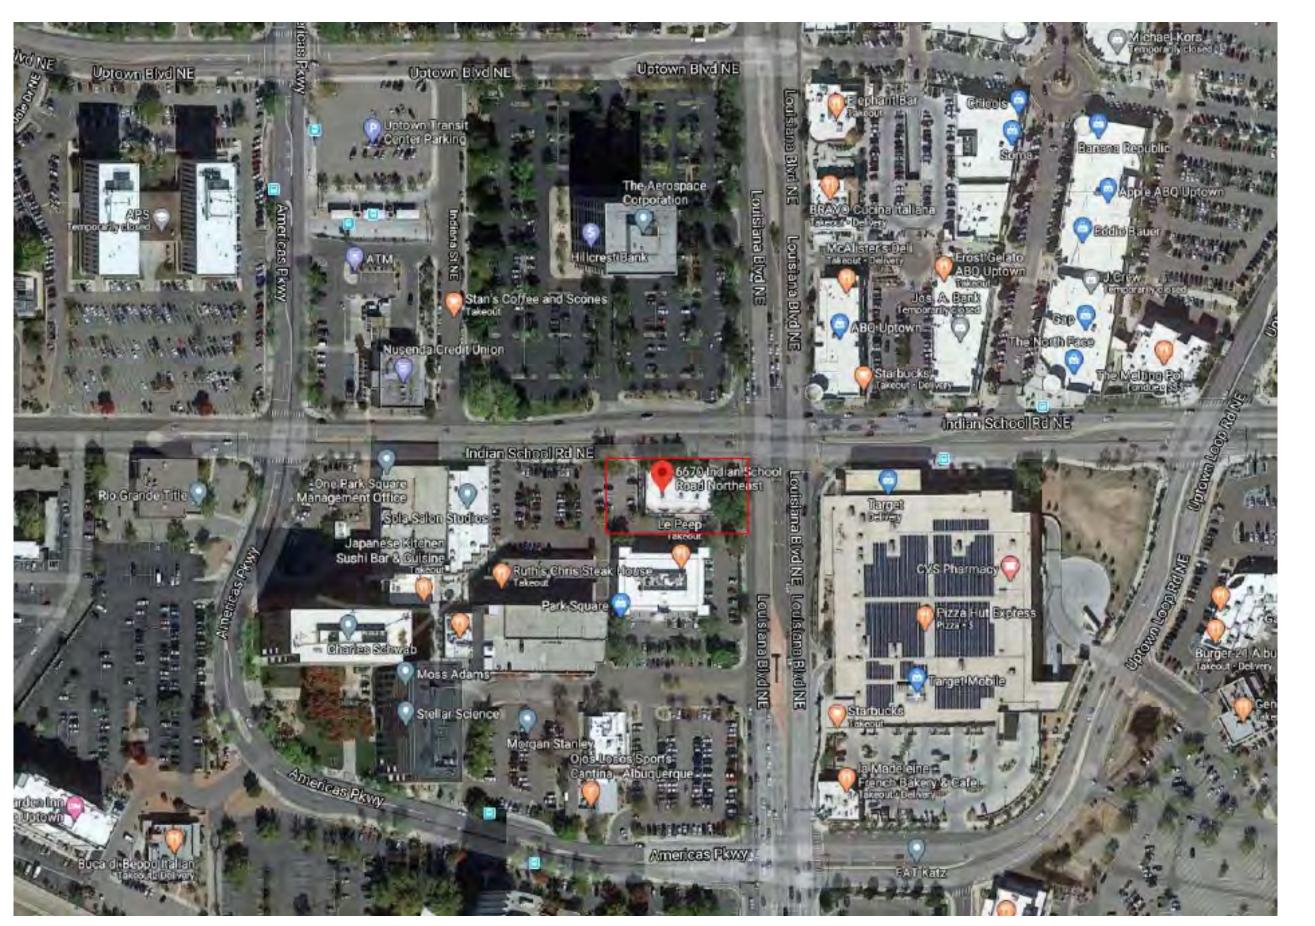



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JP Morgan Chase Bank #38200P367111

Indian School Rd NE & Louisiana Rd 6670 Indian School Rd NE Albuquerque, NM 87110

Initial Date: ___08/10/20 Salesperson: Arthur Navarro Coordinator: Lorena Leon **ASena** Designer:_

As noted

CUSTOMER APPROVAL

Customer Signature

COPY, COLORS & SIZES

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RESPONSIBILITY OF OTHERS!

Customer Signature

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Drawing Number:

CHASE 38000P123456 1

Revision:


R4 - 10.02.20

20-01032

Enlarged Aerial Site

INTERIOR SIGN LEGEND

| Elevation | Sign No. | Sign Type | Description | Sq.Ft. |
|-----------|----------|----------------|---|--------|
| | I.13 | SUR-TTW-U-4-TP | Universal Thin-Profile ATM Surround | |
| | E.14 | ADA-EP | ADA Accessible Entrance Plaque | |
| | I.15 | ADA-EX | ADA Exit Plaque | |
| | I.16 | ADA-EX | ADA Exit Plaque | |
| | 1.17 | OCT-24-INT | Illuminated Blue Bitro Interior Octagon | |
| | I.18 | ADA-TW | ADA Accessible Teller Window Plaque | |
| | I.19 | ADA-TW-ALS | ADA Assisted Listening System Plaque | |
| | 1.20 | ADA-EEX | ADA Emergency Exit Plaque | |
| | 1.21 | ADA-EEX | ADA Emergency Exit Plaque | |
| | 1.22 | ADA-RRAG-A-G | ADA Accessible All-Gender Restroom Plaque | |
| | 1.23 | ADA-RRAG-A-G | ADA Accessible All-Gender Restroom Plaque | |
| | E.24 | ADA-EO | ADA Exit Only Plaque | |

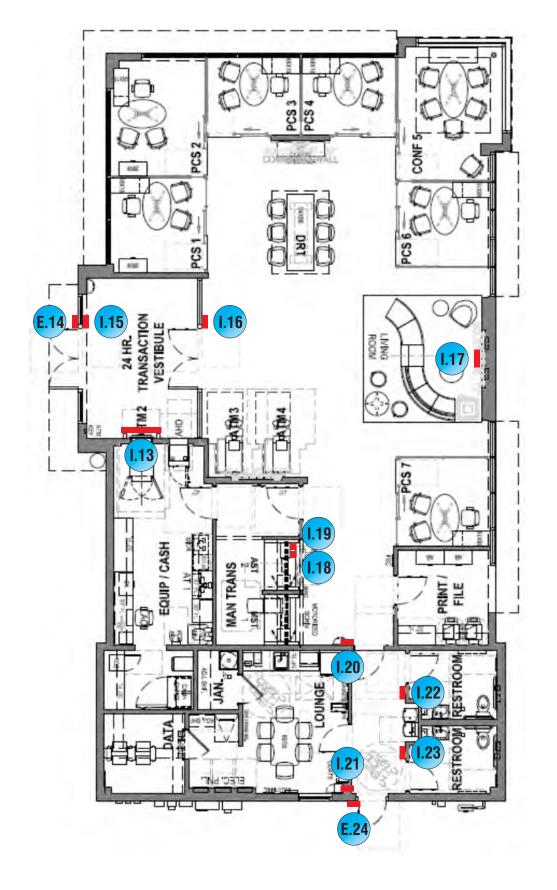

DESIGN STANDARDS 7B HARDINESS ZONE 20.2 OVERHEAD DOOR ACCEPTABLE *

(1) OFFICE SHALL RECEIVE DUAL MONITORS & ARMS FOR CPC OR FUTURE CPC.

FLOOR PLAN SCALE: 3/32"=1'-0"

DESIGNER DATE 07/02/2020 MJB



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JP Morgan Chase Bank #38200P367111

Indian School Rd NE & Louisiana Rd 6670 Indian School Rd NE Albuquerque, NM 87110

Initial Date: ___08/10/20 Salesperson: Arthur Navarro Coordinator: Lorena Leon **ASena** Designer:_

CUSTOMER APPROVAL

As noted

Customer Signature

COPY, COLORS & SIZES

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RESPONSIBILITY OF OTHERS!

Customer Signature

Date

20-01032

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Drawing Number:

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Revision:

Project ID:


R4 - 10.02.20

Sign Legend / Floor Plan

DRC Page 5

* HARDINESS ZONES >/= 7A

SIGNAGE OVERVIEW - ALLOWED

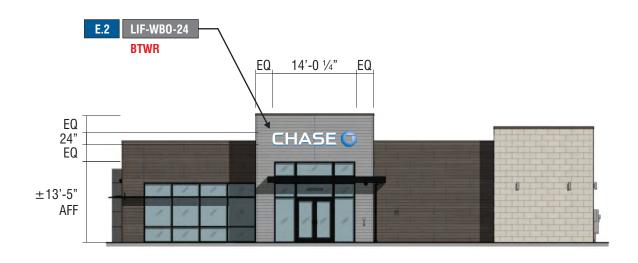


WEST ELEVATION SCALE: 1/16"=1'-0"

14'-0 1/4"

CHASE 🗅


AFF

EQ

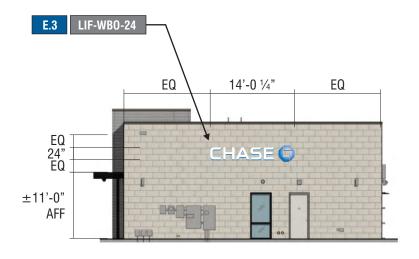

SOUTH ELEVATION

SCALE: 1/16"=1'-0"

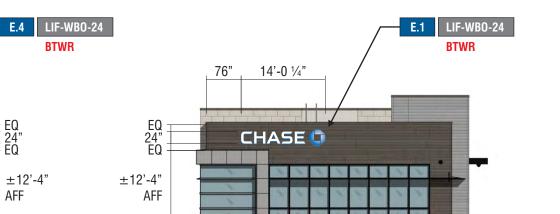

EAST ELEVATION SCALE: 1/16"=1'-0" **NORTH ELEVATION SCALE:** 1/16"=1'-0"







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CUSTOMER APPROVAL

As noted

Customer Signature

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Customer Signature

Date

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Drawing Number:

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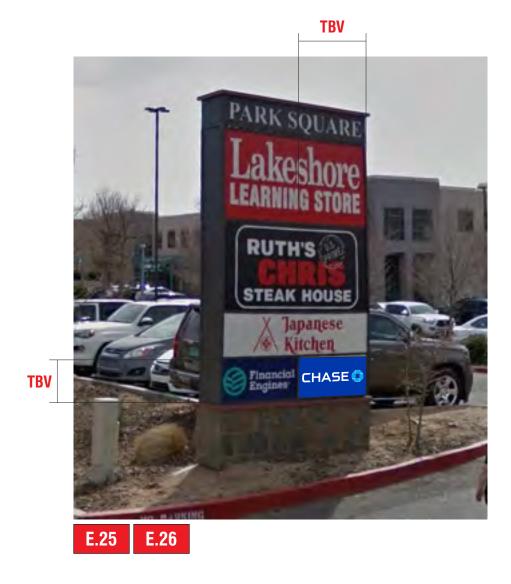
CHASE 38000P123456 1 Project ID:

Revision:

R4 - 10.02.20

Exterior Elevations

SIGNAGE OVERVIEW - ADDITIONAL APPROVAL REQUIRED



TBV ARK SOUARE RUTH'S STEAK HOUSE LePeep Grill LeBreakfast LeLunch CHASE 4 E.28

E.27

MONUMENT ON INDIAN SCHOOL RD NE

SCALE: NTS

MONUMENT ON LOUSIANA BLVD NE

SCALE: NTS

E.28 E.27

SIGN TYPE CUSTOM TENANT PANEL WITH MORE THAN TWO TENANTS WITH WHITE PLEX/LEXAN FACE AND VINYL



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CUSTOMER APPROVAL

As noted

Customer Signature

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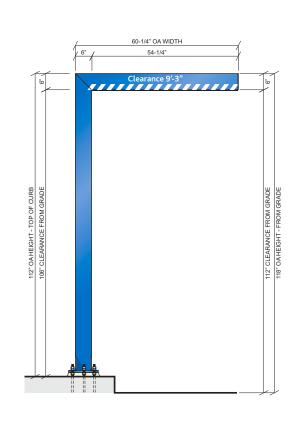
Project ID:

CHASE 38000P123456 1

Revision:

R4 - 10.02.20

SIGNAGE OVERVIEW







FRONT VIEW CAN-ATM SCALE: 1/4" = 1'-0"

SIGN TYPE CAN-ATM-SIG-OCT


I.13 SIGN TYPE SUR-TTW-U-4-TP THIN PROFILE

46" 38 1/4"


CHASE 🗘

181


SIGN TYPE HB-U

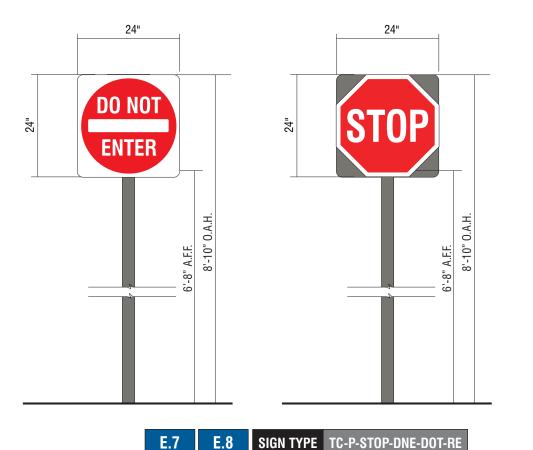


CUSTOM POST MOUNT D/F DOT STOP/DNE SIGN FACES

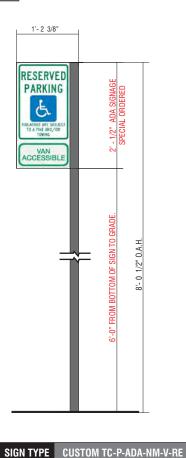

CITY SPECIFIC

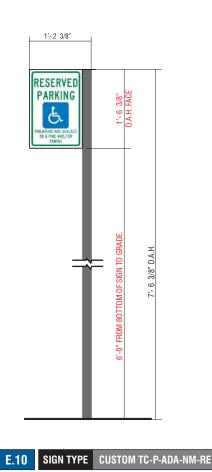

CITY SPECIFIC

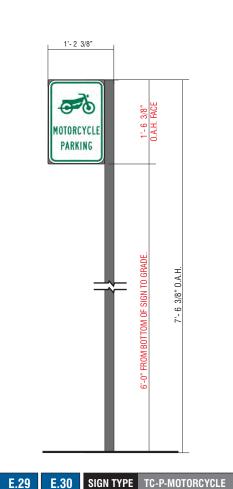





JP Morgan Chase Bank #38200P367111

Indian School Rd NE & Louisiana Rd 6670 Indian School Rd NE Albuquerque, NM 87110

Initial Date: __08/10/20 Salesperson: Arthur Navarro Coordinator: Lorena Leon **ASena** Designer:_ As noted

CUSTOMER APPROVAL

Customer Signature

COPY, COLORS & SIZES

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RESPONSIBILITY OF OTHERS!

Customer Signature

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Drawing Number:


CHASE 38000P123456 1

Project ID: Revision:

R4 - 10.02.20

20-01032

SIGNAGE OVERVIEW

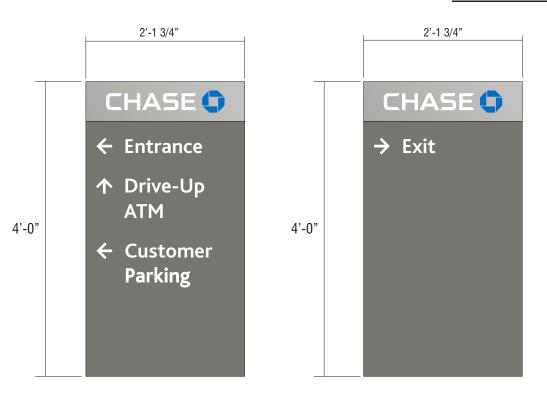

CHASE ↓

↑ Entrance

← Drive-Up

ATM

↑ Customer

Parking

CHASE ↓

← Exit

→ Drive-Up


ATM

FRONT VIEW BACK VIEW FRONT VIEW BACK VIEW


E.11 SIGN TYPE D-7.6-RE

E.12

SIGN TYPE D-7.6-RE

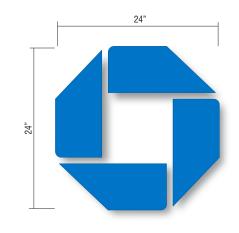

I.17 SIGN TYPE OCT-24-INT
BLUE BITRO

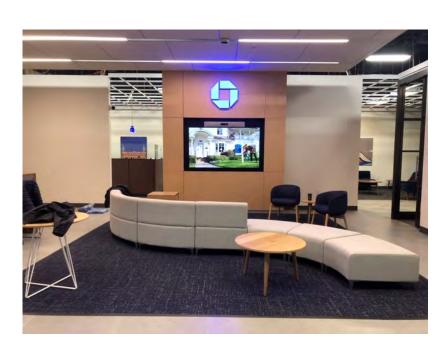







JP Morgan Chase Bank #38200P367111

Indian School Rd NE & Louisiana Rd 6670 Indian School Rd NE Albuquerque, NM 87110

Initial Date: ___08/10/20
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Coordinator: Lorena Leon
Designer: ASena

CUSTOMER APPROVAL

As noted

Customer Signature

COPY, COLORS & SIZES

Signtech does NOT provide primary electrical to sign location -

RESPONSIBILITY OF OTHERS!

Customer Signature

Da

20-01032

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Drawing Number:


Project ID: CHASE 38000P123456 1


Revision:

DRC Page 9

aue.

SIGNAGE OVERVIEW

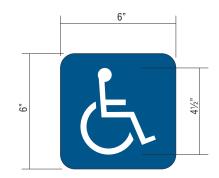


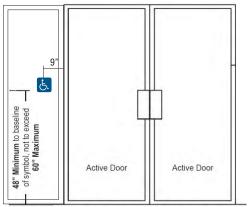


Double door with both doors active, sign is mounted to the <u>left</u> of the <u>left</u> side door

E.14

SIGN TYPE ADA-EP ACCESSIBILITY PLAQUE

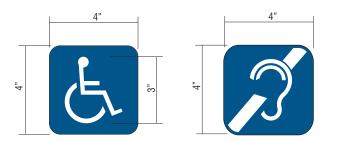

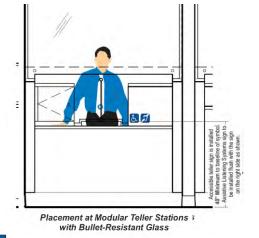


I.18

SIGN TYPE ADA-TW ACCESSIBLE TELLER PLAQUE

1.19


SIGN TYPE ADA-TW-ALS ASSISTED LISTENING SYSTEM PLAQUE



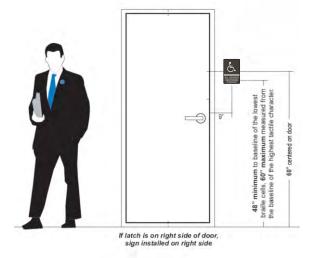


1.23


SIGN TYPE ADA-RRAG-A-G ALL-GENDER RESTROOM PLAQUES

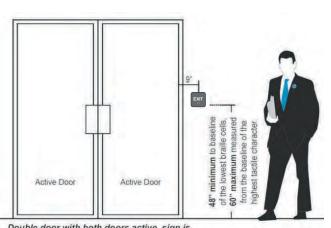


Double door with both doors active, sign is mounted to the right of the right hand door

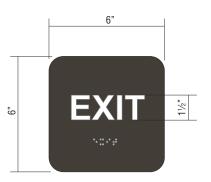

I.15 I.16 SIGN TYPE ADA-EX EXIT PLAQUE

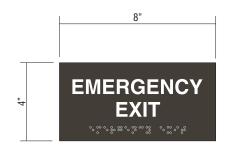

1.20 1.21 SIGN TYPE ADA-EEX EMERGENCY EXIT PLAQUE

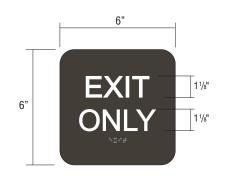

E.24

SIGN TYPE ADA-EO EXIT ONLY PLAQUE



Phone: (619) 527-6100 / Fax: (619) 527-6111 signtech.com





JP Morgan Chase Bank #38200P367111

Indian School Rd NE & Louisiana Rd 6670 Indian School Rd NE Albuquerque, NM 87110

Initial Date: ___08/10/20 Salesperson: Arthur Navarro Coordinator: Lorena Leon **ASena** Designer:_ As noted

CUSTOMER APPROVAL

Customer Signature

COPY, COLORS & SIZES

Signtech does NOT provide primary electrical to sign location -

RESPONSIBILITY OF OTHERS!

Customer Signature

Date

20-01032

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Drawing Number:

CHASE 38000P123456 1 Project ID:

R4 - 10.02.20 Revision:



CITY OF ALBUQUERQUE INVOICE

CUMULUS DESIGN 2080 N. HIGHWAY

Reference NO: SI-2021-01129 Customer NO: CU-120002707

DateDescriptionAmount7/22/212% Technology Fee\$1.007/22/21Application Fee\$50.00


Due Date: 7/22/21 Total due for this invoice: \$51.00

Options to pay your Invoice:

1. Online with a credit card: http://posse.cabq.gov/posse/pub/lms/Default.aspx

2. In person: Plaza Del Sol, 600 2nd St. NW, Albuquerque, NM 87102

PLEASE RETURN THE BOTTOM PORTION OF THIS INVOICE NOTICE WITH PAYMENT

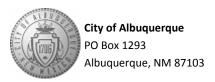

Date: 7/22/21 Amount Due: \$51.00

Reference NO: SI-2021-01129

Payment Code: 130

Customer NO: CU-120002707

CUMULUS DESIGN 2080 N. HIGHWAY TEXAS, TX 75050

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