



PLANT MATERIAL LIST


VEV	OLIANITITY!	ORNAMENTAL TREES DESCRIPTION	CIZE	
<u>KEY</u>	QUANTITY		SIZE	
DW	2	CHILOPSIS LINEARIS 'BUBBA' DESERT WILLOW	30 GAL., 8' HT., 3' SPREAD	
RB	4	CERCIS CANADENSIS 'OKLAHOMA'	30 GAL., 8' HT.,	
		REDBUD	3' SPREAD	
VAC	VITEX AGNUS-CASTUS 'SHOAL CREEK'		30 GAL., 8' HT.,	
		SHOAL CREEK VITEX	3' SPREAD	
14514	OLIANTITY	SHRUBS	6175	
<u>KEY</u>	QUANTITY	DESCRIPTION	SIZE	
DS	7	DASYLIRION TEXANUM	5 0 4 4 4 4 5 11 1 1 7	
		GREEN DESERT SPOON	5 GAL., MIN. 15" HT.	
BM	1 1	CARYOPTERIS X CLANDONENSIS 'DARK		
		KNIGHT' BLUE MIST	5 GAL., MIN. 15" HT.	
GC	25	COTONEASTER BUXIFOLIUS		
GC		GRAY COTONEASTER	5 GAL., MIN. 15" HT.	
NRS	7	ILEX X 'NELLIE R. STEVENS'	30 GAL., 5' HT.,	
INICO	'	NELLIE R. STEVENS HOLLY	3' SPREAD	
TC		LEUCOPHYLLUM LANGMANIAE		
TS	11	TEXAS SAGE 'LYNN'S LEGACY'	5 GAL., MIN. 15" HT.	
		HESPERALOE PARVIFOLIA		
RY	7	RED YUCCA	3 GAL., MIN. 10" HT.	
		SCUTELLARIA SUFFRUTESCENS		
SC	33	PINK SKULLCAP	5 GAL., MIN. 15" HT.	
		SALVIA X 'ULTRA VIOLET'	3 37 (2.) (11111 23 1111	
SG	14	ULTRA VIOLET SAGE	5 GAL., MIN. 15" HT.	
		CAESALPINIA GILLIESII	J GAL., WIIIV. 13 TIT.	
YBP	3	YELLOW BIRD OF PARADISE	10 GAL., MIN. 36" HT.	
		AGAVE OVATIFOLIA	10 GAL., IVIIIN. 30 HT.	
WT	2	WHALE'S TONGUE	10 CAL MINI 20" LIT	
			10 GAL., MIN. 36" HT.	
YF	12	YUCCA FILAMENTOSA 'COLOR GUARD'		
		COLOR GUARD YUCCA	5 GAL., MIN. 8" HT.	
		GROUND COVER		
<u>KEY</u>	QUANTITY	<u>DESCRIPTION</u>	SIZE	
SV	120	VERBENA RIGIDA	1 GAL., FULL PLANT	
		SANDPAPER VERBENA	30" O.C.	
PG	30	TEUCRIUM CHAMAEDRYS 'PROSTRATUM'	I GAL., FULL PLANT 36"	
		PROSTRATE GERMANDER	O.C.	
		ORNAMENTAL GRASSES		
<u>KEY</u>	QUANTITY	DESCRIPTION	<u>SIZE</u>	
ABM	8	MUHLENBERGIA CAPILLARIS 'REGAL MIST'		
ADIVI		AUTUMN BLUSH MUHLY	3 GAL., FULL PLANT	
FRG	10	CALAMAGROSTIS ARUNDINACEA 'KARL		
רתט	10	FOESTER' FEATHER REED GRASS	3 GAL., FULL PLANT	
NALIC	10	MISCANTHUS SINENSIS 'ADAGIO'		
MHG	18	ADAGIO GRASS	3 GAL., FULL PLANT	
	NASSELLA TENUISSIMA		1 GAL., FULL PLANT	
MFG	41	MEXICAN FEATHER GRASS	16" O.C.	

 $\frac{\text{LANDSCAPE PLAN}}{\text{SCALE: 1"} = 10'-0"}$

GRAVEL KEY

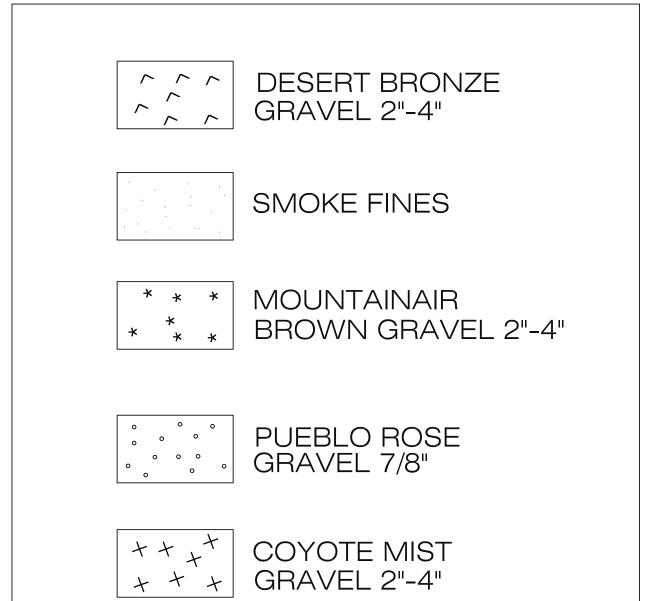

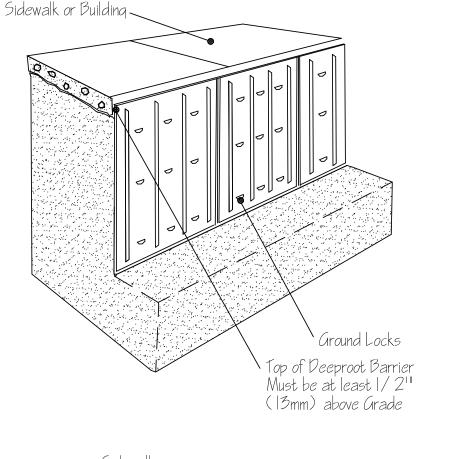

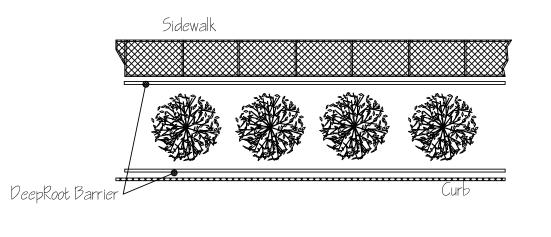

ROOT BARRIER DETAIL

SCALE: NTS

SHEET NOTES:

LANDSCAPE CONTRACTOR TO PROVIDE A COST FOR TREE PRUNING FOR EXISTING TREES TO REMAIN AS AN ALTERNATE TO THE BID.

REMOVE ALL EXISTING PLANTS AROUND MONUMENT SIGN

THE DRAWINGS AND SPECIFICATIONS ARE COMPLIMENTARY. ANYTHING CALLED FOR ON ONE AND NOT THE OTHER IS AS BINDING AS IF SHOWN AND CALLED FOR ON BOTH. THE PLANT SCHEDULE IS AN AID TO BIDDERS ONLY.

J. CAMILLE LA FOY

LANDSCAPE ARCHITECTURE CONSULTING

101C NORTH GREENVILLE AVENUE, #242
ALLEN, TEXAS 75002
214-502-4036

INDIAN SCHOOL RD NE & LOUISIANA RD
6670 INDIAN SCHOOL ROAD NE
ALBUQUERQUE, NEW MEXICO 87110

1445 ROSS AVENUE SUITE 5700 DALLAS, TEXAS 7520 214.997.6029

07/12/2021

REVISIONS

DATE ISSUED: SEPTEMBER 09, 2020

JOB #: 2020030

SHEET NAME:

LANDSCAPE PLAN

 Δ NIDOO2

CITY OF ALBUQUERQUE

Planning Department Brennon Williams, Director



July 15, 2021

Paul Cragun, P.E. Cumulus Design 2080 N. Highway 360, Suite 240 Grand Prairie, TX 75050

RE: Chase Bank – Indian School Rd. 6670 Indian School Rd. NE Revised Grading and Drainage Plans Engineer's Stamp Date: 06/30/21 Hydrology File: J18D001C

Dear Mr. Cragun:

PO Box 1293 Based upon the information provided in your submittal received 06/29/2021, the Revised Grading and Drainage Plans are approved for Building Permit and action by the DRB on Site

Grading and Drainage Plans are approved for Building Permit and action by the DRB on Site

Plan for Building Permit.

Albuquerque Please attach a copy of this approved plan in the construction sets for Building Permit processing

along with a copy of this letter. Prior to approval in support of Permanent Release of Occupancy

by Hydrology, Engineer Certification per the DPM checklist will be required.

NM 87103

As a reminder, if the project total area of disturbance (including the staging area and any work

within the adjacent Right-of-Way) is 1 acre or more, then an Erosion and Sediment Control (ESC) Plan and Owner's certified Notice of Intent (NOI) is required to be submitted to the Stormwater Quality Engineer (Doug Hughes, PE, jhughes@cabq.gov, 924-3420) 14 days prior to

any earth disturbance.

The Payment in Lieu payment of \$2,028.80 must be paid prior to Permanent Release of Occupancy approval. Please use the attached City of Albuquerque Treasury Deposit form and when ready please email this form to Shannon Cordero (sdcordero@cabq.gov). She will then produce and email back with a receipt and instructions on how to pay online. Once paid, please email me proof of payment. This will insure that Hydrology with be able to process Permanent

Release of Occupancy approval when officially submitted.

www.cabq.gov

CITY OF ALBUQUERQUE

Planning Department Brennon Williams, Director



Mayor Timothy M. Keller

If you have any questions, please contact me at 924-3995 or rbrissette@cabq.gov.

Sincerely, Renée C. Brissette Renée C. Brissette, P.E. CFM Senior Engineer, Hydrology


Planning Department

PO Box 1293

Albuquerque

NM 87103

www.cabq.gov

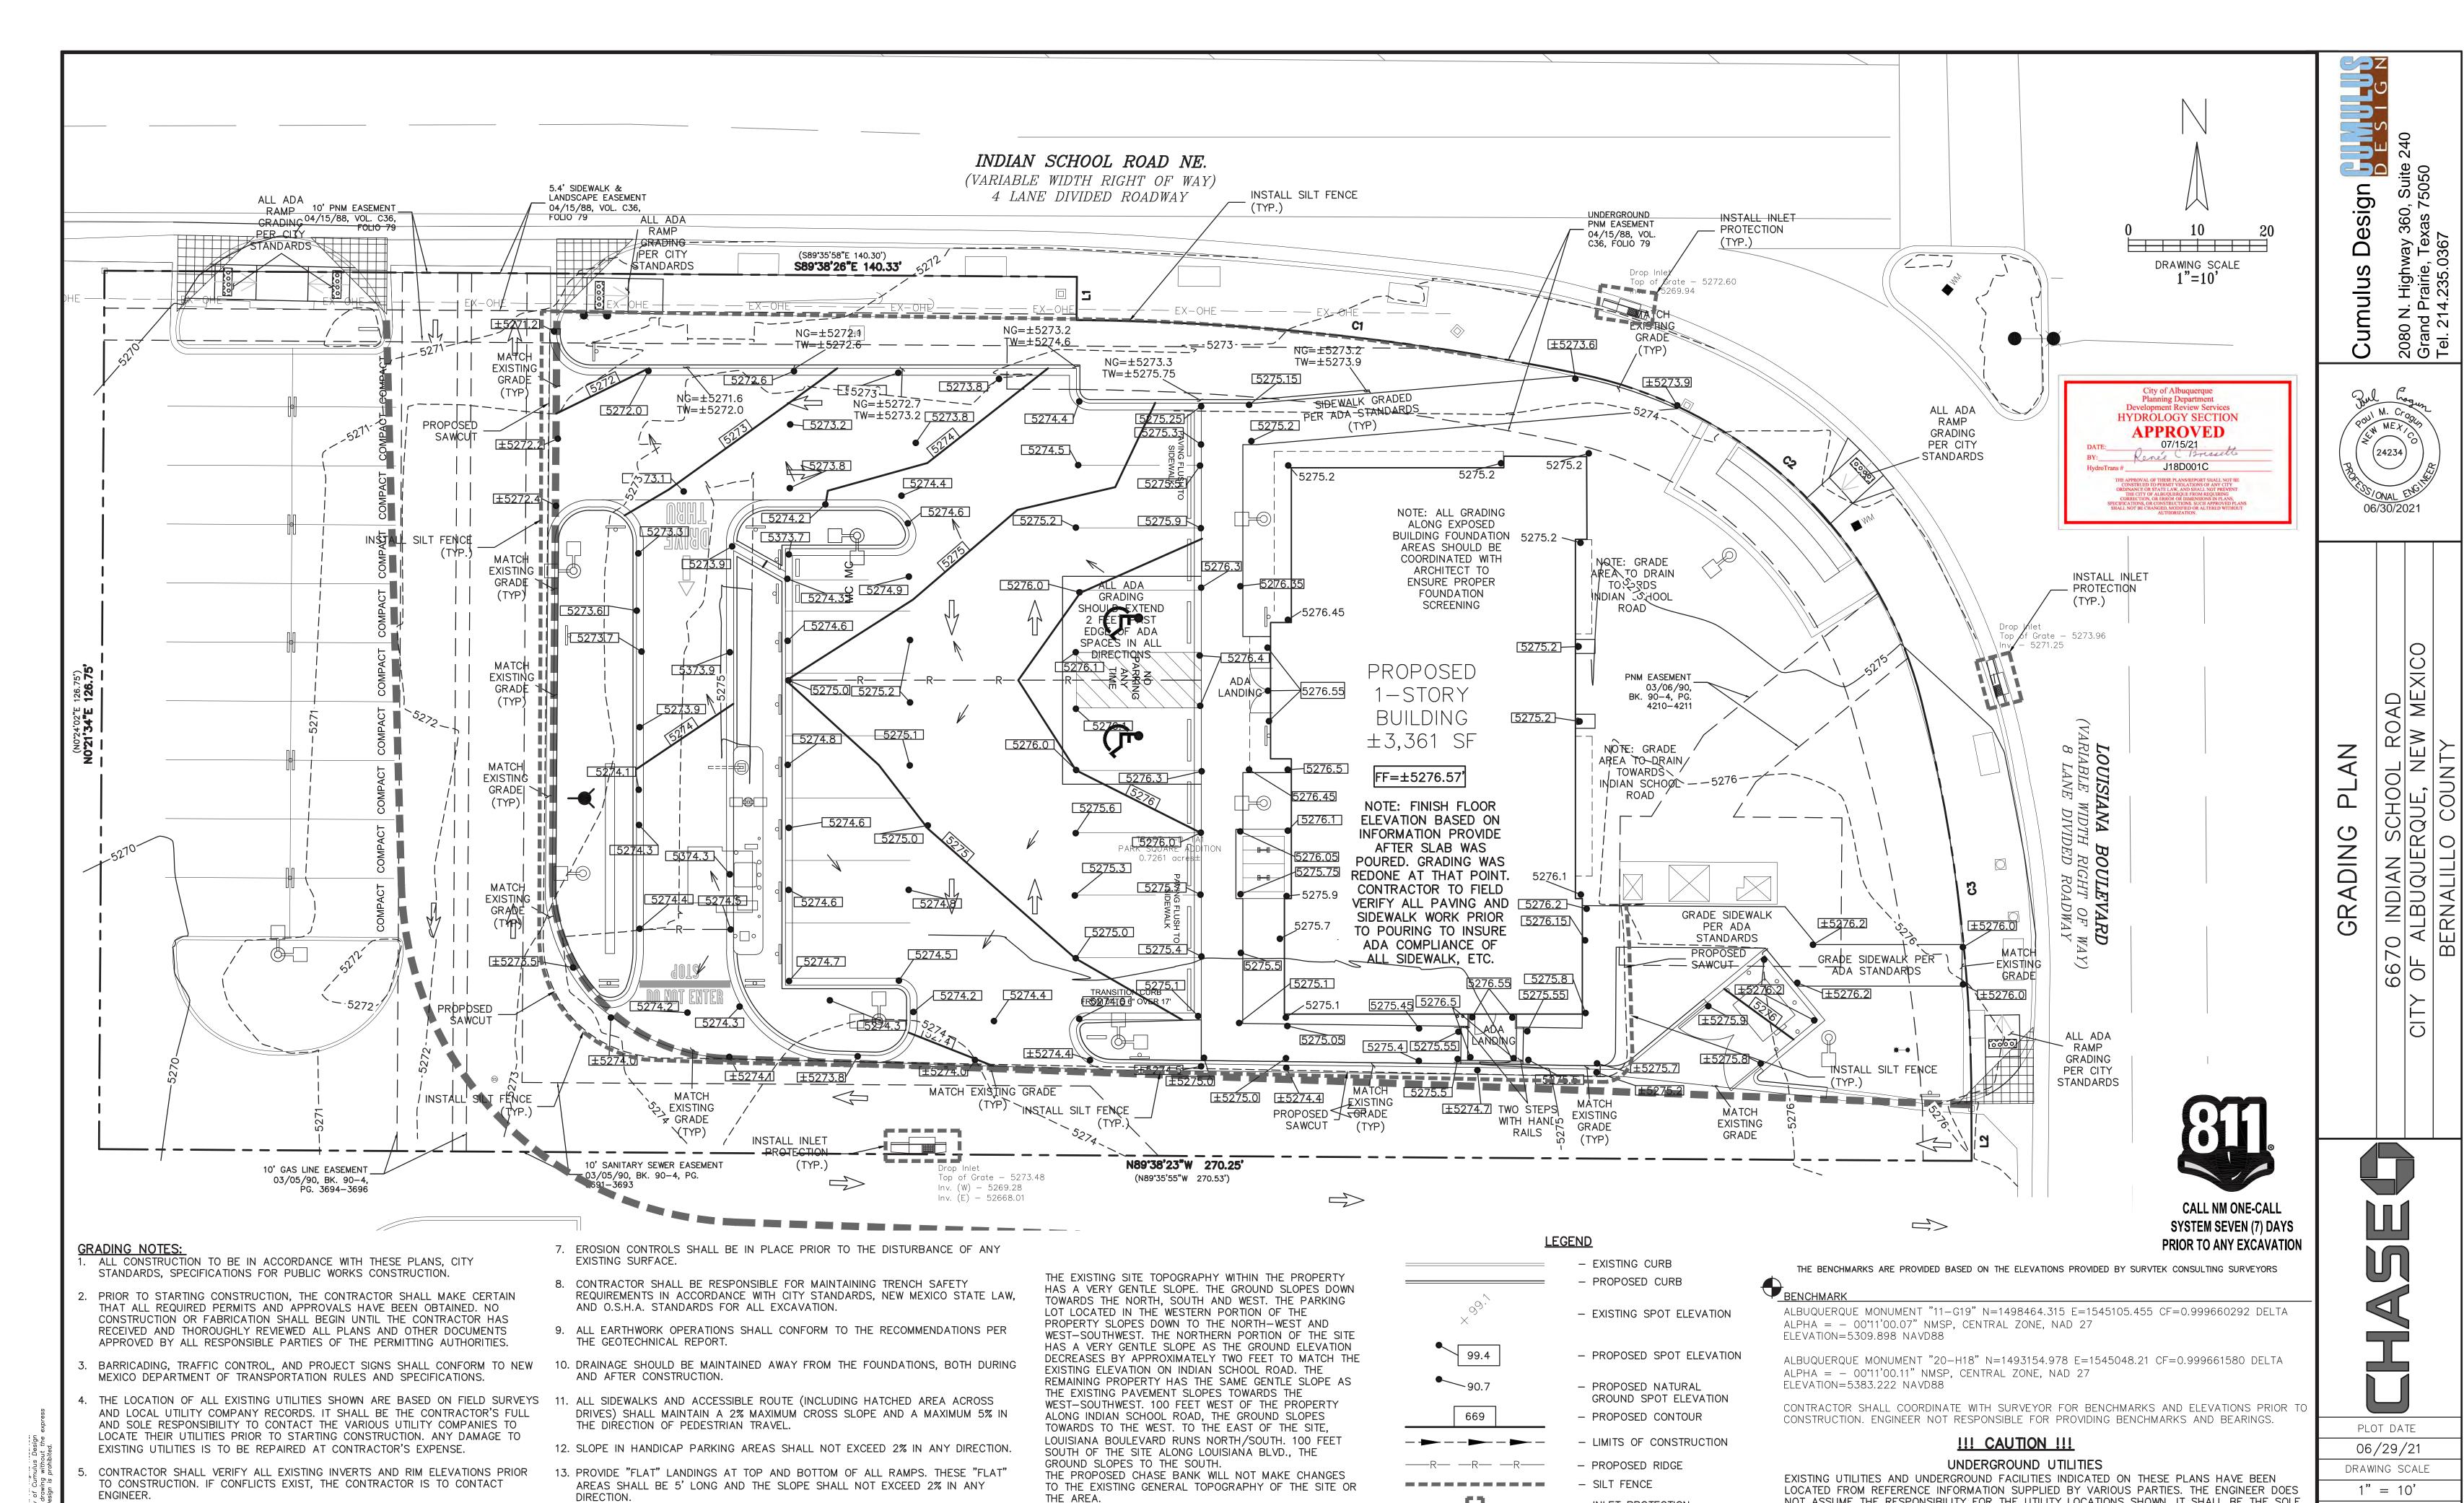

NOT ASSUME THE RESPONSIBILITY FOR THE UTILITY LOCATIONS SHOWN. IT SHALL BE THE SOLE

LOCATION OF ALL UTILITIES AND UNDERGROUND FACILITIES PRIOR TO CONSTRUCTION, TO TAKE

PRECAUTIONS IN ORDER TO PROTECT ALL FACILITIES ENCOUNTERED AND NOTIFY THE ENGINEER

OF ALL CONFLICTS OF THE WORK WITH EXISTING FACILITIES. THE CONTRACTOR SHALL PROTECT

CONTRACTOR TO UTILITIES SHALL BE REPAIRED OR REPLACED BY THE CONTRACTOR AT THEIR

AND MAINTAIN ALL UTILITIES FROM DAMAGE DURING CONSTRUCTION. ANY DAMAGE BY THE

CALL: NEW MEXICO ONE CALL @ NM 811 AT LEAST 7 DAYS PRIOR TO CONSTRUCTION.

RESPONSIBILITY OF THE CONTRACTOR(S) TO VERIFY THE HORIZONTALLY AND VERTICALLY

PROJECT NUMBER

CDC20013

SHEET NUMBER

INLET PROTECTION

PROPOSED SAWCUT

NATURAL GROUND

- TOP OF WALL/CURB

DIRECTIONAL FLOW ARROW

EXPENSE OF THE CONTRACTOR.

BENCHMARKS HAVE BEEN PROVIDED AS A REFERENCE. IT IS THE CONTRACTOR'S

RESPONSIBILITY TO LOCATE, VERIFY, AND/OR ESTABLISH A BENCHMARKS PRIOR

SURVEY STAKES AND MARKERS FOR THE DURATION OF THE PROJECT. IF ANY

TO BE REPLACED, SUCH REPLACEMENT SHALL BE BY THE SURVEYOR AT THE

CONSTRUCTION STAKES OR MARKERS ARE LOST OR DISTURBED AND ARE NEEDED

TO CONSTRUCTION. IT IS THE CONTRACTOR'S RESPONSIBILITY TO PRESERVE

\\SERVER-PC\SERVER\2020 CDC PROJECTS\CDC20013 — INDIAN SCHOOL ROAD, ALBUQUERQUE\PLANS\GRADING PLAN CDC20013.DWG


14. IT IS THE RESPONSIBILITY OF THE CONTRACTOR TO PROVIDE POSITIVE DRAINAGE

INDICATED. SURFACE WATER SHALL NOT BE RELEASED ONTO ADJACENT PRIVATE

15. SITE GRADING SHALL BE PERFORMED IN A MANNER TO DIRECT WATER AS

AWAY FROM BUILDING AND PARKING AT ALL TIMES.

PROPERTY.

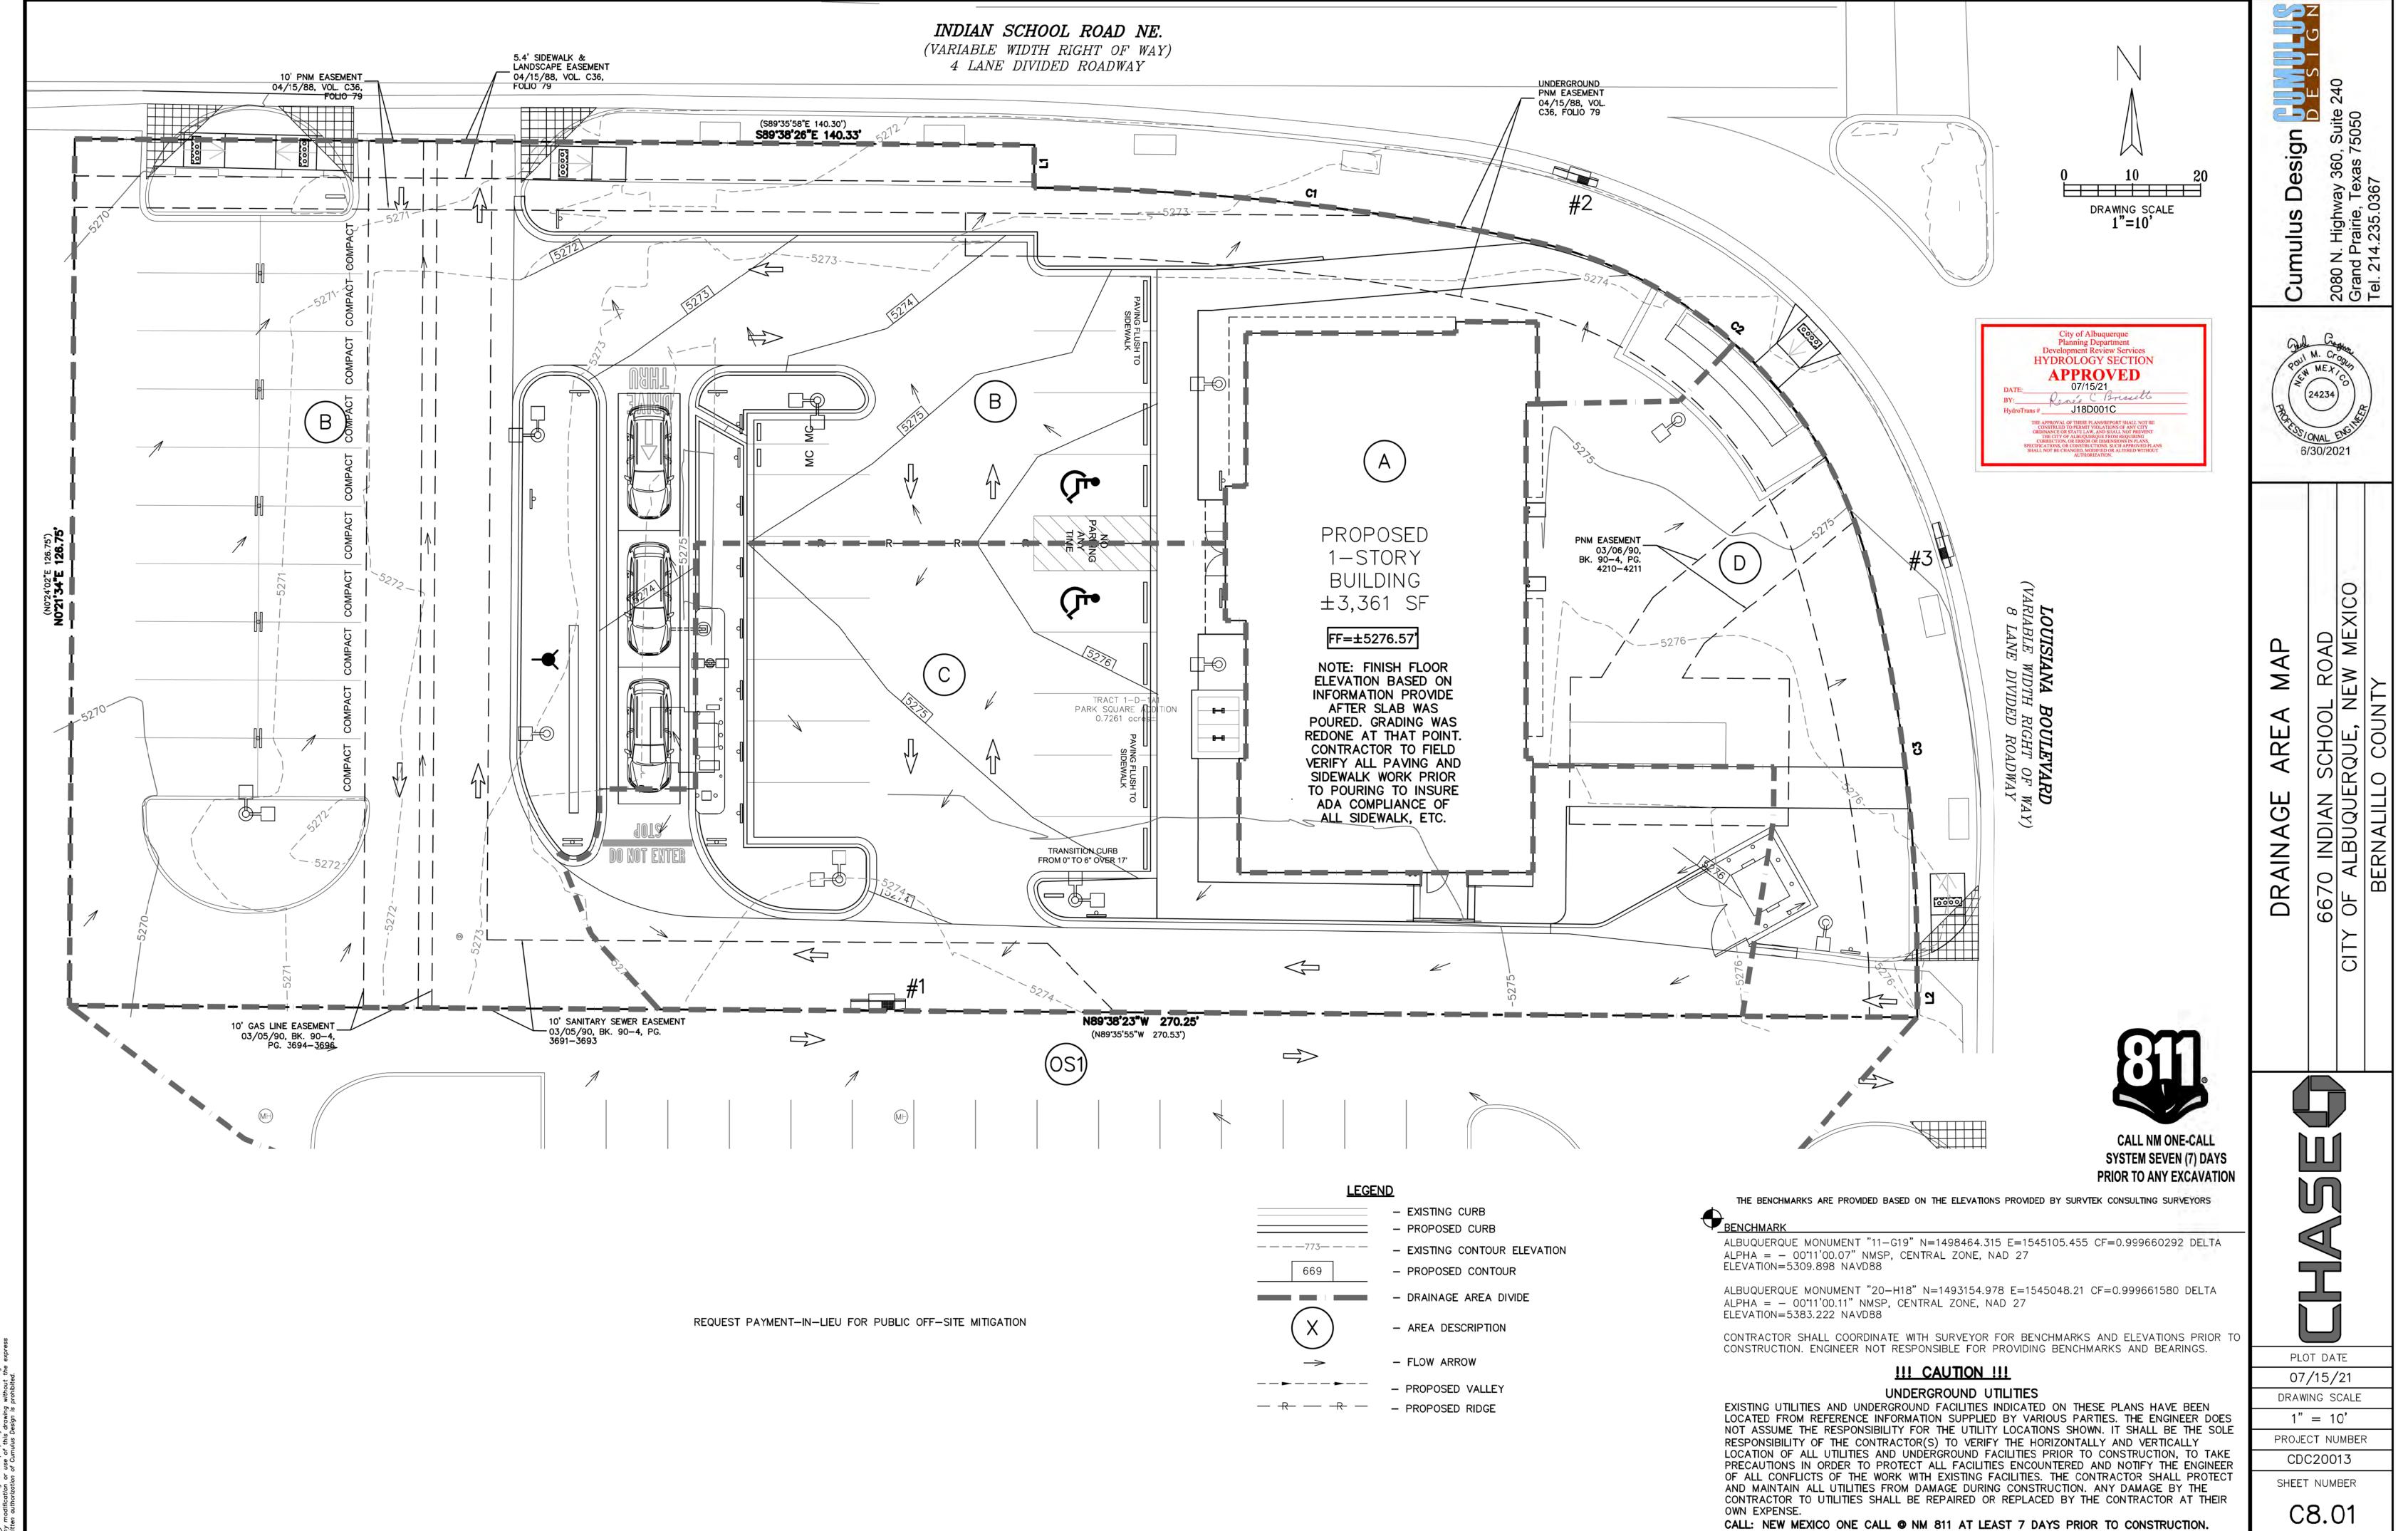

(())This grawing is the property of Cumulus Design

\\SERVER-PC\SERVER\2020 CDC PROJECTS\CDC20013 - INDIAN SCHOOL ROAD, ALBUQUERQUE\PLANS\PROPOSED DRAINAGE AREA MAP CDC20013.DWG



MAP

ARE,

AINAG

DR

70 INDIAN ALBUQUE SERNALILL

PLOT DATE 06/29/21

DRAWING SCALE

PROJECT NUMBER CDC20013

SHEET NUMBER

	PROPOSED DRAINAGE DATA CHART												
DRAINAGE ID	AREA (SQ. FT.)	AREA (AC.)	C2	C10	C100	Tc (min)	2 (in/hr)	10 (in/hr)	100 (in/hr)	Q2 (cfs)	Q10 (cfs)	Q100 (cfs)	COMMENT
Α	3361.09	0.08	0.89	0.54	0.91	5.0	1.94	3.12	4.96	0.13	0.13	0.35	ROOF DRAINS TO AREA "C" THEN TO INLET #1
В	16735.87	0.38	0.73	0.50	0.83	5.0	1.94	3.12	4.96	0.54	0.60	1.58	DRAINS TO INDIAN SCHOOL RD THEN TO INLET #2
С	8006.12	0.18	0.79	0.51	0.86	5.0	1.94	3.12	4.96	0.28	0.29	0.78	DRAINS TO INLET #1
D	3524.34	0.08	0.20	0.37	0.56	5.0	1.94	3.12	4.96	0.03	0.09	0.22	DRAINS TO LOUISIANA BLVD THEN TO INLET #3
OS1	7709.17	0.18	0.16	0.36	0.54	5.0	1.94	3.12	4.96	0.05	0.20	0.47	DRAINS TO AREA "C"
TOTAL	31627.41	0.73								1.05	1.31	3.41	


CALCULATIONS ARE BASED ON THE RATIONAL METHOD FROM CITY OF ALBUQUERQUE DEVELOPMENT PROCESS MANUAL CHAPTER 6 - DRAINAGE, FLOOD CONTROL AND EROSION CONTROL. DATED 06/08/2020


	COMPOSITE ANALYSIS FOR RUNOFF COEFFICIENT											
DRAINAGE ID	PERCENT IMPERVIOUS	PERCENT PERVIOUS	C IMPERVIOUS (2 year)	C PERVIOUS (2 year)	C IMPERVIOUS (10 year)	C PERVIOUS (10 year)	C IMPERVIOUS (100 year)	C PERVIOUS (100 year)		COMPOSITE C (10 year)	COMPOSITE C (100 year)	
А	100.0	0.0	0.89	0.08	0.54	0.34	0.91	.50	0.89	0.54	0.91	
В	79.8	20.2	0.89	0.08	0.54	0.34	0.91	.50	0.73	0.50	0.83	
С	87.2	12.8	0.89	0.08	0.54	0.34	0.91	.50	0.79	0.51	0.86	
D	14.3	85.7	0.89	0.08	0.54	0.34	0.91	.50	0.20	0.37	0.56	
OS1	9.9	90.1	0.89	0.08	0.54	0.34	0.91	.50	0.16	0.36	0.54	

80TH PERCENTILE STORMWATER QUALITY VOLUME TABLE								
DRAINAGE ID	NEW IMPERVIOUS AREA (SQ. FT.)	REDEVELOPMENT SITE FACTOR	80TH PERCENTILE STORM VOLUME (CFS)					
A	3362.0	0.26	72.8					
В	4980.0	0.26	107.9					
С	3362.0	0.26	72.8					
D	0.0	0.26	0.0					
	253.6							

REQUEST PAYMENT-IN-LIEU FOR PUBLIC OFF-SITE MITIGATION

WEIGHTED ANALYSIS FOR 6-HOUR EXCESS PRECIPITATION, 'E'									
DRAINAGE ID	LAND TREATMENT B	LAND TREATMENT D	AREA LAND TREATMENT B	AREA LAND TREATMENT D	WEIGHTED E (100 year) (IN)	VOLUME (100 year) (ACRE-FT)			
Α	0.86	2.58	0.000	0.080	2.580	0.045			
В	0.86	2.58	0.077	0.303	2.233	0.007			
С	0.86	2.58	0.016	0.023	1.882	0.044			
D	0.86	2.58	0.011	0.0686	2.334	0.016			
				TOTAL \	0.112				

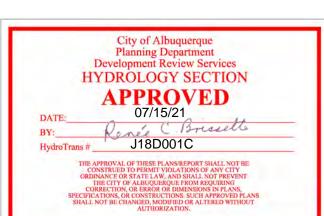

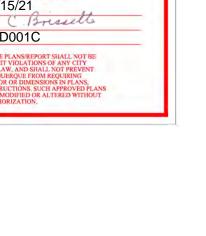

CALL NM ONE-CALL SYSTEM SEVEN (7) DAYS PRIOR TO ANY EXCAVATION

THE BENCHMARKS ARE PROVIDED BASED ON THE ELEVATIONS PROVIDED BY SURVIEK CONSULTING SURVEYORS

ALBUQUERQUE MONUMENT "11-G19" N=1498464.315 E=1545105.455 CF=0.999660292 DELTA $ALPHA = -00^{\circ}11'00.07"$ NMSP, CENTRAL ZONE, NAD 27 ELEVATION=5309.898 NAVD88

ALBUQUERQUE MONUMENT "20-H18" N=1493154.978 E=1545048.21 CF=0.999661580 DELTA ALPHA = - 00°11'00.11" NMSP, CENTRAL ZONE, NAD 27 ELEVATION=5383.222 NAVD88

CONTRACTOR SHALL COORDINATE WITH SURVEYOR FOR BENCHMARKS AND ELEVATIONS PRIOR TO CONSTRUCTION. ENGINEER NOT RESPONSIBLE FOR PROVIDING BENCHMARKS AND BEARINGS.

!!! CAUTION !!!

UNDERGROUND UTILITIES EXISTING UTILITIES AND UNDERGROUND FACILITIES INDICATED ON THESE PLANS HAVE BEEN LOCATED FROM REFERENCE INFORMATION SUPPLIED BY VARIOUS PARTIES. THE ENGINEER DOES NOT ASSUME THE RESPONSIBILITY FOR THE UTILITY LOCATIONS SHOWN. IT SHALL BE THE SOLE RESPONSIBILITY OF THE CONTRACTOR(S) TO VERIFY THE HORIZONTALLY AND VERTICALLY LOCATION OF ALL UTILITIES AND UNDERGROUND FACILITIES PRIOR TO CONSTRUCTION, TO TAKE PRECAUTIONS IN ORDER TO PROTECT ALL FACILITIES ENCOUNTERED AND NOTIFY THE ENGINEER OF ALL CONFLICTS OF THE WORK WITH EXISTING FACILITIES. THE CONTRACTOR SHALL PROTECT AND MAINTAIN ALL UTILITIES FROM DAMAGE DURING CONSTRUCTION. ANY DAMAGE BY THE CONTRACTOR TO UTILITIES SHALL BE REPAIRED OR REPLACED BY THE CONTRACTOR AT THEIR

CALL: NEW MEXICO ONE CALL @ NM 811 AT LEAST 7 DAYS PRIOR TO CONSTRUCTION.

\\SERVER-PC\\SERVER\2020 CDC PROJECTS\CDC20013 - INDIAN SCHOOL ROAD, ALBUQUERQUE\PLANS\PROPOSED DRAINAGE AREA MAP CDC20013.DWG

DRAINAGE CRITERIA

ZONE 3 Q=C*I*A

12=1.94 in/hr $I_{10}=3.12 \text{ in/hr}$ 1100=4.96 in/hr tc=12 min.

CITY OF ALBUQUERQUE

Planning Department Brennon Williams, Director



Mayor Timothy M. Keller

July 14, 2021

Carlos Iglesias Cumulus Design 2080 N. Highway 360, Ste. 240 Grand Pairie, TX 75050

e: Chase Bank – Indian School Road 6670 Indian School Road NE Traffic Circulation Layout Architect's Stamp 07-12-2021 (J18-D001C)

Dear Mr. Iglesias,

The TCL submittal received 07-13-2021 is approved for Building Permit with. A copy of the stamped and signed plan will be needed for each of the building permit plans. Please keep the original to be used for certification of the site for final C.O. for Transportation.

PO Box 1293

When the site construction is completed and an inspection for Certificate of Occupancy (C.O.) is requested, use the original City stamped approved TCL for certification. Redline any minor changes and adjustments that were made in the field. A NM registered architect or engineer must stamp, sign, and date the certification TCL along with indicating that the development was built in "substantial compliance" with the TCL. Submit this certification, the TCL, and a completed <u>Drainage and Transportation Information Sheet</u> to front counter personnel for log in and evaluation by Transportation.

Albuquerque

NM 87103

Once verification of certification is completed and approved, notification will be made to Building Safety to issue Final C.O. To confirm that a final C.O. has been issued, call Building Safety at 924-3690.

www.cabq.gov

Nilo Salgado-Fernandez, P.E.


Senior Traffic Engineer, Planning Dept.

Development Review Services

C: CO Clerk, File

Sincerely.

Page 1 of 1

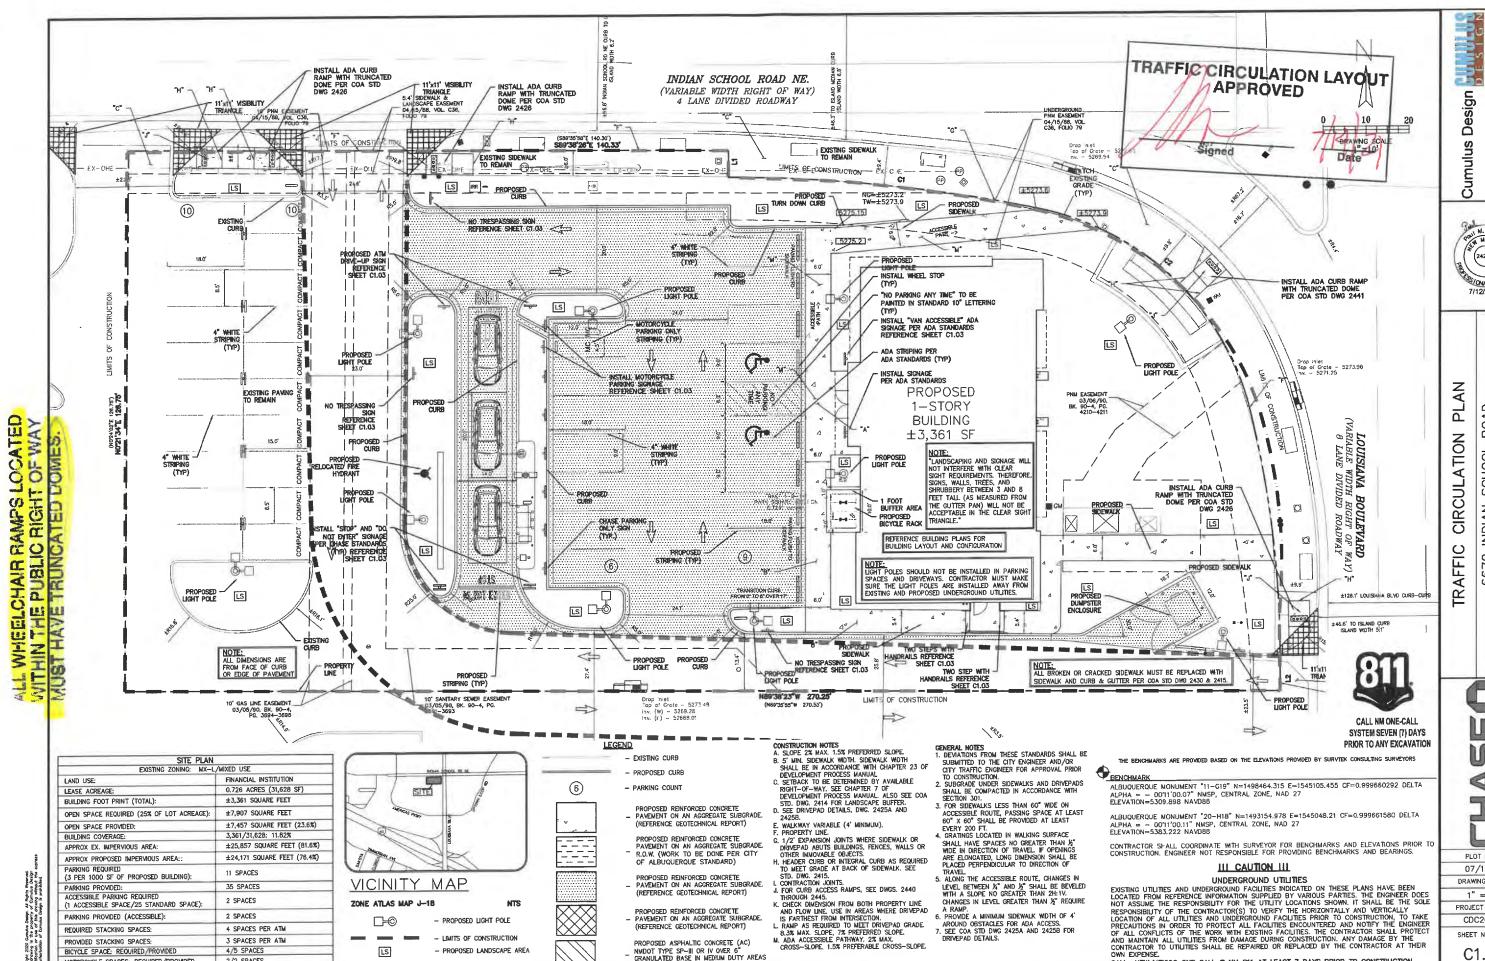

NMDOT TYPE SP-III OR IV OVER 6"
GRANULATED BASE IN MEDIUM DUTY AREAS

(REFERENCE GEOTECHNICAL REPORT)

BICYCLE SPACE: REQUIRED PROVIDED

MOTORCYCLE SPACES: REQUIRED/PROVIDED

4/5 SPACES

2/2 SPACES

LS

PLOT DATE

1

07/12/21 DRAWING SCALE

1" = 10' PROJECT NUMBER

Suite 7

MEXICO

70 INDIAN SCHOOL ROA F ALBUQUERQUE, NEW M BERNALILLO COUNTY

일양

CITY

Design

Cumulus

CDC20013 SHEET NUMBER

C1.02

CALL: NEW MEXICO ONE CALL O NM B11 AT LEAST 7 DAYS PRIOR TO CONSTRUCTION.



TYPICAL ADA SIGNAGE FOR VAN ACCESSIBLE SPACES



TYPICAL ADA SIGNAGE



MOTORCYCLE PARKING SIGN N.T.S. NO TRESPASSIN


NO TRESPASSING SIGN N.T.S.




R5 - 1(SIZE: 30"x30") DO NOT ENTER SIGN



R1 - 1(SIZE: 30"X30") STOP SIGN

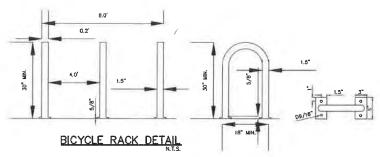


1. INSTALLATION TO BE COMPLETED IN ACCORDANCE WITH MANUFACTURER'S SPECIFICATIONS.

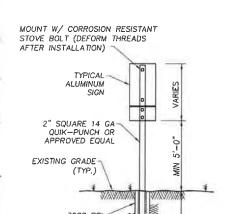


CONCRETE

2 1" 12 GA-


MOUNTING SLEEVE ADA DUAL SIGNAGE MOUNTING DETAIL

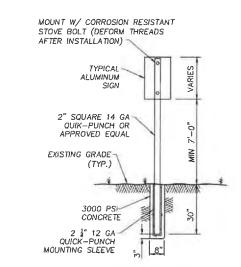


SINGLE ADA AND MOTORCYCLE SIGNAGE MOUNTING DETAIL

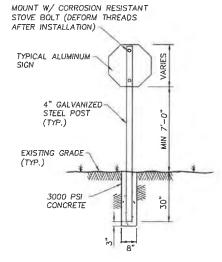

"STOP" AND "DO NOT ENTER" SIGNAGE MOUNTING DETAIL

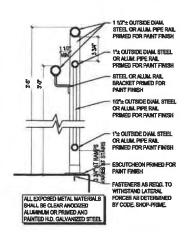

ADA RAMP HAND RAIL DETAIL

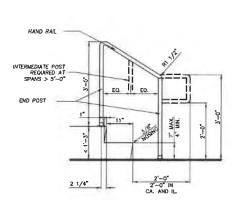


HANDRAIL DETAIL




TEXT DETAILS



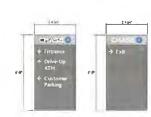

ENTRANCE SIGN #1 DETAIL

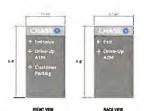

ENTRANCE SIGN #2 DETAIL



DRIVE-THRU ATM SIGNAGE DETAIL

CALL NM ONE-CALL SYSTEM SEVEN (7) DAYS PRIOR TO ANY EXCAVATION

THE BENCHWARKS ARE PROVIDED BASED ON THE ELEVATIONS PROVIDED BY SURVIEK CONSULTING SURVEYORS

BENCHMARK ALBUQUERQUE MONUMENT "11-G19" N=1498464.315 E=1545105.455 CF=0.999660292 DELTA ALPHA = - 00'11'00.07" NMSP, CENTRAL ZONE, NAD 27 ELEVATION=5309.898 NAVD88

ALBUQUERQUE MONUMENT "20-H18" N=1493154.978 E=1545048.21 CF=0.999661580 DELTA ALPHA = - 00"1" O0.11" NMSP. CENTRAL ZONE, NAD 27 ELEVATION=5383.222 NAVD88

CONTRACTOR SHALL COORDINATE WITH SURVEYOR FOR BENCHMARKS AND ELEVATIONS PRIOR TO CONSTRUCTION, ENGINEER NOT RESPONSIBLE FOR PROVIDING BENCHMARKS AND BEARINGS.

HI CAUTION HI

UNDERGROUND UTILITIES

EXISTING UTILITIES AND UNDERGROUND FACILITIES INDICATED ON THESE PLANS HAVE BEEN LOCATED FROM REFERENCE INFORMATION SUPPLIED BY VARIOUS PARTIES. THE ENGINEER DOES NOT ASSUME THE RESPONSIBILITY FOR THE UTILITY LOCATIONS SHOWN. IT SHALL BE THE SOLE RESPONSIBILITY OF THE CONTRACTOR(S) TO VERIFY THE HORIZONTALLY AND VERTICALLY LOCATION OF ALL UTILITIES AND UNDERGROUND FACILITIES PRIOR TO CONSTRUCTION. TO TAKE PRECAUTIONS IN ORDER TO PROTECT ALL FACILITIES ENCOUNTERED AND NOTIFY THE ENGINEER OF ALL CONFLICTS OF THE WORK WITH EXISTING FACILITIES. THE CONTRACTOR SHALL PROTECT AND MAINTAIN ALL UTILITIES FROM DAMAGE DURING CONSTRUCTION. ANY DAMAGE BY THE CONTRACTOR TO UTILITIES SHALL BE REPAIRED OR REPLACED BY THE CONTRACTOR AT THEIR OWN EXPENSE.

CALL: NEW MEXICO ONE CALL @ NM 811 AT LEAST 7 DAYS PRIOR TO CONSTRUCTION.

Design Figure 16

Cumulus

PLAN

CIRCULATION

TRAFFIC

2080 N. Highway 360, Suite 2 Grand Prairie, Texas 75050 Tel. 214.235.0367

70 INDIAN SCHOOL ROAD

ALBUQUERQUE, NEW MEXICO
BERNALILLO COUNTY

667 0F

CIT

60

PLOT DATE 07/12/21 DRAWING SCALE

PROJECT NUMBER


CDC20013 SHEET NUMBER


C1.03







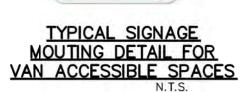

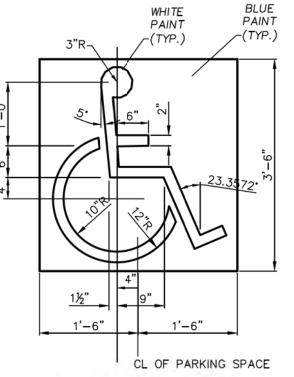

TYPICAL SIGNAGE MOUTING DETAIL FOR ACCESSIBLE SPACES

ACCESSIBLE PARKING SYMBOL DETAIL

ADA PARKING STALLS AND AISLE DETAIL

26.0' @ 2.0% MAX



(SIZE: 30"X30")


STOP SIGN




(SIZE: 30"x30")

DO NOT ENTER SIGN



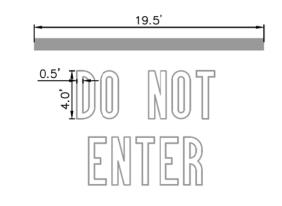

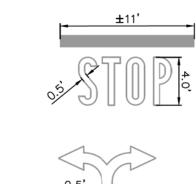

NO TRESPASSING

TEXT DETAILS




SIGN N.T.S.


PRECAST CONCRETE WHEEL STOP EDGE OF PAVEMENT, FACE OF CURB OR FACE OF WALL #4 STEEL REBAR, 18" LONG. SET 12" INTO PAVEMENT TWO REQUIRED (1.0' @ PAVEMENT EDGE 2.5' @ CURB 3.0' @ FENCE OR WALL

WHEEL STOP DETAIL


MOUNT W/ CORROSION RESISTANT STOVE BOLT (DEFORM THREADS AFTER INSTALLATION) TYPICAL-ALUMINUM 2" SQUARE 14 GA-QUIK-PUNCH OR APPROVED EQUAL EXISTING GRADE-(TYP.) CONCRETE 2 ¼" 12 GA QUICK-PUNCH MOUNTING SLEEVE


ADA DUAL SIGNAGE MOUNTING DETAIL

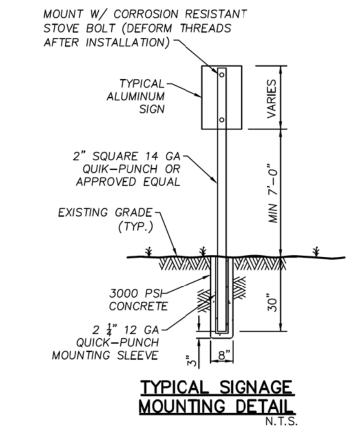


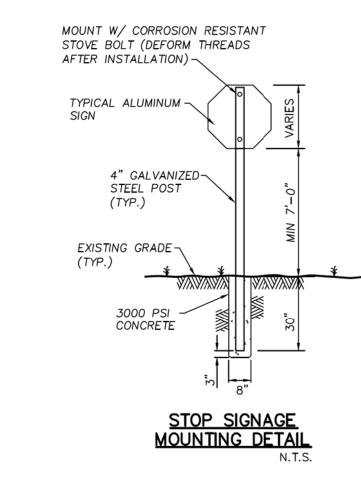

NOTE DETAILS ON THIS SHEET ARE PRIVATE. ALL WORK WITHIN PUBLIC EASEMENTS OR RIGHT-OF-WAY SHALL BE PER CITY (OR STATE, IF APPLICABLE) STANDARD DETAILS. THE CONTRACTOR IS REQUIRED TO HAVE ON—SITE, AT ALL TIMES, A COPY OF THE CITY'S CONSTRUCTION DETAILS.

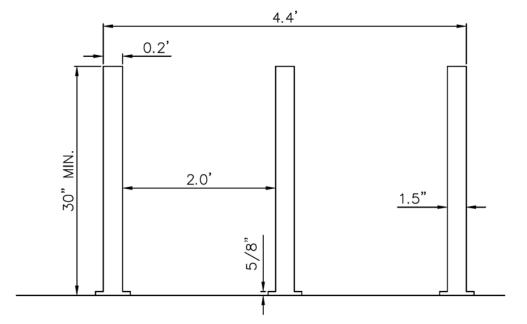

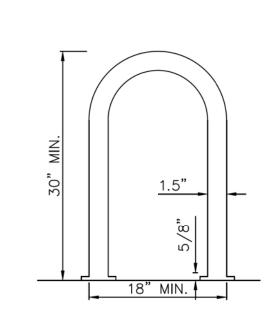


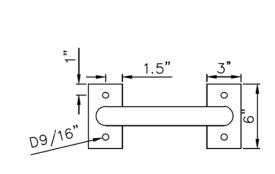


1. INSTALLATION TO BE COMPLETED IN ACCORDANCE WITH MANUFACTURER'S SPECIFICATIONS.


BICYCLE RACK DETAIL N.T.S.

MISCELLANEOUS DETAILS

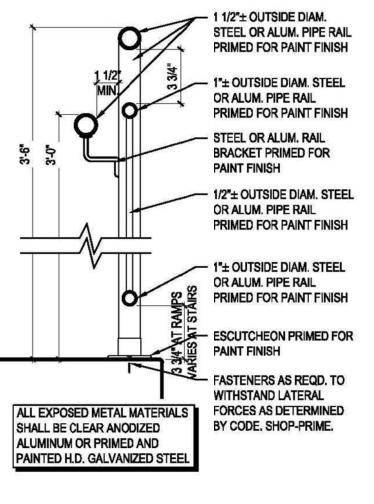





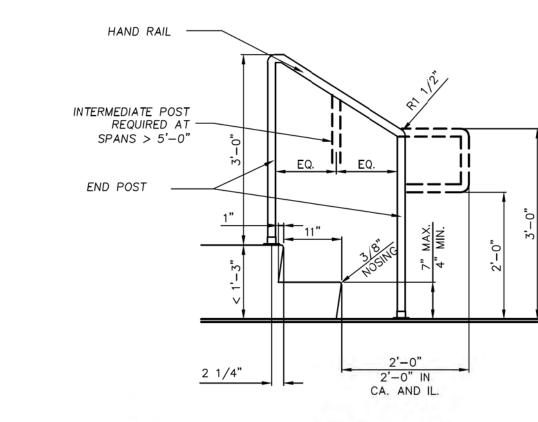


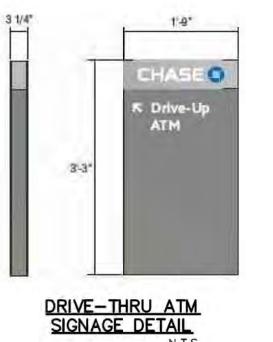



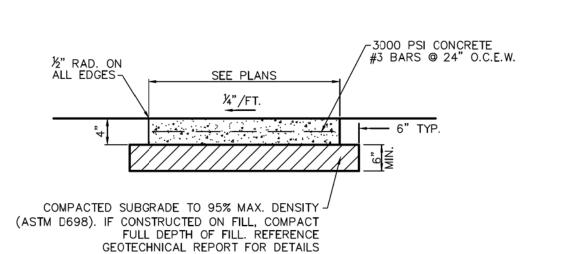

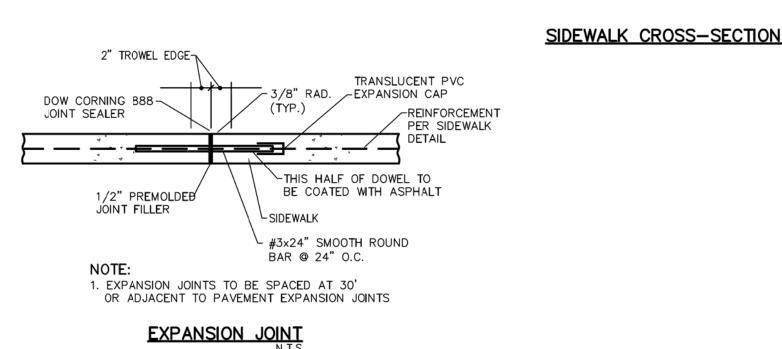

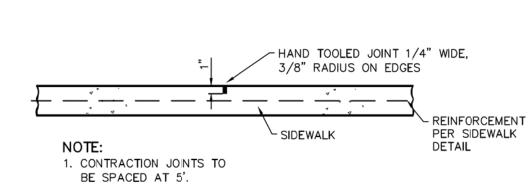

CONTRACTION JOINT

SIDEWALK DETAILS

PLOT DATE 07/16/21

esign

(24234)

(PRIVA)


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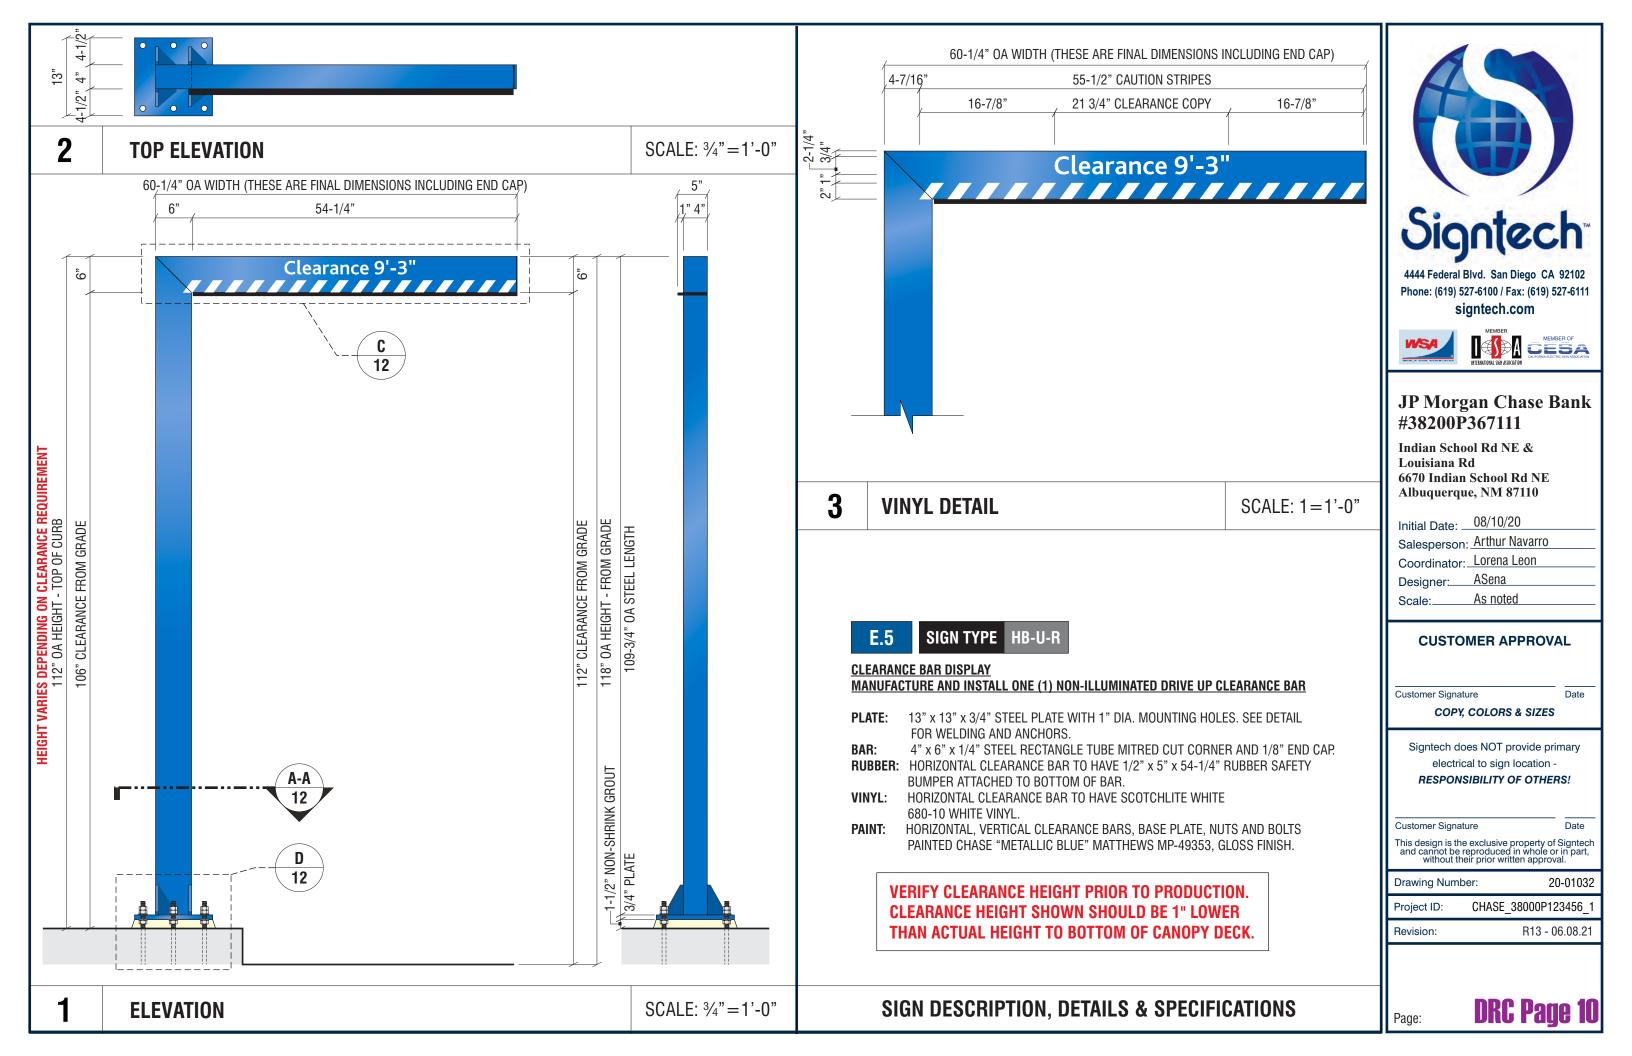
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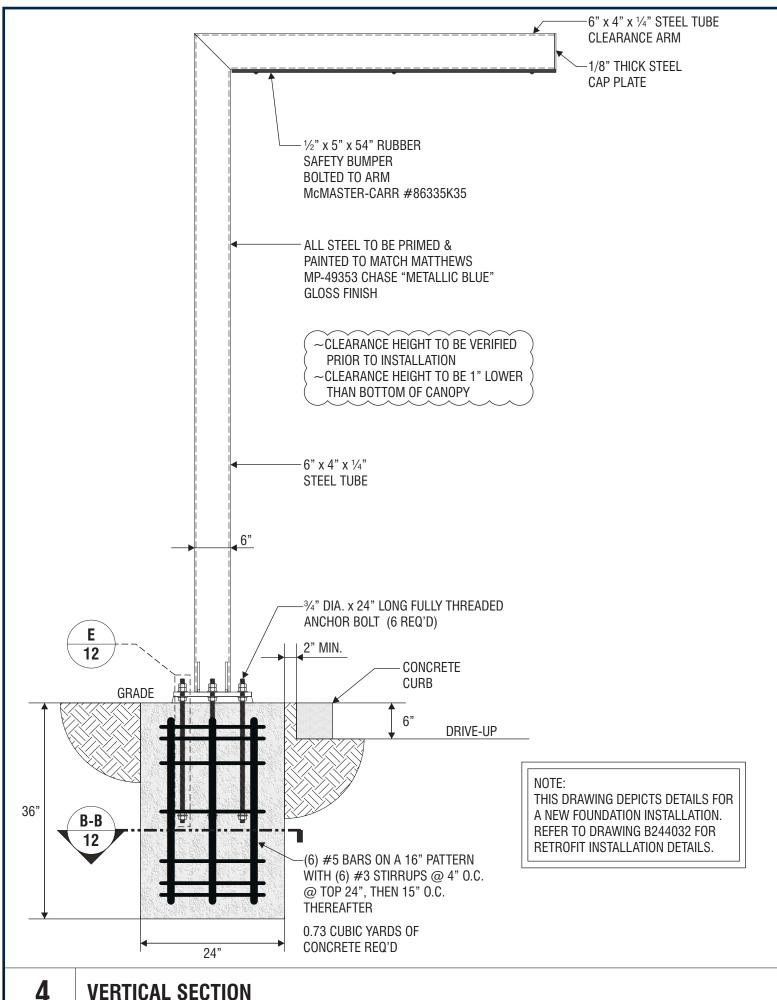
DRAWING SCALE

PROJECT NUMBER CDC20013

SHEET NUMBER C13.02





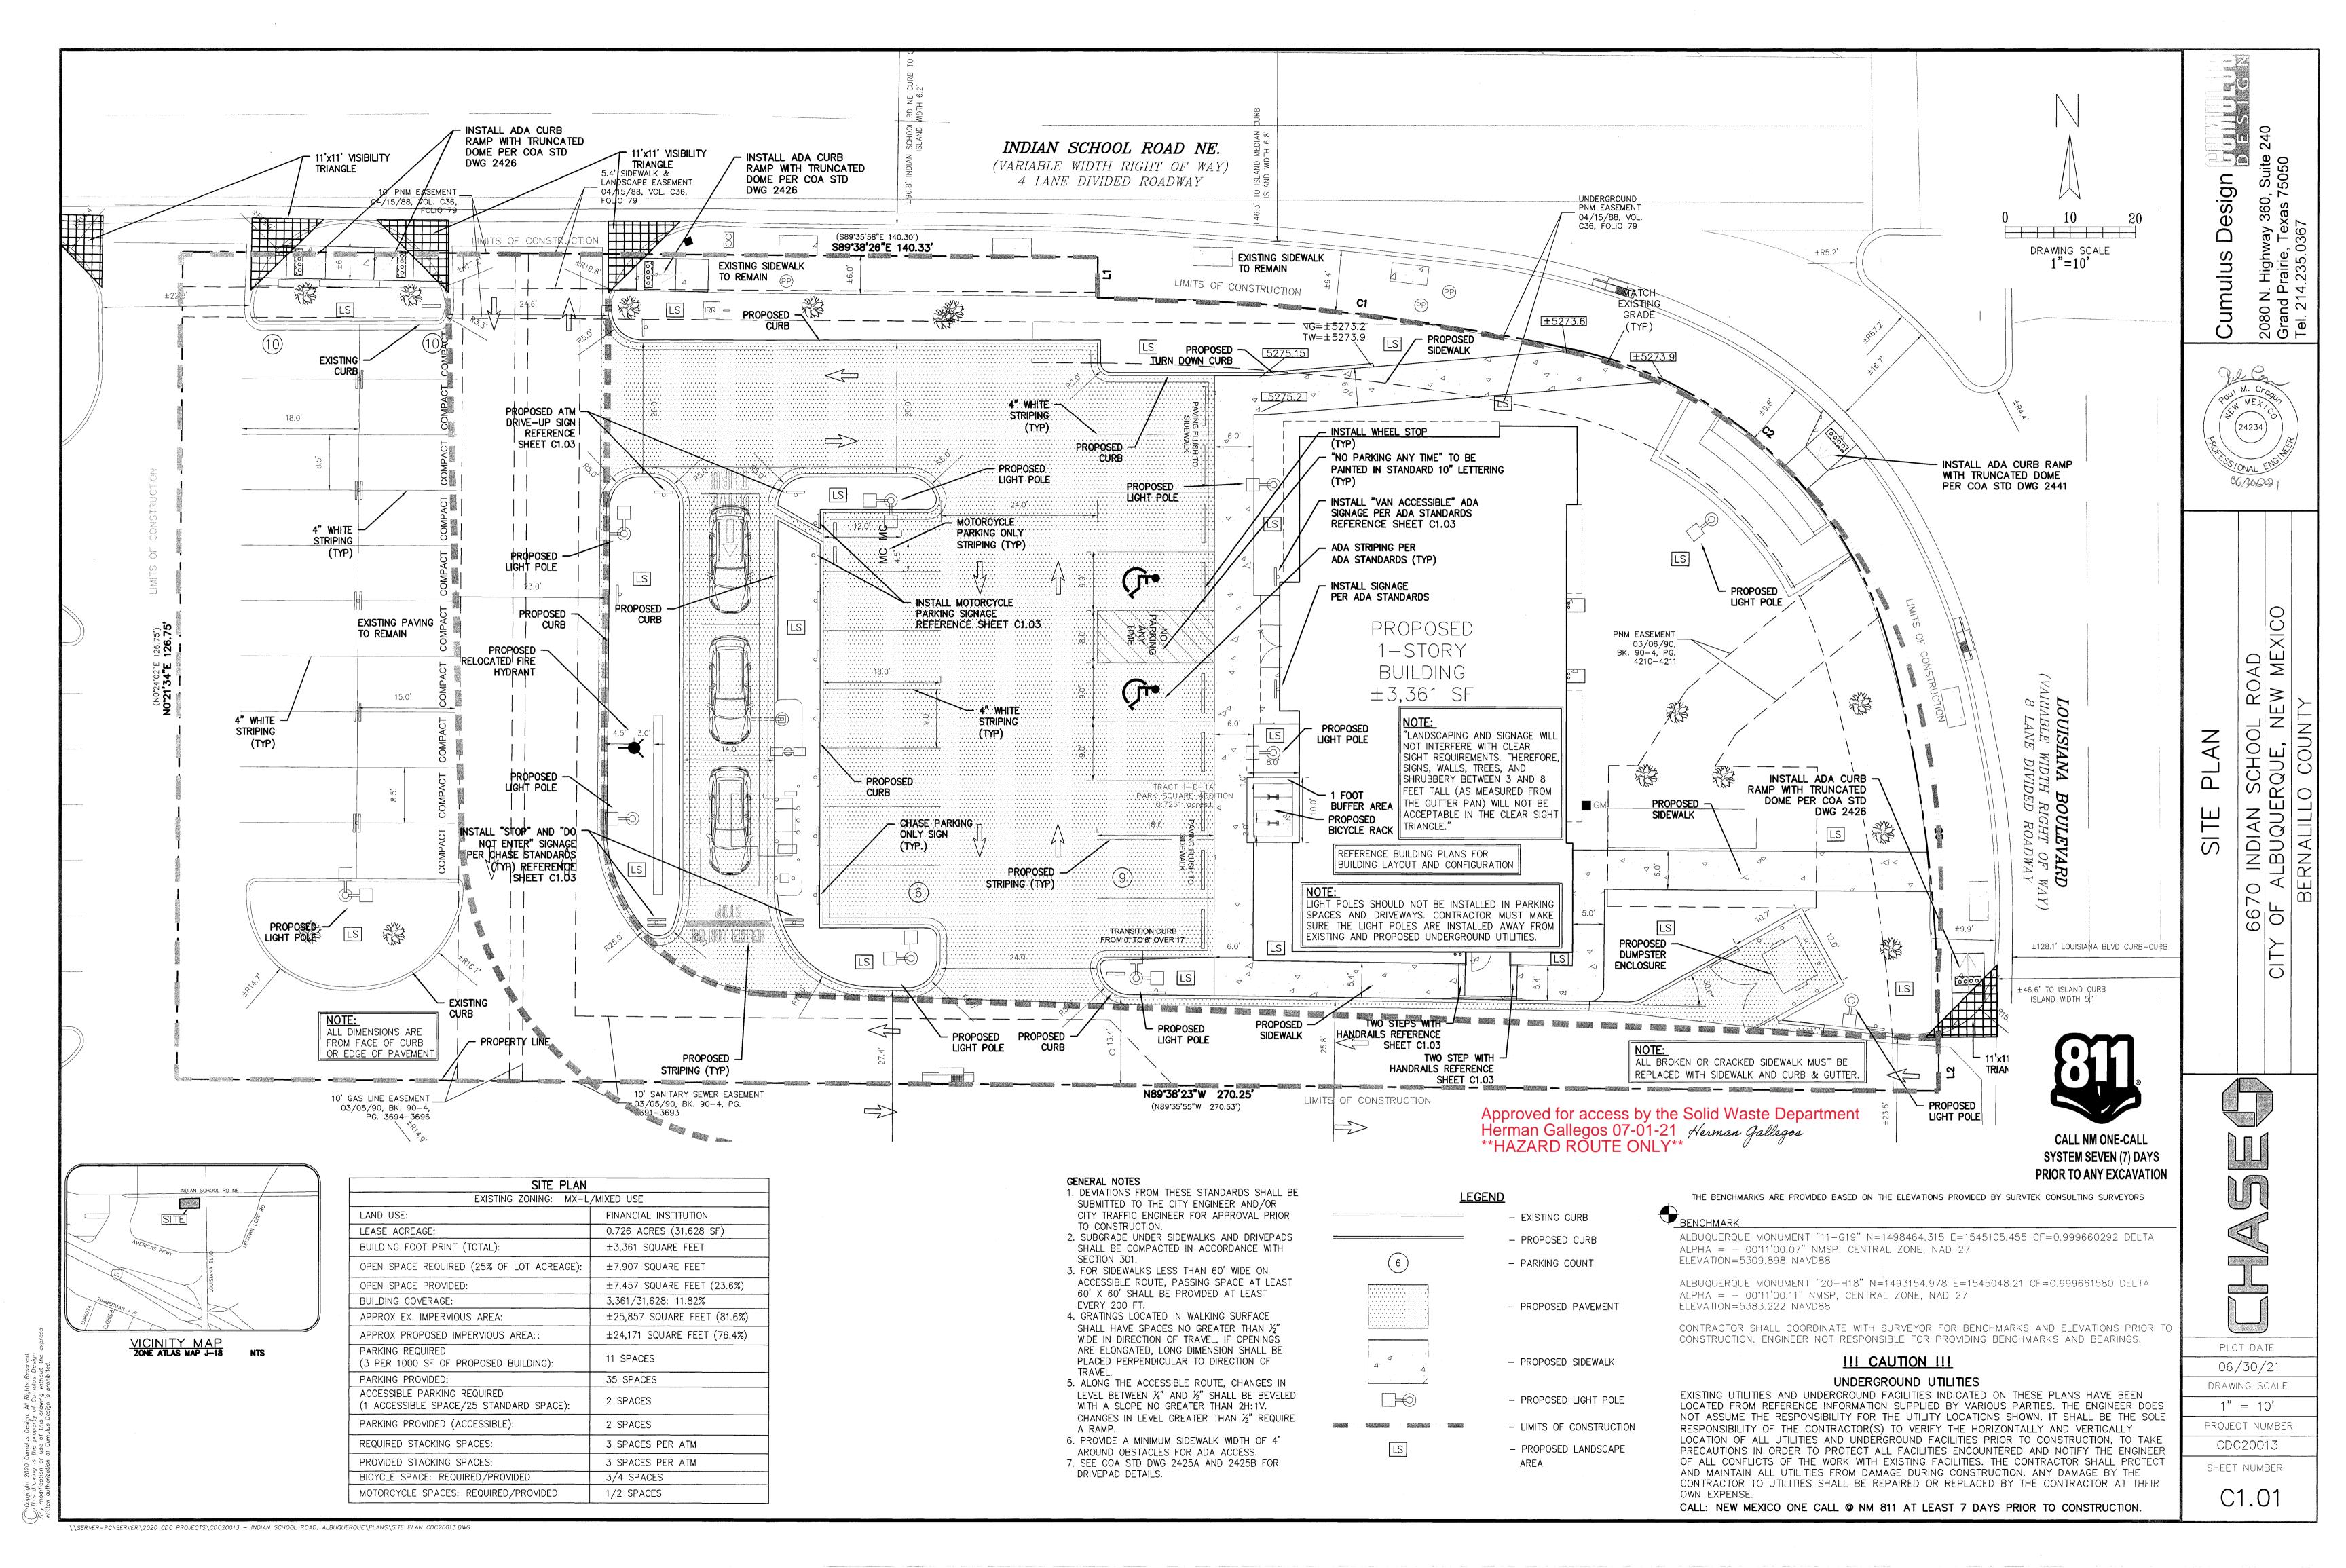

NOTES:

- 1. Design is based on guidelines provided by the International Building Code 2006
- 2. Foundation is based on a safe lateral soil bearing pressure minimum of 300 psf per foot of depth. Soil report was not furnished. Allowable bearing pressure should be verified prior to placement of concrete. Do not place foundation in fill.
- 3. Concrete shall be mixed to attain a minimum compressive strength of 3000 psi in 28 days.
- 4. Support member shall be free from defects and shall meet ASTM A500 grade B with a minimum yield strength of 46000 psi for tube. Plate and angle shall meet ASTM A36.
- 5. Structural bolts shall be zinc coated A307 unless otherwise noted.
- 6. Anchor bolts shall be cut from A36 round stock. Exposed surfaces shall be galvanized or coated to prevent corrosion.
- 7. All voids between column base plate and foundation surface shall be completely filled with high strength, non-shrink grout.
- 8. Welds shall be made with E70xx electrodes by persons qualified in accordance with AWS standards within the past two years.
- 9. Steel reinforcing bars shall conform to ASTM 615 grade 60 with deformations in accordance with ASTM A-305. Welding of reinforcing bars is prohibited.
- 10. This design is prototypical and should not be used for site specific applications unless deemed suitable by a competent Professional Engineer.



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JP Morgan Chase Bank #38200P367111

Indian School Rd NE & Louisiana Rd 6670 Indian School Rd NE Albuquerque, NM 87110

Initial Date: __08/10/20

Salesperson: Arthur Navarro

Coordinator: Lorena Leon **ASena** Designer:__

Scale:. As noted

CUSTOMER APPROVAL

Customer Signature

COPY, COLORS & SIZES

Signtech does NOT provide primary electrical to sign location -

RESPONSIBILITY OF OTHERS!

Customer Signature

Date

20-01032

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Drawing Number:


CHASE 38000P123456 1

Project ID:

Revision:


R13 - 06.08.21

DRC Page 11

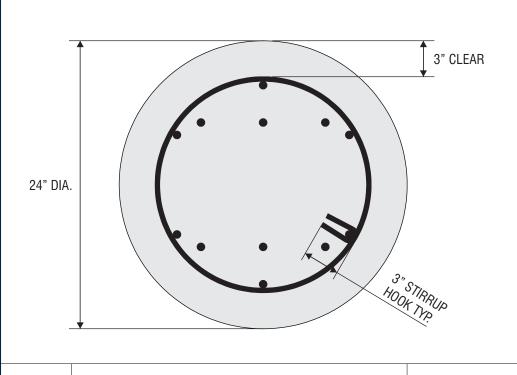

B-B **SECTION THROUGH CAISSON**


SCALE: 1 ½"=1'-0"

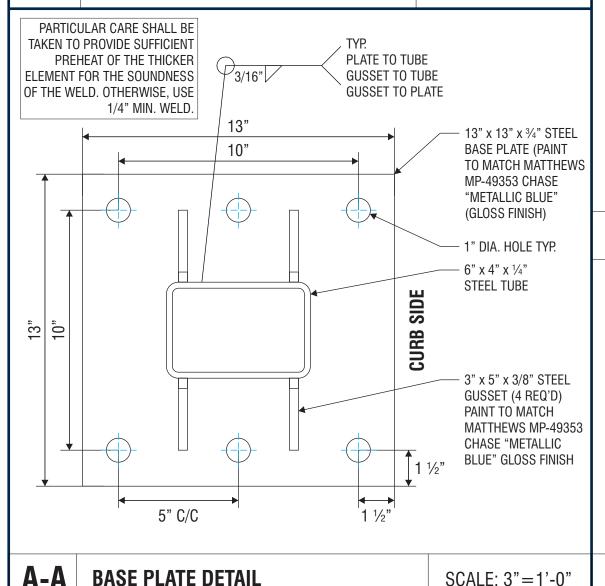


SCALE: 3"=1'-0"

E

PLATE TUBE TO 3/16" TO TUBE 3/16" TUBE 45° MITER 6" x 4" x 1/4" STEEL **JOINT** CLEARANCE ARM OPEN-END NUT-SERT FOR 1/8" THICK STEEL 1/4" DIA. BOLT (3 REQ'D) CAP PLATE · 1/2" x 5" x 54" RUBBER 1/4" DIA. x 1" ROUND SAFETY BUMPER HEAD S.S. BOLT WITH **BOLTED TO ARM** WASHER (3 REQ'D) McMASTER-CARR #86335K35 23" 23" 6" x 4" x 1/4" STEEL TUBE **CLEARANCE ARM DETAIL** SCALE: 1 ½"=1'-0"

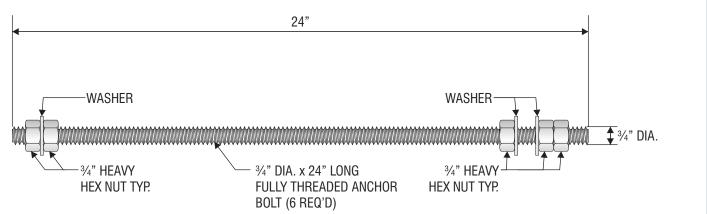

ANCHOR BOLT DETAIL SCALE: 3"=1'-0"

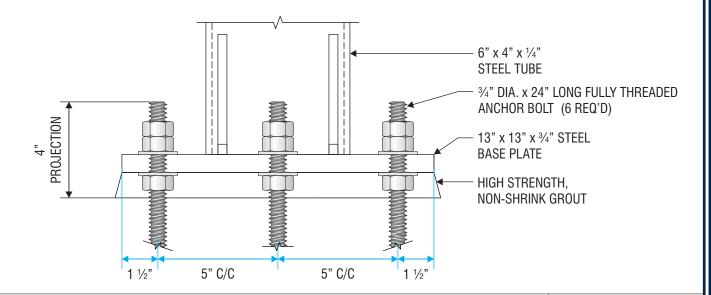







JP Morgan Chase Bank #38200P367111

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CUSTOMER APPROVAL

Customer Signature

COPY, COLORS & SIZES

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RESPONSIBILITY OF OTHERS!

Customer Signature

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Drawing Number:

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Date

20-01032

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R13 - 06.08.21

DRC Page 12

ANCHOR BOLT PROJECTION DETAIL SCALE: 3"=1'-0" **GRAPHICS DEPICTED ARE FOR ILLUSTRATIVE PURPOSES ONLY USE ONLY APPROVED** ARTWORK FOR PRODUCTION.

White Diffuser White Translucent Intense Blue Translucent Blue 3M 3632-20 3M 3635-70 3M 3632-127 Aristech 6046


Chase Metallic Blue Paint to match MP-49353 Metallic Gloss Finish

Chase Dark Nickel Paint to match MP-18248

ALL EXPOSED FASTENER HEADS SHALL BE PAINTED TO MATCH THE EXTERIOR CABINET FINISH

Matte Finish

ALL EXPOSED PAINTED SURFACES
SHALL BE COATED WITH MATTHEWS
#282-208SP VOC GLOSS CLEAR, WITH
MINIMUM 2 MILS DRY FILM THICKNESS
(DFT) PER MATTHEWS APPLICATION
SPECIFICATIONS SPECIFICATIONS.

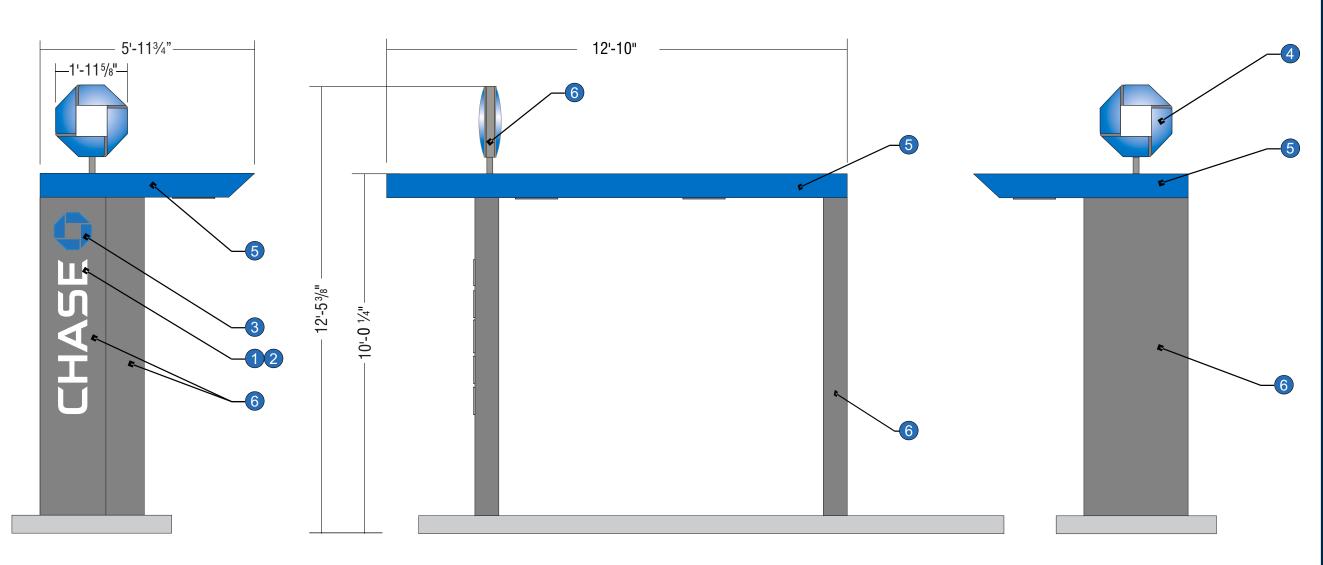

APPROACH ELEVATION

SCALE: 3/8" = 1'-0"

FRONT VIEW CAN-ATM

DEPARTURE ELEVATION SCALE: 3/8" = 1'-0"

SCALE: 3/8" = 1'-0"

SIGN TYPE CAN-ATM-SIG-OCT

MANUFACTURE AND INSTALL ONE (1) ILLUMINATED SIGNATURE ATM CANOPY w/ OCTAGON

2/24/20 MOVED CANOPY ELECT. TRR IK







JP Morgan Chase Bank #38200P367111

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Initial Date: 08/10/20 Salesperson: Arthur Navarro Coordinator: Lorena Leon **ASena** Designer:_ As noted

CUSTOMER APPROVAL

Customer Signature

COPY, COLORS & SIZES

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Customer Signature

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Drawing Number:

20-01032

Date

CHASE 38000P123456 1 Project ID:

Revision:


R13 - 06.08.21

DRC Page 13



LEDS: (41) 1100°K WHITE SLOAN PRISM #101269-1WSJI-MB (43) BLUE SLOAN PRISM #701269-BLGJI-MB DOWNLIGHTS: (2) E-CONOLIGHT 5000K WHITE LED LIGHT FIXTURE *C-CP-B-SQ-4L-50K-WH @ 0.30A LED POWER SUPPLY: (3) SLOAN #701507-60C1 @ 0.70A TOTAL LOAD: 2.70 AMPS @ 120VAC CIRCUITS: (1) 20 AMP REQ'D.


ALL EXPOSED PAINTED SURFACES SHALL BE COATED WITH MATTHEWS *282-2086P VOC GLOSS CLEAR, WITH MINIMUM 2 MILS DRY FILM THICKNESS (DFT) PER MATTHEWS APPLICATION SPECIFICATIONS.

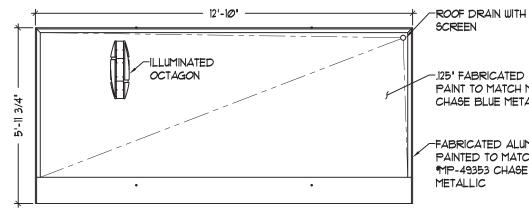

-.125" FABRICATED ALUM. ROOF PANEL PAINT TO MATCH MATTHEWS *MP-49353 CHASE BLUE METALLIC GLOSS FINISH

-FABRICATED ALUM. CANOPY PAINTED TO MATCH MATTEWS MP-49353 CHASE BLUE METALLIC

TOP VIEW

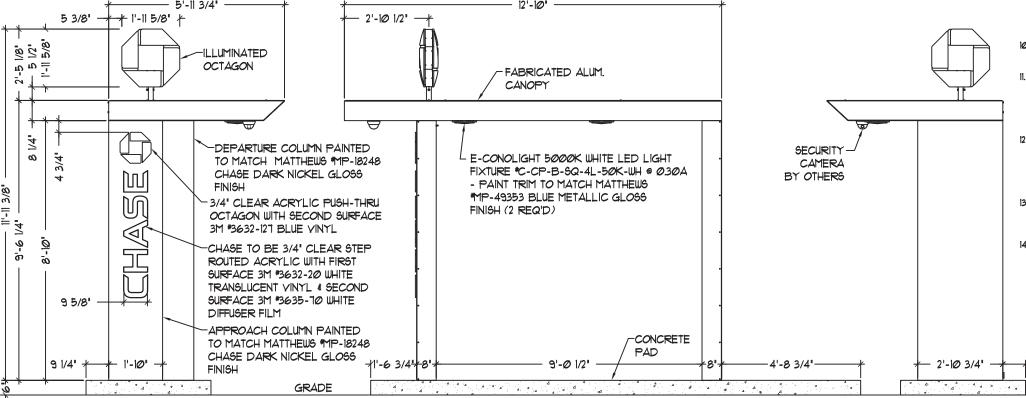

ELEVATION

General Notes:

- Design is based on a 115 mph, 3 second gust wind design per
- IBC 2015, Category II, Exposure C. 40ps Ground Snow Load. Spread foundation is based on a presumptive safe vertical soil bearing pressure minimum of 7
- A soil report was not provided. Foundation analysis assumes Soil Classification 4. Allowable bearing pressure should be verified prior to placement of concrete. In the event that the stated requirements are not met and conditions appear deleterious, cease and secure excavation and immediately contact the project manager.
 Foundation shall not be placed at the top of, or on the side
- of a slope exceeding 3:1, or adjacent to a fill slope unless re-evaluated by a competent Professional Engineer. Do not place foundation in fill."
- Concrete shall be mixed to attain a minimum 28 day compressive strength of 3000 psi.
- Steel reinforcing bars shall conform to ASTM A615, Grade 60 with deformations in accordance with ASTM A305. Welding of reinforcing bars is prohibited.
- All voids between column base plate and foundation surface shall be completely filled with high-strength, non-shrink grout.

 Anchor bolts shall meet ASTM F1554 Grade 36. Exposed
- surfaces shall be galvanized or coated to prevent corrosion.
- 9. All support members shall be free from defects. Steel tube shall meet ASTM A500 Grade B with a minimum yield strength of 46000 psi. Steel angle, channel and plate shall meet ASTM A36. Extruded aluminum shapes shall be 6061-76 alloy. Aluminum sheet shall be 3003-HI4 alloy. Aluminum plate shall be 5052-H34 alloy.

 Welds shall be made with E70xx low hydrogen electrodes for
- steel 4 with 5356 filler for aluminum by persons qualified in accordance with AWS standards within the past two years.
- All structural bolts shall conform to ASTM A325, and be zinc coated unless noted otherwise. When used with structural bolts, heavy hex nuts shall conform to ASTM A563, and washers shall conform to ASTM F436. Pretension all high strength bolts using the Turn-of-Nut method unless noted
- JP Morgan Chase will not be responsible for the safety on this job site before, during or after installation of this structure. It is the responsibility of the contractors and installers to ensure that the installation and erection of this structure is performed using methods that are in full compliance with OSHA regulations.
- Any deviation from this design or from any part of this drawing, including the General Notes, without prior written consent from JP Morgan Chase voids this drawing in its
- 14. This design is prototypical and should not be used for site specific applications unless reviewed and deemed suitible for use at that site by a competent Professional Engineer.

9 1/4"

DEPARTURE ELEVATION









JP Morgan Chase Bank #38200P367111

Indian School Rd NE & Louisiana Rd 6670 Indian School Rd NE Albuquerque, NM 87110

Initial Date: __08/10/20 Salesperson: Arthur Navarro Coordinator: Lorena Leon

<u>ASena</u> Designer:_ As noted Scale:.

CUSTOMER APPROVAL

Customer Signature

COPY. COLORS & SIZES

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RESPONSIBILITY OF OTHERS!

Customer Signature

Date

20-01032

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Drawing Number:

CHASE 38000P123456 1 Project ID:


Revision:

R13 - 06.08.21

6/5/20 - CHANGED #E-CSA04A-W50W LIGHT FIXTURE TO THE *C-CP-B-SQ-4L-50K-WH LIGHT FIXTURE

APPROACH ELEVATION

BOLLARDS TO BE MANUFACTURED / INSTALLED BY OTHERS

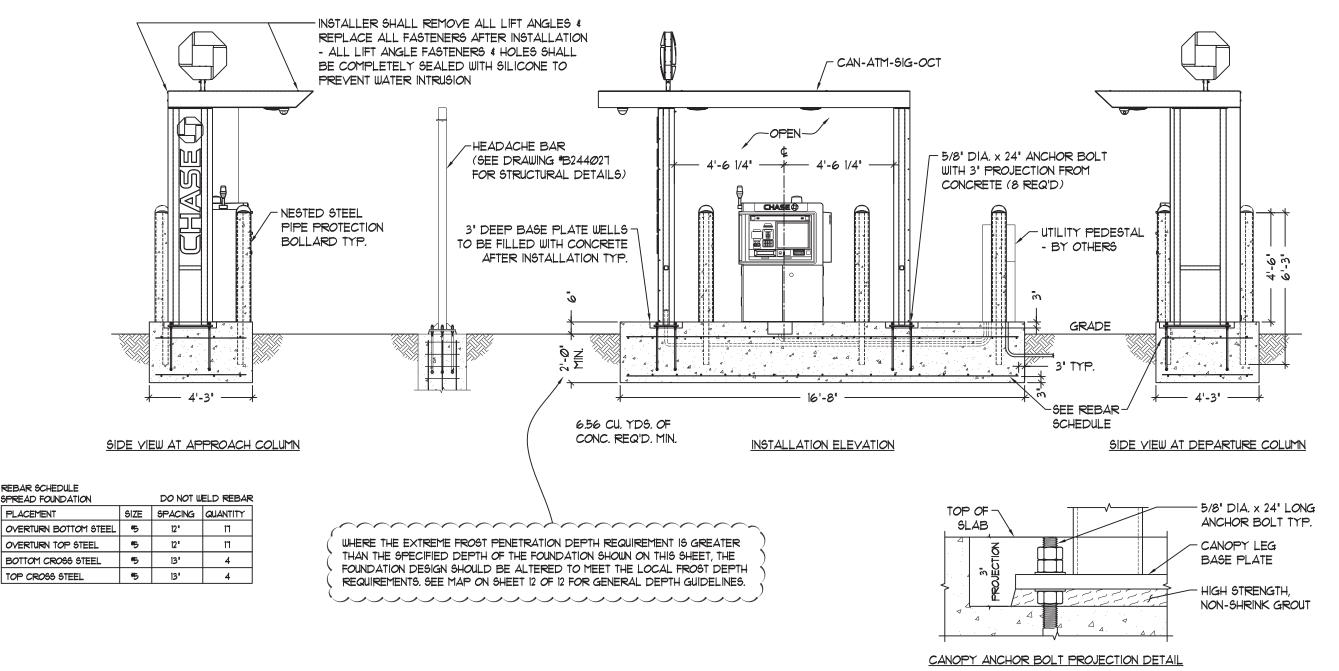









JP Morgan Chase Bank #38200P367111

Indian School Rd NE & Louisiana Rd 6670 Indian School Rd NE Albuquerque, NM 87110

Initial Date: 08/10/20
Salesperson: Arthur Navarro
Coordinator: Lorena Leon
Designer: ASena
Scale: As noted

CUSTOMER APPROVAL

Customer Signature

0 01750

COPY, COLORS & SIZES

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Customer Signature

Date

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Drawing Number:

20-01032

Project ID:

CHASE 38000P123456 1


Revision:

Page:

R13 - 06.08.21

DRC Page 15

Z. 6/5/20 - CHANGED *E-CSA04A-W50W LIGHT FIXTURE TO THE *C-CP-B-5Q-4L-50K-WH LIGHT FIXTURE

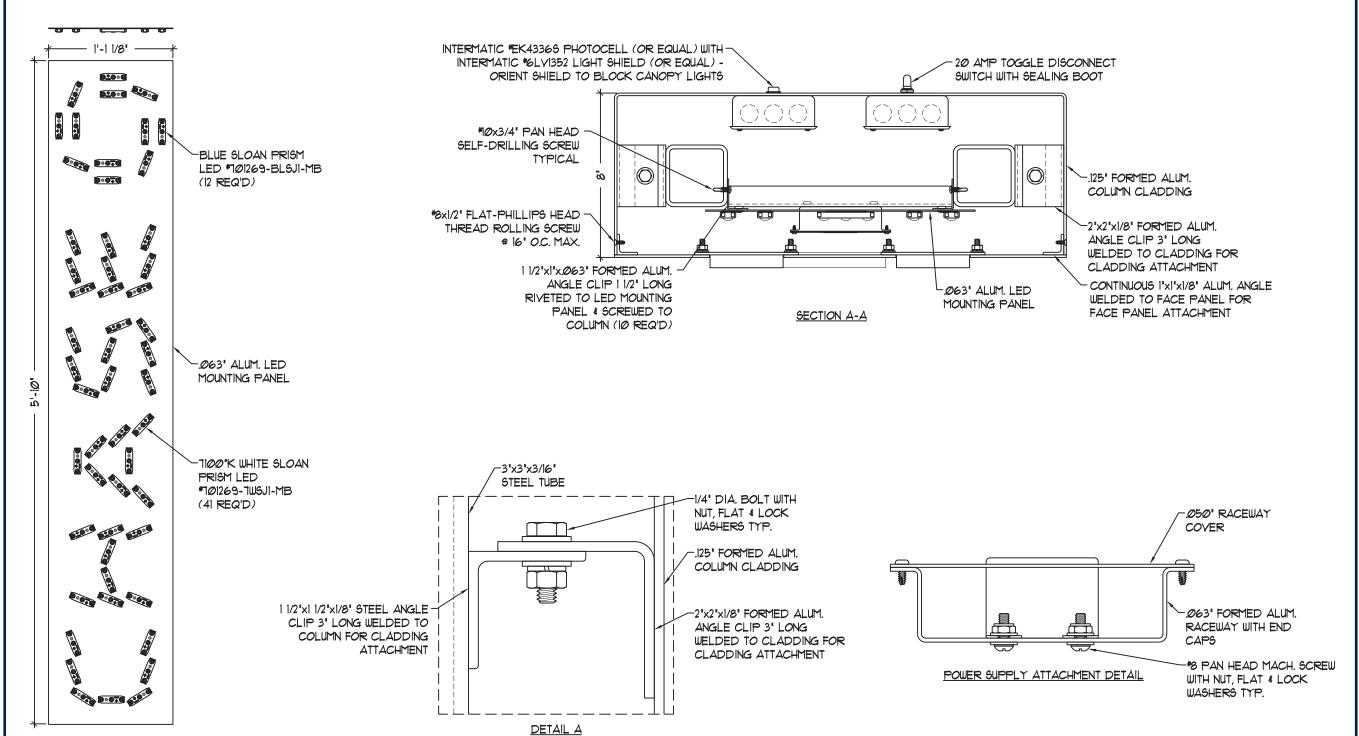



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JP Morgan Chase Bank #38200P367111

Indian School Rd NE & Louisiana Rd 6670 Indian School Rd NE Albuquerque, NM 87110

Initial Date: __08/10/20 Salesperson: Arthur Navarro Coordinator: Lorena Leon **ASena** Designer:_

CUSTOMER APPROVAL

As noted

Customer Signature

Scale:_

COPY, COLORS & SIZES

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RESPONSIBILITY OF OTHERS!

Customer Signature

Date

20-01032

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Drawing Number:

CHASE 38000P123456 1

Project ID:

Revision:


R13 - 06.08.21

6/5/20 - CHANGED *E-CSAO4A-W5OW LIGHT FIXTURE TO THE *C-CP-B-SQ-4L-50K-WH LIGHT FIXTURE

LED MOUNTING PANEL DETAIL

DRC Page 16

BOLLARDS TO BE MANUFACTURED / INSTALLED BY OTHERS

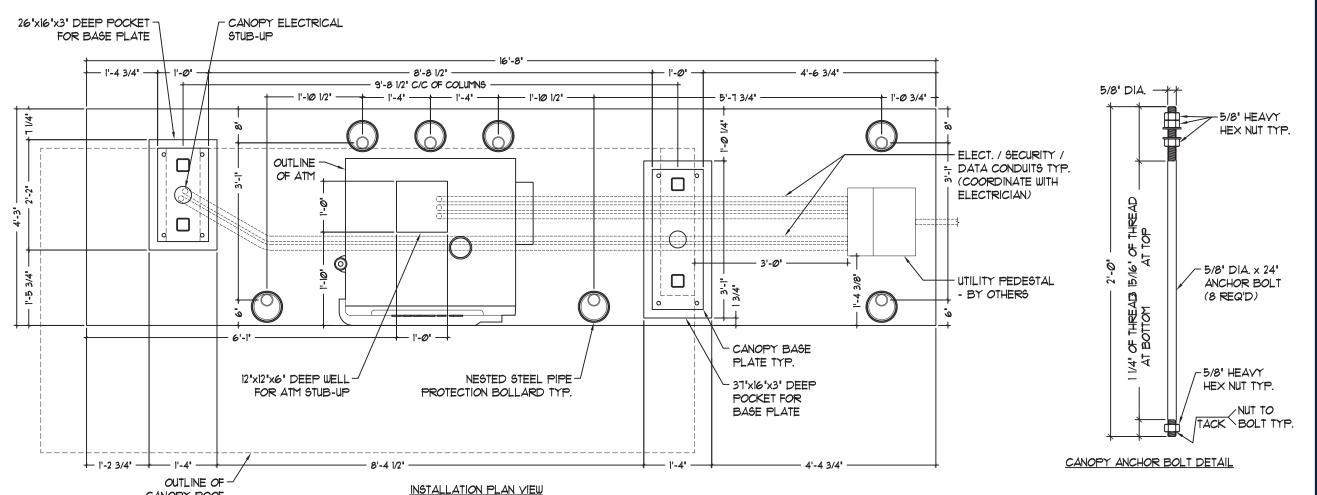

CONDUITS ARE TO BE PROVIDED & SET BY THE ELECTRICIAN PRIOR TO THE PLACEMENT OF CONCRETE







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JP Morgan Chase Bank #38200P367111

Indian School Rd NE & Louisiana Rd 6670 Indian School Rd NE Albuquerque, NM 87110

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CUSTOMER APPROVAL

Customer Signature

COPY, COLORS & SIZES

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electrical to sign location -**RESPONSIBILITY OF OTHERS!**

Customer Signature

Date

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Drawing Number:

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Project ID: Revision:


Page:

R13 - 06.08.21

DRC Page 17

6/5/20 - CHANGED #E-CSA04A-W50W LIGHT FIXTURE TO THE *C-CP-B-5Q-4L-5ØK-WH LIGHT FIXTURE

CANOPY ROOF

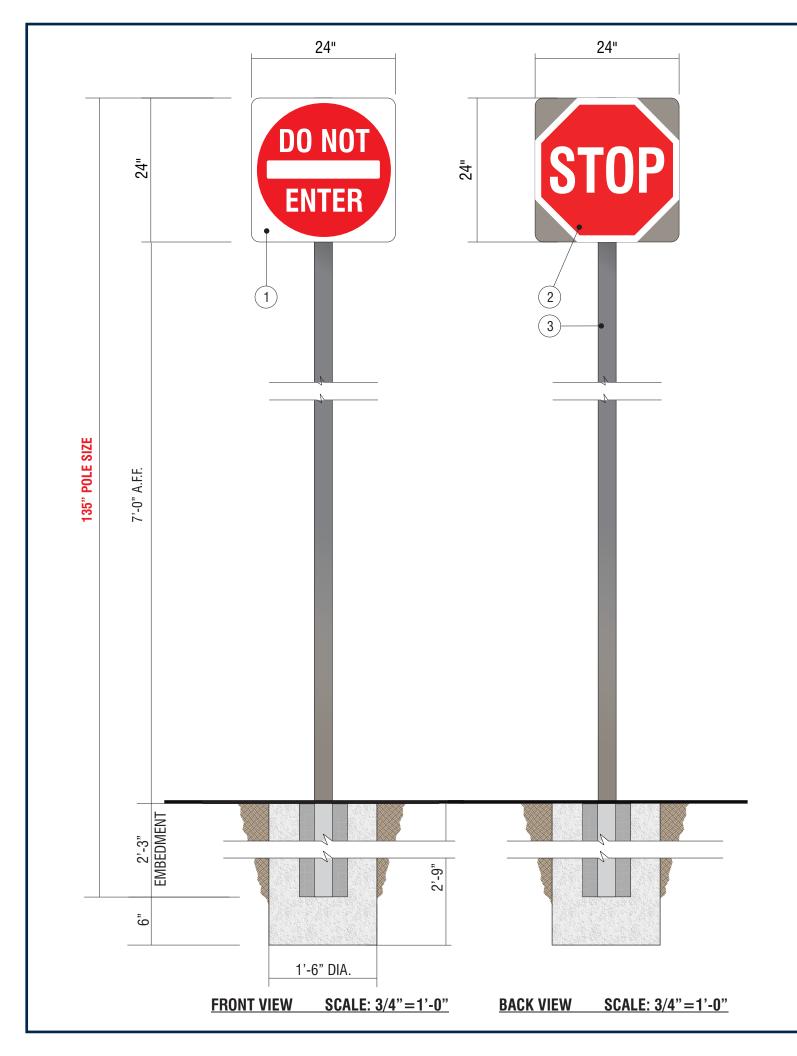


E.7 E.8

SIGN TYPE

CUSTOM TC-P-H DOT STOP/DO NOT ENTER

MANUFACTURE AND INSTALL TWO (2) D/F NON-ILLUMINATED SIGNS

- 1. .125" ALUMINUM SIGN FACE, D.O.T. STANDARD "DO NOT ENTER" PAINT FINISH BACK SIDE SURFACE DARK NICKEL MATTHEWS MP #18248, GLOSS FINISH.
- 2. .125" ALUMINUM SIGN FACE, D.O.T. STANDARD "STOP" PAINT FINISH BACK SIDE SURFACE DARK NICKEL MATTHEWS MP #18248, GLOSS FINISH.
- **3.** SQ. ALUM. TUBE POST, **3"** x **3"** x **1/8"** x **135"** LONG W/ .063" THICK ALUM. CAP PLATE @ TOP.

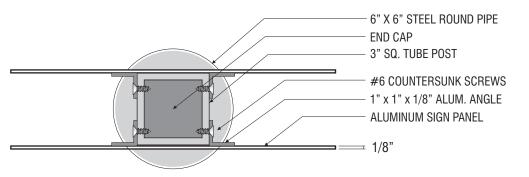

TOP SECTION SCALE: 1"=1'-0"







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JP Morgan Chase Bank #38200P367111

Indian School Rd NE & Louisiana Rd 6670 Indian School Rd NE Albuquerque, NM 87110

Initial Date: 08/10/20
Salesperson: Arthur Navarro
Coordinator: Lorena Leon
Designer: ASena
Scale: As noted

CUSTOMER APPROVAL

Customer Signature

COPY, COLORS & SIZES

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RESPONSIBILITY OF OTHERS!

Customer Signature

Date

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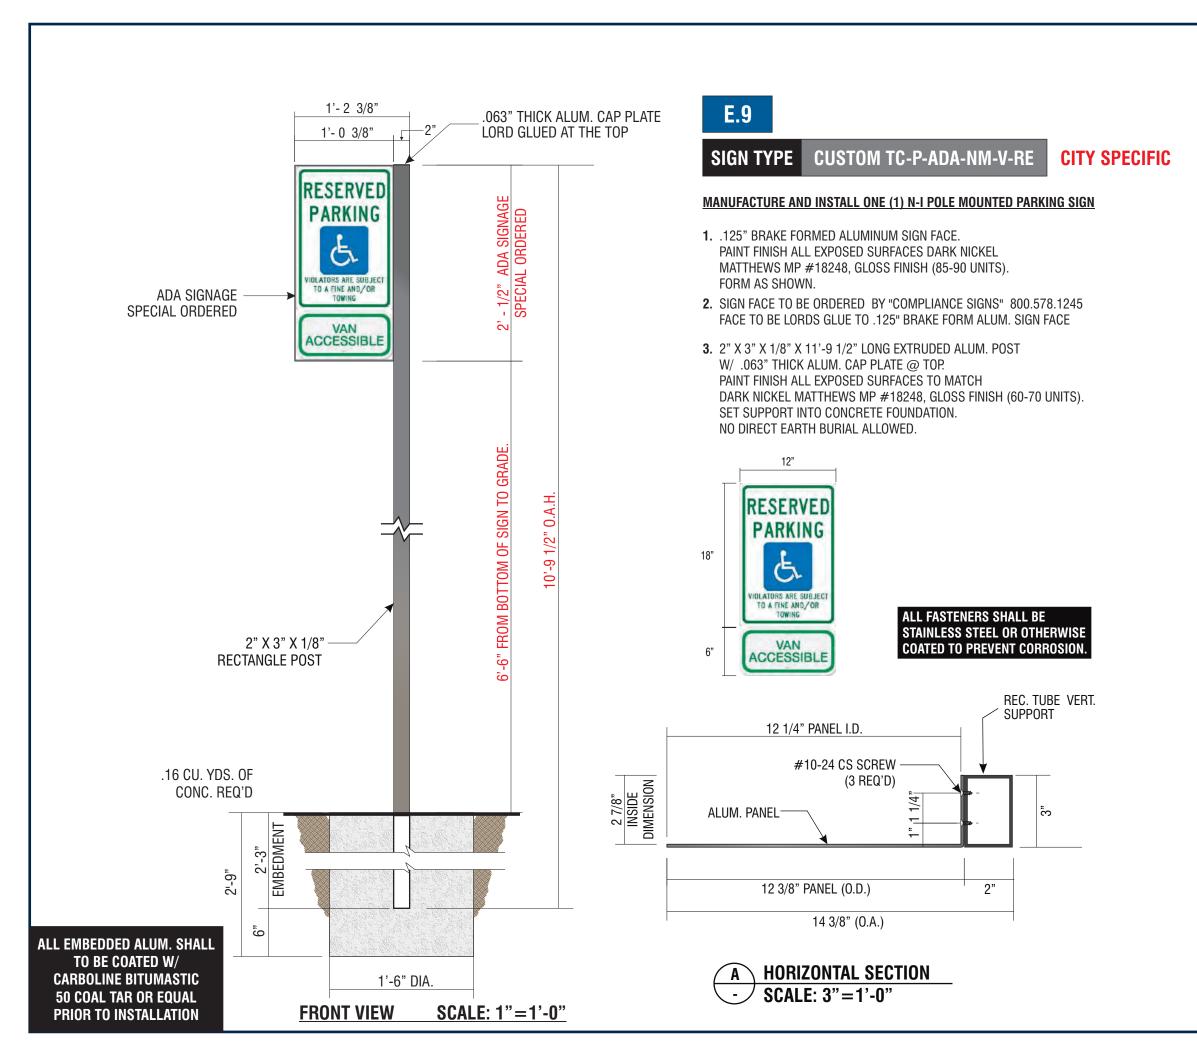
Project ID:

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R13 - 06.08.21

Page:

DRC Page 18





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JP Morgan Chase Bank #38200P367111

Indian School Rd NE & Louisiana Rd 6670 Indian School Rd NE Albuquerque, NM 87110

Initial Date: ___08/10/20 Salesperson: Arthur Navarro Coordinator: Lorena Leon **ASena** Designer:_ As noted

CUSTOMER APPROVAL

Customer Signature

COPY, COLORS & SIZES

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CHASE 38000P123456 1


20-01032

Project ID:

Revision:

R13 - 06.08.21

DRC Page 19

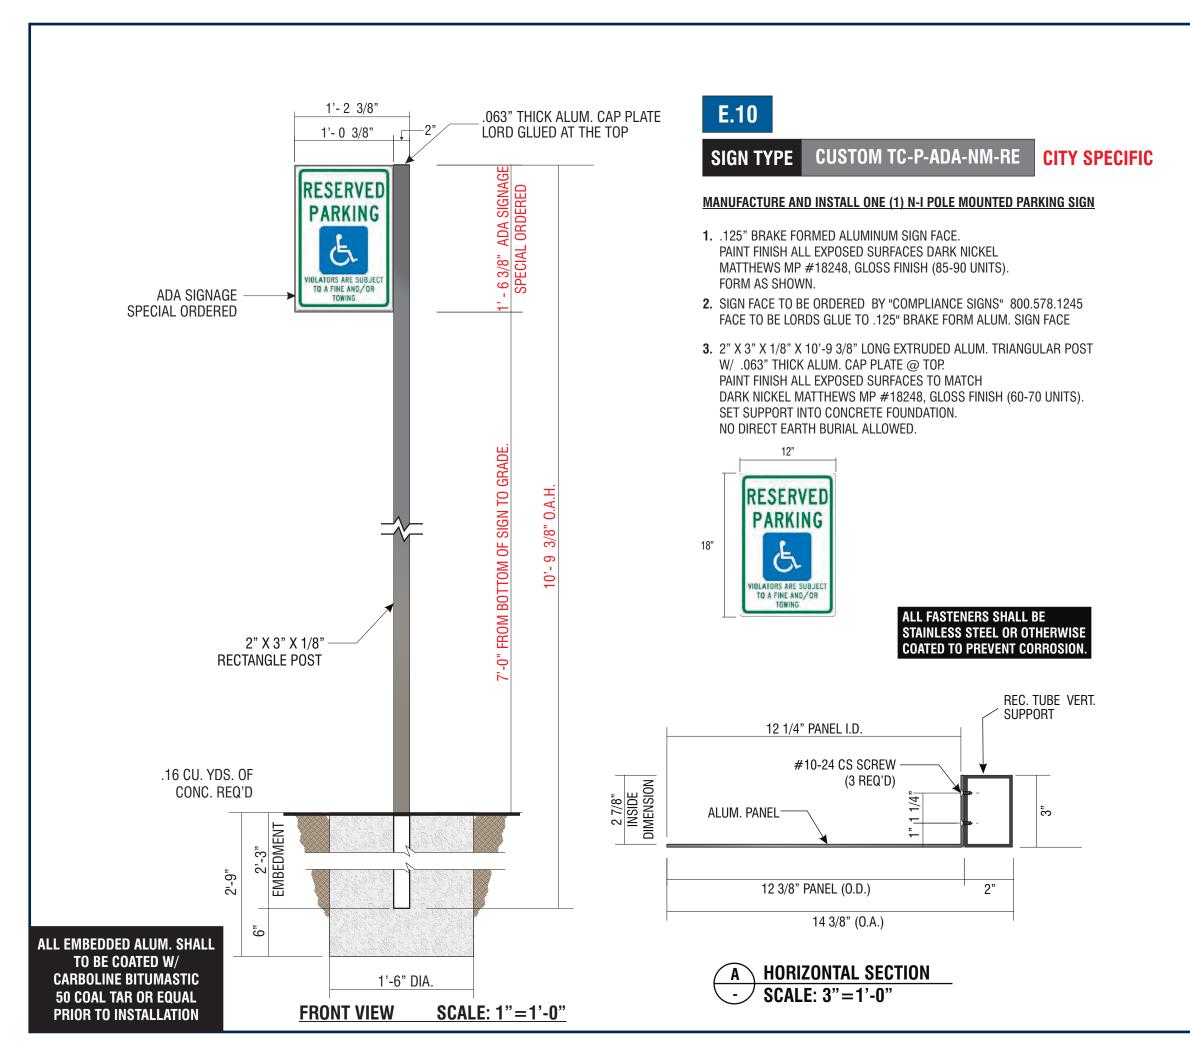



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CUSTOMER APPROVAL

As noted

Customer Signature

COPY, COLORS & SIZES

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Customer Signature

Date

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CHASE 38000P123456 1


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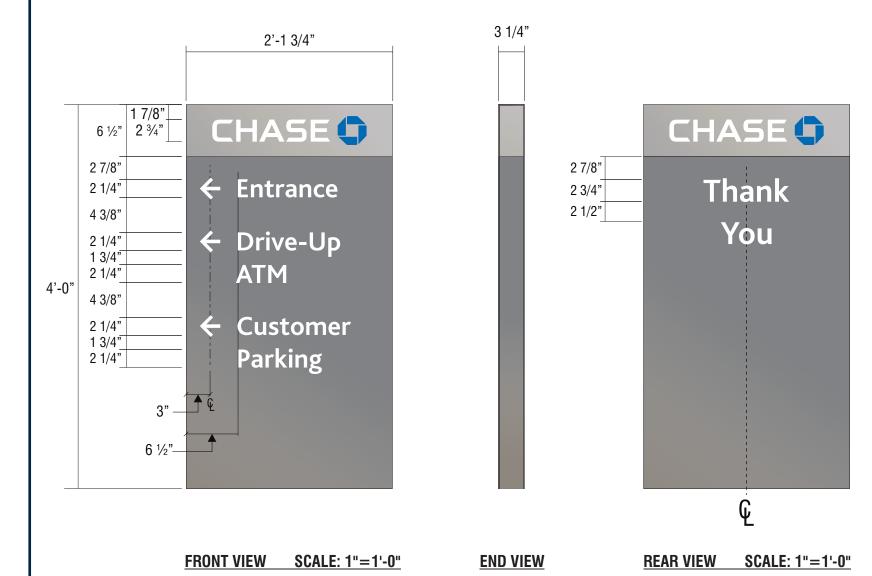
Revision:

R13 - 06.08.21

DRC Page 20



TOP VIEW SCALE: 1"=1'-0"

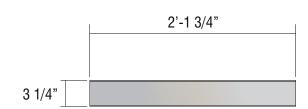

E.11 SIGN TYPE D-7.6-RE

MANUFACTURE & INSTALL ONE (1) NON-ILLUMINATED DIRECTIONAL SIGN

FACES: .125" THICK ALUMINUM FACES, QUARTER ROUNDED. TOP PORTION: PAINT CHASE NICKEL #19891, GLOSS FINISH. BOTTOM PORTION: PAINT CHASE DARK NICKEL #18248, GLOSS FINISH.

CHASE COPY: 3M #7725-10 WHITE VINYL.

OCTAGON: 3M #3632-127 BLUE OVER #7725-10 WHITE. SECONDARY COPY/ARROWS: TO BE 3M SCOTCHLITE #680-10

REFLECTIVE WHITE VINYL

POSTS: 2" X 3" X.125" RECTANGLE TUBE POSTS.

TOP PORTION: CONTINUOUS BAND TO BE PAINTED NICKEL

#19891, GLOSS FINISH.

BOTTOM PORTION: PAINT CHASE DARK NICKEL #18248,

GLOSS FINISH.

TOP CAP: .125" ALUMINUM PAINTED CHASE NICKEL #19891, GLOSS FINISH.







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Designer: ASena
Scale: As noted

CUSTOMER APPROVAL

Customer Signature

COPY, COLORS & SIZES

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Customer Signature

Date

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Drawing Number:

CHASE 38000P123456 1


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Revision:


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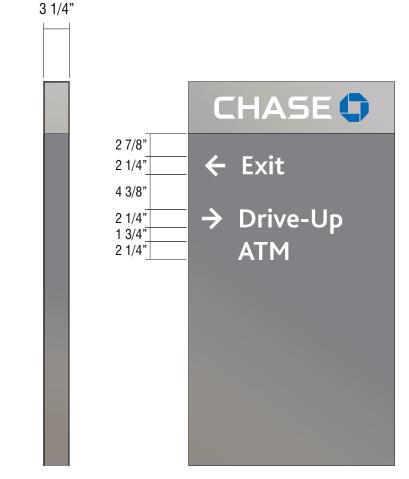
R13 - 06.08.21

DRC Page 21



TOP VIEW SCALE: 1"=1'-0"

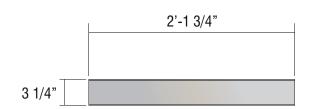

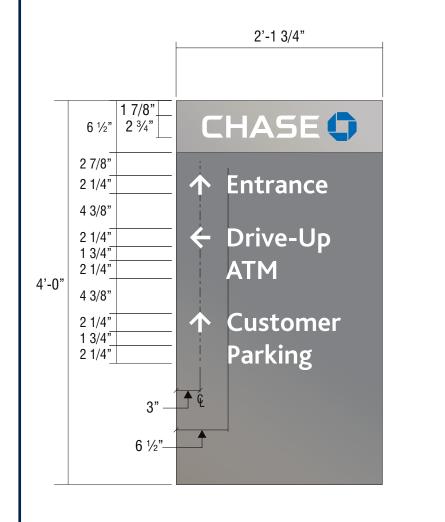

FRONT VIEW SCALE: 1"=1'-0" END VIEW REAR VIEW SCALE: 1"=1'-0"

E.12 SIGN TYPE D-7.6-RE

MANUFACTURE & INSTALL ONE (1) NON-ILLUMINATED DIRECTIONAL SIGN

FACES: .125" THICK ALUMINUM FACES, QUARTER ROUNDED. TOP PORTION: PAINT CHASE NICKEL #19891, GLOSS FINISH. BOTTOM PORTION: PAINT CHASE DARK NICKEL #18248, GLOSS FINISH.

CHASE COPY: 3M #7725-10 WHITE VINYL.

OCTAGON: 3M #3632-127 BLUE OVER #7725-10 WHITE. SECONDARY COPY/ARROWS: TO BE 3M SCOTCHLITE #680-10

REFLECTIVE WHITE VINYL

POSTS: 2" X 3" X.125" RECTANGLE TUBE POSTS.

TOP PORTION: CONTINUOUS BAND TO BE PAINTED NICKEL

#19891, GLOSS FINISH.

BOTTOM PORTION: PAINT CHASE DARK NICKEL #18248,

GLOSS FINISH.

TOP CAP: .125" ALUMINUM PAINTED CHASE NICKEL

#19891, GLOSS FINISH.







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Drawing Number:

CHASE 38000P123456 1


20-01032

Project ID:

Revision:

R13 - 06.08.21

DRC Page 22

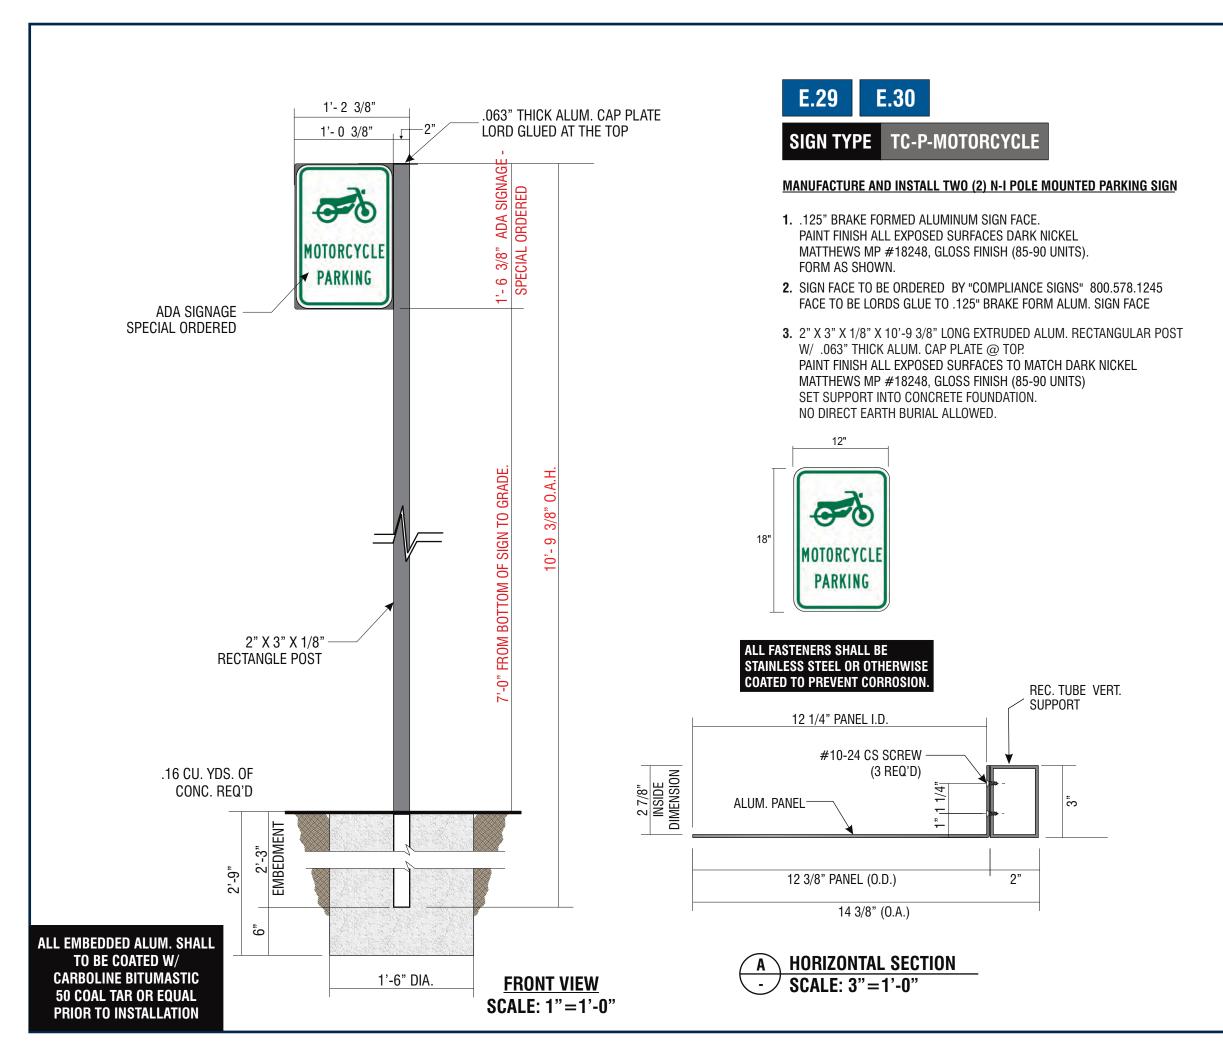



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JP Morgan Chase Bank #38200P367111

Indian School Rd NE & Louisiana Rd 6670 Indian School Rd NE Albuquerque, NM 87110

Initial Date: __08/10/20 Salesperson: Arthur Navarro Coordinator: Lorena Leon

ASena Designer:_ Scale: As noted

CUSTOMER APPROVAL

Customer Signature

COPY, COLORS & SIZES

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RESPONSIBILITY OF OTHERS!

Customer Signature

Date

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Drawing Number:

20-01032


Project ID:

CHASE 38000P123456 1

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R13 - 06.08.21

DRC Page 23

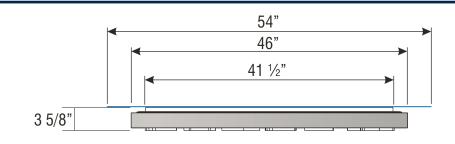

STIPPLE FINISH PAINT PROCESS FOR MATTHEWS #MP-18101 CHASE NICKEL: BASE COAT: * 3-4 MEDIUM COATS OF MAP SVOC2471 FOR BASE COAT. ALLOW TO AIR DRY 12-24 HRS OR FORCE DRY AT 200 DEG. F. FOR 15MIN

STIPPLE FINISH COAT:* MIX MAP SVOC1761 WITH CATALYST BUT *NO* REDUCER; SET PRESSURE POT AT 18-20 PSI TANK PRESSURE AND 20-25 PSI ATOMIZING AIR AT THE PAINT GUN USE 1.0 TO 1.2 FLUID NOZZLE.

STIPPLE FINISH PAINT PROCESS FOR MATTHEWS #MP-49353 CHASE BLUE METALLIC: BASE COAT:* 3-4 MEDIUM COATS OF SVOC2472 SP FOR BASE COAT. ALLOW TO AIR DRY 12-24 HRS OR FORCE DRY AT 200 DEG. F. FOR 15MIN STIPPLE FINISH COAT:* MIX MAP SVOC2049 SP WITH CATALYST BUT_*NO*_REDUCER; SET PRESSURE POT AT 18-20 PSI TANK PRESSURE AND 20-25 PSI ATOMIZING AIR AT THE PAINT GUN USE 1.0 TO 1.2 FLUID NOZZLE. APPLY 5-6 PASSES OF A FINE TIGHT STIPPLE

TOP VIEW SUR-TTW-U-4 SCALE: 3/4" = 1'-0"


NOTE: PUSH-THRU ACRYLIC SHALL HAVE A MILL FINISH ON ALL ROUTED EDGES


APPLY 5-6 PASSES OF A FINE TIGHT STIPPL

ALL EXPOSED FASTENER HEADS SHALL BE PAINTED TO MATCH THE **EXTERIOR CABINET FINISH**

SLOAN BLUE LED STRIPE AROUND PERIMETER TO PROVIDE HALO-LIT EFFECT AGAINST BACK PANEL

GRAPHICS DEPICTED ARE FOR I LLUSTRATIVE PURPOSES ONLY! USE ONLY APPROVED ARTWORK FOR PRODUCTION.

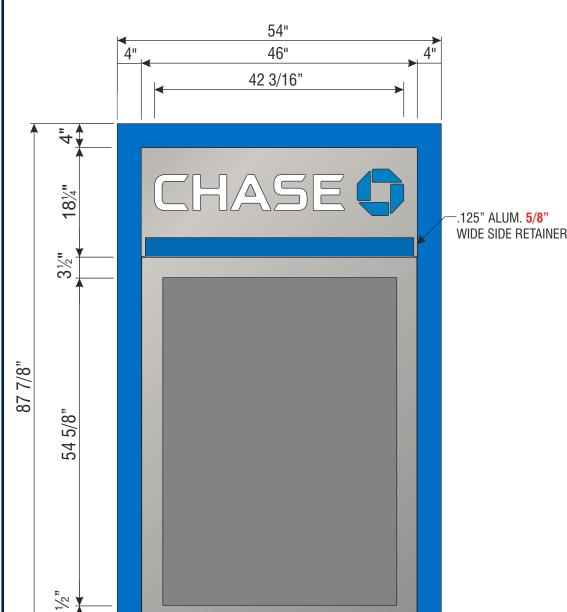

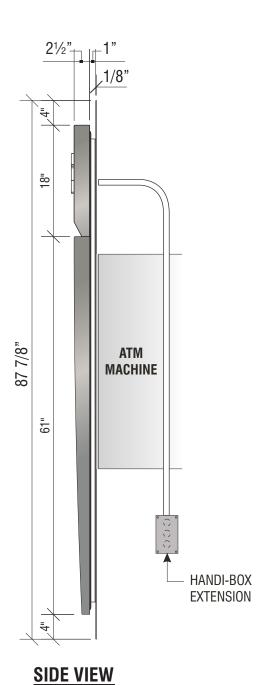



FRONT VIEW SCALE: 3/4"=1'-0"

 \Im

SIGN TYPE SUR-TTW-U-4-TP

MANUFACTURE AND INSTALL ONE (1) INTERNALLY ILLUMINATED THIN PROFILE ATM SURROUND

PERSPECTIVE VIEW



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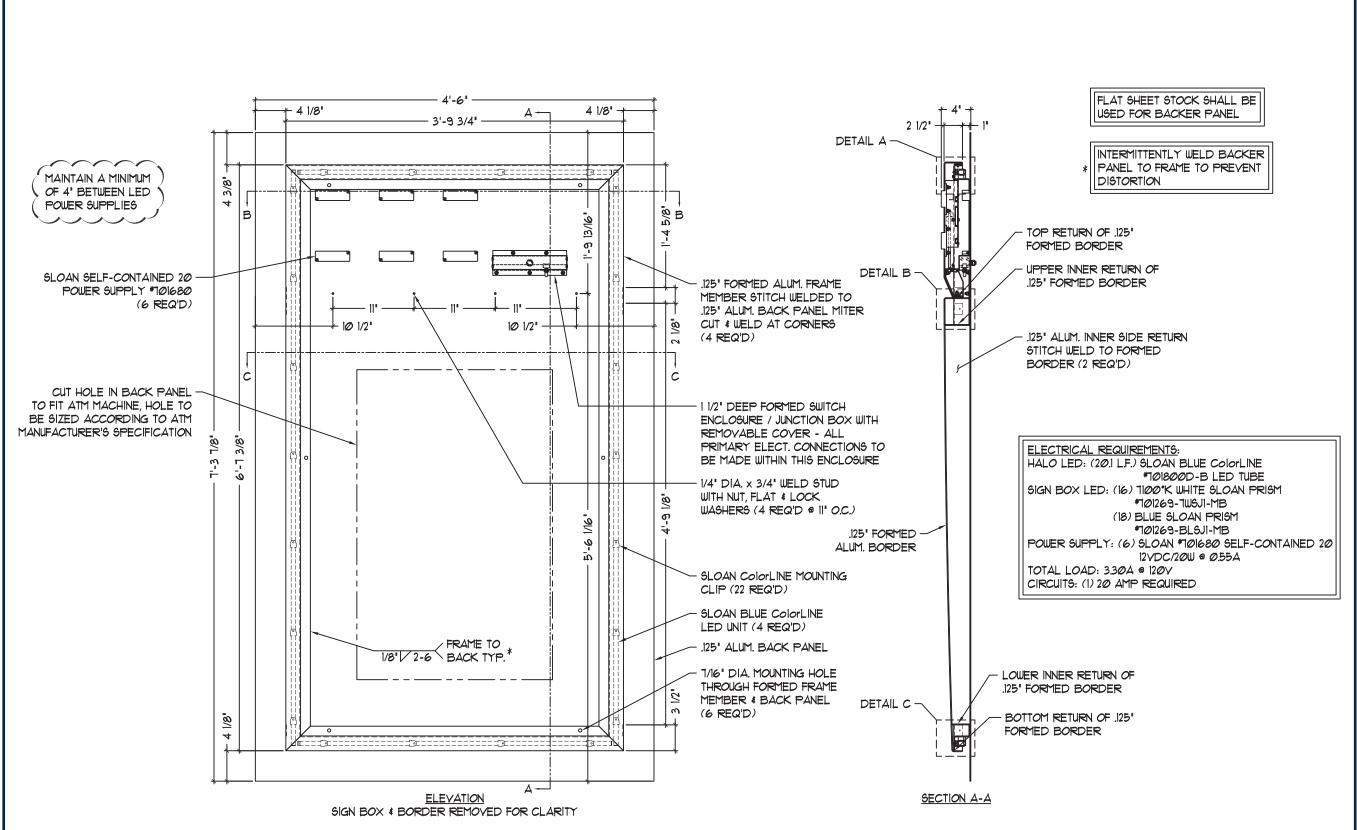
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CHASE 38000P123456 1

Revision:

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DRC Page 24





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Revision:

R13 - 06.08.21

DRC Page 25

ColorLINE

The Ultimate LED Border Tube



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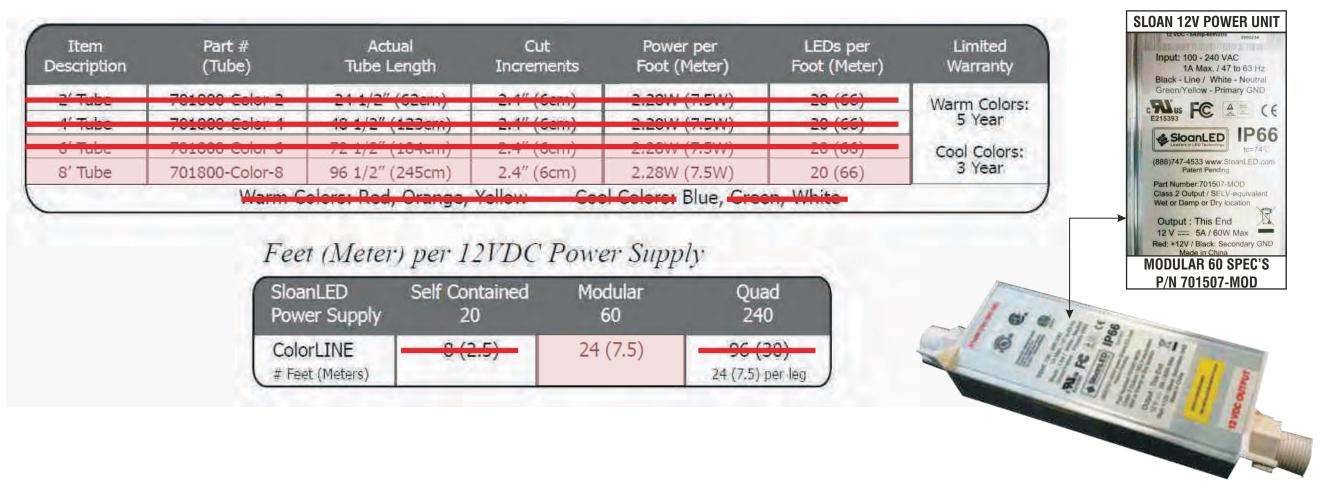


- · Super Bright
- · Profile Similar to Neon
- · Lit, Mitered Corners
- · Fully Compatible with All SloanLED 12 VDC Products

COLORLINE SIZES AND CUT LENGTHS:

- (3) EA. #701800-COLOR-8 (96 ½" LONG)
- MAKE VERTICAL TUBES FROM (2) 96 1/2" PARTS.
- MAKE HORIZONTAL TUBES FROM (1) 96 1/2" PART.
- EACH PART MUST HAVE A FACTORY RUBBER END.
- ONCE PLASTIC CAP IS ATTACHED TO THE CUT SIDE. THE TUBE WILL FINISH AT 77 5/32" FOR VERTICAL IN LENGTH INCLUDING CAP.

THE TUBE WILL FINISH AT 45 3/16" FOR HORIZONTAL IN LENGTH INCLUDING CAP.





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DRC Page 26