
ADMINISTRATIVE	
FILE #PROJ	ECT #
· · · · · · · · · · · · · · · · · · ·	
	<i>a</i> .
APPROVED BY	DATE

CITY OF ALBUQUERQUE

Planning Department Brennon Williams, Director

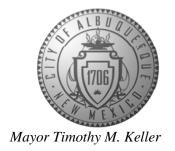

November 19, 2020

Paul Cragun, P.E. Cumulus Design 2080 N. Highway 360, Suite 240 Grand Prairie, TX 75050

RE: Chase Bank – Indian School Rd. 6670 Indian School Rd. NE Grading and Drainage Plans Engineer's Stamp Date: 11/09/20

Hydrology File: J18D001C

Dear Mr. Cragun:

Based upon the information provided in your submittal received 11/09/2020, the Grading and Drainage Plans are approved for Building Permit and action by the DRB on Site Plan for

Building Permit.

PO Box 1293

Albuquerque

NM 87103

www.cabq.gov

Please attach a copy of this approved plan in the construction sets for Building Permit processing along with a copy of this letter. Prior to approval in support of Permanent Release of Occupancy by Hydrology, Engineer Certification per the DPM checklist will be required.

As a reminder, if the project total area of disturbance (including the staging area and any work

within the adjacent Right-of-Way) is 1 acre or more, then an Erosion and Sediment Control (ESC) Plan and Owner's certified Notice of Intent (NOI) is required to be submitted to the Stormwater Quality Engineer (Doug Hughes, PE, jhughes@cabq.gov, 924-3420) 14 days prior to

any earth disturbance.

The Payment in Lieu payment of \$2,028.80 must be paid prior to Permanent Release of Occupancy approval. Please use the attached City of Albuquerque Treasury Deposit form. Once the Owner paid the fee, please provide Hydrology with a copy of the receipt.


If you have any questions, please contact me at 924-3995 or rbrissette@cabq.gov.


Sincerely,

Renée C. Brissette, P.E. CFM Senior Engineer, Hydrology

Renée C. Brissette

Planning Department

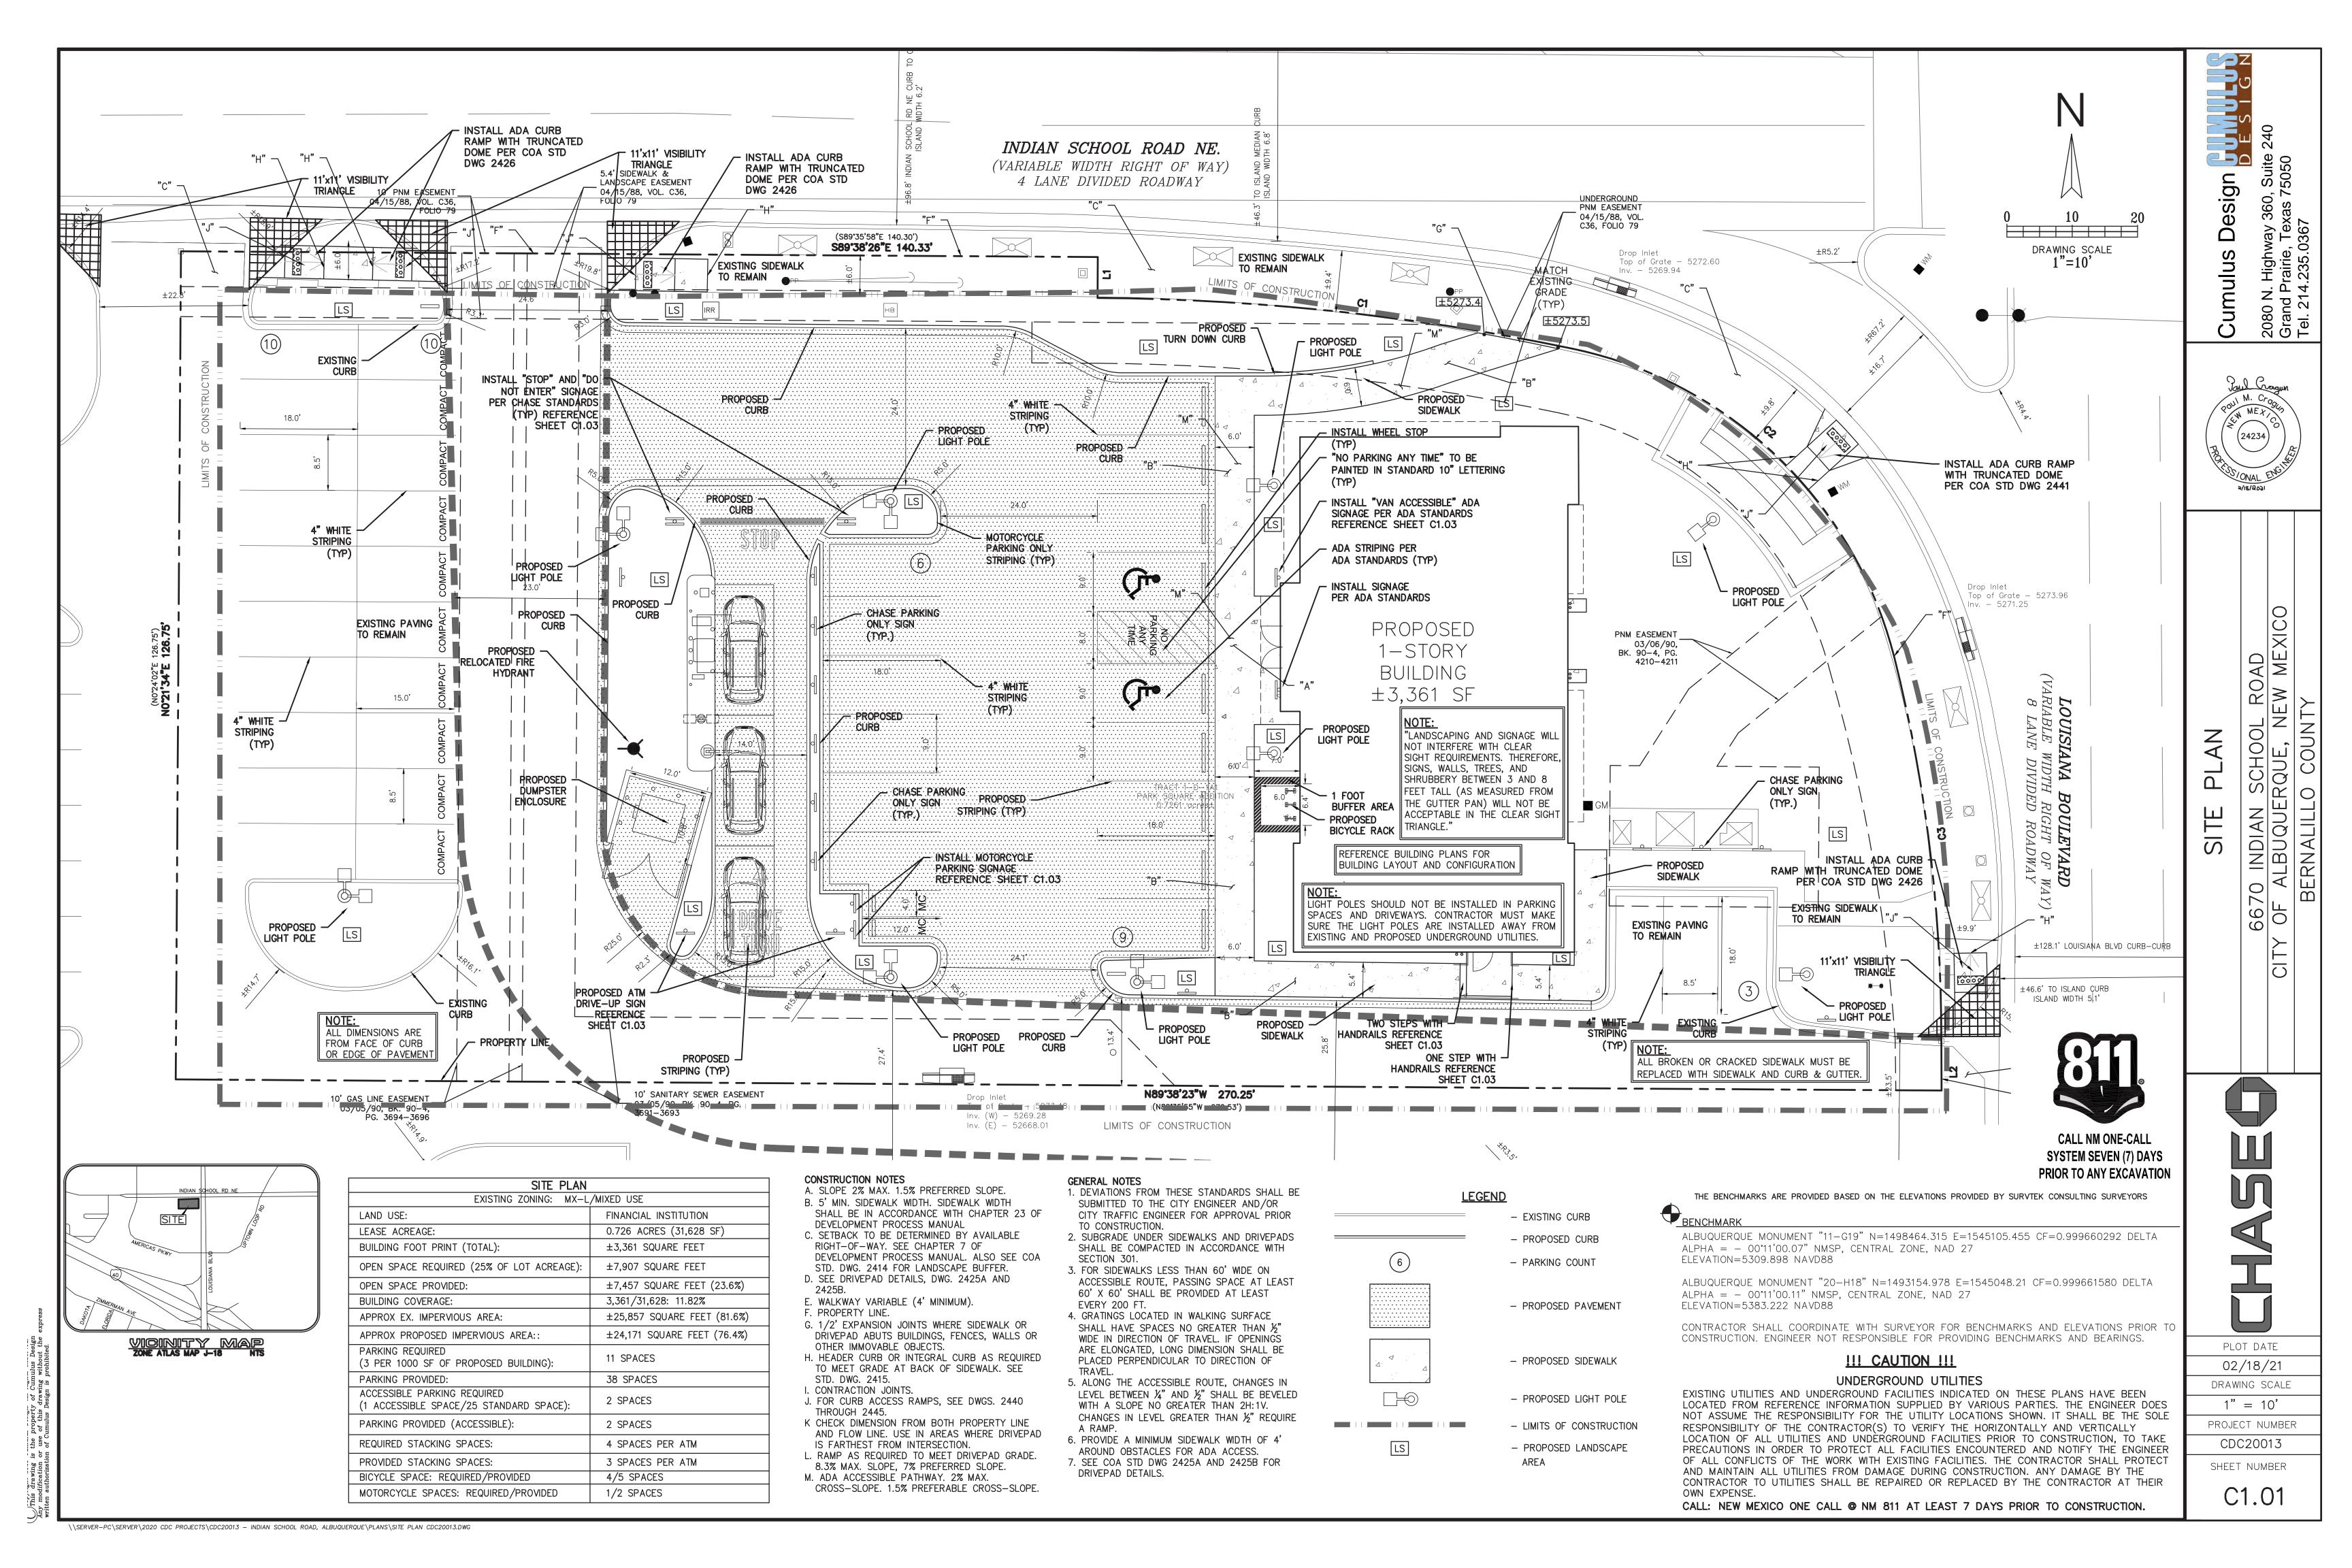

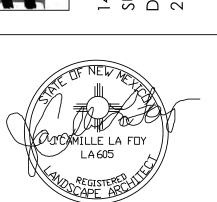


10/09/2020

REVISIONS

DATE ISSUED: SEPTEMBER 09, 2020 2020030 SHEET NAME:

LANDSCAPE PLAN

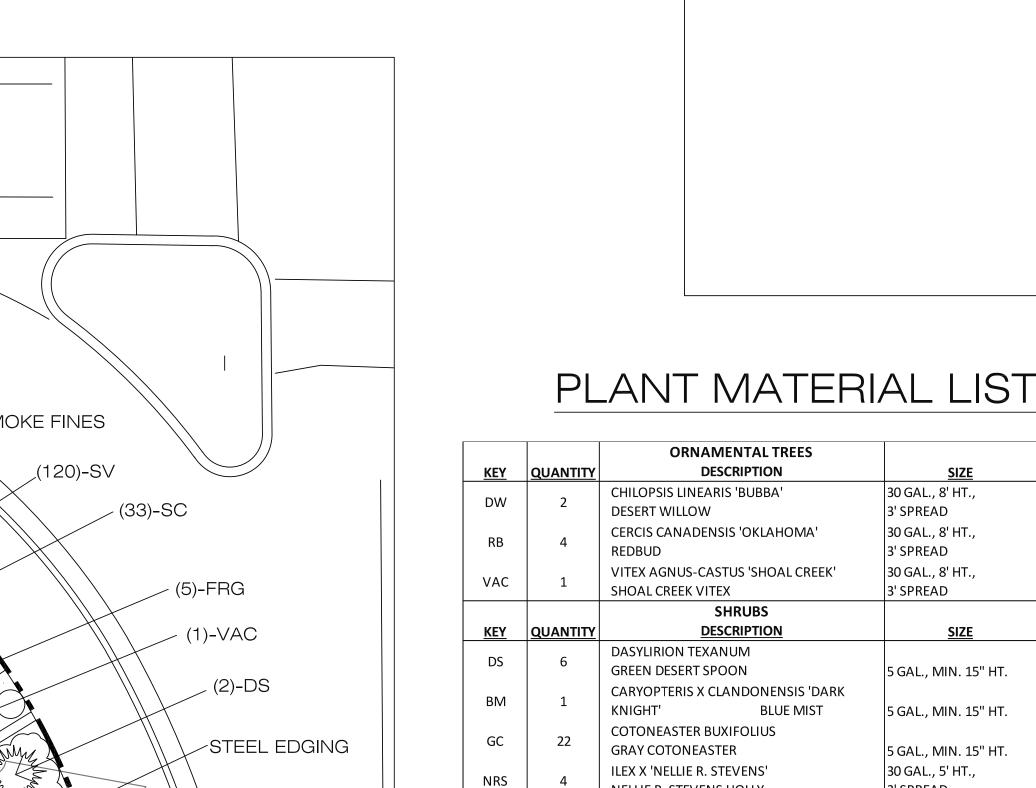

KEY QUANTITY CHILOPSIS LINEARIS 'BUBBA' 30 GAL., 8' HT., DESERT WILLOW 3' SPREAD 30 GAL., 8' HT. 3' SPREAD 30 GAL., 8' HT., VITEX AGNUS-CASTUS 'SHOAL CREEK' SHOAL CREEK VITEX 3' SPREAD KEY QUANTITY DASYLIRION TEXANUM GREEN DESERT SPOON 5 GAL., MIN. 15" HT. CARYOPTERIS X CLANDONENSIS 'DARK **BLUE MIST** 5 GAL., MIN. 15" HT. COTONEASTER BUXIFOLIUS **GRAY COTONEASTER** 5 GAL., MIN. 15" HT. 30 GAL., 5' HT., ILEX X 'NELLIE R. STEVENS' NRS NELLIE R. STEVENS HOLLY 3' SPREAD 10 LEUCOPHYLLUM LANGMANIAE TEXAS SAGE 'LYNN'S LEGACY' 5 GAL., MIN. 15" HT. HESPERALOE PARVIFOLIA **RED YUCCA** 3 GAL., MIN. 10" HT. SCUTELLARIA SUFFRUTESCENS PINK SKULLCAP 5 GAL., MIN. 15" HT. SALVIA X 'ULTRA VIOLET ULTRA VIOLET SAGE 5 GAL., MIN. 15" HT. CAESALPINIA GILLIESII YBP YELLOW BIRD OF PARADISE 10 GAL., MIN. 36" HT. AGAVE OVATIFOLIA WHALE'S TONGUE 10 GAL., MIN. 36" HT. YUCCA FILAMENTOSA 'COLOR GUARD' COLOR GUARD YUCCA 5 GAL., MIN. 8" HT. GROUND COVER **DESCRIPTION** 1 GAL., FULL PLANT VERBENA RIGIDA 120 SANDPAPER VERBENA TEUCRIUM CHAMAEDRYS 'PROSTRATUM' I GAL., FULL PLANT 36" PROSTRATE GERMANDER ORNAMENTAL GRASSES KEY QUANTITY MUHLENBERGIA CAPILLARIS 'REGAL MIST' ABM AUTUMN BLUSH MUHLY CALAMAGROSTIS ARUNDINACEA 'KARL FRG FOESTER' FEATHER REED GRASS 3 GAL., FULL PLANT MISCANTHUS SINENSIS 'ADAGIO' MHG

3 GAL., FULL PLANT 1 GAL., FULL PLANT

J. CAMILLE LA FOY

LANDSCAPE ARCHITECTURE CONSULTING

101C NORTH GREENVILLE AVENUE, #242 ALLEN, TEXAS 75002 214-502-4036

16" O.C.

ADAGIO GRASS

SHEET NOTES:

LANDSCAPE CONTRACTOR TO PROVIDE A COST FOR

REMOVE ALL EXISTING PLANTS AROUND MONUMENT

COMPLIMENTARY. ANYTHING CALLED FOR ON ONE AND

NOT THE OTHER IS AS BINDING AS IF SHOWN AND CALLED FOR ON BOTH. THE PLANT SCHEDULE IS AN AID

THE DRAWINGS AND SPECIFICATIONS ARE

ALTERNATE TO THE BID.

TO BIDDERS ONLY.


TREE PRUNING FOR EXISTING TREES TO REMAIN AS AN

NASSELLA TENUISSIMA

MEXICAN FEATHER GRASS

INDIAN SCHOOL ROAD NE. (VARIABLE WIDTH RIGHT OF WAY) COYOTE MIST 4 LANE DIVIDED ROADWAY GRAVEL 2"-4" PROTECTIVE TREE FENCING ₁(8)-MFG MOUNTAINAIR
BROWN GRAVEL 2"-4" /BOULDER , GRAVEL EDGE 7/(1)-YBP /(30)-PG , (6)-SG SMOKE FINES MOUNTAINAIR/ BROWN GRAVEL 2"-4" BOULDER MOUNTAINAIR (3)-MHG <u></u> BROWN GRAVEL 2"-4" \ _/(11)-MFG PUEBLO ROSE-GRAVEL 7/8" ROOT BARRIER (1)-SG-APPROX. 215 L.F. BOULDER-MOUNTAINAIR BROWN GRAVEL 2"-4" DESERT BRONZE --GRAVEL 2"-4" _ (1)-WT COYOTE MIST GRAVEL 2"-4" (5)-GC PUEBLO ROSE GRAVEL 7/8" SMOKE FINES **(**2)-MFG~ BOULDER-MOUNTAINAIR (1)-SG-`(7)-FRG BROWN GRAVEL 2"-4"~ (1)-YF— BIKE RACK -/PROTECTIVE TREE FENCING (1)-YBP< – PUEBLO ROSE GRAVEL 7/8" PUEBLO ROSE GRAVEL 7/8" (1)-DS⁻ DESERT GRAVEL BOULDER-(3)-MFG² - GRAVEL (2)-MFG / √(1)-RY 0.7261 acres± N89°38′23″W 270.25′ (N89°35′55″W 270.53′) PUEBLO ROSE / GRAVEL 7/8" BOULDER FRONT LOT EDGE LANDSCAPE BUFFER

LANDSCAPE PLAN SCALE: 1" = 10'-0"

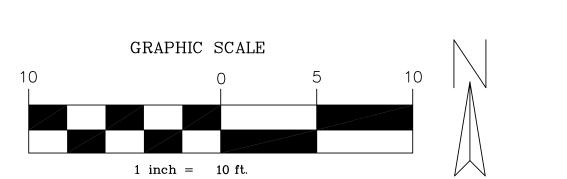

GRAVEL KEY













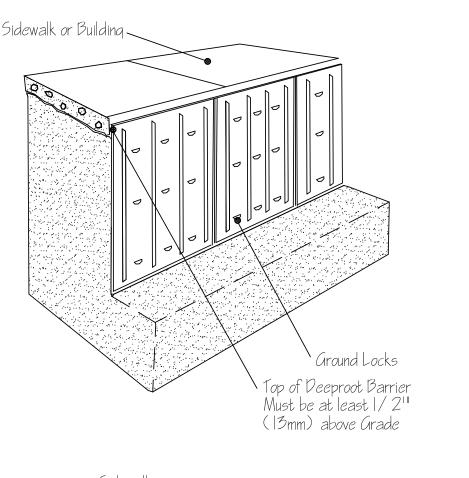

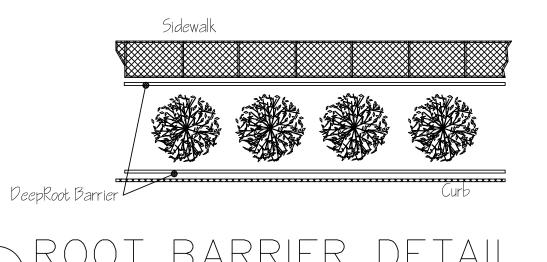

BARRIER DETAIL



TYPICAL SIGNAGE MOUTING DETAIL FOR

ACCESSIBLE SPACES

(SIZE: 30"X30")

STOP SIGN

MOUNT W/ CORROSION RESISTANT

TYPICAL-

ALUMINUM

2" SQUARE 14 GA \ QUIK-PUNCH OR

APPROVED EQUAL

3000 PSI CONCRETE

ADA DUAL SIGNAGE MOUNTING DETAIL

QUICK-PUNCH

MOUNTING SLEEVE

EXISTING GRADE -

STOVE BOLT (DEFORM THREADS

AFTER INSTALLATION)













R5 - 1

(SIZE: 30"x30")

MOUNT W/ CORROSION RESISTANT

TYPICAL-ALUMINUM

2" SQUARE 14 GA— QUIK—PUNCH OR

APPROVED EQUAL

CONCRETE

QUICK-PUNCH

MOUNTING SLEEVE

EXISTING GRADE 7


SIGN

STOVE BÓLT (DEFORM THREADS

AFTER INSTALLATION)



DO NOT ENTER SIGN

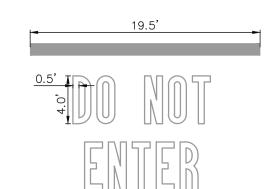

BLUE PAINT


WHITE PAINT /-(TYP.)

CL OF PARKING SPACE


ACCESSIBLE PARKING SYMBOL DETAIL

26.0' @ 2.0% MAX


ADA PARKING STALLS AND AISLE DETAIL

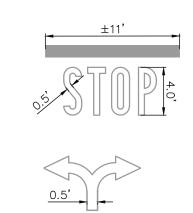


TEXT DETAILS

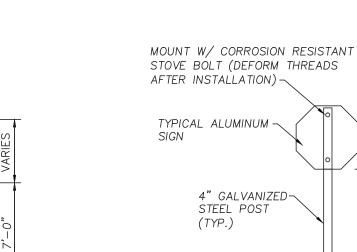



TYPICAL ALUMINUM -4" GALVANIZED \ STEEL POST (TYP.) EXISTING GRADE -3000 PSI -CONCRETE TYPICAL SIGNAGE MOUNTING DETAIL STOP SIGNAGE MOUNTING DETAIL

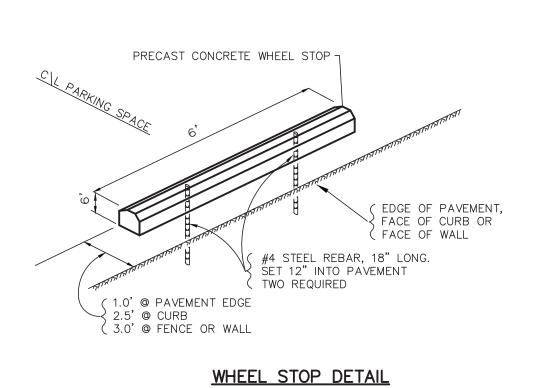

DETAILS ON THIS SHEET ARE PRIVATE. ALL WORK WITHIN PUBLIC EASEMENTS OR RIGHT-OF-WAY SHALL BE PER CITY (OR STATE, IF APPLICABLE) STANDARD DETAILS. THE CONTRACTOR IS REQUIRED TO HAVE ON—SITE, AT ALL TIMES, A COPY OF THE CITY'S CONSTRUCTION DETAILS.

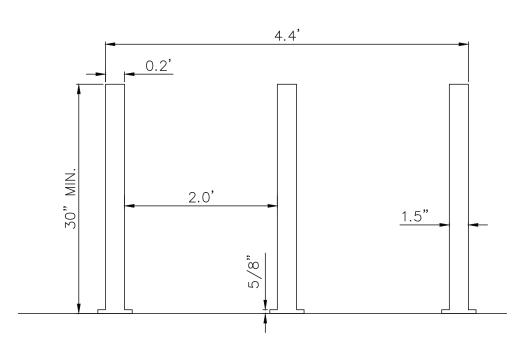

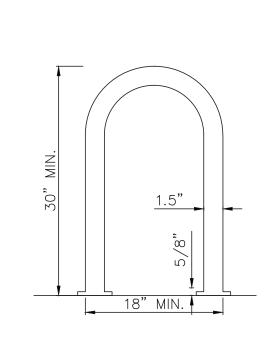


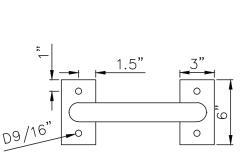


1. INSTALLATION TO BE COMPLETED IN ACCORDANCE WITH MANUFACTURER'S SPECIFICATIONS.


BICYCLE RACK DETAIL N.T.S.

MISCELLANEOUS DETAILS

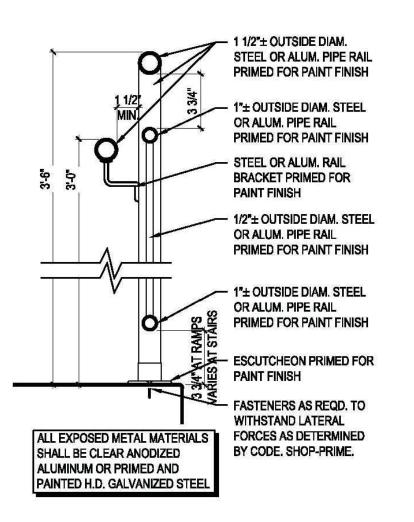


ADA RAMP HAND RAIL DETAIL

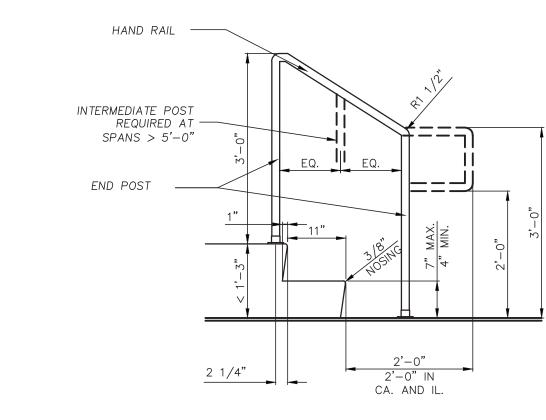


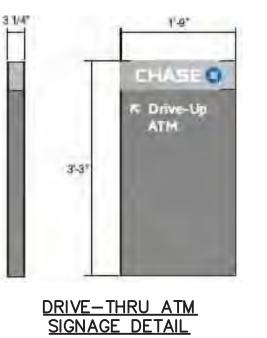


MOTORCYCLE PARKING MOTORCYCLE PARKING SIGN

HANDRAIL DETAIL

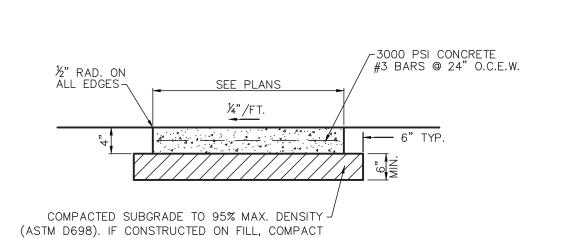

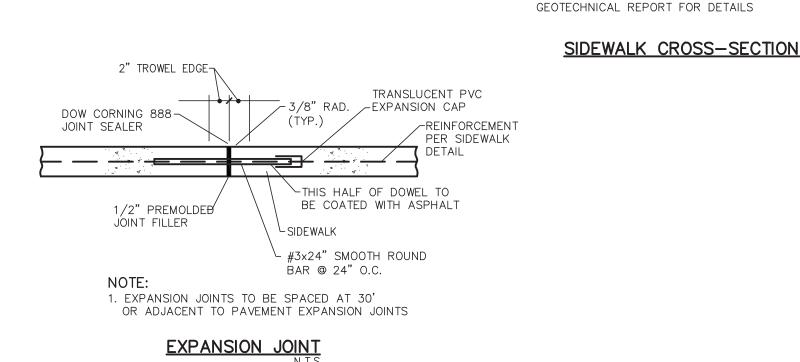

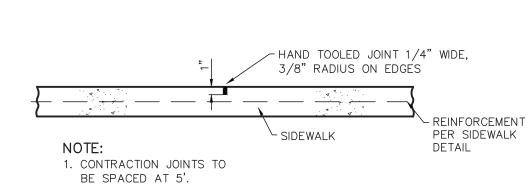

CONTRACTION JOINT

SIDEWALK DETAILS



esign

AD MEXICO

70 INDIAN - ALBUQU BERNALIL

(PRIVA)

TAIL


DRAWING SCALE

PROJECT NUMBER CDC20013

SHEET NUMBER

C13.02

\\SERVER-PC\\SERVER\\2020 CDC PROJECTS\\CDC20013 - INDIAN SCHOOL ROAD, ALBUQUERQUE\\PLANS\\DETAILS (PRIVATE) CDC20013.DWG

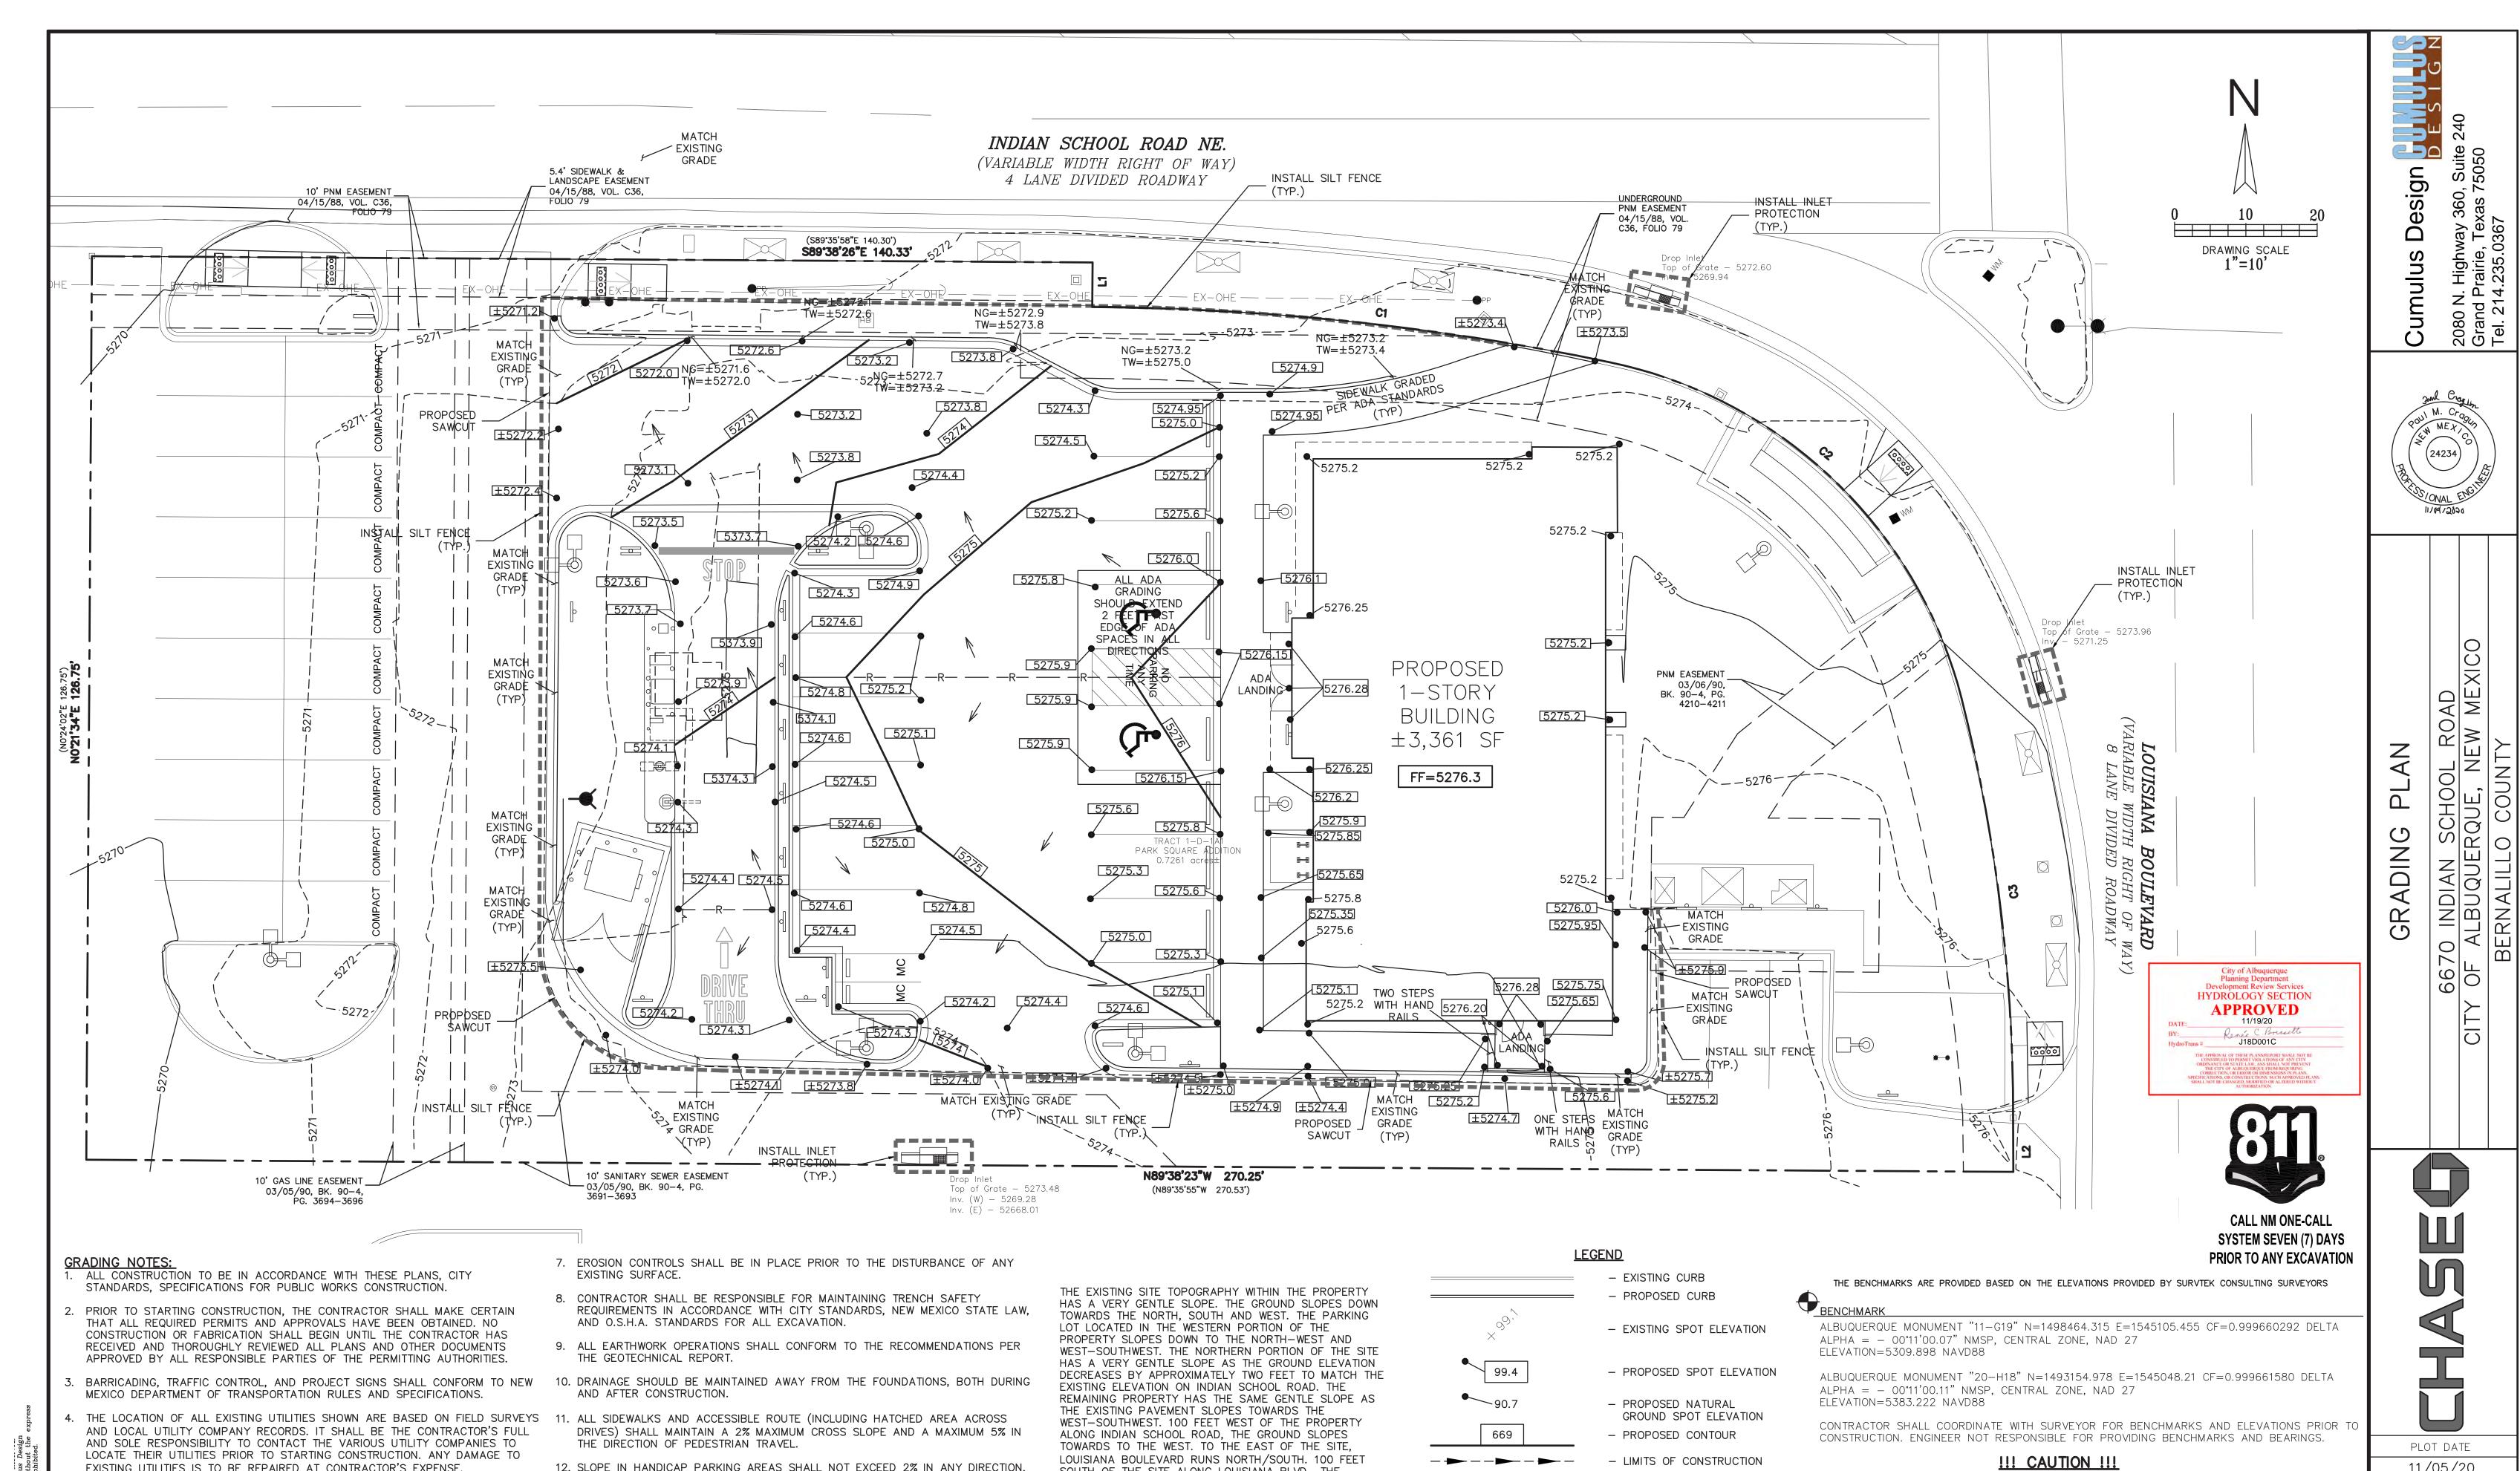

SOUTH OF THE SITE ALONG LOUISIANA BLVD., THE

THE PROPOSED CHASE BANK WILL NOT MAKE CHANGES

TO THE EXISTING GENERAL TOPOGRAPHY OF THE SITE OR

——R— —R— —R——

- PROPOSED RIDGE

INLET PROTECTION

PROPOSED SAWCUT

NATURAL GROUND

- TOP OF WALL/CURB

DIRECTIONAL FLOW ARROW

SILT FENCE

GROUND SLOPES TO THE SOUTH.

THE AREA.

11/05/20

DRAWING SCALE

1" = 10'

PROJECT NUMBER

CDC20013

SHEET NUMBER

UNDERGROUND UTILITIES

RESPONSIBILITY OF THE CONTRACTOR(S) TO VERIFY THE HORIZONTALLY AND VERTICALLY

EXISTING UTILITIES AND UNDERGROUND FACILITIES INDICATED ON THESE PLANS HAVE BEEN

LOCATED FROM REFERENCE INFORMATION SUPPLIED BY VARIOUS PARTIES. THE ENGINEER DOES

NOT ASSUME THE RESPONSIBILITY FOR THE UTILITY LOCATIONS SHOWN. IT SHALL BE THE SOLE

LOCATION OF ALL UTILITIES AND UNDERGROUND FACILITIES PRIOR TO CONSTRUCTION, TO TAKE

PRECAUTIONS IN ORDER TO PROTECT ALL FACILITIES ENCOUNTERED AND NOTIFY THE ENGINEER

OF ALL CONFLICTS OF THE WORK WITH EXISTING FACILITIES. THE CONTRACTOR SHALL PROTECT

CONTRACTOR TO UTILITIES SHALL BE REPAIRED OR REPLACED BY THE CONTRACTOR AT THEIR

AND MAINTAIN ALL UTILITIES FROM DAMAGE DURING CONSTRUCTION. ANY DAMAGE BY THE

CALL: NEW MEXICO ONE CALL @ NM 811 AT LEAST 7 DAYS PRIOR TO CONSTRUCTION.

12. SLOPE IN HANDICAP PARKING AREAS SHALL NOT EXCEED 2% IN ANY DIRECTION.

13. PROVIDE "FLAT" LANDINGS AT TOP AND BOTTOM OF ALL RAMPS. THESE "FLAT"

AREAS SHALL BE 5' LONG AND THE SLOPE SHALL NOT EXCEED 2% IN ANY

14. IT IS THE RESPONSIBILITY OF THE CONTRACTOR TO PROVIDE POSITIVE DRAINAGE

INDICATED. SURFACE WATER SHALL NOT BE RELEASED ONTO ADJACENT PRIVATE

15. SITE GRADING SHALL BE PERFORMED IN A MANNER TO DIRECT WATER AS

AWAY FROM BUILDING AND PARKING AT ALL TIMES.

DIRECTION.

PROPERTY.

ENGINEER.

EXPENSE OF THE CONTRACTOR. \\SERVER-PC\SERVER\2020 CDC PROJECTS\CDC20013 - INDIAN SCHOOL ROAD, ALBUQUERQUE\PLANS\GRADING PLAN CDC20013.DWG

EXISTING UTILITIES IS TO BE REPAIRED AT CONTRACTOR'S EXPENSE.

CONTRACTOR SHALL VERIFY ALL EXISTING INVERTS AND RIM ELEVATIONS PRIOR

BENCHMARKS HAVE BEEN PROVIDED AS A REFERENCE. IT IS THE CONTRACTOR'S

RESPONSIBILITY TO LOCATE, VERIFY, AND/OR ESTABLISH A BENCHMARKS PRIOR


SURVEY STAKES AND MARKERS FOR THE DURATION OF THE PROJECT. IF ANY

TO BE REPLACED, SUCH REPLACEMENT SHALL BE BY THE SURVEYOR AT THE

CONSTRUCTION STAKES OR MARKERS ARE LOST OR DISTURBED AND ARE NEEDED

TO CONSTRUCTION. IF CONFLICTS EXIST, THE CONTRACTOR IS TO CONTACT

TO CONSTRUCTION. IT IS THE CONTRACTOR'S RESPONSIBILITY TO PRESERVE

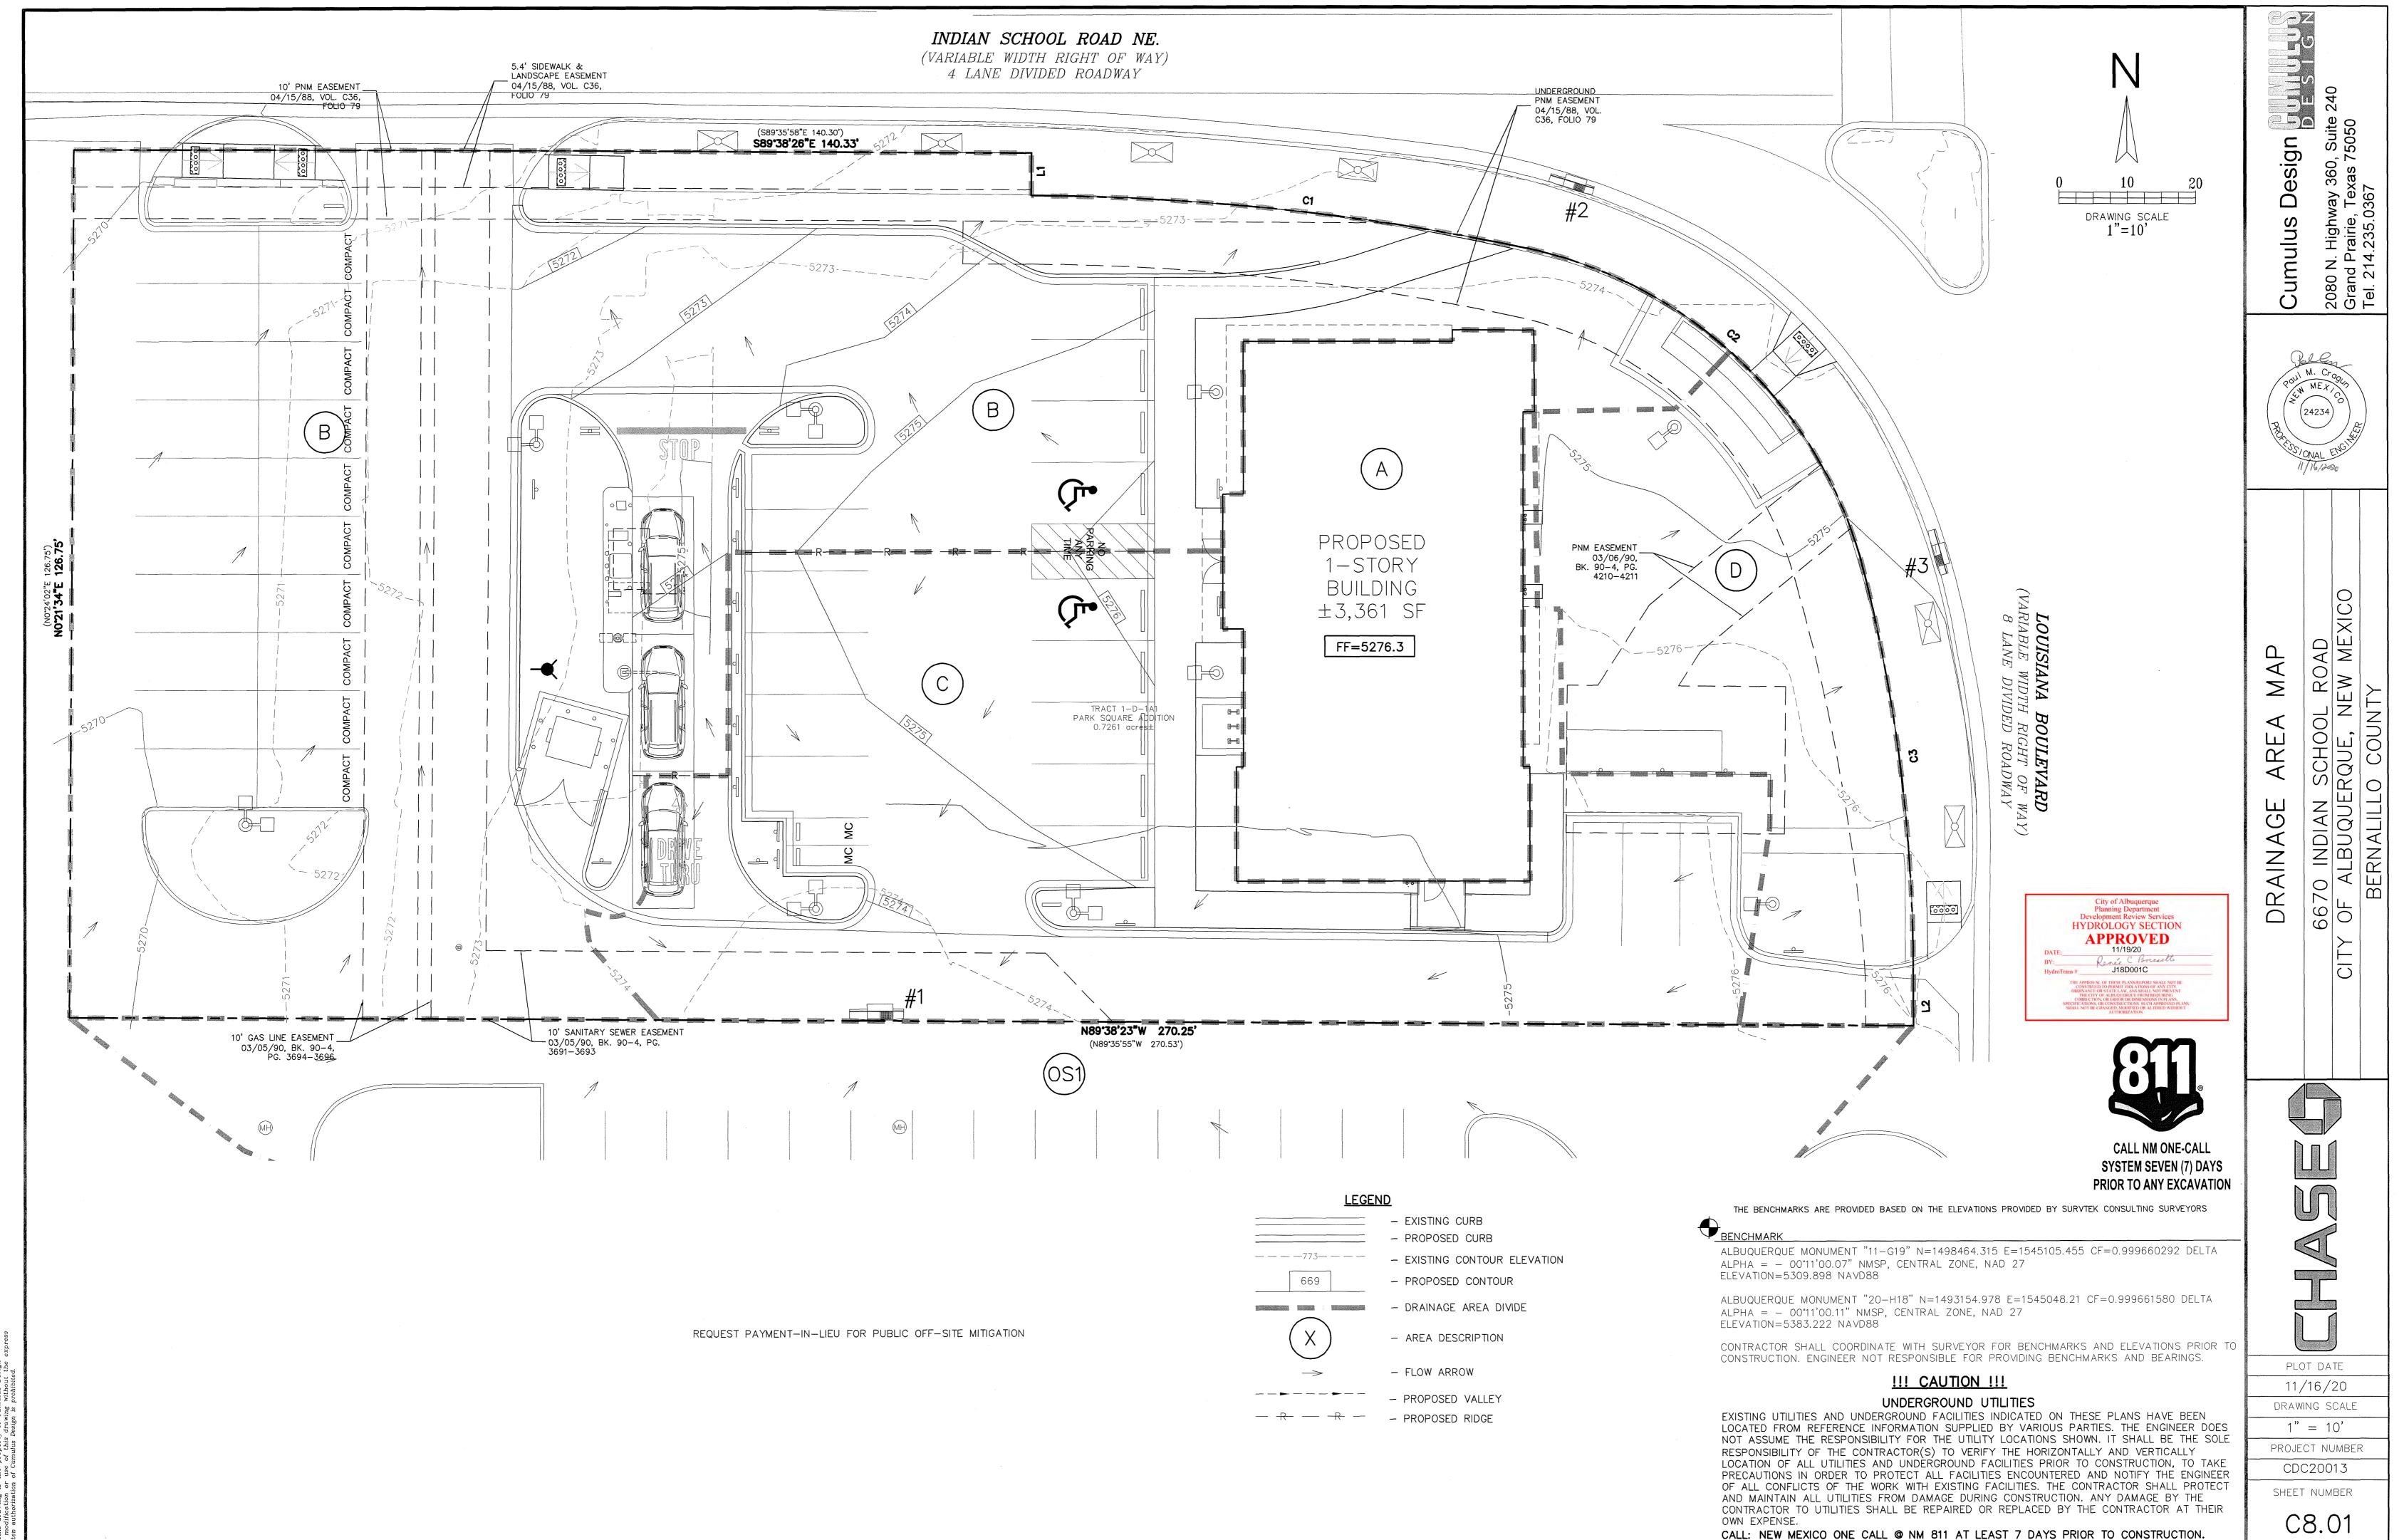

\\SERVER-PC\SERVER\2020 CDC PROJECTS\CDC20013 - INDIAN SCHOOL ROAD, ALBUQUERQUE\PLANS\PROPOSED DRAINAGE AREA MAP CDC20013.DWG

11/16/20 DRAWING SCALE

PROJECT NUMBER CDC20013

SHEET NUMBER

CALL: NEW MEXICO ONE CALL @ NM 811 AT LEAST 7 DAYS PRIOR TO CONSTRUCTION.

PROPOSED DRAINAGE DATA CHART AREA (AC.) Q10 (cfs) 1100 (in/hr) Q2 (cfs) 110 (in/hr) DRAINAGE Q100 C_2 C10 COMMENT C100 (SQ. FT.) (min) (cfs) (in/hr) ROOF DRAINS TO AREA "C" THEN TO INLET #1 3.12 4.96 0.35 3361.09 0.08 0.89 | 0.54 | 0.91 | 5.0 1.94 0.13 0.13 5.0 3.12 0.61 DRAINS TO INDIAN SCHOOL RD THEN TO INLET #2 17024.66 0.39 0.74 | 0.50 | 0.83 4.96 DRAINS TO INLET #1 0.18 | 0.81 | 0.52 | 0.87 | 5.0 3.12 4.96 7906.67 0.29 0.29 0.08 0.16 | 0.36 | 0.54 | 5.0 3.12 4.96 0.02 0.09 0.21 DRAINS TO LOUISIANA BLVD THEN TO INLET #3 0.16 | 0.36 | 0.54 | 5.0 0.05 0.20 3.12 DRAINS TO AREA "C" 0S1 7709.17 0.18 31628.23 0.73 TOTAL 1.06 1.32 3.42

CALCULATIONS ARE BASED ON THE RATIONAL METHOD FROM CITY OF ALBUQUERQUE DEVELOPMENT PROCESS MANUAL CHAPTER 6 - DRAINAGE, FLOOD CONTROL AND EROSION CONTROL. DATED 06/08/2020

DRAINAGE CRITERIA

ZONE 3 Q=C*I*A I₂=1.94 in/hr

l₁₀=3.12 in/hr l₁₀₀=4.96 in/hr tc=12 min.


			COMPOS	SITE ANA	LYSIS FOR	RUNOFF	COEFFICIE	NT			
DRAINAGE ID	PERCENT IMPERVIOUS	PERCENT PERVIOUS	C IMPERVIOUS (2 year)	C PERVIOUS (2 year)	C IMPERVIOUS (10 year)	C PERVIOUS (10 year)	C IMPERVIOUS (100 year)	C PERVIOUS (100 year)	I	COMPOSITE C (10 year)	COMPOSITE C (100 year)
А	100.0	0.0	0.89	0.08	0.54	0.34	0.91	.50	0.89	0.54	0.91
В	81.2	18.8	0.89	0.08	0.54	0.34	0.91	.50	0.74	0.50	0.83
С	90.6	9.4	0.89	0.08	0.54	0.34	0.91	.50	0.81	0.52	0.87
D	9.5	90.5	0.89	0.08	0.54	0.34	0.91	.50	0.16	0.36	0.54
OS1	9.9	90.1	0.89	0.08	0.54	0.34	0.91	.50	0.16	0.36	0.54

80TH PER	CENTILE STORMWA	TER QUALITY VOLUM	IE TABLE	
DRAINAGE ID	NEW IMPERVIOUS AREA (SQ. FT.)	REDEVELOPMENT SITE FACTOR	80TH PERCENTILE STORM VOLUME (CFS)	
А	3362.0	0.26	72.8	
В	4980.0	0.26	107.9	
С	3362.0	0.26	72.8	
D	0.0	0.26	0.0	
			253.6	

REQUEST PAYMENT-IN-LIEU FOR PUBLIC OFF-SITE MITIGATION

WEIG	SHTED ANAL	YSIS FOR 6	-HOUR EX	CESS PRECI	PITATION, 'I	Ε'	
DRAINAGE ID	LAND TREATMENT B	LAND TREATMENT D	AREA LAND TREATMENT B	AREA LAND TREATMENT D	WEIGHTED E (100 year) (IN)	VOLUME (100 year) (ACRE-FT)	
А	0.86	2.58	0.000	0.080	2.580	0.045	
В	0.86	2.58	0.073	0.317	2.257	0.008	
С	0.86	2.58	0.017	0.163	2.418	0.056	
D	0.86	2.58	0.008	0.0724	2.417	0.016	
				TOTAL \	VOLUME	0.125	



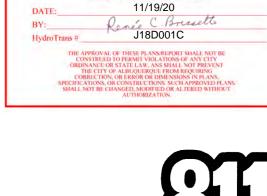

CALL NM ONE-CALL SYSTEM SEVEN (7) DAYS

PRIOR TO ANY EXCAVATION THE BENCHMARKS ARE PROVIDED BASED ON THE ELEVATIONS PROVIDED BY SURVTEK CONSULTING SURVEYORS

ALBUQUERQUE MONUMENT "11-G19" N=1498464.315 E=1545105.455 CF=0.999660292 DELTA $ALPHA = -00^{\circ}11'00.07"$ NMSP, CENTRAL ZONE, NAD 27 ELEVATION=5309.898 NAVD88

ALBUQUERQUE MONUMENT "20-H18" N=1493154.978 E=1545048.21 CF=0.999661580 DELTA ALPHA = - 00°11'00.11" NMSP, CENTRAL ZONE, NAD 27 ELEVATION=5383.222 NAVD88

CONTRACTOR SHALL COORDINATE WITH SURVEYOR FOR BENCHMARKS AND ELEVATIONS PRIOR TO CONSTRUCTION. ENGINEER NOT RESPONSIBLE FOR PROVIDING BENCHMARKS AND BEARINGS.

!!! CAUTION !!!

UNDERGROUND UTILITIES

EXISTING UTILITIES AND UNDERGROUND FACILITIES INDICATED ON THESE PLANS HAVE BEEN LOCATED FROM REFERENCE INFORMATION SUPPLIED BY VARIOUS PARTIES. THE ENGINEER DOES NOT ASSUME THE RESPONSIBILITY FOR THE UTILITY LOCATIONS SHOWN. IT SHALL BE THE SOLE RESPONSIBILITY OF THE CONTRACTOR(S) TO VERIFY THE HORIZONTALLY AND VERTICALLY LOCATION OF ALL UTILITIES AND UNDERGROUND FACILITIES PRIOR TO CONSTRUCTION, TO TAKE PRECAUTIONS IN ORDER TO PROTECT ALL FACILITIES ENCOUNTERED AND NOTIFY THE ENGINEER OF ALL CONFLICTS OF THE WORK WITH EXISTING FACILITIES. THE CONTRACTOR SHALL PROTECT AND MAINTAIN ALL UTILITIES FROM DAMAGE DURING CONSTRUCTION. ANY DAMAGE BY THE CONTRACTOR TO UTILITIES SHALL BE REPAIRED OR REPLACED BY THE CONTRACTOR AT THEIR

\\SERVER-PC\\SERVER\2020 CDC PROJECTS\CDC20013 — INDIAN SCHOOL ROAD, ALBUQUERQUE\PLANS\PROPOSED DRAINAGE AREA MAP CDC20013.DWG