
CITY OF ALBUQUERQUE

Planning Department Brennon Williams, Director

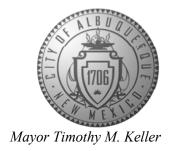

November 19, 2020

Paul Cragun, P.E. Cumulus Design 2080 N. Highway 360, Suite 240 Grand Prairie, TX 75050

RE: Chase Bank – Indian School Rd. 6670 Indian School Rd. NE Grading and Drainage Plans Engineer's Stamp Date: 11/09/20 Hydrology File: J18D001C

Dear Mr. Cragun:

PO Box 1293

Albuquerque

NM 87103

www.cabq.gov

Based upon the information provided in your submittal received 11/09/2020, the Grading and Drainage Plans are approved for Building Permit and action by the DRB on Site Plan for Building Permit.

Please attach a copy of this approved plan in the construction sets for Building Permit processing along with a copy of this letter. Prior to approval in support of Permanent Release of Occupancy by Hydrology, Engineer Certification per the DPM checklist will be required.

As a reminder, if the project total area of disturbance (including the staging area and any work within the adjacent Right-of-Way) is 1 acre or more, then an Erosion and Sediment Control (ESC) Plan and Owner's certified Notice of Intent (NOI) is required to be submitted to the Stormwater Quality Engineer (Doug Hughes, PE, jhughes@cabq.gov, 924-3420) 14 days prior to any earth disturbance.

The Payment in Lieu payment of \$2,028.80 must be paid prior to Permanent Release of Occupancy approval. Please use the attached City of Albuquerque Treasury Deposit form. Once the Owner paid the fee, please provide Hydrology with a copy of the receipt.

If you have any questions, please contact me at 924-3995 or rbrissette@cabq.gov.

Sincerely,

Renée C. Brissette, P.E. CFM Senior Engineer, Hydrology Planning Department

Renée C. Brissette




Transmittals for: PROJECTS Only

Payment-in-Lieu for Storm Water Quality Volume Requirement

CASH COUNT	AMOUNT	ACCOUNT NUMBER	FUND NUMBER	BUSINESS UNIT	PROJECT ID	ACTIVITY ID	AMOUNT
TOTAL CHECKS	\$ 2,028.80	461615	305	PCDMD	24_MS4	7547210	\$ 2,028.80
TOTAL AMOUNT						TOTAL DEPOSIT	\$ 2,028.80

Hydrology#:Name: Name: Chase Bank – Indian School	Rd.
Payment In-Lieu For Storm Water Quality Volume Requirement	
Address/Legal 6670 Indian School Rd. NE Description:	
DEPARTMENT NAME: Planning Department/Development Review Services, Hydrology	
PREPARED BY Renée C. Brissette, P.E. CFM PHONE 505-924-3995	
BUSINESS DATE November 19, 2020	
DUAL VERIFICATION OF DEPOSIT Renée C. Brissette EMPLOYEE SIGNATURE	
AND BY EMPLOYEE SIGNATURE	
LIVIT LOTEL GIGINATORE	
REMITTER:	
AMOUNT:	
BANK:	
CHECK #: DATE ON CHECK:	

The Payment-in-Lieu can be paid at the Plaza del Sol Treasury, 600 2nd St. NW. **Bring three copies of this invoice to the Treasury** and provide a copy of the receipt to Hydrology, Suite 201, 600 2nd St. NW, or e-mail with the Hydrology submittal to PLNDRS@cabq.gov.

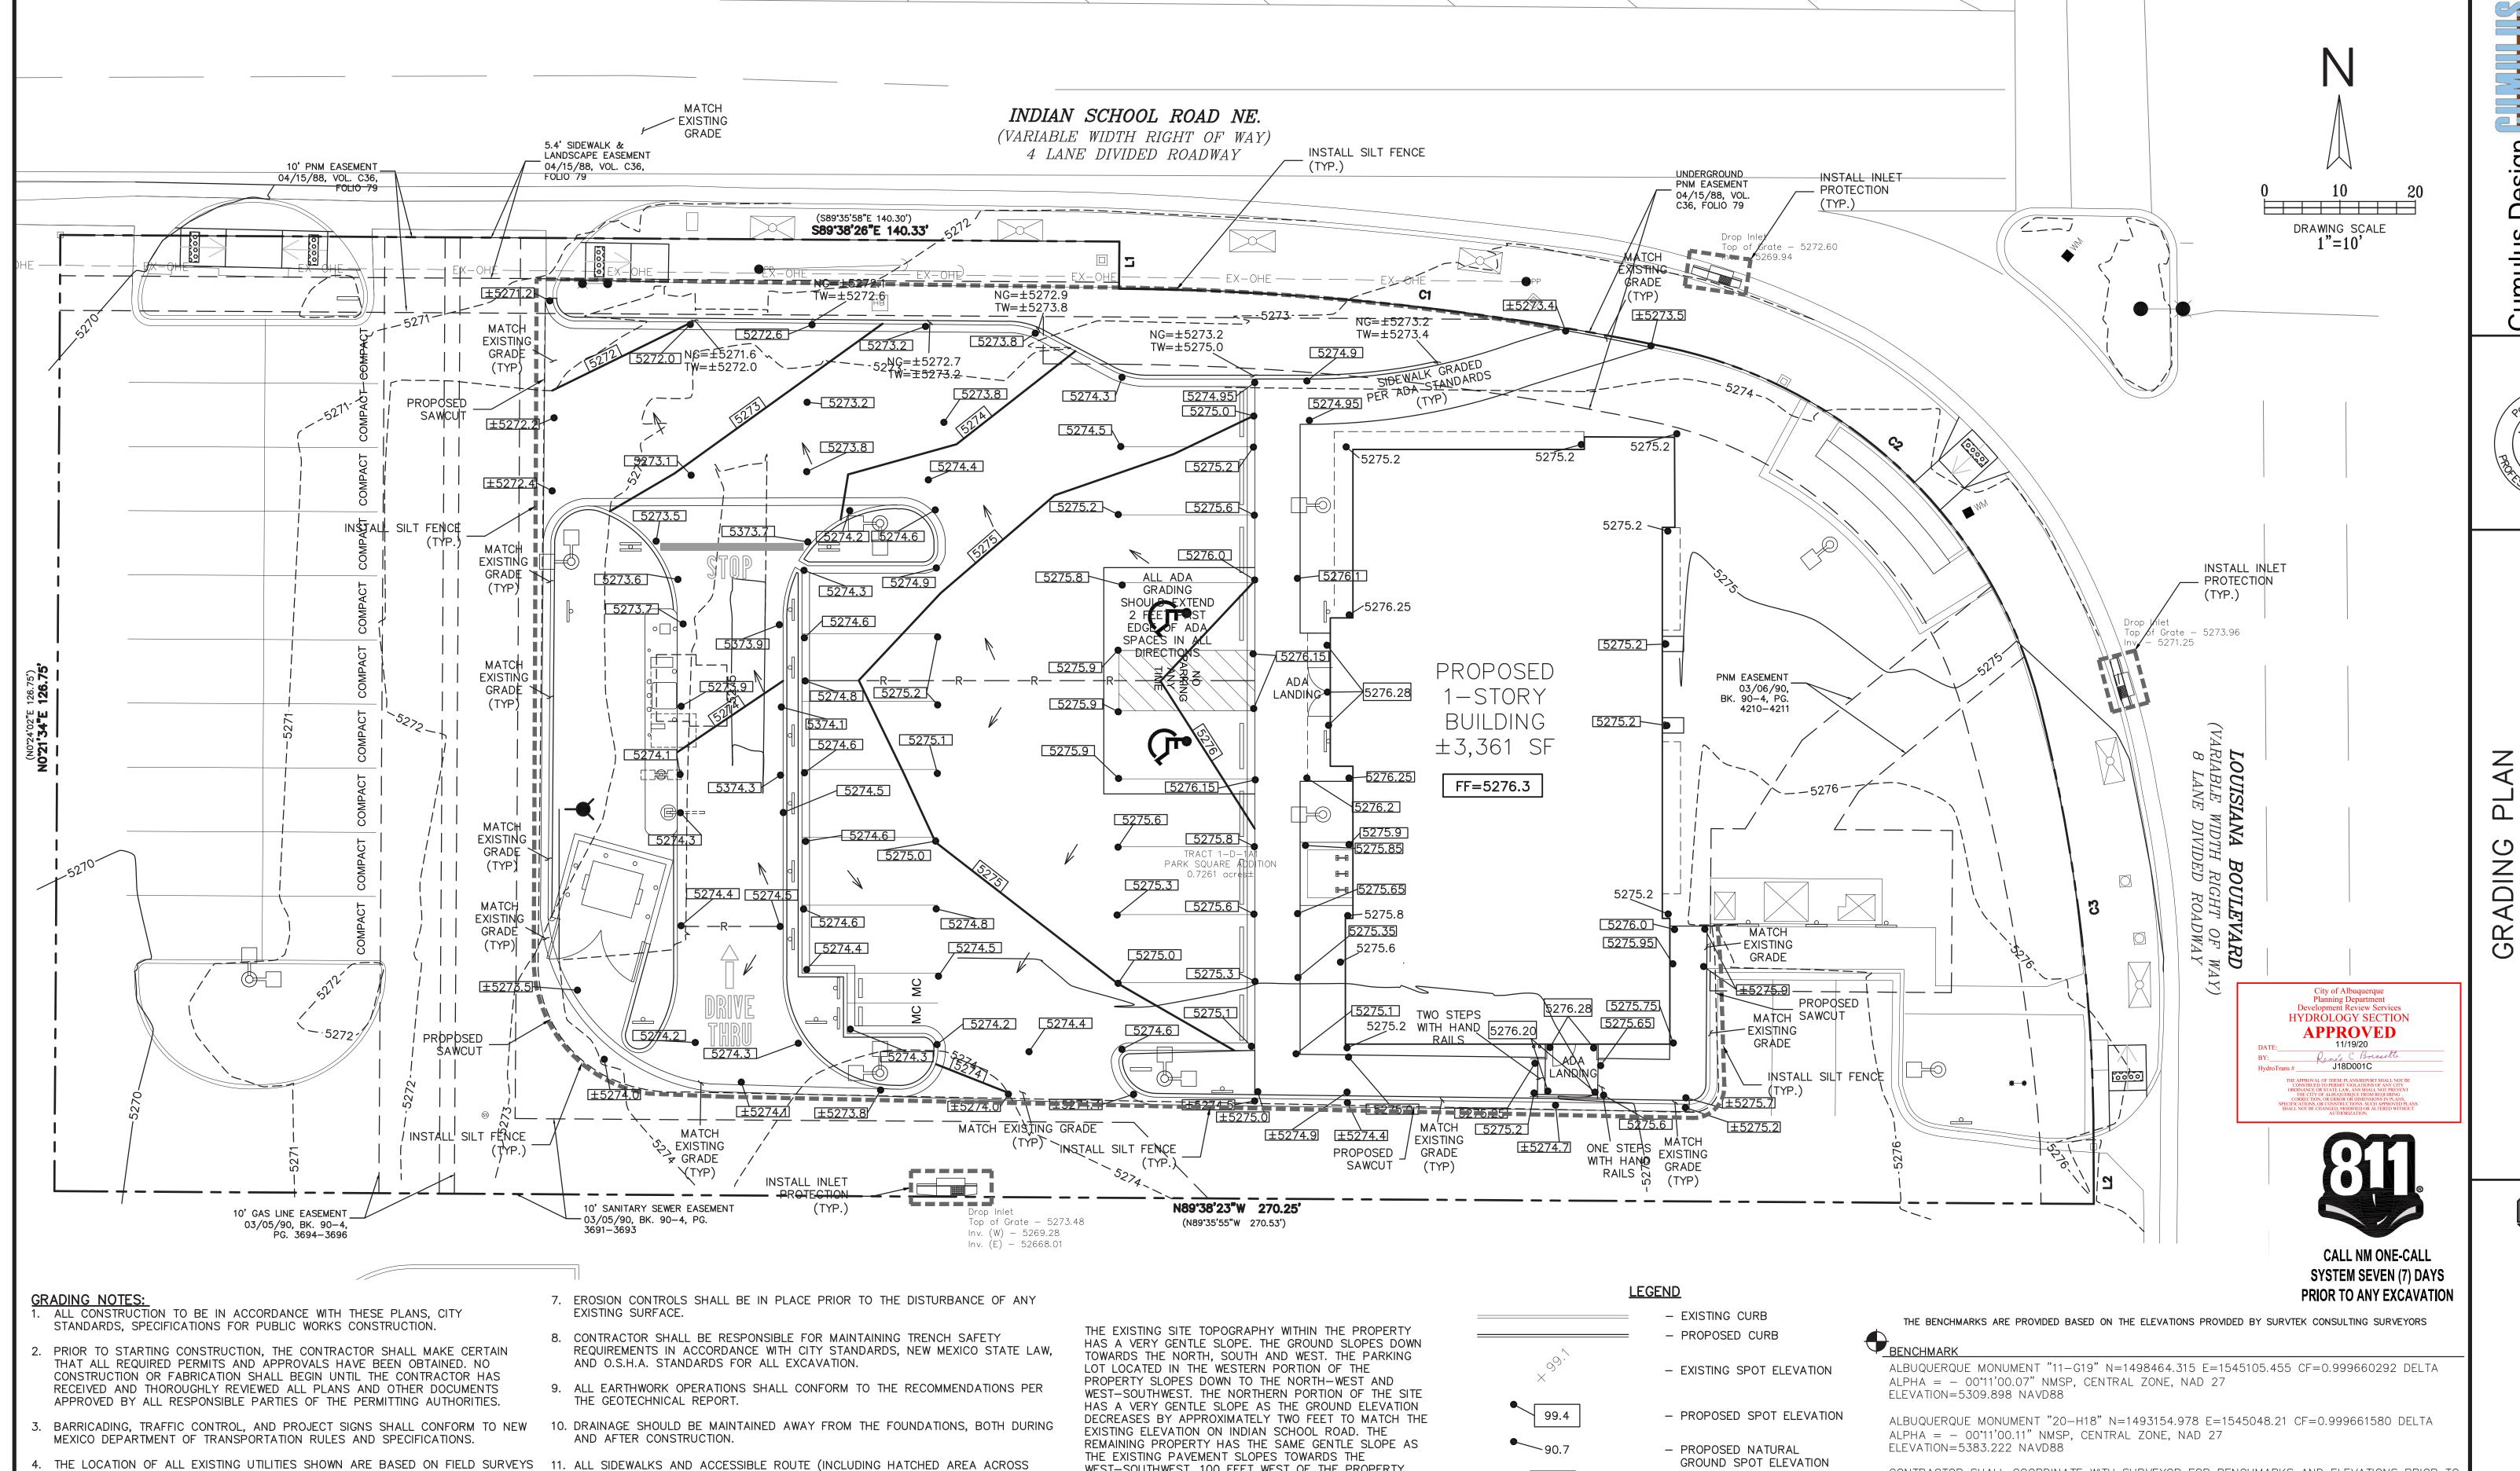

ENGINEER.

EXPENSE OF THE CONTRACTOR.

BENCHMARKS HAVE BEEN PROVIDED AS A REFERENCE. IT IS THE CONTRACTOR'S RESPONSIBILITY TO LOCATE, VERIFY, AND/OR ESTABLISH A BENCHMARKS PRIOR

AND LOCAL UTILITY COMPANY RECORDS. IT SHALL BE THE CONTRACTOR'S FULL

AND SOLE RESPONSIBILITY TO CONTACT THE VARIOUS UTILITY COMPANIES TO

LOCATE THEIR UTILITIES PRIOR TO STARTING CONSTRUCTION. ANY DAMAGE TO

CONTRACTOR SHALL VERIFY ALL EXISTING INVERTS AND RIM ELEVATIONS PRIOR

TO CONSTRUCTION. IF CONFLICTS EXIST, THE CONTRACTOR IS TO CONTACT

EXISTING UTILITIES IS TO BE REPAIRED AT CONTRACTOR'S EXPENSE.

TO CONSTRUCTION. IT IS THE CONTRACTOR'S RESPONSIBILITY TO PRESERVE SURVEY STAKES AND MARKERS FOR THE DURATION OF THE PROJECT. IF ANY CONSTRUCTION STAKES OR MARKERS ARE LOST OR DISTURBED AND ARE NEEDED TO BE REPLACED, SUCH REPLACEMENT SHALL BE BY THE SURVEYOR AT THE

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DRIVES) SHALL MAINTAIN A 2% MAXIMUM CROSS SLOPE AND A MAXIMUM 5% IN THE DIRECTION OF PEDESTRIAN TRAVEL.

12. SLOPE IN HANDICAP PARKING AREAS SHALL NOT EXCEED 2% IN ANY DIRECTION.

13. PROVIDE "FLAT" LANDINGS AT TOP AND BOTTOM OF ALL RAMPS. THESE "FLAT" AREAS SHALL BE 5' LONG AND THE SLOPE SHALL NOT EXCEED 2% IN ANY DIRECTION.

14. IT IS THE RESPONSIBILITY OF THE CONTRACTOR TO PROVIDE POSITIVE DRAINAGE AWAY FROM BUILDING AND PARKING AT ALL TIMES.

15. SITE GRADING SHALL BE PERFORMED IN A MANNER TO DIRECT WATER AS INDICATED. SURFACE WATER SHALL NOT BE RELEASED ONTO ADJACENT PRIVATE PROPERTY.

WEST-SOUTHWEST. 100 FEET WEST OF THE PROPERTY ALONG INDIAN SCHOOL ROAD, THE GROUND SLOPES TOWARDS TO THE WEST. TO THE EAST OF THE SITE, LOUISIANA BOULEVARD RUNS NORTH/SOUTH. 100 FEET SOUTH OF THE SITE ALONG LOUISIANA BLVD., THE GROUND SLOPES TO THE SOUTH. THE PROPOSED CHASE BANK WILL NOT MAKE CHANGES TO THE EXISTING GENERAL TOPOGRAPHY OF THE SITE OR

THE AREA.

669 PROPOSED CONTOUR ——R——R——R—— - PROPOSED RIDGE ______ PROPOSED SAWCUT _____

GROUND SPOT ELEVATION

LIMITS OF CONSTRUCTION

SILT FENCE

INLET PROTECTION

DIRECTIONAL FLOW ARROW

 NATURAL GROUND - TOP OF WALL/CURB

CONTRACTOR SHALL COORDINATE WITH SURVEYOR FOR BENCHMARKS AND ELEVATIONS PRIOR TO CONSTRUCTION. ENGINEER NOT RESPONSIBLE FOR PROVIDING BENCHMARKS AND BEARINGS.

LOCATED FROM REFERENCE INFORMATION SUPPLIED BY VARIOUS PARTIES. THE ENGINEER DOES NOT ASSUME THE RESPONSIBILITY FOR THE UTILITY LOCATIONS SHOWN. IT SHALL BE THE SOLE LOCATION OF ALL UTILITIES AND UNDERGROUND FACILITIES PRIOR TO CONSTRUCTION, TO TAKE PRECAUTIONS IN ORDER TO PROTECT ALL FACILITIES ENCOUNTERED AND NOTIFY THE ENGINEER OF ALL CONFLICTS OF THE WORK WITH EXISTING FACILITIES. THE CONTRACTOR SHALL PROTECT CONTRACTOR TO UTILITIES SHALL BE REPAIRED OR REPLACED BY THE CONTRACTOR AT THEIR

CALL: NEW MEXICO ONE CALL @ NM 811 AT LEAST 7 DAYS PRIOR TO CONSTRUCTION.

!!! CAUTION !!!

UNDERGROUND UTILITIES EXISTING UTILITIES AND UNDERGROUND FACILITIES INDICATED ON THESE PLANS HAVE BEEN RESPONSIBILITY OF THE CONTRACTOR(S) TO VERIFY THE HORIZONTALLY AND VERTICALLY AND MAINTAIN ALL UTILITIES FROM DAMAGE DURING CONSTRUCTION. ANY DAMAGE BY THE

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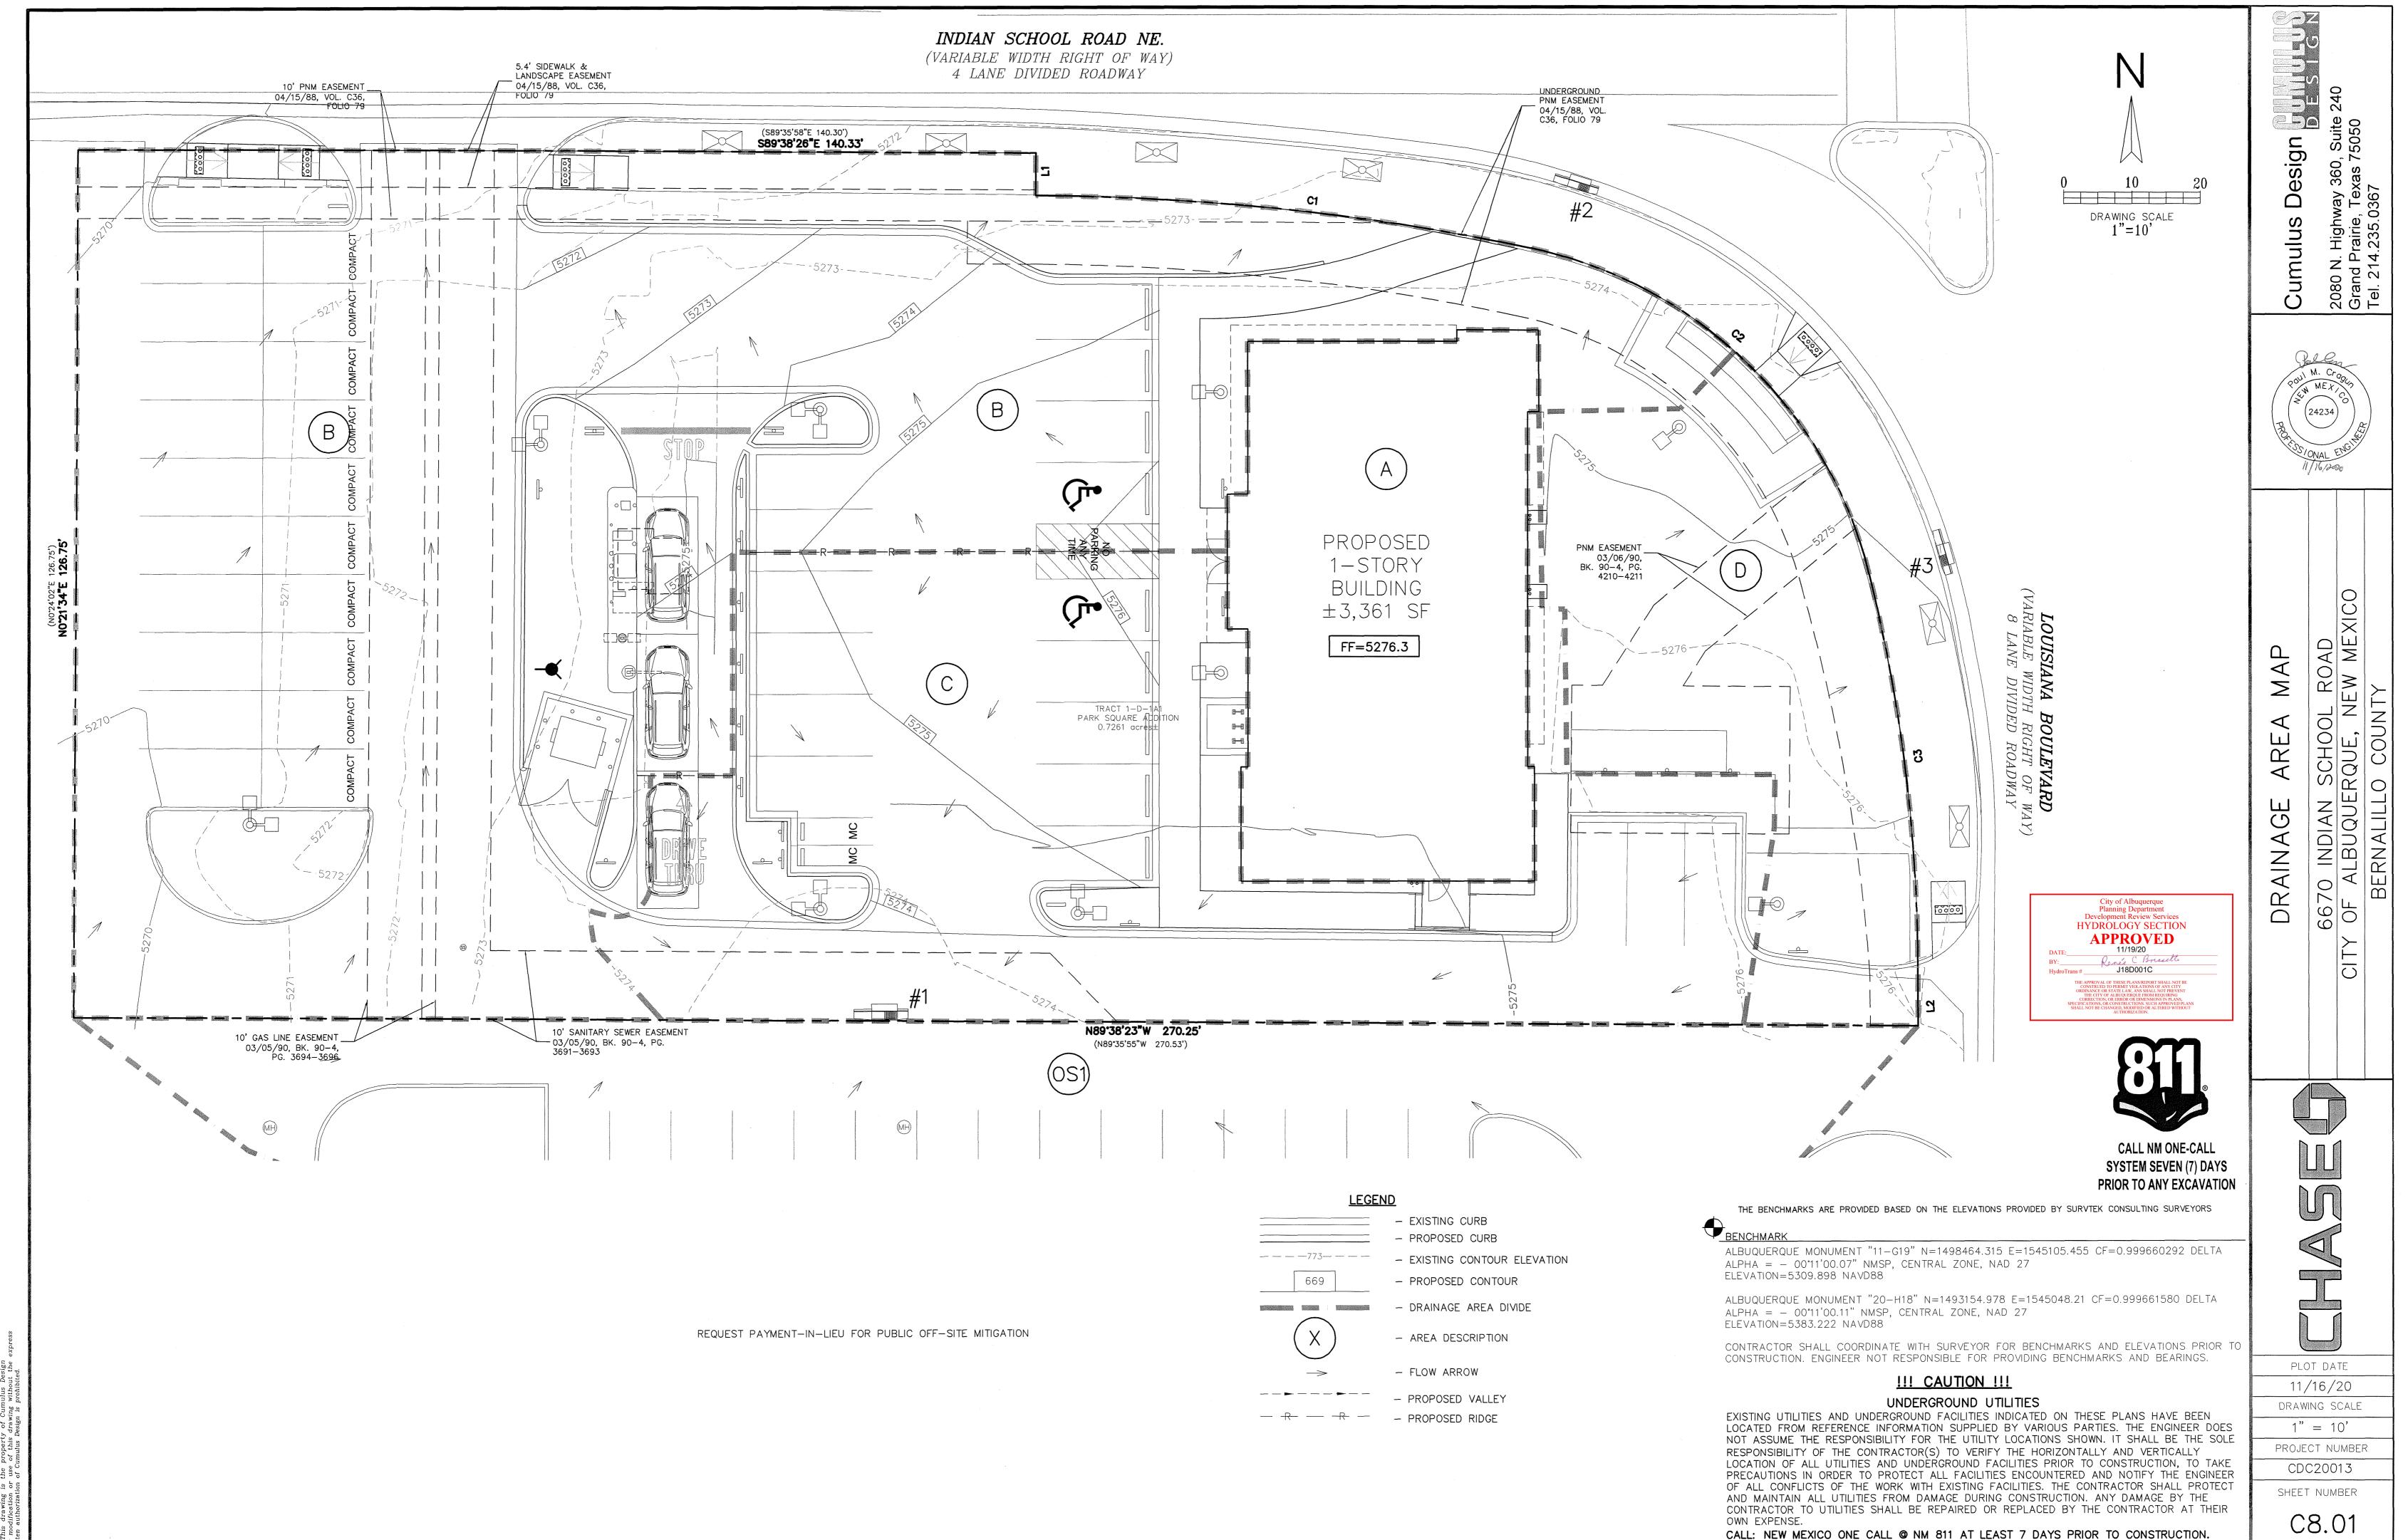
O INE ALBU SERN

PLOT DATE 11/05/20

DRAWING SCALE 1" = 10'

PROJECT NUMBER CDC20013

SHEET NUMBER



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11/16/20 DRAWING SCALE

PROJECT NUMBER

CDC20013 SHEET NUMBER

			·										
							PROPOS	SED DRA	AINAGE	DATA	CHART		
DRAINAGE ID	AREA (SQ. FT.)	AREA (AC.)	C2	C10	C100	Tc (min)	12 (in/hr)	10 (in/hr)	1100 (in/hr)	Q2 (cfs)	Q10 (cfs)	Q100 (cfs)	COMMENT
А	3361.09	0.08	0.89	0.54	0.91	5.0	1.94	3.12	4.96	0.13	0.13	0.35	ROOF DRAINS TO AREA "C" THEN TO INLET #1
В	17024.66	0.39	0.74	0.50	0.83	5.0	1.94	3.12	4.96	0.56	0.61	1.61	DRAINS TO INDIAN SCHOOL RD THEN TO INLET #2
С	7906.67	0.18	0.81	0.52	0.87	5.0	1.94	3.12	4.96	0.29	0.29	0.78	DRAINS TO INLET #1
D	3335.81	0.08	0.16	0.36	0.54	5.0	1.94	3.12	4.96	0.02	0.09	0.21	DRAINS TO LOUISIANA BLVD THEN TO INLET #3
0S1	7709.17	0.18	0.16	0.36	0.54	5.0	1.94	3.12	4.96	0.05	0.20	0.47	DRAINS TO AREA "C"
TOTAL	31628.23	0.73								1.06	1.32	3.42	

CALCULATIONS ARE BASED ON THE RATIONAL METHOD FROM CITY OF ALBUQUERQUE DEVELOPMENT PROCESS MANUAL CHAPTER 6 - DRAINAGE, FLOOD CONTROL AND EROSION CONTROL. DATED 06/08/2020

DRAINAGE CRITERIA

ZONE 3 Q=C*I*A I₂=1.94 in/hr


l₁₀=3.12 in/hr l₁₀₀=4.96 in/hr tc=12 min.

			COMPOS	SITE ANA	LYSIS FOF	RUNOFF	COEFFICIE	NT			
DRAINAGE ID	PERCENT IMPERVIOUS	PERCENT PERVIOUS	C IMPERVIOUS (2 year)	C PERVIOUS (2 year)	C IMPERVIOUS (10 year)	C PERVIOUS (10 year)	C IMPERVIOUS (100 year)	C PERVIOUS (100 year)		COMPOSITE C (10 year)	COMPOSITE C (100 year)
А	100.0	0.0	0.89	0.08	0.54	0.34	0.91	.50	0.89	0.54	0.91
В	81.2	18.8	0.89	0.08	0.54	0.34	0.91	.50	0.74	0.50	0.83
С	90.6	9.4	0.89	0.08	0.54	0.34	0.91	.50	0.81	0.52	0.87
D	9.5	90.5	0.89	0.08	0.54	0.34	0.91	.50	0.16	0.36	0.54
OS1	9.9	90.1	0.89	0.08	0.54	0.34	0.91	.50	0.16	0.36	0.54

80TH PER	CENTILE STORMWA	TER QUALITY VOLUM	IE TABLE
DRAINAGE ID	NEW IMPERVIOUS AREA (SQ. FT.)	REDEVELOPMENT SITE FACTOR	80TH PERCENTILE STORM VOLUME (CFS)
А	3362.0	0.26	72.8
В	4980.0	0.26	107.9
С	3362.0	0.26	72.8
D	0.0	0.26	0.0
			253.6

REQUEST PAYMENT-IN-LIEU FOR PUBLIC OFF-SITE MITIGATION

WEIG	SHTED ANAL	YSIS FOR 6	-HOUR EX	CESS PRECI	PITATION, 'I	Ε'
DRAINAGE ID	LAND TREATMENT B	LAND TREATMENT D	AREA LAND TREATMENT B	AREA LAND TREATMENT D	WEIGHTED E (100 year) (IN)	VOLUME (100 year) (ACRE-FT)
А	0.86	2.58	0.000	0.080	2.580	0.045
В	0.86	2.58	0.073	0.317	2.257	0.008
С	0.86	2.58	0.017	0.163	2.418	0.056
D	0.86	2.58	0.008	0.0724	2.417	0.016
				TOTAL	VOLUME	0.125

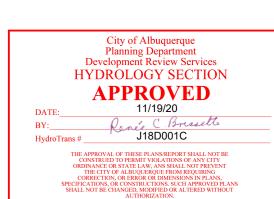



CALL NM ONE-CALL SYSTEM SEVEN (7) DAYS

PRIOR TO ANY EXCAVATION THE BENCHMARKS ARE PROVIDED BASED ON THE ELEVATIONS PROVIDED BY SURVTEK CONSULTING SURVEYORS

ALBUQUERQUE MONUMENT "11-G19" N=1498464.315 E=1545105.455 CF=0.999660292 DELTA $ALPHA = -00^{\circ}11'00.07"$ NMSP, CENTRAL ZONE, NAD 27 ELEVATION=5309.898 NAVD88

ALBUQUERQUE MONUMENT "20-H18" N=1493154.978 E=1545048.21 CF=0.999661580 DELTA ALPHA = - 00°11'00.11" NMSP, CENTRAL ZONE, NAD 27 ELEVATION=5383.222 NAVD88

CONTRACTOR SHALL COORDINATE WITH SURVEYOR FOR BENCHMARKS AND ELEVATIONS PRIOR TO CONSTRUCTION. ENGINEER NOT RESPONSIBLE FOR PROVIDING BENCHMARKS AND BEARINGS.

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