
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DEKKER PERICH SABATINI

6000 FOREST HILLS D ALBUQUERQUE, N

ADMINISTRATIVE AMENDMENT

02/25/2021

20-0023

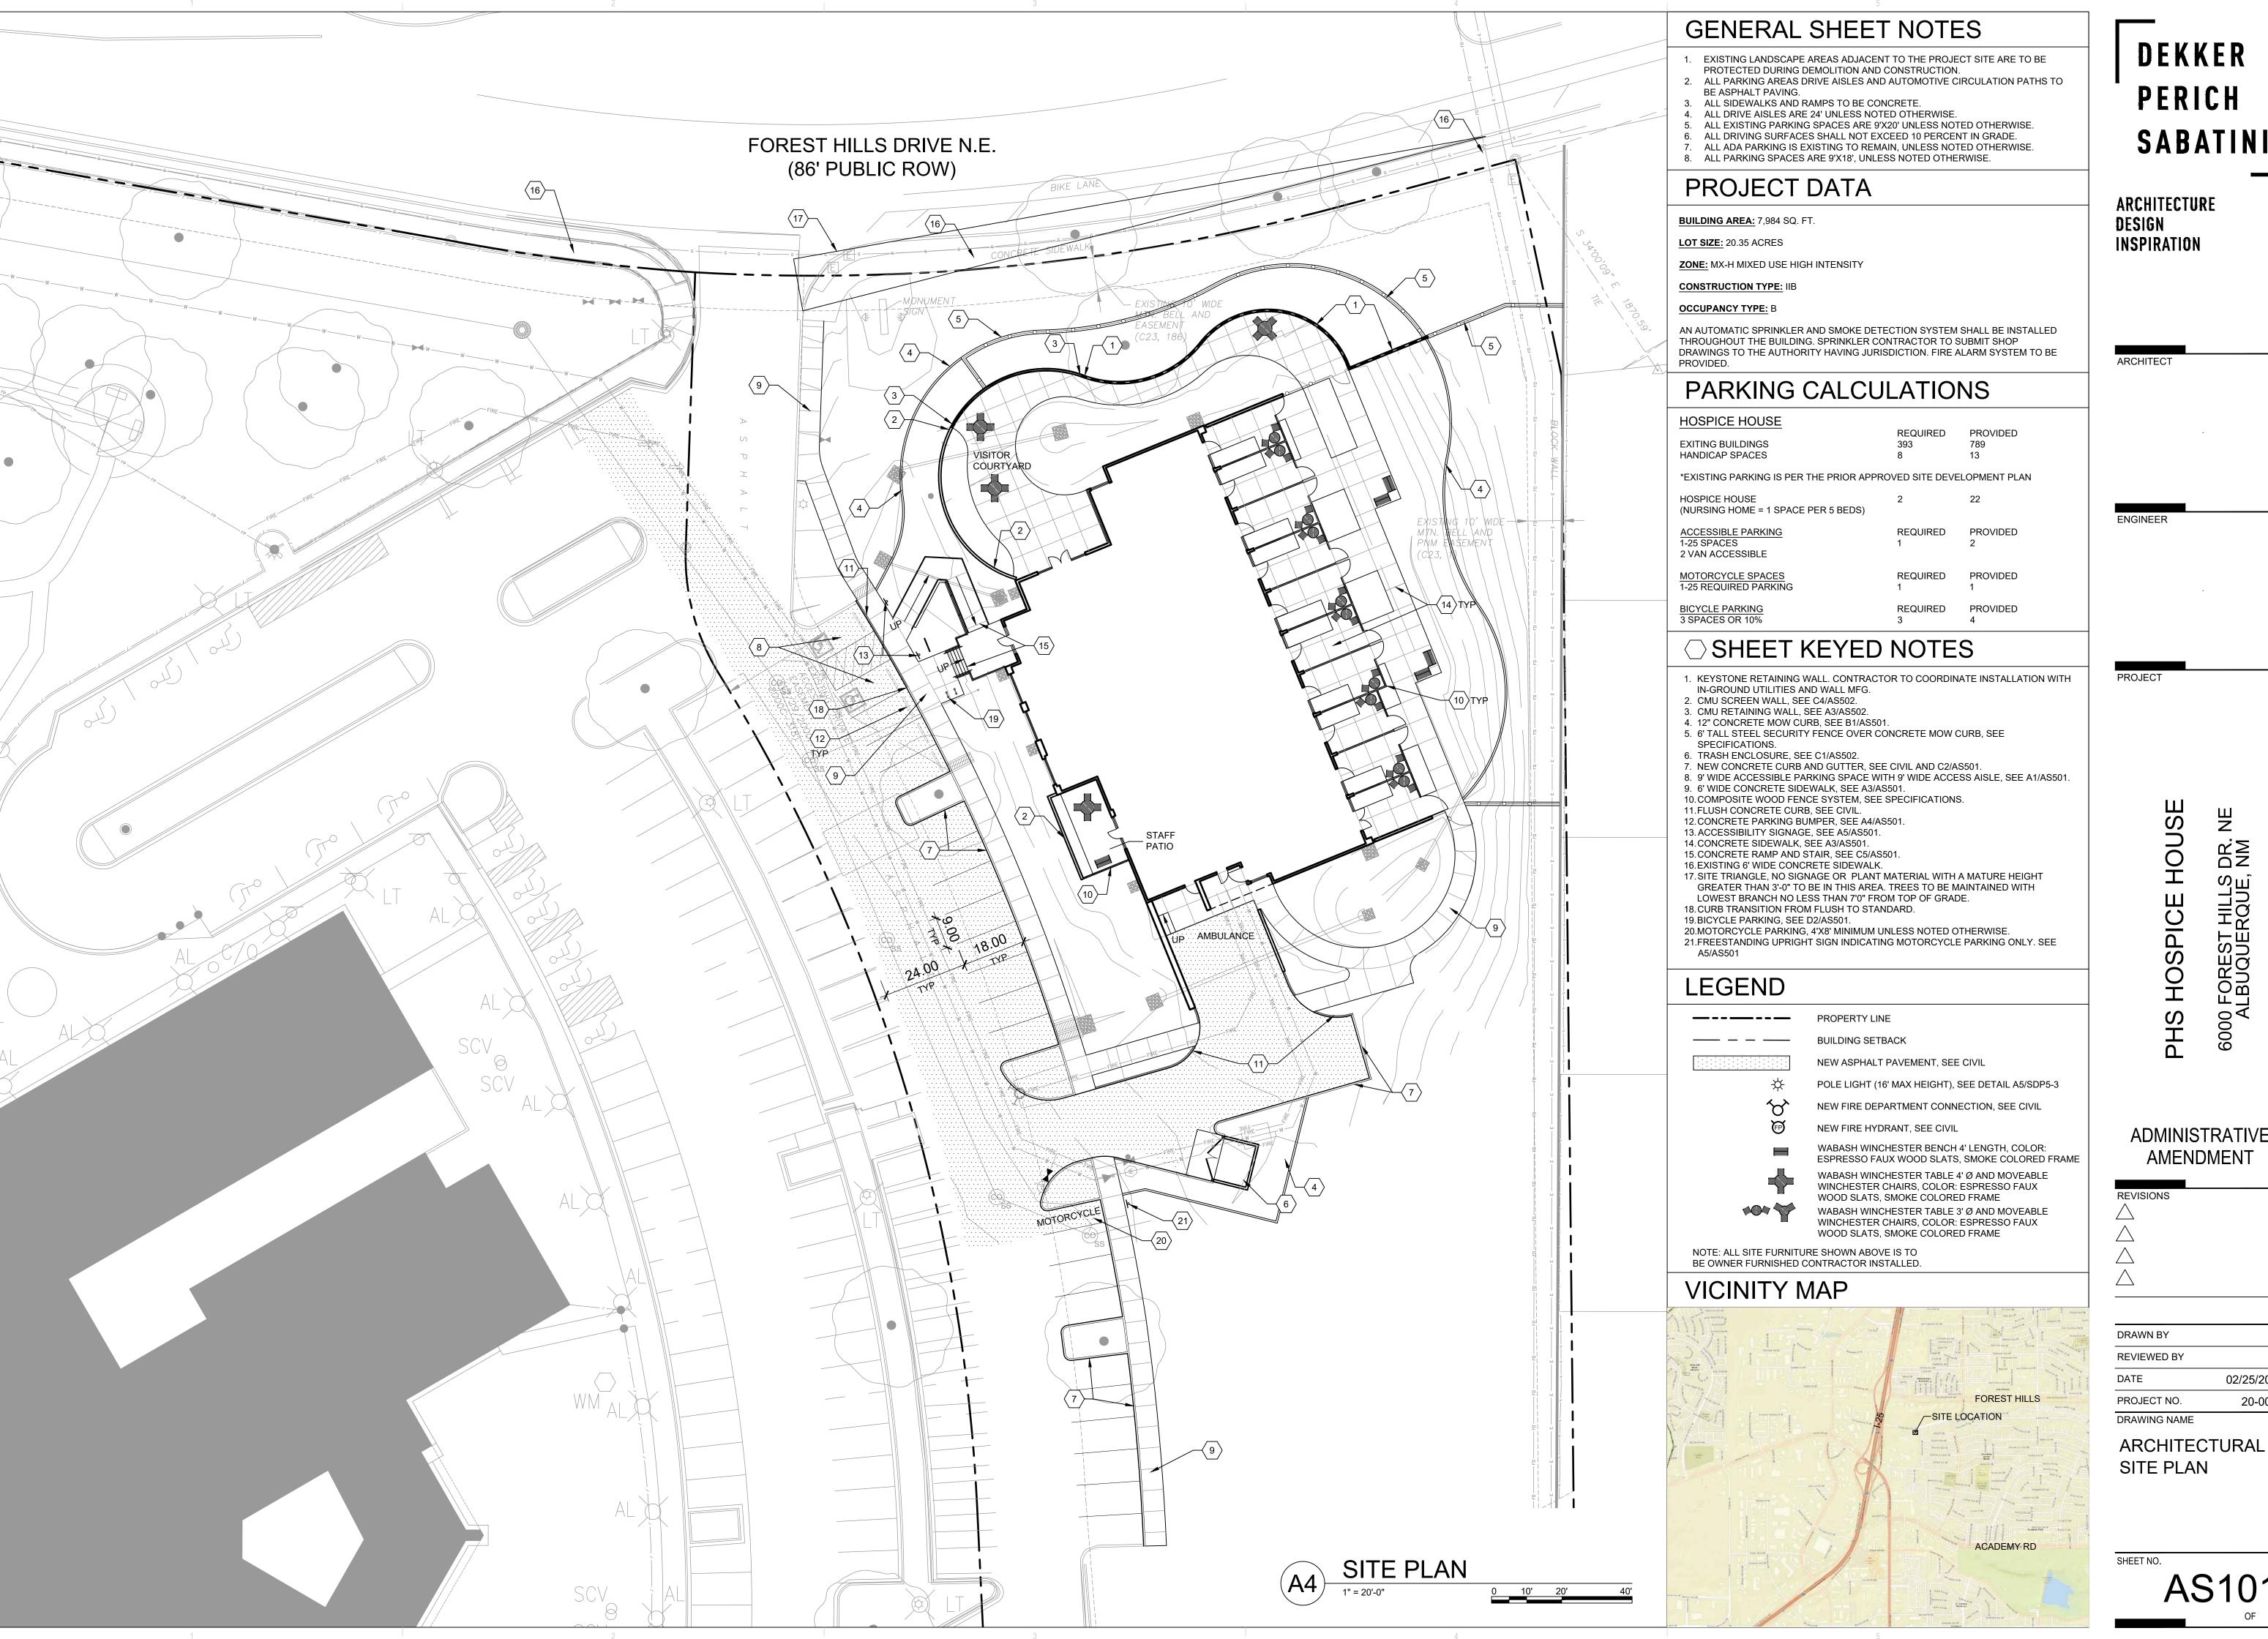

GRADING KEYED NOTES

- INSTALL HDPE (N12WT OR APPROVED EQUAL) STORM DRAIN PIPE. SEE PLAN FOR SIZE AND
- 2. GRASS LANDSCAPED SWALE. SEE LANDSCAPE PLAN FOR STABILIZATION.
- INSTALL 24" SIDEWALK CULVERT PER COA STD DWG 2236.
- 4. INSTALL CURB OPENING PER DETAIL B2 SHEET C-201
- 5. RETAINING WALL. SEE STRUCTURAL PLAN FOR DETAILS.
- 6. INSTALL RIP RAP PAD PER DETAIL A2 SHEET C-201.
- INSTALL 10" NYLOPLAST STORM DRAIN INLET WITH DOME GRATE.
- 8. INSTALL 2-24' SIDEWALK CULVERTS PER COA STD DWG 2236.
- 9. DEPRESS LANDSCAPE AREA TO PROVIDED POSITIVE DRAINAGE FROM ROOF DRAIN OUTLET TO SIDEWALK CULVERT.
- 10. CENTER RIP RAP PAD ON ROOF DRAIN OUTFALL.
- INSTALL TURNBLOCK IN WALL.
- 12. CURB TRANSITION, SEE PAVING PLAN.

HDPE PIPE AND FITTINGS SHALL BE INSTALLED AND BACKFILLED PER MANUFACTURER SPECIFICATIONS. CONNECTIONS TO CONCRETE MANHOLES AND CONCRETE DROP INLETS SHALL USE WATER STOP GASKETS AND SHALL BE INSTALLED PER MANUFACTURER'S SPECIFICATIONS

SIDEWALK CROSS-SLOPES SHALL BE AT A MINIMUM OF 1.0% AND A MAXIMUM OF 2.0%

CONTRACTOR SHALL PROVIDE AS-BUILT GRADING INFORMATION STAMPED BY A PROFESSIONAL SURVEYOR. AS-BUILT INFORMATION REQUIRED SHALL BE COORDINATED WITH THE ENGINEER AND SHALL BE SUFFICIENTLY DETAILED TO VERIFY THAT THE DRAINAGE WILL FUNCTION IN ACCORDANCE WITH THE DESIGN. AS-BUILT DATA SHALL BE PROVIDED AT LEAST 5 WORKING DAYS PRIOR TO CONTRACTOR'S REQUEST FOR PERMANENT CERTIFICATE OF OCCUPANCY. AT A MINIMUM, AS-BUILT DATA SHALL INCLUDE:

- ALL GRATES AND INVERTS OF CATCH BASINS APPROXIMATELY 75% OF ALL DESIGN SPOT ELEVATIONS & FINISHED
- FLOOR ELEVATIONS.

LEGEND

—— — — LIMITS OF GRADING PROPERTY LINE

PROPOSED SPOT ELEVATION TC=TOP OF CURB FL=FLOW LINE

TOC=TOP OF CONCRETE TS=TOP OF SIDEWALK TG=TOP OF GRATE FG=FINISHED GRADE FGH=FINISHED GRADE HIGH FGL=FINISHED GRADE LOW INV=INVERT

EXISTING INDEX CONTOUR

EXISTING INTERMEDIATE CONTOUR


WATER BLOCK/GRADE BREAK -->>-PROPOSED STORM DRAIN MANHOLE



PROPOSED STORM DRAIN INLETS

DIRECTION OF FLOW

PROPOSED STORM DRAIN CAP

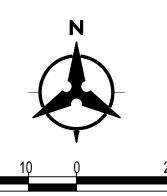

1"=20' ON 24"X36" SHEET

GRADING GENERAL NOTES

PROPERTY OR PUBLIC RIGHT-OF-WAY.

- EXCEPT AS PROVIDED HEREIN, GRADING SHALL BE PERFORMED AT THE ELEVATIONS AND IN ACCORDANCE WITH THE DETAILS SHOWN ON THIS PLAN.
- THE COST FOR REQUIRED CONSTRUCTION DUST AND EROSION CONTROL MEASURES SHALL BE
- INCIDENTAL TO THE PROJECT COST, AND INCLUDED IN THE GMP.
- IT IS THE INTENT OF THESE PLANS THAT THIS CONTRACTOR SHALL NOT PERFORM ANY WORK

EARTH SLOPES SHALL NOT EXCEED 3 HORIZONTAL TO 1 VERTICAL UNLESS SHOWN OTHERWISE

- OUTSIDE OF THE PROPERTY BOUNDARIES EXCEPT AS REQUIRED BY THIS PLAN. THE CONTRACTOR SHALL ENSURE THAT NO SOIL ERODES FROM THE SITE ONTO ADJACENT
- A DISPOSAL SITE FOR ANY & ALL EXCESS EXCAVATION MATERIAL, AND UNSUITABLE MATERIAL AND/OR A BORROW SITE CONTAINING ACCEPTABLE FILL MATERIAL SHALL BE OBTAINED BY THE CONTRACTOR IN COMPLIANCE WITH APPLICABLE ENVIRONMENTAL REGULATIONS AND APPROVED BY THE INSPECTOR. ALL COSTS INCURRED IN OBTAINING A DISPOSAL OR BORROW SITE AND HAUL TO OR FROM SHALL BE CONSIDERED INCIDENTAL TO THE PROJECT AND NO SEPARATE MEASUREMENT OR PAYMENT SHALL BE MADE.
- PAVING AND ROADWAY GRADES SHALL BE +/-0.1' FROM PLAN ELEVATIONS. PAD ELEVATION SHALL BE +/-0.05' FROM BUILDING PLAN ELEVATION.
- ALL PROPOSED CONTOURS REFLECT TOP OF PAVEMENT ELEVATIONS IN THE PARKING AREA AND MUST BE ADJUSTED FOR MEDIANS AND ISLANDS.
- VERIFY ALL ELEVATIONS SHOWN ON PLAN FROM BASIS OF ELEVATION CONTROL STATION PRIOR TO BEGINNING CONSTRUCTION.
- THE CONTRACTOR SHALL PROVIDE AS-BUILTS SURVEY DATA TO ENSURE COMPLIANCE WITH THE CONSTRUCTION DOCUMENTS. THE SURVEY SHALL BE PERFORMED BY A PROFESSIONAL SURVEYOR LICENSED IN THE THE STATE OF NEW MEXICO. THE AS-BUILT DRAWING SHALL BE CERTIFIED BY THE SURVEYOR OF RECORD.

GENERAL NOTES

- ALL WORK DETAILED ON THESE PLANS AND PERFORMED UNDER THIS CONTRACT SHALL BE CONSTRUCTED IN ACCORDANCE WITH THE PROJECT SPECIFICATIONS AND THE PROJECT GEOTECHNICAL REPORT. WHERE APPLICABLE, CITY OF ALBUQUERQUE STANDARD SPECIFICATIONS SHALL APPLY.
- THE CONTRACTOR SHALL ABIDE BY ALL LOCAL, STATE, AND FEDERAL LAWS, RULES AND REGULATIONS WHICH APPLY TO THE CONSTRUCTION OF THESE IMPROVEMENTS, INCLUDING EPA REQUIREMENTS WITH RESPECT TO STORM WATER DISCHARGE.
- PRIOR TO CONSTRUCTION, THE CONTRACTOR SHALL FIELD VERIFY THE HORIZONTAL AND VERTICAL LOCATIONS OF ALL POTENTIAL OBSTRUCTIONS INCLUDING ALL UNDERGROUND UTILITIES. SHOULD A CONFLICT EXIST, THE CONTRACTOR SHALL NOTIFY THE CONSTRUCTION OBSERVER OR ENGINEER SO THAT THE CONFLICT CAN BE RESOLVED WITH A MINIMUM AMOUNT OF DELAY.
- TWO (2) WORKING DAYS PRIOR TO ANY EXCAVATION, THE CONTRACTOR SHALL CONTACT LINE LOCATING SERVICE FOR LOCATION OF EXISTING UTILITIES.
- ALL ELECTRICAL, TELEPHONE, CABLE TV, GAS AND OTHER UTILITY LINES, CABLES, AND APPURTENANCES ENCOUNTERED DURING CONSTRUCTION THAT REQUIRE RELOCATION, SHALL BE COORDINATED WITH THAT UTILITY. THE CONTRACTOR SHALL BE RESPONSIBLE FOR COORDINATION OF ALL NECESSARY UTILITY ADJUSTMENTS. NO ADDITIONAL COMPENSATION WILL BE ALLOWED FOR DELAYS OR INCONVENIENCES CAUSED BY UTILITY COMPANY WORK CREWS. THE CONTRACTOR MAY BE REQUIRED TO RESCHEDULE HIS ACTIVITIES TO ALLOW UTILITY CREWS TO PERFORM THEIR REQUIRED WORK.
- THE CONTRACTOR IS RESPONSIBLE FOR PROTECTING ALL EXISTING UTILITY LINES WITHIN THE CONSTRUCTION AREA. ANY DAMAGE TO EXISTING FACILITIES CAUSED BY CONSTRUCTION ACTIVITY SHALL BE REPAIRED OR REPLACED AT THE CONTRACTOR'S EXPENSE AND APPROVED BY THE CONSTRUCTION OBSERVER.
- CONSTRUCTION ACTIVITY SHALL BE LIMITED TO THE PROPERTY AND/OR PROJECT LIMITS. ANY DAMAGE TO ADJACENT PROPERTIES RESULTING FROM THE CONSTRUCTION PROCESS SHALL BE REPAIRED OR REPLACED AT THE CONTRACTOR'S EXPENSE.
- OVERNIGHT PARKING OF CONSTRUCTION EQUIPMENT SHALL NOT OBSTRUCT DRIVEWAYS OR DESIGNATED TRAFFIC LANES. THE CONTRACTOR SHALL NOT STORE ANY EQUIPMENT OR MATERIAL WITHIN THE PUBLIC RIGHT-OF-WAY.
- THE CONTRACTOR SHALL OBTAIN ALL THE NECESSARY PERMITS FOR THE PROJECT PRIOR TO COMMENCING CONSTRUCTION (I.E., BARRICADING, TOPSOIL DISTURBANCE, EXCAVATION PERMITS, EPA STORM WATER PERMITS, ETC.).
- ALL PROPERTY CORNERS DESTROYED DURING CONSTRUCTION SHALL BE REPLACED AT THE CONTRACTOR'S EXPENSE. ALL PROPERTY CORNERS MUST BE RESET BY A REGISTERED LAND SURVEYOR.
- THE CONTRACTOR SHALL PREPARE A CONSTRUCTION TRAFFIC CONTROL AND SIGNING PLAN AND OBTAIN APPROVAL OF SUCH PLAN FROM THE BERNALILLO COUNTY, TRAFFIC ENGINEERING DEPARTMENT, PRIOR TO BEGINNING ANY CONSTRUCTION WORK ON OR ADJACENT TO EXISTING
- ALL BARRICADES AND CONSTRUCTION SIGNING SHALL CONFORM TO APPLICABLE SECTIONS OF THE "MANUAL ON UNIFORM TRAFFIC CONTROL DEVICES" (MUTCD), US DEPARTMENT OF TRANSPORTATION, LATEST EDITION.
- THE CONTRACTOR SHALL MAINTAIN ALL CONSTRUCTION BARRICADES AND SIGNING AT ALL TIMES. THE CONTRACTOR SHALL VERIFY THE PROPER LOCATION OF ALL BARRICADING AT THE END AND BEGINNING OF EACH DAY.
- THE CONTRACTOR SHALL TAKE ALL STEPS NECESSARY TO CONFORM WITH EPA REQUIREMENTS, INCLUDING COMPLIANCE WITH NPDES PHASE 2 REQUIREMENTS.
- THE CONTRACTOR SHALL PROVIDE 1 HARD COPY AND 1 ELECTRONIC COPY OF THE EPA STORM WATER POLLUTION PREVENTION PLAN ALONG WITH THE APPROPRIATE SUBMITTAL FEE TO CITY OF ALBUQUERQUE TWO WEEKS PRIOR TO THE START OF SITE DISTURBANCE.



DEKKER PERICH SABATINI

ARCHITECTURE DESIGN **INSPIRATION**

ARCHITECT

ENGINEER



PROJECT

 $\Box Z$ 6000 FOREST HILLS ALBUQUERQUE, HOSPIC PHS


ADMINISTRATIVE AMENDMENT

REVISIONS

DRAWN BY **REVIEWED BY** MS DATE 02/24/2021 PROJECT NO. 20-0023 DRAWING NAME

GRADING PLAN

SHEET NO. C-100

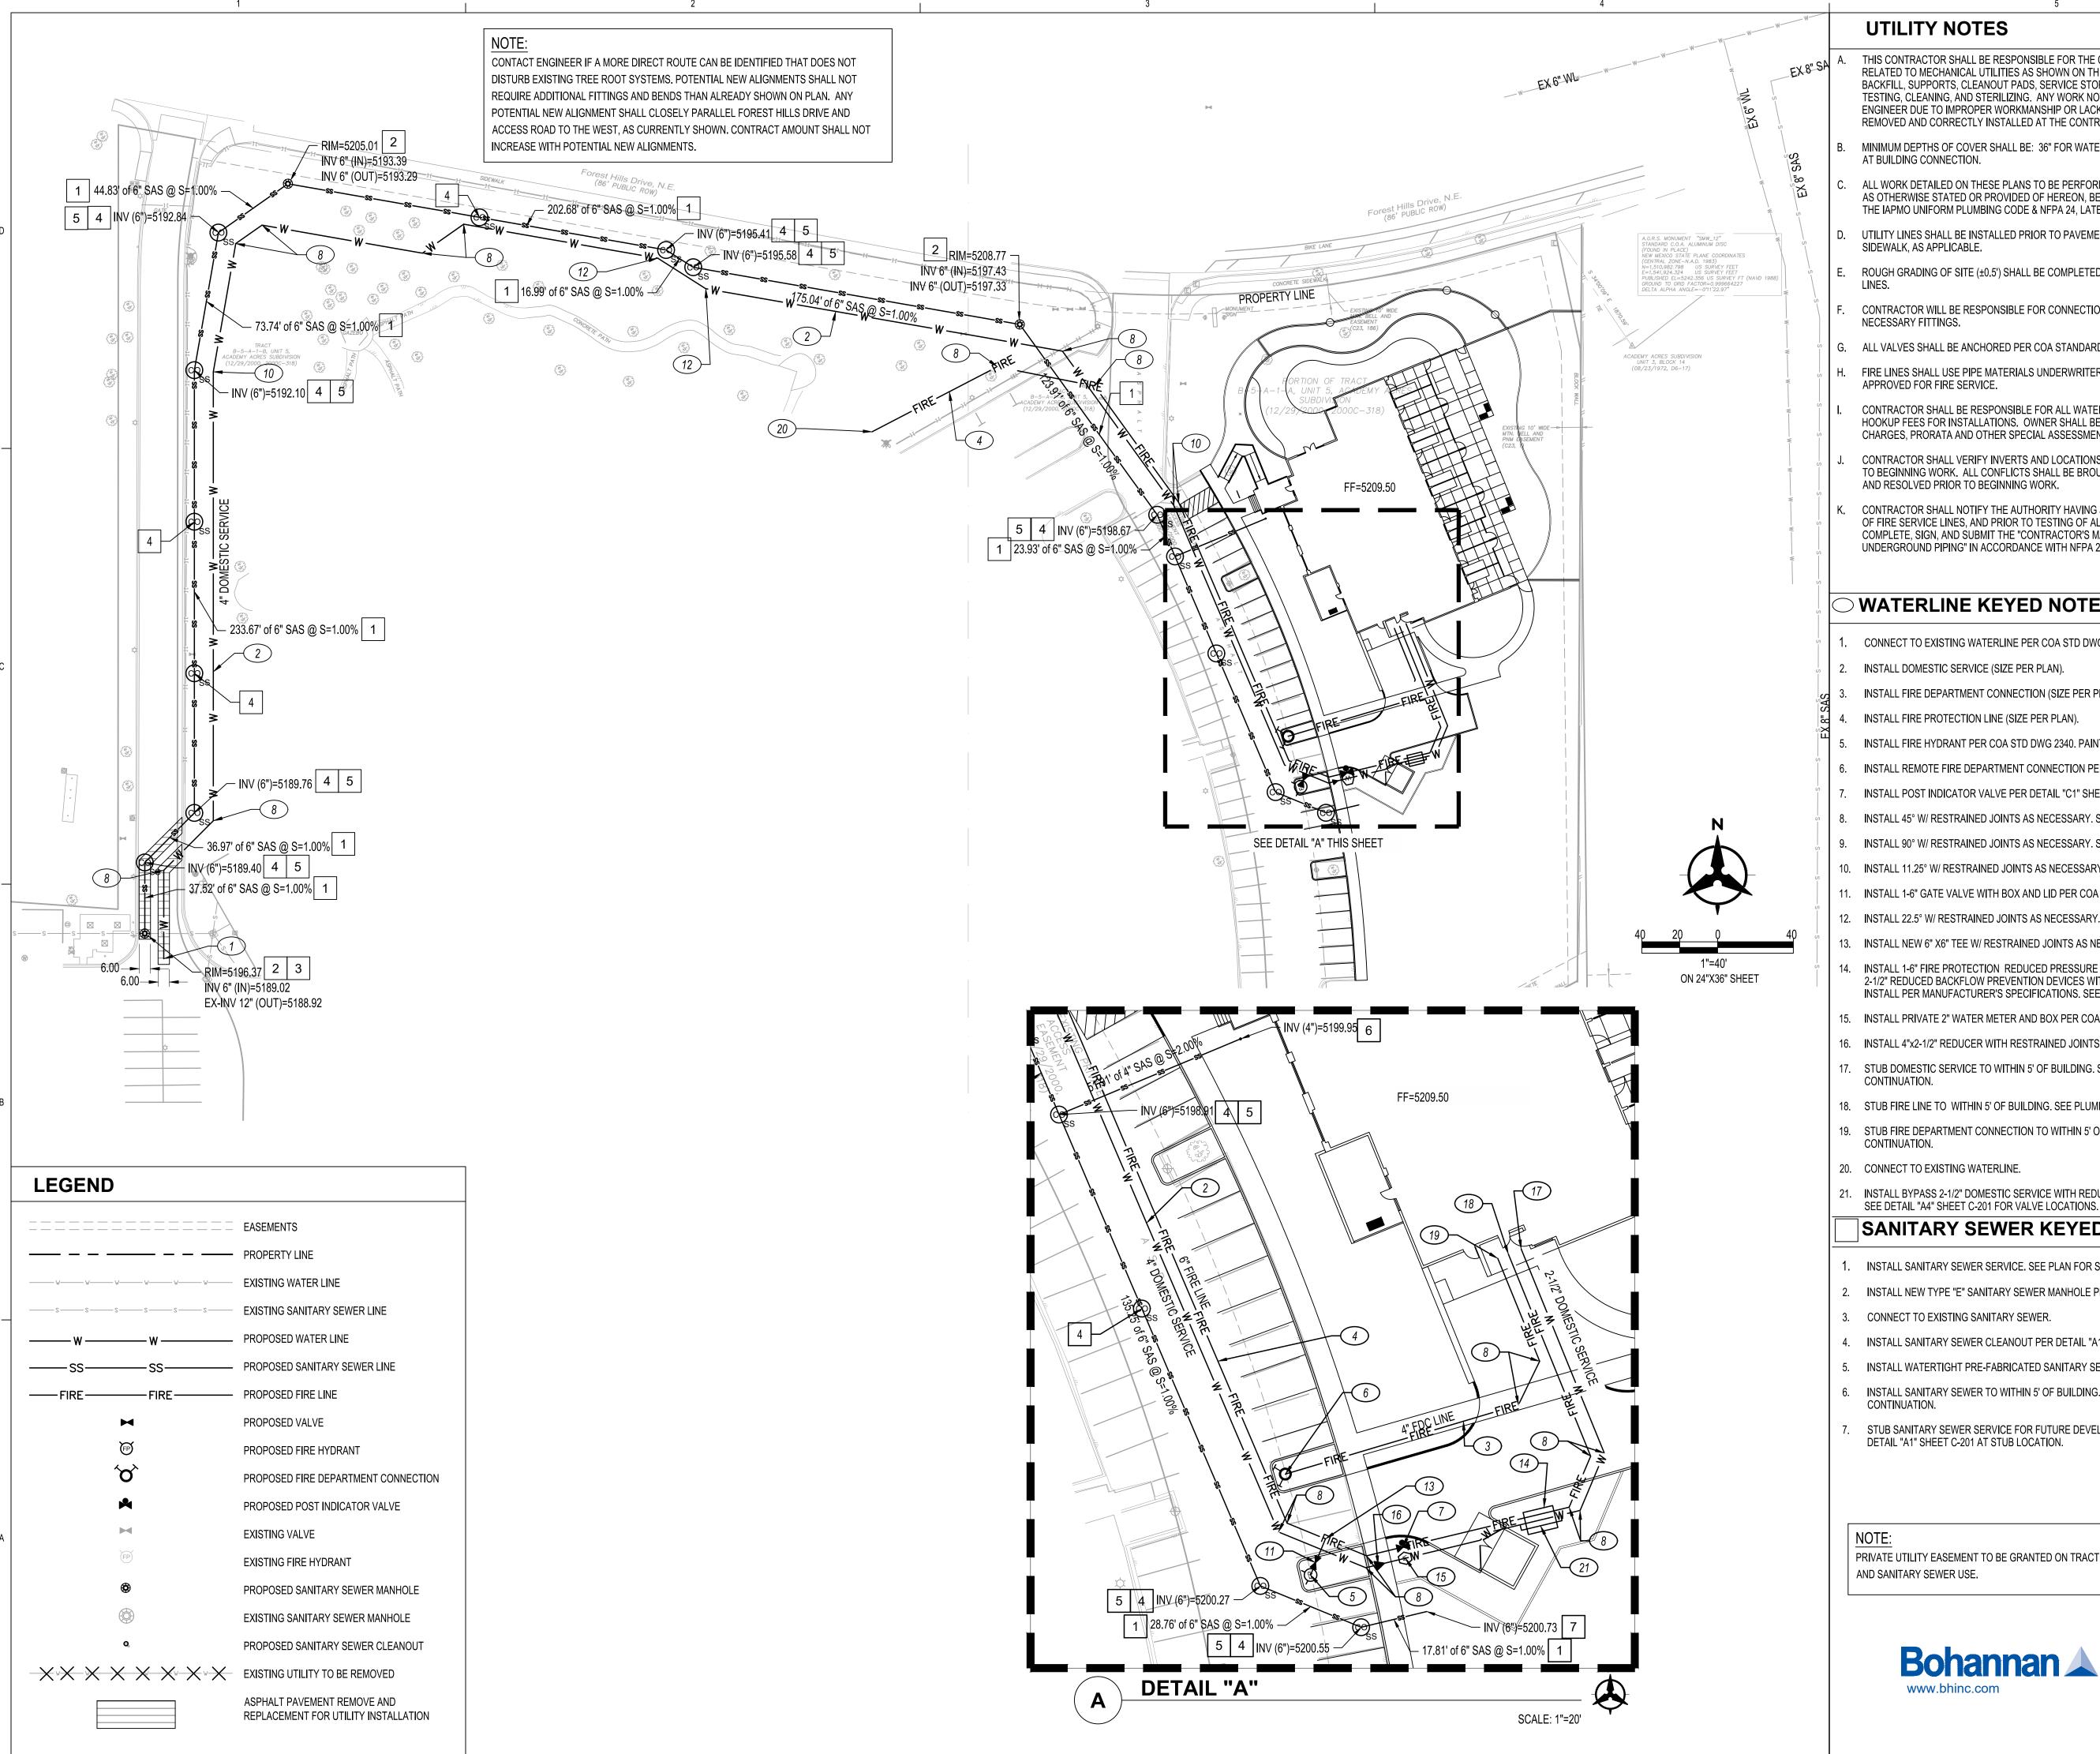

UTILITY NOTES

- THIS CONTRACTOR SHALL BE RESPONSIBLE FOR THE COMPLETE INSTALLATION OF ALL WORK RELATED TO MECHANICAL UTILITIES AS SHOWN ON THIS PLAN INCLUDING: TRENCHING, BACKFILL, SUPPORTS, CLEANOUT PADS, SERVICE STOPS AND BOXES, SERVICE LINES, TESTING, CLEANING, AND STERILIZING. ANY WORK NOT ACCEPTED BY THE ARCHITECT OR ENGINEER DUE TO IMPROPER WORKMANSHIP OR LACK OF PROPER COORDINATION SHALL BE REMOVED AND CORRECTLY INSTALLED AT THE CONTRACTOR'S EXPENSE, AS DIRECTED.
- MINIMUM DEPTHS OF COVER SHALL BE: 36" FOR WATERLINES AND 48" FOR SEWER, EXCEPT AT BUILDING CONNECTION.
- ALL WORK DETAILED ON THESE PLANS TO BE PERFORMED UNDER CONTRACT SHALL, EXCEPT AS OTHERWISE STATED OR PROVIDED OF HEREON, BE CONSTRUCTED IN ACCORDANCE WITH THE IAPMO UNIFORM PLUMBING CODE & NFPA 24, LATEST EDITION.
- UTILITY LINES SHALL BE INSTALLED PRIOR TO PAVEMENT, CURB AND GUTTER, AND/OR
- ROUGH GRADING OF SITE (±0.5') SHALL BE COMPLETED PRIOR TO INSTALLATION OF UTILITY
- CONTRACTOR WILL BE RESPONSIBLE FOR CONNECTIONS TO BUILDING DRAIN LINES AND ALL NECESSARY FITTINGS.
- G. ALL VALVES SHALL BE ANCHORED PER COA STANDARD DWG. 2333.
- FIRE LINES SHALL USE PIPE MATERIALS UNDERWRITERS LABORATORIES LISTED AND APPROVED FOR FIRE SERVICE.
- CONTRACTOR SHALL BE RESPONSIBLE FOR ALL WATER METER, FIRE LINE, AND SEWER HOOKUP FEES FOR INSTALLATIONS. OWNER SHALL BE RESPONSIBLE FOR UTILITY EXPANSION CHARGES, PRORATA AND OTHER SPECIAL ASSESSMENTS.
- CONTRACTOR SHALL VERIFY INVERTS AND LOCATIONS OF EXISTING WATER/SAS LINES PRIOR TO BEGINNING WORK. ALL CONFLICTS SHALL BE BROUGHT TO ATTENTION OF THE ENGINEER AND RESOLVED PRIOR TO BEGINNING WORK.
- CONTRACTOR SHALL NOTIFY THE AUTHORITY HAVING JURISDICTION PRIOR TO INSTALLATION OF FIRE SERVICE LINES, AND PRIOR TO TESTING OF ALL WATERLINES. CONTRACTOR SHALL COMPLETE, SIGN, AND SUBMIT THE "CONTRACTOR'S MATERIAL & TEST CERTIFICATE FOR UNDERGROUND PIPING" IN ACCORDANCE WITH NFPA 24.

WATERLINE KEYED NOTES

- CONNECT TO EXISTING WATERLINE PER COA STD DWG 2363.
- INSTALL DOMESTIC SERVICE (SIZE PER PLAN).
- INSTALL FIRE DEPARTMENT CONNECTION (SIZE PER PLAN).
- INSTALL FIRE PROTECTION LINE (SIZE PER PLAN).
- INSTALL FIRE HYDRANT PER COA STD DWG 2340. PAINT HYDRANT SAFETY ORANGE.
- INSTALL REMOTE FIRE DEPARTMENT CONNECTION PER DETAIL "C3" SHEET C-201.
- INSTALL POST INDICATOR VALVE PER DETAIL "C1" SHEET C-201.
- INSTALL 45° W/ RESTRAINED JOINTS AS NECESSARY. SEE PLAN FOR SIZE.
- INSTALL 90° W/ RESTRAINED JOINTS AS NECESSARY. SEE PLAN FOR SIZE.
- 10. INSTALL 11.25° W/ RESTRAINED JOINTS AS NECESSARY. SEE PLAN FOR SIZE.
- INSTALL 1-6" GATE VALVE WITH BOX AND LID PER COA STD DWG 2326.
- 12. INSTALL 22.5° W/ RESTRAINED JOINTS AS NECESSARY. SEE PLAN FOR SIZE..
- INSTALL NEW 6" X6" TEE W/ RESTRAINED JOINTS AS NECESSARY.
- INSTALL 1-6" FIRE PROTECTION REDUCED PRESSURE BACKFLOW PREVENTION DEVICE, 2 2-1/2" REDUCED BACKFLOW PREVENTION DEVICES WITHIN TRIPLE HEATED ENCLOSURE. INSTALL PER MANUFACTURER'S SPECIFICATIONS. SEE ELECTRICAL PLANS FOR POWER.
- 15. INSTALL PRIVATE 2" WATER METER AND BOX PER COA STD 2367.
- 16. INSTALL 4"x2-1/2" REDUCER WITH RESTRAINED JOINTS AS NECESSARY.
- STUB DOMESTIC SERVICE TO WITHIN 5' OF BUILDING. SEE PLUMBING PLAN FOR CONTINUATION.
- 18. STUB FIRE LINE TO WITHIN 5' OF BUILDING. SEE PLUMBING PLAN FOR CONTINUATION.
- 19. STUB FIRE DEPARTMENT CONNECTION TO WITHIN 5' OF BUILDING. SEE PLUMBING PLAN FOR CONTINUATION.
- 20. CONNECT TO EXISTING WATERLINE.
- INSTALL BYPASS 2-1/2" DOMESTIC SERVICE WITH REDUCED BACKFLOW PREVENTION DEVICE

SANITARY SEWER KEYED NOTES

- INSTALL SANITARY SEWER SERVICE. SEE PLAN FOR SIZE AND SLOPE.
- 2. INSTALL NEW TYPE "E" SANITARY SEWER MANHOLE PER COA STD DWG 2102
- CONNECT TO EXISTING SANITARY SEWER.
- 4. INSTALL SANITARY SEWER CLEANOUT PER DETAIL "A1" SHEET C-201.
- INSTALL WATERTIGHT PRE-FABRICATED SANITARY SEWER FITTING.
- INSTALL SANITARY SEWER TO WITHIN 5' OF BUILDING. SEE PLUMBING PLANS FOR
- STUB SANITARY SEWER SERVICE FOR FUTURE DEVELOPMENT. INSTALL CLEANOUT PER

DETAIL "A1" SHEET C-201 AT STUB LOCATION.

PRIVATE UTILITY EASEMENT TO BE GRANTED ON TRACT B-5-A-1-B FOR FIRE, DOMESTIC, AND SANITARY SEWER USE.



DEKKER PERICH SABATINI

ARCHITECTURE DESIGN **INSPIRATION**

ARCHITECT

ENGINEER



PROJECT

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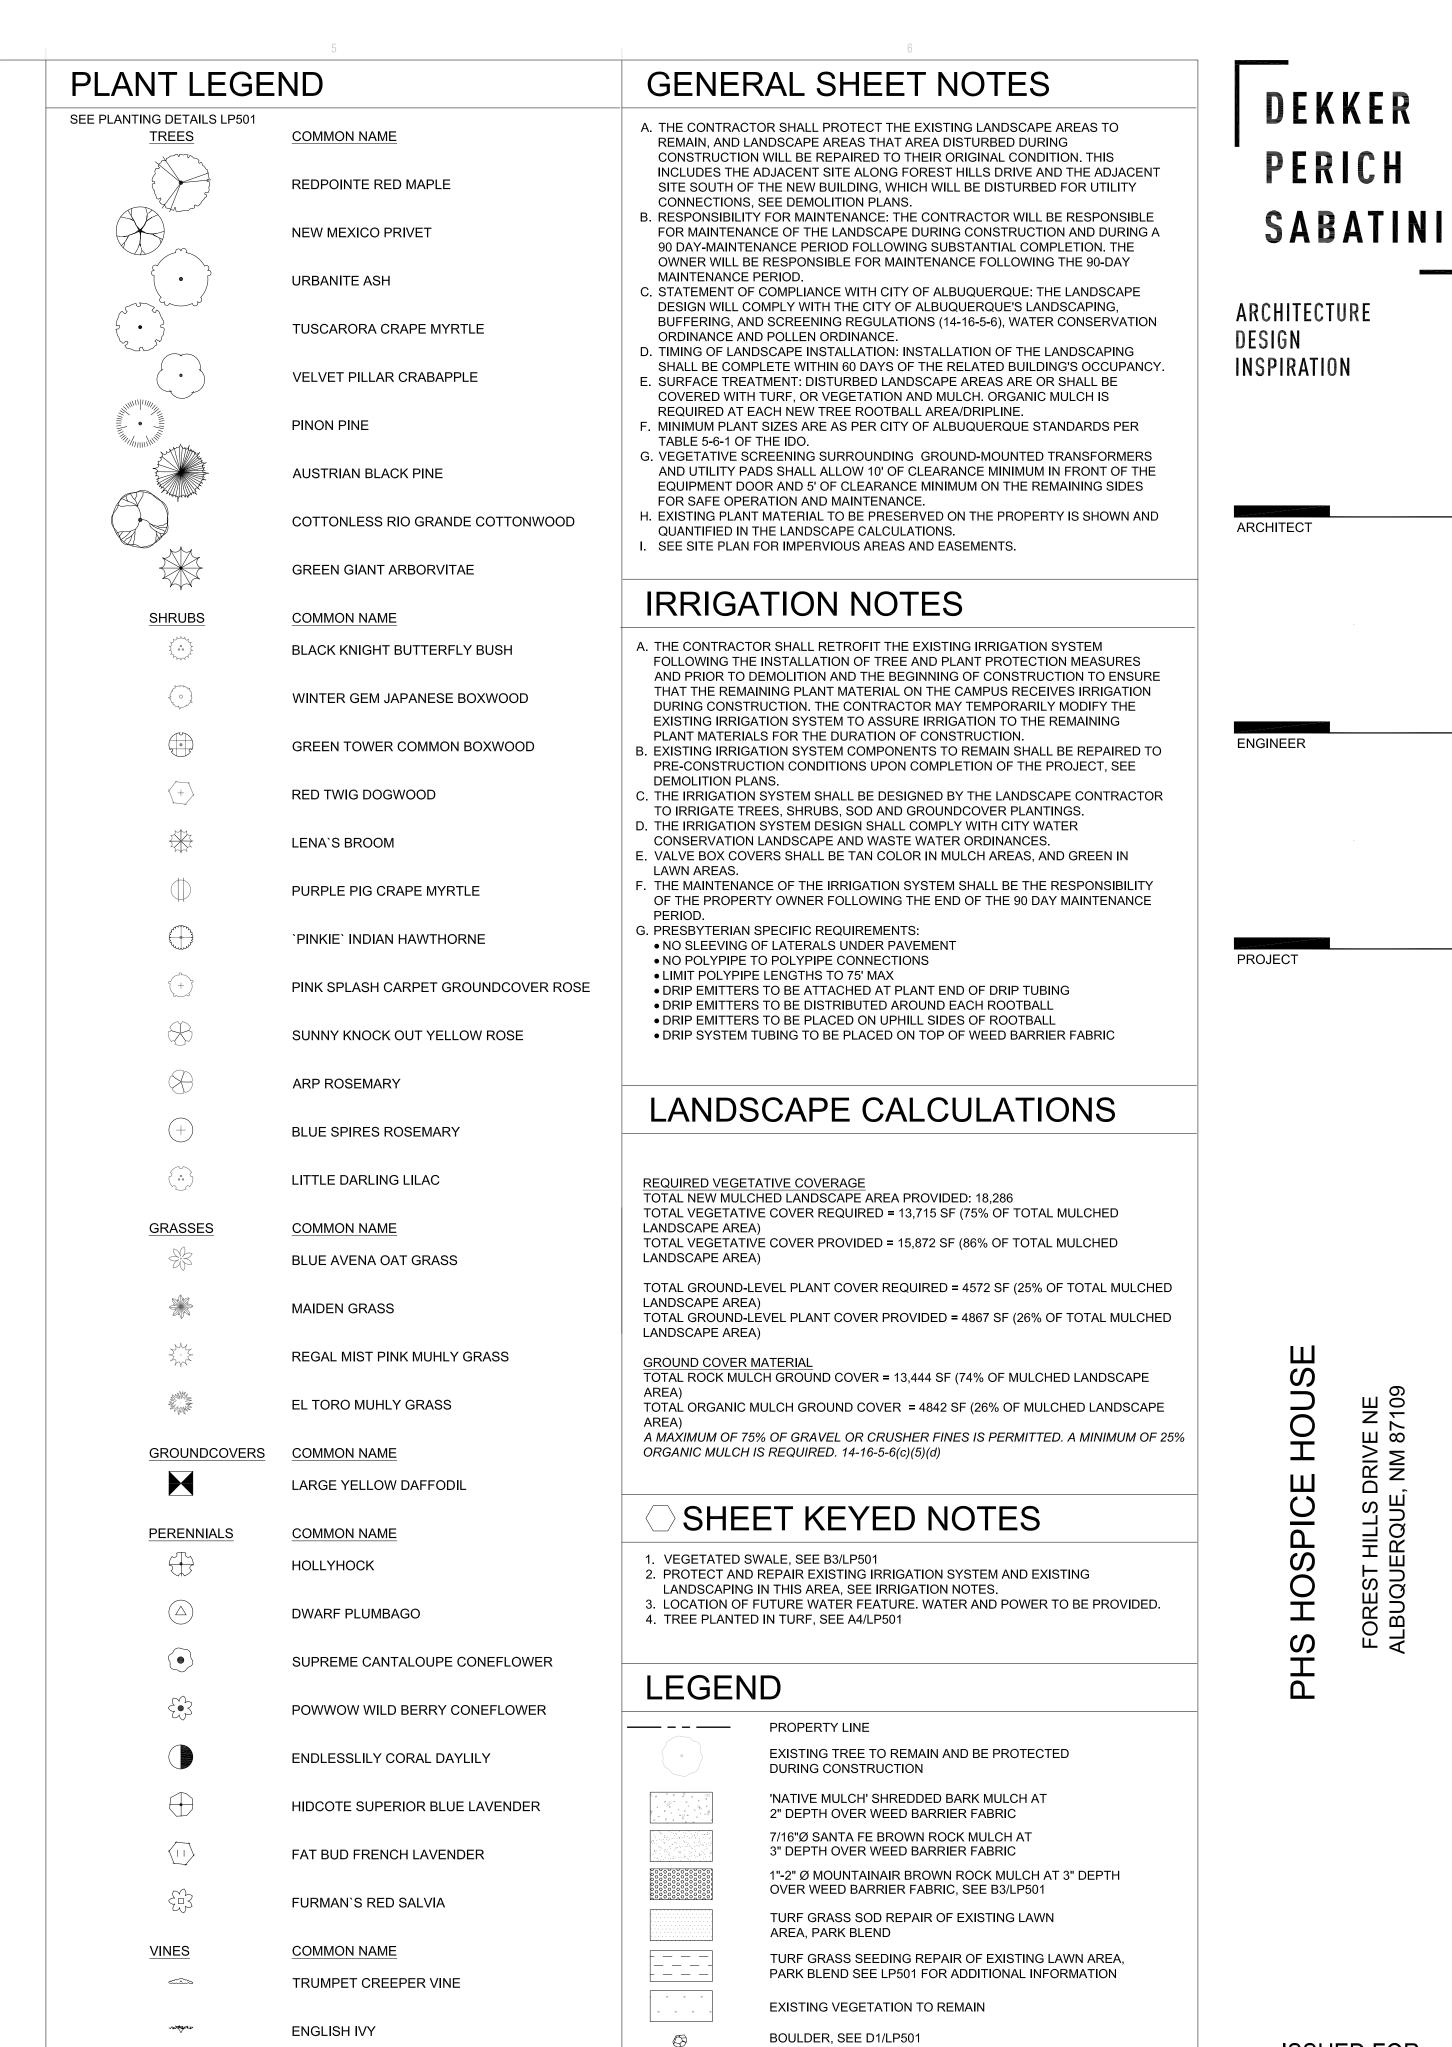
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UTILITY PLAN

SHEET NO. C-200






BRITE EYES CLIMBING ROSE


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REVIEWED BY	CM/ME
DATE	01/15/2021
PROJECT NO.	20-0023.001
RAWING NAME	

LANDSCAPE PLAN

LP101



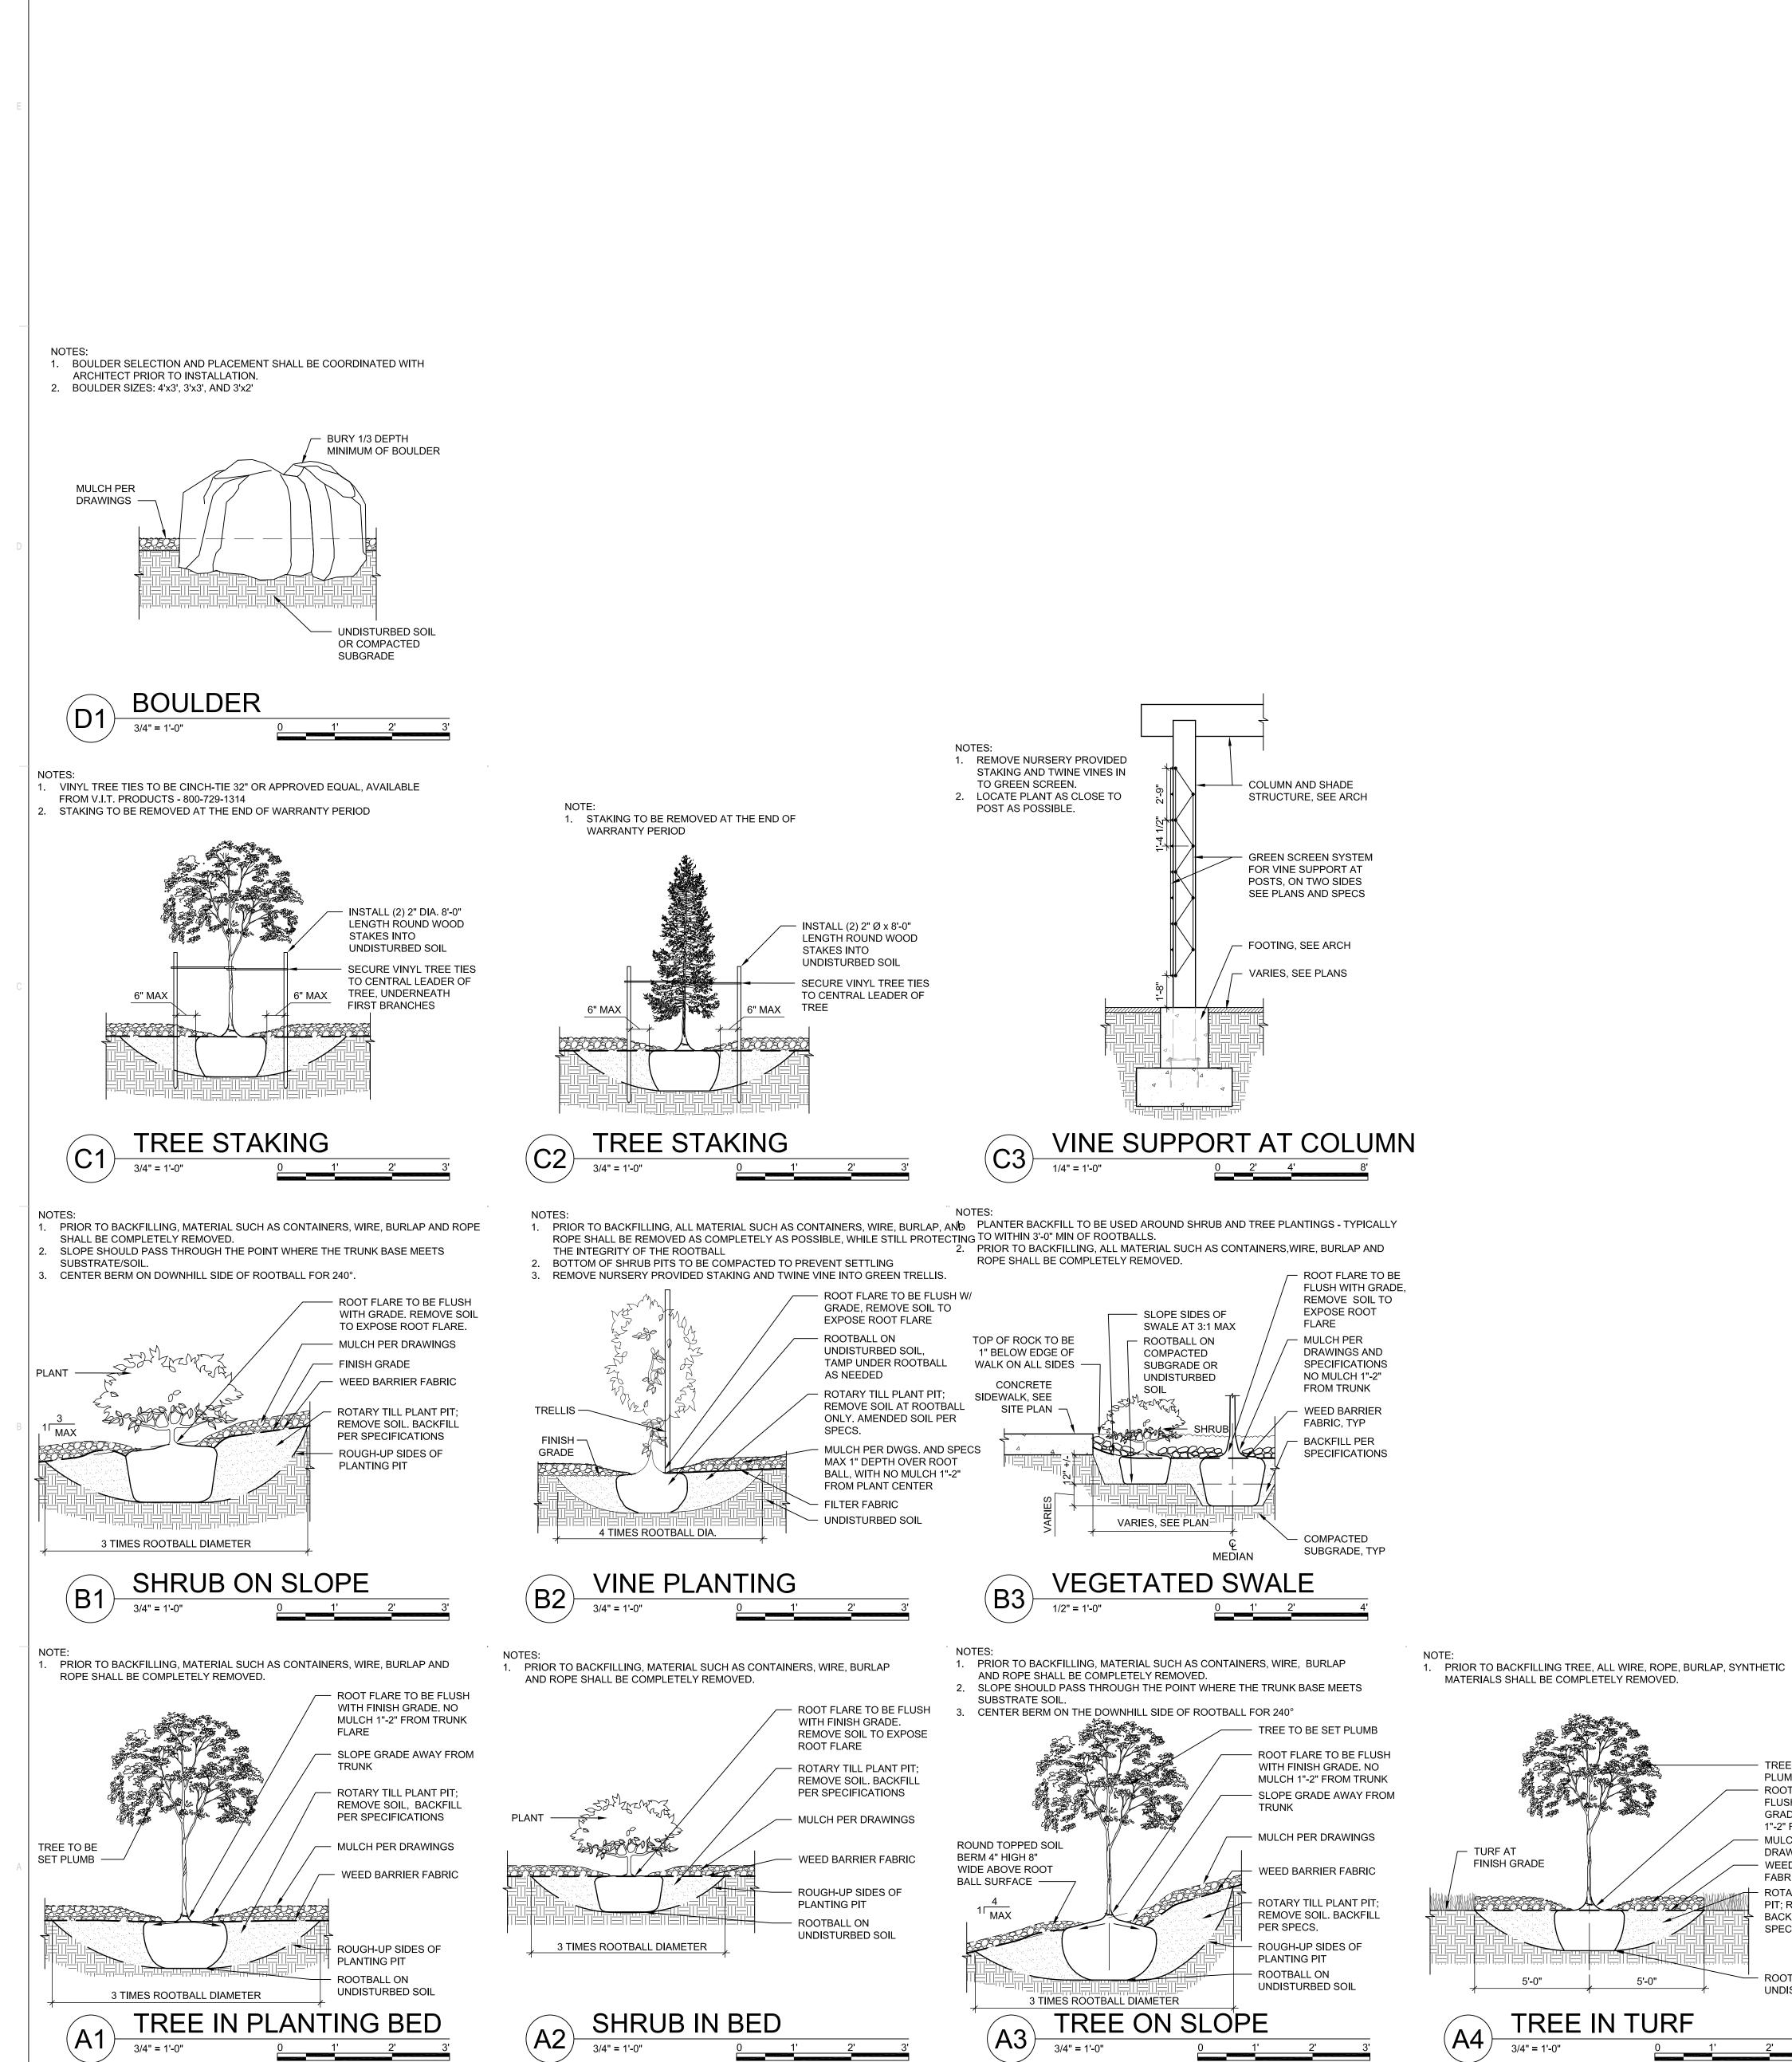

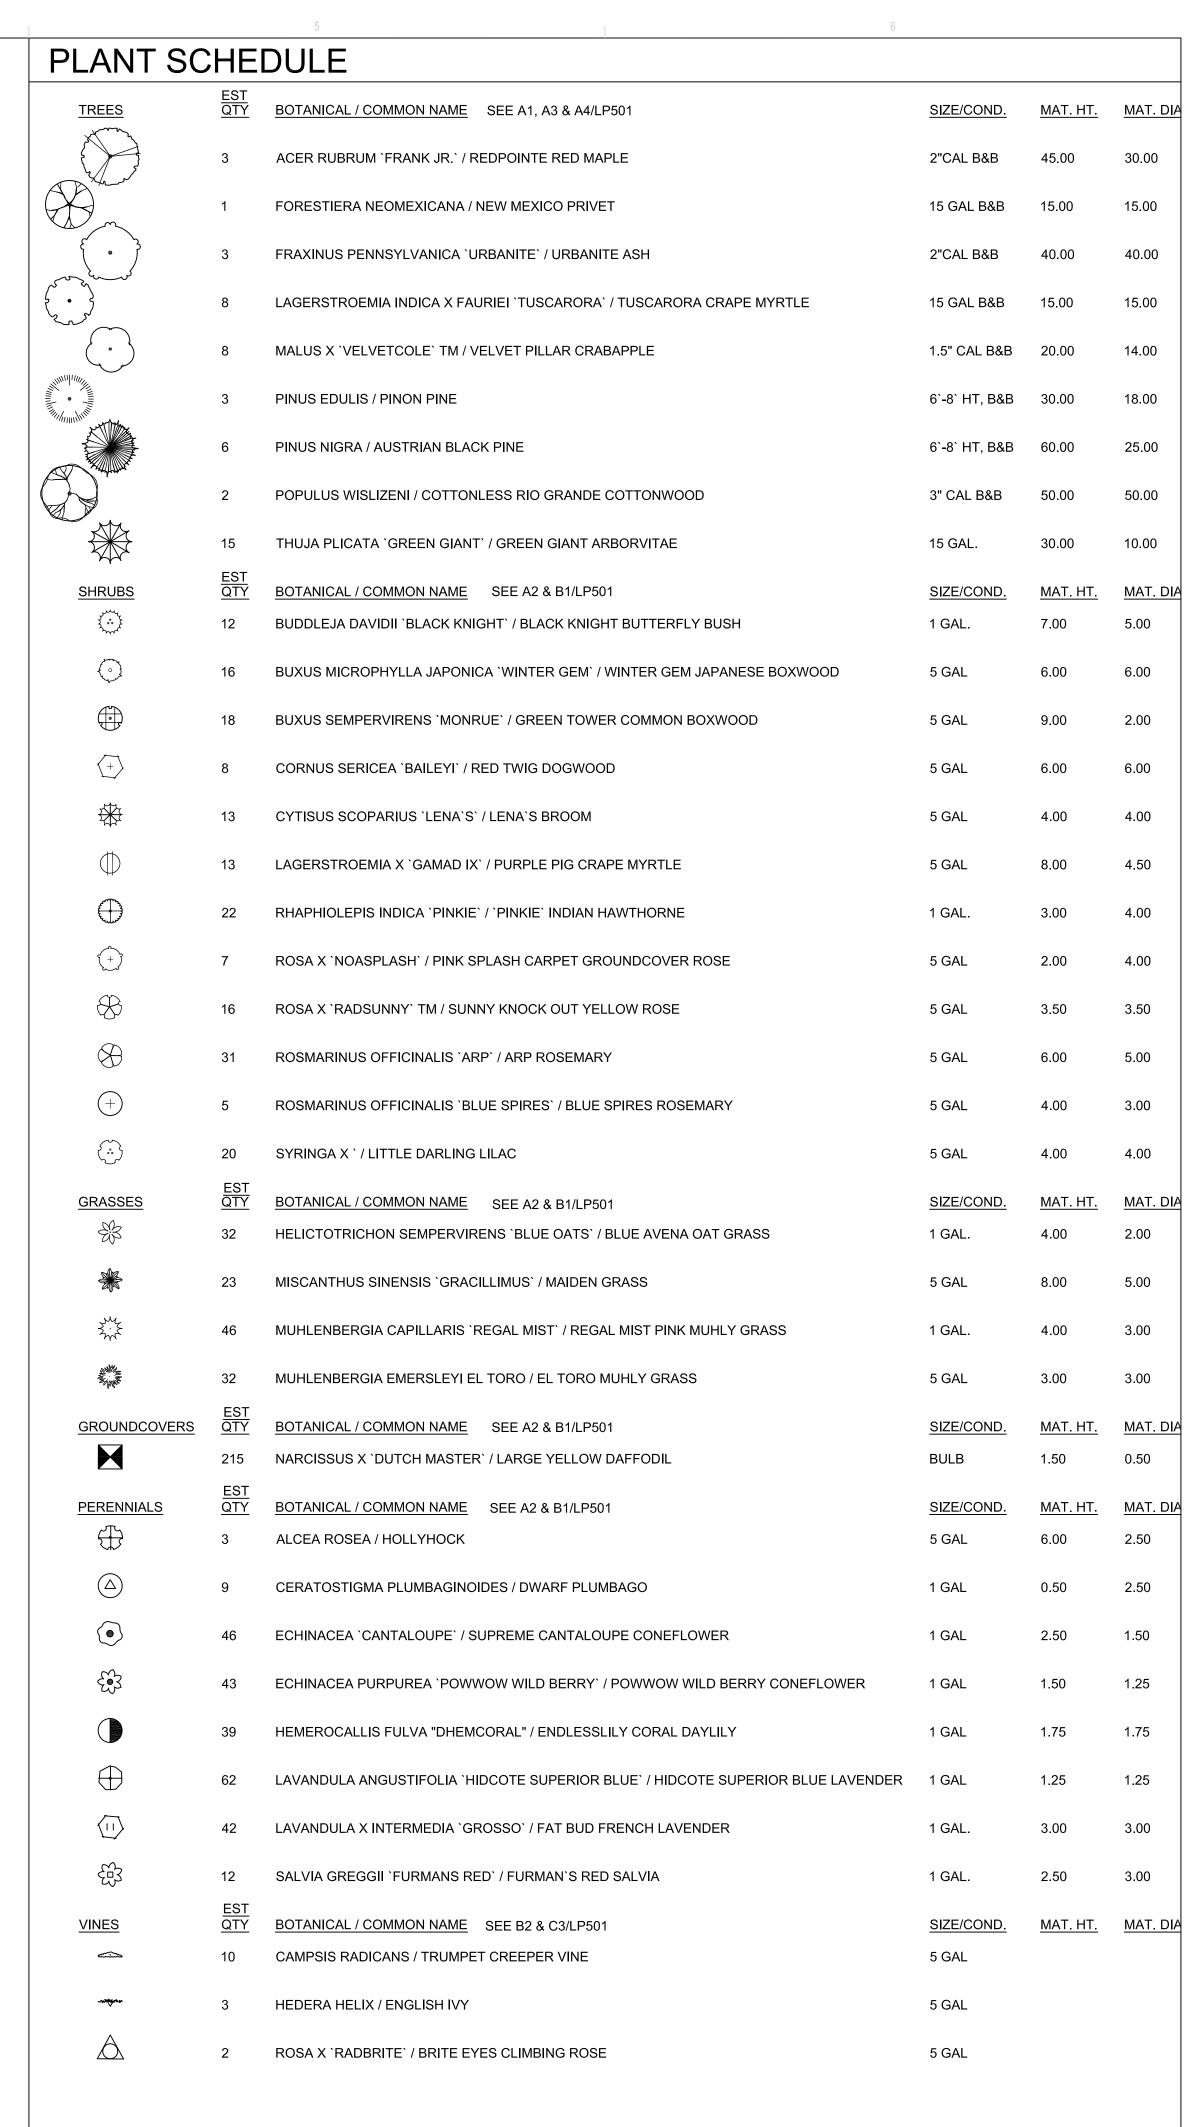AVAILABLE FROM SUPPLIER:

505/877-0220

505/344-6626

505/344-6626

505-384-2430

877/907-1806

505/892-8869

SOILUTIONS, ALBUQUERQUE, NM

BUILDOLOGY, ALBUQUERQUE, NM

BUILDOLOGY, ALBUQUERQUE, NM

EVERGREEN TURF, MCINTOSH, NM

CURTIS AND CURTIS SEED, CLOVIS, NM

JPR GRAVEL NM, ALBUQUERQUE, NM

LEGEND

— — — PROPERTY LINE

EXISTING TREE TO REMAIN AND BE PROTECTED

'NATIVE MULCH' SHREDDED BARK MULCH AT 2" DEPTH

1"-2" Ø MOUNTAINAIR BROWN ROCK MULCH AT 3" DEPTH

TURF GRASS SEEDING REPAIR OF EXISTING LAWN AREA,

PARK BLEND, INCL. KENTUCKY BLUEGRASS, PERENNIAL

7/16" Ø SANTA FE BROWN ROCK MULCH AT 3" DEPTH

TURF GRASS SOD REPAIR OF EXISTING LAWN AREA,

OVER WEED BARRIER FABRIC, SEE B3/LP501

RYEGRASS AND TALL FESCUE, 8#/1000 SQFT

EXISTING VEGETATION TO REMAIN

BOULDER, COLOR: JUST GOLD

DURING CONSTRUCTION

NO WEED BARRIER FABRIC

PARK BLEND

OVER WEED BARRIER FABRIC

SYMBOL:

TREE TO BE SET

- ROOT FLARE TO BE

FLUSH WITH FINISH

GRADE. NO MULCH

1"-2" FROM FLARE

ROTARY TILL PLANT

PIT; REMOVE SOIL.

SPECIFICATIONS

ROOTBALL ON

UNDISTURBED SOIL

BACKFILL PER

MULCH PER

DRAWINGS

FABRIC

— WEED BARRIER

PLUMB

ISSUED FOR PERMITTING/ CONSTRUCTION

DEKKER

PERICH

ARCHITECTURE

DESIGN

ARCHITECT

ENGINEER

PROJECT

INSPIRATION

SABATINI

REVISIONS

EST QTY:

4,842 SF

10,968 SF

2,476 SF


1,765 SF

11,030 SF

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LANDSCAPE DETAILS

SHEET NO.

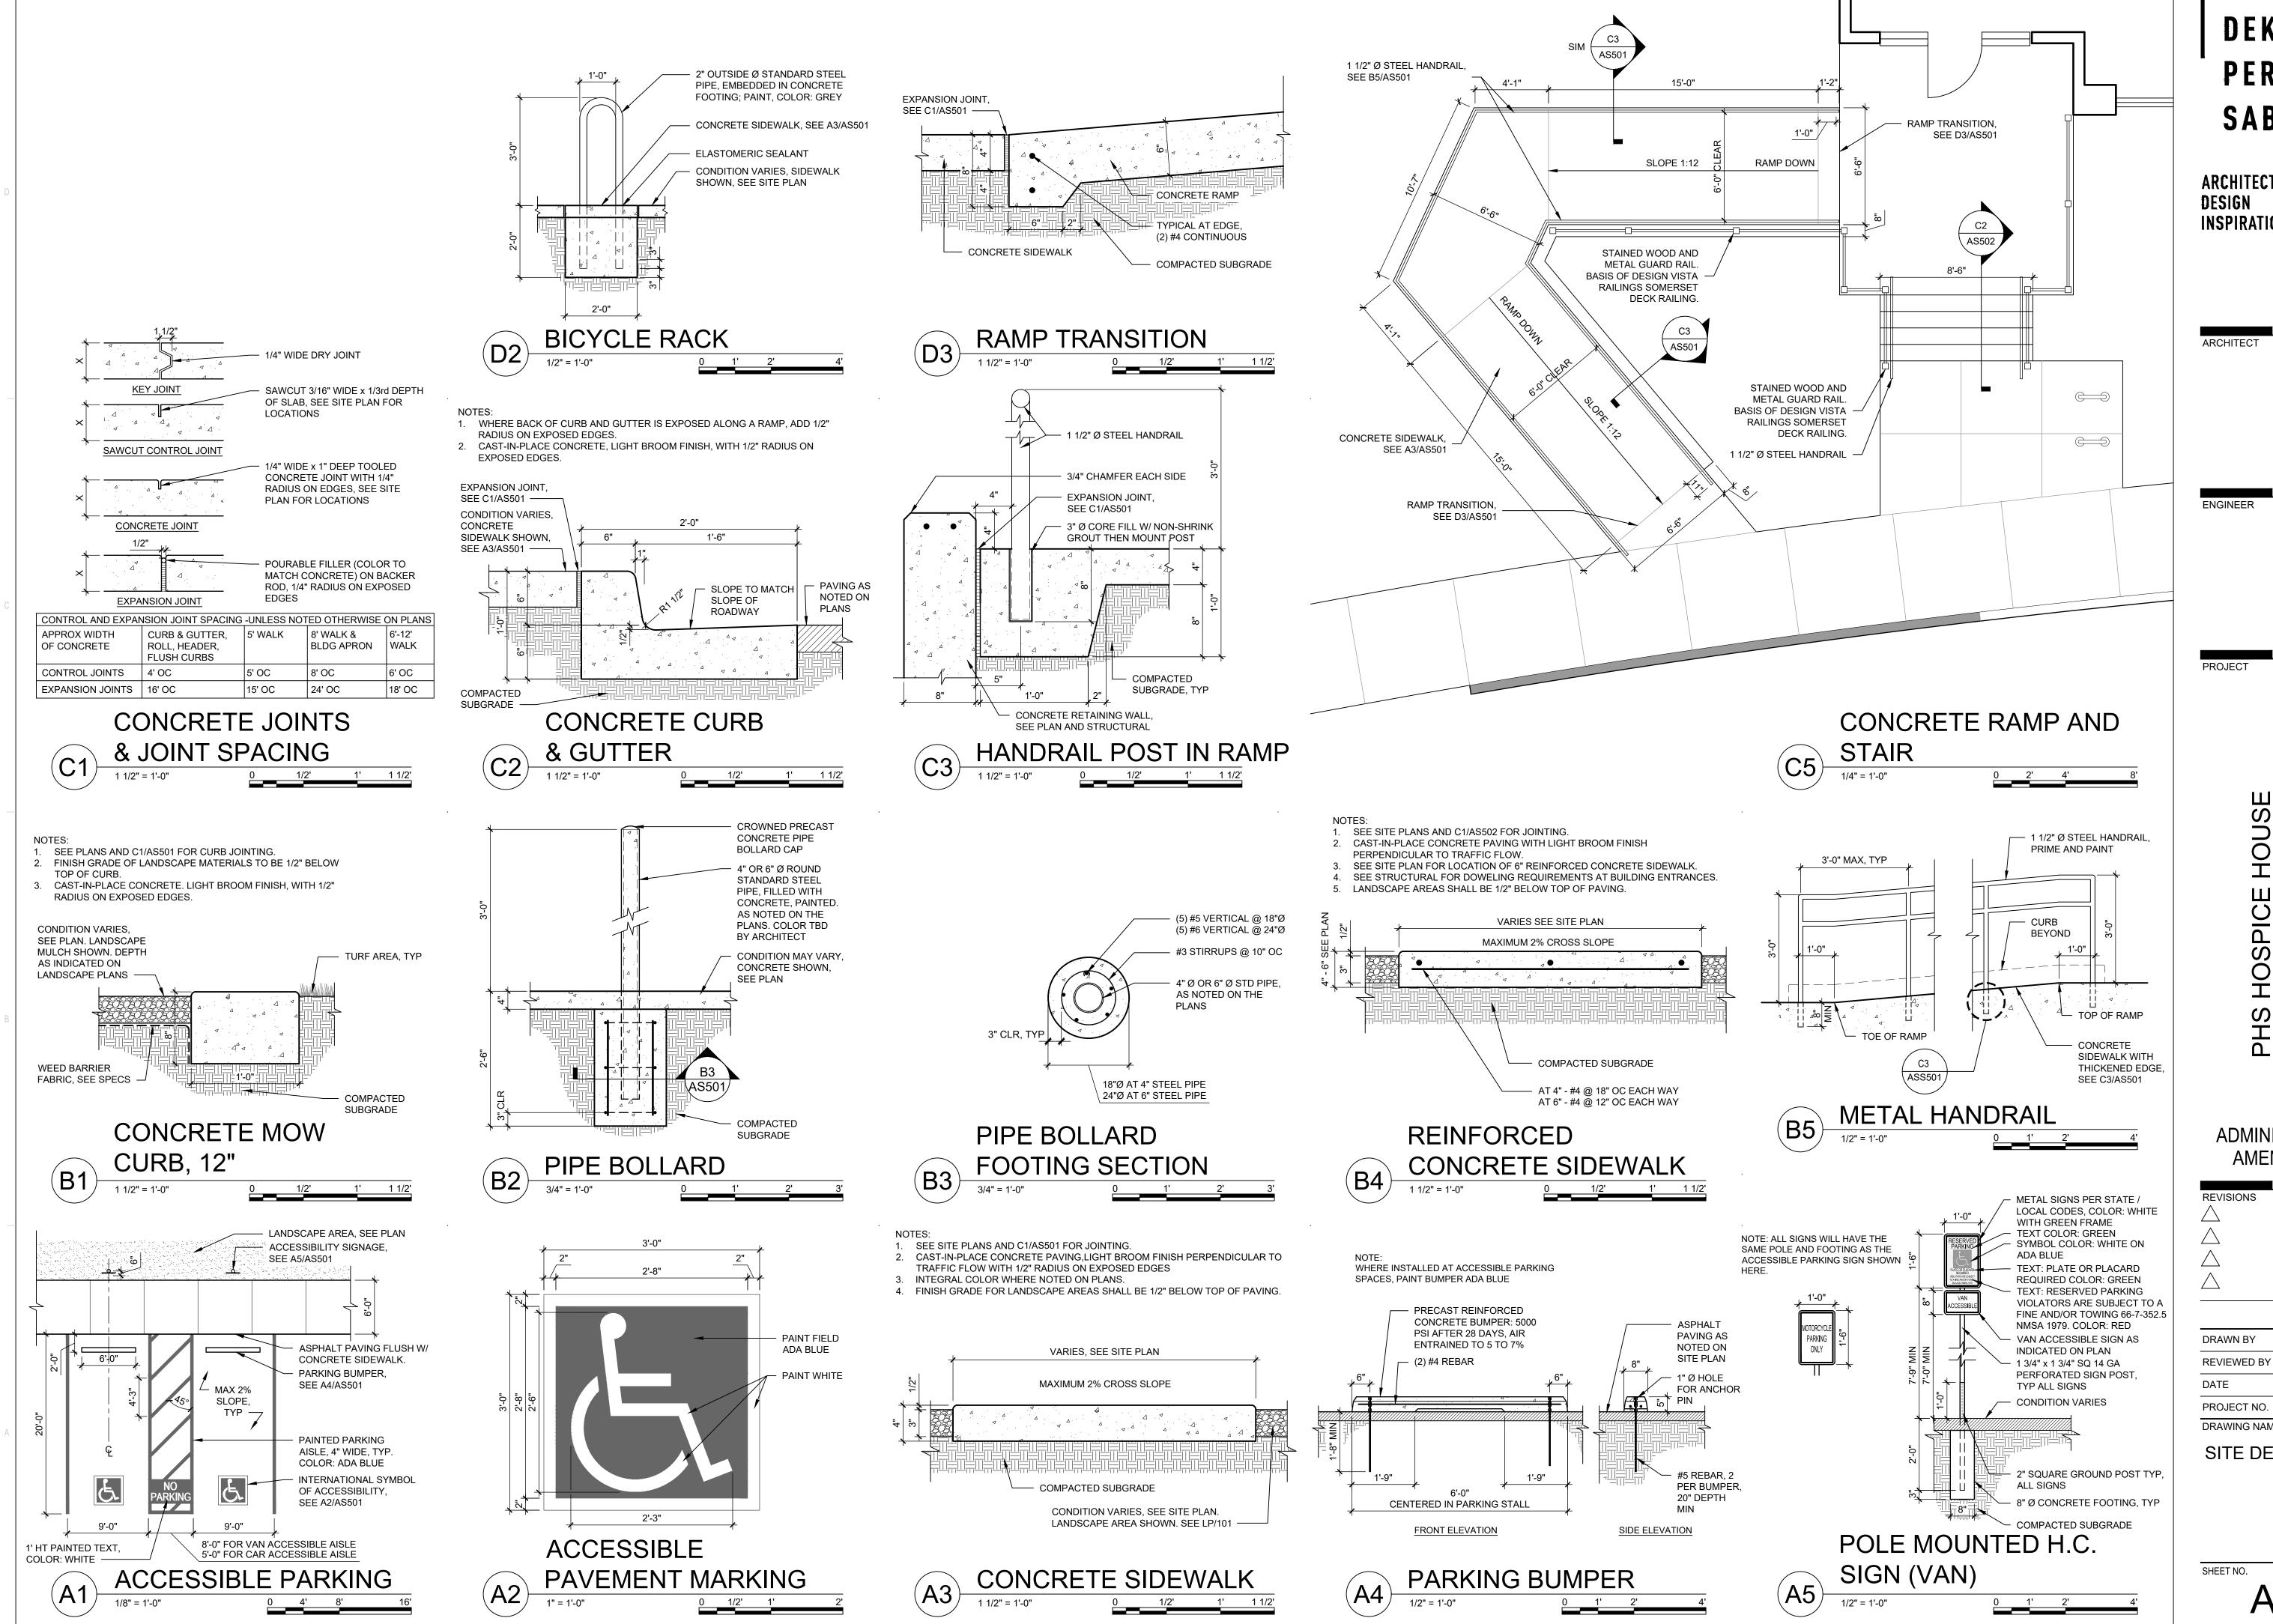

DEKKER PERICH SABATINI

ARCHITECTURE INSPIRATION


6000 FOREST HILLS D ALBUQUERQUE, N PHS

ADMINISTRATIVE AMENDMENT

A. SANTI G. EVERETT 02/25/2021 20-0023 DRAWING NAME

SITE DETAILS

AS501

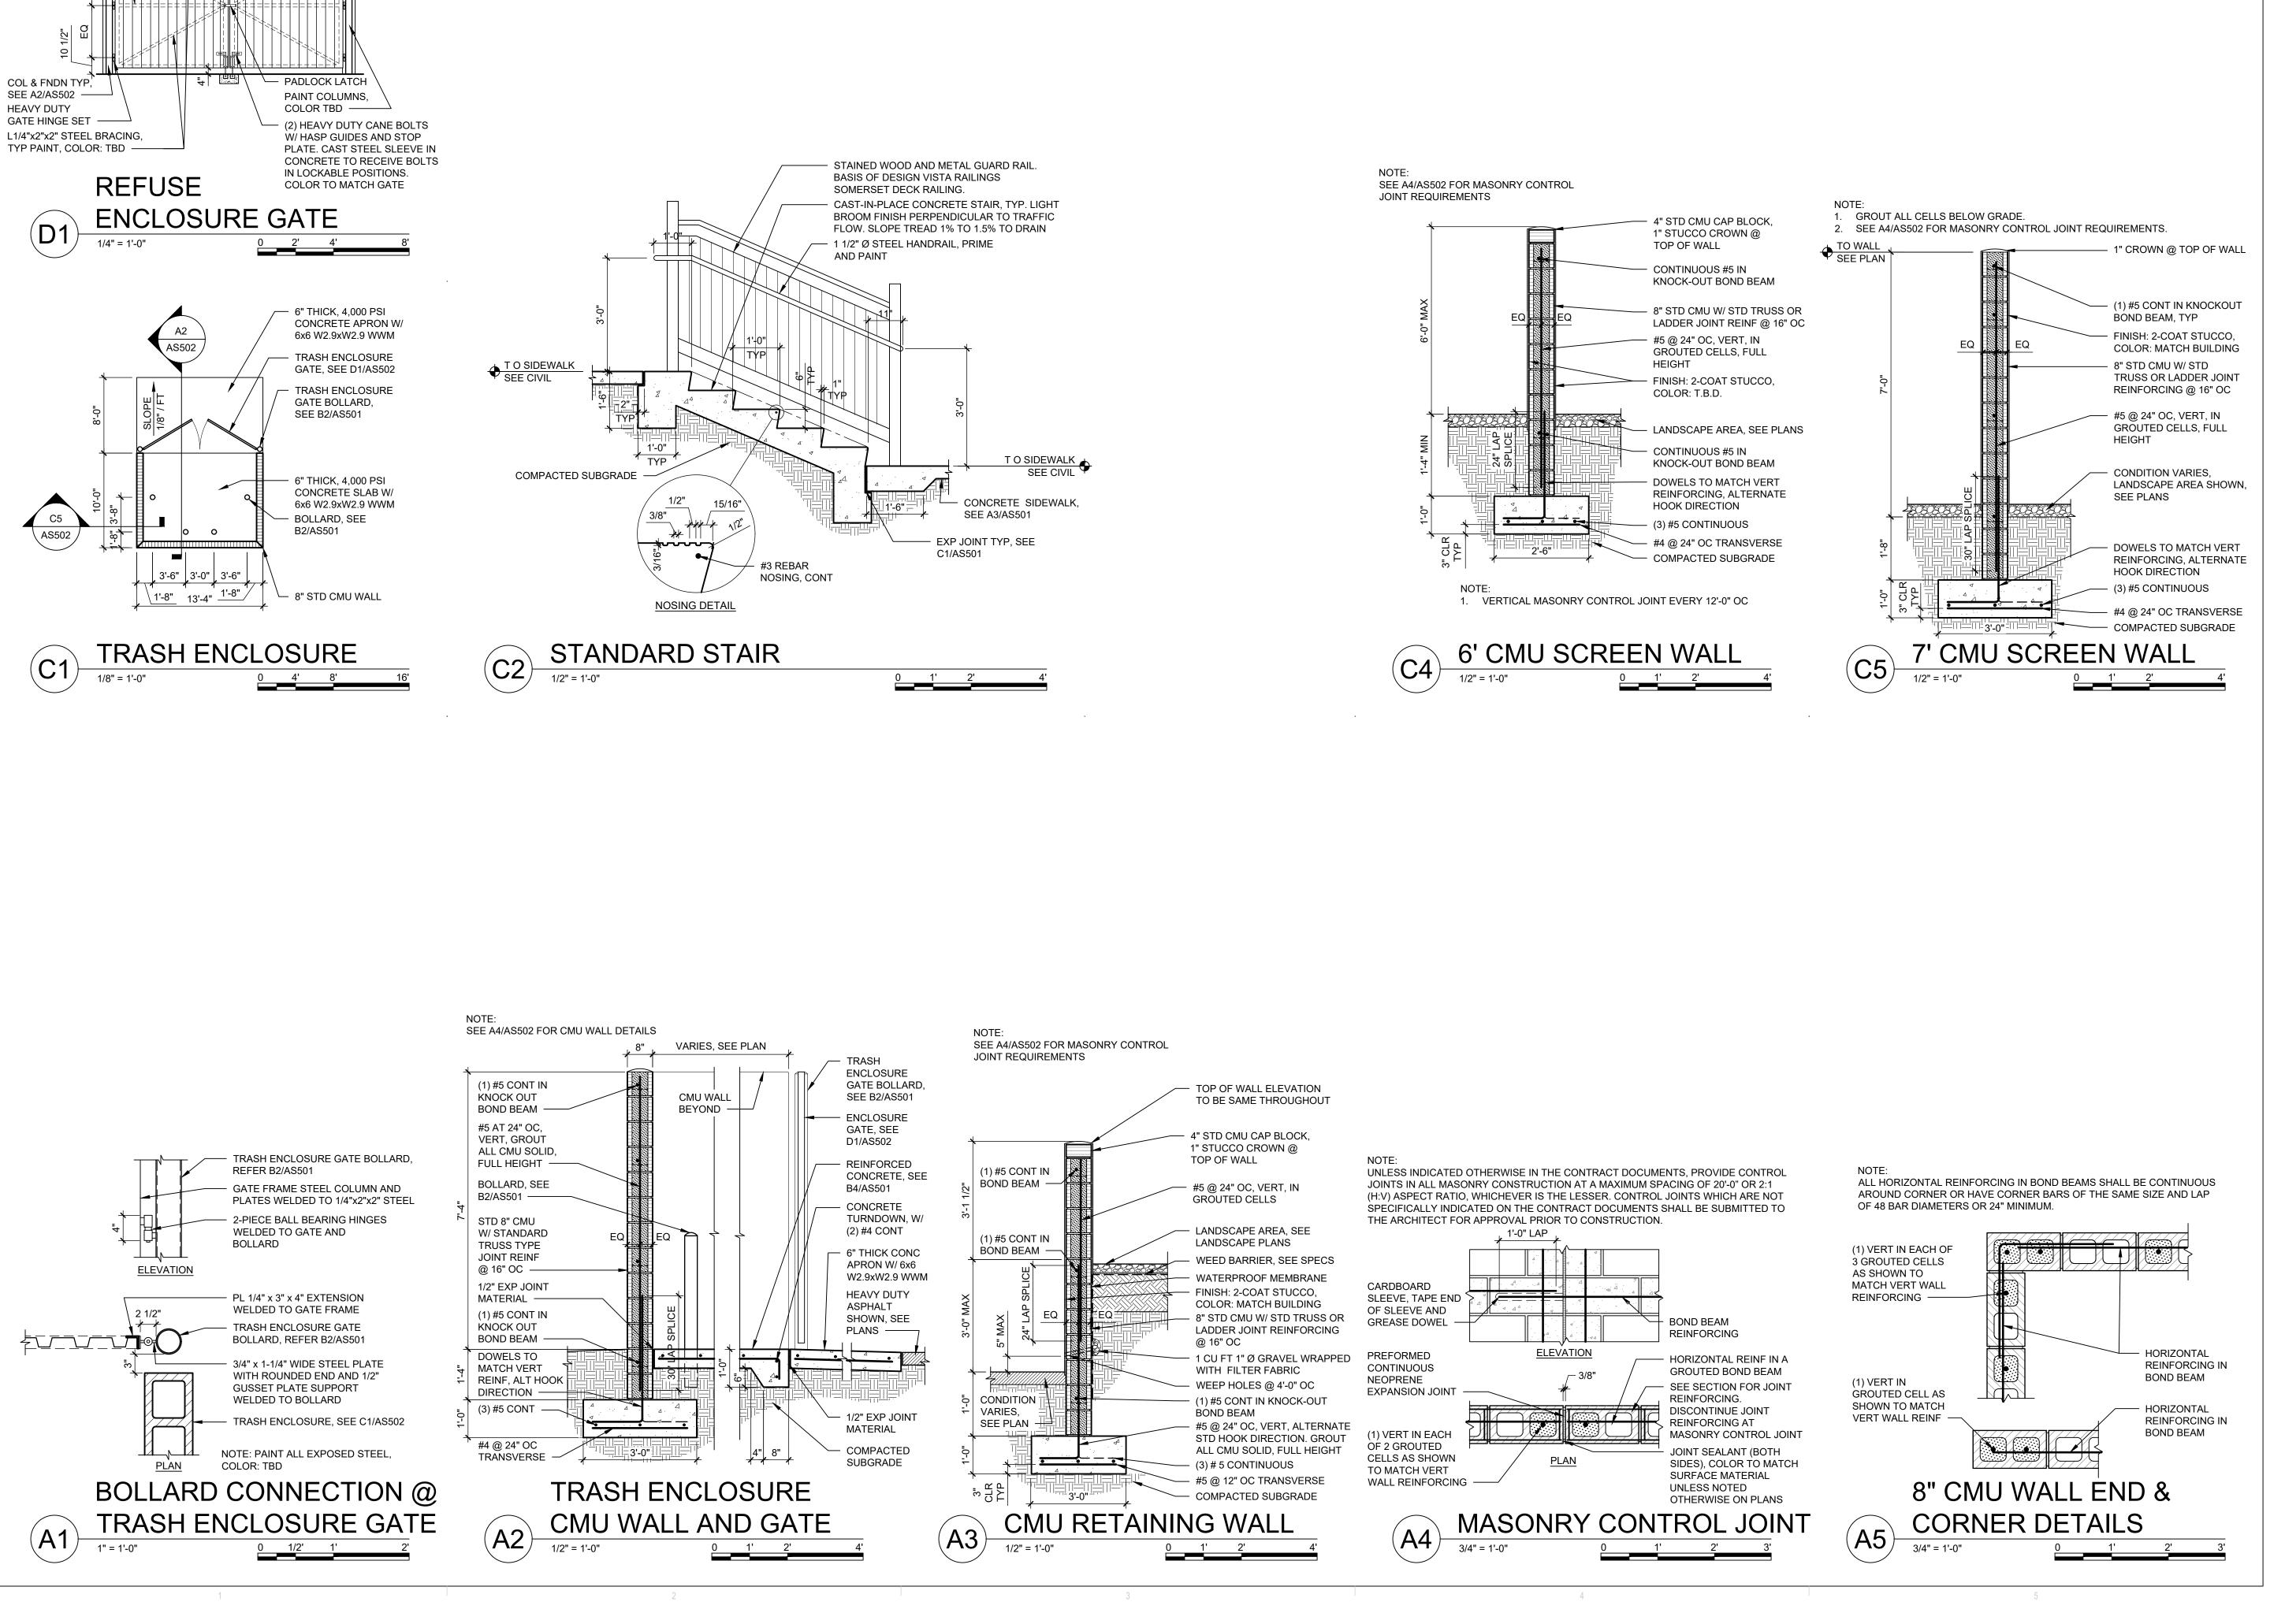

12'-4"

EQ

CORRUGATED

METAL PANELS.

COLOR: TBD

- PAINTED

3 3/4"

EQ

- L1/4"x2"x3" STEEL

CONNECTIONS,

PAINT, TYP.

COLOR: TBD

FRAME, WELDED

7 3/4"

DEKKER PERICH SABATINI

ARCHITECTURE DESIGN INSPIRATION

ARCHITECT

ENGINEER

PROJECT

ADMINISTRATIVE AMENDMENT


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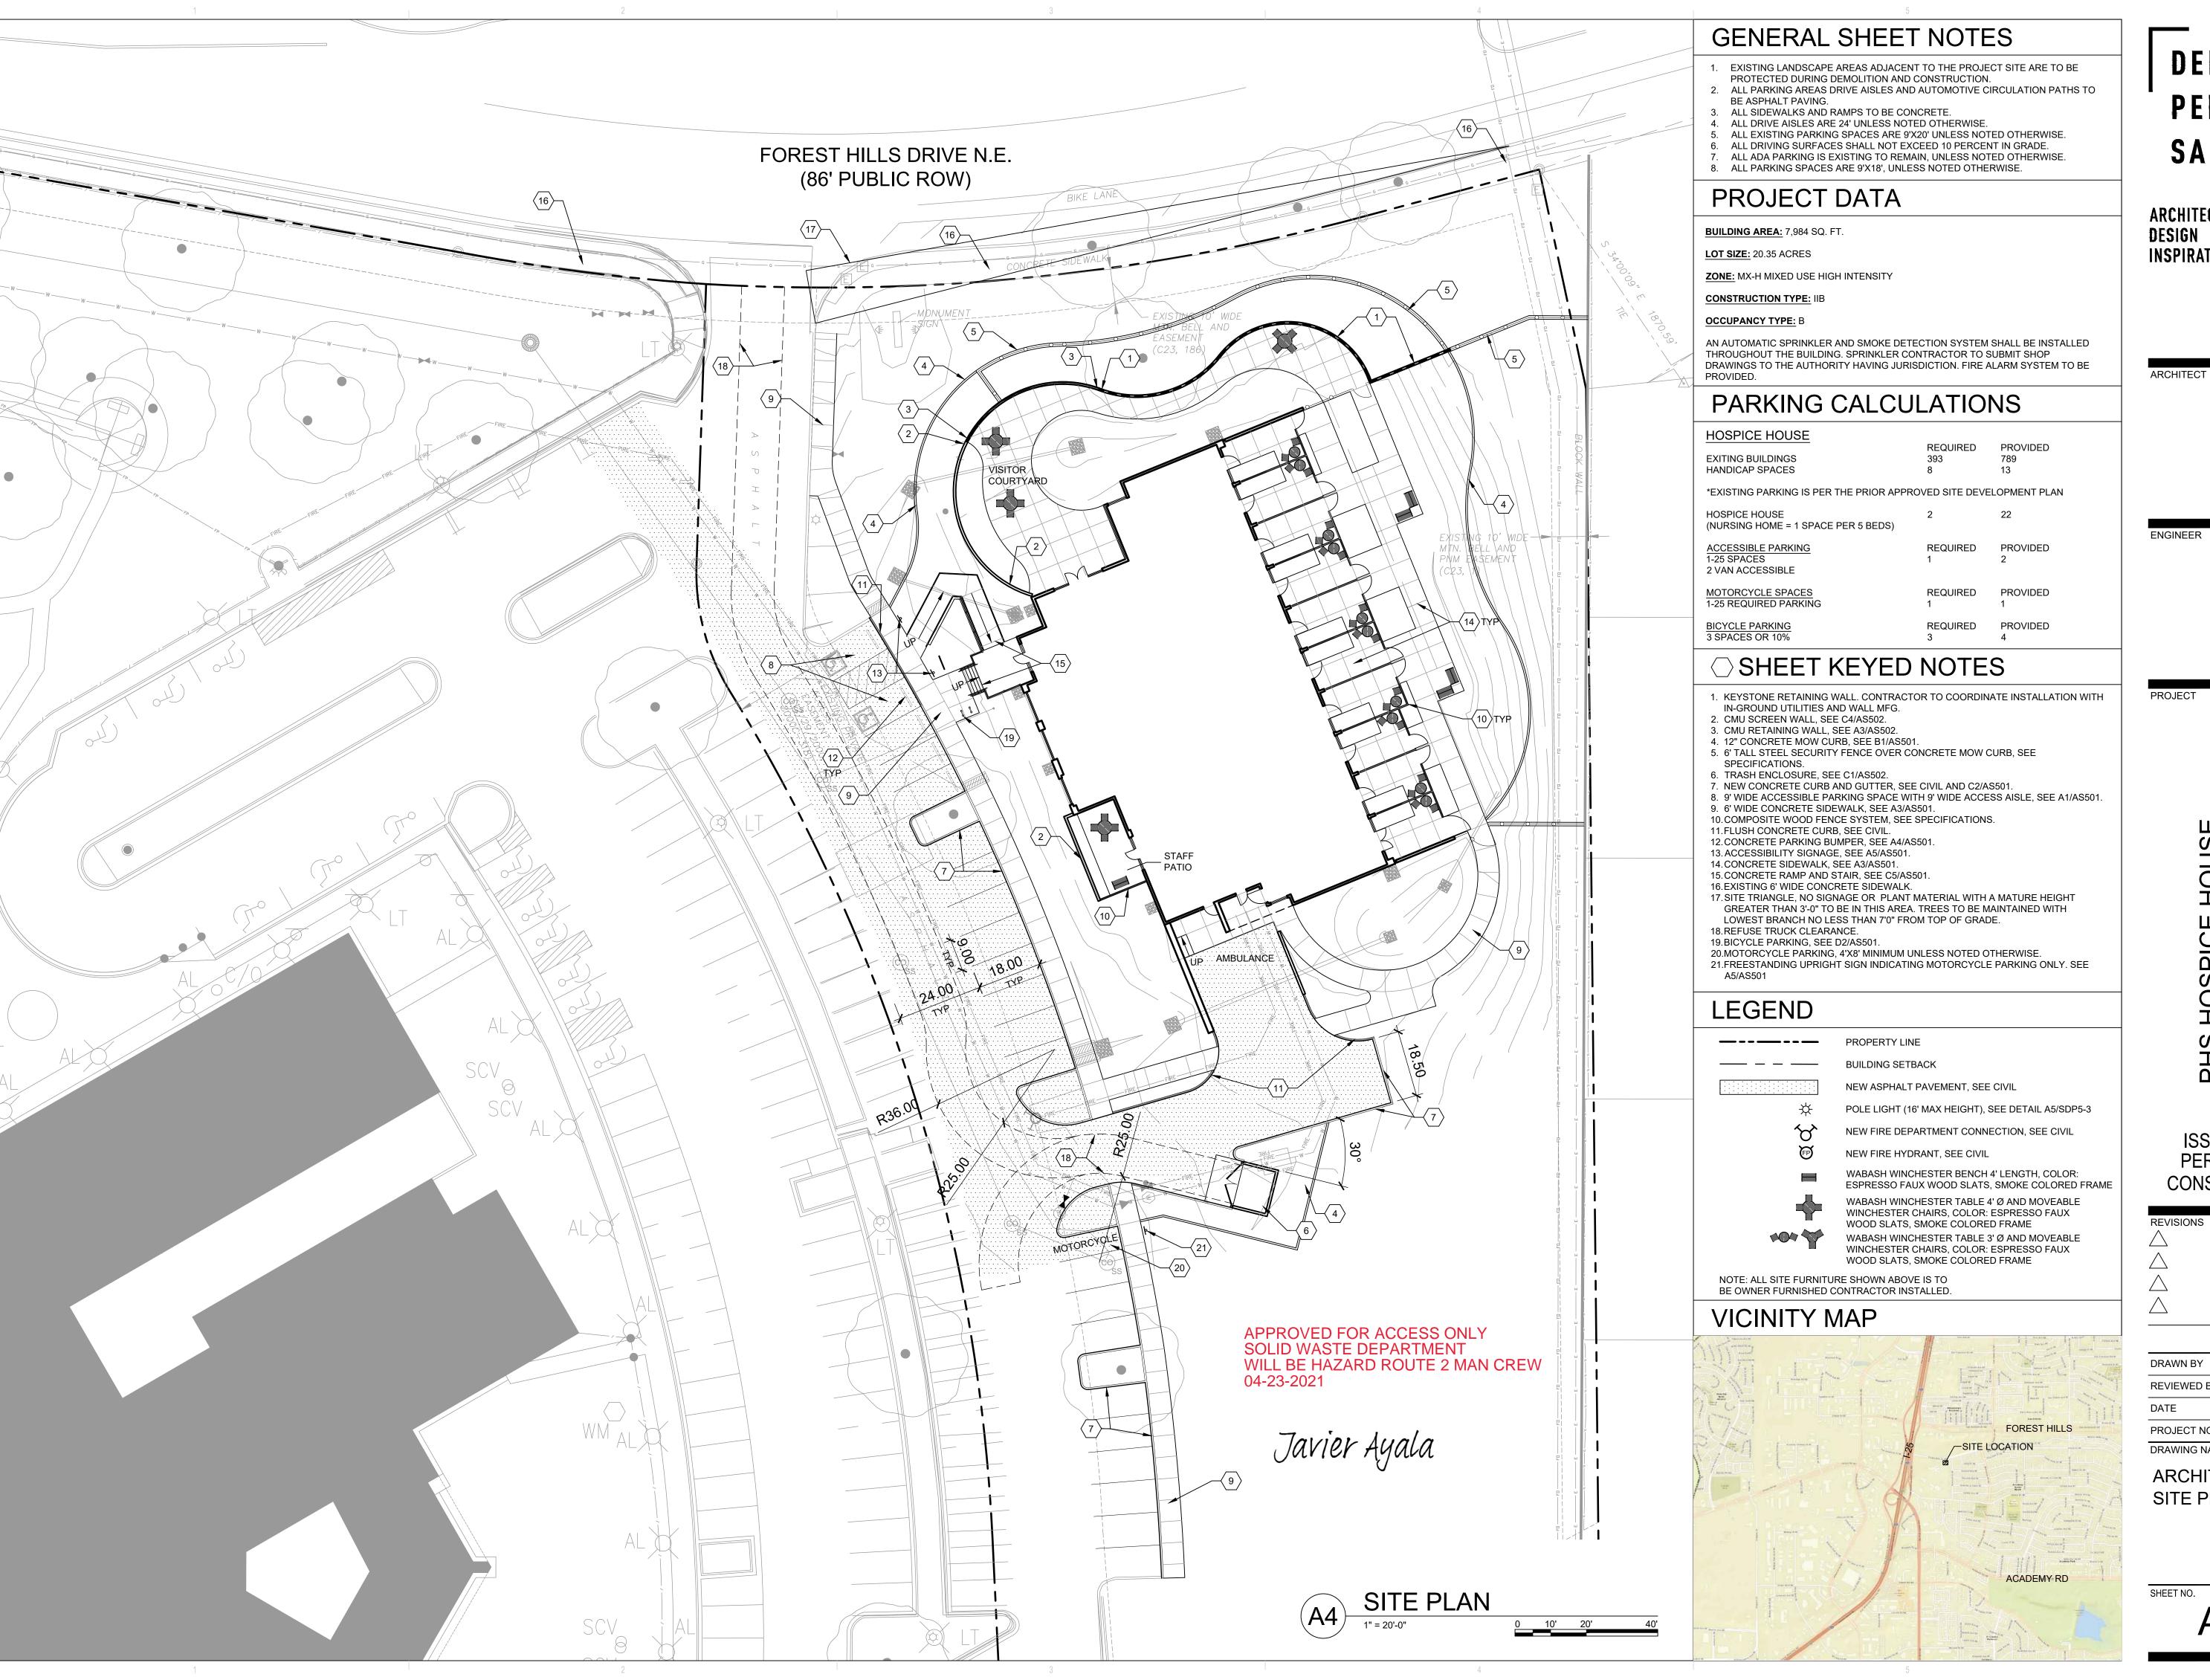
DRAWN BY A. SANTI REVIEWED BY G. EVERETT 02/25/2021 PROJECT NO. 20-0023 DRAWING NAME

SITE DETAILS

SHEET NO.

AS502



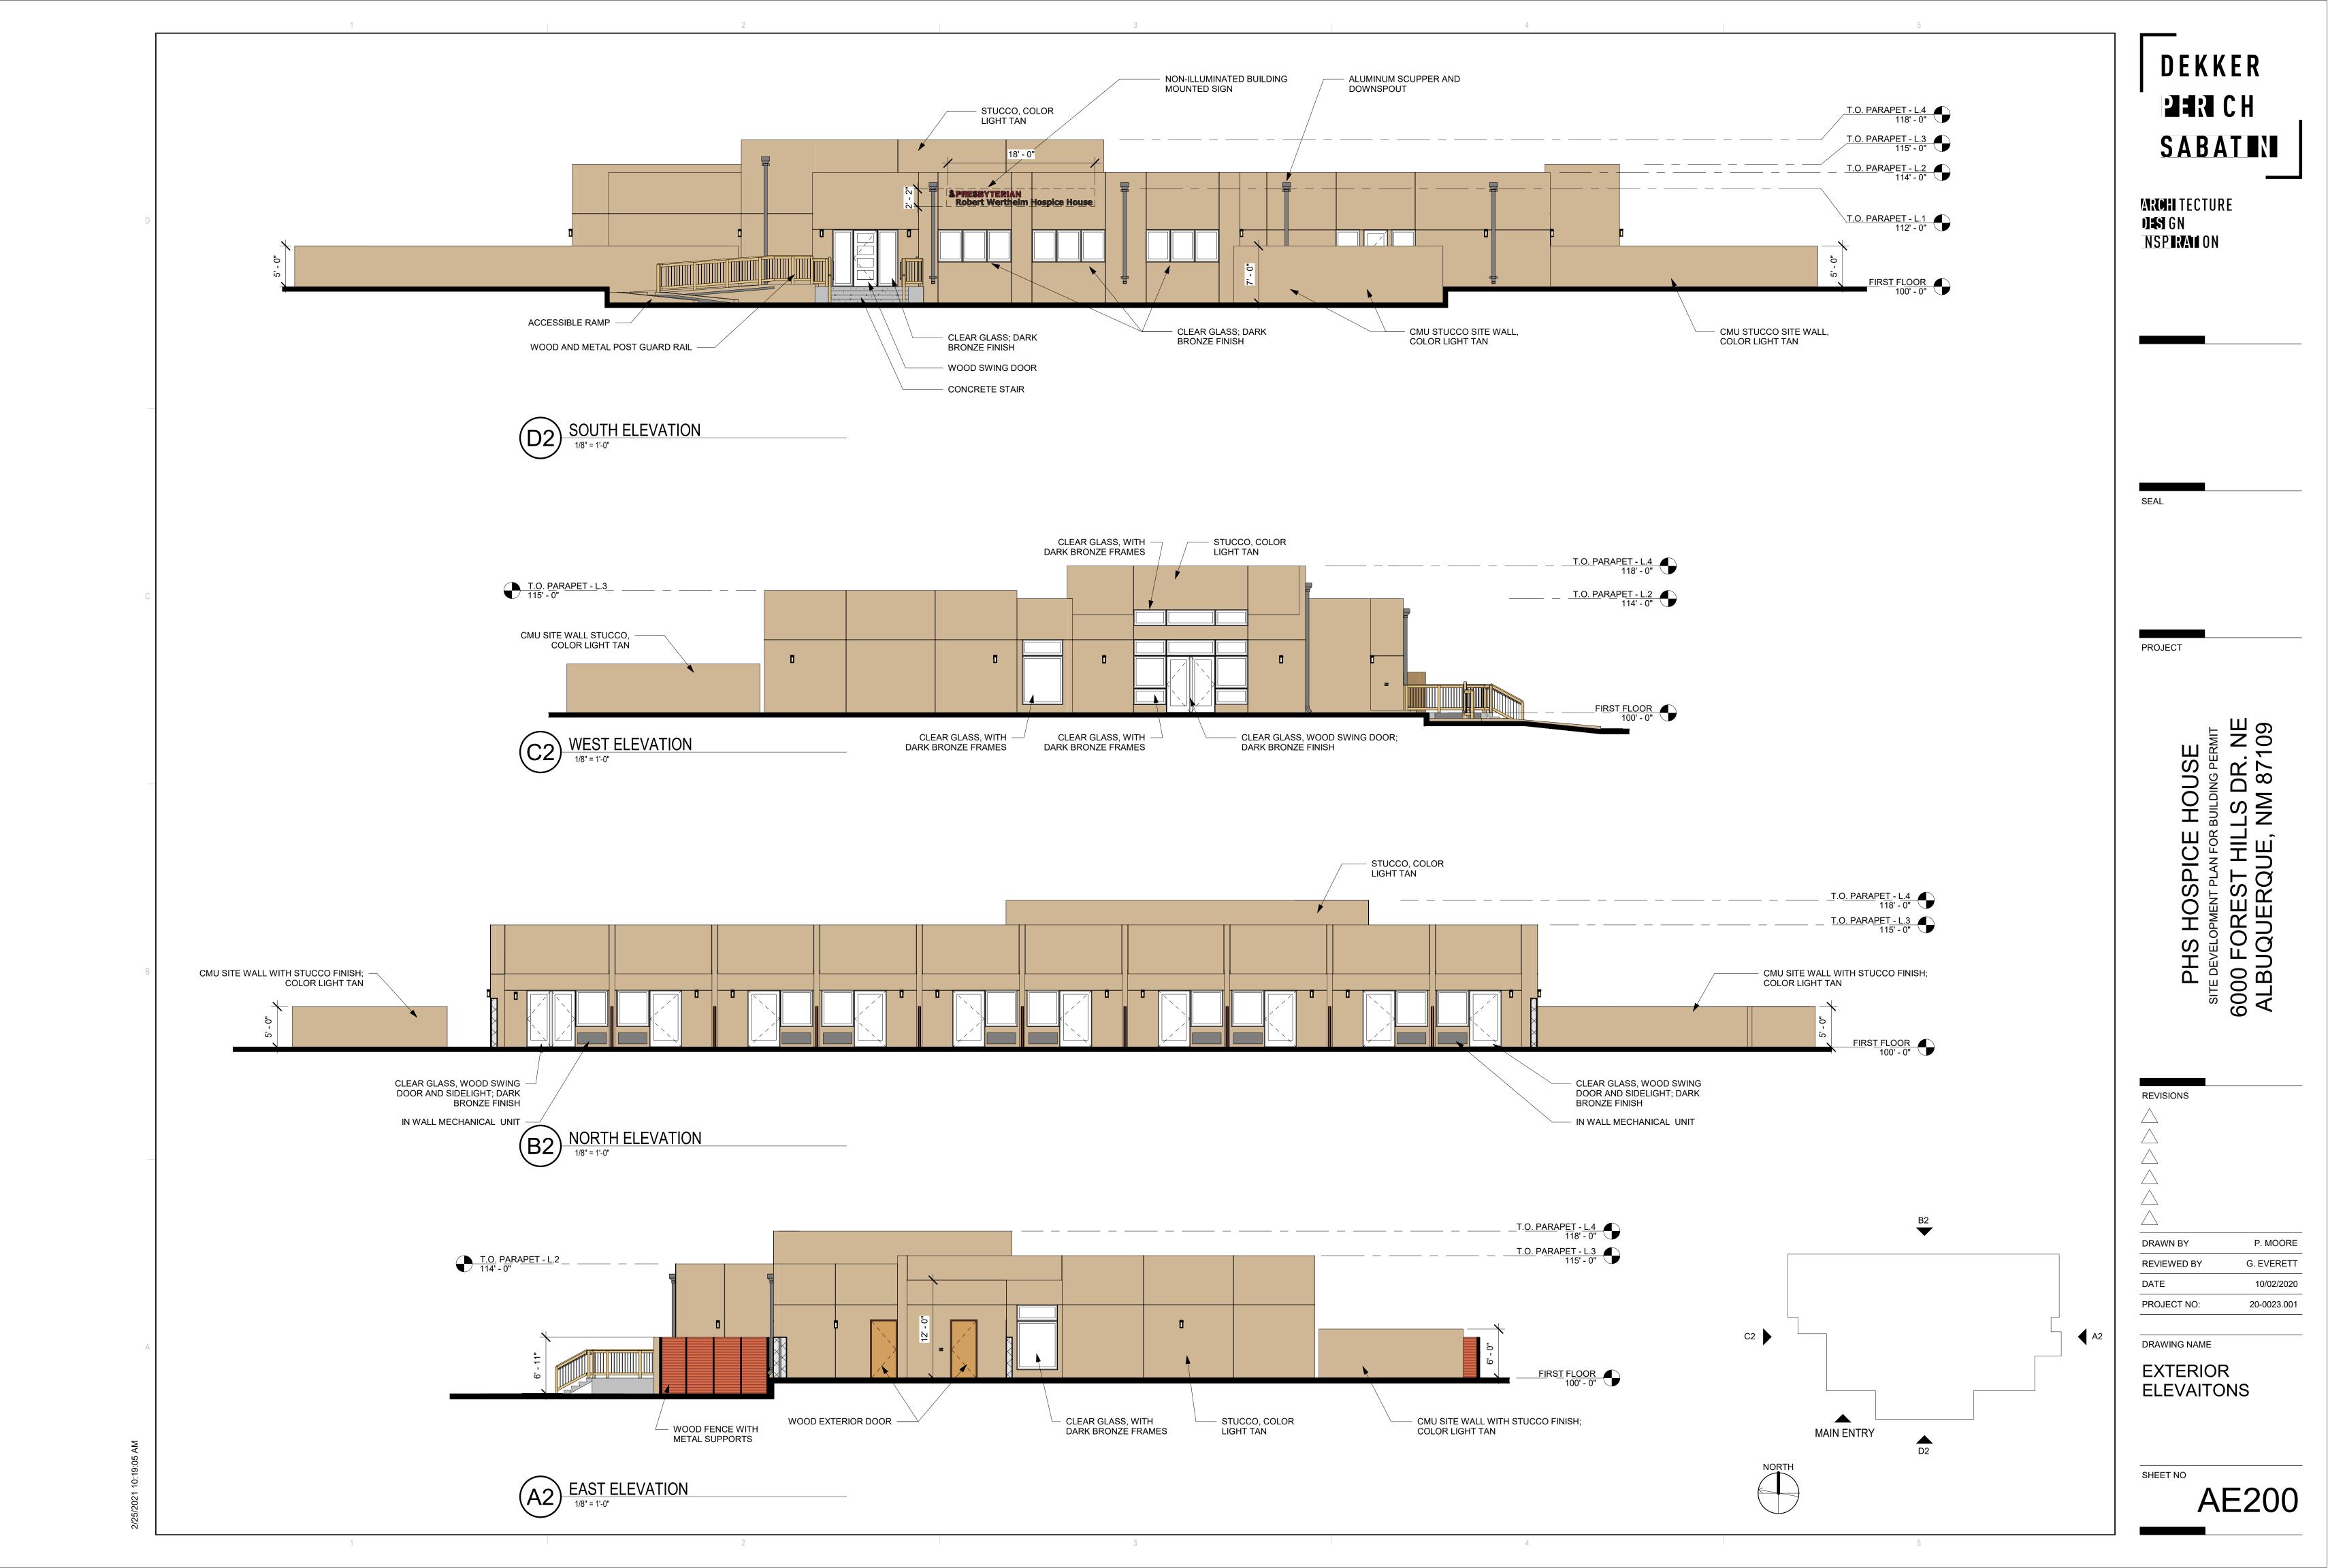

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DRAWING NAME ARCHITECTURAL

SITE PLAN

AS101