

GENERAL SHEET NOTES

- EXISTING LANDSCAPE AREAS ADJACENT TO THE PROJECT SITE ARE TO BE PROTECTED DURING DEMOLITION AND CONSTRUCTION. ALL PARKING AREAS DRIVE AISLES AND AUTOMOTIVE CIRCULATION PATHS TO BE ASPHALT PAVING.
- ALL SIDEWALKS AND RAMPS TO BE CONCRETE. ALL DRIVE AISLES ARE 24' UNLESS NOTED OTHERWISE.
- ALL EXISTING PARKING SPACES ARE 9'X20' UNLESS NOTED OTHERWISE.
- ALL DRIVING SURFACES SHALL NOT EXCEED 10 PERCENT IN GRADE.
- ALL ADA PARKING IS EXISTING TO REMAIN, UNLESS NOTED OTHERWISE.
 ALL PARKING SPACES ARE 9'X18', UNLESS NOTED OTHERWISE.

PROJECT DATA

BUILDING AREA: 7,984 SQ. FT.

LOT SIZE: 20.35 ACRES

ZONE: MX-H MIXED USE HIGH INTENSITY

CONSTRUCTION TYPE: IIB

OCCUPANCY TYPE: B


AN AUTOMATIC SPRINKLER AND SMOKE DETECTION SYSTEM SHALL BE INSTALLED THROUGHOUT THE BUILDING. SPRINKLER CONTRACTOR TO SUBMIT SHOP DRAWINGS TO THE AUTHORITY HAVING JURISDICTION. FIRE ALARM SYSTEM TO BE PROVIDED.

PARKING CALCULATIONS

HOSPICE HOUSE			
EXITING BUILDINGS HANDICAP SPACES	REQUIRED 393 8	PROVIDED 789 13	
*EXISTING PARKING IS PER THE PRIOR APPROVED SITE DEVELOPMENT PLAN			
HOSPICE HOUSE (NURSING HOME = 1 SPACE PER 5 BEDS)	2	22	
ACCESSIBLE PARKING 1-25 SPACES 2 VAN ACCESSIBLE	REQUIRED 1	PROVIDED 2	
MOTORCYCLE SPACES 1-25 REQUIRED PARKING	REQUIRED 1	PROVIDED 1	
BICYCLE PARKING 3 SPACES OR 10%	REQUIRED 3	PROVIDED 3	

○ SHEET KEYED NOTES

- I. KEYSTONE RETAINING WALL. CONTRACTOR TO COORDINATE INSTALLATION WITH IN-GROUND UTILITIES AND WALL MFG. 2. CMU SCREEN WALL, SEE C4/AS502.
- 3. CMU RETAINING WALL, SEE A3/AS502.
- 4. 12" CONCRETE MOW CURB, SEE B1/AS501. 5. 6' TALL STEEL SECURITY FENCE OVER CONCRETE MOW CURB, SEE
- SPECIFICATIONS.
- 6. TRASH ENCLOSURE, SEE C1/AS502.
- 7. NEW CONCRETE CURB AND GUTTER, SEE CIVIL AND C2/AS501. 8. 9' WIDE ACCESSIBLE PARKING SPACE WITH 9' WIDE ACCESS AISLE, SEE A1/AS501.
- 9. 6' WIDE CONCRETE SIDEWALK, SEE A3/AS501.
- 10. COMPOSITE WOOD FENCE SYSTEM, SEE SPECIFICATIONS. 11. FLUSH CONCRETE CURB, SEE CIVIL.
- 2.CONCRETE PARKING BUMPER, SEE A4/AS501
- 13. ACCESSIBILITY SIGNAGE, SEE A5/AS501. 14. CONCRETE SIDEWALK, SEE A3/AS501.
- 15. CONCRETE RAMP AND STAIR, SEE C5/AS501
- 16. EXISTING 6' WIDE CONCRETE SIDEWALK.

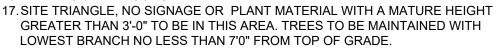

LEGEND

 PROPERTY LINE
 BUILDING SETBACK

-X

 \sim (FP)

- NEW ASPHALT PAVEMENT, SEE CIVIL
- POLE LIGHT (16' MAX HEIGHT), SEE DETAIL A5/SDP5-3
- NEW FIRE DEPARTMENT CONNECTION, SEE CIVIL
- NEW FIRE HYDRANT, SEE CIVIL


WABASH WINCHESTER BENCH 4' LENGTH, COLOR: ESPRESSO FAUX WOOD SLATS, SMOKE COLORED FRAME WABASH WINCHESTER TABLE 4' Ø AND MOVEABLE WINCHESTER CHAIRS, COLOR: ESPRESSO FAUX WOOD SLATS, SMOKE COLORED FRAME WABASH WINCHESTER TABLE 3' Ø AND MOVEABLE WINCHESTER CHAIRS, COLOR: ESPRESSO FAUX

WOOD SLATS, SMOKE COLORED FRAME

NOTE: ALL SITE FURNITURE SHOWN ABOVE IS TO BE OWNER FURNISHED CONTRACTOR INSTALLED.

VICINITY MAP

101 5

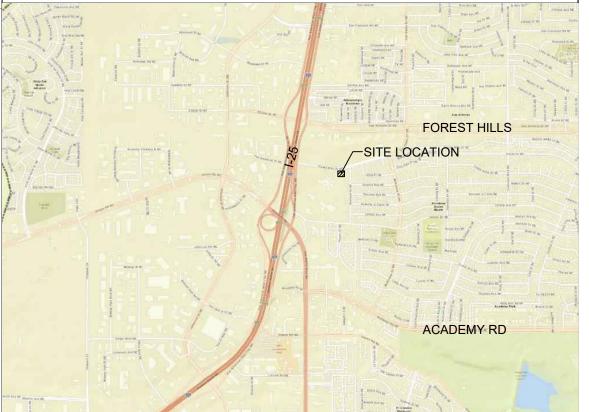

DEKKER PERICH SABATINI

ARCHITECTURE DESIGN INSPIRATION

	1
ARCHITECT	
ENGINEER	

PROJECT

USE Ш Z rΣ О Н 6000 FOREST HILLS D ALBUQUERQUE, N HOSPICE PHS

ADMINISTRATIVE AMENDMENT

REVISIONS \bigtriangleup \triangle \triangle \triangle

DRAWN BY	
REVIEWED BY	
DATE	02/25/2021
PROJECT NO.	20-0023
DRAWING NAME	

ARCHITECTURAL SITE PLAN

SHEET NO.





GRADING KEYED NOTES

- INSTALL HDPE (N12WT OR APPROVED EQUAL) STORM DRAIN F SLOPE.
- 2. GRASS LANDSCAPED SWALE. SEE LANDSCAPE PLAN FOR STA
- 3. INSTALL 24" SIDEWALK CULVERT PER COA STD DWG 2236.
- 4. INSTALL CURB OPENING PER DETAIL B2 SHEET C-201.
- 5. RETAINING WALL. SEE STRUCTURAL PLAN FOR DETAILS.
- 6. INSTALL RIP RAP PAD PER DETAIL A2 SHEET C-201.
- 7. INSTALL 10" NYLOPLAST STORM DRAIN INLET WITH DOME GRA
- 8. INSTALL 2-24' SIDEWALK CULVERTS PER COA STD DWG 2236.
- 9. DEPRESS LANDSCAPE AREA TO PROVIDED POSITIVE DRAINAG TO SIDEWALK CULVERT.
- 10. CENTER RIP RAP PAD ON ROOF DRAIN OUTFALL.
- 11. INSTALL TURNBLOCK IN WALL.
- 12. CURB TRANSITION, SEE PAVING PLAN.

NOTE

HDPE PIPE AND FITTINGS SHALL BE INSTALLED AND BACKFILLED PI MANUFACTURER SPECIFICATIONS. CONNECTIONS TO CONCRETE I CONCRETE DROP INLETS SHALL USE WATER STOP GASKETS AND S INSTALLED PER MANUFACTURER'S SPECIFICATIONS

NOTE

SIDEWALK CROSS-SLOPES SHALL BE AT A MINIMUM OF 1.0% AND A

NOTE

CONTRACTOR SHALL PROVIDE AS-BUILT GRADING INFORMATION S PROFESSIONAL SURVEYOR. AS-BUILT INFORMATION REQUIRED SI COORDINATED WITH THE ENGINEER AND SHALL BE SUFFICIENTLY VERIFY THAT THE DRAINAGE WILL FUNCTION IN ACCORDANCE WIT AS-BUILT DATA SHALL BE PROVIDED AT LEAST 5 WORKING DAYS PI CONTRACTOR'S REQUEST FOR PERMANENT CERTIFICATE OF OCCU MINIMUM, AS-BUILT DATA SHALL INCLUDE:

> ALL GRATES AND INVERTS OF CATCH BASINS APPROXIMATELY 75% OF ALL DESIGN SPOT ELEVA • • FLOOR ELEVATIONS.

LEGEND _____ _ _ _ ___ LIMITS OF GRADING PROPERTY LINE PROPOSED SPOT ELEN TC=TOP OF CURB FL=FLOW LINE • 95.40 TOC=TOP OF CONCF TS=TOP OF SIDEWAI TG=TOP OF GRATE FG=FINISHED GRADE FGH=FINISHED GRAI FGL=FINISHED GRAI INV=INVERT EXISTING INDEX CONT - 4960 — — 4959 — EXISTING INTERMEDIA DIRECTION OF FLOW _____**>** WATER BLOCK/GRADE \bigcirc PROPOSED STORM DR/ PROPOSED STORM DR/ PROPOSED STORM DR/

1"=20' ON 24"X36" SHEET 4

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	GRADING GENERAL NOTES		
N PIPE. SEE PLAN FOR SIZE AND	A. EXCEPT AS PROVIDED HEREIN, GRADING SHALL BE PERFORMED AT THE ELEVATIONS AND IN ACCORDANCE WITH THE DETAILS SHOWN ON THIS PLAN.	OVIDED HEREIN, GRADING SHALL BE PERFORMED AT THE ELEVATIONS AND IN WITH THE DETAILS SHOWN ON THIS PLAN.	
TABILIZATION.	B. THE COST FOR REQUIRED CONSTRUCTION DUST AND EROSION CONTROL MEASURES SHALL BE INCIDENTAL TO THE PROJECT COST, AND INCLUDED IN THE GMP.	PERICH	
	C. EARTH SLOPES SHALL NOT EXCEED 3 HORIZONTAL TO 1 VERTICAL UNLESS SHOWN OTHERWISE.D. IT IS THE INTENT OF THESE PLANS THAT THIS CONTRACTOR SHALL NOT PERFORM ANY WORK	SABATINI	
	OUTSIDE OF THE PROPERTY BOUNDARIES EXCEPT AS REQUIRED BY THIS PLAN.		
	E. THE CONTRACTOR SHALL ENSURE THAT NO SOIL ERODES FROM THE SITE ONTO ADJACENT PROPERTY OR PUBLIC RIGHT-OF-WAY.	ARCHITECTURE	
GRATE. 6. IAGE FROM ROOF DRAIN OUTLET	F. A DISPOSAL SITE FOR ANY & ALL EXCESS EXCAVATION MATERIAL, AND UNSUITABLE MATERIAL AND/OR A BORROW SITE CONTAINING ACCEPTABLE FILL MATERIAL SHALL BE OBTAINED BY THE CONTRACTOR IN COMPLIANCE WITH APPLICABLE ENVIRONMENTAL REGULATIONS AND APPROVED BY THE INSPECTOR. ALL COSTS INCURRED IN OBTAINING A DISPOSAL OR BORROW SITE AND HAUL TO OR FROM SHALL BE CONSIDERED INCIDENTAL TO THE PROJECT AND NO SEPARATE MEASUREMENT OR PAYMENT SHALL BE MADE.	DESIGN INSPIRATION	
	G. PAVING AND ROADWAY GRADES SHALL BE +/-0.1' FROM PLAN ELEVATIONS. PAD ELEVATION SHALL BE +/-0.05' FROM BUILDING PLAN ELEVATION.		
	H. ALL PROPOSED CONTOURS REFLECT TOP OF PAVEMENT ELEVATIONS IN THE PARKING AREA AND MUST BE ADJUSTED FOR MEDIANS AND ISLANDS.		
	I. VERIFY ALL ELEVATIONS SHOWN ON PLAN FROM BASIS OF ELEVATION CONTROL STATION PRIOR TO BEGINNING CONSTRUCTION.	ARCHITECT	
) PER TE MANHOLES AND D SHALL BE	J. THE CONTRACTOR SHALL PROVIDE AS-BUILTS SURVEY DATA TO ENSURE COMPLIANCE WITH THE CONSTRUCTION DOCUMENTS. THE SURVEY SHALL BE PERFORMED BY A PROFESSIONAL SURVEYOR LICENSED IN THE THE STATE OF NEW MEXICO. THE AS-BUILT DRAWING SHALL BE CERTIFIED BY THE SURVEYOR OF RECORD.		
	GENERAL NOTES	ENGINEER	
D A MAXIMUM OF 2.0%	A. ALL WORK DETAILED ON THESE PLANS AND PERFORMED UNDER THIS CONTRACT SHALL BE CONSTRUCTED IN ACCORDANCE WITH THE PROJECT SPECIFICATIONS AND THE PROJECT GEOTECHNICAL REPORT. WHERE APPLICABLE, CITY OF ALBUQUERQUE STANDARD SPECIFICATIONS SHALL APPLY.	THEW H. SAICH	
	B. THE CONTRACTOR SHALL ABIDE BY ALL LOCAL, STATE, AND FEDERAL LAWS, RULES AND REGULATIONS WHICH APPLY TO THE CONSTRUCTION OF THESE IMPROVEMENTS, INCLUDING EPA REQUIREMENTS WITH RESPECT TO STORM WATER DISCHARGE.	PROFESSIONAL	
N STAMPED BY A SHALL BE LY DETAILED TO VITH THE DESIGN. & PRIOR TO CCUPANCY. AT A	C. PRIOR TO CONSTRUCTION, THE CONTRACTOR SHALL FIELD VERIFY THE HORIZONTAL AND VERTICAL LOCATIONS OF ALL POTENTIAL OBSTRUCTIONS INCLUDING ALL UNDERGROUND UTILITIES. SHOULD A CONFLICT EXIST, THE CONTRACTOR SHALL NOTIFY THE CONSTRUCTION OBSERVER OR ENGINEER SO THAT THE CONFLICT CAN BE RESOLVED WITH A MINIMUM AMOUNT OF DELAY.	PROJECT	
	D. TWO (2) WORKING DAYS PRIOR TO ANY EXCAVATION, THE CONTRACTOR SHALL CONTACT LINE LOCATING SERVICE FOR LOCATION OF EXISTING UTILITIES.		
EVATIONS & FINISHED	E. ALL ELECTRICAL, TELEPHONE, CABLE TV, GAS AND OTHER UTILITY LINES, CABLES, AND APPURTENANCES ENCOUNTERED DURING CONSTRUCTION THAT REQUIRE RELOCATION, SHALL BE COORDINATED WITH THAT UTILITY. THE CONTRACTOR SHALL BE RESPONSIBLE FOR COORDINATION OF ALL NECESSARY UTILITY ADJUSTMENTS. NO ADDITIONAL COMPENSATION WILL BE ALLOWED FOR DELAYS OR INCONVENIENCES CAUSED BY UTILITY COMPANY WORK CREWS. THE CONTRACTOR MAY BE REQUIRED TO RESCHEDULE HIS ACTIVITIES TO ALLOW UTILITY CREWS TO PERFORM THEIR REQUIRED WORK.	N B M. NE	
	F. THE CONTRACTOR IS RESPONSIBLE FOR PROTECTING ALL EXISTING UTILITY LINES WITHIN THE CONSTRUCTION AREA. ANY DAMAGE TO EXISTING FACILITIES CAUSED BY CONSTRUCTION ACTIVITY SHALL BE REPAIRED OR REPLACED AT THE CONTRACTOR'S EXPENSE AND APPROVED BY THE CONSTRUCTION OBSERVER.	E HOL NUE, NM	
	G. CONSTRUCTION ACTIVITY SHALL BE LIMITED TO THE PROPERTY AND/OR PROJECT LIMITS. ANY DAMAGE TO ADJACENT PROPERTIES RESULTING FROM THE CONSTRUCTION PROCESS SHALL BE REPAIRED OR REPLACED AT THE CONTRACTOR'S EXPENSE.	OSPIC DREST HI	
	H. OVERNIGHT PARKING OF CONSTRUCTION EQUIPMENT SHALL NOT OBSTRUCT DRIVEWAYS OR DESIGNATED TRAFFIC LANES. THE CONTRACTOR SHALL NOT STORE ANY EQUIPMENT OR MATERIAL WITHIN THE PUBLIC RIGHT-OF-WAY.	HO HO	
	I. THE CONTRACTOR SHALL OBTAIN ALL THE NECESSARY PERMITS FOR THE PROJECT PRIOR TO COMMENCING CONSTRUCTION (I.E., BARRICADING, TOPSOIL DISTURBANCE, EXCAVATION PERMITS, EPA STORM WATER PERMITS, ETC.).	PHS HC 6000 FOI ALBU	
	J. ALL PROPERTY CORNERS DESTROYED DURING CONSTRUCTION SHALL BE REPLACED AT THE CONTRACTOR'S EXPENSE. ALL PROPERTY CORNERS MUST BE RESET BY A REGISTERED LAND SURVEYOR.	ADMINISTRATIVE	
EVATION 3	K. THE CONTRACTOR SHALL PREPARE A CONSTRUCTION TRAFFIC CONTROL AND SIGNING PLAN AND OBTAIN APPROVAL OF SUCH PLAN FROM THE BERNALILLO COUNTY, TRAFFIC ENGINEERING DEPARTMENT, PRIOR TO BEGINNING ANY CONSTRUCTION WORK ON OR ADJACENT TO EXISTING STREETS.	AMENDMENT	
NCRETE NALK IE ADE	L. ALL BARRICADES AND CONSTRUCTION SIGNING SHALL CONFORM TO APPLICABLE SECTIONS OF THE "MANUAL ON UNIFORM TRAFFIC CONTROL DEVICES" (MUTCD), US DEPARTMENT OF TRANSPORTATION, LATEST EDITION.	REVISIONS	
RADE HIGH RADE LOW	M. THE CONTRACTOR SHALL MAINTAIN ALL CONSTRUCTION BARRICADES AND SIGNING AT ALL TIMES. THE CONTRACTOR SHALL VERIFY THE PROPER LOCATION OF ALL BARRICADING AT THE END AND BEGINNING OF EACH DAY.	$ \begin{array}{c} \bigtriangleup \\ \bigtriangleup \\ \land \end{array} \end{array} $	
NTOUR	N. THE CONTRACTOR SHALL TAKE ALL STEPS NECESSARY TO CONFORM WITH EPA REQUIREMENTS, INCLUDING COMPLIANCE WITH NPDES PHASE 2 REQUIREMENTS.	Δ	
DIATE CONTOUR	0. THE CONTRACTOR SHALL PROVIDE 1 HARD COPY AND 1 ELECTRONIC COPY OF THE EPA STORM WATER POLLUTION PREVENTION PLAN ALONG WITH THE APPROPRIATE SUBMITTAL FEE TO CITY		
V DE BREAK	OF ALBUQUERQUE TWO WEEKS PRIOR TO THE START OF SITE DISTURBANCE.	DRAWN BY BF REVIEWED BY MS	
DRAIN MANHOLE		DATE 02/24/2021	
DRAIN INLETS		PROJECT NO. 20-0023 DRAWING NAME	
DRAIN CAP			
		GRADING PLAN	


Bohannan Huston www.bhinc.com 800.877.5332

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SHEET NO. C-100

RF MS 02/24/2021 20-0023

GRADING PLAN



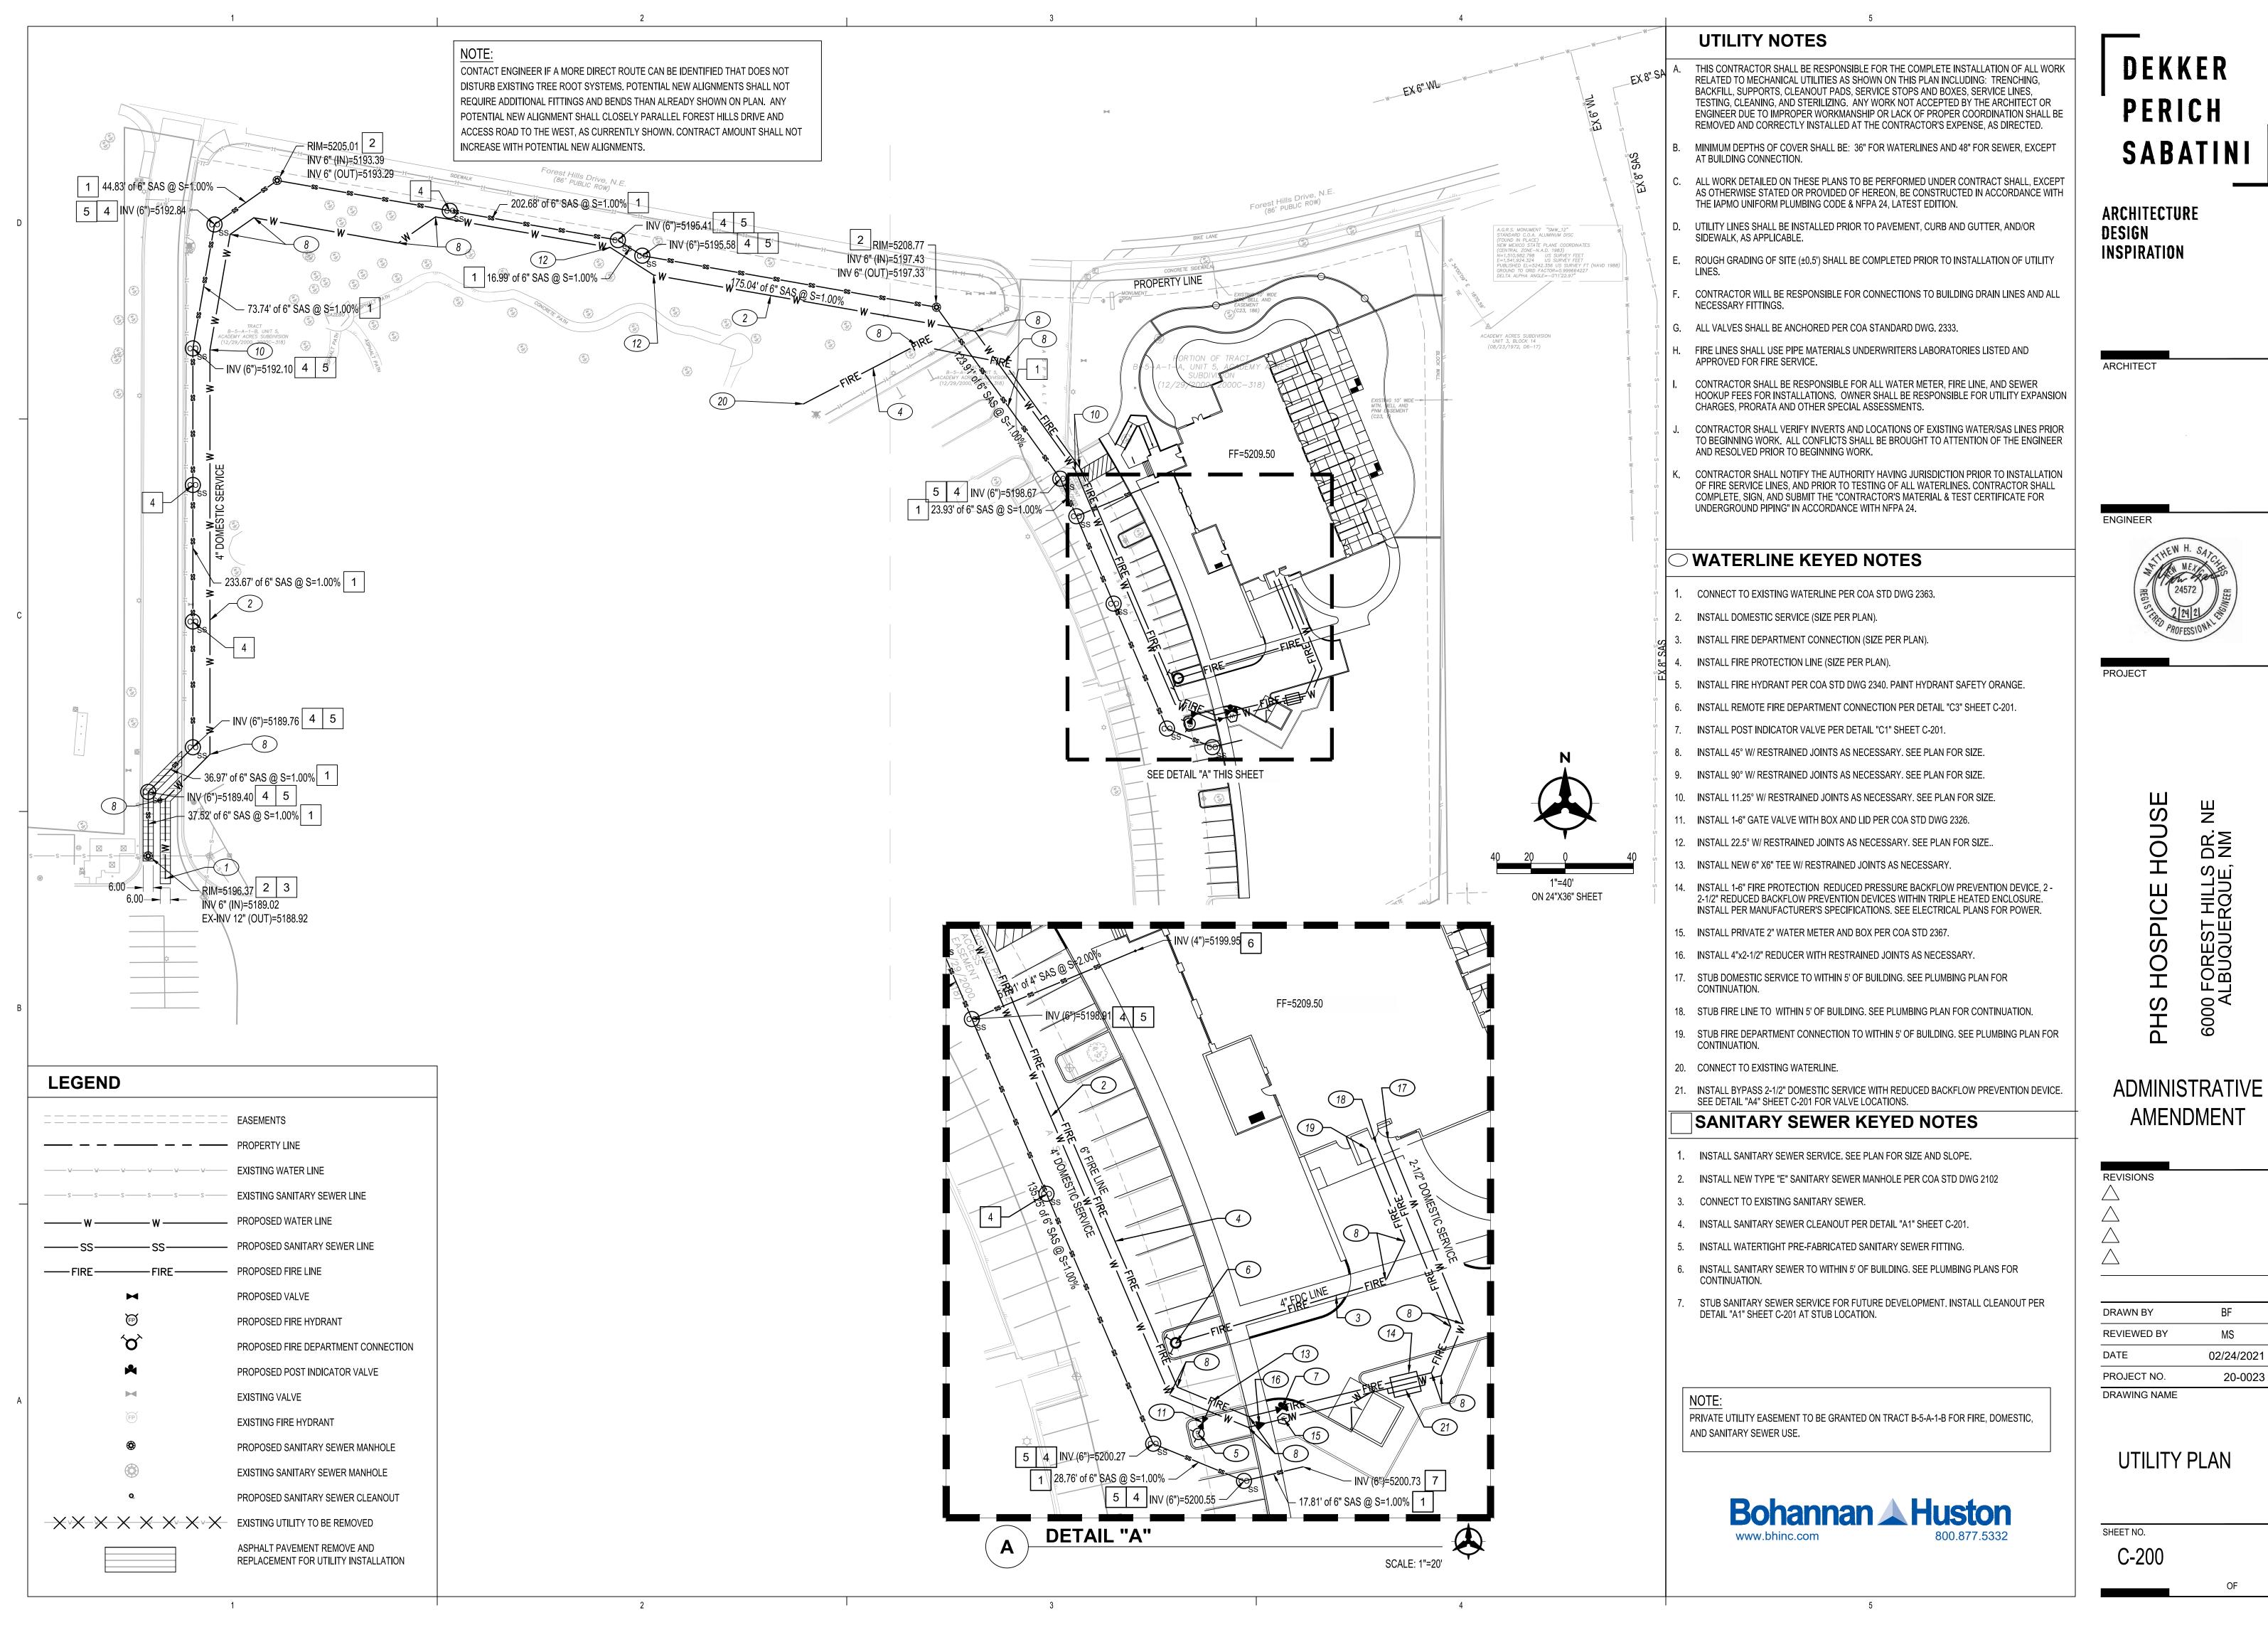


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PLANT LEGEND COMMON NAME TREES REDPOINTE RED MAPLE NEW MEXICO PRIVET URBANITE ASH TUSCARORA CRAPE MYRTLE VELVET PILLAR CRABAPPLE PINON PINE AUSTRIAN BLACK PINE COTTONLESS RIO GRANDE (\mathcal{A} GREEN GIANT ARBORVITAE COMMON NAME SHRUBS BLACK KNIGHT BUTTERFLY E $\langle \circ \rangle$ WINTER GEM JAPANESE BOX GREEN TOWER COMMON BO $\langle + \rangle$ RED TWIG DOGWOOD LENA`S BROOM PURPLE PIG CRAPE MYRTLE ÷ **`PINKIE` INDIAN HAWTHORNE** (+)PINK SPLASH CARPET GROU R SUNNY KNOCK OUT YELLOW $\langle \! \rangle$ ARP ROSEMARY (+)BLUE SPIRES ROSEMARY NOTES: LITTLE DARLING LILAC 1. PRIOR TO BACKFILLING, MATERIAL SUCH AS CONTAINERS, WIRE, BURLAP AND ROPE SHALL BE COMPLETELY REMOVED. GRASSES COMMON NAME ROOT FLARE TO BE FLUSH WITH FINISH GRADE. SB. BLUE AVENA OAT GRASS REMOVE SOIL TO EXPOSE ROOT FLARE MAIDEN GRASS ROTARY TILL PLANT PIT; REMOVE SOIL. BACKFILL PER SPECIFICATIONS 3.5 REGAL MIST PINK MUHLY GR 22 pm mm PLANT MULCH PER DRAWINGS Sound States EL TORO MUHLY GRASS 23° 5200 WEED BARRIER FABRIC GROUNDCOVERS COMMON NAME ROUGH-UP SIDES OF PLANTING PIT LARGE YELLOW DAFFODIL ROOTBALL ON UNDISTURBED SOIL COMMON NAME 3 TIMES ROOTBALL DIAMETER PERENNIALS \bigoplus HOLLYHOCK \bigcirc DWARF PLUMBAGO SHRUB IN BED (A2) \bigcirc SUPREME CANTALOUPE CON 3/4" = 1'-0" E. POWWOW WILD BERRY CONE NOTE: 1. PRIOR TO BACKFILLING, MATERIAL SUCH AS CONTAINERS, WIRE, BURLAP AND ROPE SHALL BE COMPLETELY REMOVED. ENDLESSLILY CORAL DAYLIL - ROOT FLARE TO BE FLUSH WITH FINISH GRADE. NO \bigoplus MULCH 1"-2" FROM TRUNK HIDCOTE SUPERIOR BLUE LA FLARE SLOPE GRADE AWAY FROM TRUNK FAT BUD FRENCH LAVENDER $\langle \cdots \rangle$ - ROTARY TILL PLANT PIT; REMOVE SOIL, BACKFILL FURMAN`S RED SALVIA PER SPECIFICATIONS VINES COMMON NAME TREE TO BE SET PLUMB — - MULCH PER DRAWINGS TRUMPET CREEPER VINE WEED BARRIER FABRIC ENGLISH IVY \triangle BRITE EYES CLIMBING ROSE ROUGH-UP SIDES OF ROOTBALL ON UNDISTURBED SOIL <u>عالد</u> <u>عالد</u> 3 TIMES ROOTBALL DIAMETER TREE IN PLANTING BED (A1) 3/4" = 1'-0"

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	A. RESPONSIBILITY FOR MAINTENANCE: THE CONTRACTOR WILL BE RESPONSIBLE	DEKKER
	FOR MAINTENANCE OF THE LANDSCAPE DURING CONSTRUCTION AND DURING A 90 DAY-MAINTENANCE PERIOD FOLLOWING SUBSTANTIAL COMPLETION. THE OWNER WILL BE RESPONSIBLE FOR MAINTENANCE FOLLOWING THE 90-DAY MAINTENANCE PERIOD.	PERICH
	 B. STATEMENT OF COMPLIANCE WITH CITY OF ALBUQUERQUE: THE LANDSCAPE DESIGN WILL COMPLY WITH THE CITY OF ALBUQUERQUE'S LANDSCAPING, BUFFERING, AND SCREENING REGULATIONS (14-16-5-6), WATER CONSERVATION ORDINANCE AND POLLEN ORDINANCE. C. TIMING OF LANDSCAPE INSTALLATION: INSTALLATION OF THE LANDSCAPING SHALL BE COMPLETE WITHIN 60 DAYS OF THE RELATED BUILDING'S OCCUPANCY. 	SABATINI
	D. SURFACE TREATMENT: DISTURBED LANDSCAPE AREAS ARE OR SHALL BE COVERED WITH TURF, OR VEGETATION AND MULCH. ORGANIC MULCH IS REQUIRED AT EACH NEW TREE ROOTBALL AREA/DRIPLINE.	ARCHITECTURE
	 E. LANDSCAPE AND SIGNAGE WILL NOT INTERFERE WITH CLEAR SIGHT REQUIREMENTS. THEREFORE SIGNS, WALLS, TREES AND SHRUBS BETWEEN 3 AND 7 FEET TALL (AS MEASURED FROM THE GUTTER PAN) WILL NOT BE PERMITTED IN THE CLEAR SIGHT TRIANGLE. F. MINIMUM PLANT SIZES ARE AS PER CITY OF ALBUQUERQUE STANDARDS PER TABLE 5-6-1 OF THE IDO. G. LANDSCAPE AREAS THAT AREA DISTURBED DURING CONSTRUCTION WILL BE REPAIRED TO THEIR ORIGINAL CONDITION. 	DESIGN INSPIRATION
TTONWOOD	 H. VEGETATIVE SCREENING SURROUNDING GROUND-MOUNTED TRANSFORMERS AND UTILITY PADS SHALL ALLOW 10' OF CLEARANCE MINIMUM IN FRONT OF THE EQUIPMENT DOOR AND 5' OF CLEARANCE MINIMUM ON THE REMAINING SIDES FOR SAFE OPERATION AND MAINTENANCE. I. EXISTING PLANT MATERIAL TO BE PRESERVED ON THE PROPERTY IS SHOWN AND 	
	QUANTIFIED IN THE LANDSCAPE CALCULATIONS. J. SEE SITE PLAN FOR IMPERVIOUS AREAS AND EASEMENTS.	ARCHITECT
SH	IRRIGATION NOTES	
OOD	 A. THE IRRIGATION FOR NEW CONSTRUCTION AREAS IS CONNECTED TO THE SITE'S EXISTING IRRIGATION SYSTEM. B. THE IRRIGATION SYSTEM DESIGN IS BE BASED ON RECORD DRAWINGS AND OWNER'S REPRESENTATIVE'S INFORMATION TO SPECIFY EXISTING IRRIGATION EQUIPMENT AND 	
VOOD	 DATA. RECORD DRAWINGS ARE AVAILABLE UPON REQUEST. C. THE IRRIGATION SYSTEM IS COMPRISED OF THE FOLLOWING: AN EXISTING POINT OF CONNECTION AND CONTROLLER ARE LOCATED XXXX. THE EXISTING CONTROLLER WILL OPERATE NEW AND EXISTING IRRIGATION. THE CURRENT VACUUM BREAKER WILL BE REMOVED AND REPLACED WITH A NEW BACKFLOW PREVENTER THAT COMPLIES WITH THE CITY OF ALBUQUERQUE BACKFLOW PREVENTION DEVICE STANDARDS AND SPECIFICATIONS. THE IRRIGATION ZONES BEING CREATED OR MODIFIED WITH THIS PROJECT ARE 	ENGINEER
	COMPRISED OF THE FOLLOWING: • NEW DRIP IRRIGATION ZONES. • RETROFIT ZONES THAT ARE IRRIGATING EXISTING PLANTS AND TURF. D. THE NEW DRIP IRRIGATION ZONES ARE DESIGNED TO MINIMIZE THE USE OF WATER. E. THE NEW AND RETROFIT IRRIGATION ZONES WILL NOT IRRIGATE IMPERVIOUS	
	SURFACES, INCLUDING SIDEWALKS, DRIVEWAYS, STREETS, PARKING, AND LOADING AREAS. F. THE NEW AND RETROFIT IRRIGATION ZONE'S RUN TIMES ARE BASE UPON PLANT SPECIES AND ESTABLISHMENT. THE CONTRACTOR SHALL ADJUST RUN TIMES	PROJECT
COVER ROSE	ACCORDING TO PLANT MATURITY, SEASON, LOCATION, AND PLANT PERFORMANCE. G. THE CONTRACTOR SHALL AUDIT THE EXISTING IRRIGATION SYSTEM TO DETERMINE ITS EXTENTS, PERFORMANCE, AND CONDITION. THE CONTRACTOR SHALL VERIFY THE EXISTING SYSTEM AND NOTE WATER METERS, SHUT-OFF VALVES, BACKFLOW	
	 PREVENTION ASSEMBLIES, PIPING, STATIONS AND OTHER COMPONENTS NECESSARY TO MANAGE DISTURBANCE, REPLACEMENT, AND OPERATION DURING CONSTRUCTION. H. THE CONTRACTOR SHALL PROTECT THE EXISTING IRRIGATION SYSTEM TO ENSURE THAT REMAINING PLANT MATERIAL RECEIVES IRRIGATION DURING CONSTRUCTION. THE CONTRACTOR MAY TEMPORARILY MODIFY THE EXISTING IRRIGATION SYSTEM TO ASSURE IRRIGATION TO THE REMAINING PLANT MATERIALS DURING CONSTRUCTION. I. THE CONTRACTOR SHALL OBTAIN NECESSARY PERMITS REQUIRED TO PERFORM THE WORK INDICATED HEREIN BEFORE BEGINNING WORK. 	
	LANDSCAPE CALCULATIONS	OUSE NM NM NM
S	REQUIRED VEGETATIVE COVERAGE TOTAL NEW MULCHED LANDSCAPE AREA PROVIDED: 12,203 TOTAL VEGETATIVE COVER REQUIRED = 9153 SF (75% OF TOTAL MULCHED LANDSCAPE AREA) TOTAL VEGETATIVE COVER PROVIDED = 10,263 SF (84% OF TOTAL MULCHED LANDSCAPE AREA)	ICE H HILLS RQUE,
	TOTAL GROUND-LEVEL PLANT COVER REQUIRED = 3050 SF (25% OF TOTAL MULCHED LANDSCAPE AREA) TOTAL GROUND-LEVEL PLANT COVER PROVIDED = 3254 SF (26% OF TOTAL MULCHED LANDSCAPE AREA)	FOR LBUG
	GROUND COVER MATERIAL TOTAL ROCK MULCH GROUND COVER = 8420 SF (69% OF MULCHED LANDSCAPE AREA) TOTAL ORGANIC MULCH GROUND COVER = 3783 SF (31% OF MULCHED LANDSCAPE AREA) A MAXIMUM OF 75% OF GRAVEL OR CRUSHER FINES IS PERMITTED. A MINIMUM OF 25% ORGANIC MULCH IS REQUIRED. 14-16-5-6(c)(5)(d)	PHS 6000
		ADMINISTRATIVE AMENDMENT
LOWER	 VEGETATED SWALE, SEE B3/LP501 PROTECT AND REPAIR EXISTING IRRIGATION SYSTEM AND EXISTING LANDSCAPING IN THIS AREA, SEE IRRIGATION NOTES. 	
OWER.	 LOCATION OF FUTURE WATER FEATURE. WATER AND POWER TO BE PROVIDED. TREE PLANTED IN TURF, SEE A4/LP501 SITE TRIANGLE, NO SIGNAGE OR PLANT MATERIAL WITH A MATURE HEIGHT GREATER THAN 3'-0" TO BE IN THIS AREA. TREES TO BE MAINTAINED WITH 	
NDER	LOWEST BRANCH NO LESS THAN 7'0" FROM TOP OF GRADE.	
		DRAWN BY CE
		REVIEWED BY CM/ME DATE 02/25/2021
	LEGEND 	PROJECT NO. 20-0023 DRAWING NAME
	EXISTING TREE TO REMAIN AND BE PROTECTED DURING CONSTRUCTION	LANDSCAPE PLAN
	SHREDDED WOOD MULCH 7/16"Ø SANTA FE BROWN ROCK MULCH AT 3" DEPTH 0//ED M/EED DADD/ED FADD/20	
	OVER WEED BARRIER FABRIC EXCLUDED FROM LANDSCAPE AREA CALCULATIONS	
	TURF GRASS SOD REPAIR OF EXISTING LAWN AREA + + + + + + TURF GRASS SEEDING REPAIR OF EXISTING LAWN AREA	SHEET NO.
		LP101



TREES	<u>EST</u> QTY	BOTANICAL / COMMON NAME SEE A1, A3 & A4/LP501	SIZE/COND.	<u>MAT. HT.</u>	MAT. D
	3	ACER RUBRUM `FRANK JR.` / REDPOINTE RED MAPLE	2"CAL B&B	45.00	30.00
	1	FORESTIERA NEOMEXICANA / NEW MEXICO PRIVET	15 GAL B&B	15.00	15.00
	3	FRAXINUS PENNSYLVANICA `URBANITE` / URBANITE ASH	2"CAL B&B	40.00	40.00
	8	LAGERSTROEMIA INDICA X FAURIEI `TUSCARORA` / TUSCARORA CRAPE MYRTLE	15 GAL B&B	15.00	15.00
\bigcirc	8	MALUS X `VELVETCOLE` TM / VELVET PILLAR CRABAPPLE	1.5" CAL B&B	20.00	14.00
	3	PINUS EDULIS / PINON PINE	6`-8` HT, B&B	30.00	18.00
	6	PINUS NIGRA / AUSTRIAN BLACK PINE	6`-8` HT, B&B	60.00	25.00
De rechterer	2	POPULUS WISLIZENI / COTTONLESS RIO GRANDE COTTONWOOD	3" CAL B&B	50.00	50.00
	15	THUJA PLICATA `GREEN GIANT` / GREEN GIANT ARBORVITAE	15 GAL.	30.00	10.00
SHRUBS	<u>EST</u> QTY	BOTANICAL / COMMON NAME SEE A2 & B1/LP501	SIZE/COND.	<u>MAT. HT.</u>	MAT. E
	12	BUDDLEJA DAVIDII `BLACK KNIGHT` / BLACK KNIGHT BUTTERFLY BUSH	1 GAL.	7.00	5.00
\odot	16	BUXUS MICROPHYLLA JAPONICA `WINTER GEM` / WINTER GEM JAPANESE BOXWOOD	5 GAL	6.00	6.00
	18	BUXUS SEMPERVIRENS `MONRUE` / GREEN TOWER COMMON BOXWOOD	5 GAL	9.00	2.00
+	8	CORNUS SERICEA `BAILEYI` / RED TWIG DOGWOOD	5 GAL	6.00	6.00
***	13	CYTISUS SCOPARIUS `LENA`S` / LENA`S BROOM	5 GAL	4.00	4.00
\bigcirc	13	LAGERSTROEMIA X `GAMAD IX` / PURPLE PIG CRAPE MYRTLE	5 GAL	8.00	4.50
\bigcirc	22	RHAPHIOLEPIS INDICA `PINKIE` / `PINKIE` INDIAN HAWTHORNE	1 GAL.	3.00	4.00
	7	ROSA X `NOASPLASH` / PINK SPLASH CARPET GROUNDCOVER ROSE	5 GAL	2.00	4.00
\bigotimes	16	ROSA X `RADSUNNY` TM / SUNNY KNOCK OUT YELLOW ROSE	5 GAL	3.50	3.50
\otimes	31	ROSMARINUS OFFICINALIS `ARP` / ARP ROSEMARY	5 GAL	6.00	5.00
(+)	5	ROSMARINUS OFFICINALIS `BLUE SPIRES` / BLUE SPIRES ROSEMARY	5 GAL	4.00	3.00
$\langle \cdot \rangle$	20	SYRINGA X ` / LITTLE DARLING LILAC	5 GAL	4.00	4.00
GRASSES	<u>EST</u> QTY	BOTANICAL / COMMON NAME SEE A2 & B1/LP501	SIZE/COND.	<u>MAT. HT.</u>	<u>MAT. [</u>
-Ara	32	HELICTOTRICHON SEMPERVIRENS `BLUE OATS` / BLUE AVENA OAT GRASS	1 GAL.	4.00	2.00
	23	MISCANTHUS SINENSIS `GRACILLIMUS` / MAIDEN GRASS	5 GAL	8.00	5.00
sure South	46	MUHLENBERGIA CAPILLARIS `REGAL MIST` / REGAL MIST PINK MUHLY GRASS	1 GAL.	4.00	3.00
Solute	32 EST	MUHLENBERGIA EMERSLEYI EL TORO / EL TORO MUHLY GRASS	5 GAL	3.00	3.00
GROUNDCOVERS	<u>QTY</u> 215	BOTANICAL / COMMON NAME SEE A2 & B1/LP501 NARCISSUS X `DUTCH MASTER` / LARGE YELLOW DAFFODIL	<u>SIZE/COND.</u> BULB	<u>MAT. HT.</u> 1.50	<u>МАТ. [</u> 0.50
PERENNIALS	<u>EST</u> QTY	BOTANICAL / COMMON NAME SEE A2 & B1/LP501	SIZE/COND.	MAT. HT.	MAT. [
	3	ALCEA ROSEA / HOLLYHOCK	5 GAL	<u>6.00</u>	2.50
	9	CERATOSTIGMA PLUMBAGINOIDES / DWARF PLUMBAGO	1 GAL	0.50	2.50
$\textcircled{\bullet}$	46	ECHINACEA `CANTALOUPE` / SUPREME CANTALOUPE CONEFLOWER	1 GAL	2.50	1.50
Ê	43	ECHINACEA PURPUREA `POWWOW WILD BERRY` / POWWOW WILD BERRY CONEFLOWER	1 GAL	1.50	1.25
	39	HEMEROCALLIS FULVA "DHEMCORAL" / ENDLESSLILY CORAL DAYLILY	1 GAL	1.75	1.75
\oplus	62	LAVANDULA ANGUSTIFOLIA `HIDCOTE SUPERIOR BLUE` / HIDCOTE SUPERIOR BLUE LAVENDER	1 GAL	1.25	1.25
$\langle 1 \rangle$	42	LAVANDULA X INTERMEDIA `GROSSO` / FAT BUD FRENCH LAVENDER	1 GAL.	3.00	3.00
。 段	12	SALVIA GREGGII `FURMANS RED` / FURMAN`S RED SALVIA	1 GAL.	2.50	3.00
<u>VINES</u>	<u>EST</u> QTY	BOTANICAL / COMMON NAME SEE B2 & C3/LP501	SIZE/COND.	<u>MAT. HT.</u>	<u>MAT. [</u>
	10	CAMPSIS RADICANS / TRUMPET CREEPER VINE	5 GAL		
-martin	3	HEDERA HELIX / ENGLISH IVY	5 GAL		
A	2	ROSA X `RADBRITE` / BRITE EYES CLIMBING ROSE	5 GAL		

LEGEND		
SYMBOL:	PROPERTY LINE	AVAILABLE FROM SUPPLIER:
	EXISTING TREE TO REMAIN AND BE PROTECTED DURING CONSTRUCTION	
	'NATIVE MULCH' SHREDDED BARK MULCH AT 2" DEPTH NO WEED BARRIER FABRIC	SOILUTIONS, ALBUQUERQUE, NM 505/877-0220
	7/16" Ø SANTA FE BROWN ROCK MULCH AT 3" DEPTH OVER WEED BARRIER FABRIC	BUILDOLOGY, ALBUQUERQUE, NM 505/344-6626
	1"-2" Ø MOUNTAINAIR BROWN ROCK MULCH AT 3" DEPTH OVER WEED BARRIER FABRIC, SEE B3/LP501	BUILDOLOGY, ALBUQUERQUE, NM 505/344-6626
	TURF GRASS SOD REPAIR OF EXISTING LAWN AREA, PARK BLEND	EVERGREEN TURF, MCINTOSH, NM 505-384-2430
	TURF GRASS SEEDING REPAIR OF EXISTING LAWN AREA, PARK BLEND, INCL. KENTUCKY BLUEGRASS, PERENNIAL RYEGRASS AND TALL FESCUE, 8#/1000 SQFT	CURTIS AND CURTIS SEED, CLOVIS, NM 877/907-1806
* * * *	EXISTING VEGETATION TO REMAIN	
Ø	BOULDER, COLOR: JUST GOLD	JPR GRAVEL NM, ALBUQUERQUE, NM 505/892-8869

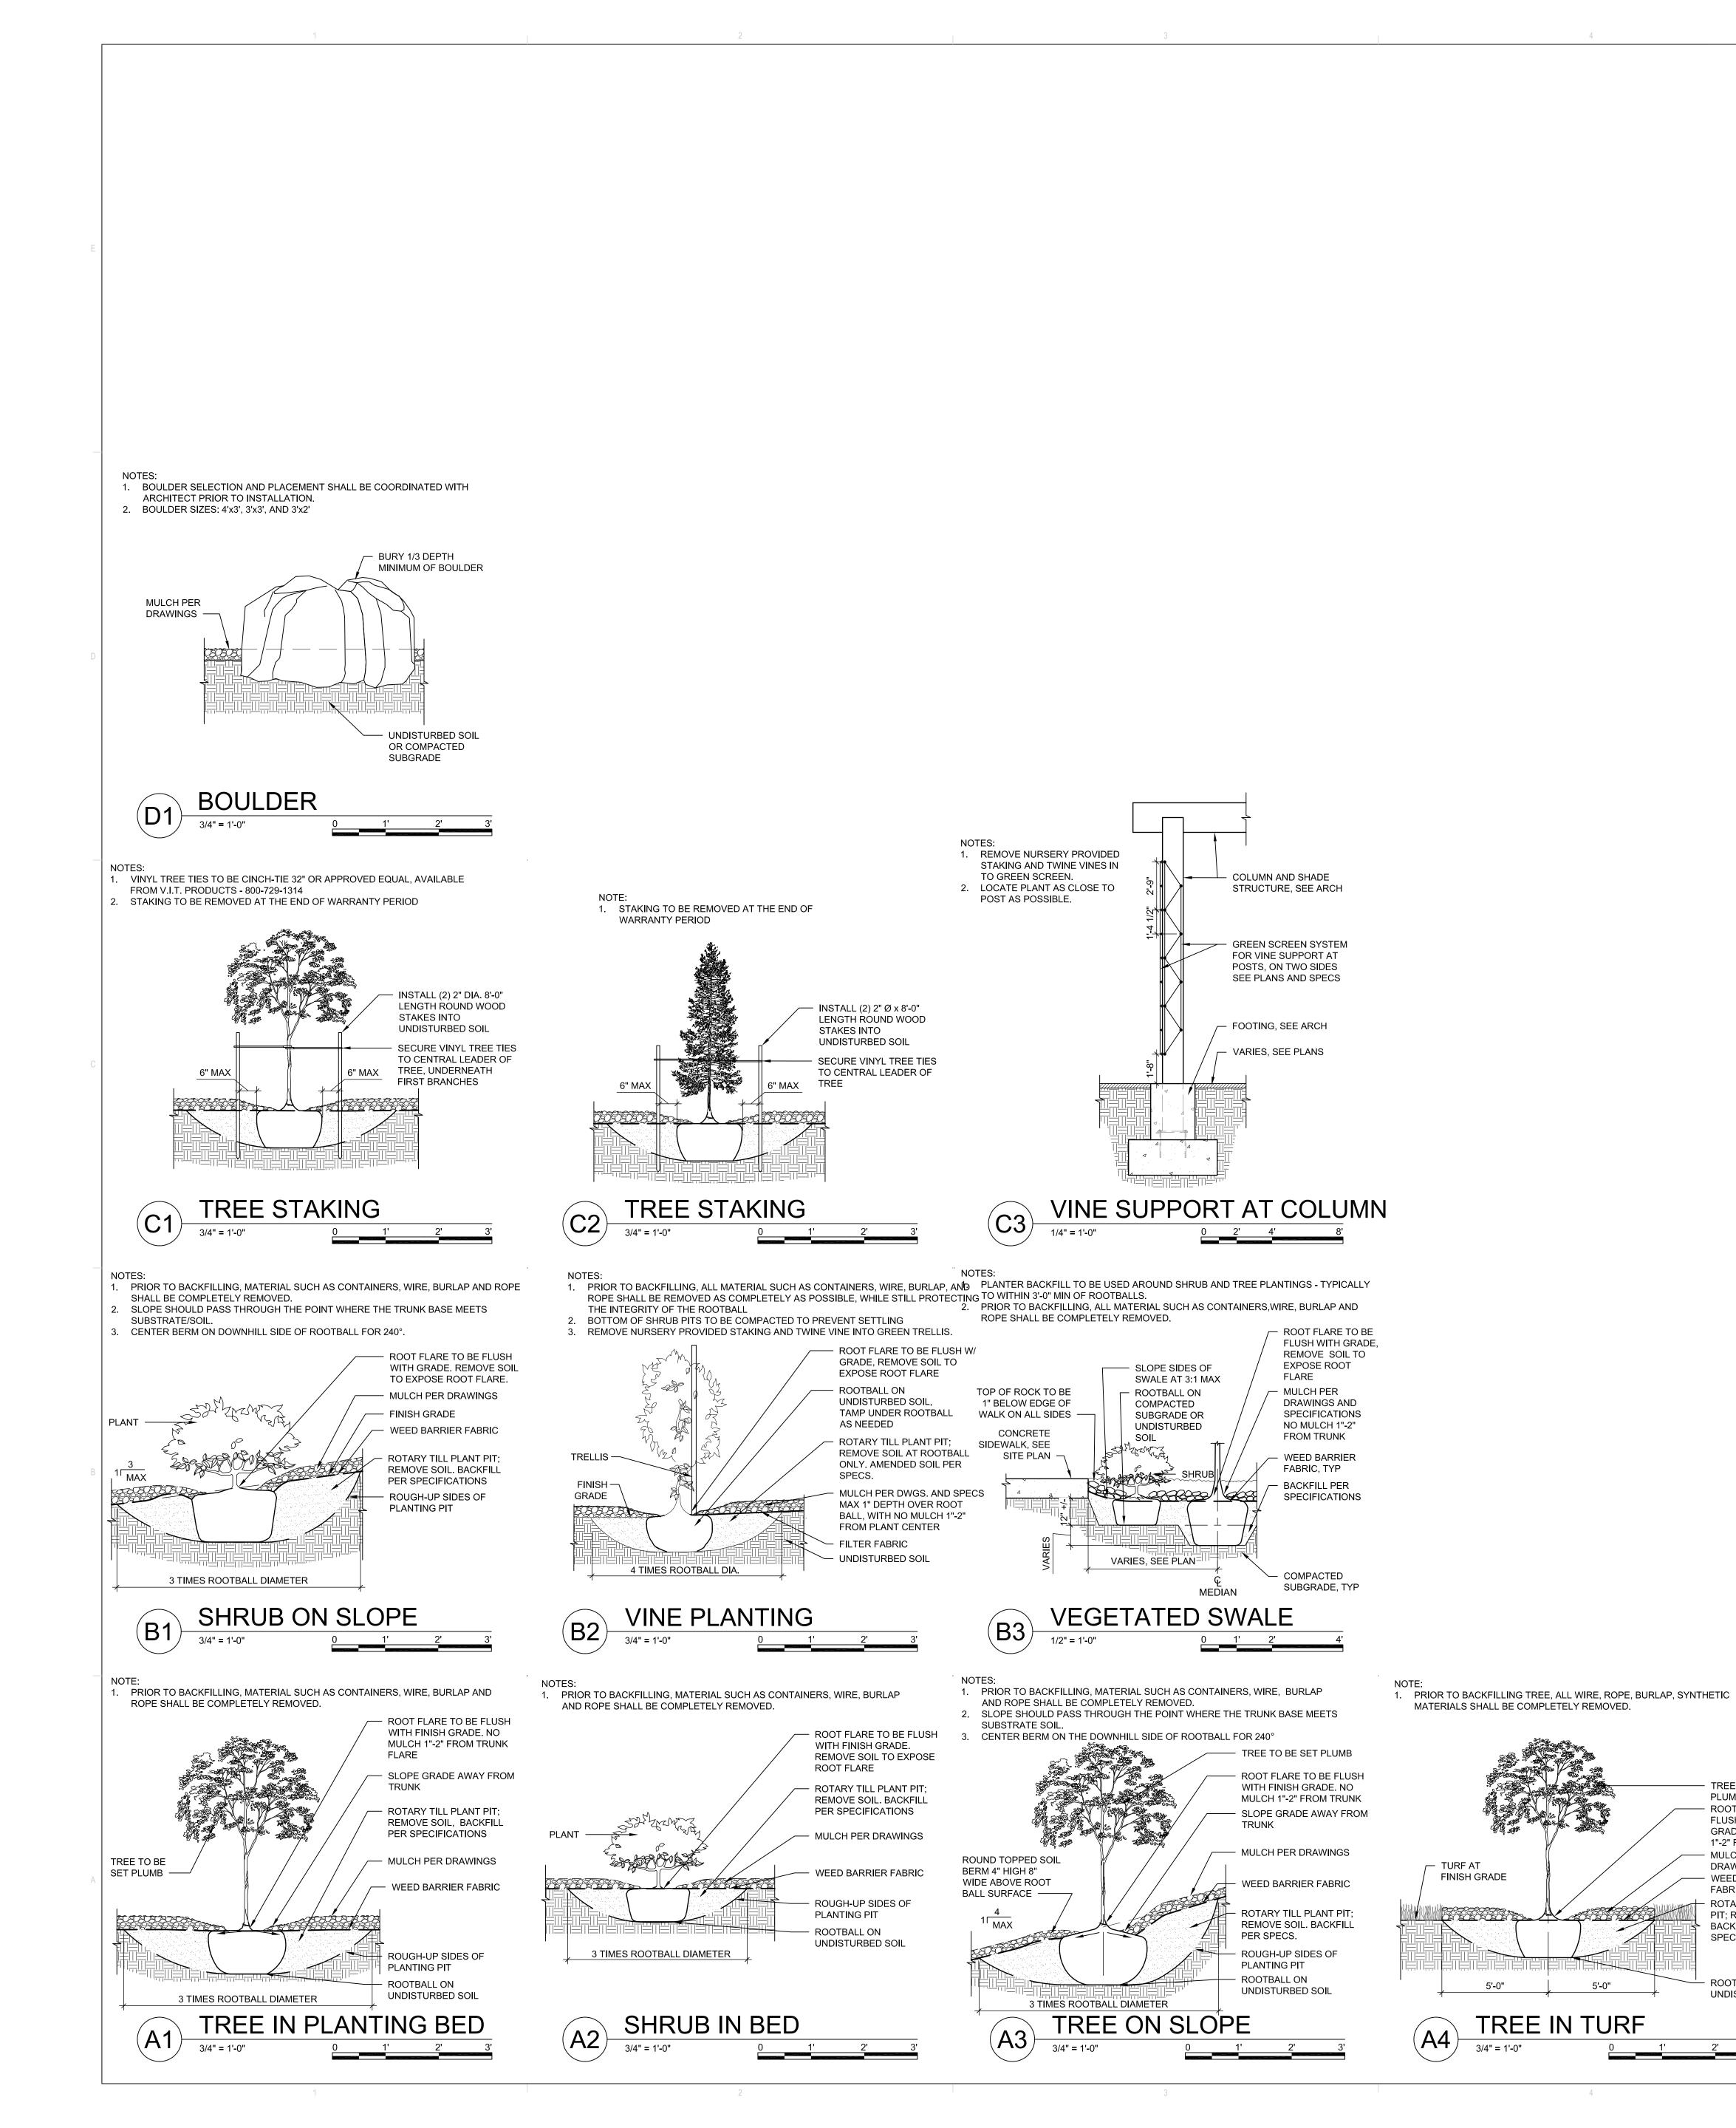DEKKER PERICH SABATINI

ARCHITECTURE DESIGN INSPIRATION

ARCHITECT

PROJECT

ENGINEER

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Z ш∞ NN VN \Box FROI FORES' ALBUQL

ISSUED FOR PERMITTING/ CONSTRUCTION

REVISIONS \square \triangle \triangle \triangle \triangle

SHEET NO.

DRAWN BY	CD
REVIEWED BY	CM/MB
DATE	01/15/2021
PROJECT NO.	20-0023.001
DRAWING NAME	

LANDSCAPE DETAILS

LP501


EST QTY:


4,842 SF 10,968 SF 2,476 SF

1,765 SF

11,030 SF


10

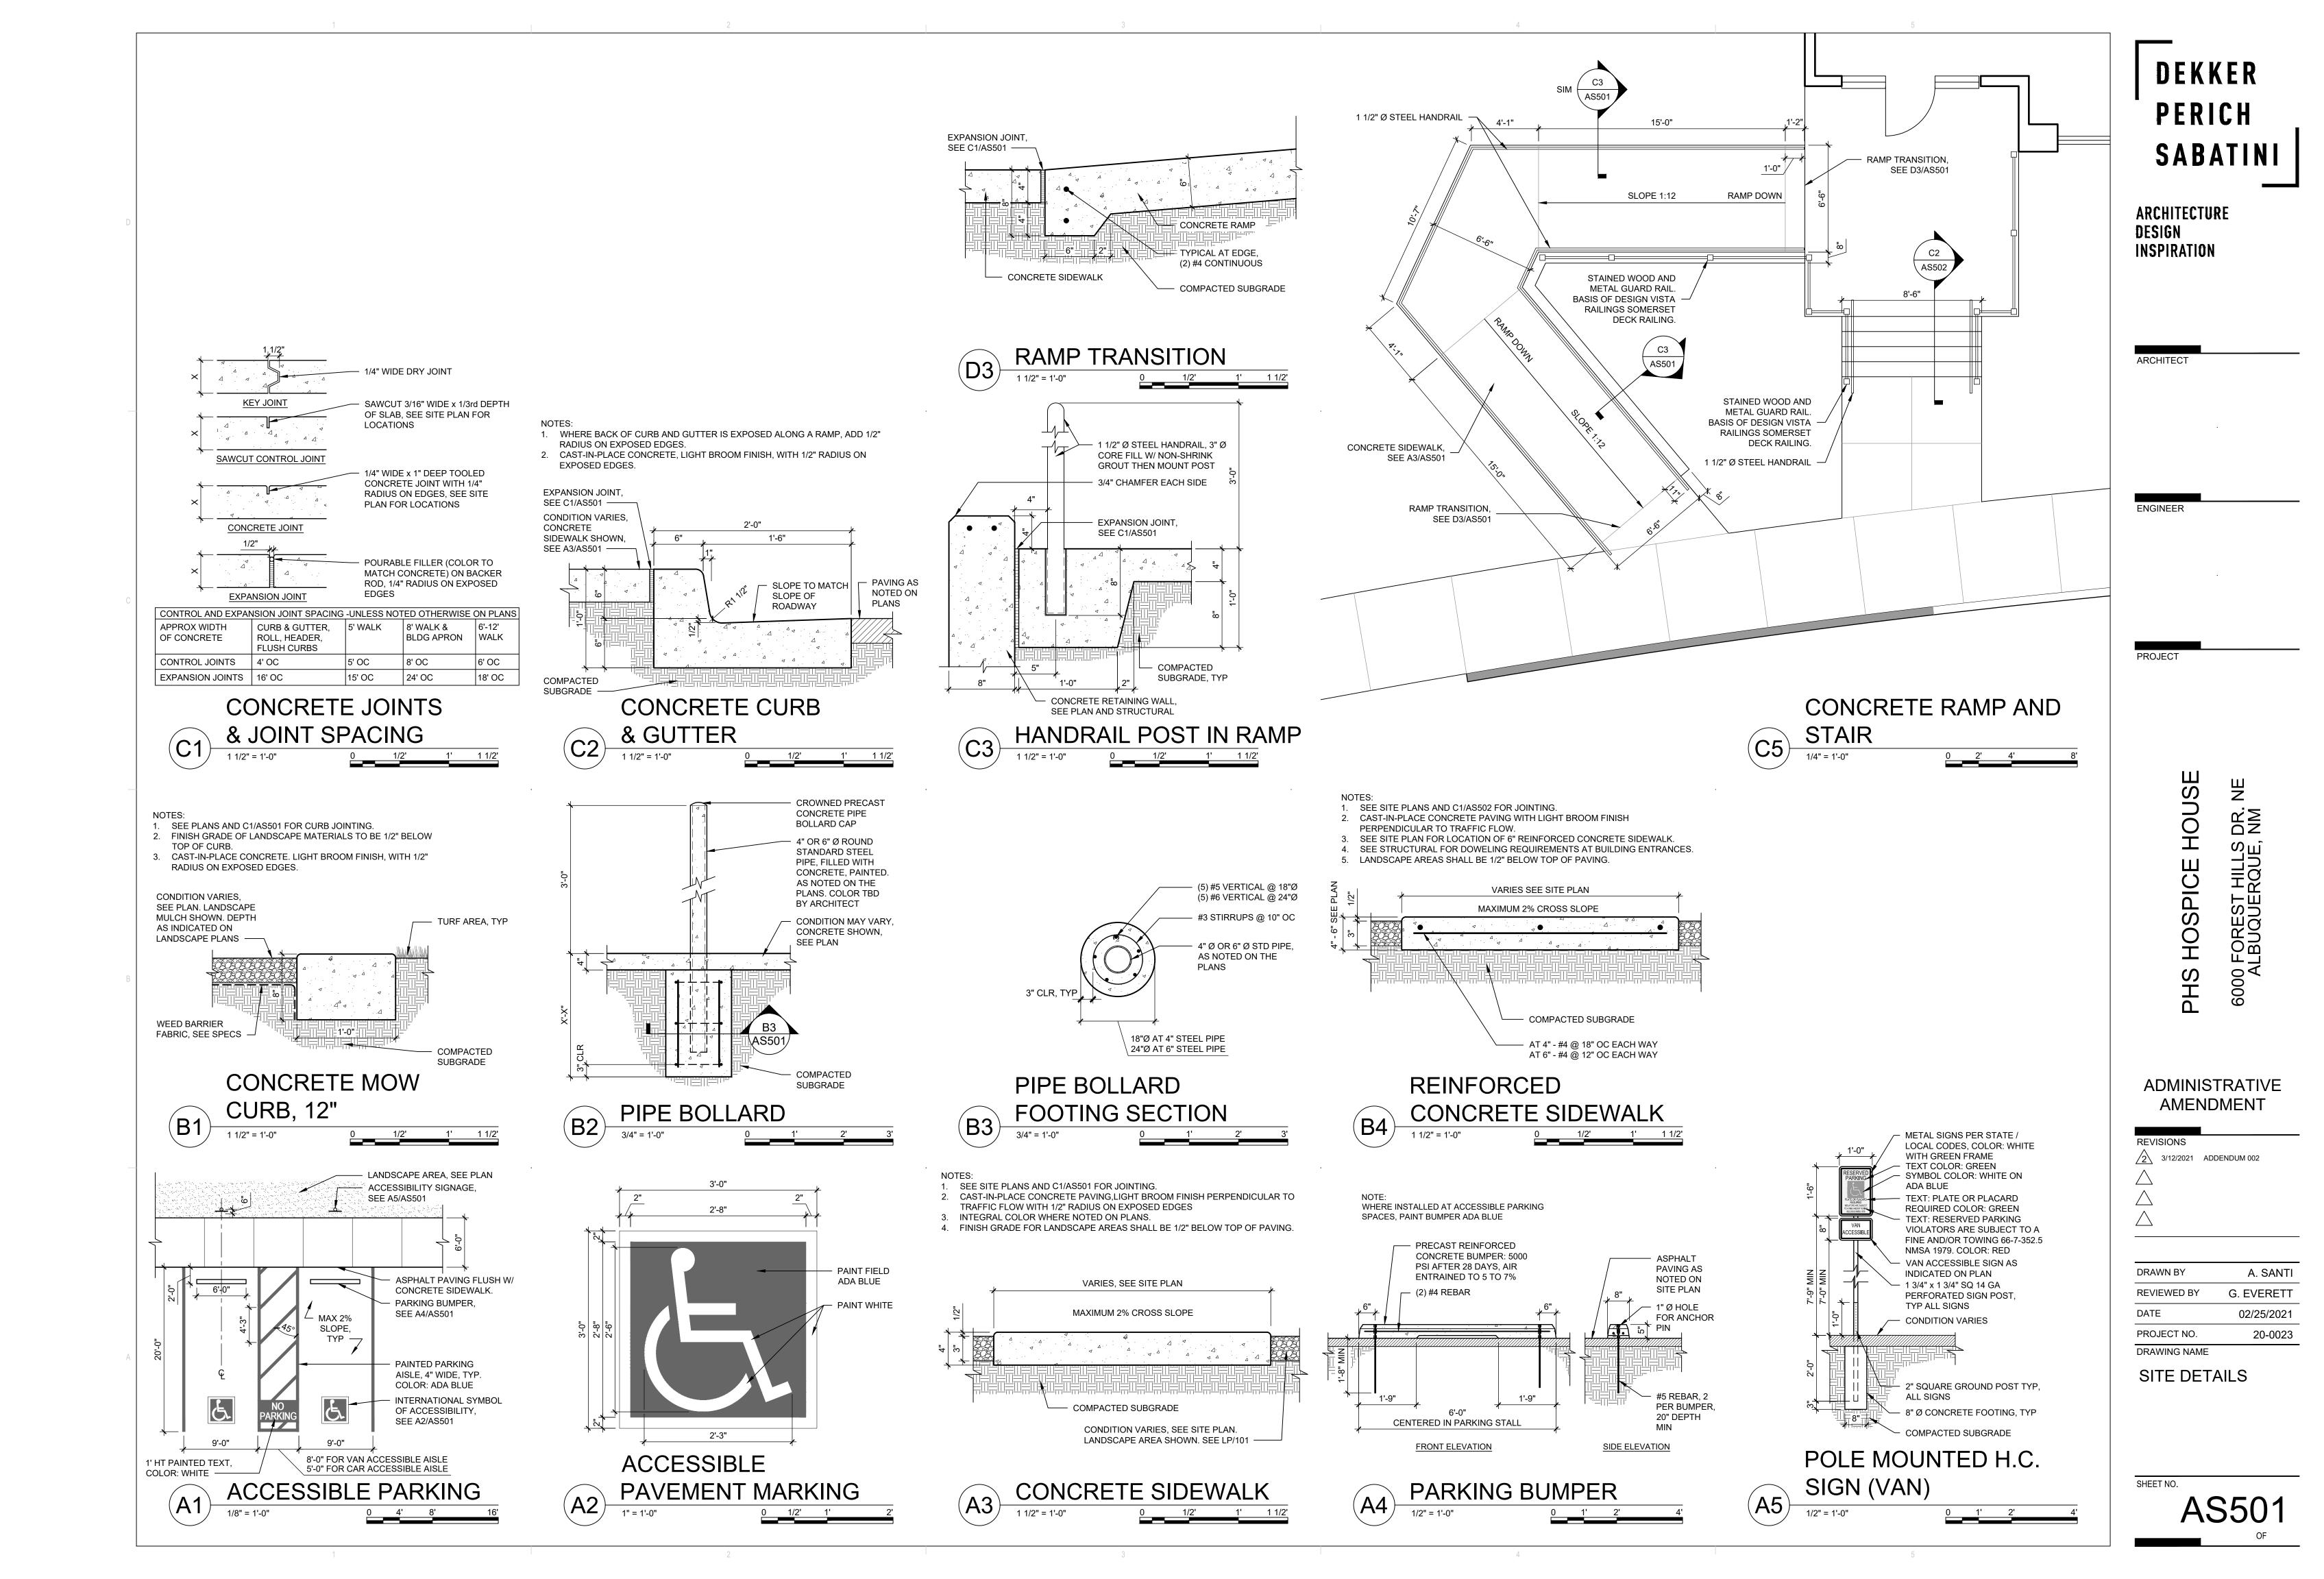

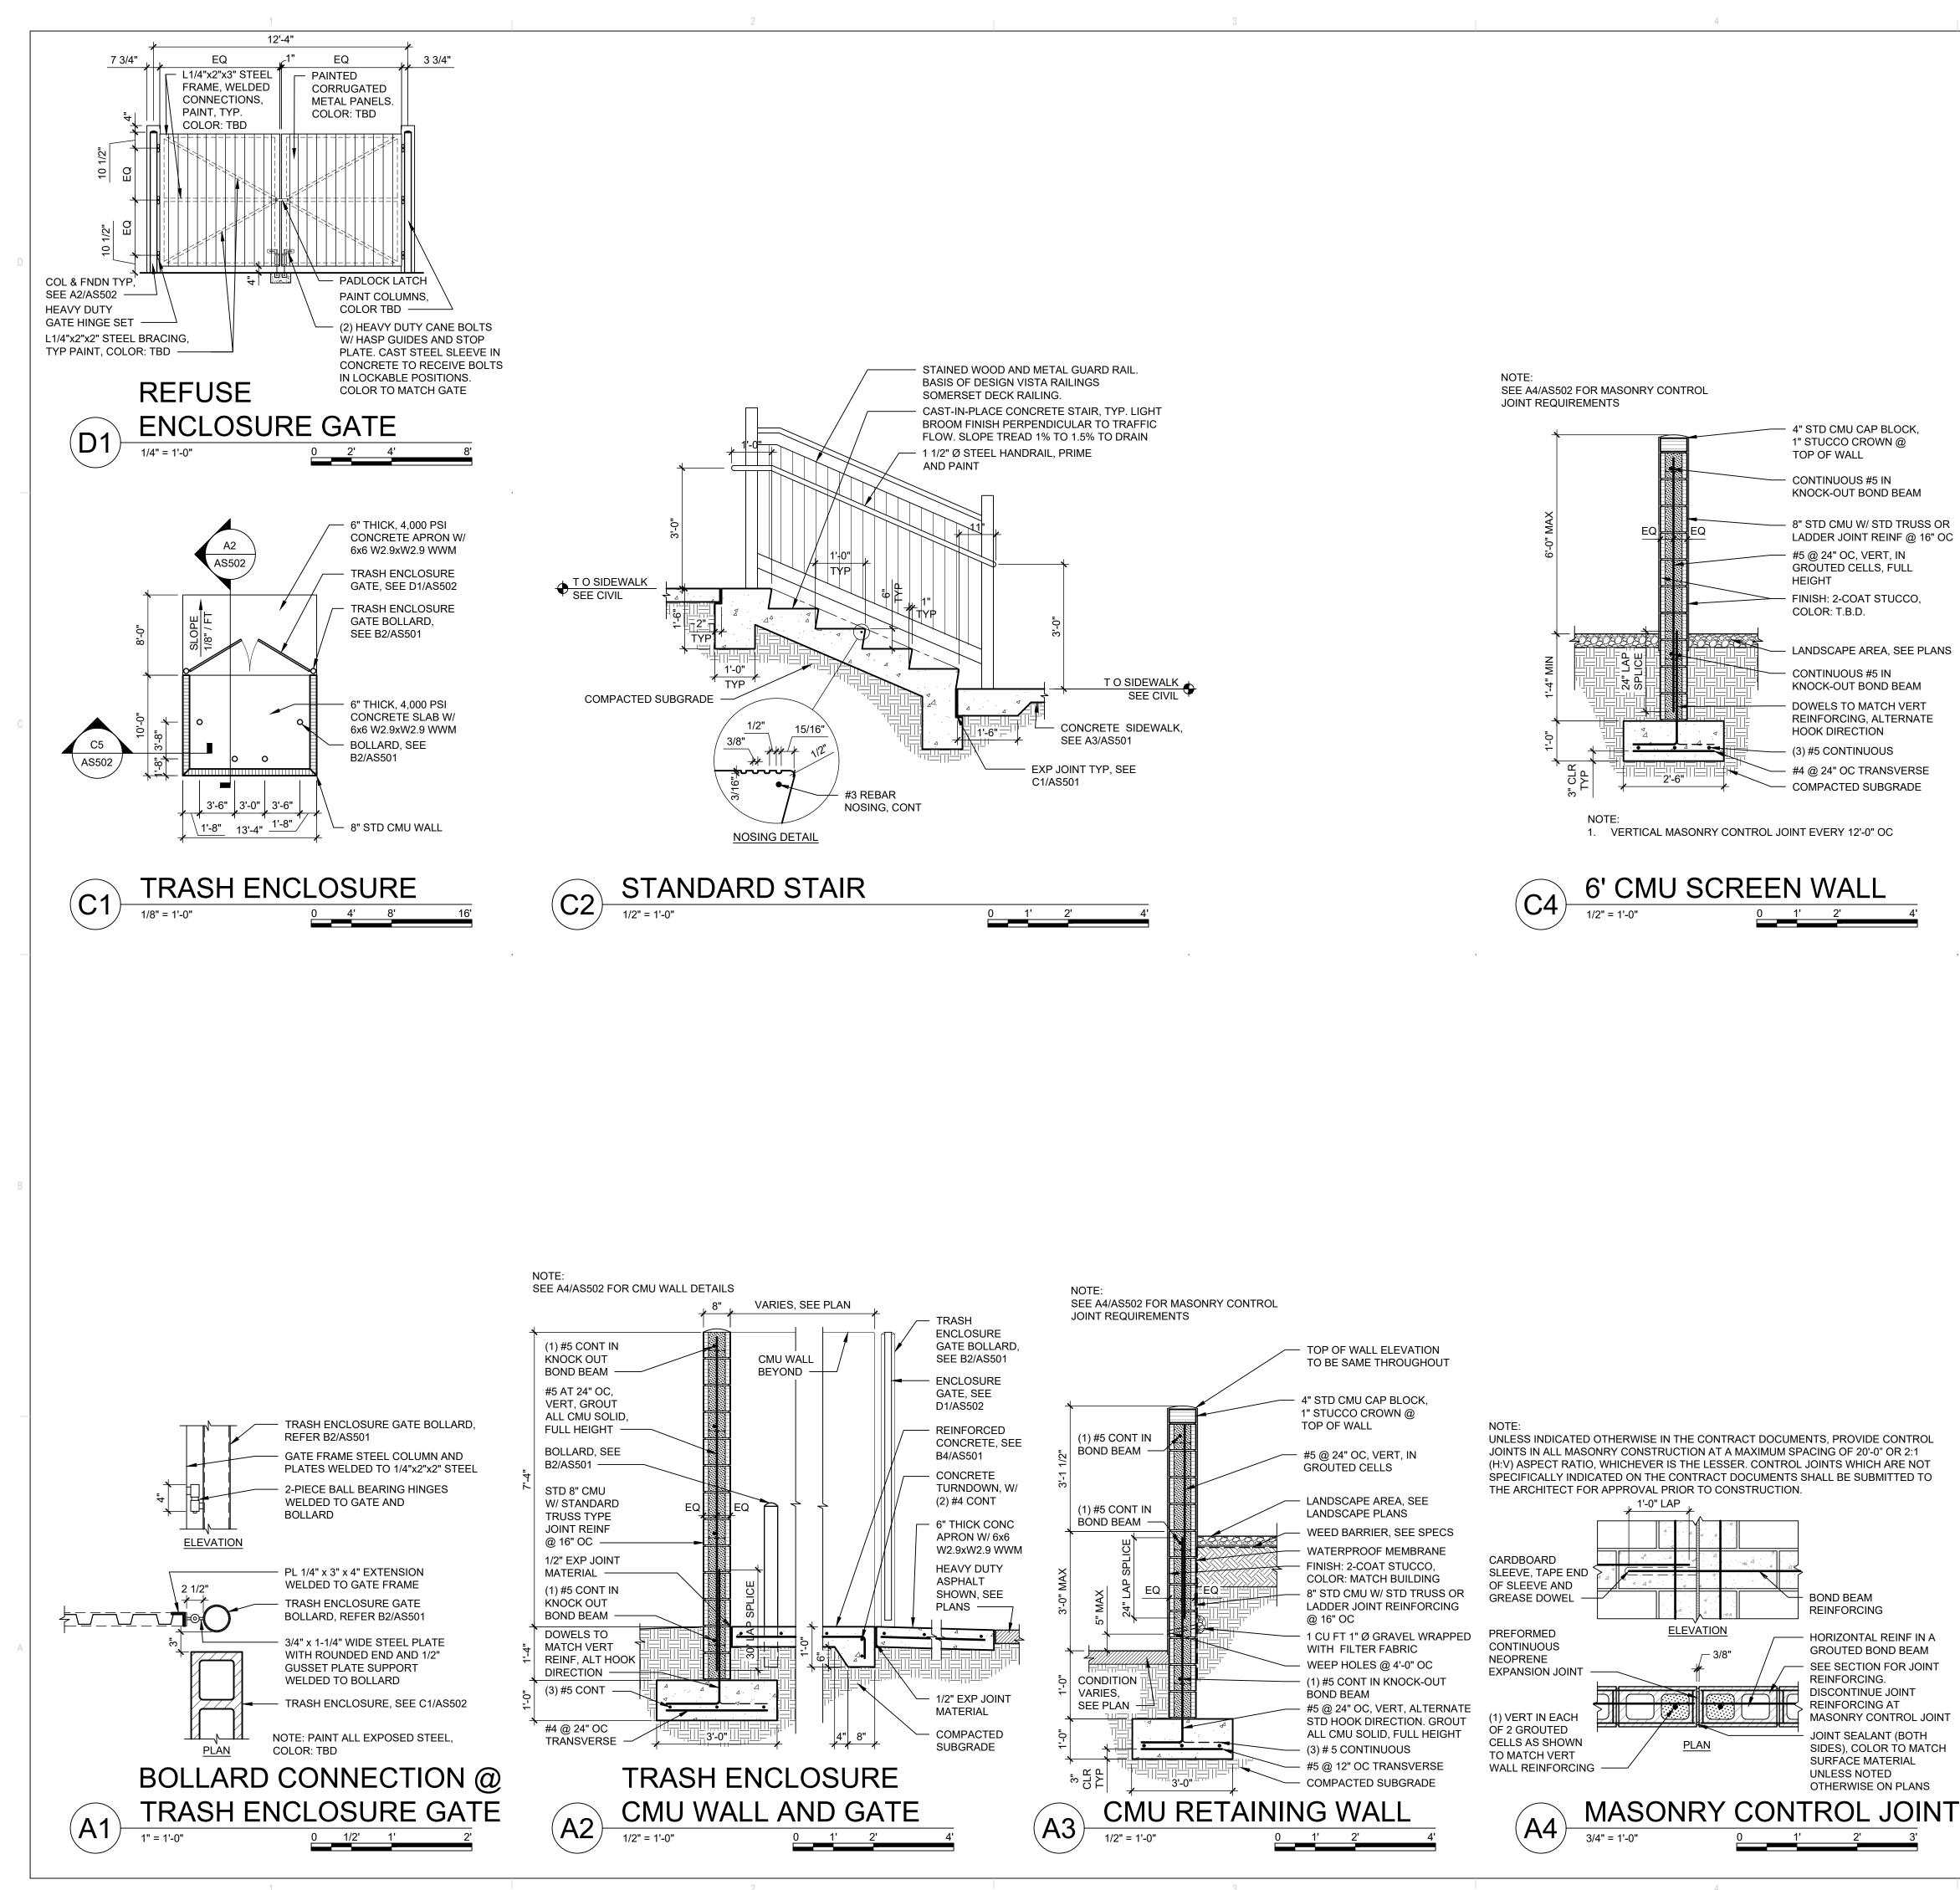

DEKKER PERICH SABATINI

ARCHITECTURE DESIGN INSPIRATION

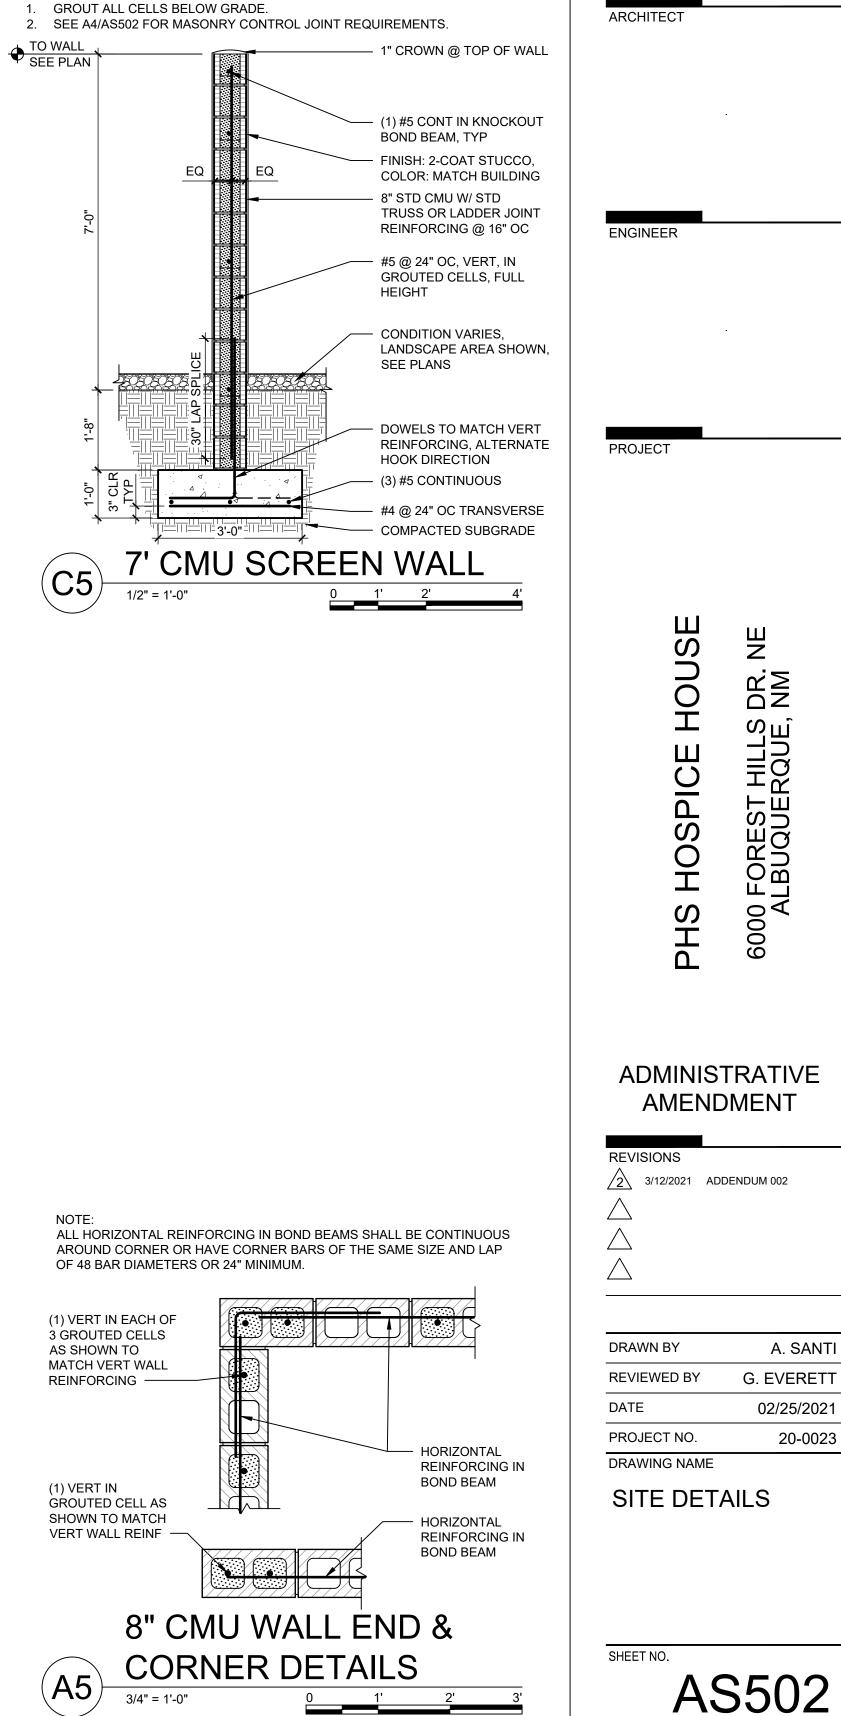

LADDER JOINT REINF @ 16" OC

NOTE:

REINFORCING, ALTERNATE

3/4" = 1'-0"

