

# **GENERAL NOTES**

- A. DIMENSIONS ARE TO FACE OF CURB, OR WALL, OR EDGE OF PAVEMENT UNLESS OTHERWISE NOTED.
- D. SITE PLAN SHALL COMPLY WITH LOCAL, STATE AND FEDERAL ADA STANDARDS & GUIDELINES, INCLUDING THE INTERNATIONAL FIRE CODE (IFC) 2015.
- E. CURBS AND ACCESSIBLE RAMPS WILL BE DESIGNED AND BUILT ACCORDING TO THE CITY OF ALBUQUERQUE STANDARDS.
   F. LIGHT FIXTURES AND DESIGN SHALL COMPLY WITH THE CITY OF ALBUQUERQUE INTEGRATED DEVICE ORDER OF THE COMPLY WITH THE CITY OF ALBUQUERQUE INTEGRATED DEVICE ORDER OF THE COMPLY WITH THE CITY OF ALBUQUERQUE
- INTEGRATED DEVELOPMENT ORDINANCE (IDO): SECTION 14-16-5-8 OUTDOOR LIGHTING.

  G. STREETS, PARKING SPACES AND ASSOCIATED DRIVES TO BE ASPHALT UNLESS
- NOTED OTHERWISE.

  H. LANDSCAPE AND SIGNAGE WILL NOT INTERFERE WITH CLEAR SIGHT REQUIREMENTS. SIGNS, WALLS AND PLANTING BETWEEN 3 FEET AND 8 FEET TALL (AS MEASURED FROM THE GUTTER PAN) WILL NOT BE PERMITTED IN THE CLEAR
- . ALL PUBLIC INFRASTRUCTURE LOCATED WITHIN CITY RIGHT-OF-WAY SHALL BE INCLUDED IN A PUBLIC WORK ORDER.

## PROJECT DATA

**ZONING:**IDO - MIXED USE - HIGH INTENSITY ZONING DISTRICT (MX-H)

LANDUSE: MULTIFAMILY RESIDENTIAL PLANNING CONTEXT:

SITE IS WITHIN THE JOURNAL CENTER EMPLOYMENT CENTER TRANSIT:

BUS ROUTES 140, 251, AND 551 ARE ALONG JEFFERSON ST. A BUS STOP IS LOCATED LESS THAN 250 FEET FROM THE SUBJECT SITE ON JEFFERSON. **LEGAL DESCRIPTION**:

TRACT 6A-1 PLAT OF JOURNAL CENTER PHASE 2 UNIT 1CONT 5.1536 AC SITE AREA: 5.15 ACRES

ZONE ATLAS: D-17-Z
SETBACKS: FRONT= 20' MIN
SIDE = 10' MIN

REAR= 10' MIN

(20' BUILDING SETBACK, 20' PARKING SETBACK FROM JEFFERSON ST.)

(20' BUILDING SETBACK 10' PARKING SETBACK ALONG MASTHEAD ST. AND TIBURON ST.)

BUILDING HEIGHT:

MAXIMUM ALLOWED: 68'-0"

ACTUAL HEIGHT: 50'-0"

SPRINKLERED: YES, NFPA 13
BUILDING OCCUPANCY: R-2 MULTIFAMILY RESIDENTIAL
CONSTRUCTION TYPE: 4 STORY RESIDENTIAL BUILDING - TYPE VA
BUILDING AREA (S.F.):

BUILDING AREA (S.F.):
BUILDING 1:
BUILDING 2:
BUILDING 3:

PARKING CALCULATION: (TABLE 5-5-1)

1.5 SPACES / DWELLING UNITS: 209 X 1.5 = 314 SPACES
WITHIN EMPLOYMENT CENTER = 20% REDUCTION = 314 X .20 = 63
TOTAL REQUIRED SPACES = 314 - 63 = 251 SPACES
PROVIDED PARKING = 274 TOTAL SPACES (INCLUDING 24 GARAGE)

ACCESSIBLE PARKING: (NMBC 208.2.3)
2% OF UNITS = 209 X .02 = 4.18 = 5 SPACES REQUIRED
7 STANDARD + 4 VAN ACCESSIBLE SPACES = 11 SPACES PROVIDED
(2 ACCESSIBLE SPACES ARE ALSO ELECTRIC VEHICLE SPACES)

BICYCLE PARKING REQUIRED = 25 SPACES (10% OF REQUIRED OFF-STREET PARKING BICYCLE PARKING PROVIDED = 25 SPACES = 16 SPACES OUTDOOR, 10 INDOOR

MOTORCYCLE PARKING REQUIRED, (TABLE 5-5-4) = 5 SPACES

MOTORCYCLE PARKING PROVIDED = 5 SPACES

ELECTRIC VEHICLE PARKING REQUIRED, 2% (TABLE 5-5(C)(9)) = 5 SPACES

ELECTRIC VEHICLE PARKING PROVIDED = 7 SPACES

#### LEGEND

LANDSCAPE AREA

HEAVY DUTY ASPHALT (RATED FOR UP TO 75,000 LBS)

- — — — — FIRELANE STRIPING MARKING FIRE ACCESS LANE; REF: A4/SDP1.2

PROPERTY LINE

FIRE HYDRANT

POST INDICATOR VALVE (PIV), RE: CONCEPTUAL UTILITY PLAN

FIRE DEPARTMENT CONNECTION (FDC) WALL-MOUNTED

BIKE RACK, REF: B5/SDP1.2

SIDEWALK RAMP (ARROW POINTS DOWN)

TRANSFORMER WITH SAFETY BOLLARDS & 6" THICK CONCRETE PAD PER PNM STANDARDS

6' TALL DECORATIVE METAL FENCE, SEE C4/SDP1.2

ACCESSIBLE PARKING WITH ACCESSIBLE SIGNAGE AND STRIPING, REF: A3/SDP1.2, B2/SDP1.2 & C3/SDP1.2.

COMPACT PARKING PER COA DPM SEC 7-4(K)(4)

LIGHT POLE 25'-0" HEIGHT, SEE D2/SDP1.2

6" BOLLARD WITH SIGN, SEE B2/SDP1.3

6' WIDE PAINTED CROSSWALK, SEE B2/SDP1.2

ELECTRIC VEHICLE (EV) CHARGING STATION WITH SIGN;

#### **VICINITY MAP**



# DEKKER PERICH SABATINI

ARCHITECTURE DESIGN INSPIRATION

ARCHITECT



ENGINEER

91,823 GSF

65,246 GSF

65,736 GSF

222,805 GSF

RO IECT


LLASO JOO AFAR IMENIS 7501 JEFFERSON ST NE ALBUQUERQUE, NM 87109

DESIGN REVIEW BOARD (DRB) APPLICATION

DRAWN BY
D/P/S
REVIEWED BY
D/P/S
DATE
09.16.2022
PROJECT NO. 20-0029
DRAWING NAME

SITE PLAN

SDP1

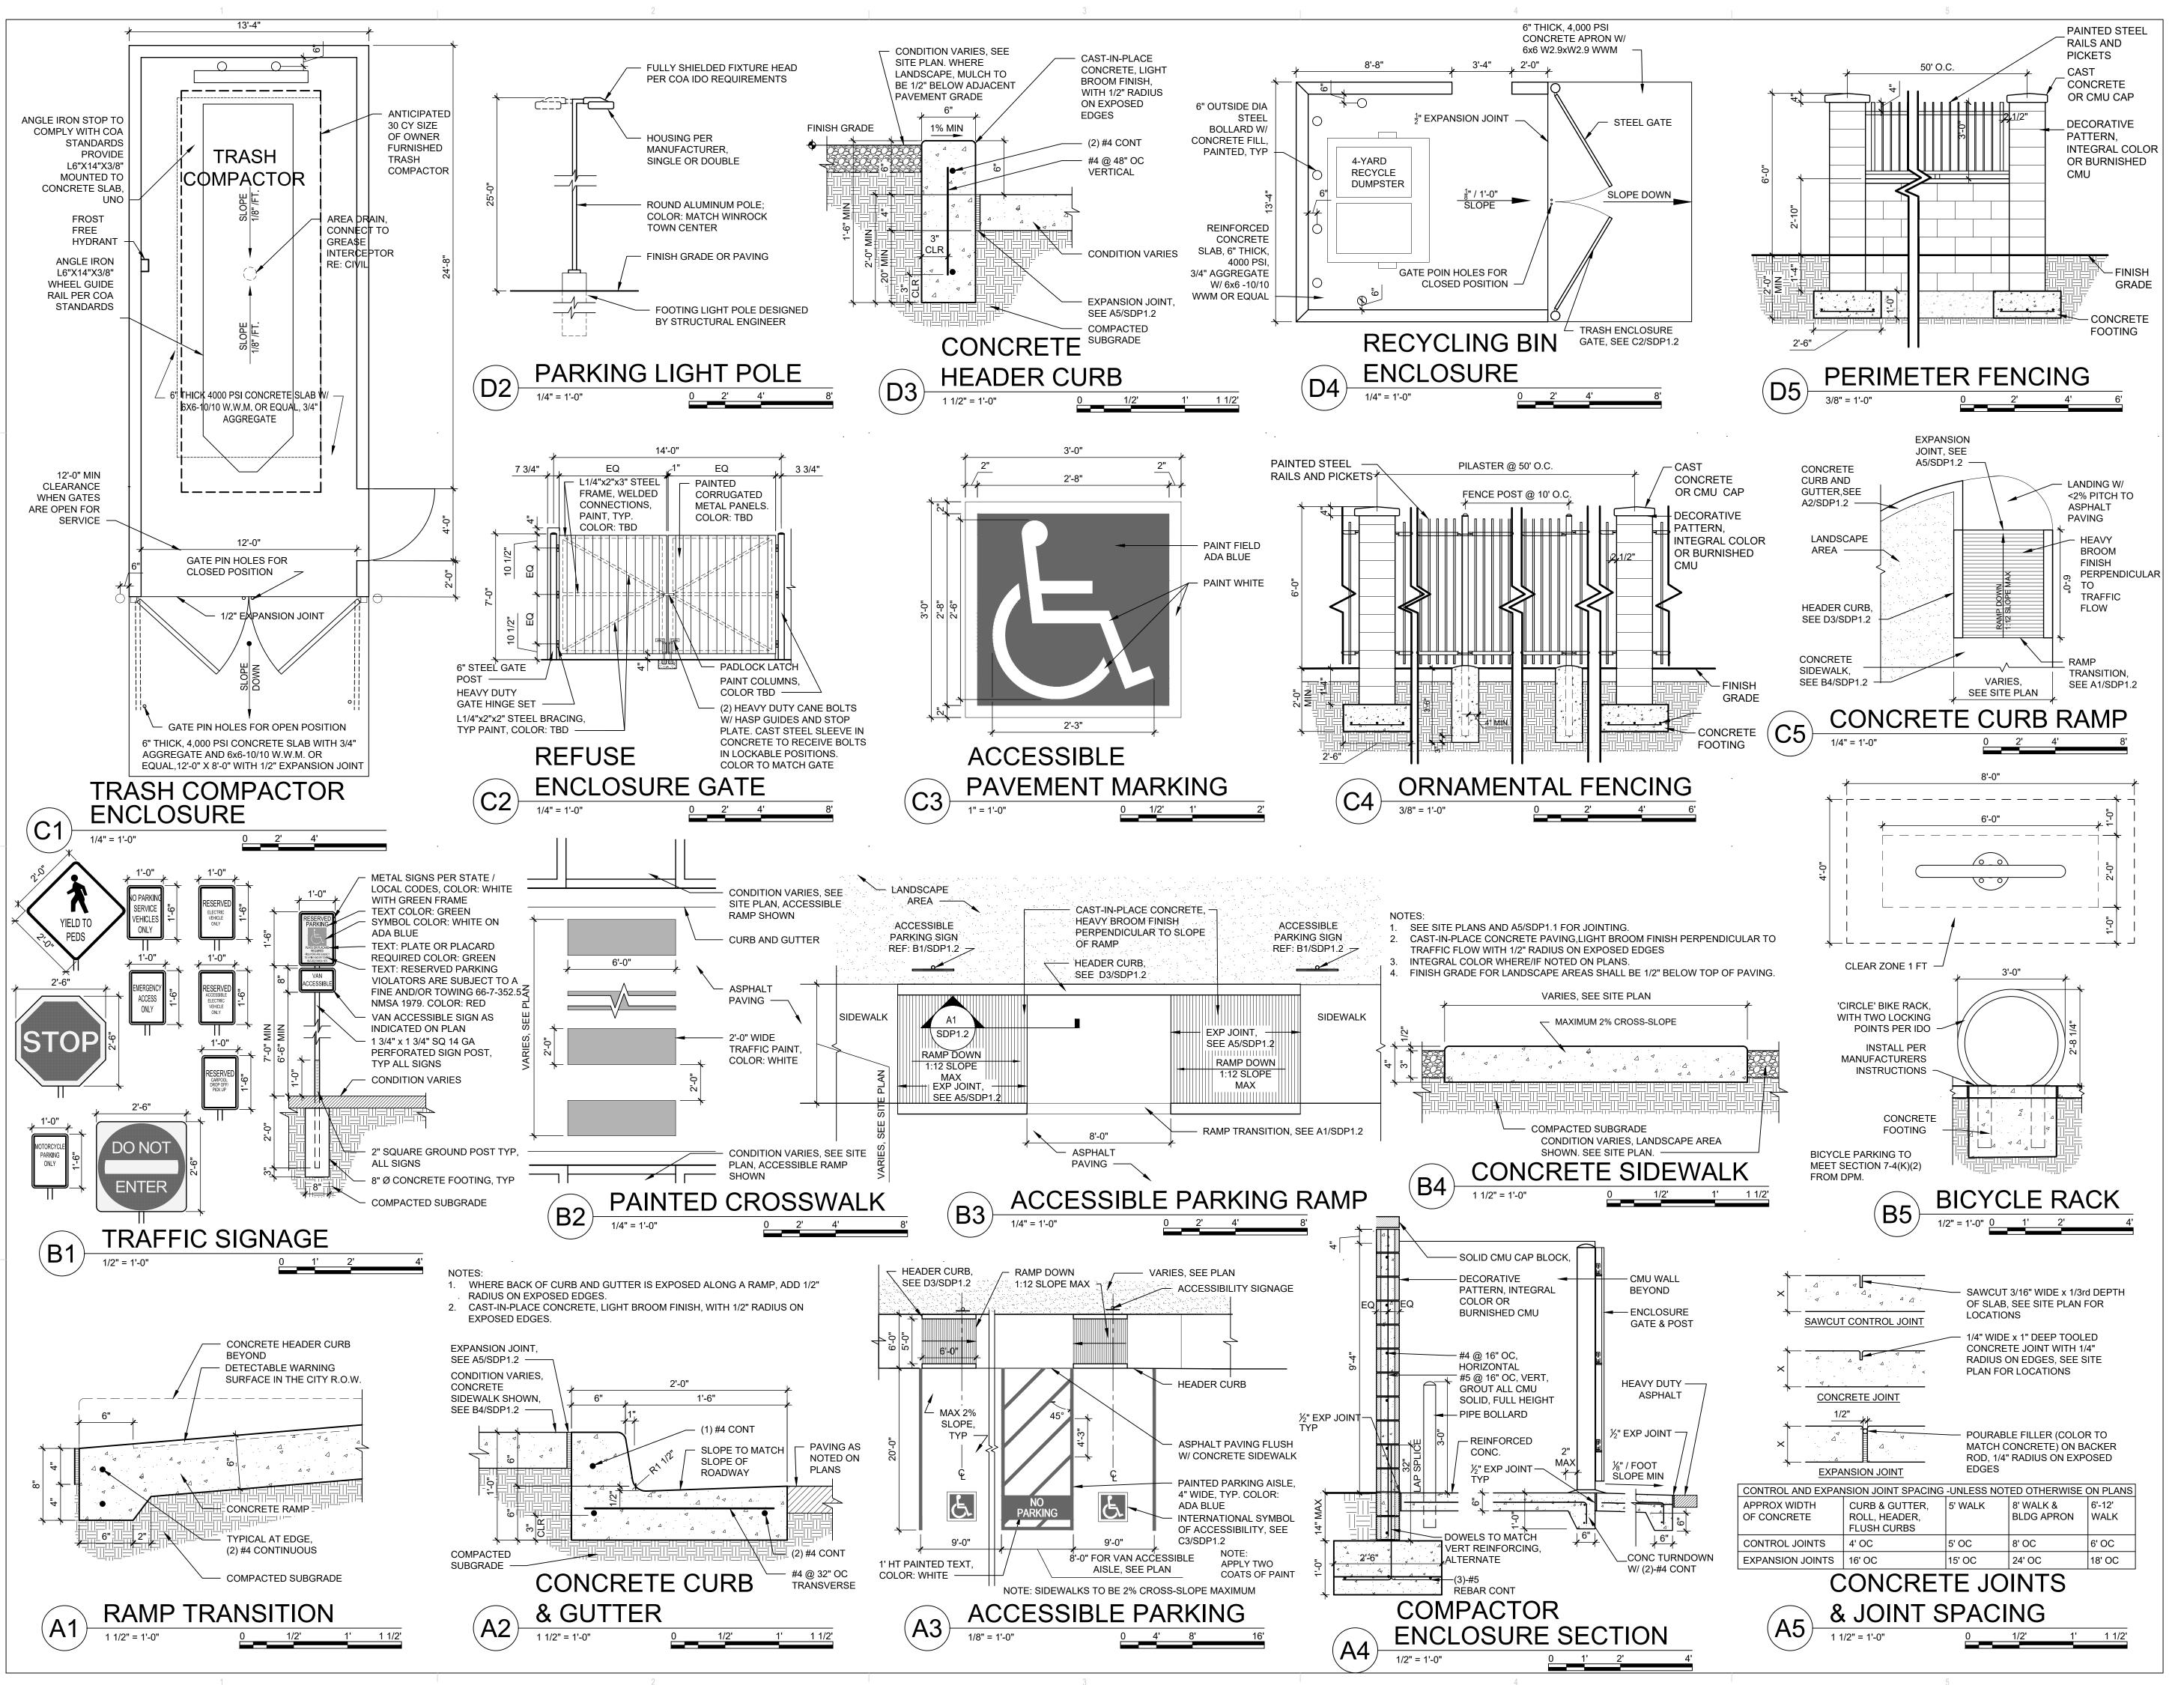

ARCHITECTURE DESIGN INSPIRATION

HANNAH FEIL GREENHOOD No. 5594

ENGINEER

PROJECT


LASO JOB APARTIMENTS
7501 JEFFERSON ST NE
ALBUQUERQUE, NM 87109

DESIGN REVIEW BOARD (DRB) APPLICATION

DRAWN BY
DPS
REVIEWED BY
DATE
09.16.2022
PROJECT NO.
20-0029
DRAWING NAME

SITE DETAILS

SHEET NO.
SDP1.2

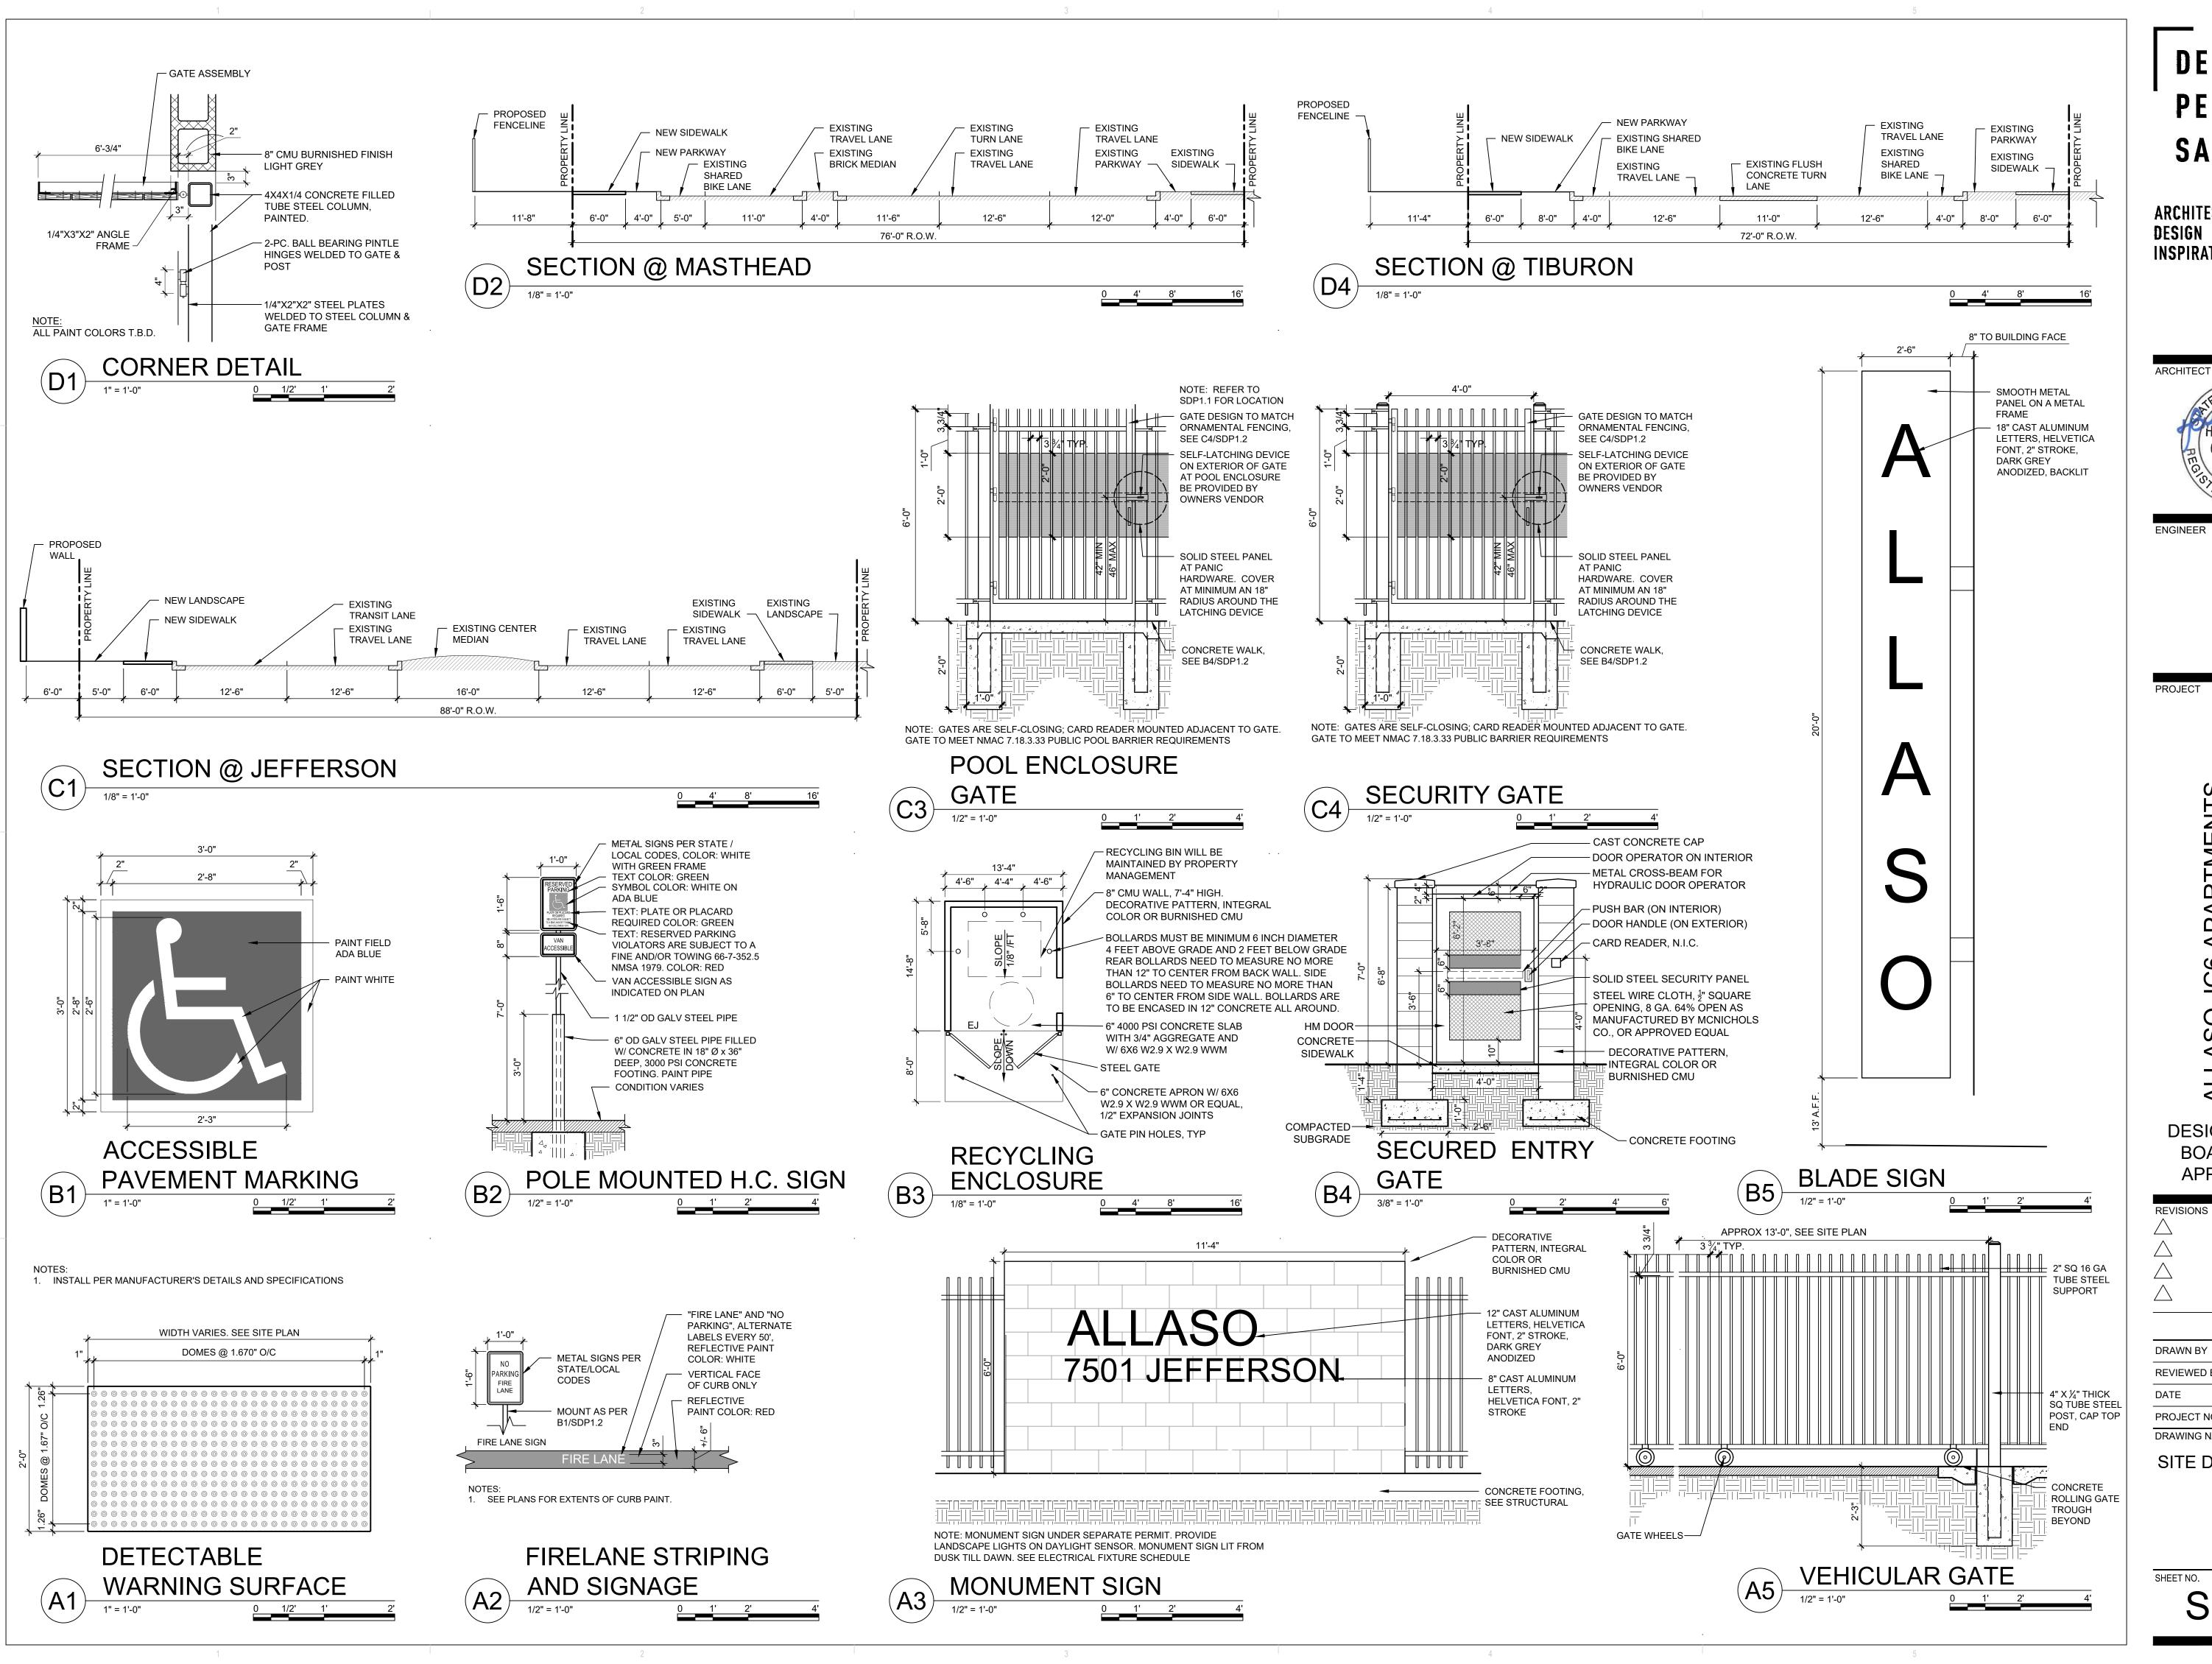

ARCHITECTURE DESIGN **INSPIRATION** 



PROJECT

7501 JEFFERSON ST ALBUQUERQUE, NM 8


**DESIGN REVIEW** BOARD (DRB) **APPLICATION** 

REVISIONS

DRAWN BY DPS REVIEWED BY DPS 09.16.2022 PROJECT NO. 20-0029 DRAWING NAME

SITE DETAILS

SHEET NO. SDP1.3

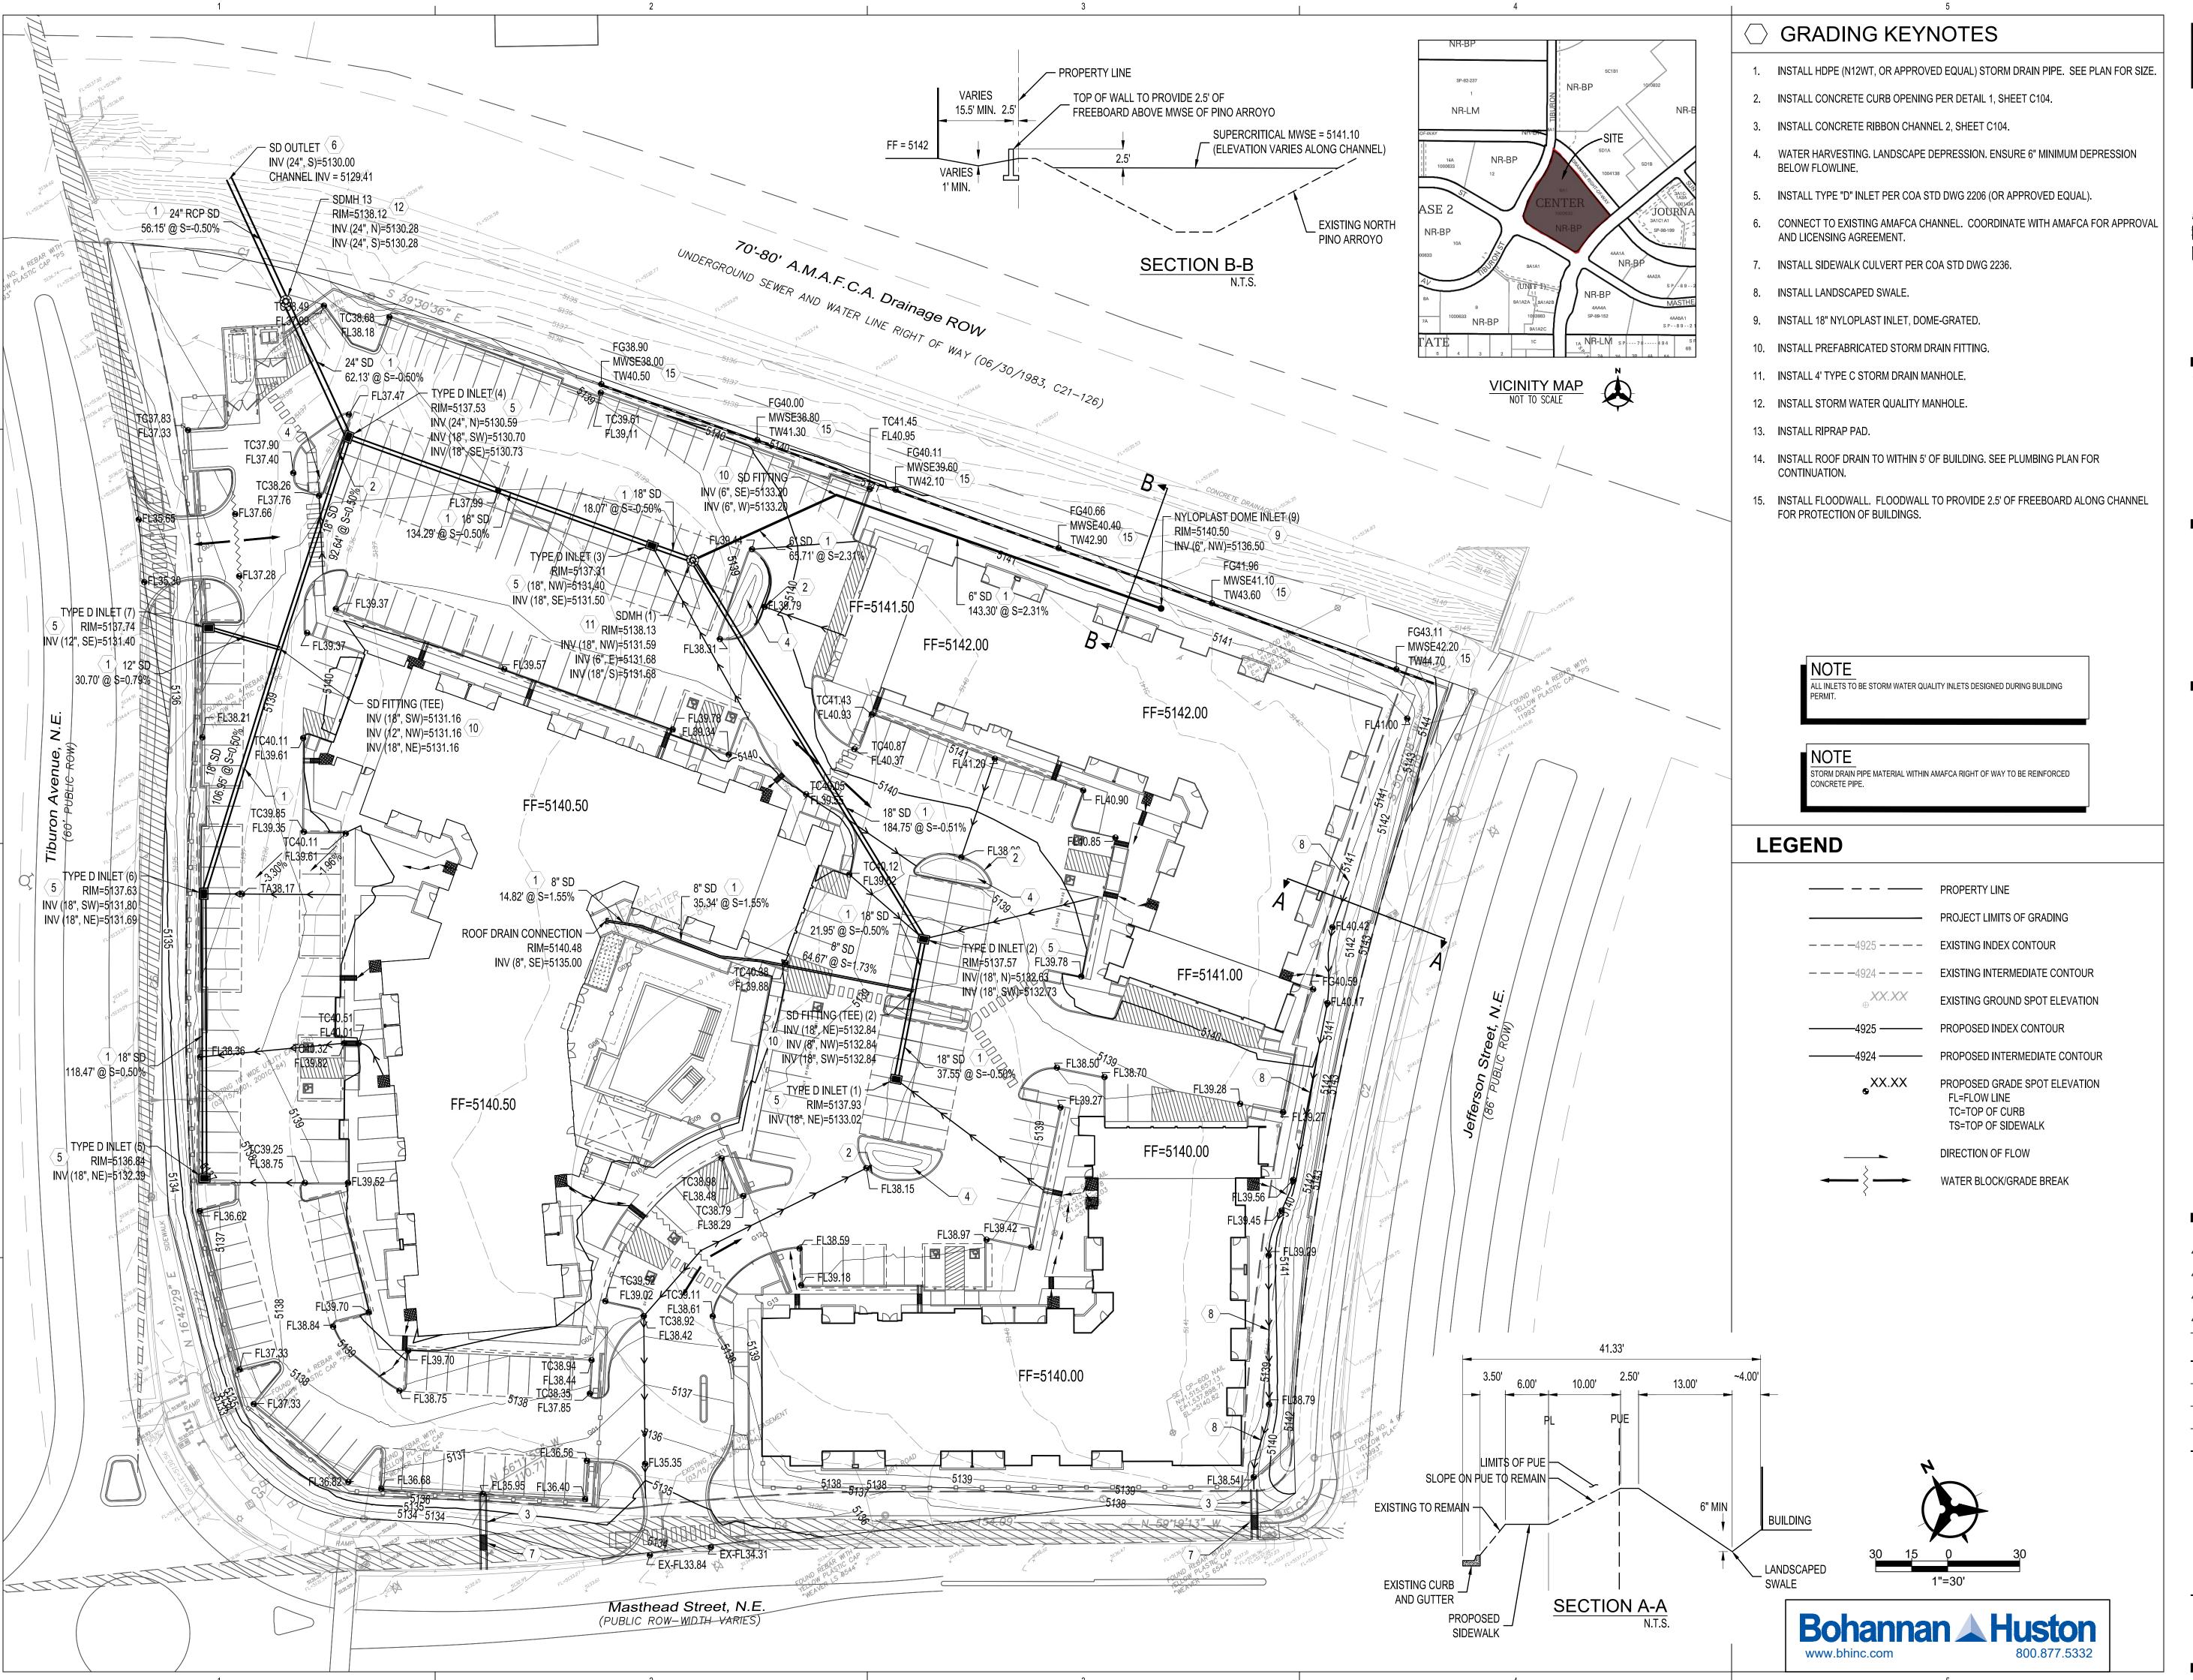

ARCHITECTURE DESIGN INSPIRATION

ARCHITECT



PROJECT

7501 JEFFERSON ST NE ALBUQUERQUE, NM, 87109

DESIGN REVIEW BOARD (DRB) -APPLICATION

DRAWN BY

REVIEWED BY

DATE 00.00.0000


PROJECT NO. 20-0029

DRAWING NAME

GRADING PLAN

SHEET NO.

C100

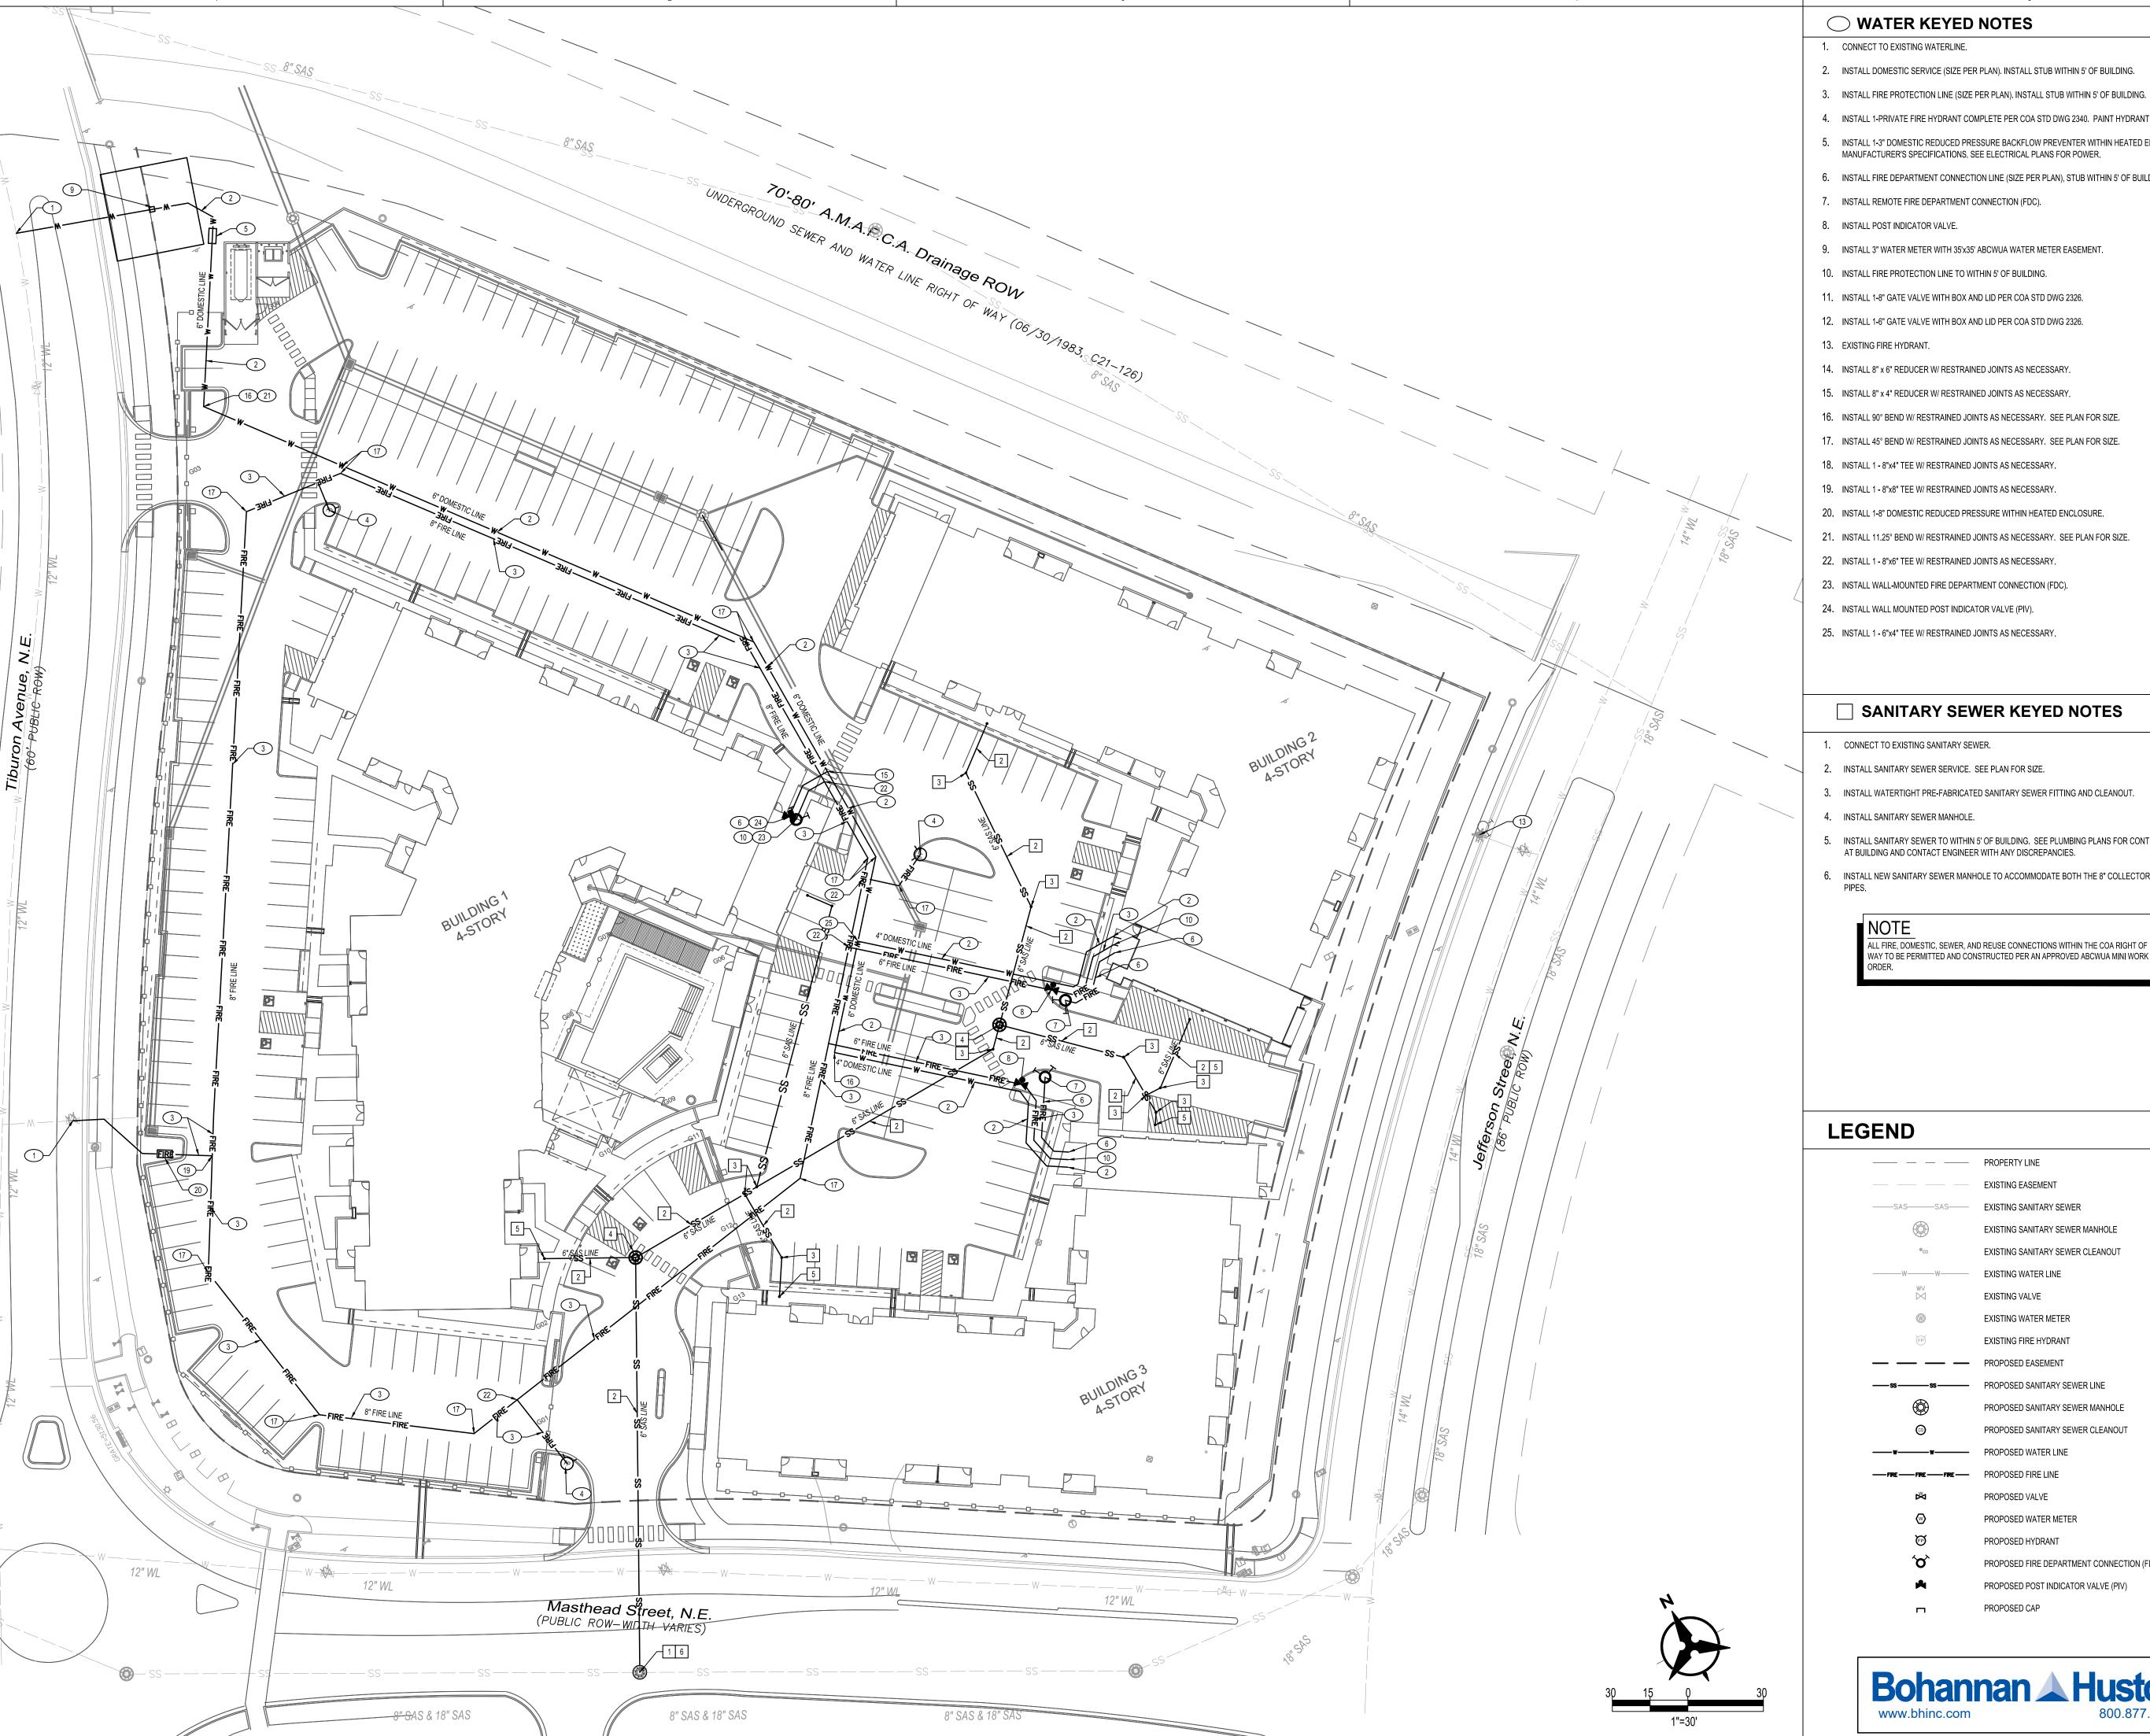

#### **WATER KEYED NOTES**

- 1. CONNECT TO EXISTING WATERLINE.
- 2. INSTALL DOMESTIC SERVICE (SIZE PER PLAN). INSTALL STUB WITHIN 5' OF BUILDING.
- 4. INSTALL 1-PRIVATE FIRE HYDRANT COMPLETE PER COA STD DWG 2340. PAINT HYDRANT SAFETY ORANGE.
- 5. INSTALL 1-3" DOMESTIC REDUCED PRESSURE BACKFLOW PREVENTER WITHIN HEATED ENCLOSURE. INSTALL PER MANUFACTURER'S SPECIFICATIONS. SEE ELECTRICAL PLANS FOR POWER.
- 6. INSTALL FIRE DEPARTMENT CONNECTION LINE (SIZE PER PLAN), STUB WITHIN 5' OF BUILDING.
- 7. INSTALL REMOTE FIRE DEPARTMENT CONNECTION (FDC).
- 8. INSTALL POST INDICATOR VALVE.
- 9. INSTALL 3" WATER METER WITH 35'x35' ABCWUA WATER METER EASEMENT.
- 10. INSTALL FIRE PROTECTION LINE TO WITHIN 5' OF BUILDING.
- 11. INSTALL 1-8" GATE VALVE WITH BOX AND LID PER COA STD DWG 2326.
- 12. INSTALL 1-6" GATE VALVE WITH BOX AND LID PER COA STD DWG 2326.
- 13. EXISTING FIRE HYDRANT.
- 14. INSTALL 8" x 6" REDUCER W/ RESTRAINED JOINTS AS NECESSARY.
- 15. INSTALL 8" x 4" REDUCER W/ RESTRAINED JOINTS AS NECESSARY.
- 16. INSTALL 90° BEND W/ RESTRAINED JOINTS AS NECESSARY. SEE PLAN FOR SIZE.
- 17. INSTALL 45° BEND W/ RESTRAINED JOINTS AS NECESSARY. SEE PLAN FOR SIZE.
- 18. INSTALL 1 8"x4" TEE W/ RESTRAINED JOINTS AS NECESSARY.
- 19. INSTALL 1 8"x8" TEE W/ RESTRAINED JOINTS AS NECESSARY.
- 20. INSTALL 1-8" DOMESTIC REDUCED PRESSURE WITHIN HEATED ENCLOSURE.
- 21. INSTALL 11.25° BEND W/ RESTRAINED JOINTS AS NECESSARY. SEE PLAN FOR SIZE.
- 22. INSTALL 1 8"x6" TEE W/ RESTRAINED JOINTS AS NECESSARY.
- 23. INSTALL WALL-MOUNTED FIRE DEPARTMENT CONNECTION (FDC).
- 24. INSTALL WALL MOUNTED POST INDICATOR VALVE (PIV).
- 25. INSTALL 1 6"x4" TEE W/ RESTRAINED JOINTS AS NECESSARY.

#### □ SANITARY SEWER KEYED NOTES

- 1. CONNECT TO EXISTING SANITARY SEWER.
- 2. INSTALL SANITARY SEWER SERVICE. SEE PLAN FOR SIZE.
- 3. INSTALL WATERTIGHT PRE-FABRICATED SANITARY SEWER FITTING AND CLEANOUT.
- 4. INSTALL SANITARY SEWER MANHOLE.
- 5. INSTALL SANITARY SEWER TO WITHIN 5' OF BUILDING. SEE PLUMBING PLANS FOR CONTINUATION. VERIFY INVERT AT BUILDING AND CONTACT ENGINEER WITH ANY DISCREPANCIES.
- 6. INSTALL NEW SANITARY SEWER MANHOLE TO ACCOMMODATE BOTH THE 8" COLLECTOR AND 18" INTERCEPTOR


ALL FIRE, DOMESTIC, SEWER, AND REUSE CONNECTIONS WITHIN THE COA RIGHT OF WAY TO BE PERMITTED AND CONSTRUCTED PER AN APPROVED ABCWUA MINI WORK

----- PROPERTY LINE EXISTING EASEMENT EXISTING SANITARY SEWER EXISTING SANITARY SEWER MANHOLE EXISTING SANITARY SEWER CLEANOUT EXISTING WATER LINE EXISTING VALVE EXISTING WATER METER EXISTING FIRE HYDRANT —ss—— PROPOSED SANITARY SEWER LINE PROPOSED SANITARY SEWER MANHOLE PROPOSED SANITARY SEWER CLEANOUT —FRE ——FRE —— PROPOSED FIRE LINE PROPOSED VALVE PROPOSED WATER METER PROPOSED HYDRANT PROPOSED FIRE DEPARTMENT CONNECTION (FDC) PROPOSED POST INDICATOR VALVE (PIV) PROPOSED CAP



# DEKKER PERICH SABATINI

ARCHITECTURE DESIGN INSPIRATION

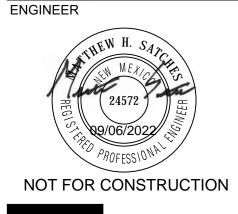

PROJECT

7501 JEFFERSON S<sup>-</sup> ALBUQUERQUE, NM,

**DESIGN REVIEW** BOARD (DRB) -**APPLICATION** 

REVISIONS


DRAWN BY REVIEWED BY

DATE 00.00.0000 20-0029 PROJECT NO.

DRAWING NAME

**UTILITY PLAN** 

SHEET NO.

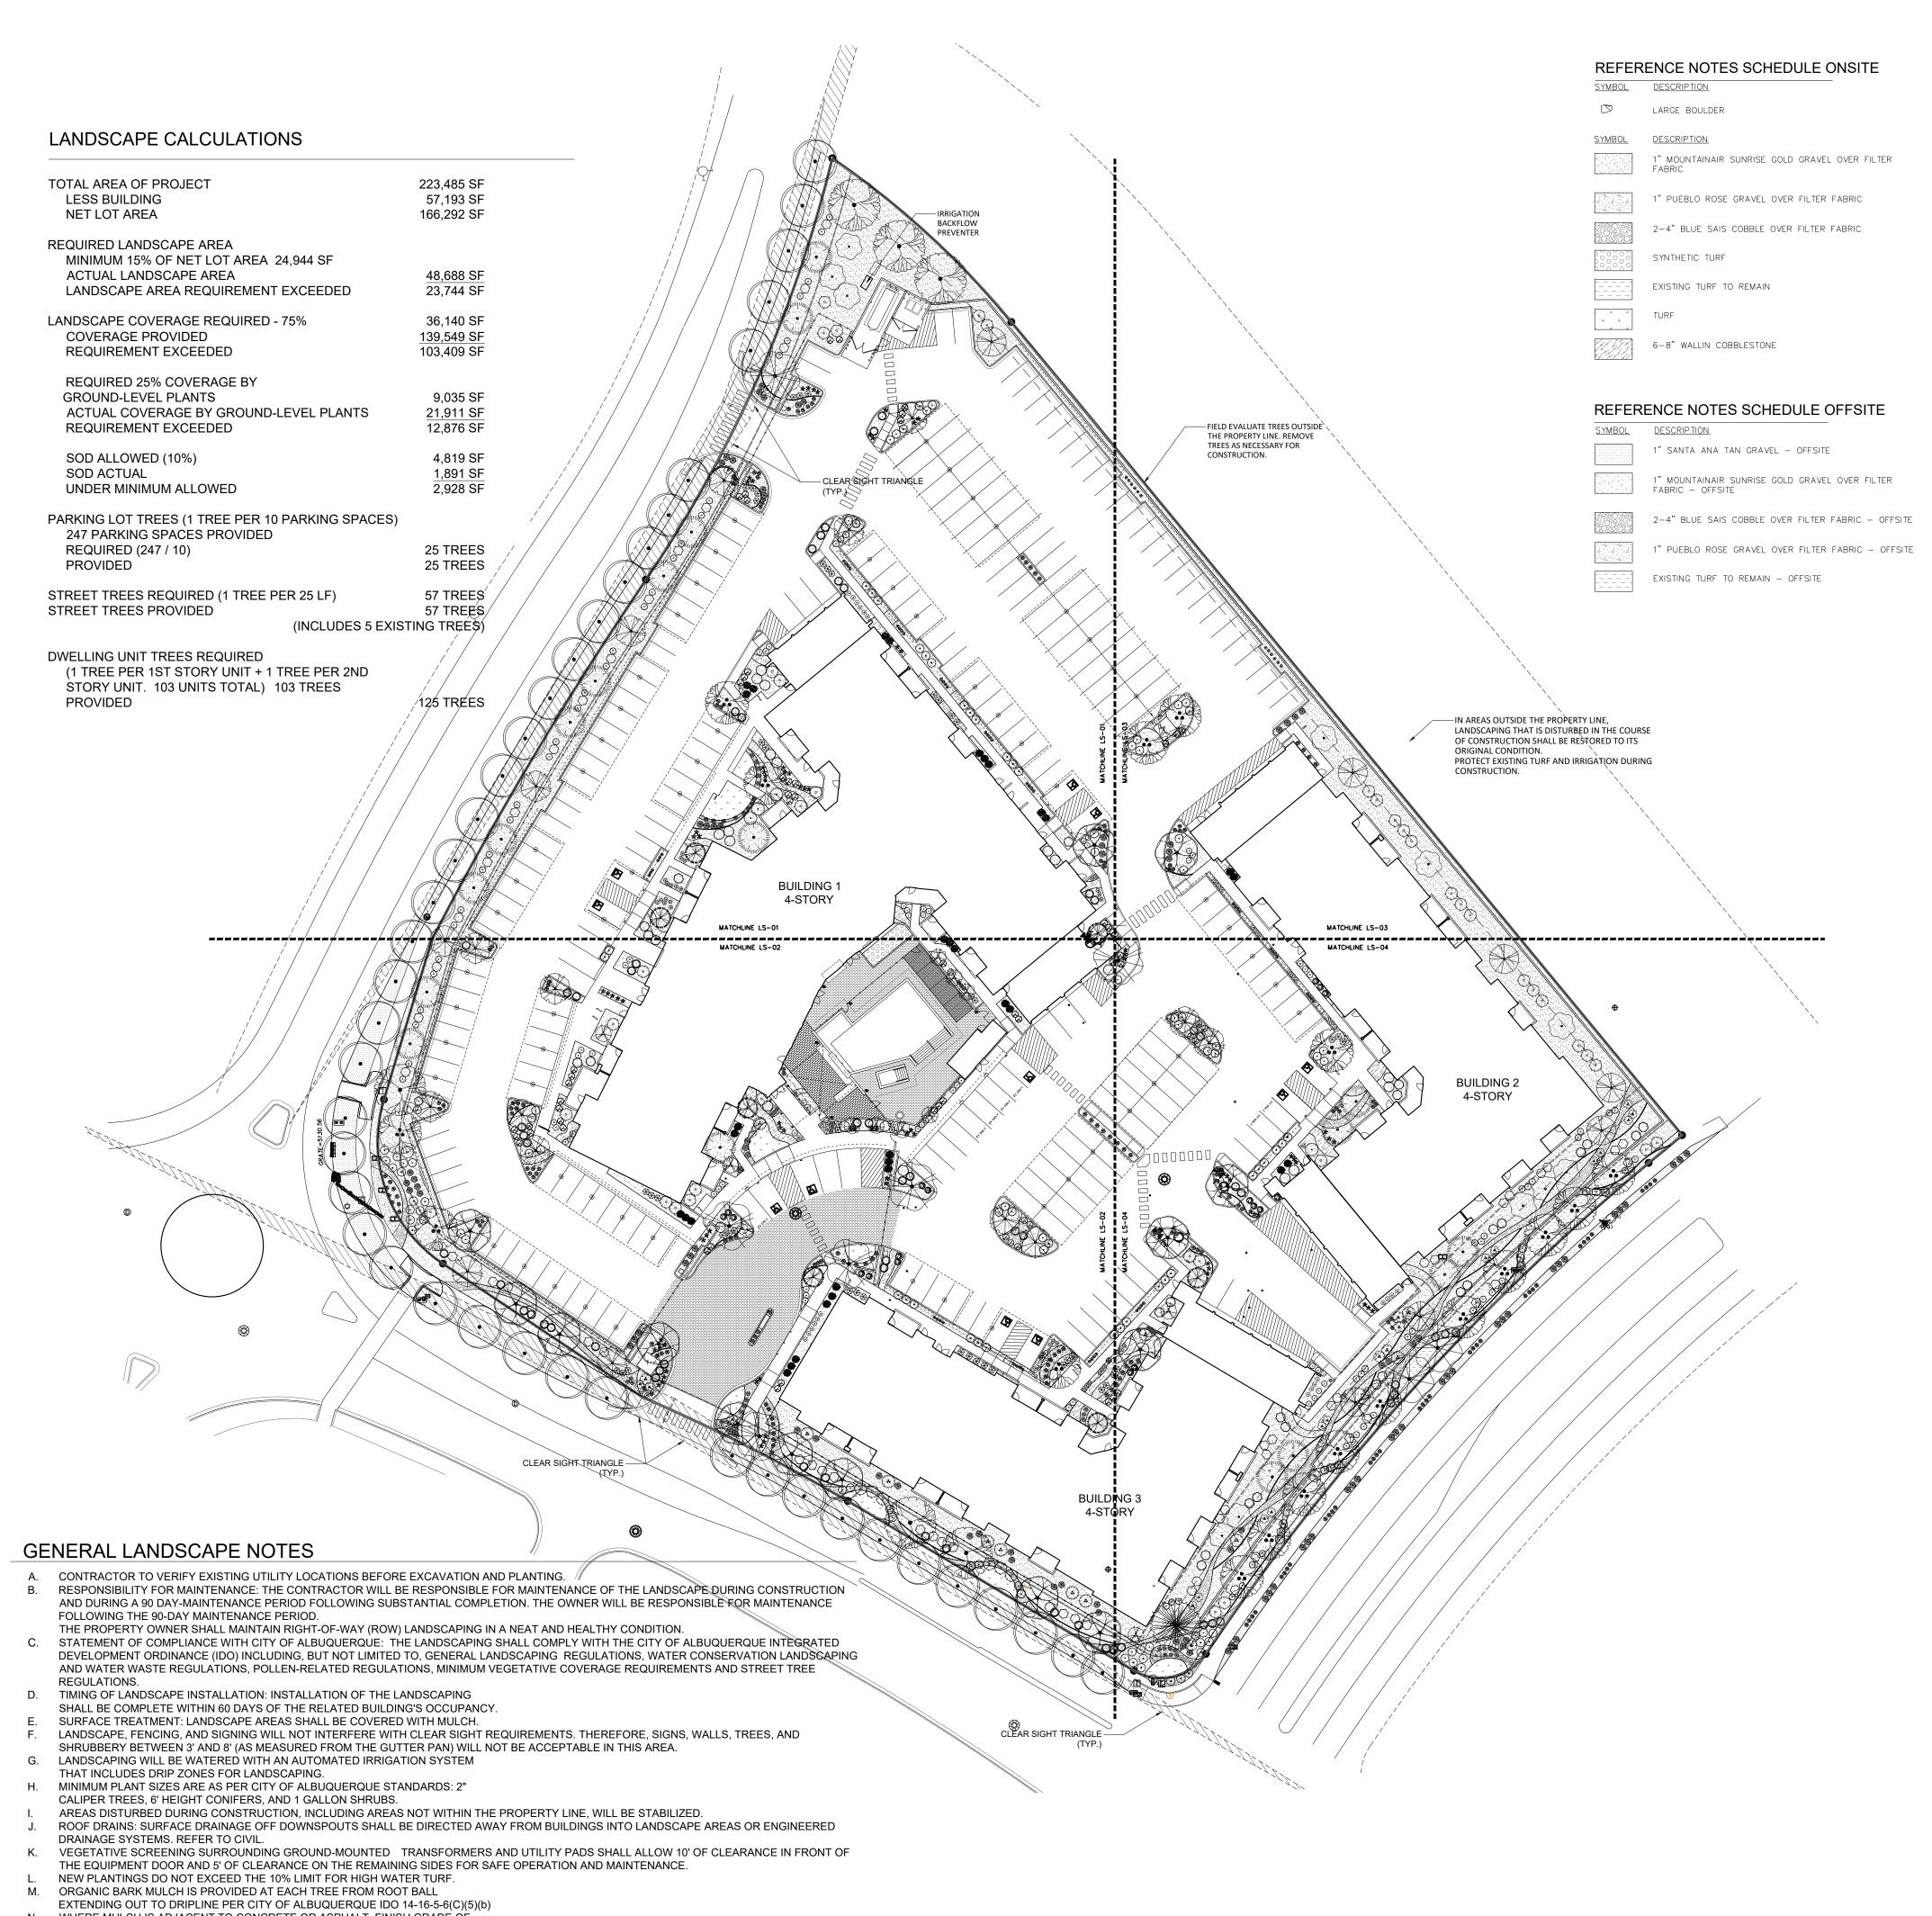

PLANT	SCHEDULE -	- ONSITE
1 -/ \1 1	COLIEDOLE	CITOLIE


DECIDUOUS TREES	QTY	BOTANICAL / COMMON NAME	<u>SIZE</u>	H X W	COVERAGE
	7	CHILOPSIS LINEARIS 'BUBBA' / BUBBA DESERT WILLOW	2" B&B	20' X 25'	491X7=3,437 SF
	17	CRATAEGUS CRUS-GALLI 'INERMIS' / THORNLESS HAWTHORN	2" B&B	50' X 45'	1590X17=27,030 SF
•	11	FORESTIERA NEOMEXICANA / NEW MEXICAN PRIVET	24"BOX	15' X 15'	177X11=1,947 SF
A	14	FRAXINUS OXYCARPA 'RAYWOOD' TM / RAYWOOD ASH	2" B&B	35' X 25'	2826X14=39,564 SF
	11	LAGERSTROEMIA INDICA / CRAPE MYRTLE	24"B0X	15' X 15'	177X11=1,947 SF
	8	PISTACIA CHINENSIS / CHINESE PISTACHE	2" B&B	40' X 30'	2826X8=22,608 SF
	18	QUERCUS MUEHLENBERGII / CHINKAPIN OAK	2" B&B	40' X 40'	491X18=8,838 SF
	6	ULMUS PARVIFOLIA 'ALLEE' / ALLEE LACEBARK ELM	2" B&B	40' X 40'	1256X6=7,536 SF
EVERGREEN TREES	QTY	BOTANICAL / COMMON NAME	<u>SIZE</u>	H X W	COVERAGE
	1	CEDRUS ATLANTICA / ATLAS CEDAR	6'-8' B&	ς 75' Χ 50'	1963X1=1,963 SF
	18	JUNIPERUS SCOPULORUM / ROCKY MOUNTAIN JUNIPER	15 GAL	40' X 20'	314X18=5652 SF
Water State of the	7	PINUS NIGRA / AUSTRIAN BLACK PINE	10' B&B	35' X 25'	79X7=553 SF
DESERT ACCENTS	QTY	BOTANICAL / COMMON NAME	<u>SIZE</u>	<u>HXW</u>	121,075 SF COVERAGE
	9	DASYLIRION TEXANUM / TEXAS SOTOL	5 GAL	5' X 5'	20X9=180 SF
•	17	HESPERALOE PARVIFLORA / RED YUCCA	5 GAL	3' X 4'	13X17=221 SF
( A CONTRACT OF THE CONTRACT O	11	NOLINA MICROCARPA / BEARGRASS	5 GAL	5' X 6'	28X11=308 SF
GRASSES	<u>QTY</u> 124	BOTANICAL / COMMON NAME  BOUTELOUA GRACILIS 'BLONDE AMBITION' / BLONDE AMBITION BLUE GRAMA	SIZE 1 GAL	HXW 3' X 3'	COVERAGE  7X124=868 SF
	69	CALAMAGROSTIS X ACUTIFLORA 'KARL FOERSTER' / FEATHER REED GRASS			3X69=207 SF
	65	MUHLENBERGIA CAPILLARIS 'REGAL MIST' TM / MUHLY	1 GAL	3' X 3'	7x65=455 SF
DECIDUOUS SHRUBS	QTY	BOTANICAL / COMMON NAME	SIZE	HXW	COVERAGE
*	87	BERBERIS THUNBERGII 'CRIMSON PYGMY' / CRIMSON PYGMY BARBERRY	5 GAL	2' X 3'	13X87=1,131 SF
$\bigcirc$	27	BUDDLEJA DAVIDII / BUTTERFLY BUSH	5 GAL	4' X 4'	13X21=351 SF
0	18	CARYOPTERIS X CLANDONENSIS 'DARK KNIGHT' / BLUE MIST SPIREA	1 GAL	3' × 3'	7X18=126 SF
ۥ3	39	GAILLARDIA X GRANDIFLORA / BLANKETFLOWER	1 GAL	2' X 2'	3X39=117 SF
$\odot$	28	LAVANDULA ANGUSTIFOLIA / ENGLISH LAVENDER	1 GAL	3' X 3'	7X28=196 SF
0	21	LEUCOPHYLLUM FRUTESCENS / TEXAS SAGE	5 GAL	6' X 6'	28X21=588 SF
•	40	NEPETA X FAASSENII 'SELECT BLUE' / CATMINT	1 GAL	1' X 2'	3X40=120 SF
+	9	PENSTEMON PINIFOLIUS / THREADLEAF BEARDTONGUE	1 GAL	1" X 20"	3X9=27 SF
$\odot$	75	RHUS AROMATICA 'GRO-LOW' / GRO-LOW FRAGRANT SUMAC	5 GAL	4' X 2'	13X75=975 SF
	33	ROSA X 'KNOCKOUT' TM / ROSE	5 GAL	6' X 5'	20X33=660 SF
+	22	SALVIA GREGGII / AUTUMN SAGE CHERRY	1 GAL	2' X 3'	7X22=154 SF
EVERGREEN SHRUBS	QTY	BOTANICAL / COMMON NAME	<u>SIZE</u>	HXW	<u>COVERAGE</u>
()	48	CERCOCARPUS LEDIFOLIUS / CURL—LEAF MOUNTAIN MAHOGANY	5 GAL	15' X 15'	177X48=8,496 SF
$\odot$	4	COTONEASTER GLAUCOPHYLLUS / GREYLEAF COTONEASTER	5 GAL	2' X 9'	64X4=256 SF
	67	ERICAMERIA LARICIFOLIA / TURPENTINE BUSH	5 GAL	3' × 4'	13X67=871 SF
$\bigcirc$	57	FALLUGIA PARADOXA / APACHE PLUME	5 GAL	6' X 7'	38X57=2,166 SF
$\odot$	44	JUNIPERUS HORIZONTALIS 'BLUE CHIP' / BLUE CHIP JUNIPER	5 GAL	1.5' X 3'	7X44=308 SF
	59	PINUS MUGO MUGO / DWARF MUGO PINE	5 GAL	4' × 4'	13X59=767 SF
$\otimes$	61	RHAPHIOLEPIS INDICA / INDIAN HAWTHORN	5 GAL	3' X 4'	13X61=793 SF
$\bigotimes$	49	ROSMARINUS OFFICINALIS / ROSEMARY	5 GAL	6' X 6'	28X49=1,372 SF
GROUNDCOVERS	QTY	BOTANICAL / COMMON NAME	SIZE	HXW	COVERAGE
	66	TEUCRIUM AROANIUM / CREEPING GERMANDER	1 GAL	1' X 2' SUBTOTAL TOTAL	3X66=198 SF 21,911 SF 139,549 SF

#### PLANT SCHEDULE OFFSITE

DECIDUOUS TREES	QTY	BOTANICAL / COMMON NAME	SIZE	<u>H X W</u>
	42	ULMUS X 'FRONTIER' / FRONTIER ELM	2" B&B	40' X 40'
<u>GRASSES</u>	QTY	BOTANICAL / COMMON NAME	SIZE	<u>HXW</u>
	37	BOUTELOUA GRACILIS 'BLONDE AMBITION' / BLONDE AMBITION BLUE GRAMA	1 GAL	3' X 3'
	30	MUHLENBERGIA CAPILLARIS 'REGAL MIST' TM / MUHLY	1 GAL	3' × 3'
DECIDUOUS SHRUBS	QTY	BOTANICAL / COMMON NAME	SIZE	<u>HXW</u>
$\odot$	2	NEPETA X FAASSENII 'SELECT BLUE' / CATMINT	1 GAL	1' X 2'
EVERGREEN SHRUBS	QTY	BOTANICAL / COMMON NAME	<u>SIZE</u>	<u>HXW</u>
$\odot$	7	JUNIPERUS HORIZONTALIS 'BLUE CHIP' / BLUE CHIP JUNIPER	5 GAL	1.5' X 3'




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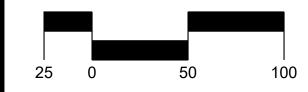


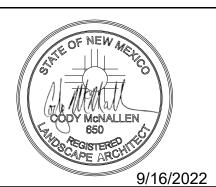Date: 9/29/2021 Revisions:

Drawn by: PL Reviewed by: <u>CM</u>

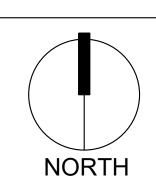

Scale: 1" = 50'




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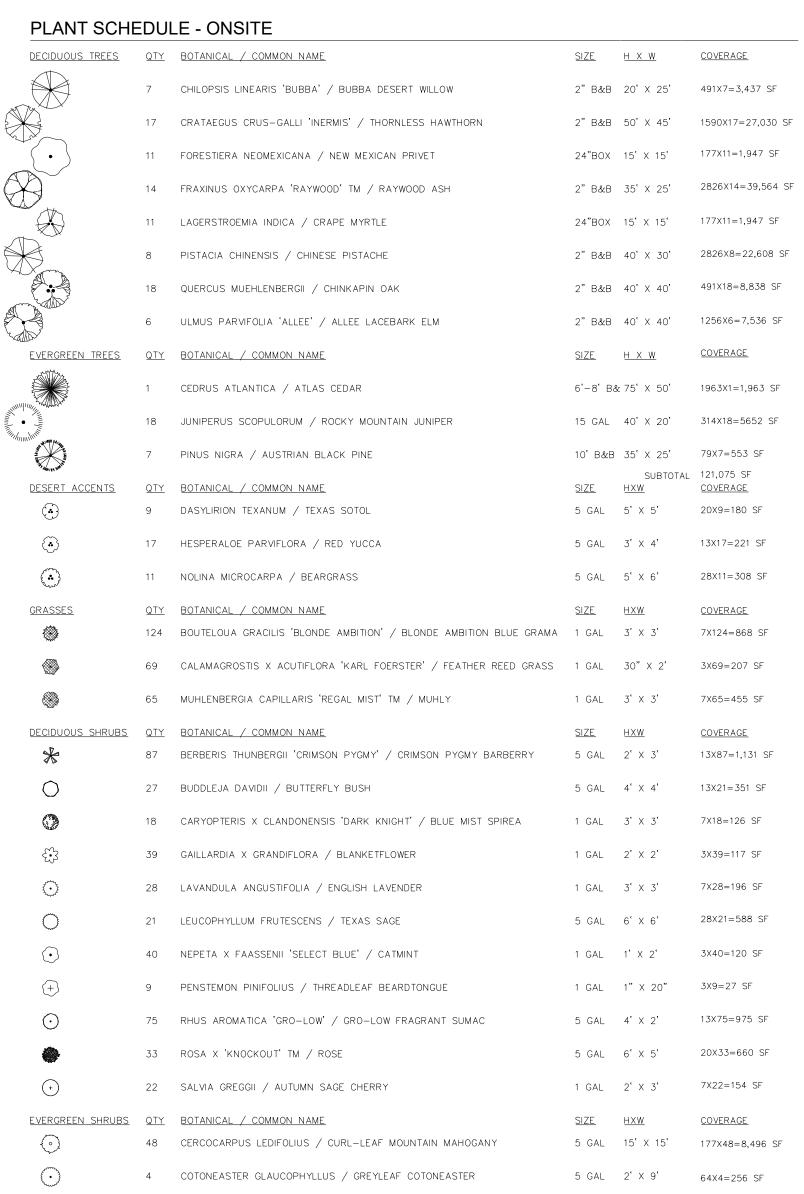
Landscape Plan

Sheet Number:

N. WHERE MULCH IS ADJACENT TO CONCRETE OR ASPHALT, FINISH GRADE OF MULCH SHALL 1/2" BELOW TOP OF CONCRETE, UNLESS OTHERWISE INDICATED. O. PLANT MATERIAL SHALL BE FREE OF DISEASE AND INSECTS AND SHALL CONFORM TO THE AMERICAN STANDARD FOR NURSERY STOCK (ASNA) OF

THE AMERICAN NURSERY AND LANDSCAPE ASSOCIATION. ALL LANDSCAPING CONTIGUOUS TO INDIGENOUS AREAS TO BE PLANTED WITH INDIGENOUS TREES AND SHRUBS. Q. PLANTINGS IN CLEAR SIGHT TRIANGLE NOT TO OBSTRUCT LINE OF VISION FROM 3' HEIGHT TO 8' HEIGHT'



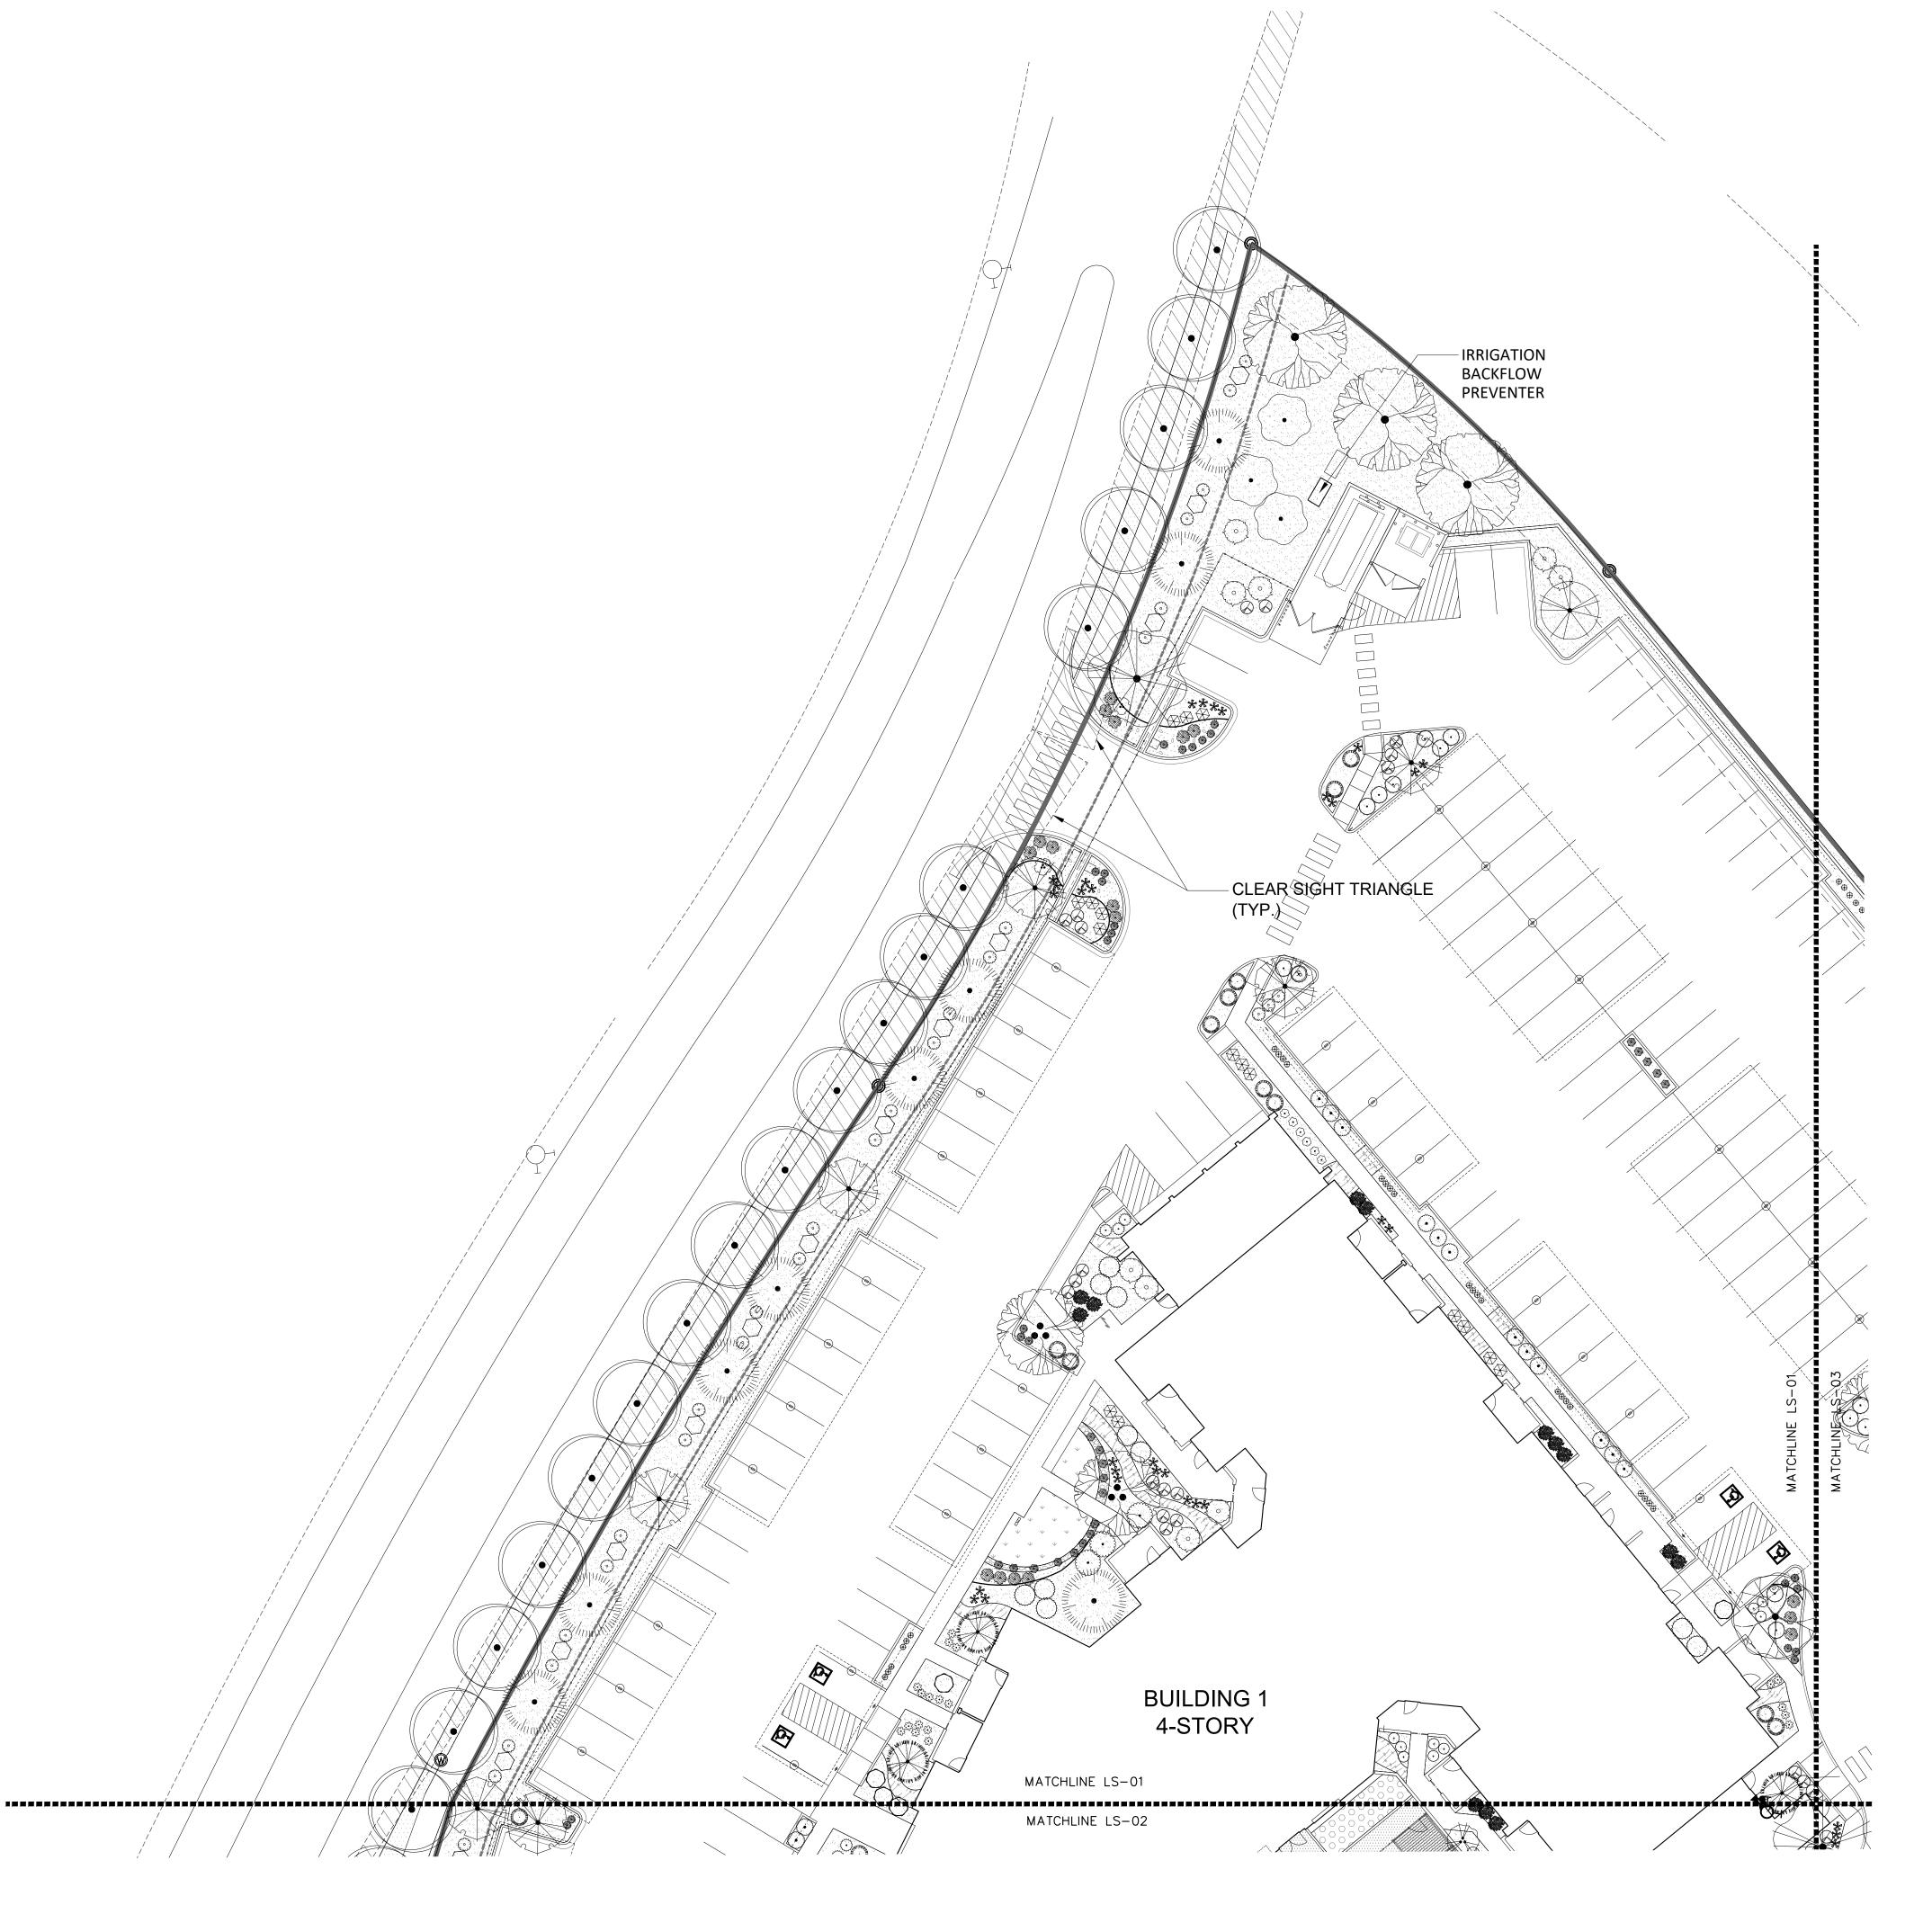

67 ERICAMERIA LARICIFOLIA / TURPENTINE BUSH

44 JUNIPERUS HORIZONTALIS 'BLUE CHIP' / BLUE CHIP JUNIPER

57 FALLUGIA PARADOXA / APACHE PLUME

59 PINUS MUGO MUGO / DWARF MUGO PINE

61 RHAPHIOLEPIS INDICA / INDIAN HAWTHORN

66 TEUCRIUM AROANIUM / CREEPING GERMANDER

49 ROSMARINUS OFFICINALIS / ROSEMARY

QTY BOTANICAL / COMMON NAME

DECIDUOUS SHRUBS QTY BOTANICAL / COMMON NAME

2 NEPETA X FAASSENII 'SELECT BLUE' / CATMINT

1 GAL 1' X 2'

EVERGREEN SHRUBS QTY BOTANICAL / COMMON NAME

3IZE HXW

SIZE HXW

5IZE HXW

5IZE HXW

5IZE HXW

6 7 JUNIPERUS HORIZONTALIS 'BLUE CHIP' / BLUE CHIP JUNIPER

5 GAL 1.5' X 3'

# REFERENCE NOTES SCHEDULE ONSITE SYMBOL DESCRIPTION

LARGE BOULDER

SYMBOL DESCRIPTION

1" MOUNTAINAIR SUNRISE GOLD GRAVEL OVER FILTER

1" MOUNTAINAIR SUNRISE GOLD GRAVEL OVER F
FABRIC

1" PUEBLO ROSE GRAVEL OVER FILTER FABRIC

2-4" BLUE SAIS COBBLE OVER FILTER FABRIC

SYNTHETIC TURF

SYNTHETIC TURF

----
EXISTING TURF TO REMAIN

<u>GROUNDCOVERS</u>

TURF

6-8" WALLIN COBBLESTONE

#### REFERENCE NOTES SCHEDULE OFFSITE

5 GAL 3' X 4' 13X67=871 SF

5 GAL 6' X 7' 38X57=2,166 SF

5 GAL 1.5' X 3' 7X44=308 SF

5 GAL 4' X 4' 13X59=767 SF

5 GAL 3' X 4' 13X61=793 SF

5 GAL 6' X 6'

<u>SIZE</u> <u>HXW</u>

28X49=1,372 SF

COVERAGE

SUBTOTAL 21,911 SF TOTAL 139,549 SF

SYMBOL DESCRIPTION

1" SANTA ANA TAN GRAVEL - OFFSITE

1" MOUNTAINAIR SUNRISE GOLD GRAVEL O

1" MOUNTAINAIR SUNRISE GOLD GRAVEL OVER FILTER
FABRIC — OFFSITE

2-4" BLUE SAIS COBBLE OVER FILTER FABRIC - OFFSITE

1" PUEBLO ROSE GRAVEL OVER FILTER FABRIC - OFFSITE

EXISTING TURF TO REMAIN - OFFSITE


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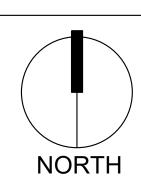
9/16/2022


Date: 9/29/2021

Revisions: 4/21/2022 DRB 9/16/2022 DRB

Drawn by: <u>PL</u> Reviewed by: <u>CM</u>

Allaso JC6

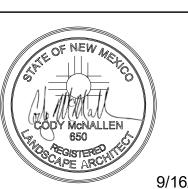


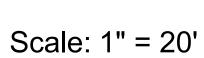


Sheet Title:

Plan

Landscape

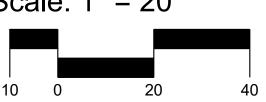

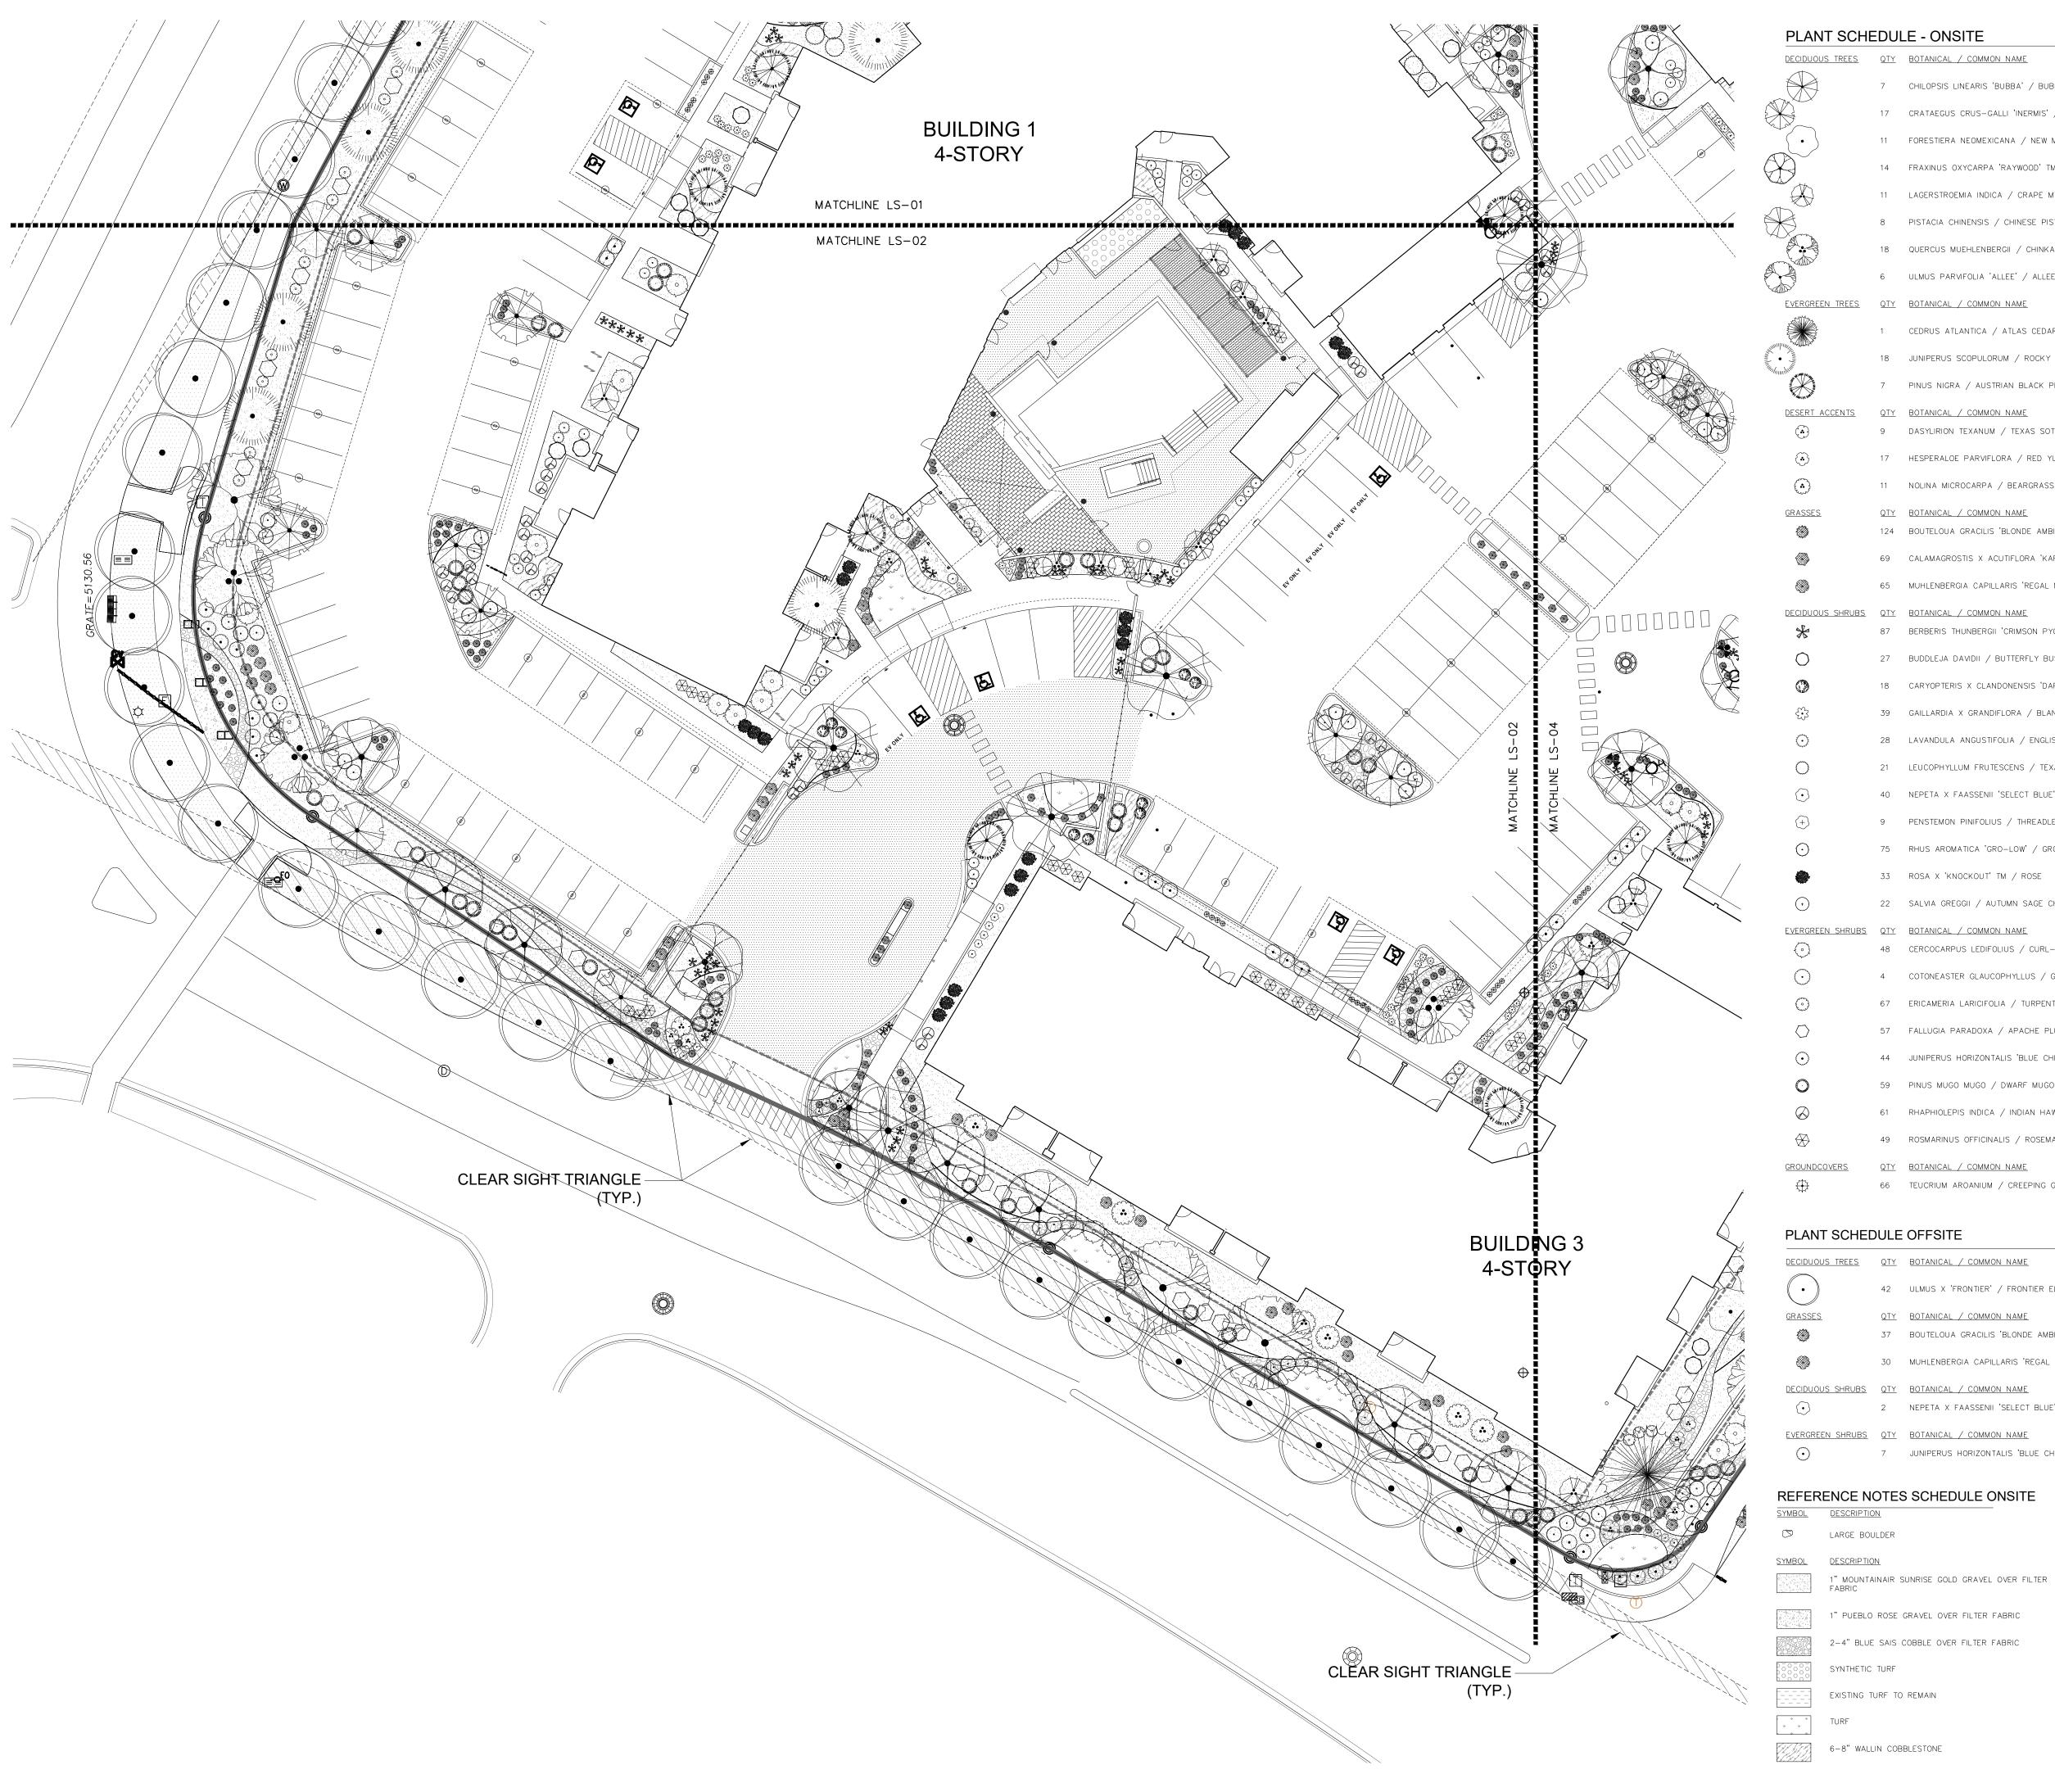

PLANT SCHE	EDUL	LE - ONSITE			
DECIDUOUS TREES	QTY	BOTANICAL / COMMON NAME	<u>SIZE</u>	H X W	<u>COVERAGE</u>
	7	CHILOPSIS LINEARIS 'BUBBA' / BUBBA DESERT WILLOW	2" B&B	20' X 25'	491X7=3,437 SF
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	14	FRAXINUS OXYCARPA 'RAYWOOD' TM / RAYWOOD ASH	2" B&B	35' X 25'	2826X14=39,564 SF
	11	LAGERSTROEMIA INDICA / CRAPE MYRTLE	24"BOX	15' X 15'	177X11=1,947 SF
	8	PISTACIA CHINENSIS / CHINESE PISTACHE	2" B&B	40' X 30'	2826X8=22,608 SF
	18	QUERCUS MUEHLENBERGII / CHINKAPIN OAK	2" B&B	40' X 40'	491X18=8,838 SF
	6	ULMUS PARVIFOLIA 'ALLEE' / ALLEE LACEBARK ELM	2" B&B	40' X 40'	1256X6=7,536 SF
EVERGREEN TREES	QTY	BOTANICAL / COMMON NAME	<u>SIZE</u>	<u>H X W</u>	<u>COVERAGE</u>
	1	CEDRUS ATLANTICA / ATLAS CEDAR	6'-8' B&	k 75' X 50'	1963X1=1,963 SF
• 1	18	JUNIPERUS SCOPULORUM / ROCKY MOUNTAIN JUNIPER	15 GAL	40' X 20'	314X18=5652 SF
William Wall	7	PINUS NIGRA / AUSTRIAN BLACK PINE	10' B&B	35' X 25'	79X7=553 SF
DESERT ACCENTS	QTY	BOTANICAL / COMMON NAME	<u>SIZE</u>	SUBTOTAL <u>HXW</u>	121,075 SF COVERAGE
	9	DASYLIRION TEXANUM / TEXAS SOTOL	5 GAL	5' X 5'	20X9=180 SF
	17	HESPERALOE PARVIFLORA / RED YUCCA	5 GAL	3' X 4'	13X17=221 SF
<b>*</b>	11	NOLINA MICROCARPA / BEARGRASS	5 GAL	5' X 6'	28X11=308 SF
<u>GRASSES</u>		BOTANICAL / COMMON NAME	<u>SIZE</u>	HXW	COVERAGE
<b>₩</b>	124	BOUTELOUA GRACILIS 'BLONDE AMBITION' / BLONDE AMBITION BLUE GRAMA		3' X 3'	7X124=868 SF
	69	,	1 GAL	30" X 2'	3X69=207 SF
	65	MUHLENBERGIA CAPILLARIS 'REGAL MIST' TM / MUHLY	1 GAL	3' X 3'	7X65=455 SF
DECIDUOUS SHRUBS	<u>QTY</u> 87	BOTANICAL / COMMON NAME  BERBERIS THUNBERGII 'CRIMSON PYGMY' / CRIMSON PYGMY BARBERRY	<u>SIZE</u> 5 GAL	HXW 2' X 3'	COVERAGE 13X87=1,131 SF
0	27	BUDDLEJA DAVIDII / BUTTERFLY BUSH	5 GAL	4' × 4'	13X21=351 SF
	18	CARYOPTERIS X CLANDONENSIS 'DARK KNIGHT' / BLUE MIST SPIREA	1 GAL	3' X 3'	7X18=126 SF
€;3	39	GAILLARDIA X GRANDIFLORA / BLANKETFLOWER	1 GAL	2' X 2'	3X39=117 SF
$\circ$	28	LAVANDULA ANGUSTIFOLIA / ENGLISH LAVENDER	1 GAL	3' X 3'	7X28=196 SF
0	21	LEUCOPHYLLUM FRUTESCENS / TEXAS SAGE	5 GAL	6' X 6'	28X21=588 SF
$\odot$	40	NEPETA X FAASSENII 'SELECT BLUE' / CATMINT	1 GAL	1' X 2'	3X40=120 SF
+	9	PENSTEMON PINIFOLIUS / THREADLEAF BEARDTONGUE	1 GAL	1" X 20"	3X9=27 SF
$\odot$	75	RHUS AROMATICA 'GRO-LOW' / GRO-LOW FRAGRANT SUMAC	5 GAL	4' X 2'	13X75=975 SF
<b>*</b>	33	ROSA X 'KNOCKOUT' TM / ROSE	5 GAL	6' X 5'	20X33=660 SF
+	22	SALVIA GREGGII / AUTUMN SAGE CHERRY	1 GAL	2' X 3'	7X22=154 SF
EVERGREEN SHRUBS	<u>QTY</u> 48	BOTANICAL / COMMON NAME  CERCOCARPUS LEDIFOLIUS / CURL-LEAF MOUNTAIN MAHOGANY	<u>SIZE</u> 5 GAL	HXW 15' X 15'	COVERAGE 177X48=8,496 SF
$\odot$	4	COTONEASTER GLAUCOPHYLLUS / GREYLEAF COTONEASTER	5 GAL	2' X 9'	64X4=256 SF
	67	ERICAMERIA LARICIFOLIA / TURPENTINE BUSH	5 GAL	3' X 4'	13X67=871 SF
$\bigcirc$	57	FALLUGIA PARADOXA / APACHE PLUME	5 GAL	6' X 7'	38X57=2,166 SF
$\odot$	44	JUNIPERUS HORIZONTALIS 'BLUE CHIP' / BLUE CHIP JUNIPER	5 GAL	1.5' X 3'	7X44=308 SF
	59	PINUS MUGO MUGO / DWARF MUGO PINE	5 GAL	4' X 4'	13X59=767 SF
$\otimes$	61	RHAPHIOLEPIS INDICA / INDIAN HAWTHORN	5 GAL	3' X 4'	13X61=793 SF
$\bigotimes$	49	ROSMARINUS OFFICINALIS / ROSEMARY	5 GAL	6' X 6'	28X49=1,372 SF
GROUNDCOVERS	<u>QTY</u> 66	BOTANICAL / COMMON NAME TEUCRIUM AROANIUM / CREEPING GERMANDER	<u>SIZE</u> 1 GAL	HXW 1' X 2'	COVERAGE  3X66=198 SF 21,911 SF

DECIDUOUS TREES	QTY	BOTANICAL / COMMON NAME	SIZE	<u>H X W</u>
	42	ULMUS X 'FRONTIER' / FRONTIER ELM	2" B&B	40' X 40'
<u>GRASSES</u>	QTY	BOTANICAL / COMMON NAME	<u>SIZE</u>	<u>HXW</u>
	37	BOUTELOUA GRACILIS 'BLONDE AMBITION' / BLONDE AMBITION BLUE GRAMA	1 GAL	3' X 3'
	30	MUHLENBERGIA CAPILLARIS 'REGAL MIST' TM / MUHLY	1 GAL	3' X 3'
DECIDUOUS SHRUBS	QTY	BOTANICAL / COMMON NAME	<u>SIZE</u>	<u>HXW</u>
$\odot$	2	NEPETA X FAASSENII 'SELECT BLUE' / CATMINT	1 GAL	1' X 2'
EVERGREEN SHRUBS	QTY	BOTANICAL / COMMON NAME	SIZE	<u>HXW</u>
$\odot$	7	JUNIPERUS HORIZONTALIS 'BLUE CHIP' / BLUE CHIP JUNIPER	5 GAL	1.5' X 3'

1" SANTA ANA TAN GRAVEL - OFFSITE

1" MOUNTAINAIR SUNRISE GOLD GRAVEL OVER FILTER FABRIC — OFFSITE


2-4" BLUE SAIS COBBLE OVER FILTER FABRIC - OFFSITE 1" PUEBLO ROSE GRAVEL OVER FILTER FABRIC - OFFSITE

Sheet Number: EXISTING TURF TO REMAIN - OFFSITE

LS-02




PO Box 10597 Albuquerque, NM 87184 505.898.9615 design@yellowstonelandscape.com

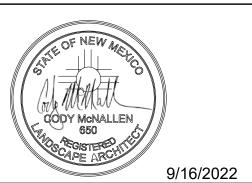

Date: 9/29/2021 Revisions: 4/21/2022 DRB

9/16/2022 DRB

Drawn by: PL Reviewed by: <u>CM</u>

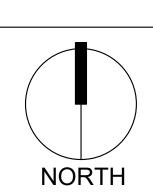


Scale: 1" = 20'



Sheet Title:

Landscape Plan

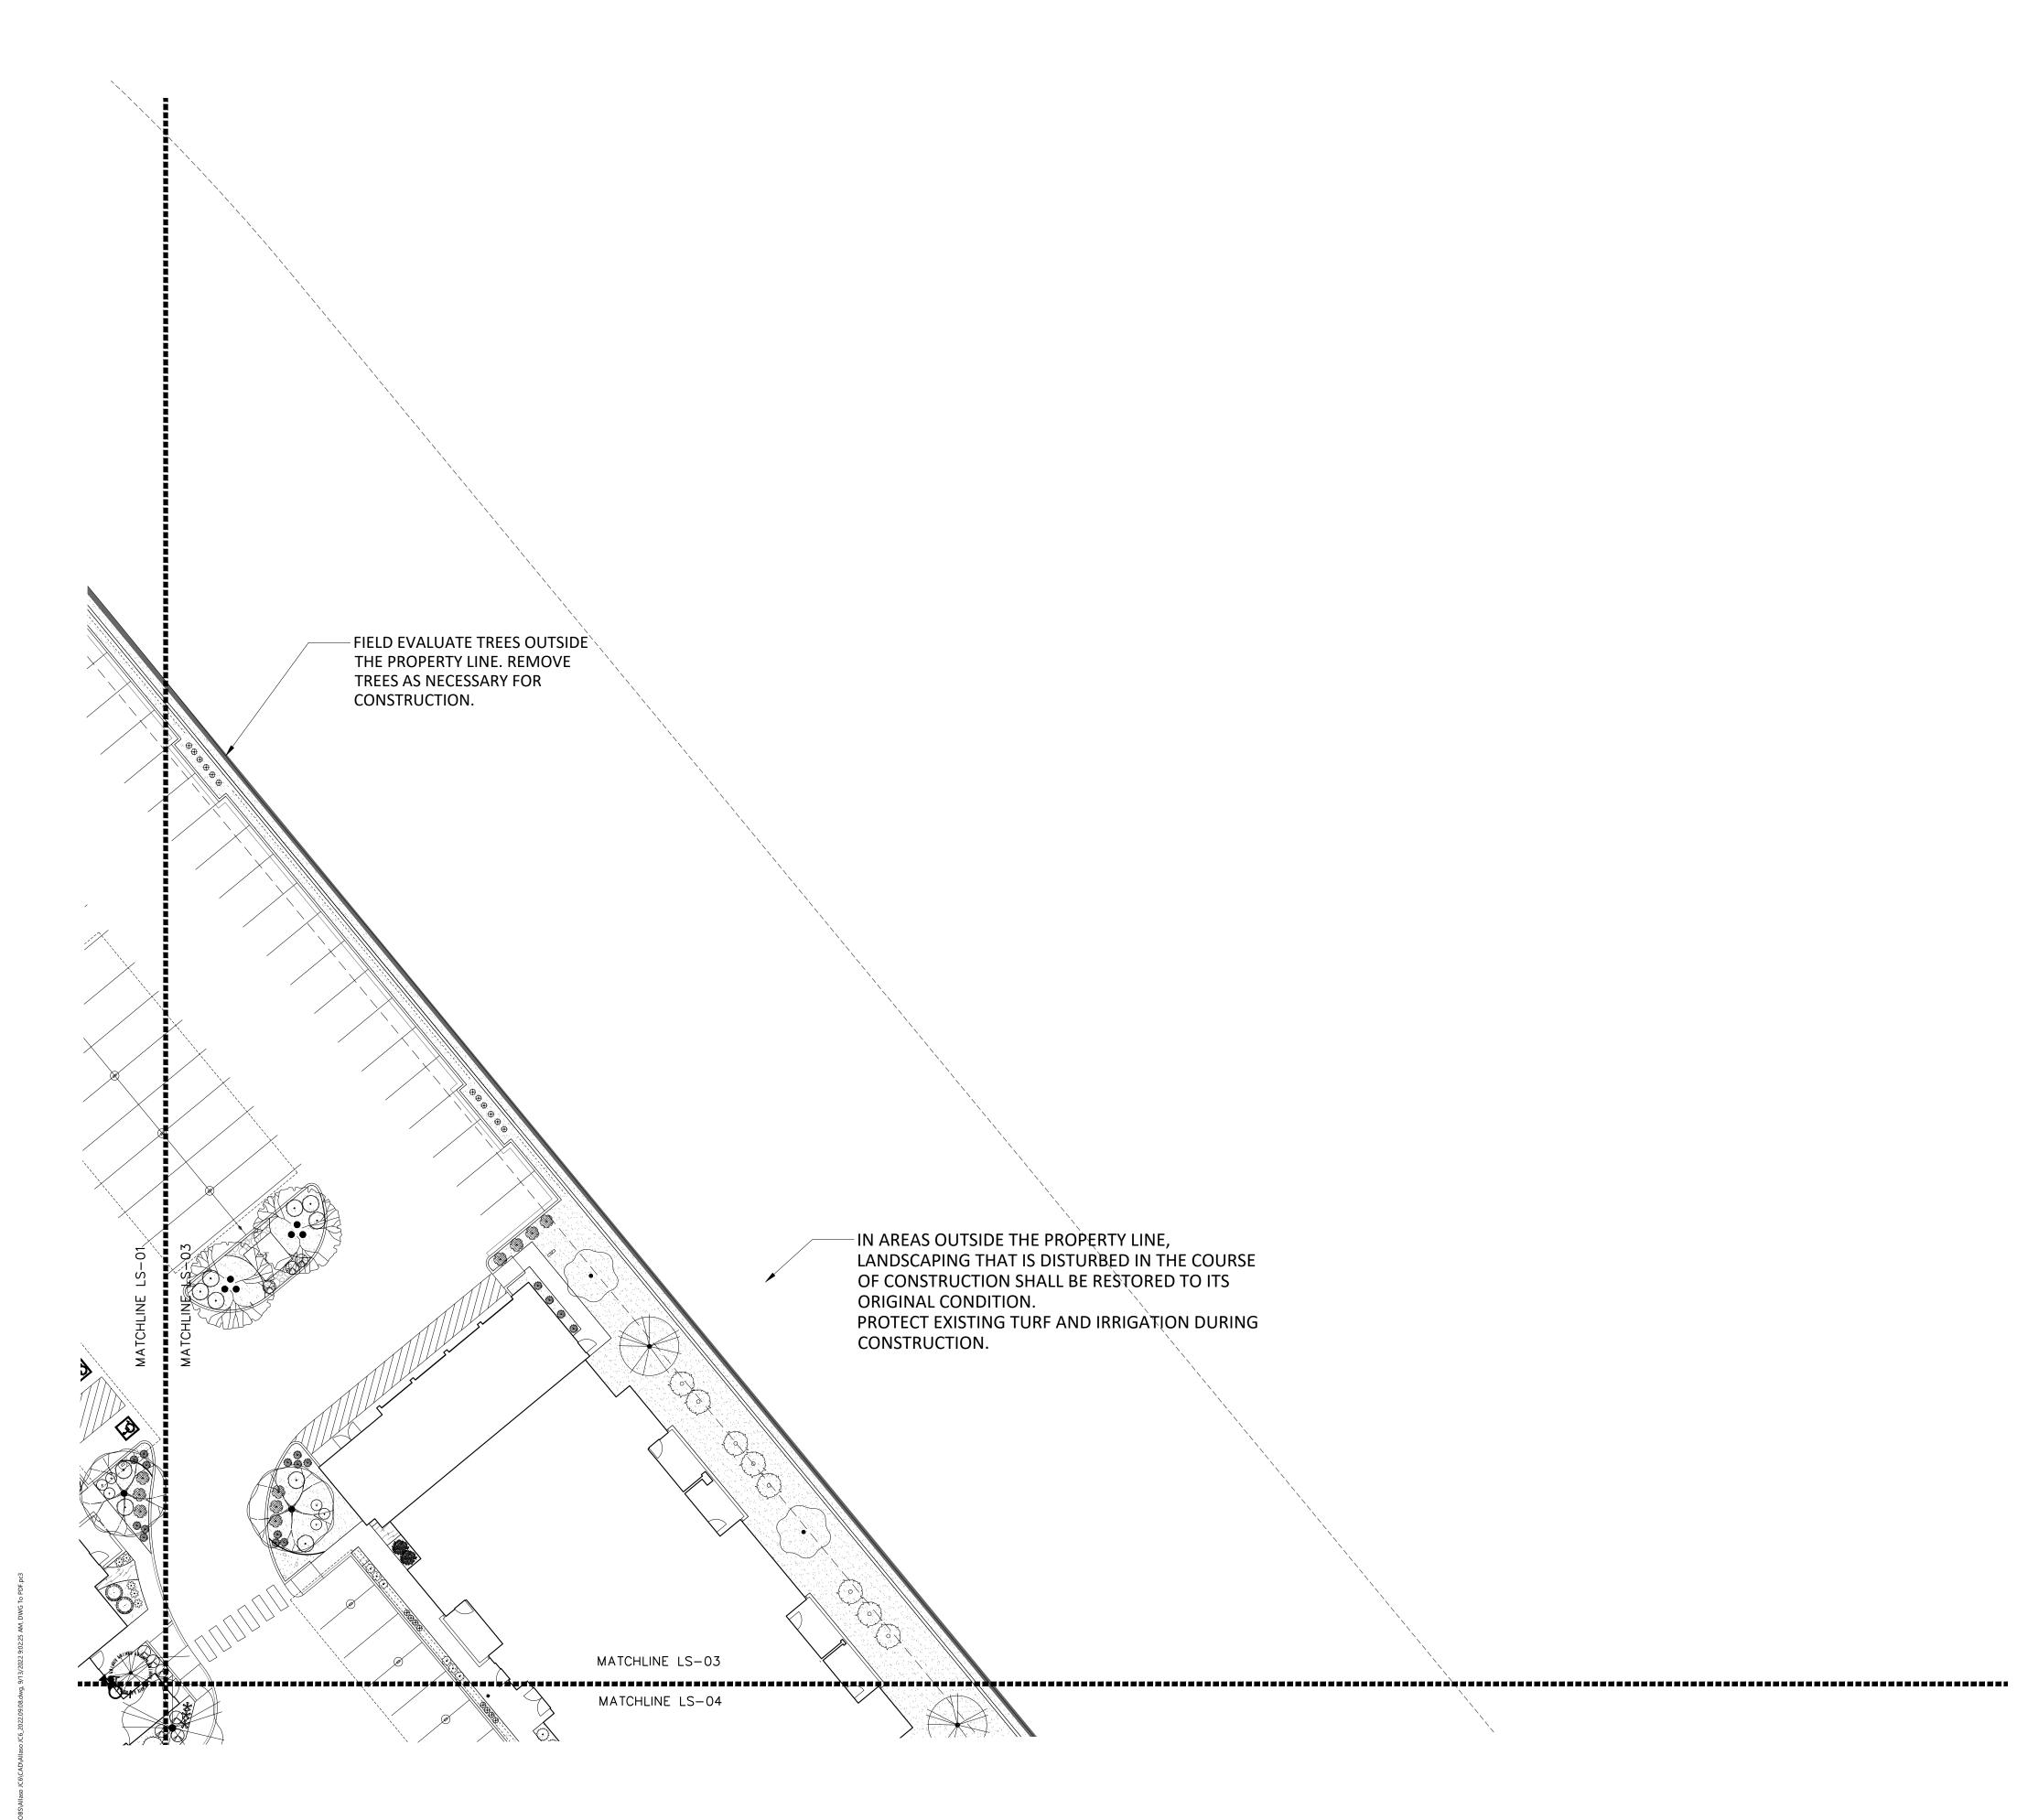

#### PLANT SCHEDULE - ONSITE

PLANT SCH	EDUI	LE - ONSITE			
DECIDUOUS TREES	QTY	BOTANICAL / COMMON NAME	SIZE	<u>H X W</u>	COVERAGE
	7	CHILOPSIS LINEARIS 'BUBBA' / BUBBA DESERT WILLOW	2" B&B	20' X 25'	491X7=3,437 SF
	17	CRATAEGUS CRUS-GALLI 'INERMIS' / THORNLESS HAWTHORN	2" B&B	50' X 45'	1590X17=27,030 SF
•	11	FORESTIERA NEOMEXICANA / NEW MEXICAN PRIVET	24"BOX	15' X 15'	177X11=1,947 SF
	14	FRAXINUS OXYCARPA 'RAYWOOD' TM / RAYWOOD ASH	2" B&B	35' X 25'	2826X14=39,564 SF
	11	LAGERSTROEMIA INDICA / CRAPE MYRTLE	24"BOX	15' X 15'	177X11=1,947 SF
	8	PISTACIA CHINENSIS / CHINESE PISTACHE	2" B&B	40' X 30'	2826X8=22,608 SF
	18	QUERCUS MUEHLENBERGII / CHINKAPIN OAK	2" B&B	40' × 40'	491X18=8,838 SF
	6	ulmus parvifolia 'allee' / allee lacebark elm	2" B&B	40' × 40'	1256X6=7,536 SF
EVERGREEN TREES	QTY	BOTANICAL / COMMON NAME	SIZE	<u>H X W</u>	<u>COVERAGE</u>
	1	CEDRUS ATLANTICA / ATLAS CEDAR	6'-8' B&	c 75' Χ 50'	1963X1=1,963 SF
•	18	JUNIPERUS SCOPULORUM / ROCKY MOUNTAIN JUNIPER	15 GAL	40' X 20'	314X18=5652 SF
VIIIIIIIII	7	PINUS NIGRA / AUSTRIAN BLACK PINE	10' B&B	35' X 25'	79X7=553 SF
DESERT ACCENTS	QTY	BOTANICAL / COMMON NAME	<u>SIZE</u>	SUBTOTAL <u>HXW</u>	121,075 SF COVERAGE
	9	DASYLIRION TEXANUM / TEXAS SOTOL	5 GAL	5' X 5'	20X9=180 SF
(*)	17	HESPERALOE PARVIFLORA / RED YUCCA	5 GAL	3' X 4'	13X17=221 SF
e e e e e e e e e e e e e e e e e e e	11	NOLINA MICROCARPA / BEARGRASS	5 GAL	5' X 6'	28X11=308 SF
<u>GRASSES</u>	<u>QTY</u> 124	BOTANICAL / COMMON NAME  BOUTELOUA GRACILIS 'BLONDE AMBITION' / BLONDE AMBITION BLUE GRAMA	SIZE	<u>HXW</u>	<u>COVERAGE</u> 7X124=868 SF
- carr				30" X 2'	
	69	CALAMAGROSTIS X ACUTIFLORA 'KARL FOERSTER' / FEATHER REED GRASS			3X69=207 SF
PEGIDIANG GURURG	65	MUHLENBERGIA CAPILLARIS 'REGAL MIST' TM / MUHLY	1 GAL	3' X 3'	7X65=455 SF
DECIDUOUS SHRUBS	<u>QTY</u> 87	BOTANICAL / COMMON NAME  BERBERIS THUNBERGII 'CRIMSON PYGMY' / CRIMSON PYGMY BARBERRY	<u>SIZE</u> 5 GAL	HXW 2' X 3'	COVERAGE 13X87=1,131 SF
$\circ$	27	BUDDLEJA DAVIDII / BUTTERFLY BUSH	5 GAL	4' × 4'	13X21=351 SF
	18	CARYOPTERIS X CLANDONENSIS 'DARK KNIGHT' / BLUE MIST SPIREA	1 GAL	3' × 3'	7X18=126 SF
€;3	39	GAILLARDIA X GRANDIFLORA / BLANKETFLOWER	1 GAL	2' X 2'	3X39=117 SF
(*)	28	LAVANDULA ANGUSTIFOLIA / ENGLISH LAVENDER	1 GAL	3' × 3'	7X28=196 SF
$\circ$	21	LEUCOPHYLLUM FRUTESCENS / TEXAS SAGE	5 GAL	6' X 6'	28X21=588 SF
$\odot$	40	NEPETA X FAASSENII 'SELECT BLUE' / CATMINT	1 GAL	1' X 2'	3X40=120 SF
+	9	PENSTEMON PINIFOLIUS / THREADLEAF BEARDTONGUE	1 GAL	1" × 20"	3X9=27 SF
$\odot$	75	RHUS AROMATICA 'GRO-LOW' / GRO-LOW FRAGRANT SUMAC	5 GAL	4' X 2'	13X75=975 SF
	33	ROSA X 'KNOCKOUT' TM / ROSE	5 GAL	6' X 5'	20X33=660 SF
+	22	SALVIA GREGGII / AUTUMN SAGE CHERRY	1 GAL	2' X 3'	7X22=154 SF
EVERGREEN SHRUBS	QTY	BOTANICAL / COMMON NAME	<u>SIZE</u>	<u>HXW</u>	<u>COVERAGE</u>
0	48	CERCOCARPUS LEDIFOLIUS / CURL-LEAF MOUNTAIN MAHOGANY	5 GAL	15' X 15'	177X48=8,496 SF
0	4	COTONEASTER GLAUCOPHYLLUS / GREYLEAF COTONEASTER	5 GAL	2' X 9'	64X4=256 SF
0	67	ERICAMERIA LARICIFOLIA / TURPENTINE BUSH	5 GAL	3' × 4'	13X67=871 SF
$\bigcirc$	57	FALLUGIA PARADOXA / APACHE PLUME	5 GAL	6' X 7'	38X57=2,166 SF
$\odot$	44	JUNIPERUS HORIZONTALIS 'BLUE CHIP' / BLUE CHIP JUNIPER	5 GAL	1.5' X 3'	7X44=308 SF
0	59	PINUS MUGO MUGO / DWARF MUGO PINE	5 GAL	4' × 4'	13X59=767 SF
$\otimes$	61	RHAPHIOLEPIS INDICA / INDIAN HAWTHORN	5 GAL	3' × 4'	13X61=793 SF
$\bigoplus$	49	ROSMARINUS OFFICINALIS / ROSEMARY	5 GAL	6' X 6'	28X49=1,372 SF
GROUNDCOVERS	QTY	BOTANICAL / COMMON NAME	<u>SIZE</u>	<u>HXW</u>	<u>COVERAGE</u>
***	66	TEUCRIUM AROANIUM / CREEPING GERMANDER	1 GAL	1' X 2' SUBTOTAL TOTAL	3X66=198 SF 21,911 SF 139,549 SF

#### PLANT SCHEDULE OFFSITE

PLAINT SCHEL	JULE	OFFOILE		
DECIDUOUS TREES	QTY	BOTANICAL / COMMON NAME	<u>SIZE</u>	<u>H X W</u>
lacksquare	42	ULMUS X 'FRONTIER' / FRONTIER ELM	2" B&B	40' X 40'
<u>GRASSES</u>	QTY	BOTANICAL / COMMON NAME	SIZE	<u>HXW</u>
	37	BOUTELOUA GRACILIS 'BLONDE AMBITION' / BLONDE AMBITION BLUE GRAMA	1 GAL	3' X 3'
	30	MUHLENBERGIA CAPILLARIS 'REGAL MIST' TM / MUHLY	1 GAL	3' X 3'
DECIDUOUS SHRUBS	QTY	BOTANICAL / COMMON NAME	<u>SIZE</u>	<u>HXW</u>
$\odot$	2	NEPETA X FAASSENII 'SELECT BLUE' / CATMINT	1 GAL	1' X 2'
EVERGREEN SHRUBS	QTY	BOTANICAL / COMMON NAME	<u>SIZE</u>	<u>HXW</u>
$\odot$	7	JUNIPERUS HORIZONTALIS 'BLUE CHIP' / BLUE CHIP JUNIPER	5 GAL	1.5' X 3'

1" MOUNTAINAIR SUNRISE GOLD GRAVEL OVER FILTER

1" PUEBLO ROSE GRAVEL OVER FILTER FABRIC

2-4" BLUE SAIS COBBLE OVER FILTER FABRIC

SYNTHETIC TURF EXISTING TURF TO REMAIN


6-8" WALLIN COBBLESTONE

1" SANTA ANA TAN GRAVEL — OFFSITE

1" MOUNTAINAIR SUNRISE GOLD GRAVEL OVER FILTER FABRIC — OFFSITE

2-4" BLUE SAIS COBBLE OVER FILTER FABRIC - OFFSITE 1" PUEBLO ROSE GRAVEL OVER FILTER FABRIC - OFFSITE EXISTING TURF TO REMAIN - OFFSITE


www.yellowstonelandscape.com PO Box 10597 Albuquerque, NM 87184 505.898.9615 design@yellowstonelandscape.com

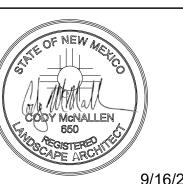


Date: <u>9/29/2021</u>

Revisions: 4/21/2022 DRB 9/16/2022 DRB

Drawn by: PL Reviewed by: CM

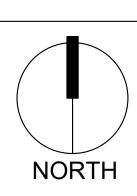


Scale: 1" = 20'

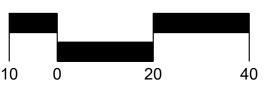

Sheet Title:

Landscape Plan

Sheet Number:

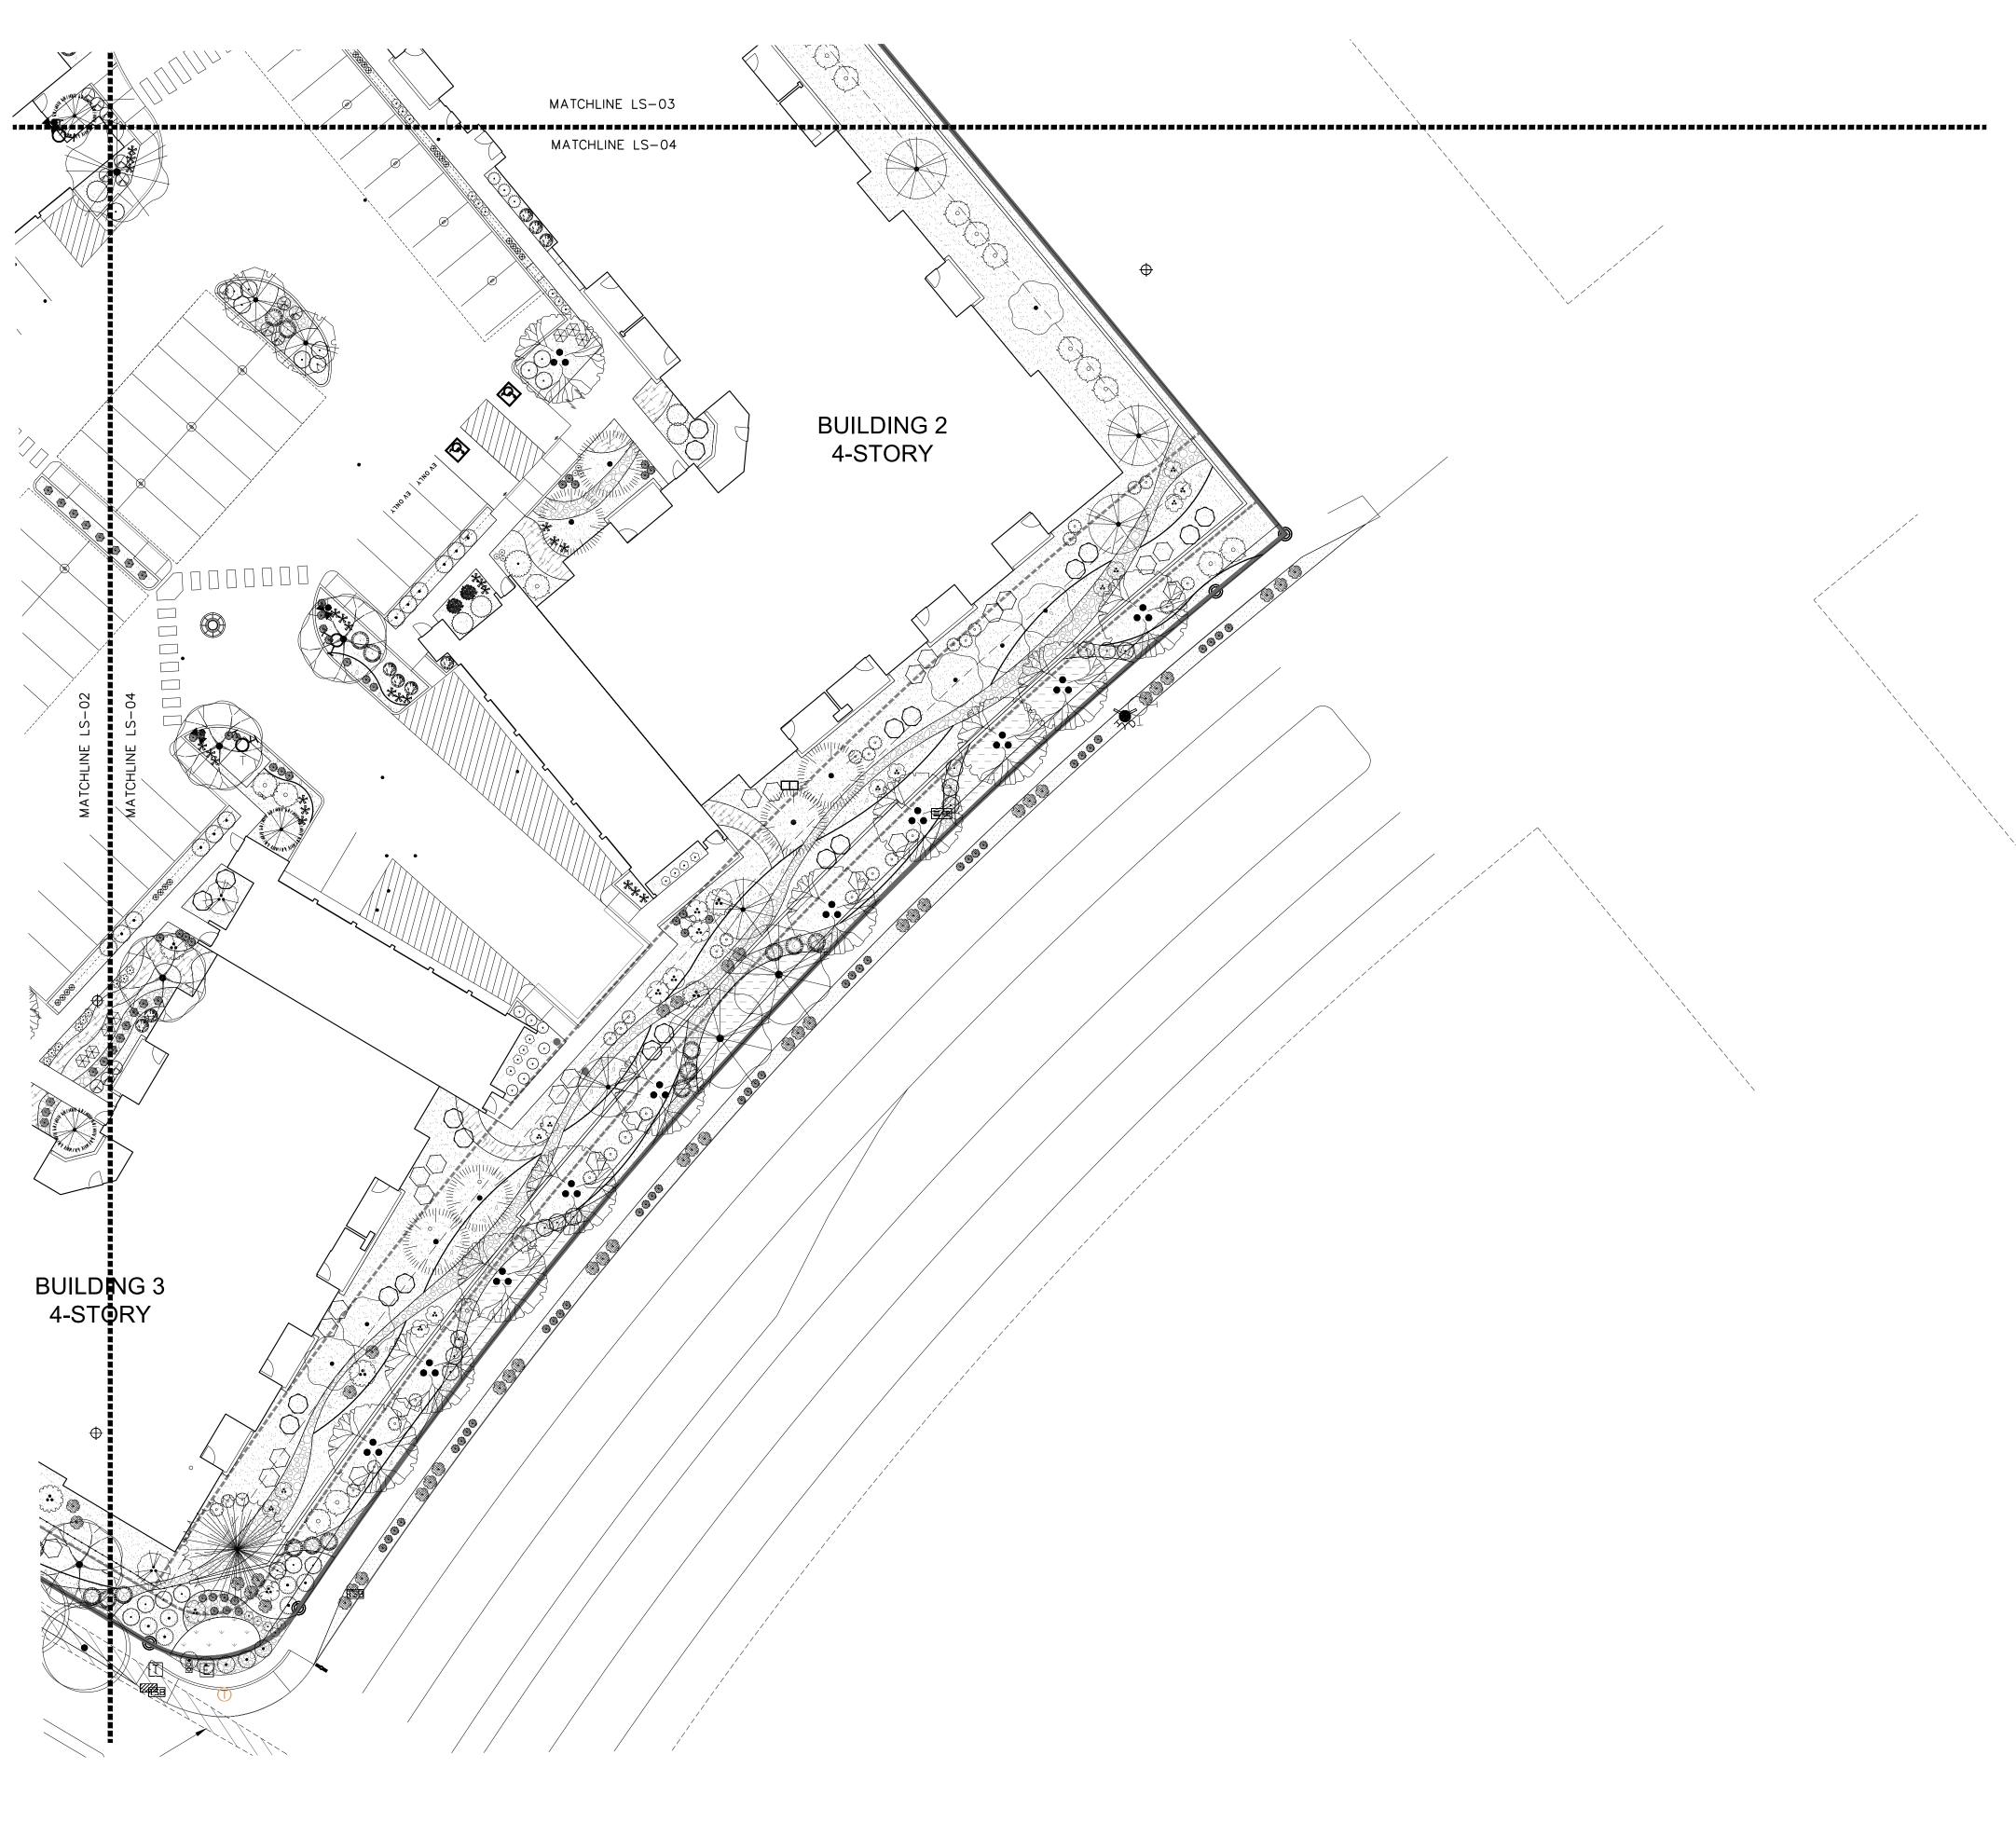

PLANT SCHEDULE - ONSITE

	PLANT SCHE	EDUI	LE - ONSITE			
	DECIDUOUS TREES	QTY	BOTANICAL / COMMON NAME	<u>SIZE</u>	<u>H X W</u>	COVERAGE
		7	CHILOPSIS LINEARIS 'BUBBA' / BUBBA DESERT WILLOW	2" B&B	20' X 25'	491X7=3,437 SF
		17	CRATAEGUS CRUS-GALLI 'INERMIS' / THORNLESS HAWTHORN	2" B&B	50' X 45'	1590X17=27,030
	•	11	FORESTIERA NEOMEXICANA / NEW MEXICAN PRIVET	24"BOX	15' X 15'	177X11=1,947 SF
1		14	FRAXINUS OXYCARPA 'RAYWOOD' TM / RAYWOOD ASH	2" B&B	35' X 25'	2826X14=39,564
		11	LAGERSTROEMIA INDICA / CRAPE MYRTLE	24"BOX	15' X 15'	177X11=1,947 SF
		8	PISTACIA CHINENSIS / CHINESE PISTACHE	2" B&B	40' X 30'	2826X8=22,608 S
		18	QUERCUS MUEHLENBERGII / CHINKAPIN OAK	2" B&B	40' X 40'	491X18=8,838 SF
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	EVERGREEN TREES	QTY	BOTANICAL / COMMON NAME	<u>SIZE</u>	<u>H X W</u>	COVERAGE
		1	CEDRUS ATLANTICA / ATLAS CEDAR	6'-8' B&	α 75' Χ 50'	1963X1=1,963 SF
	The state of the s	18	JUNIPERUS SCOPULORUM / ROCKY MOUNTAIN JUNIPER	15 GAL	40' X 20'	314X18=5652 SF
	Marian I. Company	7	PINUS NIGRA / AUSTRIAN BLACK PINE	10' B&B	35' X 25'	79X7=553 SF
	DESERT ACCENTS	QTY	BOTANICAL / COMMON NAME	<u>SIZE</u>	SUBTOTAL <u>HXW</u>	121,075 SF COVERAGE
		9	DASYLIRION TEXANUM / TEXAS SOTOL	5 GAL	5' X 5'	20X9=180 SF
		17	HESPERALOE PARVIFLORA / RED YUCCA	5 GAL	3' × 4'	13X17=221 SF
	•	11	NOLINA MICROCARPA / BEARGRASS	5 GAL	5' X 6'	28X11=308 SF
	<u>GRASSES</u>	QTY	BOTANICAL / COMMON NAME	<u>SIZE</u>	HXW	COVERAGE
	<b>*</b>	124	BOUTELOUA GRACILIS 'BLONDE AMBITION' / BLONDE AMBITION BLUE GRAMA			7X124=868 SF
		69	CALAMAGROSTIS X ACUTIFLORA 'KARL FOERSTER' / FEATHER REED GRASS			3X69=207 SF
		65	MUHLENBERGIA CAPILLARIS 'REGAL MIST' TM / MUHLY	1 GAL	3' X 3'	7X65=455 SF
	DECIDUOUS SHRUBS	<u>QTY</u> 87	BOTANICAL / COMMON NAME  BERBERIS THUNBERGII 'CRIMSON PYGMY' / CRIMSON PYGMY BARBERRY	<u>SIZE</u> 5 GAL	HXW 2' X 3'	COVERAGE 13X87=1,131 SF
	$\bigcirc$	27	BUDDLEJA DAVIDII / BUTTERFLY BUSH	5 GAL	4' × 4'	13X21=351 SF
		18	CARYOPTERIS X CLANDONENSIS 'DARK KNIGHT' / BLUE MIST SPIREA	1 GAL	3' X 3'	7X18=126 SF
		39	GAILLARDIA X GRANDIFLORA / BLANKETFLOWER	1 GAL	2' X 2'	3X39=117 SF
	$\circ$	28	LAVANDULA ANGUSTIFOLIA / ENGLISH LAVENDER	1 GAL	3' × 3'	7X28=196 SF
	0	21	LEUCOPHYLLUM FRUTESCENS / TEXAS SAGE	5 GAL	6' × 6'	28X21=588 SF
	$\odot$	40	NEPETA X FAASSENII 'SELECT BLUE' / CATMINT	1 GAL	1' X 2'	3X40=120 SF
	(+)	9	PENSTEMON PINIFOLIUS / THREADLEAF BEARDTONGUE		1" X 20"	3X9=27 SF
<b>\</b>	$\odot$	75	RHUS AROMATICA 'GRO-LOW' / GRO-LOW FRAGRANT SUMAC	5 GAL		13X75=975 SF
		33	ROSA X 'KNOCKOUT' TM / ROSE	5 GAL		20X33=660 SF
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	EVERGREEN SHRUBS	QTY	BOTANICAL / COMMON NAME	SIZE	HXW	COVERAGE
	$\odot$	48	CERCOCARPUS LEDIFOLIUS / CURL-LEAF MOUNTAIN MAHOGANY		15' X 15'	177X48=8,496 SF
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	$\odot$	44	JUNIPERUS HORIZONTALIS 'BLUE CHIP' / BLUE CHIP JUNIPER	5 GAL	1.5' X 3'	7X44=308 SF
	0	59	PINUS MUGO MUGO / DWARF MUGO PINE	5 GAL	4' X 4'	13X59=767 SF
	$\otimes$	61	RHAPHIOLEPIS INDICA / INDIAN HAWTHORN	5 GAL	3' X 4'	13X61=793 SF
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	GROUNDCOVERS	<u>QTY</u> 66	BOTANICAL / COMMON NAME TEUCRIUM AROANIUM / CREEPING GERMANDER	<u>SIZE</u> 1 GAL	HXW 1' X 2'	COVERAGE  3X66=198 SF
					SUBTOTAL	∠ı,∀ll 5F

#### PLANT SCHEDULE OFFSITE

DECIDUOUS TREES	QTY	BOTANICAL / COMMON NAME	SIZE	H X W
	42	ULMUS X 'FRONTIER' / FRONTIER ELM	2" B&B	40' X 40'
<u>GRASSES</u>	QTY	BOTANICAL / COMMON NAME	SIZE	<u>HXW</u>
	37	BOUTELOUA GRACILIS 'BLONDE AMBITION' / BLONDE AMBITION BLUE GRAMA	1 GAL	3' X 3'
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DECIDUOUS SHRUBS	QTY	BOTANICAL / COMMON NAME	SIZE	<u>HXW</u>
$\odot$	2	NEPETA X FAASSENII 'SELECT BLUE' / CATMINT	1 GAL	1' X 2'
EVERGREEN SHRUBS	QTY	BOTANICAL / COMMON NAME	<u>SIZE</u>	<u>HXW</u>
$\odot$	7	JUNIPERUS HORIZONTALIS 'BLUE CHIP' / BLUE CHIP JUNIPER	5 GAL	1.5' X 3'
	GRASSES  DECIDUOUS SHRUBS  EVERGREEN SHRUBS	GRASSES QTY  37 30  DECIDUOUS SHRUBS QTY  2  EVERGREEN SHRUBS QTY	GRASSES QTY BOTANICAL / COMMON NAME   37 BOUTELOUA GRACILIS 'BLONDE AMBITION' / BLONDE AMBITION BLUE GRAMA   DECIDUOUS SHRUBS QTY BOTANICAL / COMMON NAME   ○ 2 NEPETA X FAASSENII 'SELECT BLUE' / CATMINT   EVERGREEN SHRUBS QTY BOTANICAL / COMMON NAME   EVERGREEN SHRUBS QTY BOTANICAL / COMMON NAME	GRASSES QTY BOTANICAL / COMMON NAME SIZE   ★ 37 BOUTELOUA GRACILIS 'BLONDE AMBITION' / BLONDE AMBITION BLUE GRAMA 1 GAL   DECIDUOUS SHRUBS QTY BOTANICAL / COMMON NAME SIZE   ↓ 2 NEPETA X FAASSENII 'SELECT BLUE' / CATMINT 1 GAL   EVERGREEN SHRUBS QTY BOTANICAL / COMMON NAME SIZE   EVERGREEN SHRUBS QTY BOTANICAL / COMMON NAME SIZE

#### REFERENCE NOTES SCHEDULE ONSITE

1" MOUNTAINAIR SUNRISE GOLD GRAVEL OVER FILTER FABRIC 1" PUEBLO ROSE GRAVEL OVER FILTER FABRIC 2-4" BLUE SAIS COBBLE OVER FILTER FABRIC SYNTHETIC TURF

EXISTING TURF TO REMAIN

6-8" WALLIN COBBLESTONE

# REFERENCE NOTES SCHEDULE OFFSITE

1" SANTA ANA TAN GRAVEL - OFFSITE 1" MOUNTAINAIR SUNRISE GOLD GRAVEL OVER FILTER FABRIC — OFFSITE

2-4" BLUE SAIS COBBLE OVER FILTER FABRIC - OFFSITE

1" PUEBLO ROSE GRAVEL OVER FILTER FABRIC - OFFSITE


SUBTOTAL 21,911 SF TOTAL 139,549 SF

Sheet Number: EXISTING TURF TO REMAIN - OFFSITE

www.yellowstonelandscape.com

PO Box 10597 Albuquerque, NM 87184


505.898.9615

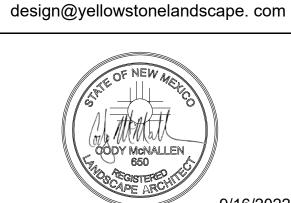

Date: <u>9/29/2021</u> Revisions:

4/21/2022 DRB 9/16/2022 DRB

Drawn by: PL Reviewed by: <u>CM</u>

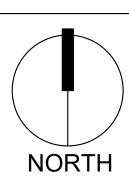


Scale: 1" = 20'



Sheet Title:

Landscape Plan



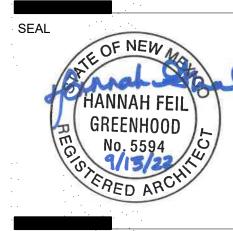

PROJECT

7501 JEFFERSON ST NE ALBUQUERQUE, NM, 87109

REVISIONS

△
△
△
△
△
DRAWN BY

DRAWN BY
D/P/S
REVIEWED BY
HFG
DATE
09/13/2022
PROJECT NO: 20-0029

DRAWING NAME

BUILDING 3 EXTERIOR ELEVATIONS

SHEET NO


SDP 5.1

#### **GENERAL SHEET NOTES**


- A. ALL ROOF MOUNTED MECHANICAL EQUIPMENT SHALL BE SCREENED BY PARAPET WALL AND NOT BE VISIBLE WHEN VIEWED FROM 5' ABOVE GRADE AT ANY PROPERTY LINE.
- B. ALL DIMENSIONS SHOWN ARE FROM FACE OF STUD, UNLESS NOTED OTHERWISE.
- C. BUILDING IDENTIFICATION SIGNAGE TO BE A MINIMUM OF 18" HIGH CHARACTERS WITH A MINIMUM OF 3" BRUSH STROKE WITH CONTRASTING ALUMINUM COLORS LIT FROM DUSK UNTIL DAWN AS WELL AS DAYLIGHT HOURS, PER 2009 IFC. MOUNT AT 15'-20' ABOVE FINISH FLOOR.
- D. ALL IDO REQUIREMENTS WILL BE MET PER SECTION 5-11(E)(2); REF: BUILDING FLOOR PLAN SHEETS FOR ADDITIONAL INFORMATION.
- E. PER IDO 5-11(E)(2); STREET FACING FACADES WILL INCORPORATE REQUIRED FEATURES; REF: SHEET KEYNOTES.

- SHEET KEYNOTES (X)
- EXTERIOR WALL: STUCCO FINISH\_COLOR 1
- 2. EXTERIOR WALL: STUCCO FINISH COLOR 2 3. EXTERIOR WALL: VERTICAL SEAM FIBER CEMENT BOARD
- 4. JULIETTE BALCONY
- 5. EXTERIOR WALL: FIBER CEMENT PANELS (~32"X64")
- 6. PREFINISHED METAL COPING COLOR TO MATCH ADJACENT MATERIAL OR STANDARD
- NEUTRAL COLOR 7. BALCONY CABLE RAILING - METAL CUSTOM FABRICATED, PRIMED AND PAINTED
- 8. BUILDING IDENTIFICATION SIGNAGE FOR WAYFINDING 9. RESIDENTIAL WINDOWS (OPERABLE, LOW-E GLASS) - FRAME COLOR: WHITE
- 10. DOWNSPOUT
- 11. UNIT PATIO/BALCONY DOOR, FULL LITE 12. HOLLOW METAL DOOR, PRIMED AND PAINTED
- 13. ALUMINUM STOREFRONT (CLEAR ANODIZED)
- 14. ALUMINUM STOREFRONT DOOR (CLEAR ANODIZED)
- 15. FRAMED EXTERIOR OPENING
- 16. 4'-0" PRIVACY WALL BOARD FORM CONCRETE

- 17. OVERHEAD GARAGE DOOR
- 18. COVERED ENTRY
- 19. TRELLIS SHADE STRUCTURE
- 20. METAL PATIO GATE, PRIMED AND PAINTED
- 21. 6'-0" WOOD SLAT PRIVACY FENCE 22. STEEL COLUMN COLOR TO MATCH GUARDRAILS
- 23. WALL PLAN PROJECTION OR RECESSES (IDO 5-11(E)(2)(a)) 24. CHANGE IN COLOR, TEXTURE OR MATERIAL. (IDO 5-11(E)(2)(b)) 25. ELECTRIC METERS
- 26. GAS METERS
- 27. EXTERIOR WALL: HORIZONTAL SEAM FIBER CEMENT BOARD
- 28. EXTERIOR WALL: STUCCO FINISH COLOR 3 29. EXTERIOR WALL:CMU WITH BREEZE BLOCK
- 30. EXTERIOR WALL: STUCCO FINISH COLOR 4
- 31. EXTERIOR WALL: STUCCO FINISH COLOR 5

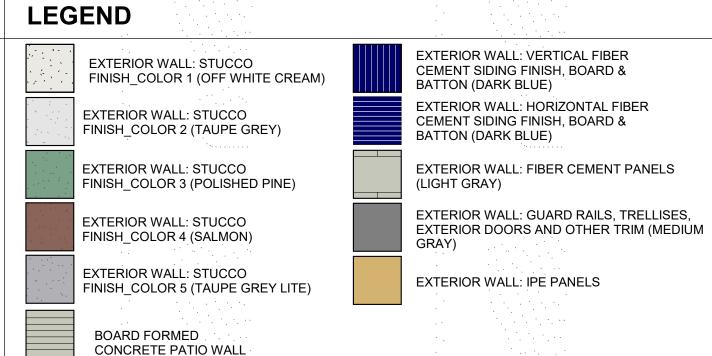

DEKKER PERICH SABATINI

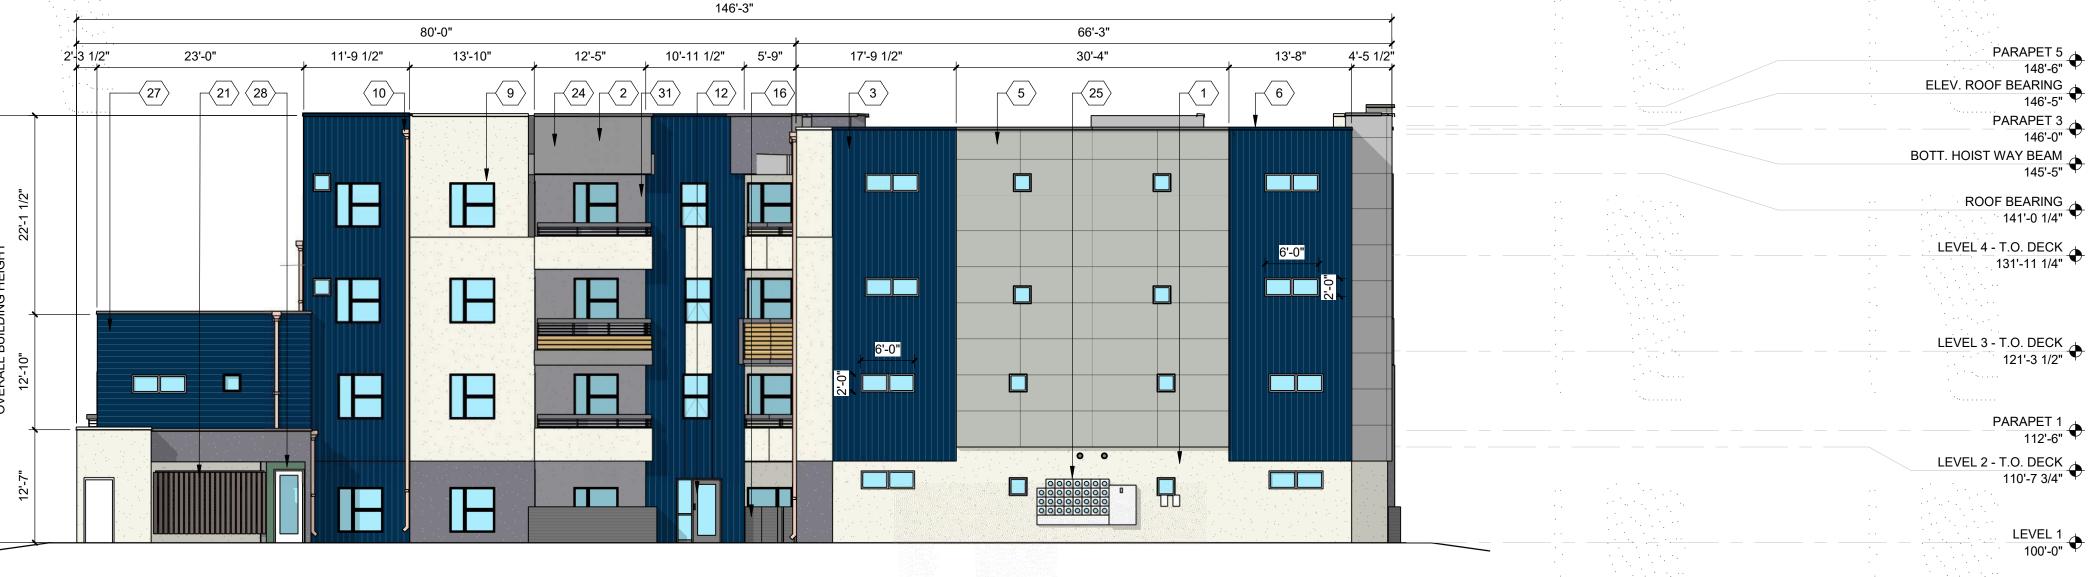









PROJECT

100'-0"

7501 JEFFERSON ALBUQUERQUE, N

REVISIONS DRAWN BY REVIEWED BY DATE 09/13/2022

DRAWING NAME

PROJECT NO:


BUILDING 2 AND 3 EXTERIOR ELEVATIONS

D/P/S

20-0029

SHEET NO SDP 5.2



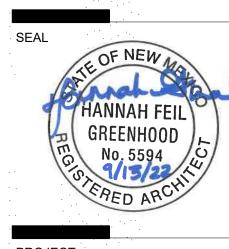

7501 JEFFERSON ALBUQUERQUE, N

D/P/S

09/13/2022

20-0029

BUILDING 2 EXTERIOR

SDP 5.3

#### **GENERAL SHEET NOTES**

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- E. PER IDO 5-11(E)(2); STREET FACING FACADES WILL INCORPORATE REQUIRED FEATURES; REF: SHEET KEYNOTES.
- SHEET KEYNOTES 🗴
  - EXTERIOR WALL: STUCCO FINISH\_COLOR 1
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  - 3. EXTERIOR WALL: VERTICAL SEAM FIBER CEMENT BOARD
  - 4. JULIETTE BALCONY
  - 5. EXTERIOR WALL: FIBER CEMENT PANELS (~32"X64")
  - 6. PREFINISHED METAL COPING COLOR TO MATCH ADJACENT MATERIAL OR STANDARD NEUTRAL COLOR
  - 7. BALCONY CABLE RAILING METAL CUSTOM FABRICATED, PRIMED AND PAINTED
  - 8. BUILDING IDENTIFICATION SIGNAGE FOR WAYFINDING 9. RESIDENTIAL WINDOWS (OPERABLE, LOW-E GLASS) - FRAME COLOR: WHITE
  - 11. UNIT PATIO/BALCONY DOOR, FULL LITE
  - 12. HOLLOW METAL DOOR, PRIMED AND PAINTED
  - 13. ALUMINUM STOREFRONT (CLEAR ANODIZED)
  - 14. ALUMINUM STOREFRONT DOOR (CLEAR ANODIZED)
  - 15. FRAMED EXTERIOR OPENING

10. DOWNSPOUT


16. 4'-0" PRIVACY WALL - BOARD FORM CONCRETE

- 17. OVERHEAD GARAGE DOOR
- 18. COVERED ENTRY
- 19. TRELLIS SHADE STRUCTURE
- 20. METAL PATIO GATE, PRIMED AND PAINTED 21. 6'-0" WOOD SLAT PRIVACY FENCE
- 22. STEEL COLUMN COLOR TO MATCH GUARDRAILS
- 23. WALL PLAN PROJECTION OR RECESSES (IDO 5-11(E)(2)(a)) 24. CHANGE IN COLOR, TEXTURE OR MATERIAL. (IDO 5-11(E)(2)(b)) 25. ELECTRIC METERS
- 26. GAS METERS
- 27. EXTERIOR WALL: HORIZONTAL SEAM FIBER CEMENT BOARD
- 28. EXTERIOR WALL: STUCCO FINISH COLOR 3 29. EXTERIOR WALL:CMU WITH BREEZE BLOCK
- 30. EXTERIOR WALL: STUCCO FINISH COLOR 4 31. EXTERIOR WALL: STUCCO FINISH COLOR 5

**EXTERIOR WALL: VERTICAL FIBER** EXTERIOR WALL: STUCCO CEMENT SIDING FINISH, BOARD & FINISH COLOR 1 (OFF WHITE CREAM) BATTON (DARK BLUE) EXTERIOR WALL: HORIZONTAL FIBER EXTERIOR WALL: STUCCO CEMENT SIDING FINISH, BOARD & FINISH\_COLOR 2 (TAUPE GREY) BATTON (DARK BLUE) **EXTERIOR WALL: FIBER CEMENT PANELS** EXTERIOR WALL: STUCCO FINISH\_COLOR 3 (POLISHED PINE) (LIGHT GRAY) EXTERIOR WALL: GUARD RAILS, TRELLISES, EXTERIOR WALL: STUCCO EXTERIOR DOORS AND OTHER TRIM (MEDIUM FINISH\_COLOR 4 (SALMON) EXTERIOR WALL: STUCCO **EXTERIOR WALL: IPE PANELS** FINISH\_COLOR 5 (TAUPE GREY LITE) BOARD FORMED CONCRETE PATIO WALL

**LEGEND** 

DEKKER PERICH SABATINI

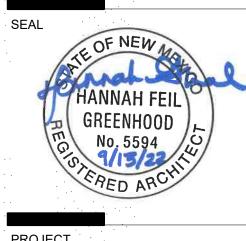

PROJECT

7501 JEFFERSON ALBUQUERQUE, N

**REVISIONS** DRAWN BY **REVIEWED BY** DATE 09/13/2022

D/P/S


20-0029

DRAWING NAME

PROJECT NO:

BUILDING 1 EXTERIOR ELEVATIONS

SHEET NO SDP 5.4

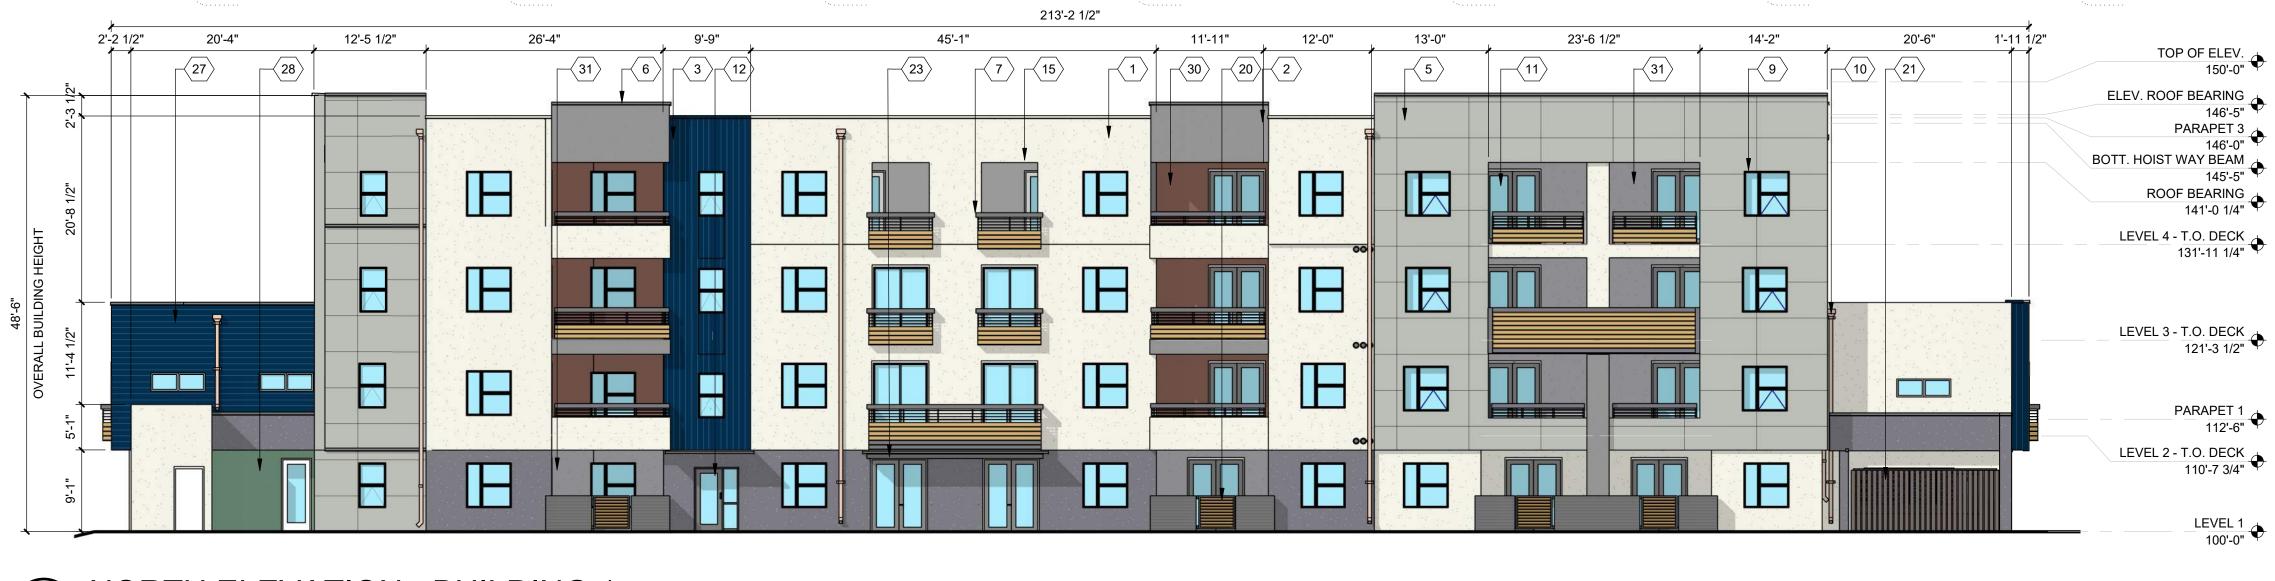








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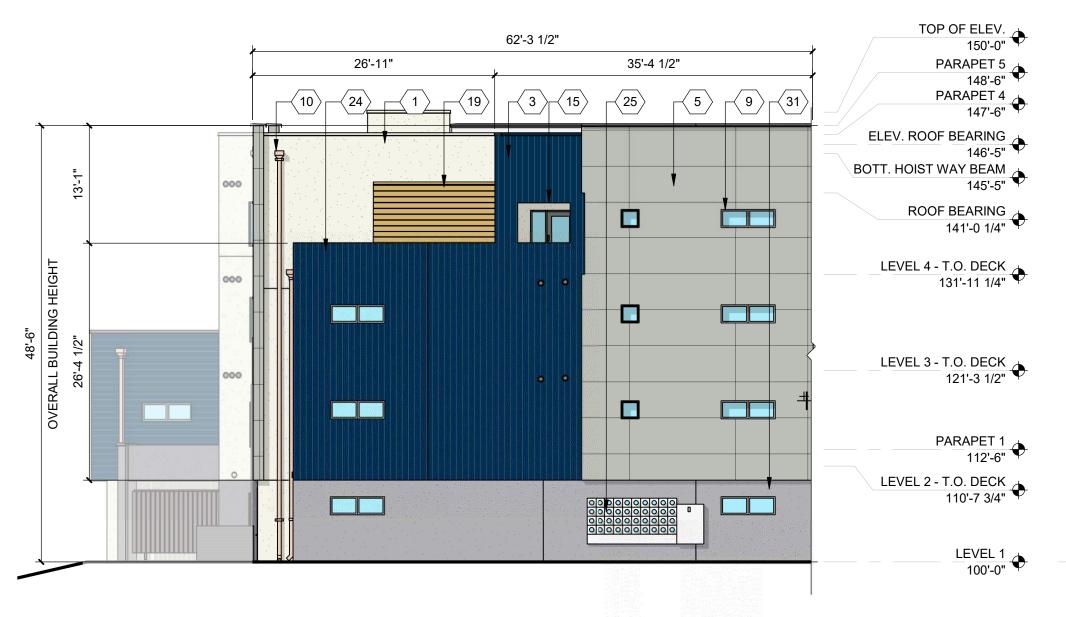
# SHEET KEYNOTES (X)

- 1. EXTERIOR WALL: STUCCO FINISH\_COLOR
- 2. EXTERIOR WALL: STUCCO FINISH COLOR 2
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DEKKER PERICH SABATINI





SOUTH ELEVATION - BUILDING 1

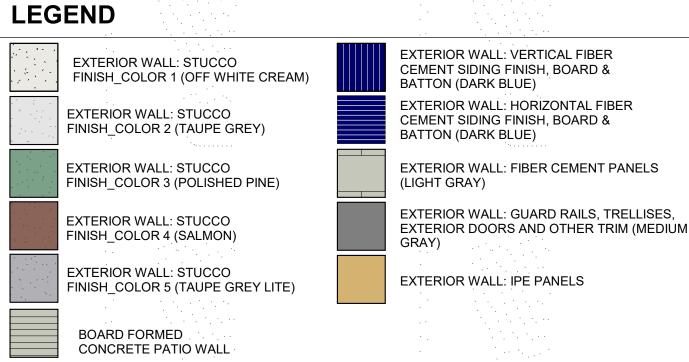





WEST ELEVATION - BUILDING 1 INTERIOR OF COURTYARD

A1 DRB 3/32" = 1'-0"

NORTH ELEVATION - BUILDING 1 INTERIOR OF COURTYARD

DRB
3/32" = 1'-0"

HANNAH FEIL **GREENHOOD** PROJECT

7501 JEFFERSON ALBUQUERQUE, N

REVISIONS

DRAWN BY REVIEWED BY DATE 09/13/2022 PROJECT NO: 20-0029

DRAWING NAME **BUILDING 1** EXTERIOR

ELEVATIONS

SHEET NO SDP 5.5



Maggie Gould Planning Manager City of Albuquerque mgould@cabq.gov

Dear Mrs. Gould,

The site located at 7501 Jefferson St. NE is planned to be developed for multifamily residential. The development will include the addition of three 4-story market rate apartment buildings. This letter is to serve as the analysis required by IDO section 14-16-5-2.

The site does not have most of the sensitive lands listed in the IDO section 5-2(C)(2), other than some existing mature trees. Please see below and attachments for the analysis of each type of sensitive land listed in the IDO.

- a. Arroyos: There are no natural arroyos on site. The site is adjacent to an existing AMAFCA drainage channel but does not affect the channel.
- b. Floodplains and Special Flood Hazard Areas: According to the FEMA flood map 35001C0137H, the site is located in Zone X area of minimal flood hazard. See attached FEMA Map.
- c. Irrigation Facilities (Acequias): There are no irrigation facilities or acequias on site.
- d. Large Stands of Mature Trees: There are mature trees on site. Some of the trees will be impacted to accommodate development. We will attempt to protect and preserve as many mature trees as possible during construction. If a tree is removed new landscaping and trees will be provided to meet city code. See attached photos with notes regarding existing trees.
- e. Rock Outcroppings: There are no rock outcroppings on site.
- f. Significant Archeological Sites: No significant sites were found in the area. See attached archeological certificate.
- g. Steep Slopes and Escarpments: There are no steep slopes or escarpments on site.
- h. Wetlands: There are no wetlands on site.

As explained above we have analyzed for sensitive lands per the IDO requirement. Please feel free to call me if you have any questions.

Very truly yours,

Dekker/Perich/Sabatini Ltd.

#### **NOTES TO USERS**

This map is for use in administering the National Flood Insurance Program. does not necessarily identify all areas subject to flooding, particularly from local drainage sources of small size. The community map repository should be consulted for possible updated or additional flood hazard information.

To obtain more detailed information in areas where Base Flood Elevations (BFEs) and/or floodways have been determined, users are encouraged to consult the Flood Profiles and Floodway Data and/or Summary of Stillwater Elevations tables contained within the Flood Insurance Study (FIS) report that accompanies this FIRM. Users should be aware that BFEs shown on the FIRM represent rounded whole-foot elevations. These BFEs are intended for flood insurance rating purposes only and should not be used as the sole source of flood elevation information. Accordingly, flood elevation data presented in the FIS report should be utilized in conjunction with the FIRM for purposes of construction and/or floodplain management.

Coastal Base Flood Elevations shown on this map apply only landward of 0.0' North American Vertical Datum of 1988 (NAVD 88). Users of this FIRM should be aware that coastal flood elevations are also provided in the Summary of Stillwater Elevations table in the Flood Insurance Study Report for this jurisdiction. Elevations shown in the Summary of Stillwater Elevations table should be used for construction, and/or floodplain management purposes when they are higher than the elevations shown on this FIRM.

Boundaries of the **floodways** were computed at cross sections and interpolated between cross sections. The floodways were based on hydraulic considerations with regard to requirements of the National Flood Insurance Program. Floodway widths and other pertinent floodway data are provided in the Flood Insurance Study report for this jurisdiction.

Certain areas not in Special Flood Hazard Areas may be protected by flood control structures. Refer to Section 2.4 "Flood Protection Measures" of the Flood Insurance Study report for information on flood control structures in this

The **projection** used in the preparation of this map was New Mexico State Plane, Central Zone (FIPS 3002). The horizontal datum was NAD83, GRS80 spheroid. Differences in datum, spheroid, projection or State Plane zones used in the production of FIRMs for adjacent jurisdictions may result in slight positional differences in map features across jurisdiction boundaries. These differences do not affect the accuracy of this FIRM.

Flood elevations on this map are referenced to the North American Vertical Datum of 1988. These flood elevations must be compared to structure and ground elevations referenced to the same vertical datum. For information regarding conversion between the National Geodetic Vertical Datum of 1929 and the North American Vertical Datum of 1988, visit the National Geodetic Survey website at http://www.ngs.noaa.gov or contact the National Geodetic Survey at the following address:

NGS Information Services NOAA, N/NGS12 National Geodetic Survey, SSMC-3, #9202 1315 East-West Highway Silver Spring, Maryland 20910-3282 (301) 713-3242

To obtain current elevation, description, and/or location information for bench marks shown on this map, please contact the Information Services Branch of the National Geodetic Survey at (301) 713-3242, or visit their website at http://www.ngs.noaa.gov/.

Base map information shown on this FIRM was provided in digital format by City of Albuquerque, 2010, Bernalillo County, 2004, and 2010, Bureau of Land Management, 2003, National Geodetic Survey, 2003, and United States Geological Survey (USGS), 1999. Additional Information was photogrammetrically compiled at a scale of 1:12,000 from U.S. Department of Agriculture aerial photography dated 2009.


This map reflects more detailed and up-to-date stream channel configurations than those shown on the previous FIRM for this jurisdiction. The floodplains and floodways that were transferred from the previous FIRM may have been adjusted to conform to these new stream channel configurations. As a result, the Flood Profiles and Floodway Data tables in the Flood Insurance Study report (which contains authoritative hydraulic data) may reflect stream channel distances that differ from what is shown on this map.

Corporate limits shown on this map are based on the best data available at the time of publication. Because changes due to annexations or de-annexations may have occurred after this map was published, map users should contact appropriate community officials to verify current corporate limit locations.

Please refer to the separately printed Map Index for an overview map of the county showing the layout of map panels; community map repository addresses; and a Listing of Communities table containing National Flood Insurance Program dates for each community as well as a listing of the panels on which each community is located.

For information on available products associated with this FIRM visit the Map Service Center (MSC) website at http://msc.fema.gov. Available products may include previously issued Letters of Map Change, a Flood Insurance Study Report, and/or digital versions of this map. Many of these products can be ordered or obtained directly from the MSC website.

If you have questions about this map, how to order products or the National Flood Insurance Program in general, please call the FEMA Map Information eXchange (FMIX) at 1-877-FEMA-MAP (1-877-336-2627) or visit the FEMA website at http://www.fema.gov/business/nfip.

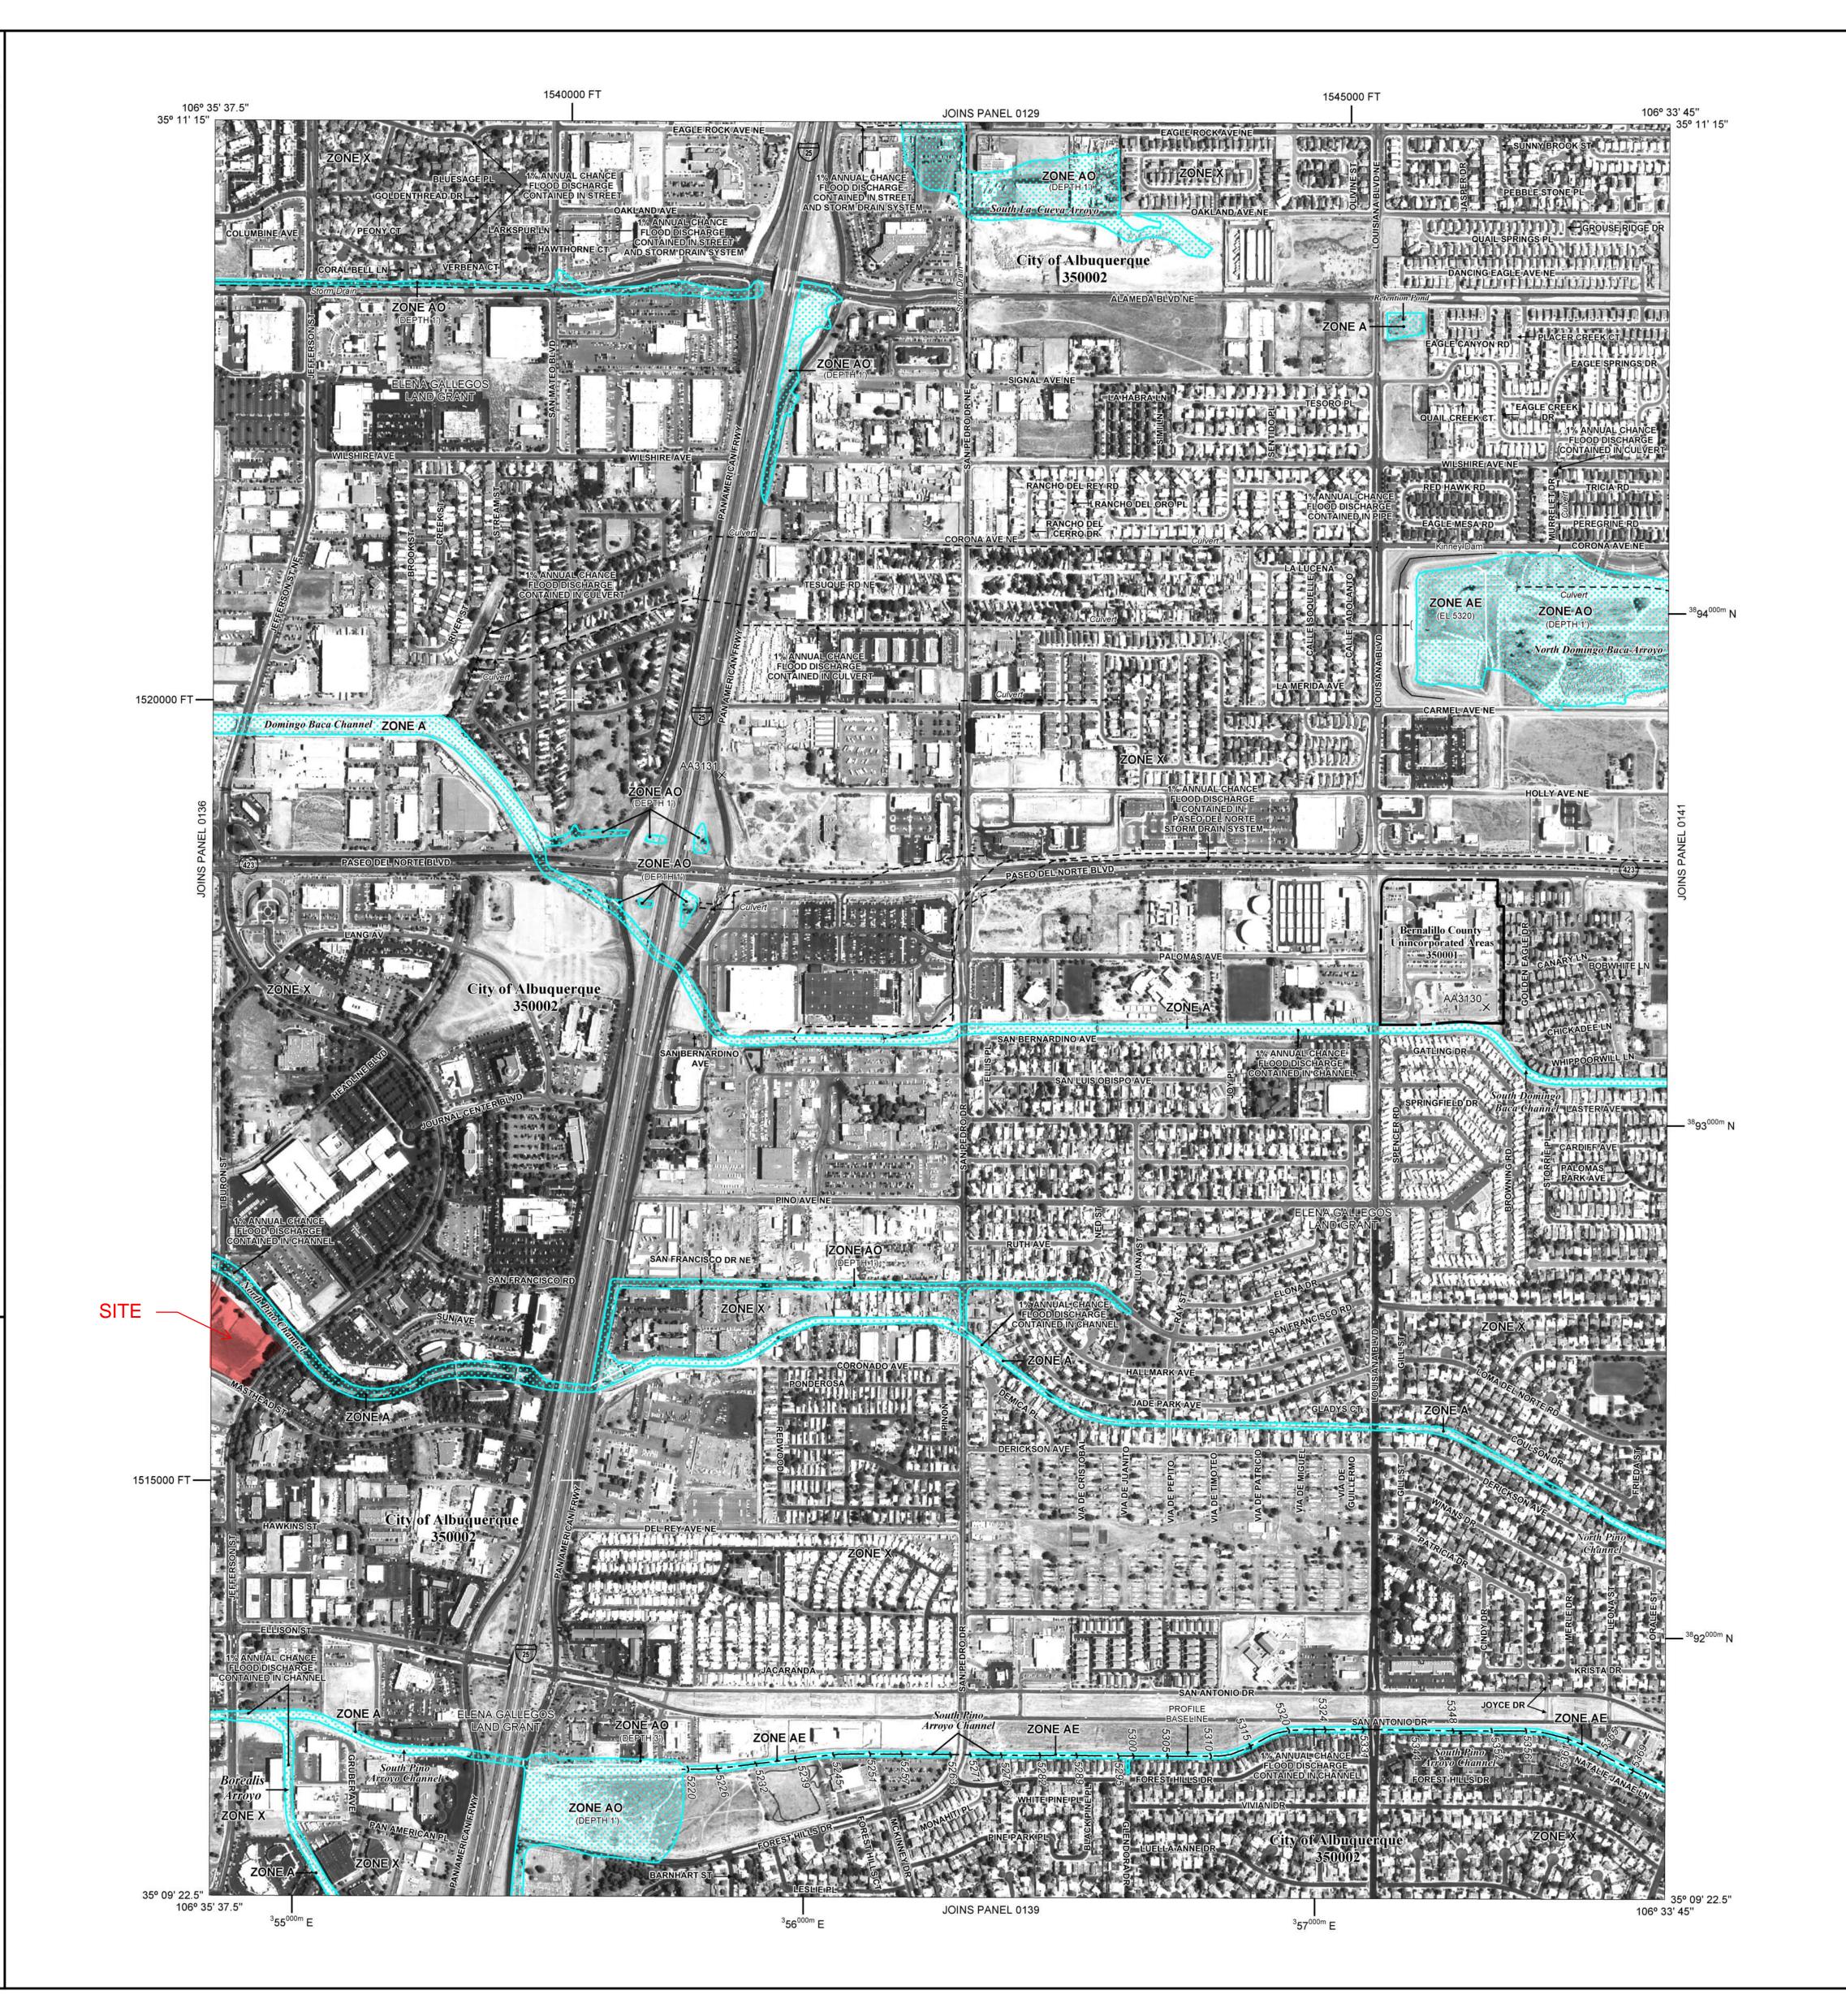

#### **LEGEND**

SPECIAL FLOOD HAZARD AREAS (SFHAs) SUBJECT TO INUNDATION BY THE 1% ANNUAL CHANCE FLOOD

The 1% annual chance flood (100-year flood), also known as the base flood, is the flood that has a 1% chance of being equaled or exceeded in any given year. The Special Flood Hazard Area is the area subject to flooding by the 1% annual chance flood. Areas of Special Flood Hazard include Zones A, AE, AH, AO, AR, A99, V, and VE. The Base

No Base Flood Elevations determined.

ZONE AE Base Flood Elevations determined. Flood depths of 1 to 3 feet (usually areas of ponding); Base Flood Elevations determined

Flood Elevation is the water-surface elevation of the 1% annual chance flood.

Flood depths of 1 to 3 feet (usually sheet flow on sloping terrain); average depths determined. For areas of alluvial fan flooding, velocities ZONE AR Special Flood Hazard Area formerly protected from the 1% annual

chance flood by a flood control system that was subsequently decertified. Zone AR indicates that the former flood control system is being restored to provide protection from the 1% annual chance or

flood protection system under construction; no Base Flood Elevations Coastal flood zone with velocity hazard (wave action); Base Flood Elevations

ZONE A99 Area to be protected from 1% annual chance flood by a Federal

#### FLOODWAY AREAS IN ZONE AE

The floodway is the channel of a stream plus any adjacent floodplain areas that must be kept free of encroachment so that the 1% annual chance flood can be carried without substantial increases in flood heights.

#### OTHER FLOOD AREAS

Areas of 0.2% annual chance flood; areas of 1% annual chance flood with average depths of less than 1 foot or with drainage areas less than 1 square mile; and areas protected by levees from 1% annual chance

OTHER AREAS

ZONE X Areas determined to be outside the 0.2% annual chance floodplain. Areas in which flood hazards are undetermined, but possible.

COASTAL BARRIER RESOURCES SYSTEM (CBRS) AREAS

OTHERWISE PROTECTED AREAS (OPAs)

CBRS areas and OPAs are normally located within or adjacent to Special Flood Hazard Areas.

1% annual chance floodplain boundary 0.2% annual chance floodplain boundary

Floodway boundary

Zone D Boundary ••••••

CBRS and OPA Boundary Boundary dividing Special Flood Hazard Area Zones and boundary dividing Special Flood Hazard Areas of different Base Flood Elevations, flood depths or flood velocities.

5000-foot grid ticks: New Mexico State Plane coordinate system.

Central zone (FIPSZONE 3002), Transverse Mercator

Base Flood Elevation line and value; elevation in feet\* **∼** 513 **∼** Base Flood Elevation value where uniform within zone; elevation in feet\* \*Referenced to the North American Vertical Datum of 1988

—⟨**A**⟩ Cross section line

(23) - - - - (23) Transect line

\_\_\_\_

Geographic coordinates referenced to the North American Datum of 1983 (NAD 83), Western Hemisphere <sup>42</sup> 76 <sup>∞∞</sup>E 1000-meter Universal Transverse Mercator grid values, zone 13

600000 FT

• M1.5

Bench mark (see explanation in Notes to Users section of this FIRM panel) River Mile

Refer to Map Repositories list on Map Index. EFFECTIVE DATE OF COUNTYWIDE FLOOD

MAP REPOSITORIES

INSURANCE RATE MAP PANEL

#### SEPTEMBER 20, 1996

EFFECTIVE DATE(S) OF REVISION(S) TO THIS PANEL April 2, 2002

November 19, 2003 September 26, 2008 August 16, 2012 - to update corporate limits, to change Base Flood Elevations, to add Special Flood Hazard Areas, to change Special Flood Hazard Areas, to add roads and

For community map revision history prior to countywide mapping, refer to the Community Map History table located in the Flood Insurance Study report for this jurisdiction.

road names, to incorporate previously issued Letters of Map Change.

To determine if flood insurance is available in this community, contact your insurance

agent or call the National Flood Insurance Program at 1-800-638-6620.



MAP SCALE 1" = 500'

# PANEL 0137H AAA N **FIRM** FLOOD INSURANCE RATE MAP PROG BERNALILLO COUNTY, **NEW MEXICO** AND INCORPORATED AREAS PANEL 137 OF 825 **CONTAINS:** ALBUQUERQUE, CITY OF BERNALILLO COUNTY

(SEE MAP INDEX FOR FIRM PANEL LAYOUT)

NUMBER PANEL SUFFIX UNINCORPORATED AREAS 350001 0137

Notice to User: The Map Number shown below should be used when placing map orders; the Community Number shown above should be used on insurance applications for the subject



35001C0137H MAP REVISED

**AUGUST 16, 2012** 


MAP NUMBER

Federal Emergency Management Agency

#### **Existing Trees:**

Trees at the intersection of Jefferson and Masthead (Don't know if they can remain).

- 3 Austrian pine trees (Pinus) 16"- 24" caliper
- 4 Crabapple trees (Malus) 12f"-15" caliper

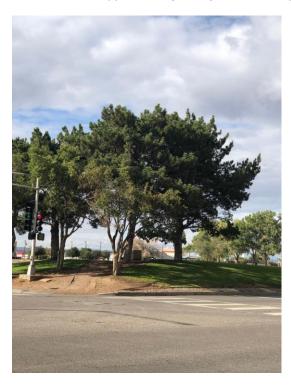

Trees on the north along the arroyo (Don't know if they are within the property lines. Concerned about the roots being severed during construction.):

- 5 cottonwood trees (Populus) 23-32" caliper
- 4 Siberian elms (Ulmus) 16"-20" caliper. (Siberian elm trees are not desirable.)



Trees at the intersection of Masthead and Tiburon (they can probably remain but they are not healthy, hence don't look good)

• 5 Hawthorn trees 3"-5" caliper.



Trees in the middle of the site. (these trees must be removed)

- 3 Siberian Elms trees (Ulmus)
- 1 Desert willow (Chilopsis)





# Tim Keller, Mayor

#### City of Albuquerque

P.O. Box 1293 Albuquerque, NM 87103

#### **Planning Department**

Alan Varela, Interim Director

Sarita Nair, CAO					
DATE: October 11,20	021				
SUBJECT: Albuquer	que Archaeological Ordinance - Compliance Documentation				
Case Number(s): Agent: Applicant: Legal Description: Zoning:	RZ-2021-00006, Project #2021-005195 Christopher Whyman (Dekker/Perich/Sabatini) Josh Rodgers (JC Six LLC) TRACT 6A-1 MX-H				
Acreage: Zone Atlas Page(s):	5.1536 D-17-Z				
CERTIFICATE OF	F NO EFFECT: Yes No				
SUPPORTING DO	OCUMENTATION:				

#### SITE VISIT: n/a

#### **RECOMMENDATIONS:**

Historic Google earth images, ARMS records

The property appears to have been bladed clear by 2002. A small portion of it was surveyed in 2002 under NMCRIS 80100 with no significant finds.

Therefore: CERTIFICATE OF NO EFFECT ISSUED-under criterion 2 "The property has been disturbed through previous land use"

**SUBMITTED BY:** 

**SUBMITTED TO:** 

Planning, Development Services

Douglas H. M. Boggess, MA, RPA Date Senior Principal Investigator

Acting City Archaeologist

Lone Mountain Archaeological Services, Inc.

Current DRC	
Project No.	

Date Submitted:	9/16/2022
Date Site Plan Approved:	
Date Preliminary Plat Approved:	
Date Preliminary Plat Expires:	

PR-2021-005195

DRB Project No.

Figure 12

#### INFRASTRUCTURE LIST

#### EXHIBIT "A" TO SUBDIVISION IMPROVEMENTS AGREEMENT DEVELOPMENT REVIEW BOARD (D.R.B.) REQUIRED INFRASTRUCTURE LIST

#### ALLASO - JC 6 TRACT 6A-1 JOURNAL CENTER PHASE 2, UNIT 1

Following is a summary of PUBLIC/PRIVATE Infrastructure required to be constructed or financially guaranteed for the above development. This Listing is not necessarily a complete listing. During the IIA process and/or in the review of the construction drawings, if the DRC Chair determines that appurtenant items and/or unforeseen items have not been included in the infrastructure listing, the DRC Chair may include those items in the listing and related financial guarantee. Likewise, if the DRC Chair determines that appurtenant or non-essential items can be deleted from the listing, those items may be deleted as well as the related portions of the financial guarantees. All such revisions require approval by the DRC Chair, the User Department and agent/owner. If such approvals are obtained, these revisions to the listing will be incorporated administratively. In addition, any unforeseen items which arise during construction which which are necessary to complete the project and which normally are the Subdivider's responsibility will be required as a condition of project acceptance and close out by the City.

IIA Sequence #	COA DRC Project #	Size	Type of Improvement	Location	From	То	Private Inspector	City Inspector	City Cnst Engineer
		PUBLIC ROADWAY IMPROVE	EMENTS						
		6' WIDE	APPROX 350 LF OF SIDEWALK	JEFFERSON ST	NORTH PROPERTY LINE OF TRACT 6A-1	INTERSECTION OF JEFFERSON & MASTHEAD	/		
		6' WIDE	APPROX 270 LF OF SIDEWALK	MASTHEAD ST	INTERSECTION OF JEFFERSON & MASTHEAD	INTERSECTION OF MASTHEAD & TIBURON			
		6' WIDE	APPROX 400 LF OF SIDEWALK	TIBURON AVE	INTERSECTION OF MASTHEAD & TIBURON	NORTH PROPERTY LINE OF TRACT 6A-1			
		10' WIDE	APPROX 600 LF OF ASPHALT TRAIL	PINO ARROYO	TIBURON AVE	JEFFERSON ST			
		BUS SHELTER	BUS SHELTER	JEFFERSON ST	SOUTHBOUND LANES OF JEFFERSON ST	EAST SIDE OF REDW FACILITY			
		ADA RAMPS	ADA RAMPS & SIDEWALK IMPROVEMENTS	INTERSECTION OF	JEFFERSON ST	MASTHEAD ST		1	
		DRIVEWAY	DRIVEWAY AND ADA RAMPS	MASTHEAD ST	N/A	N/A		1	
		DRIVEWAY	DRIVEWAY AND ADA RAMPS	TIBURON AVE	N/A	N/A			
		PUBLIC SANITARY SEWER IN	MPROVEMENTS						
		4' DIA	SANITARY SEWER MANHOLE	MASTHEAD	N/A	N/A		1	
		PUBLIC STORM DRAIN IMPR	OVEMENTS						
		24" DIA	RCP STORM DRAIN CHANNEL PENETRATION (APPROX 40 LF)	N PINO ARROYO	NW CORNER OF TRACT 6A-1	N/A			

AGENT/	OWNER		DEVELO	PMENT REVIEW BOARD ME	MBER APPROVALS	
MATTHEW S	SATCHES, PE	DRB CHAIR		DATE	CODE ENFORCEMENT	DATE
BOHANNAN I	HUSTON INC.					
FIRM:	Sec	TRANSPORTATION DEVELOPMENT		DATE	PARKS & RECREATION	DATE
SIGNATURE		ABCWUA		DATE	CITY ENGINEER	DATE
MAXIMUM TIME ALLOW TO CONSTI						
INIT KOVEMENTO WITHOUT KEND	EXTENSION			DATE		DATE
		DESIG	GN REVIEW COMMITTEE REVISION	DNS		
REVISION	DATE	DRC CHAIR	USER DEPAR	TMENT		AGENT/OWNER



### SHEET KEYED NOTES

- TRASH COMPACTOR, SEE D1/SDP1.2
- PARKING LOT STRIPING, 4" WIDE TYPICAL, COLOR: WHITE
- CONCRETE CURB & GUTTER, SEE A2/SDP1.2
- LANDSCAPING AND SIGNAGE WILL NOT INTERFERE WITH CLEAR SIGHT REQUIREMENTS. THEREFORE, SIGNS, WALLS, TREES, AND SHRUBBERY BETWEEN 3 AND 8 FEET TALL (AS MEASURED FROM THE GUTTER PAN) WILL NOT BE ACCEPTABLE IN THE CLEAR SIGHT TRIANGLE
- 20' FRONT SETBACK
- 10' SIDE/REAR SETBACK
- ACCESSIBLE RAMP, SEE B3/SDP1.2 AND C5/SDP1.2
- ACCESSIBLE RAMP. CONSTRUCT PER C.O.A. STANDARD DETAIL 24463 BUILDING MOUNTED BLADE SIGN SEE C5/SDP 1.3
- MONUMENT SIGN SEE C4/SDP 1.2 OUTDOOR GATHERING AREA WITH SWIMMING POOL AND SPA
- 6' DECORATIVE METAL FENCE SEE C4/SDP-1.2
- 6' DECORATIVE CMU WALL W/ 3' METAL FENCING INFILL, SEE D5/SDP/1.2
- ELECTRIC VEHICLE (EV) CHARGING STATION WITH SIGN; REF: B1/SDP1.2 BIKE RACK, REF: B5/SDP1.2
- MOTORCYCLE PARKING WITH SIGN; REF: B1/SDP1.2

#### RECYCLING BIN ENCLOSURE, REF: D4/SDP1.2

1. EXISTING 10' UTILITY EASEMENT, TYPICAL ALONG STREET R.O.W.

AMENITIES ON-SITE WILL INCLUDE COVERED PARKING SPACES, LEASING OFFICE, MAIL AND PACKAGE CENTER, AND BIKE STORAGE ROOM. THERE IS A CLUBHOUSE WITH GATHERING SPACE AND FITNESS CENTER. IN ADDITION TO THE CLUBHOUSE, OUTDOOR AMENITIES INCLUDE A SWIMMING POOL AND SPA, COVERED GATHERING AREAS AND LANDSCAPING.

## OPEN SPACE CALCULATIONS

TABLE 2-4-5 / MX-M ZONING 225 SF x 123 UNITS = 27,675 SF 285 SF x 84 UNITS = 23,940 SF

= 51,615 SF

= 49,282 SF **OPEN PATIO/BALCONIES** = 21,064 SF

UNIT TYPE	DESCRIPTION	GSF	#UNI	TS TOTAL
S1	STUDIO	601 SF	17	10,217 SF
S2	STUDIO	682 SF	2	1,364 SF
A1	1 BEDROOM / 1 BATHROOM	627 SF	70	43,890 SF
A2	1 BEDROOM / 1 BATHROOM	776 SF	2	1,552 SF
A3	1 BEDROOM / 1 BATHROOM	661 SF	-	0 SF
A4	1 BEDROOM / 1 BATHROOM	622 SF	2	1,244 SF
A5	1 BEDROOM / 1 BATHROOM	741 SF	4	2,964 SF
A6	1 BEDROOM / 1 BATHROOM	715 SF	3	2,145 SF
A7	1 BEDROOM / 1 BATHROOM	707 SF	5	3,535 SF
A8	1 BEDROOM / 1 BATHROOM	732 SF	1	732 SF
A9	1 BEDROOM / 1 BATHROOM	718 SF	6	4,308 SF
A10	1 BEDROOM / 1 BATHROOM	810 SF	1	810 SF
A11	1 BEDROOM / 1 BATHROOM	681 SF	3	2,043 SF
B1	2 BEDROOM / 2 BATHROOM	1,007 SF	15	15,105 SF
B2	2 BEDROOM / 2 BATHROOM	1,020 SF	24	24,480 SF
B3	2 BEDROOM / 2 BATHROOM	1,138 SF	8	9,104 SF
B4	2 BEDROOM / 2 BATHROOM	1,063 SF	14	14,882 SF
B5	2 BEDROOM / 2 BATHROOM	1,178 SF	8	9,424 SF
B6	2 BEDROOM / 2 BATHROOM	1,085 SF	3	3,255 SF
B7	2 BEDROOM / 2 BATHROOM	1,300 SF	2	2,600 SF
B8	2 BEDROOM / 2 BATHROOM	1,221 SF	2	2,442 SF
B9	2 BEDROOM / 2 BATHROOM	963 SF	2	1,926 SF
B10	2 BEDROOM / 2 BATHROOM	1,037 SF	3	3,111 SF
B11	2 BEDROOM / 2 BATHROOM	1,041 SF	2	2,082 SF
B12	2 BEDROOM / 2 BATHROOM	1,137 SF	1	1,137 SF
CARRIAGE 1	1 BEDROOM / 1 BATHROOM	1,000 SF	3	3,000 SF
CARRIAGE 2	1 BEDROOM / 1 BATHROOM	767 SF	4	1,536 SF
TOTAL:			207 UNITS	167,352 SF

Application Number:

Is an Infrastructure List required? ( ) Yes ( ) No If yes, then a set of approved DRC plans with a work order is required for any construction within Public Right-of-Wayor for construction of public improvements.

Date

Date

Date

DRB SITE DEVELOPMENT PLAN APPROVAL:

ABCWUA	
Parks and Recreation Department	
City Engineeer/Hydrology	

\*Environmental Heath Department (conditional) Date Herman Gallegos Herman Gallegos 12-09-21 Solid Waste Management Date

DRB Chairperson, Panning Department

### **GENERAL NOTES**

- A. DIMENSIONS ARE TO FACE OF CURB, OR WALL, OR EDGE OF PAVEMENT UNLESS OTHERWISE NOTED.
- D. SITE PLAN SHALL COMPLY WITH LOCAL, STATE AND FEDERAL ADA STANDARDS & GUIDELINES, INCLUDING THE INTERNATIONAL FIRE CODE (IFC) 2015.
- CURBS AND ACCESSIBLE RAMPS WILL BE DESIGNED AND BUILT ACCORDING TO THE CITY OF ALBUQUERQUE STANDARDS. . LIGHT FIXTURES AND DESIGN SHALL COMPLY WITH THE CITY OF ALBUQUERQUE
- INTEGRATED DEVELOPMENT ORDINANCE (IDO): SECTION 14-16-5-8 OUTDOOR LIGHTING. G. STREETS. PARKING SPACES AND ASSOCIATED DRIVES TO BE ASPHALT UNLESS
- NOTED OTHERWISE. H. LANDSCAPE AND SIGNAGE WILL NOT INTERFERE WITH CLEAR SIGHT REQUIREMENTS. SIGNS, WALLS AND PLANTING BETWEEN 3 FEET AND 8 FEET TALL
- (AS MEASURED FROM THE GUTTER PAN) WILL NOT BE PERMITTED IN THE CLEAR SIGHT TRIANGLE. ALL PUBLIC INFRASTRUCTURE LOCATED WITHIN CITY RIGHT-OF-WAY SHALL BE INCLUDED IN A PUBLIC WORK ORDER.

### PROJECT DATA

IDO - MIXED USE - HIGH INTENSITY ZONING DISTRICT (MX-H)

LANDUSE: MULTIFAMILY RESIDENTIAL **PLANNING CONTEXT:** 

SITE IS WITHIN THE JOURNAL CENTER EMPLOYMENT CENTER

BUS ROUTES 140, 251, AND 551 ARE ALONG JEFFERSON ST. A BUS STOP IS LOCATED LESS THAN 250 FEET FROM THE SUBJECT SITE ON JEFFERSON. **LEGAL DESCRIPTION:** 

TRACT 6A-1 PLAT OF JOURNAL CENTER PHASE 2 UNIT 1CONT 5.1536 AC **SITE AREA:** 5.15 ACRES

ZONE ATLAS: D-17-Z **SETBACKS:** FRONT= 20' MIN SIDE = 10' MIN REAR= 10' MIN

(40' BUILDING SETBACK, 30' PARKING SETBACK FROM JEFFERSON ST.) (30' BUILDING SETBACK 20'PARKING SETBACK ALONG MASTHEAD ST. AND TIBURON ST.)

**BUILDING HEIGHT:** MAXIMUM ALLOWED: 68'-0' ACTUAL HEIGHT:

SPRINKLERED: YES, NFPA 13 BUILDING OCCUPANCY: R-2 MULTIFAMILY RESIDENTIAL **CONSTRUCTION TYPE:** 4 STORY RESIDENTIAL BUILDING - TYPE VA

BUILDING AREA (S.F.): BUILDING A: **BUILDING B:** BUILDING C:

207,334 GSF **PARKING CALCULATION:** (TABLE 5-5-1) 1.5 SPACES / DWELLING UNITS: 207 X 1.5 = 311 SPACES WITHIN EMPLOYEMENT CENTER = 20% REDUCTION = 311 X .20 = 62 TOTAL REQUIRED SPACES = 311 - 62 = 249 SPACES

PROVIDED PARKING = 271 TOTAL SPACES (INCLUDING 24 GARAGE) **ACCESSIBLE PARKING: (NMBC 208.2.3)** 2% OF UNITS = 207 X .02 = 4.14 = 5 SPACES REQUIRED 8 STANDARD SPACES + 4 VAN ACCESSIBLE SPACES = 12 SPACES PROVIDED

BICYCLE PARKING REQUIRED (10% OF REQUIRED OFF-STREET PARKING = 249 X 0.10 = 25 SPACES BICYCLE PARKING PROVIDED = 26 SPACES

MOTORCYCLE PARKING REQUIRED, (TABLE 5-5-4) = 5 SPACES MOTORCYCLE PARKING PROVIDED ELECTRIC VEHICLE PARKING REQUIRED, 2% (TABLE 5-5(C)(9)) = 5 SPACES **ELECTRIC VEHICLE PARKING PROVIDED** = 5 SPACES

#### **LEGEND**

LANDSCAPE AREA HEAVY DUTY ASPHALT (RATED FOR UP TO 75,000 LBS)

- - - - - - FIRELANE STRIPING MARKING FIRE ACCESS LANE; REF: A4/SDP1.2

PROPERTY LINE

POST INDICATOR VALVE (PIV), RE: CONCEPTUAL UTILITY PLAN

FIRE DEPARTMENT CONNECTION (FDC) WALL-MOUNTED BIKE RACK, REF: B5/SDP1.2

SIDEWALK RAMP (ARROW POINTS DOWN)

TRANSFORMER WITH SAFETY BOLLARDS & 6" THICK CONCRETE PAD PER PNM STANDARDS

6' TALL DECORATIVE METAL FENCE

ACCESSIBLE PARKING WITH ACCESSIBLE SIGNAGE AND STRIPING, REF: A3/SDP1.2, A4/SDP1.2 & B4/SDP1.2.

COMPACT PARKING; REF: D5/SDP1.3 LIGHT POLE 25'-0" HEIGHT

6" BOLLARD WITH SIGN

6' WIDE PAINTED CROSSWALK, SEE A4/SDP1.2 ELECTRIC VEHICLE (EV) CHARGING STATION WITH SIGN; REF: B1/SDP1.2

## VICINITY MAP



# PERICH SABATINI

ARCHITECTURE DESIGN **INSPIRATION** 

ARCHITECT

**PRELIMINARY** NOT FOR CONSTRUCTION

**ENGINEER** 

59,687 GSF

59,687 GSF

87,960 GSF

PROJECT


7501 JEFFERSON STALBUQUERQUE, NM

**DESIGN REVIEW** BOARD (DRB) **APPLICATION** 

REVISIONS

DRAWN BY D/P/S REVIEWED BY D/P/S 12.10.2021 PROJECT NO. 20-0029

DRAWING NAME SITE PLAN

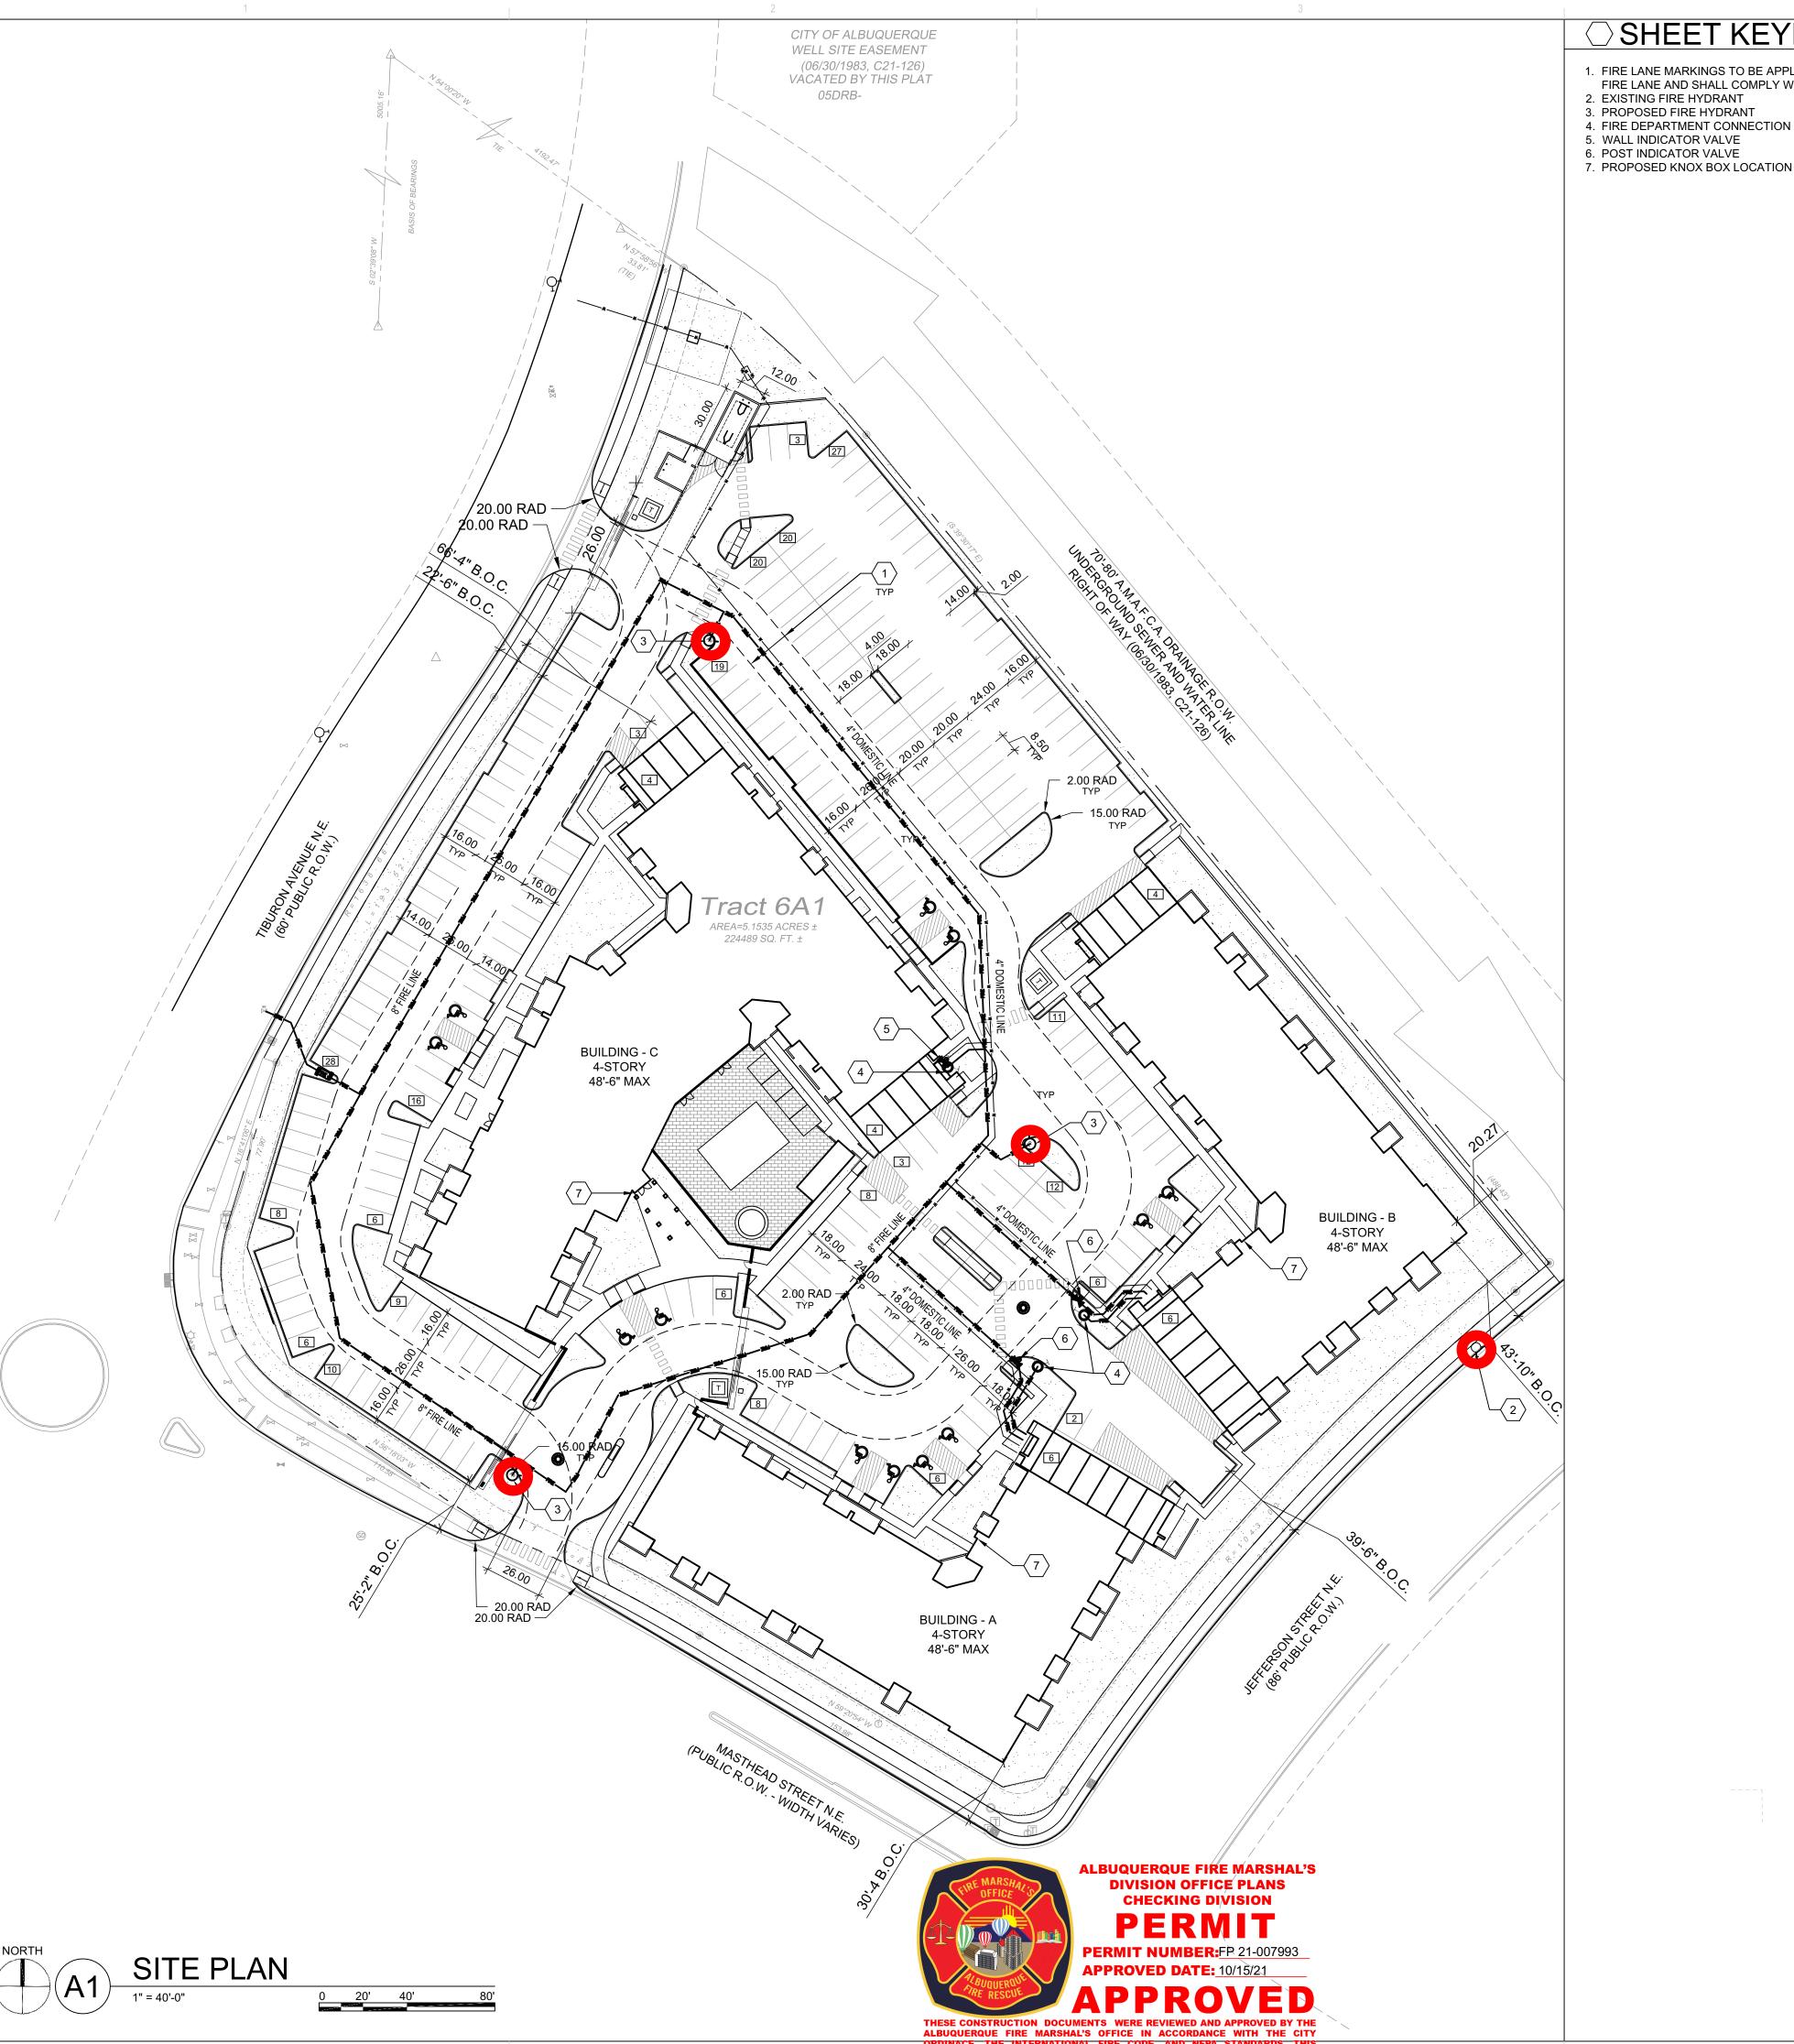

FIRE FLOW: V-A 207,334 SF 2625 GPM 3 HYDRANTS

### SHEET KEYED NOTES

- 2. EXISTING FIRE HYDRANT
- 3. PROPOSED FIRE HYDRANT
- 4. FIRE DEPARTMENT CONNECTION
- 6. POST INDICATOR VALVE
- I. FIRE LANE MARKINGS TO BE APPLIED TO CURBS BOTH SIDES OF THE INDICATED
- THE PARKING LOT SURFACE SHALL BE ASPHALT PAVING AND CAPABLE OF
- SUPPORTING AN IMPOSED LOAD OF A FIRE APPARATUS WEIGHING 75,000 LBS. FIRE LANE AND SHALL COMPLY WITH FIRE ORDINANCE 503.3 AND 503.3.1 2. ALL SIDEWALKS AND RAMPS TO BE CONCRETE. 3. THE MINIMUM DRIVE ISLE WIDTH SHALL BE 26' UNLESS NOTED OTHERWISE.
  - 4. THE MINIMUM TURNING RADIUS SHALL BE 28' AS DETERMINED BY THE FIRE CODE
  - 5. BUILDINGS SHALL HAVE APPROVED ADDRESS NUMBERS OR BUILDING IDENTIFICATION PLACED IN A POSITION PLAINLY LEGIBLE AND VISIBLE FROM THE
  - 6. ALL DRIVING SURFACES SHALL NOT EXCEED 10 PERCENT IN GRADE. 7. FIRE DEPARTMENT CONNECTIONS SHALL BE LOCATED WITHIN 100' OF A HYDRANT
  - AND BE UNOBSTRUCTED FROM ANY OBJECT FOR A MINIMUM DISTANCE OF 3'. 8. POST INDICATOR VALVES SHALL BE PROVIDED PER NFPA 13. 9. A KNOX BOX SHALL BE PROVIDED AT THE ENTRANCE OF THE PROPOSED BUILDINGS.
  - 10. STANDPIPE SYSTEMS SHALL BE INSTALLED THROUGHOUT BUILDINGS WHERE THE FLOOR LEVEL OF THE HIGHEST STORY IS LOCATED MORE THAN 30 FEET ABOVE THE LOWEST LEVEL OF THE FIRE DEPT. VEHICLE ACCESS.
  - 11.BUILDINGS WHICH EXCEED 30 FEET IN HEIGHT REQUIRE UNOBSTRUCTED AERIAL APPARATUS ACCESS ROADS NOT LESS THAN 26 FEET IN WIDTH EXCLUSIVE OF SHOULDERS.

### PROJECT DATA

**GENERAL NOTES** 

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**SPRINKLERED:** YES, NFPA 13 **BUILDING OCCUPANCY:** R-2 MULTIFAMILY RESIDENTIAL CONSTRUCTION TYPE: 4 STORY RESIDENTIAL BUILDING - TYPE VA

BUILDING AREA (S.F.): **BUILDING B:** 


BUILDING C:

AN AUTOMATIC SPRINKLER AND SMOKE DETECTION SYSTEM SHALL BE INSTALLED THROUGHOUT THE BUILDING. SPRINKLER CONTRACTOR TO SUBMIT SHOP DRAWINGS TO THE AUTHORITY HAVING JURISDICTION. FIRE ALARM SYSTEM TO BE PROVIDED.

FIRE FLOW: IFC TABLE b105.1(2) MULTIFAMILY HOUSING = 8,000 x .25 = 2,000 GPM

FIRE HYDRANTS: 2 REQUIRED, 4 PROVIDED

### LEGEND

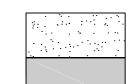

LANDSCAPE AREA

HEAVY DUTY ASPHALT (RATED FOR UP TO 75,000 LBS)

---- FIRELANE STRIPING MARKING FIRE ACCESS LANE; REF: A4/SDP1.2

———— PROPERTY LINE

→ FIRE HYDRANT

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FIRE DEPARTMENT CONNECTION (FDC) WALL-MOUNTED

☐ SIDEWALK RAMP (ARROW POINTS DOWN)

TRANSFORMER WITH SAFETY BOLLARDS & 6" THICK CONCRETE PAD PER PNM STANDARDS

6' TALL DECORATIVE METAL FENCE


ACCESSIBLE PARKING WITH ACCESSIBLE SIGNAGE AND STRIPING, REF: A3/SDP1.2, A4/SDP1.2 & B4/SDP1.2.

CC COMPACT PARKING; REF: D5/SDP1.3

6' WIDE PAINTED CROSSWALK, SEE A4/SDP1.2

LIGHT POLE 25'-0" HEIGHT

→ 6" BOLLARD WITH SIGN

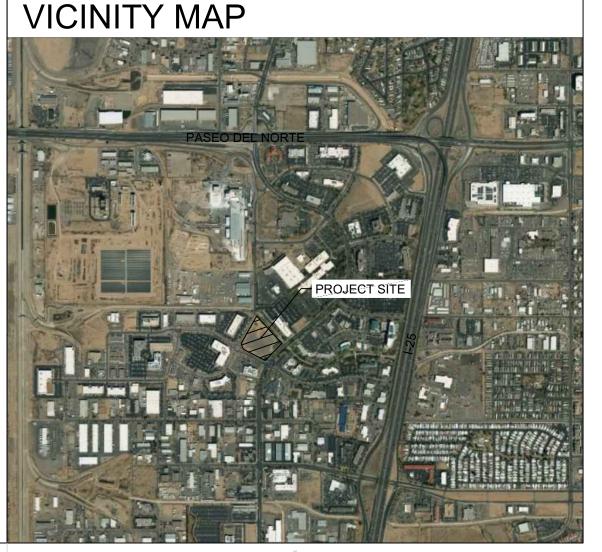

# PERICH SABATINI

ARCHITECTURE DESIGN INSPIRATION

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**ENGINEER** 

PROJECT

59,687 GSF

59,687 GSF

87,960 GSF 207,334 GSF

7501 JEFFERSON ALBUQUERQUE, N

JCC-ARC

REVISIONS

D/P/S DRAWN BY REVIEWED BY D/P/S 09.23.2021 PROJECT NO. 20-0029 DRAWING NAME

SITE PLAN

SHEET NO.

FIRE 1