



DO NOT ENTER SIGN

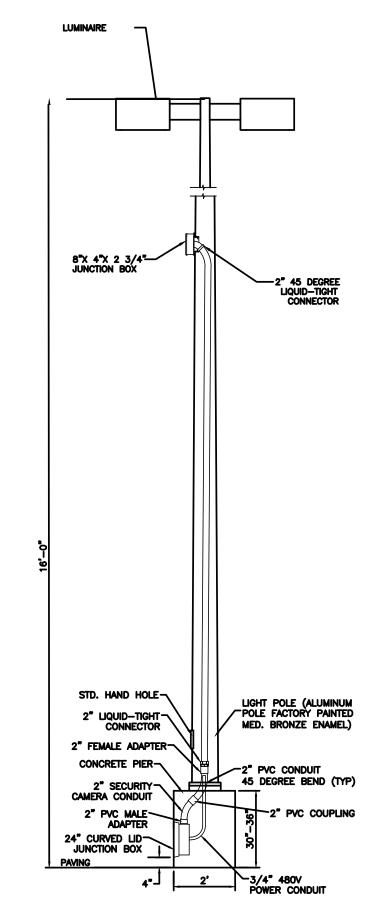



LIGHT STANDARD

DO NOT ENTER PAVEMENT MARKER W/ARROW NTS NOTE: ALL TRAFFIC FLOW ARROWS TO BE REFLECTIVE WHITE PAINT PER COA SPECS. TRAFFIC FLOW ARROW NTS

NOTE: ALL TRAFFIC FLOW STRIPING
TO BE SOLID WHITE REFLECTIVE
TRAFFIC PAINT PER

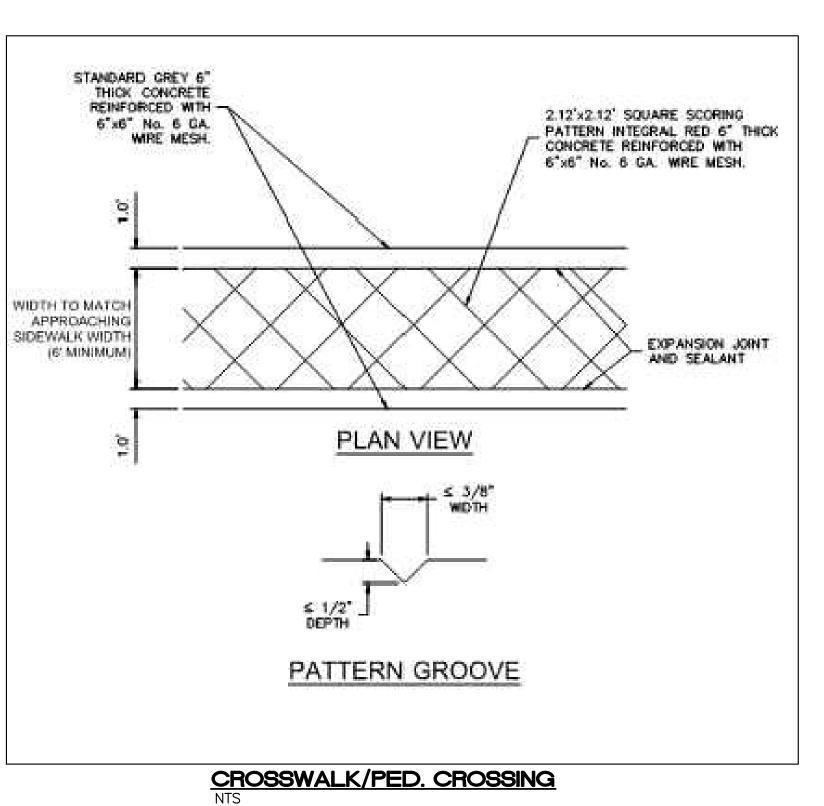


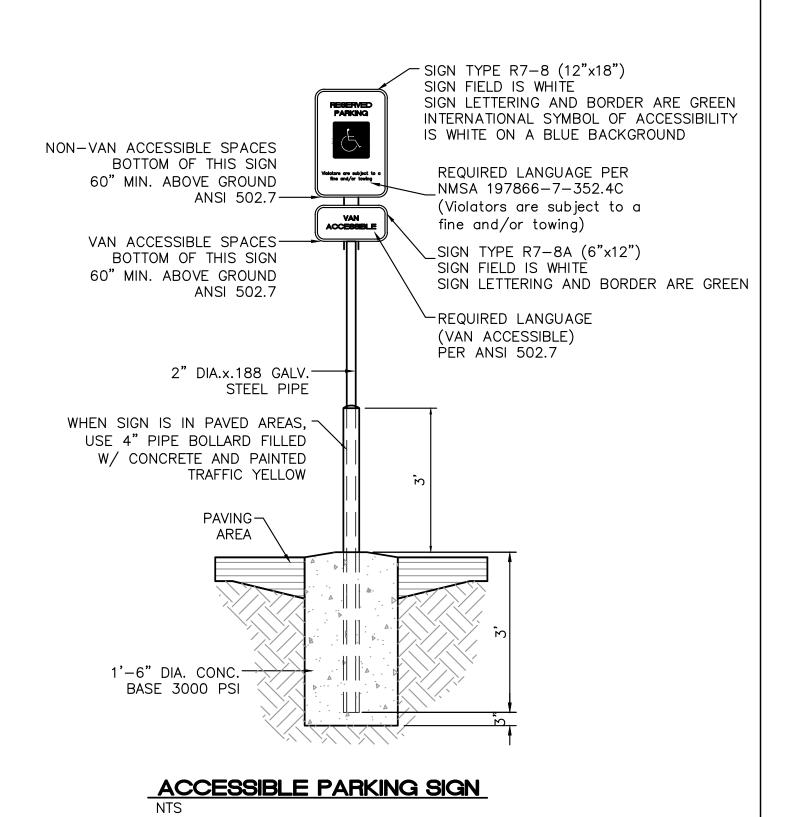

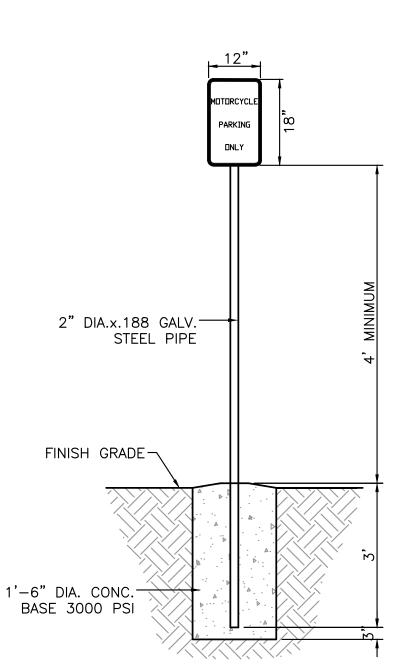



MOTORCYCLE PARKING SIGN


	NOT FOR CONSTRUCTION							
	ENGINEER'S SEAL 11/17/2021	NM 528 AND ELLISON	<i>DRAWN BY</i> LN					
	PROPERTY TO THE PROPERTY TO TH	3615 HWY 528	DATE					
		SITE PLAN DETAILS	11/17/2021					
			<i>DRAWING</i> 2014069-SPE					
			SHEET #					
		TIERRA WEST, LLC 5571 MIDWAY PARK PL NE ALBUQUERQUE, NEW MEXICO 87109 (505) 858-3100 www.tierrawestllc.com	C2.2					
	RONALD R. BOHANNAN P.E. #7868		<i>JOB #</i> 2020091					

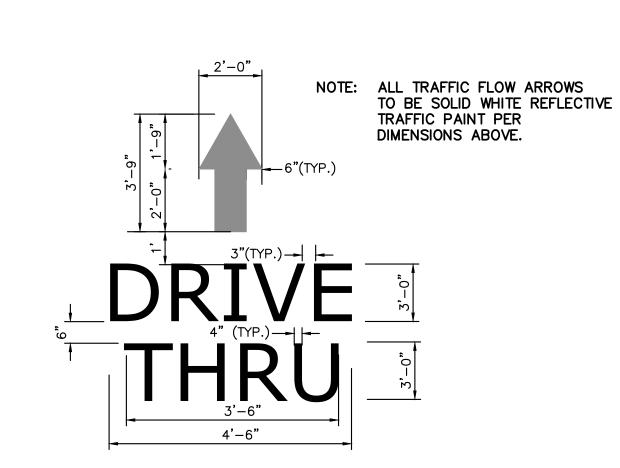



"ONE WAY" PAVEMENT MARKER W/ARROW

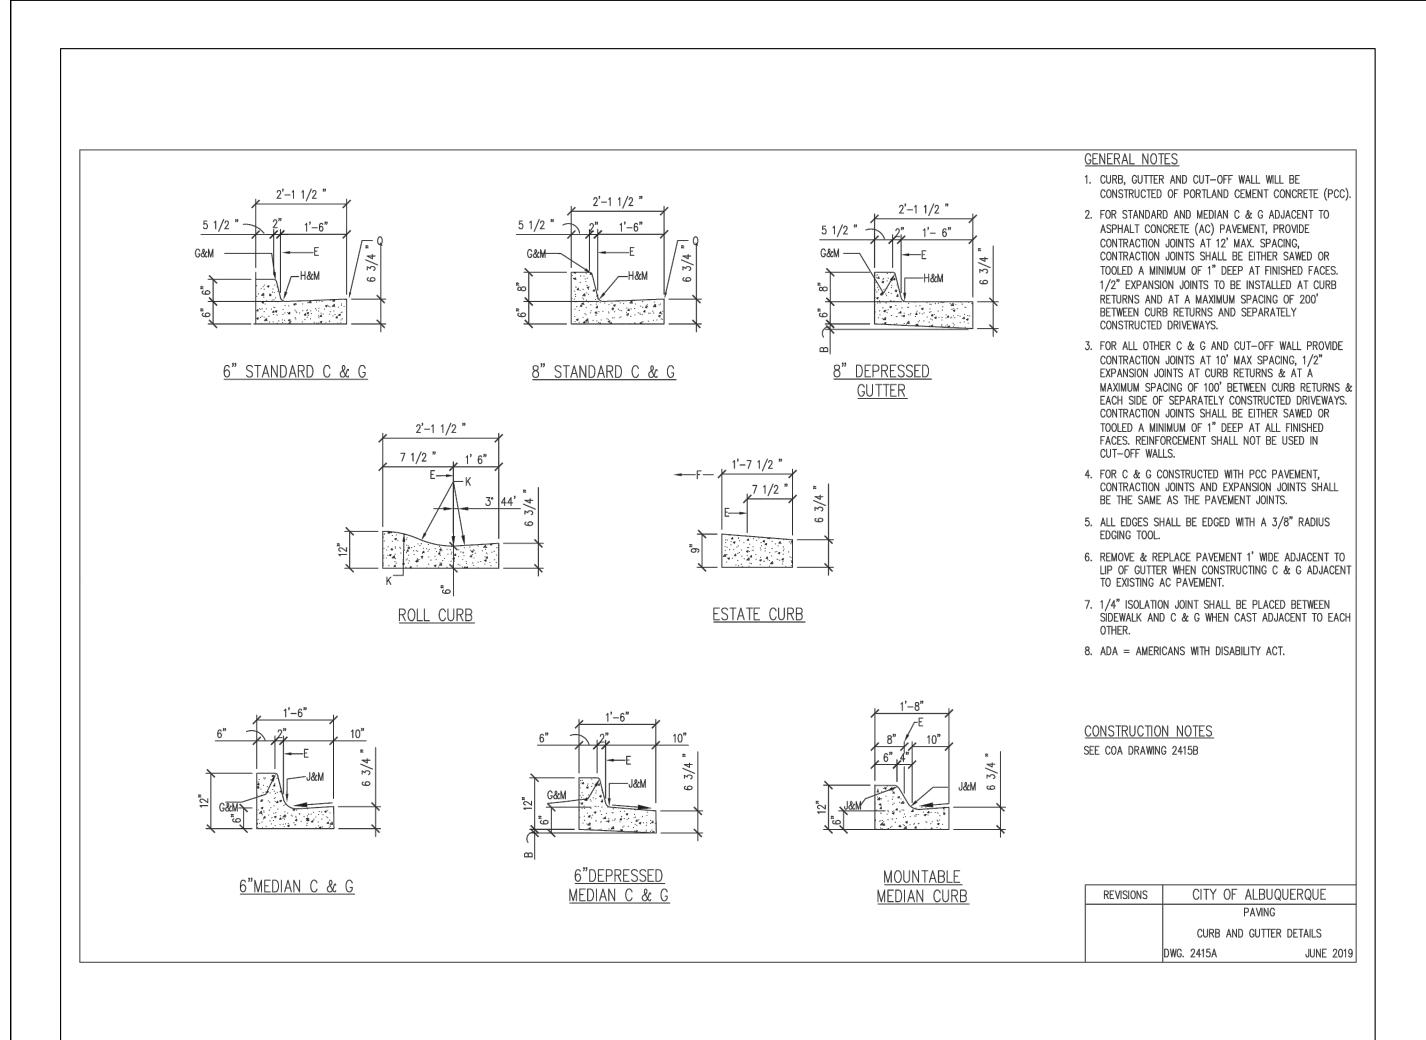

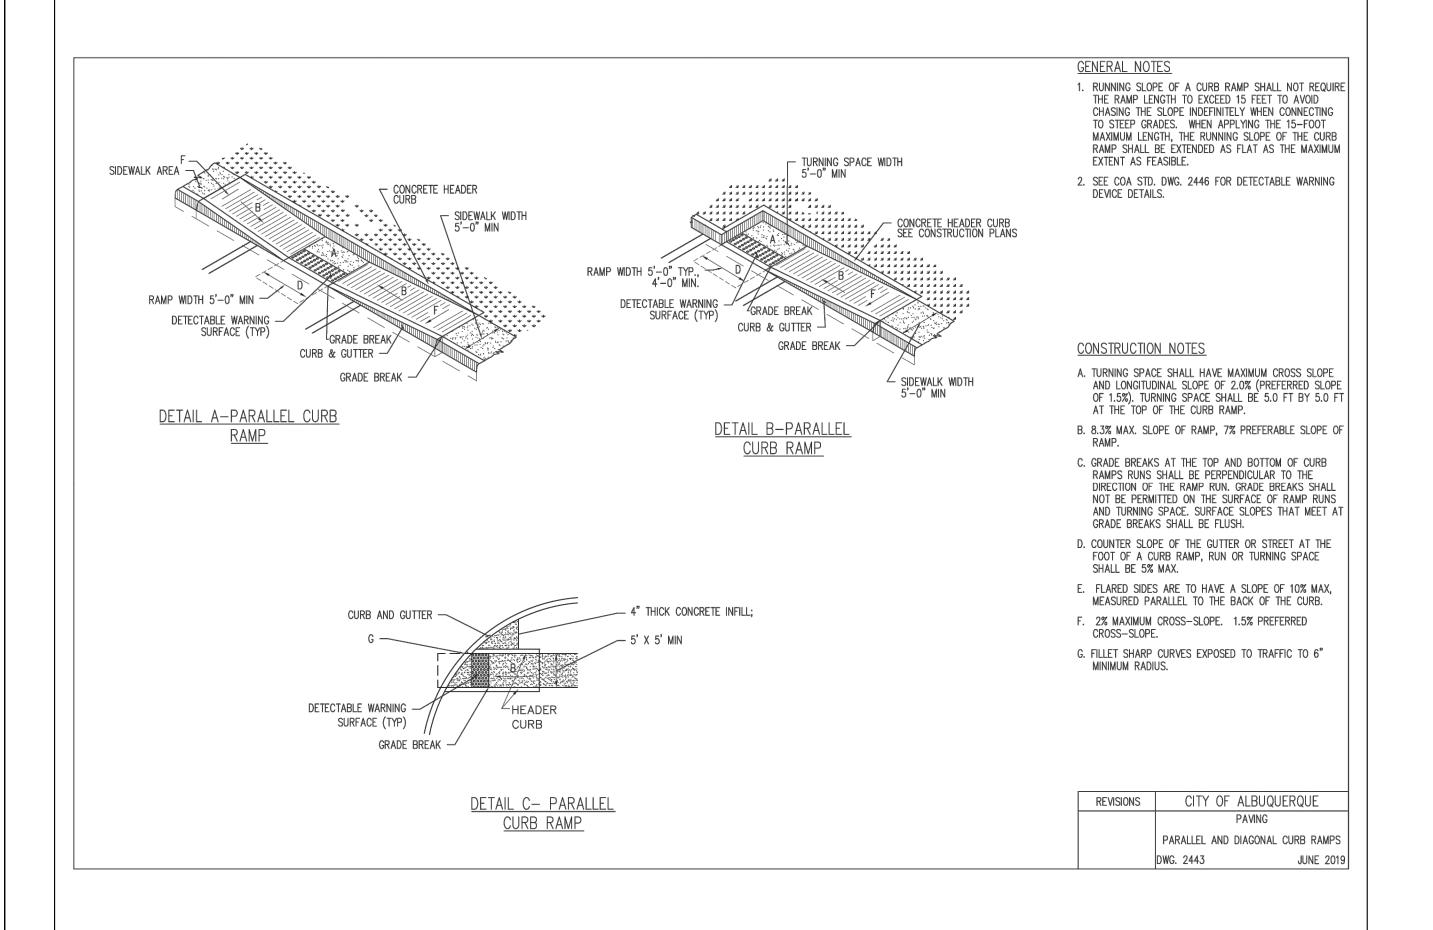

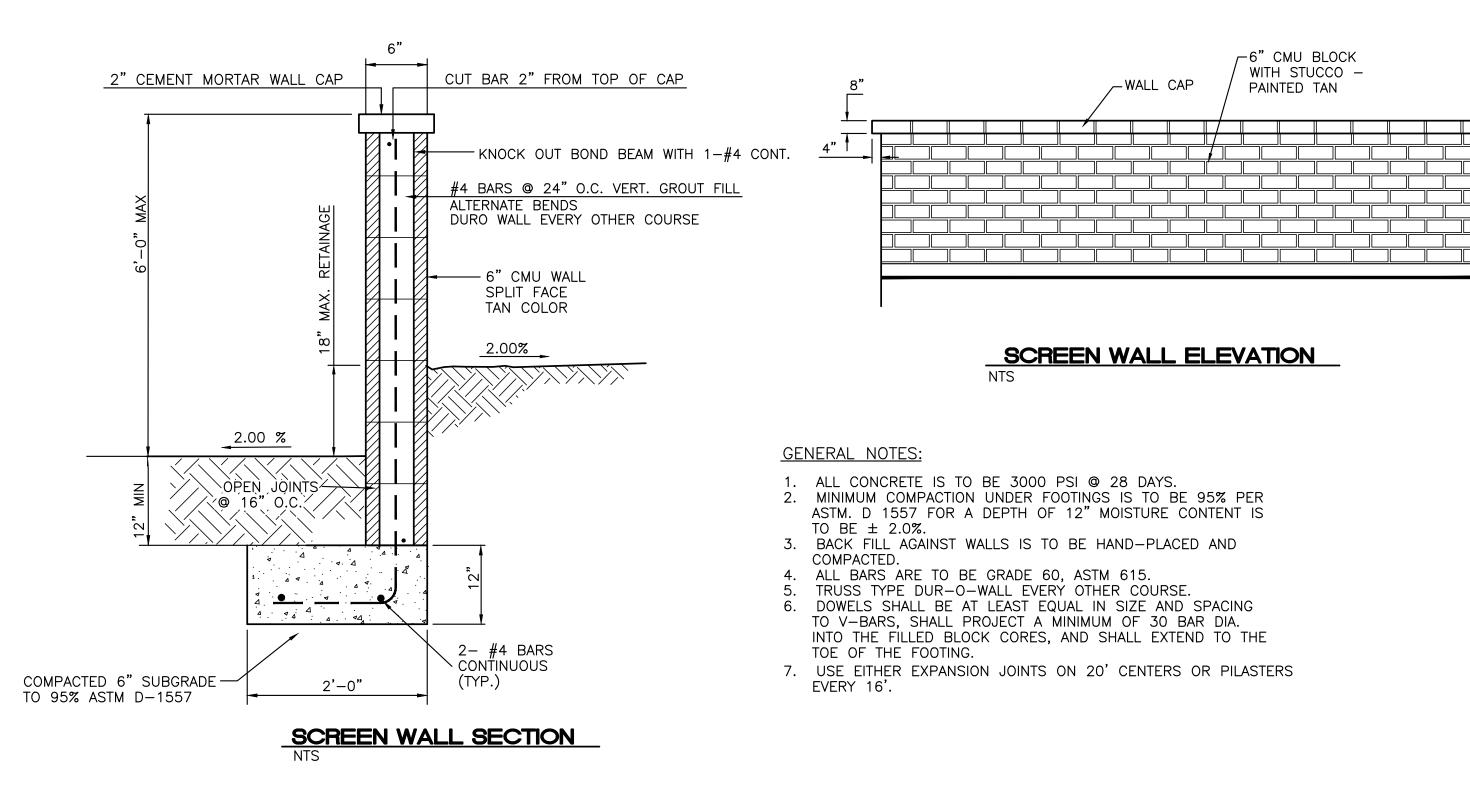

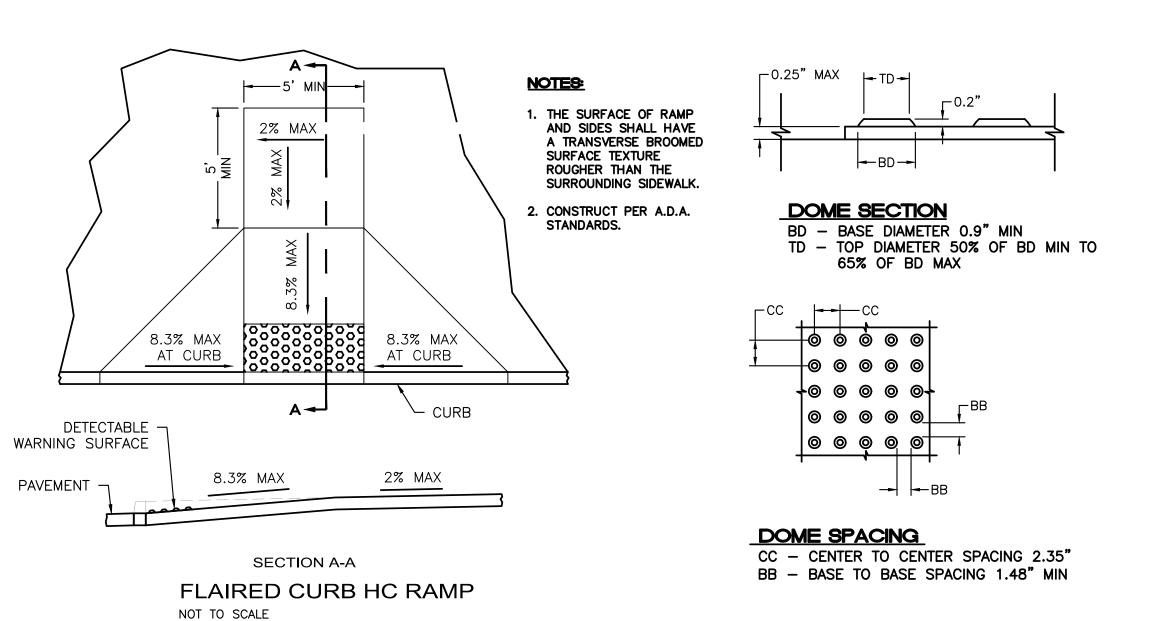

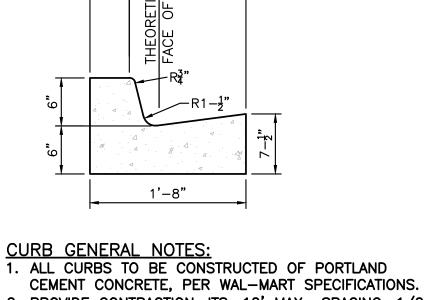

6".2". 1'-0"

1. ALL CURBS TO BE CONSTRUCTED OF PORTLAND

- 2. PROVIDE CONTRACTION JTS. 12' MAX., SPACING, 1/2" EXP. JTS. AT CURB RETURNS AND AT A MAX. SPACING OF 120' BETWEEN CURB RETURNS AND EACH SIDE OF SEPARATELY CONSTRUCTED DRIVEWAYS. CONTRACTION JTS., SHALL BE EITHER SAWED OR TOOLED A MINIMUM OF 1" DEEP AT FINISHED FACES.
- 3. ALL EDGES SHALL BE EDGED WITH A 3/8" RADUIS EDGING TOOL.
- 4. 1/4" ISOLATION JOINT SHALL BE PLACED BETWEEN SIDEWALK AND CURB WHEN CAST ADJACENT TO EACH OTHER.

6" PRIVATE CURB & GUTTER

	NOT FOR CONSTRUCTION					
ENGINEER'S SEAL 11/17/2021	NM 528 AND ELLISON	<i>DRAWN BY</i> LN				
TRANS MEXICO ZZ 7868	3615 HWY 528 SITE PLAN DETAILS	<i>DATE</i> 11/17/2021				
	OHE I LAN DETAILO	<i>DRAWING</i> 2014069—SPE				
PORTESSIONAL ERGIN	1	SHEET #				
fu Pal	TIERRA WEST, LLC 5571 MIDWAY PARK PL NE ALBUQUERQUE, NEW MEXICO 87109	C2.3				
RONALD R. BOHANNAN P.E. #7868	(505) 858-3100 www.tierrawestllc.com	<i>JOB #</i> 2020091				

LANDSCAPE PLAN

CLEAR SIGHT TRIANGLE NOTE

LANDSCAPING, FENCING AND SIGNING WILL NOT INTERFERE WITH CLEAR SIGHT REQUIREMENTS.
THEREFORE, SIGNS, WALLS, TREES, AND SHRUBBERY BETWEEN 3 AND 8 FEET TALL (AS MEASURED FROM THE GUTTER PAN) WILL NOT BE ACCEPTABLE IN THE CLEAR SIGHT TRIANGL.

LANDSCAPE DATA

25% OF VEGETATION COVERAGE

PROPOSED GROUND-LEVEL COVERAGE

LANDSCAPE DATA	
GROSS LOT AREA LESS BUILDING(S) NET LOT AREA	86,684 S 4300 S 82,384 S
REQUIRED LANDSCAPE 15% OF NET LOT AREA PROPOSED LANDSCAPE	<u>12,261</u> S <u>18,118</u> S
REQUIRED PARKING LOT TREES 1 TREE PER 10 PARKING SPACES PROPOSED PARKING LOT TREES	6 6
REQUIRED VEGETATION COVERAGE 75% OF LANDSCAPE AREA PROPOSED VEGETATION COVERAGE	9,196 S 43,446 S
REQUIRED GROUND-LEVEL PLANTS CO	OVERAGE

NOTE

MAINTENANCE OF LANDSCAPE PROVIDED BY OWNER

PLANTINGS TO BE WATERED BY AUTO. DRIP IRRIGATION SYSTEM WITH REDUCED PRESSURE BACKFLOW PREVENTER PER CITY OF ALBUQUERQUE

WATER MANAGEMENT IS THE SOLE RESPONSIBILITY OF THE PROPERTY OWNER

THIS PLAN IS TO COMPLY WITH THE CITY
OF ALBUQUERQUE LANDSCAPING ORDINANCE
LANDSCAPE AREAS TO BE MULCHED WITH GRAVEL

MULCH AT 3" DEPTH OVER FILTER FABRIC

GENERAL NOTES

- 1. IN CASE OF DISCREPANCIES IN PLANT QUANTITIES SHOWN ON THE PLANT SCHEDULE AND THOSE SHOWN ON THE PLAN, THE QUANTITIES SHOWN ON THE PLAN SHALL PREVAIL. CONTRACTOR SHALL VERIFY ALL QUANTITIES PRIOR TO BID AND INSTALLATION.
- 2. POSITIVE DRAINAGE AWAY FROM ALL STRUCTURES IS TO REMAIN AFTER ALL LANDSCAPE WORK IS COMPLETED.
- 3. ALL MAINTENANCE FOR LANDSCAPE AND IRRIGATION SYSTEMS SHALL BE PROVIDED BY OWNER. MAINTENANCE OF STREET TREES AND SHRUBS SHALL FIND THEM IN HEALTHY, LIVING, AND ATTRACTIVE CONDITION.
- 4. ALL ON-SITE PLANT MATERIAL, NOW AND EXISTING, SHALL BE IRRIGATED BY COMPLETE, AUTOMATIC DRIP IRRIGATION WITH SUBTERRANEAN LATERALS. EMITTERS SHALL BE PLACED AT EVEN SPACING AT DRIP LINE OF TREES AND SHRUBS AT THE MULCH'S SURFACE AT A RATE OF SIX (6) 2.0 GPH EMITTERS PER TREE AND TWO (2) 2.0 GPH EMITTERS PER SHRUB.
- 5. WATER MANAGEMENT IS THE SOLE RESPONSIBILITY OF THE PROPERTY OWNER. APPROPRIATE MEASURES HAVE BEEN TAKEN TO DESIGN AND INSTALL A WATER-CONSERVATIVE, ENVIRONMENTALLY SOUND LANDSCAPE.
- 6. LANDSCAPING BEDS MUST BE DEPRESSED BELOW GRADE PURSUANT TO 5-6(C)(13)(B).

PLANT SCHEDULE

QTY	BOTANICAL / COMMON NAME	<u>SIZE</u>	<u>H X W</u>	<u>COVERAGE</u>
7	EXISTING TREE TO REMAIN	VARIES		
3	ulmus parvifolia 'allee' TM / allee lacebark elm	2" B&B	50' X 30'	707X3=2121
QTY	BOTANICAL / COMMON NAME	SIZE	H X W	<u>COVERAGE</u>
5	CHILOPSIS LINEARIS / DESERT WILLOW	2" B&B	20' X 25'	491X5=2455
5	FRAXINUS OXYCARPA 'RAYWOOD' TM / RAYWOOD ASH	2" B&B	60' X 60'	2826X5=14130
4	PISTACIA CHINENSIS / CHINESE PISTACHE	2" B&B	60' X 60'	2826X4=11304
3	POPULUS DELTOIDES WISLIZENII / RIO GRANDE COTTONWOOD	2" B&B	50' X 50'	1963X3=5889
5	PYRUS CALLERYANA 'CLEVELAND SELECT' / CLEVELAND SELECT PEAR	2" B&B	25' X 15'	177X5=885
1	QUERCUS BUCKLEYI / BUCKLEY OAK	2" B&B	50' X 50'	1963X1=1963
QTY	BOTANICAL / COMMON NAME	<u>SIZE</u>	<u>H X W</u>	<u>COVERAGE</u>
6	PINUS CEMBROIDES EDULIS / PINYON PINE	6'	30' X 20'	314X6=1884
2	PINUS EDULIS / PINYON PINE			177X2=354
QTY	BOTANICAL / COMMON NAME	SIZE	<u>HXW</u>	40,985 sf COVERAGE
7	HESPERALOE PARVIFLORA / RED YUCCA	5 GAL	3' × 4'	13X7=91
QTY	BOTANICAL / COMMON NAME	<u>SIZE</u>	<u>HXW</u>	<u>COVERAGE</u>
41	CALAMAGROSTIS X ACUTIFLORA 'KARL FOERSTER' / FEATHER REED GRASS	1 GAL	30" X 2'	3X41=123
31	MUHLENBERGIA CAPILLARIS 'REGAL MIST' TM / MUHLY	1 GAL	3' X 3'	7X31=217
69	NASSELLA TENUISSIMA / MEXICAN FEATHERGRASS	1 GAL	2' X 2'	3X69=207
5	SCHIZACHYRIUM SCOPARIUM / LITTLE BLUESTEM GRASS	1 GAL	2' X 2'	3X5=15
28	SORGHASTRUM NUTANS / INDIAN GRASS	1 GAL	4' × 2'	3X28=84
QTY	BOTANICAL / COMMON NAME	<u>SIZE</u>	<u>HXW</u>	<u>COVERAGE</u>
31	RHUS AROMATICA 'GRO-LOW' / GRO-LOW FRAGRANT SUMAC	5 GAL	4' × 4'	13X31=403
QTY	BOTANICAL / COMMON NAME	<u>SIZE</u>	<u>HXW</u>	<u>COVERAGE</u>
34	ARTEMISIA FILIFOLIA / SAND SAGEBRUSH	5 GAL	4' × 4'	13X34=442
11	CERCOCARPUS INTRICATUS / LITTLE LEAF MOUNTAIN MAHOGONY	5 GAL	6' X 6'	28X11=308
2	COTONEASTER PARNEYI / COTONEASTER	5 GAL	10' X 15'	177X2=354
31	EUPHORBIA RIGIDA / YELLOW SPURGE	1 GAL	2' × 3'	7X31=217
	7 3 QTY 5 4 3 5 1 QTY 6 2 QTY 7 QTY 41 31 69 5 28 QTY 31 QTY 31 21 31 21	DIVERSING TREE TO REMAIN ULMUS PARVIFOLIA "ALLES" TW / ALLES LACEBARK ELM CHILOPSIS LINEARS / DESERT WILLOW FRAXINUS OXYCARPA "RAYWOOD" TM / RAYWOOD ASH PISTACIA CHINENSIS / CHINESE PISTACHE POPULUS DELITIDES WISHZENIL / RIG GRANGE COTTONWOOD PYRUS CALLERYANA "CLEVELAND SELECT" / CLEVELAND SELECT PEAR ULMUS CEMBROIDES EQUI S / PINYON PINE PINUS EDJAIS / RIKYON PINE BOTANICAL / COMMON NAME CALAWAGROSTIS X ACUTIFLORA "KASL FOERSTER" / FEATHER REED GRASS MUHLENBERGIA CAPILLAR'S "REGAL VIST" TV / MUHLY MASSELLA TENUISSIMA / MEXICAN FEATHERGRASS SCHIZAGHYNIUM SCOPARIUM / LITTLE BLUESTEM GRASS SCHIZAGHYNIUM SCOPARIUM / LITTLE BLUESTEM GRASS SCHIZAGHYNIUM SCOPARIUM / LITTLE BLUESTEM GRASS RIUS AROVATICA "GRO-LOW PRAGBANT SUMAC PINUS AROVATICA "GRO-LOW PRAGBANT SUMAC PINUS AROVATICA "GRO-LOW PRAGBRUSH CERCOCARFUS INTRICATUS / LITTLE LEAF MOUNTAIN VAHOGONY COTONEASTER PARNEY! / COTONEASTER	7 FXISTING TREE TO REMAIN 27 BASH 3 U.M.S. PARV FOLIA "ALLEFT TM / ALLEF LACEBARK FLM 27 BASH 9TY BOTANICAL / COMMON NAME 527 5 CHILDESIS LINEARIS / DESERT WILLOW 27 BASH 5 PRAXINUS OXYCARPA "RAYWOOD" IM / RAYWOOD ASH 27 BASH 3 POPULUS DELICIDES WISLZENT / RIO GRANDE COTTONWOOD 27 BASH 3 POPULUS DELICIDES WISLZENT / RIO GRANDE COTTONWOOD 27 BASH 6 PYRUS CALLERYANA "CLEVELAND SELECT" / CLEVELAND SELECT TEAR 27 BASH 1 OJERCUS PUCKLEYL / EUCKLEY DAK 27 BASH 0TM EOTANICAL / COMMON NAME 932E 2 PINUS CEMBRIC DES EDULS / PINYON PINE 6* 4 PINUS CEMBRIC DES EDULS / PINYON PINE 6* 5 PINUS CEMBRIC DES EDULS / PINYON PINE 6* 6 PINUS CEMBRIC DES EDULS / PINYON PINE 6* 1 COTANICAL / COMMON NAME 932E 7 ECTANICAL / COMMON NAME 932E 1 CAL 1 CAL 3 CALILARES TREGAL MIST TM / MUFLLY 1 CAL	PROBLEM PROPORTION PROPOR


MATERIAL SCHEDULE


SYMBOL DESCRIPTION

MOUNTAINAIR BROWN 7/8" GRAVEL OVER FILTER FABRIC




2-4" BLUE SAIS OVER FILTER FABRIC

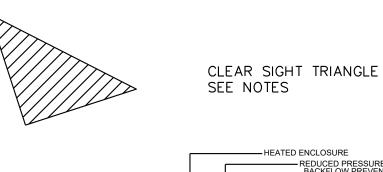

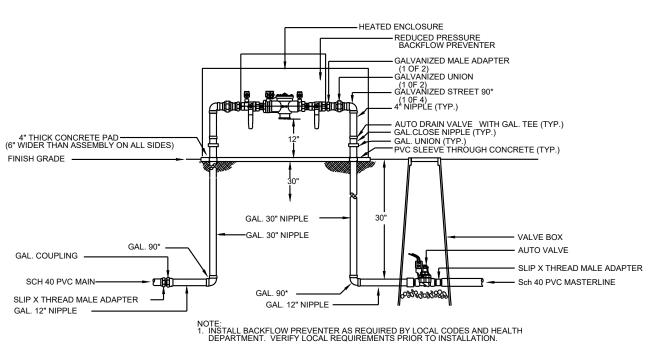

RP BACKFLOW/MASTER VALVE DETAIL

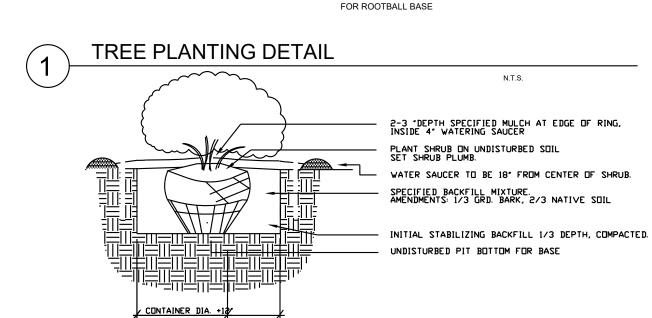

LEADER LEFT UNPRUNED

RUBBING, CROSSED OR

DAMAGED BRANCHES ARE REMOVED

- TRUNK PROTECTED BY LOOSE TREE GUARD, REMOVED AFTER ONE YEAR

— 2/3 NATIVE SOIL AND 1/3 CWA SCREENED BARK MULCH TO BE USED AS BACKFILL

PLANTING HOLE 2-3 TIMES ROOT BALL

WIDTH, DEPTH SAME AS ROOT BALL

 2"-3" DEPTH ORGANIC MULCH APPLIED WELL AWAY FROM TRUNK

OF BURLAP AND WIRE BASKET

REMOVED, BURLAP SLIT FOR ROOT EXTENSION

-UNDISTURBED PIT BOTTOM

(NO BLACK PLASTIC)

SHRUB PLANTING DETAIL

YELLOWSTONE

LANDSCAPE

www.yellowstonelandscape.com
POBox10597
Albuquerque, NM 87184
505.898.9615
design@yellowstonelandscape.com



Date: <u>5/3/21</u>

Revisions:


5/26/2021
6/30/2021

7/2/2021 7/29/2021 10/5/2021 11/17/2021


Drawn by: <u>PL</u> Reviewed by: <u>CM</u>

Reviewed by: CIVI

3615 NM HWY 528 Albudierale New Mexico

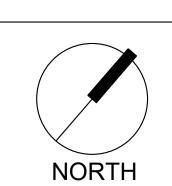

Scale: 1" = 30'

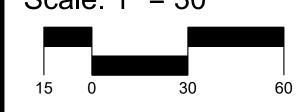


Sheet Title:

Landscape Plan

Sheet Number:

LS-01

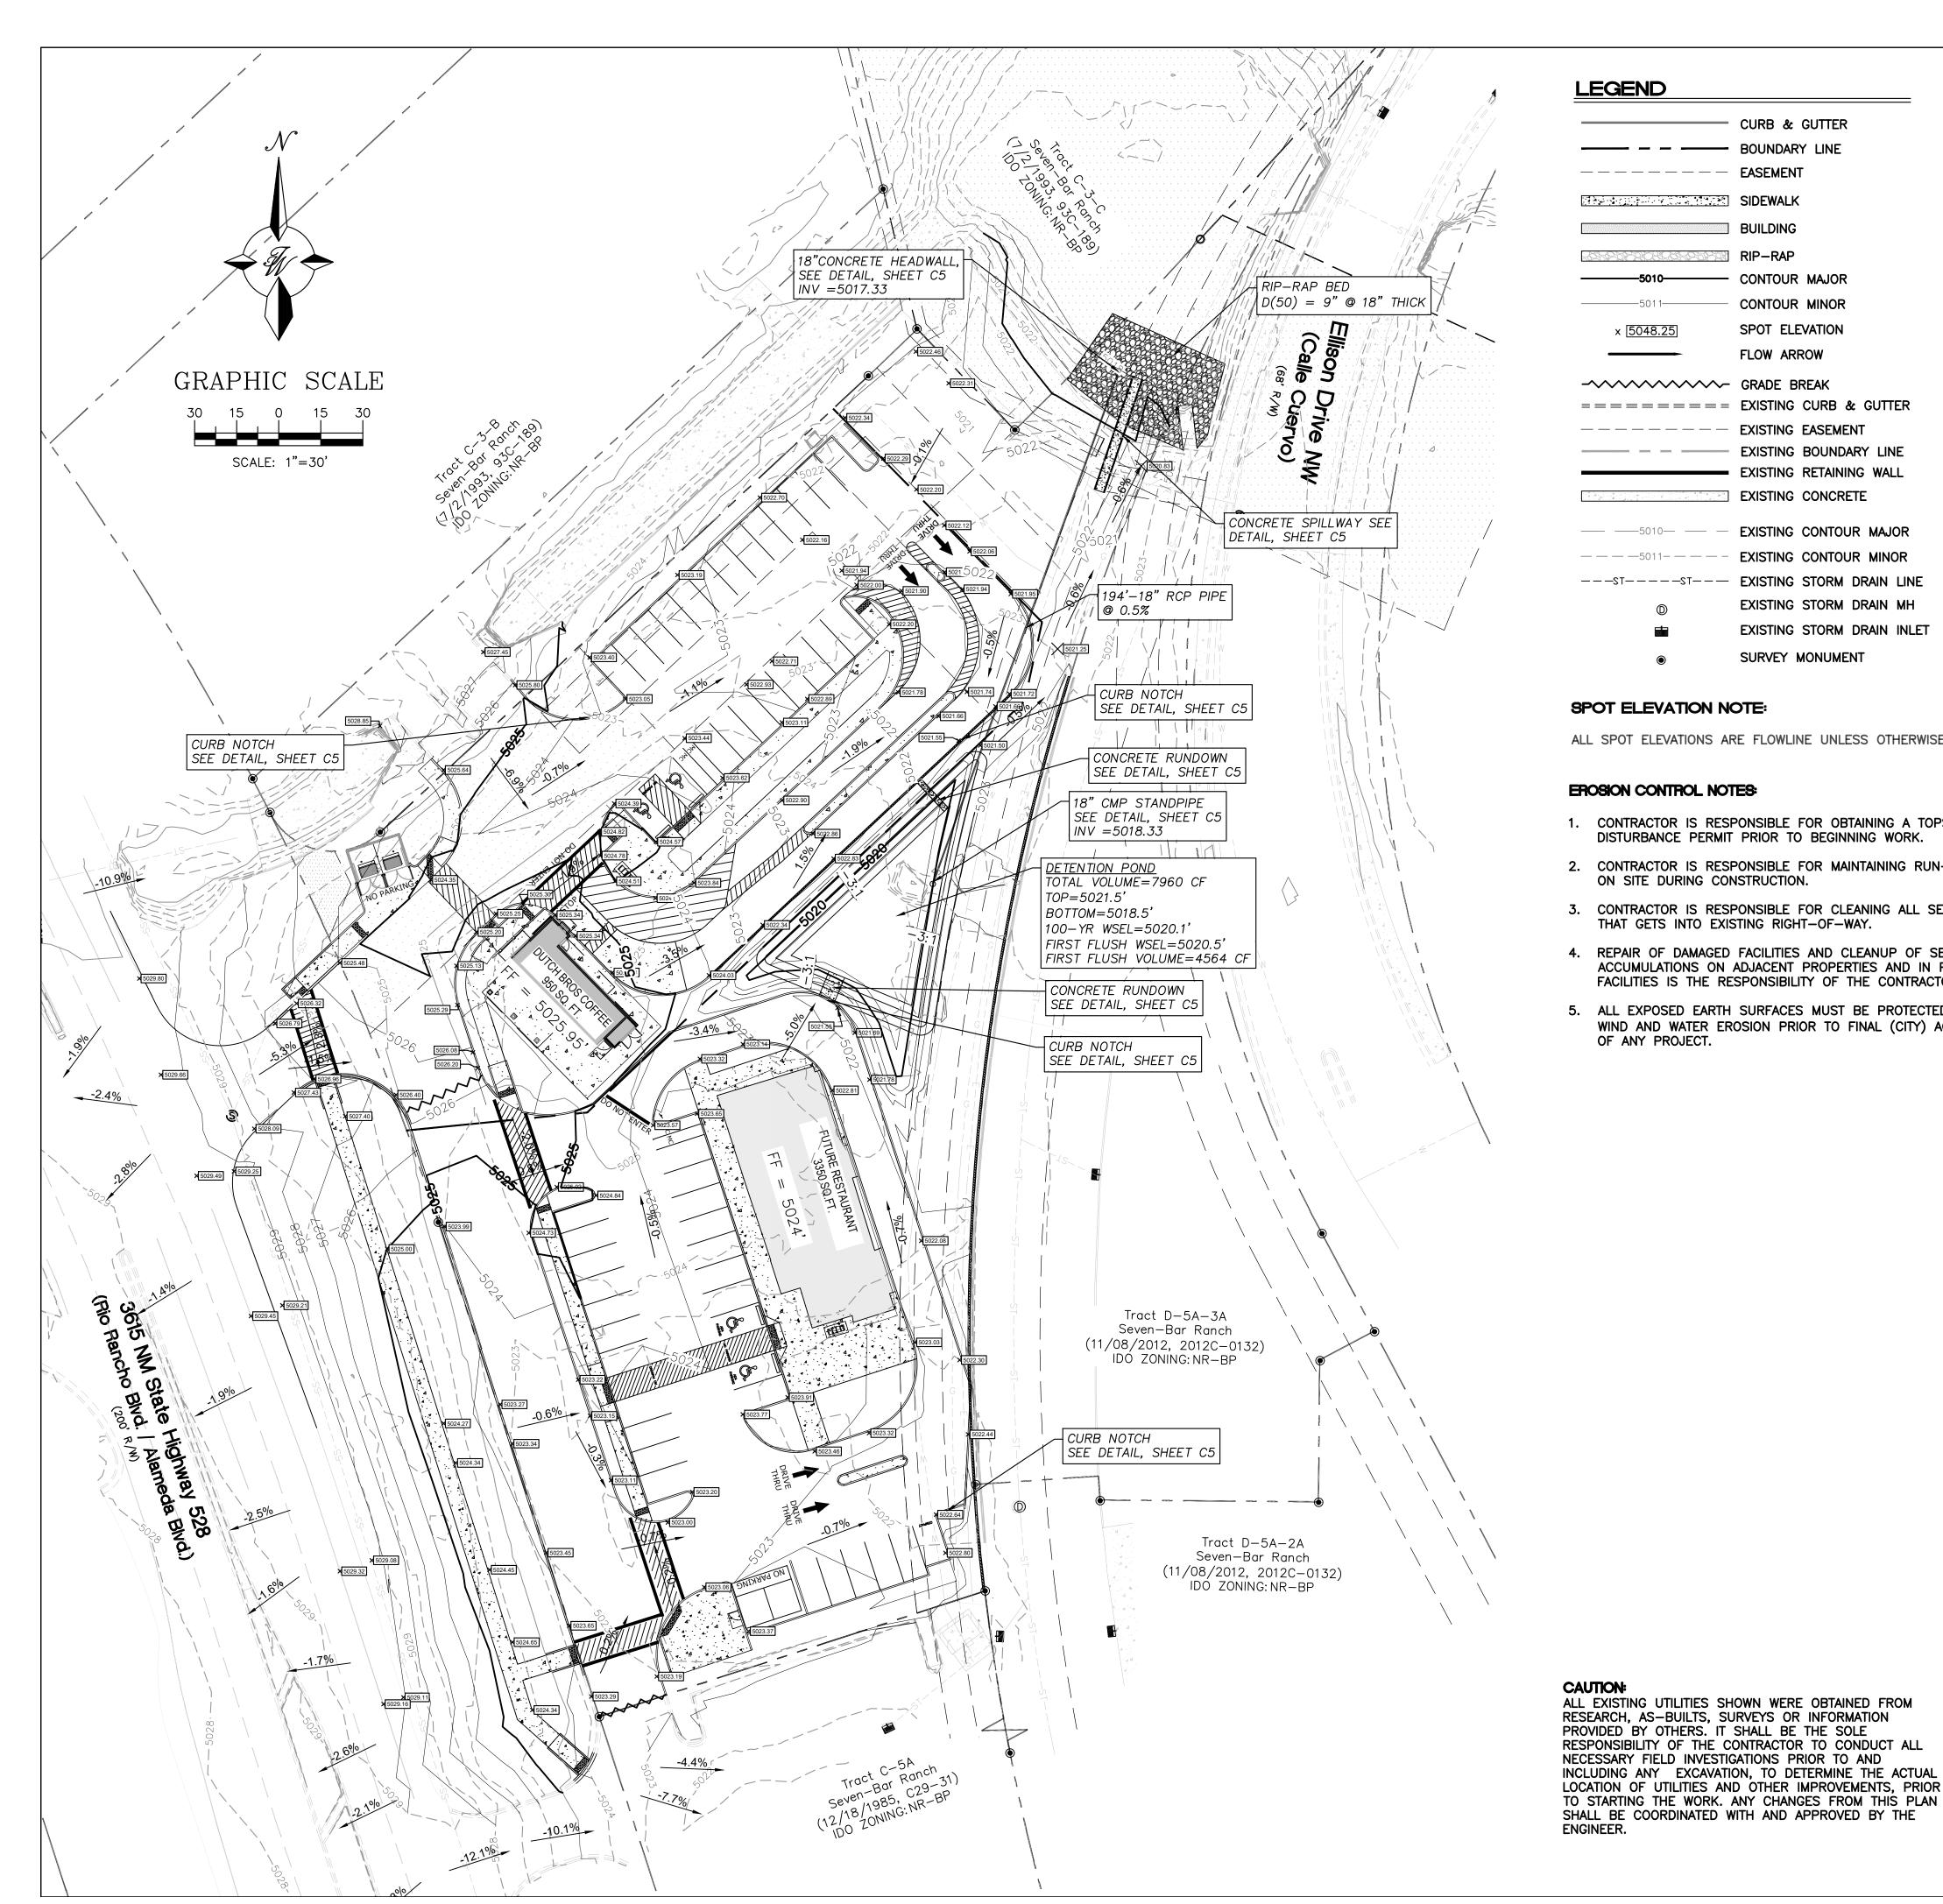

LEGEND

CURB & GUTTER BOUNDARY LINE SIDEWALK BUILDING RIP-RAP CONTOUR MAJOR CONTOUR MINOR SPOT ELEVATION FLOW ARROW ->>>> GRADE BREAK ======= EXISTING CURB & GUTTER ---- EXISTING EASEMENT EXISTING BOUNDARY LINE EXISTING RETAINING WALL EXISTING CONCRETE ----- EXISTING CONTOUR MINOR ---st---- Existing Storm Drain Line EXISTING STORM DRAIN MH EXISTING STORM DRAIN INLET


SPOT ELEVATION NOTE:

ALL SPOT ELEVATIONS ARE FLOWLINE UNLESS OTHERWISE NOTED.

SURVEY MONUMENT

EROSION CONTROL NOTES:

- 1. CONTRACTOR IS RESPONSIBLE FOR OBTAINING A TOPSOIL DISTURBANCE PERMIT PRIOR TO BEGINNING WORK.
- 2. CONTRACTOR IS RESPONSIBLE FOR MAINTAINING RUN-OFF ON SITE DURING CONSTRUCTION.
- 3. CONTRACTOR IS RESPONSIBLE FOR CLEANING ALL SEDIMENT THAT GETS INTO EXISTING RIGHT-OF-WAY.
- 4. REPAIR OF DAMAGED FACILITIES AND CLEANUP OF SEDIMENT ACCUMULATIONS ON ADJACENT PROPERTIES AND IN PUBLIC FACILITIES IS THE RESPONSIBILITY OF THE CONTRACTOR.
- 5. ALL EXPOSED EARTH SURFACES MUST BE PROTECTED FROM WIND AND WATER EROSION PRIOR TO FINAL (CITY) ACCEPTANCE OF ANY PROJECT.

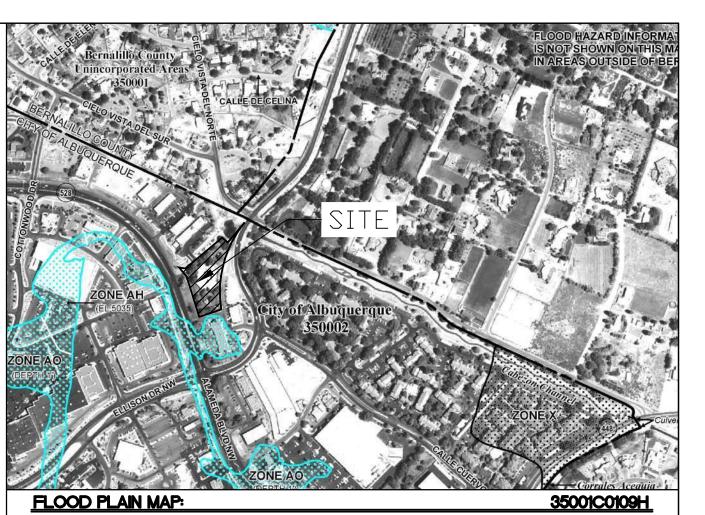

SITE INFORMATION

THE PROPOSED DEVELOPMENT IS A 1.99 ACRE MULTI-PAD COMMERCIAL DEVELOPMENT PROJECT, LOCATED AT 3615 HWY 528 ALBUQUERQUE, NM 87114. THE PROPOSED DEVELOPMENT IS LOCATED IN PRECIPITATION ZONE 1, WEST OF THE RIO GRANDE RIVER AS SPECIFIED IN THE DEVELOPMENT PROCESS MANUEL CH. 6. THE PROJECT SITE IS LOCATED WITHIN SAD 223, WHERE DRAINAGE IS COLLECTED FROM A LARGE AREA AROUND THE COTTONWOOD MALL. THE PROJECT SITE PREVIOUSLY CONTAINED A TWO STORY OFFICE BUILDING WHICH HAS SINCE BEEN DEMOLISHED AND REMOVED. THE PROJECT SITE HAS BEEN PREVIOUSLY GRADED AND IS PARTLY PAVED. THE SITE IS BORDERED BY A VARIETY OF COMMERCIAL AND RESIDENTIAL ZONE DISTRICTS. TO THE SOUTH LAYS THE INTERSECTION OF NM-528 AND ELLISON DR. TO THE NORTH THE SITE IS BORDERED BY AN AMAFCA DRAINAGE CHANNEL AND A DE-SILTING POND. THE PROPOSED SITE LIES WITHIN HYDROLOGY NUMBER A14D019 AND DOES NOT CONTAIN A FLOOD PLAIN.

EXISTING CONDITIONS

THE SITE IS CURRENTLY PARTLY PAVED WHICH INCLUDES ACCESS AISLES AND PARKING ON THE SOUTH SIDE OF THE PROPERTY. THE REMAINDER OF THE LOT REMAINS VACANT WITH GROWING VEGETATION. BASED ON THE TOPOGRAPHY, RUNOFF SURFACE FLOWS NORTH-EAST AND DISCHARGES INTO THE AMAFCA DE-SILTING POND VIA AN EXISTING ROCK SWALE, LOCATED ON THE SOUTH-EAST SIDE OF THE DE-SILTING POND. CROSS LOT DRAINAGE FROM THE NEIGHBORING LOTS IS REDUCED DUE TO EXISTING RETAINING WALLS AND CURBING ALONG THE SOUTH, EASTERN AND NORTHERN PROPERTY LINE. OFFSITE DRAINAGE FROM A PORTION OF HWY NM-528'S RIGHT OF WAY FLOWS EAST INTO THE SUBJECT PROPERTY AND IS TAKEN INTO CONSIDERATION.

PROPOSED CONDITIONS

THE CONCEPTUAL GRADING AND DRAINAGE REPORT AND PLAN FOR THIS SITE HAS BEEN PREVIOUSLY APPROVED BY HYDROLOGY UNDER HYDRO NUMBER A14D019. THE DEVELOPED FLOWS WILL SURFACE FLOW INTO A DETENTION POND LOCATED ON THE EASTERN SIDE OF THE PROJECT SITE. THE DETENTION POND IS DESIGNED TO RETAIN THE FIRST 0.62 INCHES OF RUNOFF. ANY FLOWS BEYOND THAT WILL BE CONVEYED INTO AN UNDERGROUND STORM DRAIN PIPE. WHICH OUTFALLS INTO THE AMAFCA DE-SILTING POND NORTH OF THE SITE. IN AN EMERGENCY SITUATION, AS THE POND REACHES MAXIMUM CAPACITY THE STORM WATER RUNOFF WILL BE ROUTED INTO AN EMERGENCY SPILLWAY WHICH DRAINS INTO THE AMAFCA DE-SILTING POND. THE EMERGENCY SPILLWAY IS A CONCRETE RUNDOWN LOCATED SOUTH-EAST OF THE DE-SILTING POND.

NOTICE TO CONTRACTORS

- 1. AN EXCAVATION/CONSTRUCTION PERMIT WILL BE REQUIRED BEFORE BEGINNING ANY WORK WITHIN CITY RIGHT-OF-WAY.
- 2. ALL WORK DETAILED ON THESE PLANS TO BE PERFORMED. EXCEPT AS OTHERWISE STATED OR PROVIDED HERON, SHALL BE CONSTRUCTED IN ACCORDANCE WITH CITY OF ALBUQUERQUE INTERIM STANDARD SPECIFICATIONS FOR PUBLIC WORKS CONSTRUCTION, 1985.
- 3. TWO WORKING DAYS PRIOR TO ANY EXCAVATION, THE CONTRACTOR MUST CONTACT NEW MEXICO ONE CALL, DIAL "811" [OR (505) 260-1990] FOR THE LOCATION OF EXISTING UTILITIES.
- 4. PRIOR TO CONSTRUCTION, THE CONTRACTOR SHALL EXCAVATE AND VERIFY THE HORIZONTAL AND VERTICAL LOCATIONS OF ALL CONNECTIONS. SHOULD A CONFLICT EXIST, THE CONTRACTOR SHALL
- 5. NOTIFY THE ENGINEER SO THAT THE CONFLICT CAN BE RESOLVED WITH A MINIMUM AMOUNT OF DELAY.
- 6. BACKFILL COMPACTION SHALL BE ACCORDING TO TRAFFIC/STREET USE.
- 7. MAINTENANCE OF THESE FACILITIES SHALL BE THE RESPONSIBILITY OF OWNER OF THE PROPERTY SERVED.
- 8. WORK ON ARTERIAL STREETS SHALL BE PERFORMED ON A 24-HOUR BASIS.


ENGINEER'S SEAL 11/17/202

NM 528 AND ELLISON DRAWN BY LN 3615 HWY 528 DATE 11/17/2021 CONCEPT GRADING DRAWING AND DRAINAGE PLAN 2014069-GRD SHEET # TIERRA WEST, LLC 5571 MIDWAY PARK PL NE

NOT FOR CONSTRUCTION

ALBUQUERQUE, NEW MEXICO 87109 (505) 858-3100 RONALD R. BOHANNAN www.tierrawestllc.com P.E. #7868

JOB # 2020091

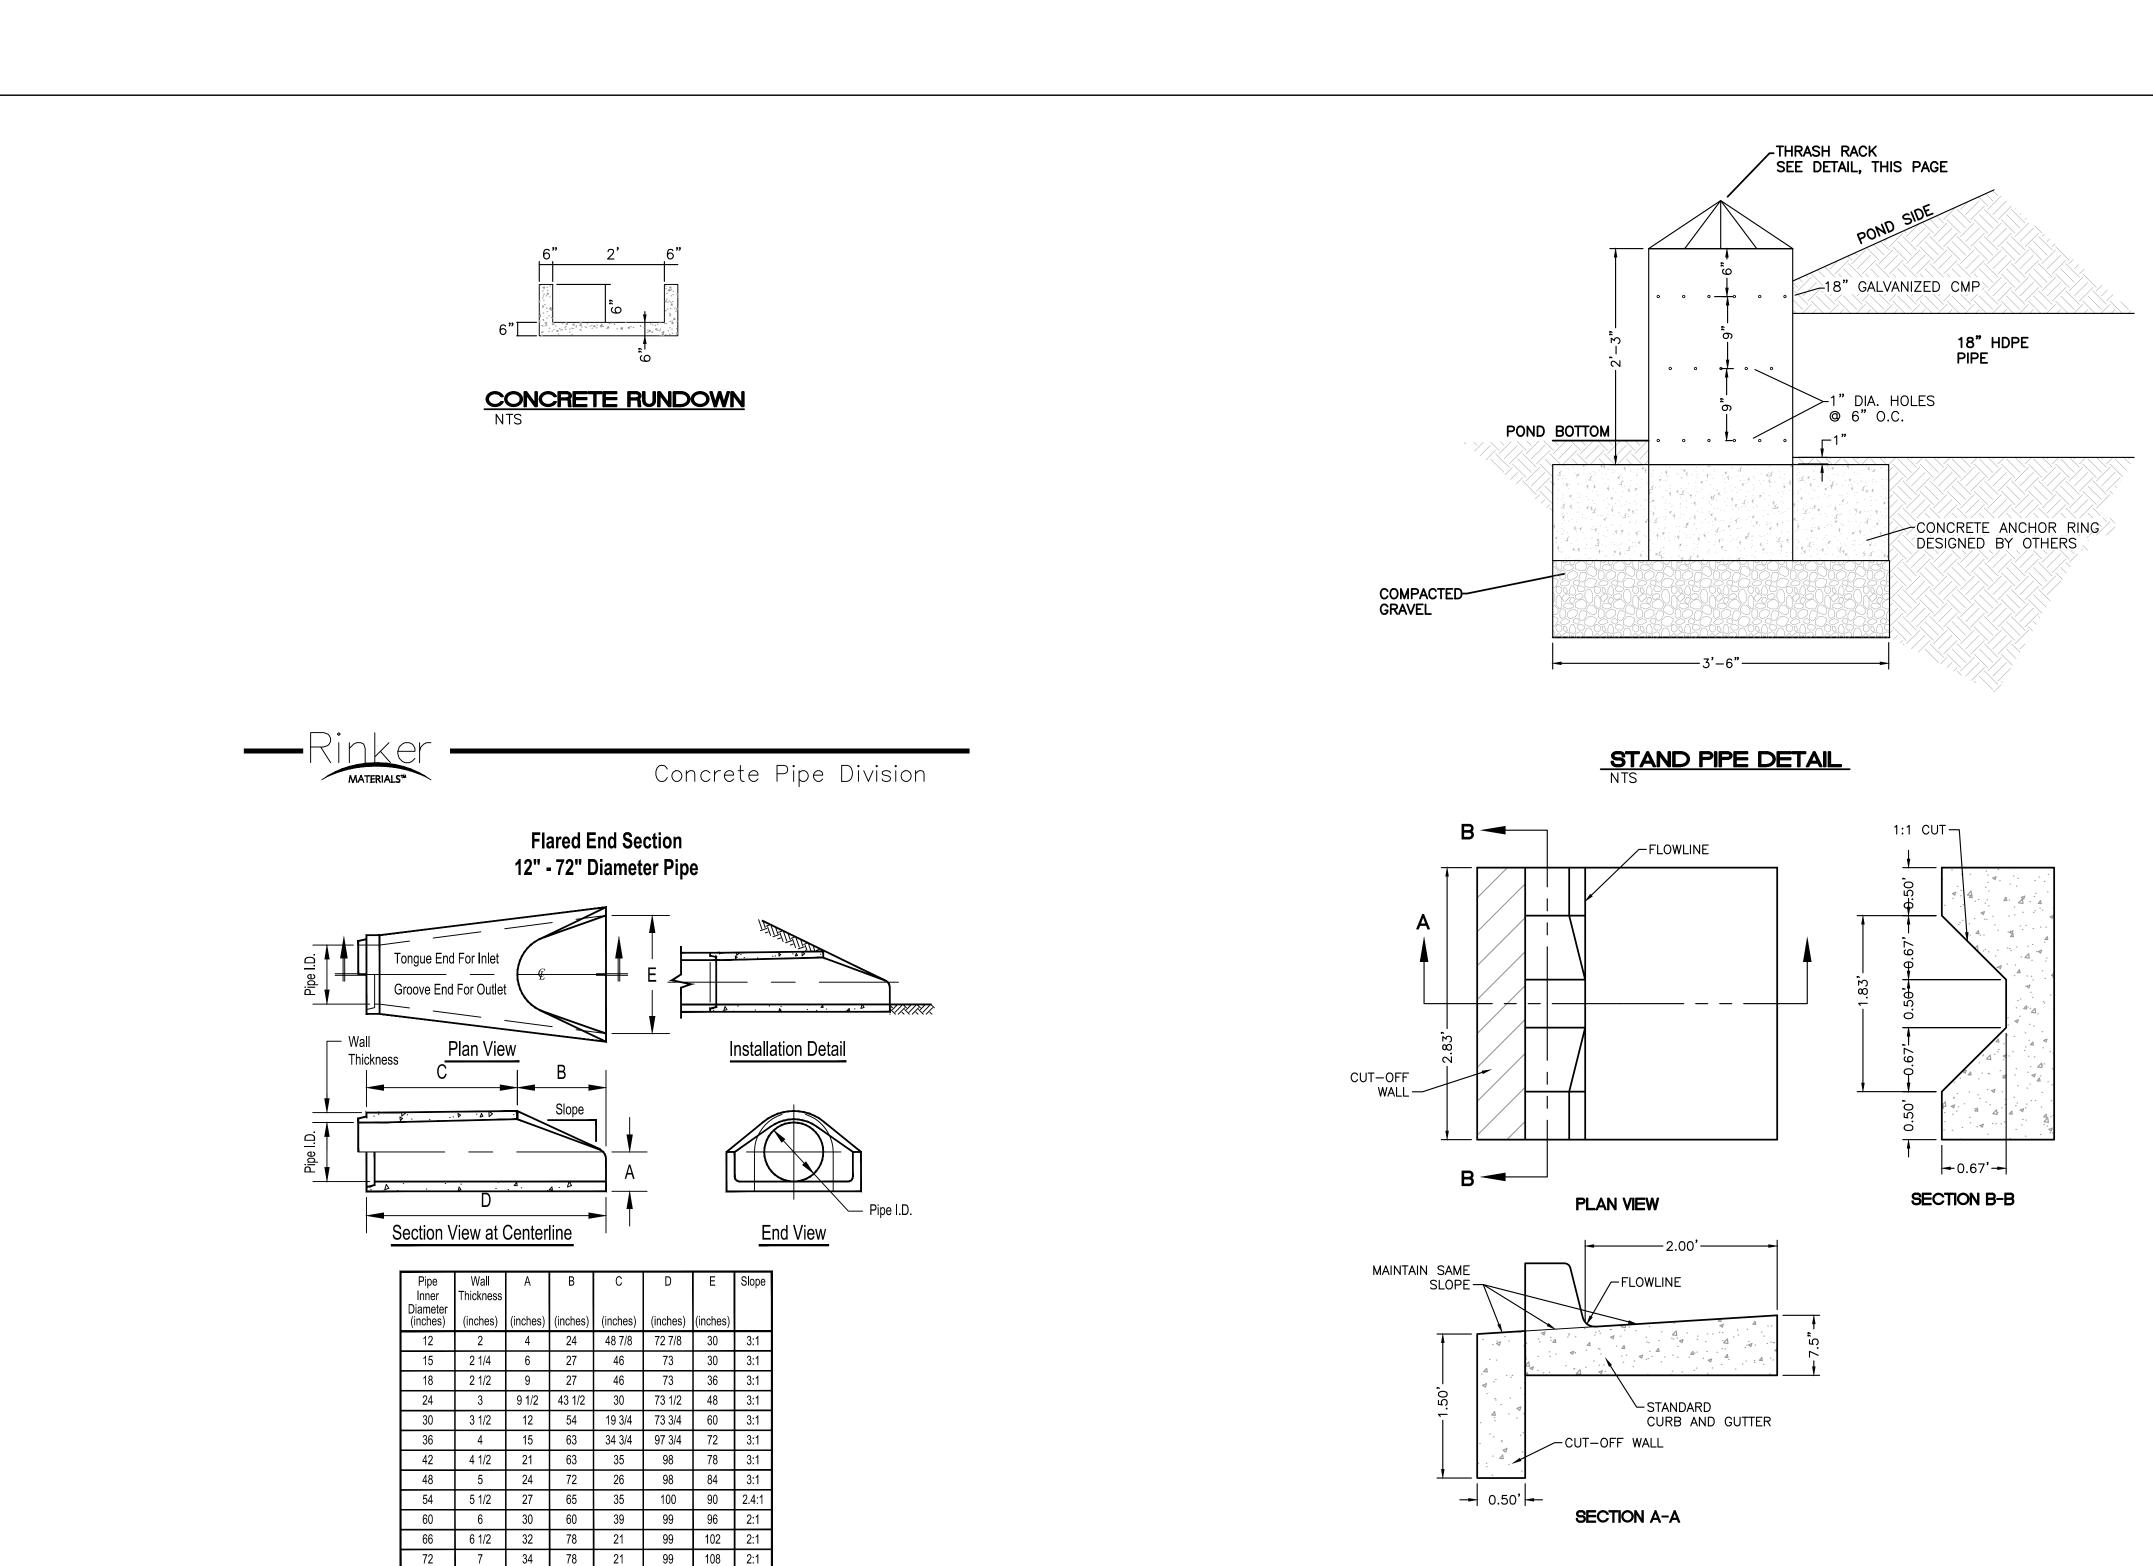

Rinker 024

KEYWAY DETAIL

Dimensions may vary depending upon equipment availability.

2. Contact a Concrete Pipe Division representative for details not listed on this sheet.

CONCRETE FLARED END SECTION DETAIL

-SEE NOTE 3

TYPE A


1. Produced to meet ASTM specifications.

-ALSO SEE NOTE 6

 $2\frac{1}{2}$ " CLEAR \rightarrow


SYMMETRICAL ABOUT CL-

CURB NOTCH DETAIL

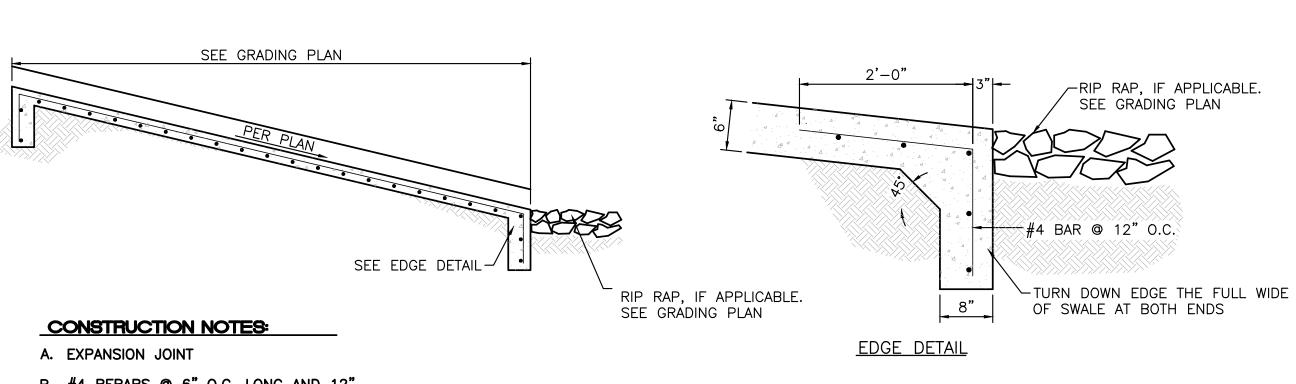

- B. #4 REBARS @ 6" O.C. LONG AND 12" O.C. TRANSVERSE
- C. 6" COMPACTED SOIL 95% ASTM D 1557
- D. WIDTH OF CHANNEL = 3"
- E. KEYED CONSTRUCTION JOINT

CONCRETE SPILLWAY NTS

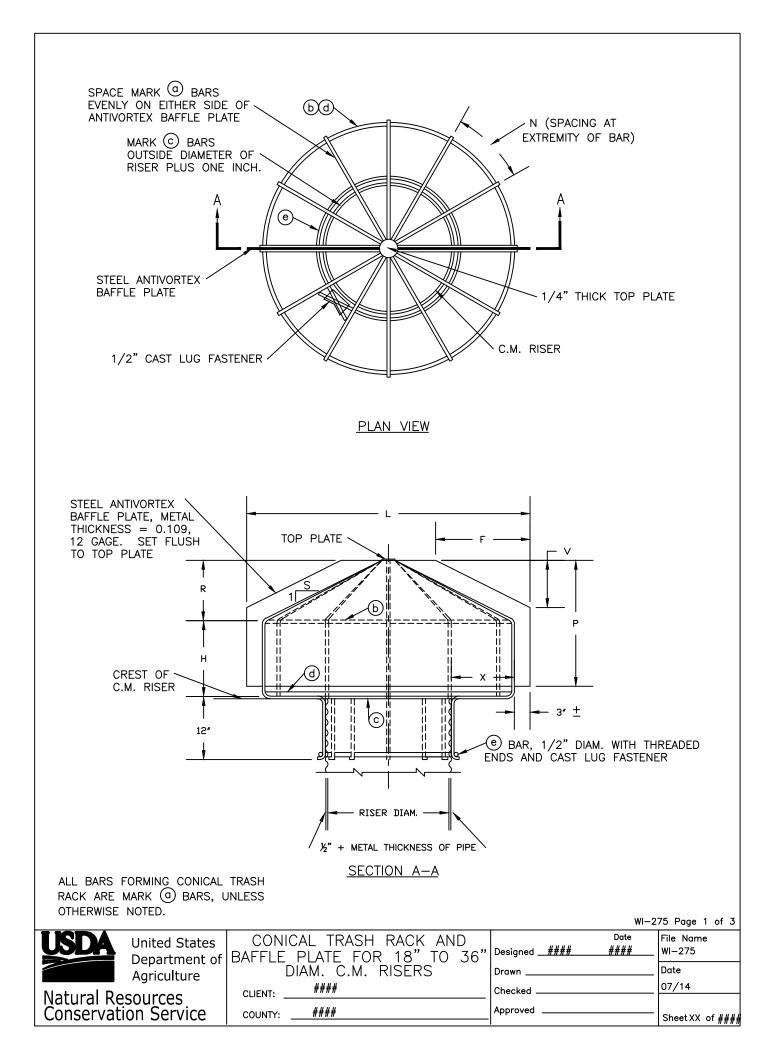


THRASH RACK

GENERAL NOTES:

- CHANNEL DEPTHS EXCEEDING 2' WILL REQUIRE SEPARATE DESIGN FOR FLOOR AND WALLS.
- 2. TYPE B LINING WILL BE USED ONLY WHERE NO UTILITIES ARE LOCATED OR PROPOSED.
- 3. UP TO 16' WIDTH USE 4" INVERTED CROWN. 16' WIDTH AND OVER USE 6" INVERTED CROWN.
- 4. WARNING: THESE WALLS ARE NOT DESIGNED TO SUPPORT THE ADDITION OF GARDEN OR RETAINING TYPE WALLS.
- 5. THE OUTSIDE OF DRAINAGE WALLS SHALL NOT EXTEND BEYOND EASEMENT LINES OR ROW LINES.
- 6. 6" CONC. BLOCK WITH CORES FILLED WITH CONC. AND #4 BARS INSERTED INTO CORES AT 1'-6" O.C. MAY BE SUBSTITUTED FOR FORMED CONC. WALLS.



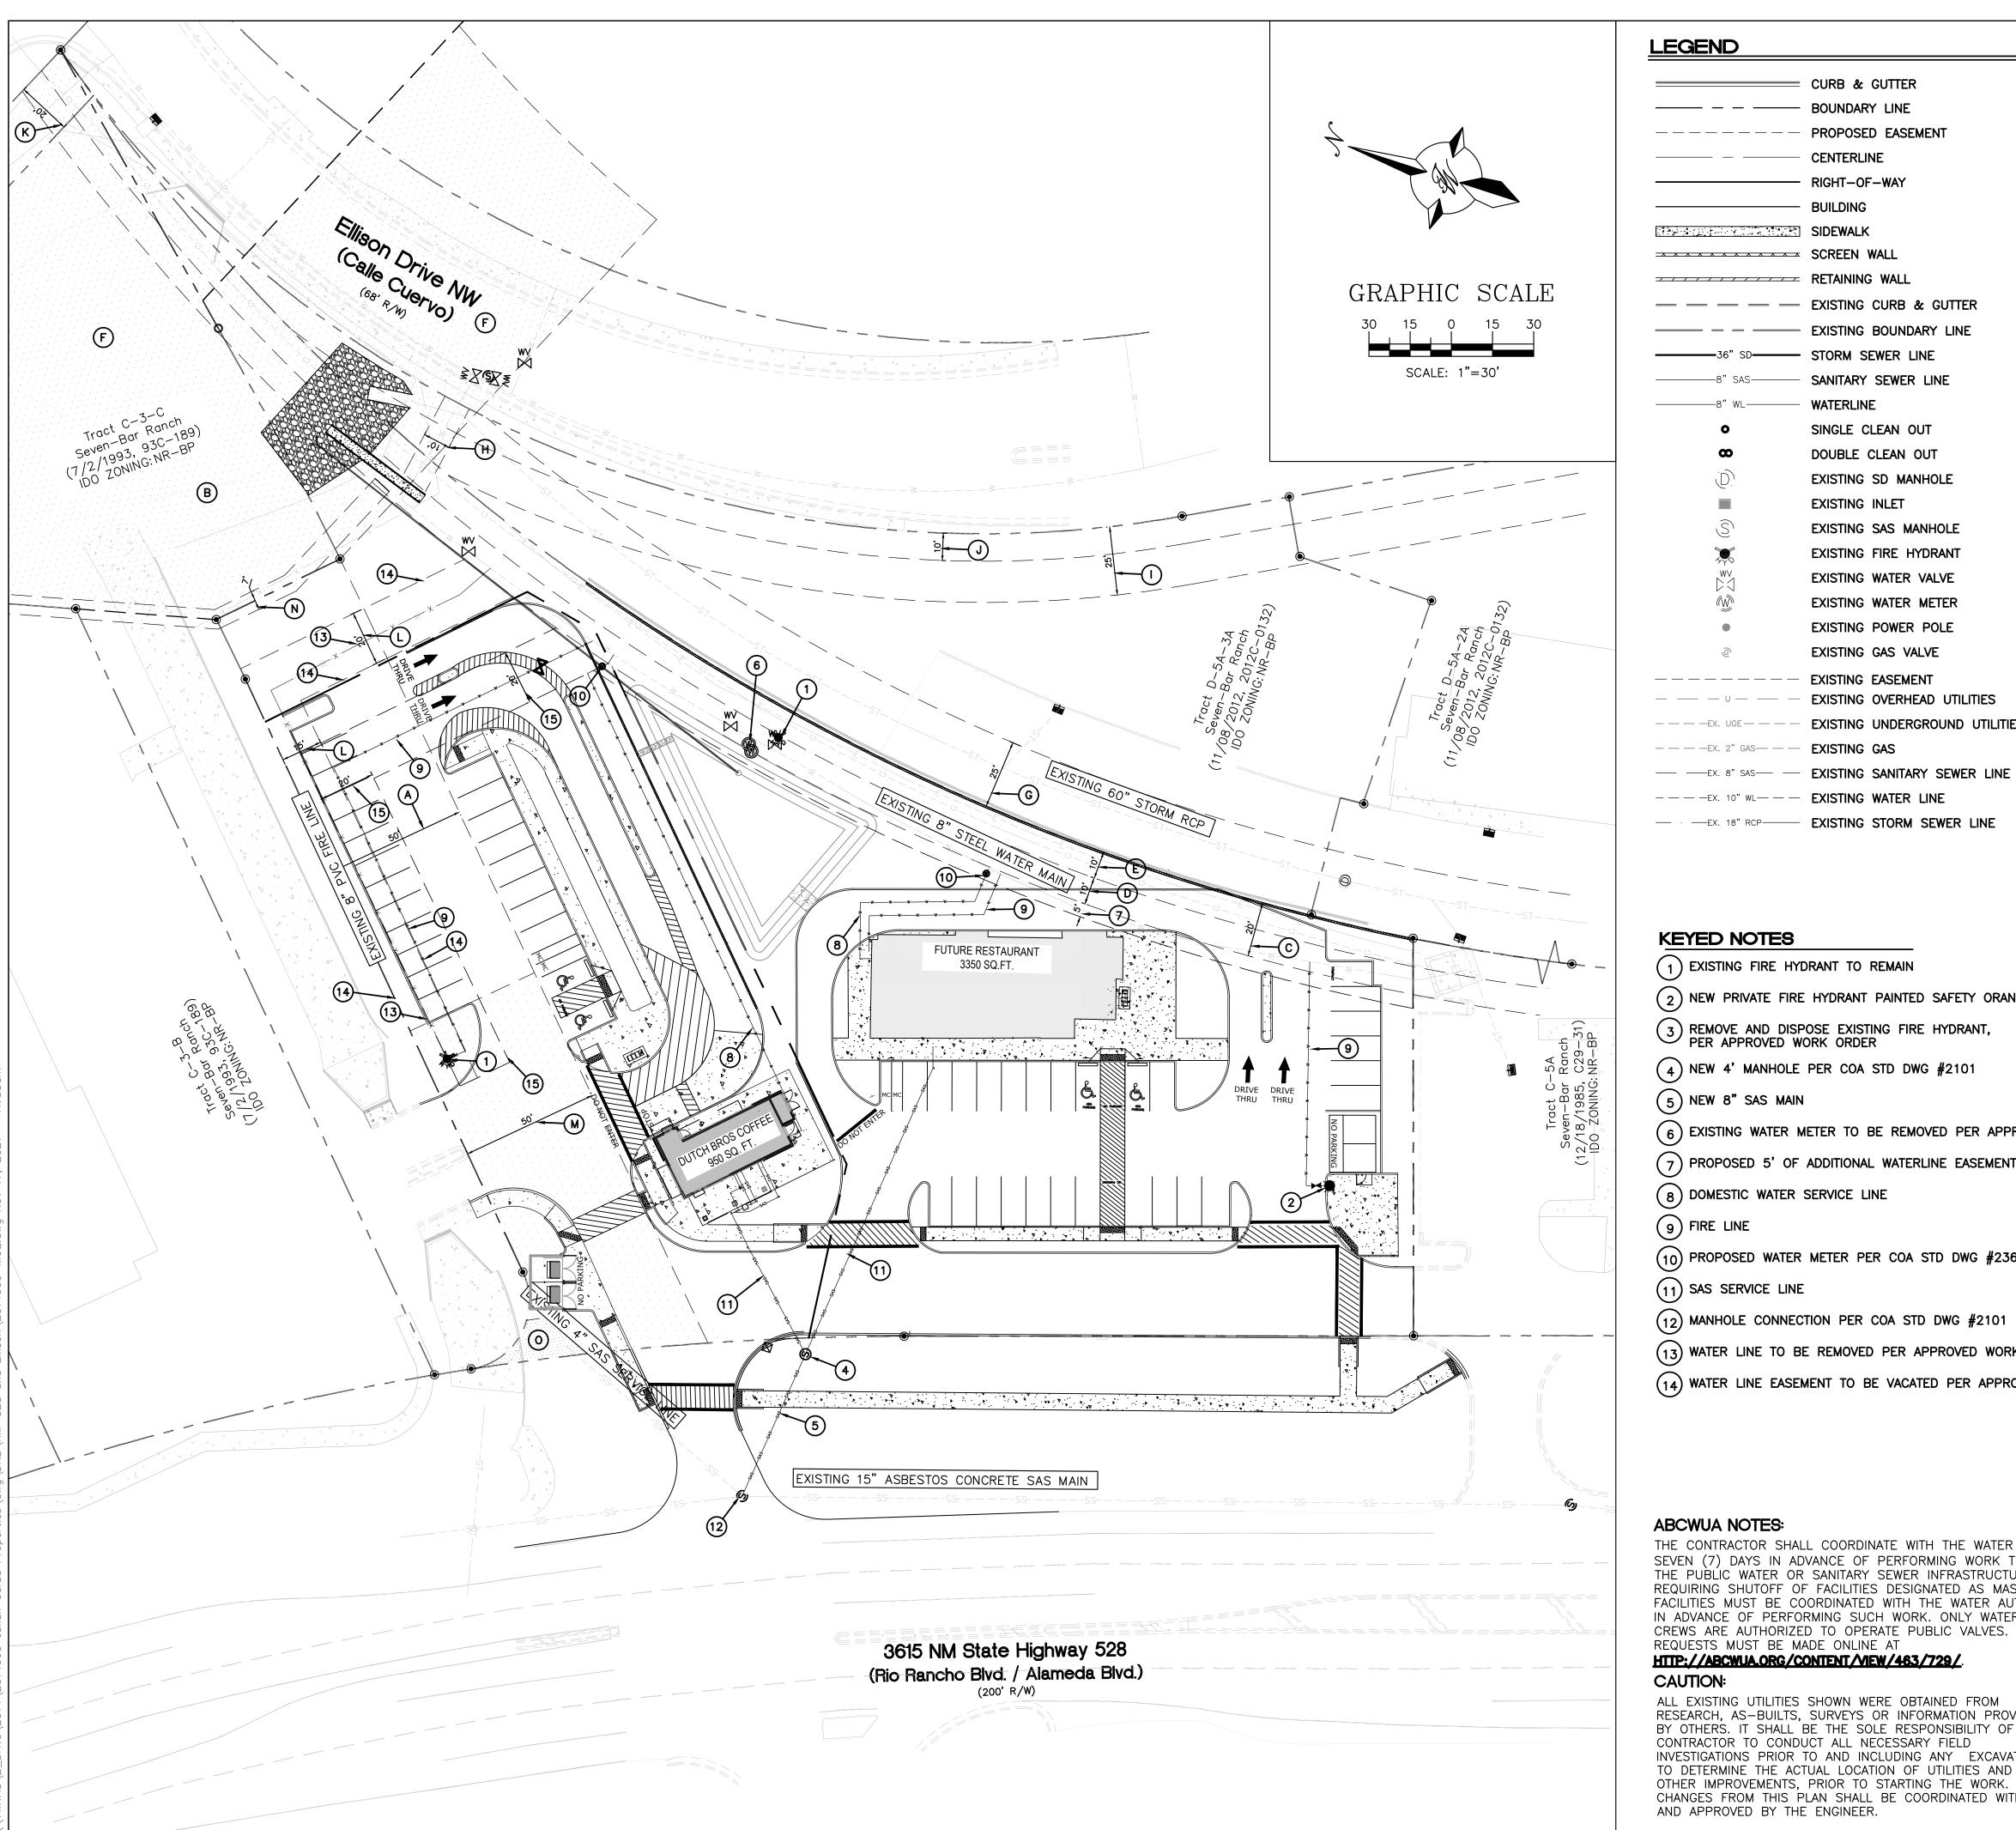

ABCWUA NOTES: 1. DEVELOPMENT ON PROPOSED TRACT 2 WILL REQUIRE ITS OWN AVAILABILITY STATEMENT. CURB & GUTTER

BOUNDARY LINE

CENTERLINE

— BUILDING

-36" SD------ STORM SEWER LINE

WATERLINE

RIGHT-OF-WAY

PROPOSED EASEMENT

EXISTING CURB & GUTTER

SANITARY SEWER LINE

SINGLE CLEAN OUT

DOUBLE CLEAN OUT

EXISTING INLET

EXISTING SD MANHOLE

EXISTING SAS MANHOLE

EXISTING FIRE HYDRANT

EXISTING WATER VALVE

EXISTING WATER METER

EXISTING POWER POLE

EXISTING OVERHEAD UTILITIES

EXISTING UNDERGROUND UTILITIES

EXISTING GAS VALVE

EXISTING EASEMENT

2. EACH PROPOSED LOT SHALL HAVE A SEPARATE PRIVATE SANITARY SEWER SERVICES.

3. THE LOCATION OF EXISTING PRIVATE WATER AND/OR PRIVATE SANITARY SEWER SERVICES, TO DETERMINE IF PRIVATE SERVICE EASEMENTS ARE NEEDED TO PRESERVE THE EXISTING SERVICE(S) FOR THE NEWLY CREATED LOTS, SHALL BE FIELD-VERIFIED.THE WIDTH OF TO PRIVATE SERVICE EASEMENT SHALL BE DETERMINED BY THE ENGINEER OR SURVEYOR.

4. CONTACT UTILITY COMPANIES FOR EXACT LOCATION FOR UNDERGROUND UTILITIES IN THE AREA.

5. PROVIDE ADEQUATE CONCRETE THRUST BLOCKING AT THE FOLLOWING: TAPPING, SLEEVES, TEES, BENDS, PLUGS - ALL FITTINGS. REFER TO ABCWUA STANDARD DETAIL DRAWING 2320

6. INSTALL A TRENCH SAFETY SYSTEM TO PROVIDE FOR THE SAFE EXCAVATION OF ALL TRENCHES EXCEEDING A DEPTH OF (5') FIVE FEET AS PER O.S.H.A. STANDARDS.

7. ALL P.V.C. PIPE ON THIS PLAN SHALL BE ENCASED WITH SELECT BEDDING WHEN PLACED IN CITY ROW. IN SITU (ACCEPTABLE) MATERIAL CAN BE USED IN PRIVATE LINES.

8. ALL VALVES ON P.V.C. WATER MAINS SHALL BE ANCHORED IN CONCRETE.

9. CITY PAVING CUT PERMIT REQUIRED BEFORE EXCAVATION.

10. RECONNECTION OF EXISTING WATER LINE SYSTEM SHOWN ON THESE PLANS MUST BE MADE, SUCH THAT MINIMAL INTERRUPTION OF SERVICE TO CUSTOMER IS MADE.

11. ALL EXISTING LINES CURRENTLY IN SERVICE MUST REMAIN IN SERVICE THROUGHOUT CONSTRUCTION. CONTRACTOR IS RESPONSIBLE FOR PROTECTING SEWER LINES (INCLUDING SERVICES) FROM DAMAGE AS A RESULT OF CONSTRUCTION.

12. CONTRACTOR SHALL VERIFY LOCATION OF SERVICES BEFORE CONSTRUCTION.

13. CONTRACTOR SHALL COORDINATE WITH CITY & COUNTY CONSTRUCTION SEQUENCE AND TRAFFIC

14. CONTRACTOR SHALL PROVIDE TEMPORARY SERVICE TO CUSTOMERS IF SERVICE WILL BE INTERRUPTED FOR MORE THAN (4) HOURS IN A 24-HOUR PERIOD.

15. CONTRACTOR TO ADJUST WATER VALVES TO FINAL GRADE WHERE NECESSARY.

GENERAL UTILITY NOTES:

CONTRACTOR MUST COORDINATE WATER SYSTEM WITH SEWER SYSTEM TO PREVENT ANY CONFLICTS WHERE THESE LINES INTERSECT ONE ANOTHER.

PROVIDE 4 FEET OF COVER MINIMUM FOR ALL PROPOSED WATER LINES. UNLESS OTHERWISE NOTED.

AREAS WHERE WATER PIPES CROSS OVER SEWER PIPES SHALL NOT HAVE ANY JOINTS.

CONTACT UTILITY COMPANIES FOR EXACT LOCATION OF UNDERGROUND UTILITIES IN THIS AREA BEFORE EXCAVATION.

INSTALL A TRENCH SAFETY SYSTEM TO PROVIDE FOR THE SAFE EXCAVATION OF ALL TRENCHES EXCEEDING A DEPTH OF (5') FEET AS PER O.S.H.A. STANDARDS.

PROVIDE ADEQUATE CONCRETE THRUST BLOCKING AT THE FOLLOWING: TAPPING SLEEVES, TEES, BENDS, PLUGS AND ALL FITTINGS.

P.V.C. PIPE SHALL BE PLACED WITH SELECT BEDDING MATERIAL ALL AROUND.

CAUTION: VERIFY LOCATION & DEPTH OF EXISTING GAS MAIN IN THE AREA OF

KEYED NOTES

(1) EXISTING FIRE HYDRANT TO REMAIN

2 NEW PRIVATE FIRE HYDRANT PAINTED SAFETY ORANGE PER COA STDS

REMOVE AND DISPOSE EXISTING FIRE HYDRANT, PER APPROVED WORK ORDER

(4) NEW 4' MANHOLE PER COA STD DWG #2101

(5) NEW 8" SAS MAIN

(6) EXISTING WATER METER TO BE REMOVED PER APPROVED WORK ORDER

(7) PROPOSED 5' OF ADDITIONAL WATERLINE EASEMENT WIDTH

(8) DOMESTIC WATER SERVICE LINE

(9) FIRE LINE

(10) PROPOSED WATER METER PER COA STD DWG #2367

(11) SAS SERVICE LINE

(12) MANHOLE CONNECTION PER COA STD DWG #2101

(13) WATER LINE TO BE REMOVED PER APPROVED WORK ORDER

(14) WATER LINE EASEMENT TO BE VACATED PER APPROVED PLAT

THE CONTRACTOR SHALL COORDINATE WITH THE WATER AUTHORITY SEVEN (7) DAYS IN ADVANCE OF PERFORMING WORK THAT WILL AFFECT THE PUBLIC WATER OR SANITARY SEWER INFRASTRUCTURE. WORK REQUIRING SHUTOFF OF FACILITIES DESIGNATED AS MASTER PLAN FACILITIES MUST BE COORDINATED WITH THE WATER AUTHORITY 14 DAYS IN ADVANCE OF PERFORMING SUCH WORK. ONLY WATER AUTHORITY CREWS ARE AUTHORIZED TO OPERATE PUBLIC VALVES. SHUTOFF REQUESTS MUST BE MADE ONLINE AT

HTTP://ABCWUA.ORG/CONTENT/VIEW/463/729/

CAUTION:

ALL EXISTING UTILITIES SHOWN WERE OBTAINED FROM RESEARCH, AS-BUILTS, SURVEYS OR INFORMATION PROVIDED BY OTHERS. IT SHALL BE THE SOLE RESPONSIBILITY OF THE CONTRACTOR TO CONDUCT ALL NECESSARY FIELD INVESTIGATIONS PRIOR TO AND INCLUDING ANY EXCAVATION, TO DETERMINE THE ACTUAL LOCATION OF UTILITIES AND OTHER IMPROVEMENTS, PRIOR TO STARTING THE WORK. ANY CHANGES FROM THIS PLAN SHALL BE COORDINATED WITH AND APPROVED BY THE ENGINEER.

EXISTING EASEMENTS

A EXISTING 50' ROADWAY & TEMPORARY DRAINAGE EASEMENT (4/20/1982, VOL. MISC. 924, PG. 741) AND (6/21/1993, VOL. 93-16, PG. 1505-1510)

B EXISTING DRAINAGE RIGHT-OF-WAY FOR AMAFCA ACROSS TRACT C-3-C PER AGREEMENT (7/2/1993, 93C-189)

(C) EXISTING 20' SOUTHERN UNION GAS CO. EASEMENT

(12/23/1974, BK. 399, PG. 963–964)

D EXISTING 10' WATERLINE EASEMENT (12/27/1974, VOL. MISC. 400, PG. 381-82)

(E) EXISTING 10' UTILITY EASEMENT (8/6/1974, VOL. MISC. 380, PG. 510)

(F) EXISTING DESILTING POND FOR DRAINAGE (12/18/1985, BK. MISC.

⁷ 303A, PG. 185–189)

G EXISTING 25' DRAINAGE EASEMENT (3/22/1998, 98C-99)

(H) EXISTING 10' WATERLINE EASEMENT (12/18/1985, C29-31)

(| EXISTING 25' SIDEWALK EASEMENT (12/18/1985, C29-31)

(J) EXISTING 10' UTILITY EASEMENT (12/18/1985, C29-31)

(K) EXISTING 20' WATERLINE EASEMENT (7/26/1984, C24-136)

EXISTING NMUI EASEMENT FOR WATERLINE (12/15/1993, BK. 93-36, PG. 956-961, DOC. NO. 93141955)

EXISTING NON-EXCLUSIVE, PERPETUAL INGRESS AND EGRESS EASEMENT (11/1/1994, BK. 94-30, PG. 6362-6367, DOC. NO. 94131022)

N EXISTING 7' PNM AND MST&T EASEMENT (9/23/1986, BK. MISC. 3978, PG. 909)

O EXISTING PRIVATE SANITARY SEWER EASEMENT (12/8/1993, BK. 93-35, PG. 3040-3046, DOC. NO. 93139036)

NOT FOR CONSTRUCTION

NM 528 AND ELLISON SEAL 11/17/202 3615 NM 528 MASTER UTILITY

P.E. #7868


DRAWING 2014069-SPE PLAN SHEET # TIERRA WEST, LLC 5571 MIDWAY PARK PL NE ALBUQUERQUE, NEW MEXICO 87109 (505) 858-3100 www.tierrawestllc.com

RONALD R. BOHANNAN

JOB # 2020091

DRAWN BY

11/17/2021

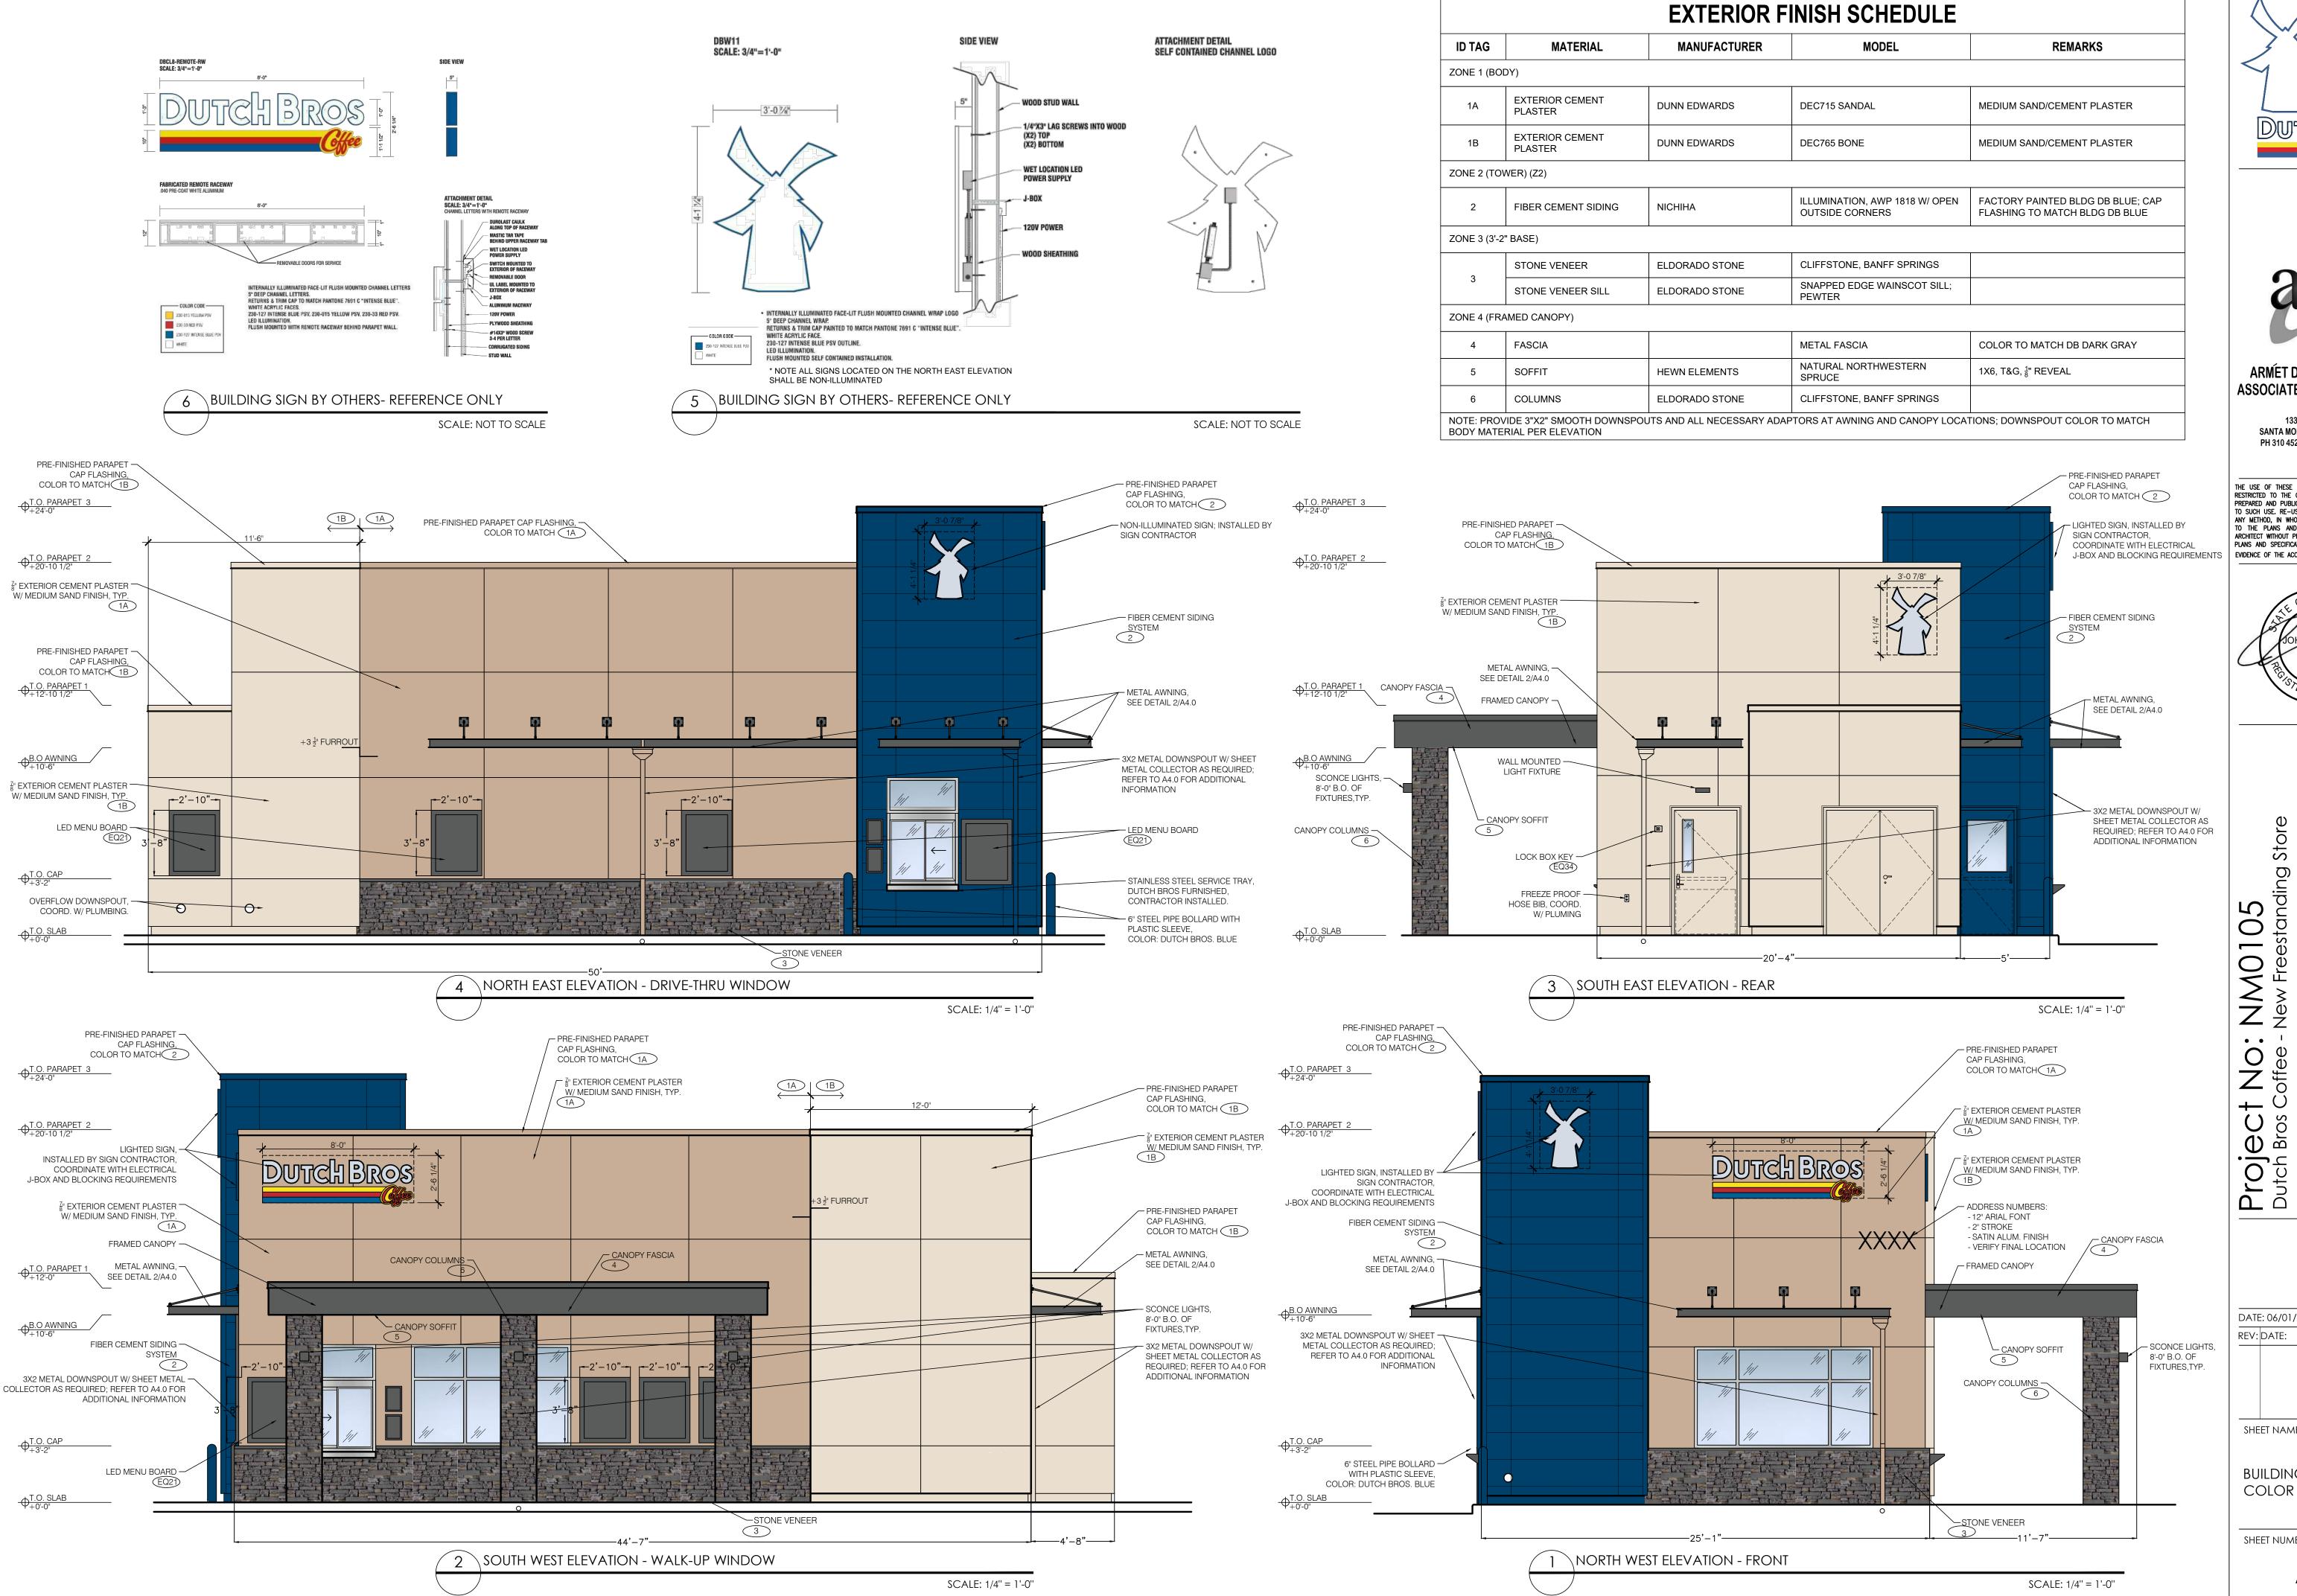




ARMÉT DAVIS NEWLOVE & **ASSOCIATES, AIA ARCHITECTS**

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Sto 0 9 \sum_{0}^{∞} Project No: Dutch Bros Coffee -2550 - A1 PROTOTYPE

> DATE: 06/01/2021 REV: DATE: DESCRIPTION:

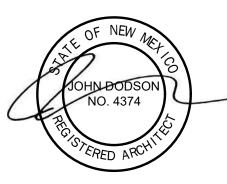
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SHEET NAME:

BUILDING ELEVATIONS

SHEET NUMBER:

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I. PURPOSE & INTENT

The following design standards were prepared with the intent of informing, guiding and preparing design professionals and developers to achieve the goals and standards set forth in this document.

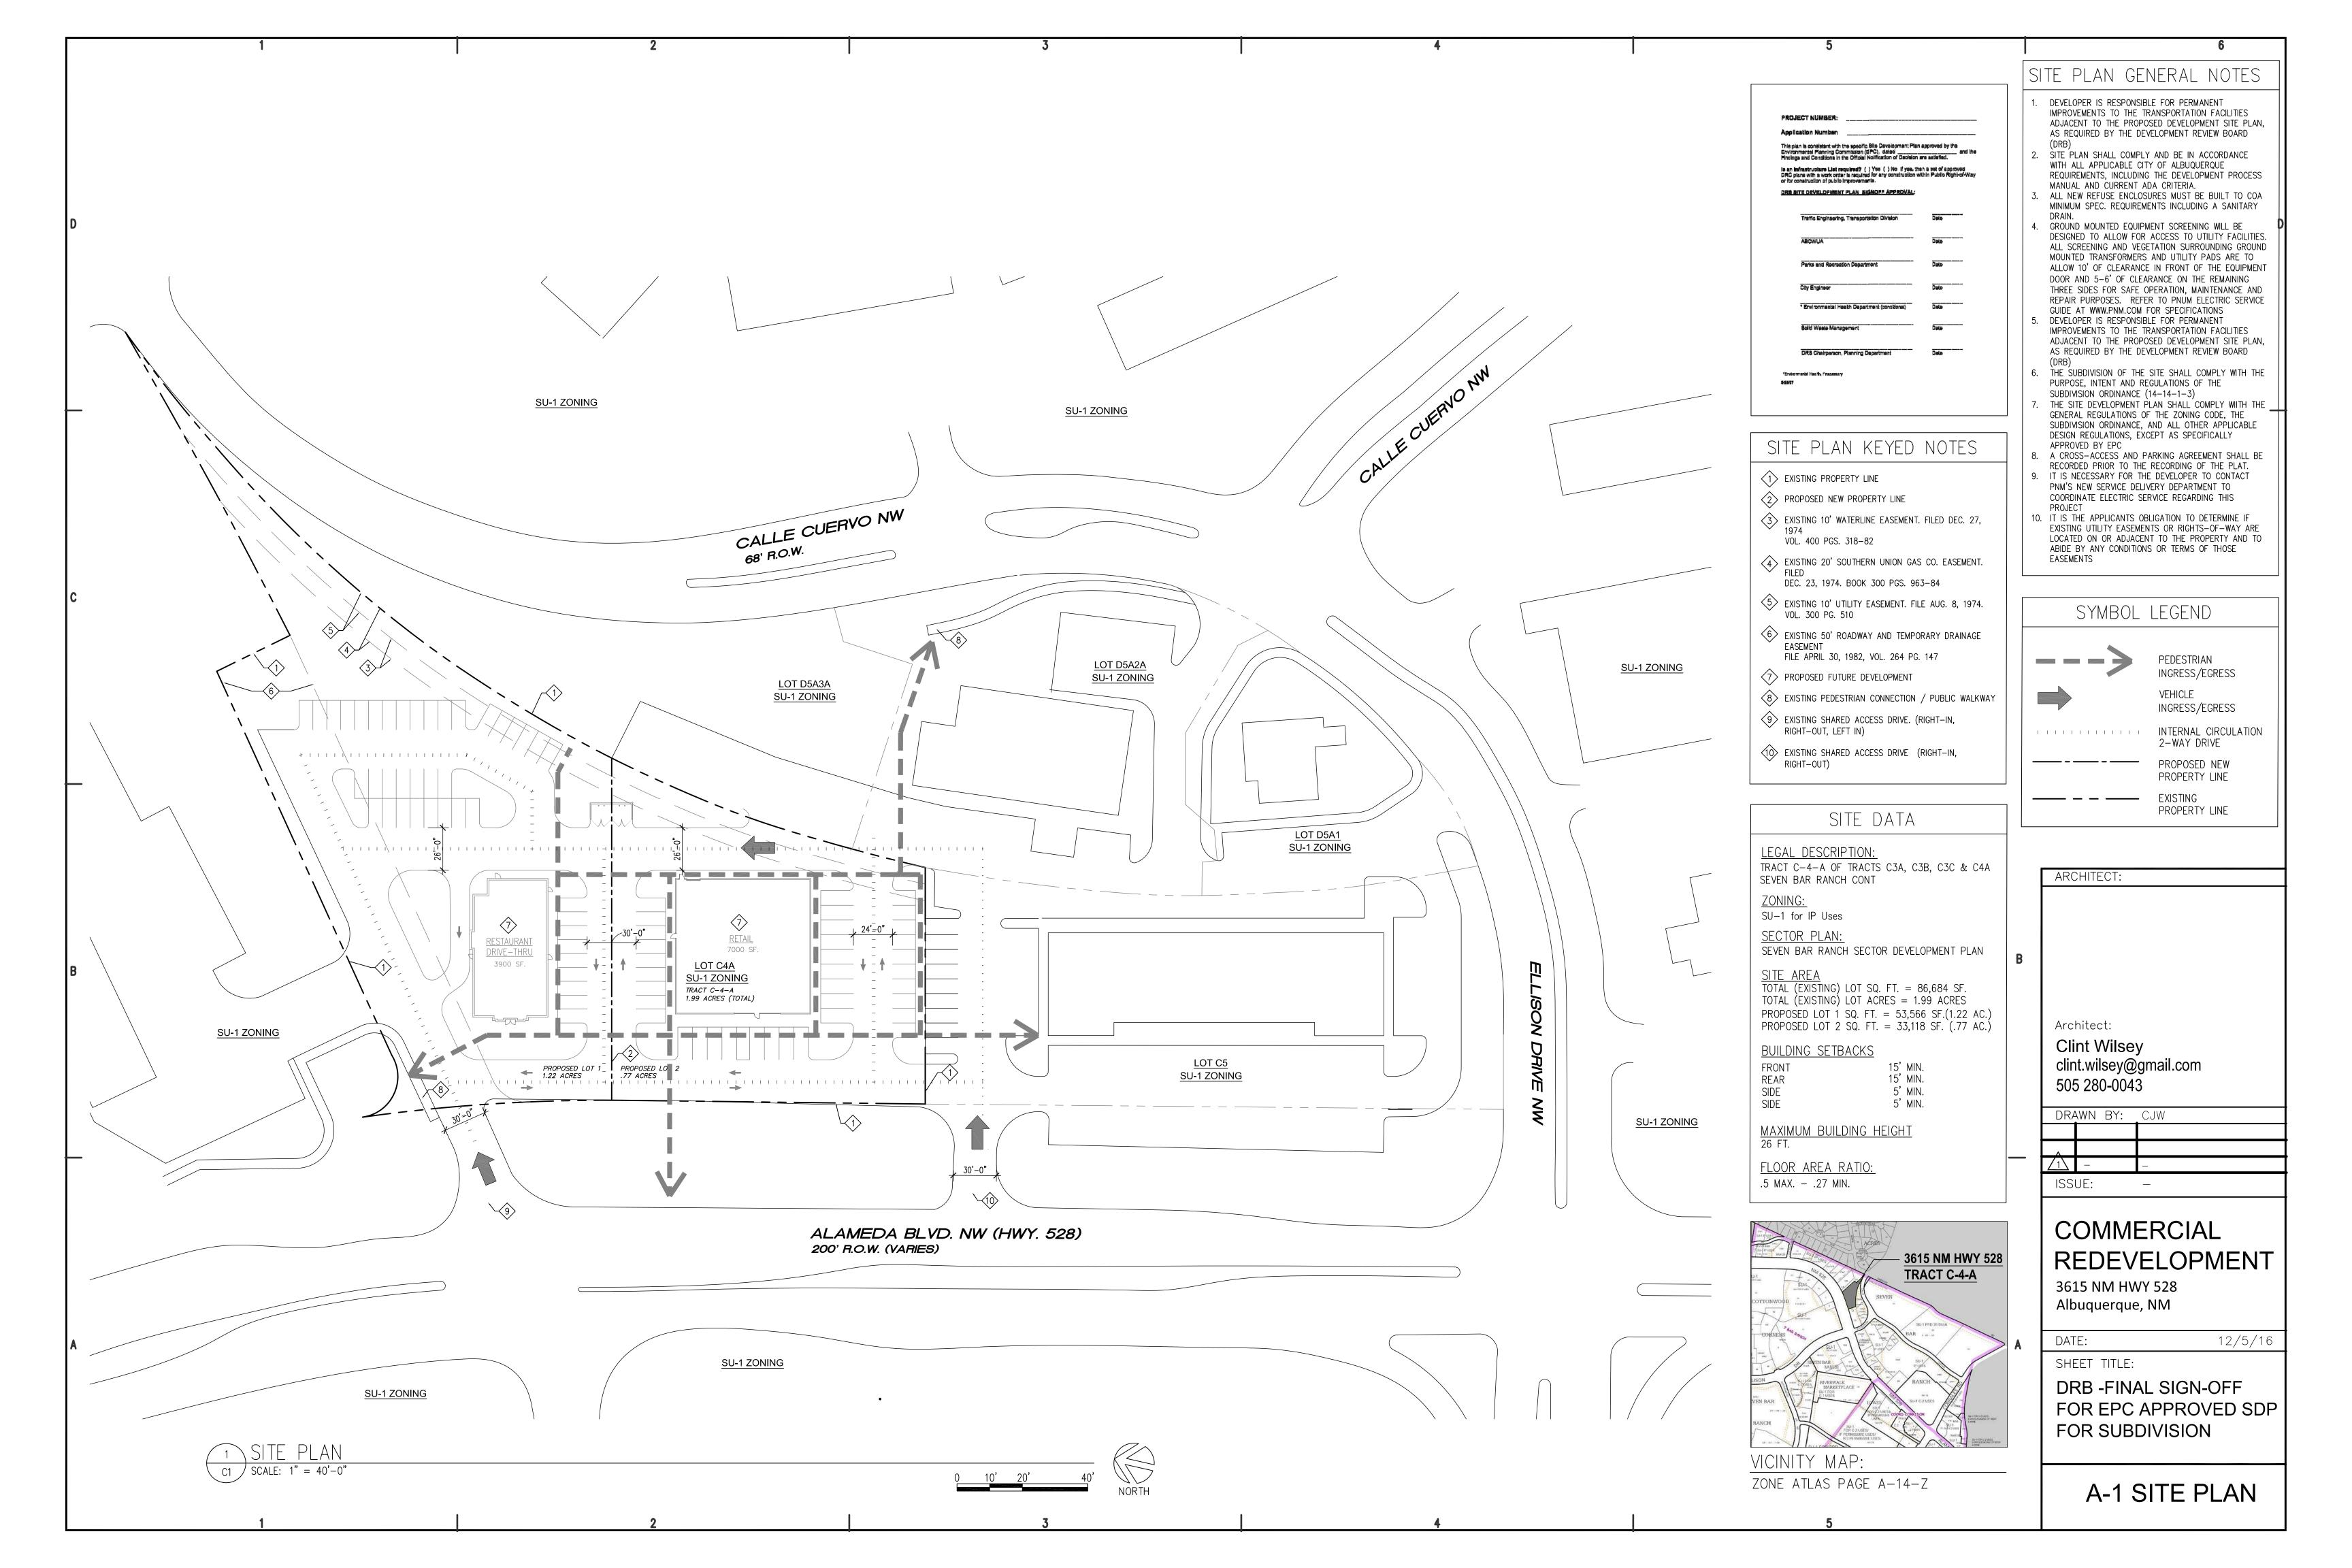The goals of the design standards are to bring thoughtful, safe, harmonious design to new development, buildings and sites along the 3600 block of HWY 528. The proposed future uses are commercial retail and restaurants, so the standards emphasize safe and functional pedestrian use, with convenient vehicular ingress/egress and parking. The architecture standards establish criteria for aesthetically pleasing buildings, with materials and features consistent and complimentary to the local built and natural environment.

a. All new development shall meet or exceed the requirements of City of Albuquerque Comprehensive Zoning Code, and the Seven Bar Ranch Sector Development Plan for SU-1 zoning.

II. SETBACKS AND BUILDING HEIGHT

Building height shall meet the requirements of the City of Albuquerque Comprehensive Zoning Code. For SU-1 Zoning the code refers to R-2 Zoning limitations (Sect. 14-16-2-11(C)). Structure height up to 26' is permitted. Structures over 26' shall fall within 45° angle plan requirements described in the above section.

a. Setbacks shall meet the requirements of the City of Albuquerque Comprehensive Zoning Code (Sect. 14-16-2-11(E)). For SU-1 Zoning the code refers to R-2 Zoning requirements. Setbacks shall be as follows:

Front yard setback: 15' min. Side yard setback: 5' min. Rear yard setback: 15' min.

b. Landscape setbacks shall meet the requirements of the CABQ Comp. Zoning Code section 14-16-3-10(E)(3)..

III. VEHICULAR ACCESS, CIRCULATION & PARKING

Proper parking and vehicle circulation is key to a safe, efficient and convenient commerical development. Visually, parking areas shall not dominate the frontage along Hwy 528. Parking shall be dispersed into smaller lots, and primarily situated between and behind buildings. Cross access and shared parking is encouraged. Careful consideration should be given to screening parking, while maintaining clear sight at intersections and pedestrian connections.

- a. Off-street parking areas, including parking spaces size, drive aisle widths, pedestrian walkways, and screening shall comply with Section 14-16-3-1 of the CABQ Comp. Zoning Code.
 - 1. Parking areas shall be designed to include a min. 6 foot wide pedestrian connections to buildings
- Parking shall be placed beside, behind buildings or screened from surrounding neighborhoods by a 3 foot wall or landscaping. Walls shall compliment the material and style of surrounding buildings.
- b. Bicycle parking shall comply with Section 14-16-3-1(B) of the CABQ Comp. Zoning Code.
- 1. Secure bicycle parking shall be provided in convenient locations to help promote cycle commuting.
- c. Motorcycle parking shall comply with Section 14-16-3-1(C) of the CABQ Comp. Zoning Code.
- d. Building entries shall be clearly visible from parking areas or by site access and circulation.
- e. Grading and drainage design of parking areas shall comply with Chapt 22 of the Development Process Monual and shall incorporate low impact development principles.
- 1. Parking islands shall allow for proper drainage or used for water harvesting.

V. WALLS, FENCES & SCREENING

To enhance the attractiveness of site and parking lots, screening of areas such as parking and utility items, as well as retaining walls shall meet the following design standards. Walls, fences and screening shall meet the requirements of Section 14-16-3-19 of the Abq. Comprehensive Zoning Code.

- a. Parking shall be screened from the public rights—of—way by means of a 3 foot high wall and/or landscaping. These walls shall be complimentary to the building designs on site, and should reflect local materials and colors.
- b. Trash receptacles, mechanical equipment, and loading docks shall be screened from public streets through the use of solid walls, solid fences, berms, or dense evergreen foliage. (loading zones located in parking areas and drives, that are not depressed or do not contain a raised dock are not subject to screening)
- 1. Trash enclosures shall be consistent with the architectural styles and materials of buildings on site.
- 2. All outdoor refuse containers shall be screened within a minimum 6 foot tall enclosure which is large enough to contain all trash stored between collections.
- 3. Trash enclosures shall have solid, or opaque gates as tall as the enclosure.
- c. Walls and fences shall be at least as tall as the objects they are intended to screen but shall not exceed 8 feet high.
- d. All screening devises shall be in compliance with the City of Albuquerque DPM's Clear Sight Triangle regulations.
- e. All mechanical equipment shall meet the screening requirements of Section 14-16-3-18(C)(6) of the CABQ Comp. Zoning Code.
 - 1. All mechanical equipment shall be screened from public view by materials that compliment the style and colors of the buildings on site and the surrounding areas.
- f. Walls and fences shall comply with Section 14-16-3-19 of the CABQ Comp. Zoning Code.
- g. Perimeter walls shall include openings at all pedestrian connections to insure convenient access to adjacent tracts.
- h. The use of razor ribbon, razor wire, barbed wire, chain link fencing with or without slats, cyclone fencing or unfinished, smooth, grey CMU is prohibited.
- i. Some examples of acceptable wall & fence materials include:
- 1. stucco over CMU
- 2. split faced block
- 3. brick
- 4. stone
- curved interlock blocks
- 6. solid, perforated or patterned sheet metal. (no corugated roofing sheet metal)
- The finish of walls & fences shall be attractive and complimentary to the building materials on site.
- k. Retaining walls are permitted and shall be attractive and complimentary to the building materials and colors on site.
 - 1. Retaining walls, seat walls, or elements intended to compensate for the slope in the site, shall avoid long, unarticulated expanses of wall. Walls shall have varied setbacks of at least one foot in planes not running in on continuous direction for more than fifty feet without a change in height or setback.
 - 2. Pedestrian sidewalks and landscape shall be integrated into these locations where applicable to allow for pedestrian access through elevation changes with the
- I. Grading and drainage plans must comply with the City of Albuquerque's Drainage Ordinance.
- 1. All measures shall be taken to provide public safety at ponding locations

VI. LIGHTING AND SECURITY

To improve safety, security and site aesthetics, lighting design shall be carefully considered. The primary design goal of site lighting shall be to maximize public safety without impacting the adjacent properties, buildings or roadways with extraneous glare or reflection.

- a. All lighting shall comply with Section 14-16-3-9, Area Lighting Regulations of the CABQ Comp. Zoning Code.
- b. Lighting fixtures shall conform to the requirements of the State of New Mexico Night Sky Protection Act. (74-12-1 to 74-12-10 NMSA 1978)
- c. All free-standing lights shall be of consistent design throughout the site.
- d. High pressure sodium & cobra-head type lighting fixtures are not permitted.
- e. Light fixtures shall be located on Site Development Plans for Building Permit
- f. The height of street lights and off—street parking area lights shall not exceed 26 feet.
- g. All lights shall be shielded to prevent light spillage onto adjocent properties or the public right-of-way.
- h. Pedestrian lighting shall not exceed 12 feet in height
- i. Tree canopy lighting may be used to accent and enhance pedestrian connections.
- Exterior elevations of buildings fronting the public right-of-way may use accent lighting to enhance the building

VII. LANDSCAPING

The site development landscape shall strive to improve and enhance the aesthetics of the site and it presence from the street, as well as define and enhance pedestrian and vehicular connections. The goal is to create a natural setting, indicative of the New Mexico landscape, and that provides year around coverage, color and interest for the development. A clear theme and style for the development shall be planned and reflected in the hardscape, paving, plantings, signage, and site ammenities. Landscaping shall conform to the regulations applicable to Apartment and Non-residential Development required in Section 14-16-3-10 of the Aba. Comprehensive Zoning Code.

- a. Street trees shall be provided as per the Street Tree Ordinance (6-6-2-1) et seq., Street Tree Ordinance of the CABQ Comp. Zoning Code.
- b. A minimum of 15% of the net site area shall be devoted to landsapce materials.
- c. Gravel, mulch, cobble, bark, and other similar materials are acceptable as a top dressing for the landscape areas
- d. Gravel shall be a 1-1/2" maximum, and color shall be consitent or specific to a design pattern throughout the site.
- e. All plant material shall be maintained by the building owner in a living, attractive condition, and free of weeds and trash.
- f. Minimum plant material sizes at the time of installation shall
- 1. Canopy Trees 2" caliper
- 2. Evergreen Trees 10" min. height
- 3. Accent Trees 2" caliper
- 4. Shrubs and groundcovers 1 gallon minimum
- g. Landscape plans shall comply with the City's Water Conservation Ordinance and Pollen Ordinance.
- h. Drought tolerant species shall be used in landscape areas, and zericscape planting is encouraged. Live plant materials shall cover a min. 75% of landscape areas at maturity.
- i. An automatic underground irrigation system is required to support all site landscaping. The system shall be designed to avoid over-spraying on walls, buildings, fences, sidewalks, parking areas, etc. Irrigation components shall be maintained properly in full working condition at all times.
- The irrigation system serving landscaped areas shall be a fully automated system with centralized computer controls.
- k. Landscape beds shall be at grade to promote water harvesting.

VIII. ARCHITECTURE / DESIGN

The architectural design of buildings and site ammenities shall be thoughtful and reflect a high quality of aesthetics, character, and appropriate scale and massing. The design shall reflect the built and natural surrounding of the southwest, and shall respond to climate, views, solar access and street visibility.

a. All development shall comply with the General Building & Site Design Regulations for Non-residential uses of the CABQ Comp. Zoning Code.

b. Architectural Style:

- 1. The development shall provide a cohesive material and color palette among all buildings.
- 2. Building features like shade canopies, storefronts, and building accents should be consistent or complimentary to the overall style of the development.
- 3. All buildings shall be "contemporary" in design and reflect characteristics and architectural styling of the present time. Contemporary design is based in modern architecture styling and can include clean lines, explicit geometry, variation in massing, minimal or no ornamentation, careful and honest use of materials, emphasis on shadow/light, and creative use of openings and glazing.
- 4. Historical references to traditional New Mexico styles shall be in a contemporary interpretation of those styles.

c. Articulation

- 1. Buildings shall have a variety of structural forms to create visual interest and character.
- 2. Long unarticulated facades shall be prohibited. Facades shall have varied front setbacks, bump—outs, or wall planes that do not run in one continuous direction of more than 100 feet without a change in color, material or architectural treatment.
- 3. Massing elements shall be reinforced with accent color or material variation.

d. Materials:

- 1. The architectural expression of all buildings shall reflect contemporary style with materials that compliment New Mexico and southwest vernacular.
- 2. Individual building elements and materials shall be of excellent design, construction, and quality. Examples of appropriate materials include:
 - Metal wall panels
- Porcelain tile
- Natural or cast stone
- Concrete (colored or patterned)
- Rammed earth
- Glass - Stucco or EIFS
- Brick or decorative CMU
- 3. The following exterior building materials shall be
 - Engineered wood paneling
 - Vinyl or plastic siding
 - plain grey, or unfinished smooth CMU
- 4. All glazing shall be clear and neutral in color. Reflective, deeply colored, and patternized glazing is prohibitied
- Canopies, trellises and awnings shall be durable and weather resistent, such as metal, corrugated metal, or steel.
- 6. Colors shall include earth tones with accent colors in limited areas.
 - i. No more than 2 accent colors shall be used per
 - ii. The use of constrasting colors for shade elements and metal accents are encouraged.

IX. SIGNAGE

Signage and graphics should create a sense of arrival to the development and provide visual continuity between the various lots and their users.

- a. All signage on subject site must comply with Sections 14-16-3-5 (General Sign Regulations) and 14-16-2-19(A)(25)(Industrial Park Zone).
- * Per these requirements, one free standing sign is permitted for each street frontage, or joint sign premises, which as at least 200 feet of street frontage. This would allow a single, 26'foot high, 100sf. sign on the subject site along NM Highway 528. A maximum of twenty percent of building facades facing NM Hwy 528 may be used as building mounted signage area.
 - b. Free standing signs shall be designed so as to not require and external bracing, angle supports, auy wires or similar devises
 - c. No signage is allowed that uses moving parts, makes audible sounds, or has blinking or flashing lights
 - d. Signs shall not overhang into the public right-of-way or extend above the buildings parapet or roof line.
 - e. Off-premise signs and portable signs are prohibited
 - f. Building mounted signs shall have contrasting colors from the background and text height and font to ensure readability

ARCHITECT:

X PROCHOSbuilding mounted sign shall intrude upon architectural features like windows, columns, or Site Developmenties!an for Building Permit shall be delegated to the Development Review Board and shall be consistent with the design standards established by the Site Development Plan for Subdivision.

> Architect: Clint Wilsey clint.wilsey@gmail.com 505 280-0043 DRAWN BY: CJW ISSUE: COMMERCIAL REDEVELOPMENT 3615 NM HWY 528 Albuquerque, NM 12/5/16 DATE:

SHEET TITLE:

DRB -FINAL SIGN-OFF FOR EPC APPROVED SDP FOR SUBDIVISION

A-2 DESIGN STANDARDS

C-101