



# DEVELOPMENT REVIEW BOARD SUPPLEMENTAL SUBMITTAL

# (Deadline is Friday at noon unless noted on DRB calendar – late submittals will not be accepted unless approved by the DRB)

**PROJECT NO.** PR-2021-005272 **Application No.** SI-2022-01239

TO:	
$\underline{\hspace{0.1cm}\checkmark\hspace{0.1cm}}$ Planning Department/Chair	
<ul> <li>✓ Hydrology</li> <li>✓ Transportation Development</li> <li>✓ ABCWUA</li> <li>✓ Code Enforcement</li> <li>✓ Parks &amp; Rec</li> <li>*(Please attach this sheet with each</li> </ul>	h collated set for each board member)
NOTE: ELECTRONIC VERSION (ie dis	sk, thumbdrive) is Required. Submittal will not be accepted without.
DRB SCHEDULED HEARING DATE: Au	ugust 17, 2022 HEARING DATE OF DEFERRAL: August 10, 2022
SUBMITTAL DESCRIPTION: Revised plan set with add	Iditional notes and revisions to keynotes for Code Enforcement comments, additional
keynotes on utility plan for ABCWUA, and	d updated G&D sheet; providing Transportation exhibits for San Pedro; re-transmitting
deviation justification letter and proposed	Infrastructure List.
Site plan has been stamped and sealed a	and Solid Waste has signed the updated version. This has been sent to the EHD
for further review and approval, as reques	sted.
CONTACT NAME: Michael Vos, AICP	
TELEPHONE: (505) 764-9801	EMAIL: vos@consensusplanning.com

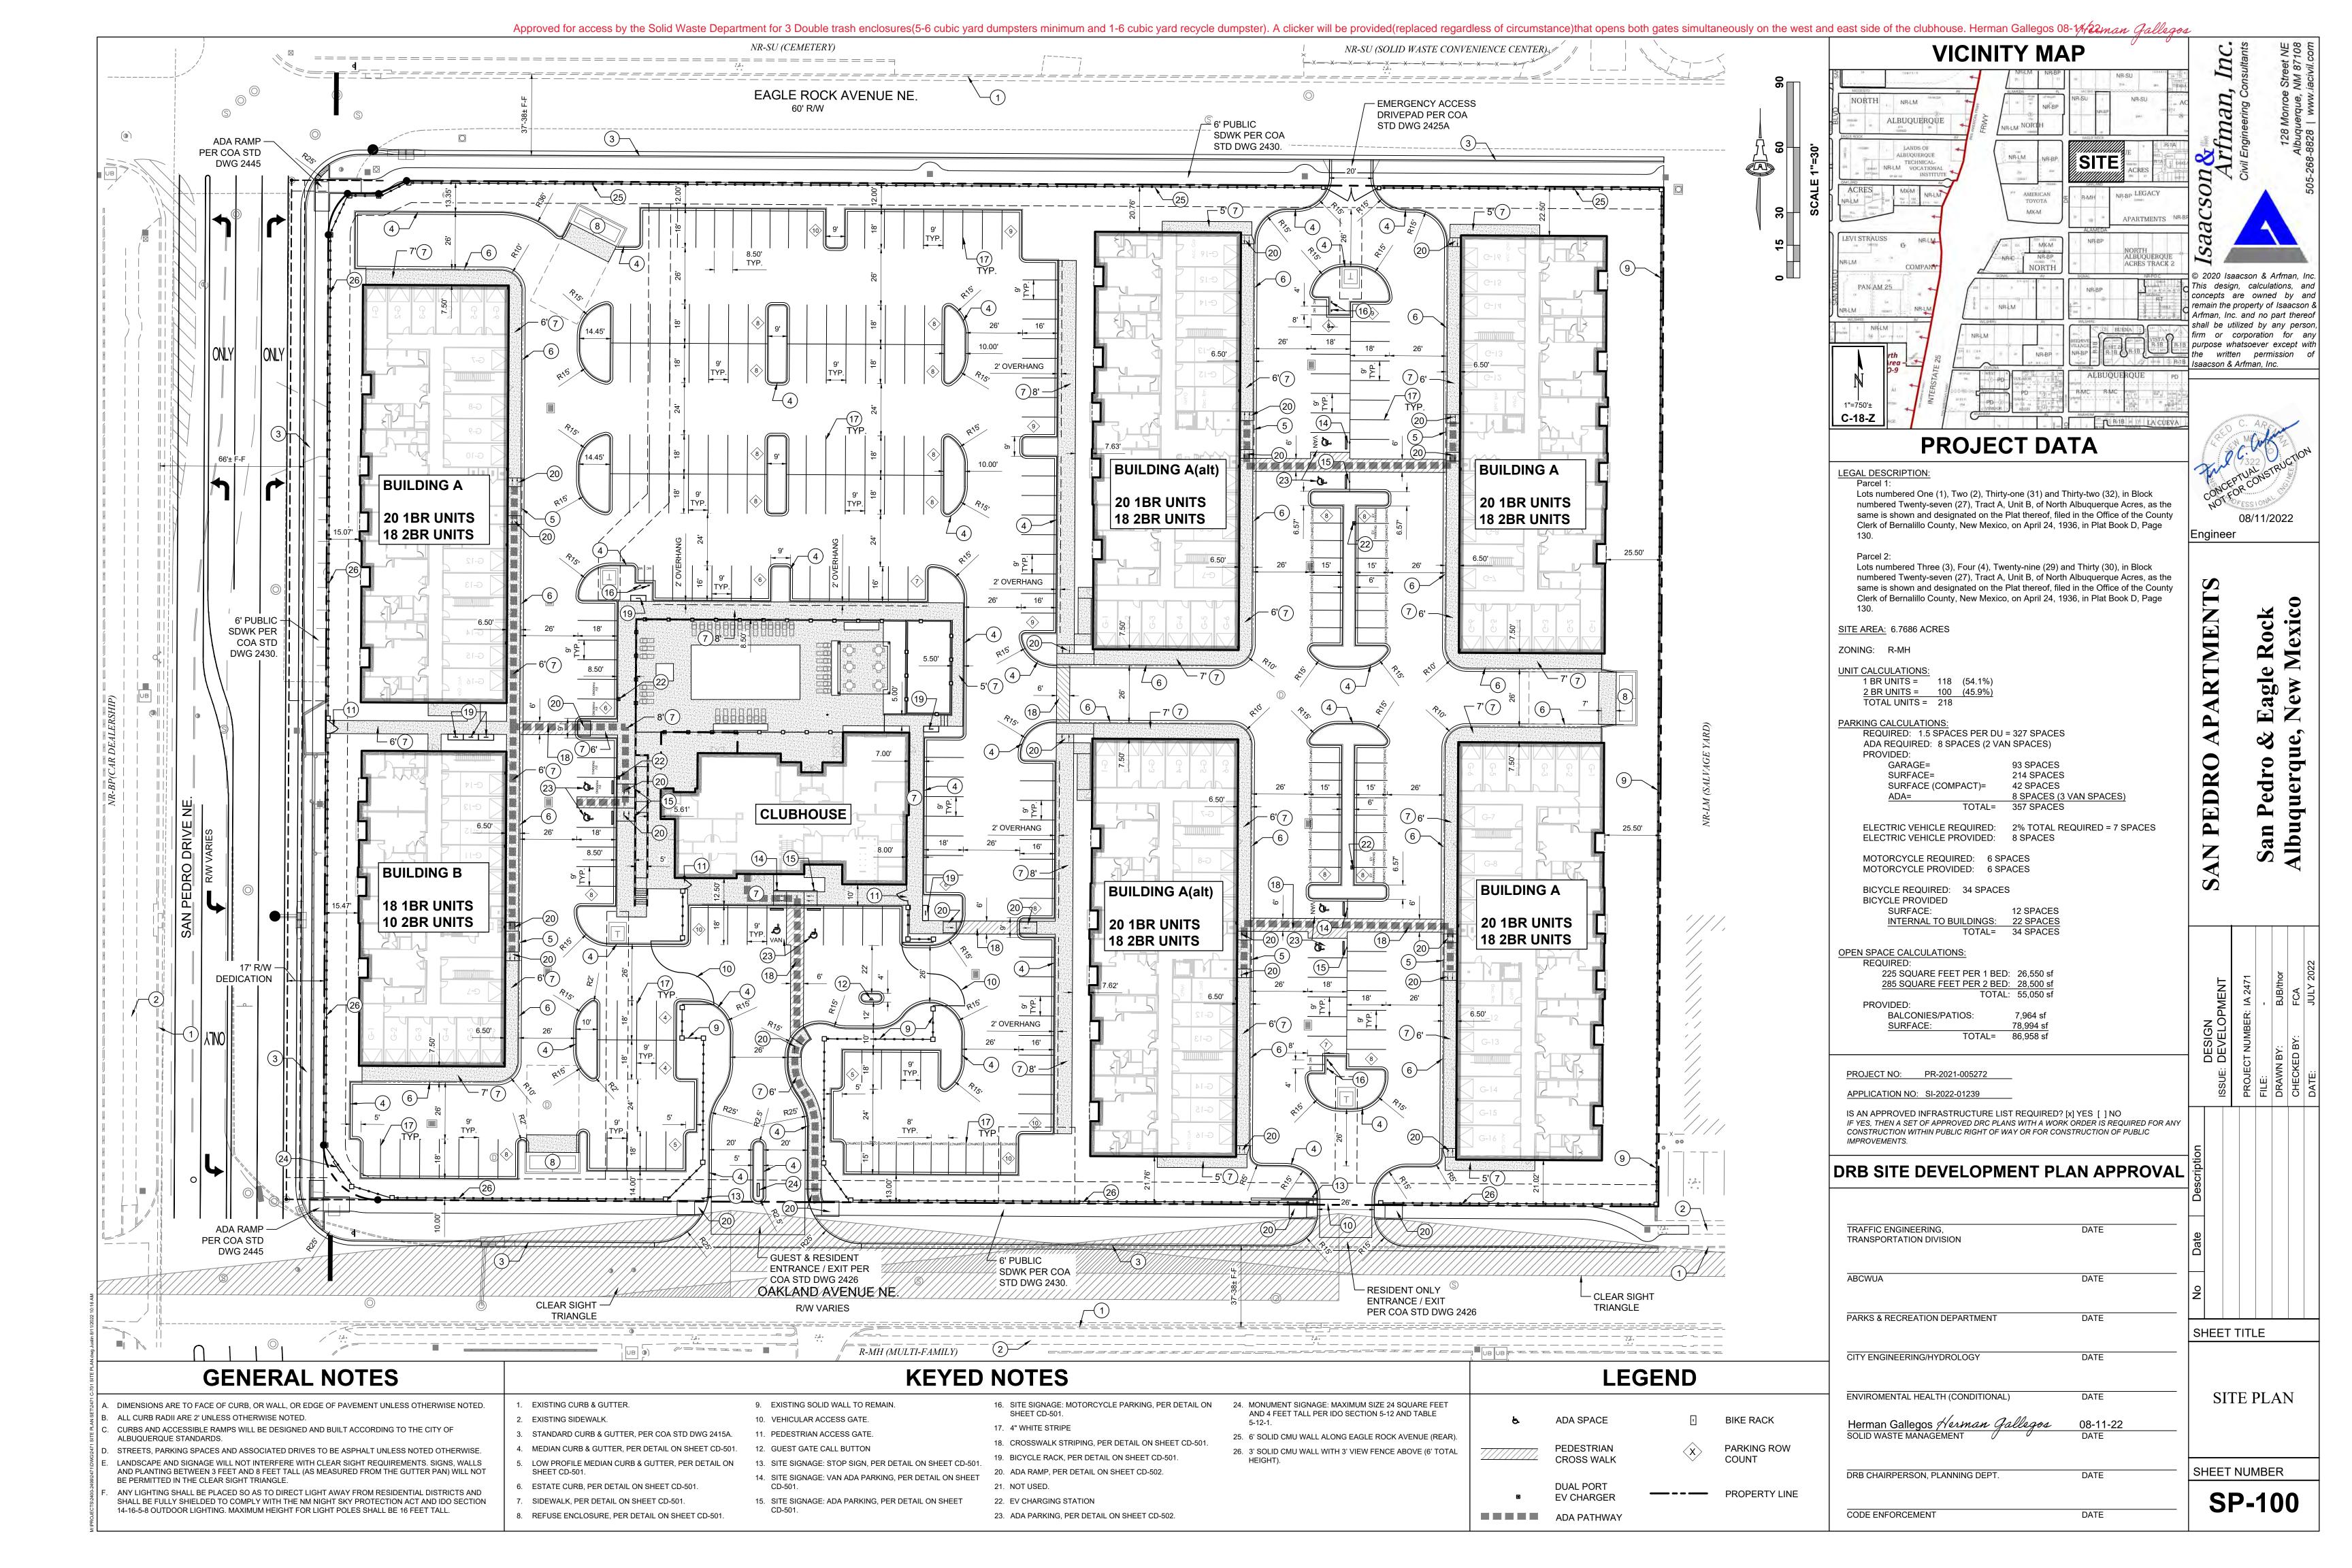

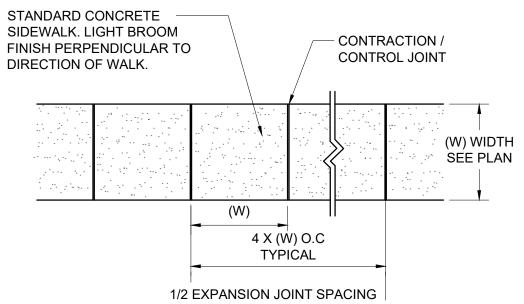


### **GENERAL NOTES**

- 4000 PSI COMPRESSIVE STRENGTH CONCRETE
- 2. SEE CONCRETE JOINTS DETAIL
- 3. FINISHED EDGE OF ASPHALT PAVING TO BE 1/2" ABOVE EDGE OF CONCRETE (TYP).
- 4. 3/8" RADII AT ALL EXPOSED EDGES.

# **CONCRETE WALK**

**BROOM FINISH** 

SCALE: N.T.S.

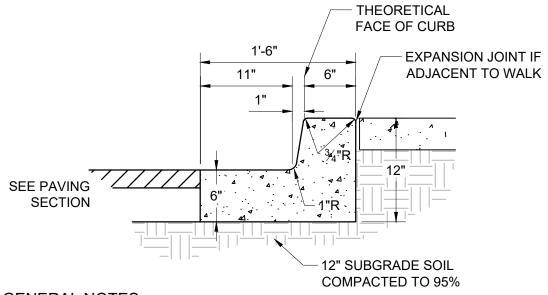


### GENERAL NOTES

- 1. REQUIRES FULL FORM ON ALL FACES.
- 2. CONTRACTION / CONTROL JOINTS @ 6' O.C. MAX.
- 3. EXPANSION JOINTS @ 48' O.C., CURB RETURNS AND EACH SIDE OF
- 4. EDGES NOT SPECIFICALLY DIMENSIONED SHALL BE EDGED WITH A 3/8"

# **MEDIAN CURB AND GUTTER**

6" WIDE THEORETICAL FACE OF CURB SCALE: N.T.S.

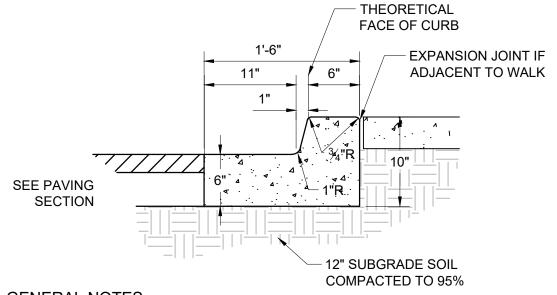

### **GENERAL NOTES**

- 1. REQUIRES FULL FORM ON ALL FACES.
- 2. CONTRACTION / CONTROL JOINTS @ 6' O.C. MAX.
- 3. EXPANSION JOINTS @ 48' O.C., CURB RETURNS AND EACH SIDE OF
- 4. EDGES NOT SPECIFICALLY DIMENSIONED SHALL BE EDGED WITH A 3/8"

### **LOW PROFILE MEDIAN CURB AND GUTTER**

6" WIDE THEORETICAL FACE OF CURB SCALE: N.T.S.

- THEORETICAL FACE OF CURB - EXPANSION JOINT IF ADJACENT TO WALK SEE PAVING SECTION - 12" SUBGRADE SOIL COMPACTED TO 95%

### **GENERAL NOTES**

- 1. REQUIRES FULL FORM ON ALL FACES.
- 2. CONTRACTION / CONTROL JOINTS @ 6' O.C. MAX.
- 3. EXPANSION JOINTS @ 48' O.C., CURB RETURNS AND EACH SIDE OF
- 4. EDGES NOT SPECIFICALLY DIMENSIONED SHALL BE EDGED WITH A 3/8"

# **ESTATE CURB**

6" WIDE THEORETICAL FACE OF CURB

SCALE: N.T.S.

This design, calculations, and

irm or corporation for any

purpose whatsoever except with

e Rock Mexico

agle lew N

国 国 Z


San Albu

erqu

the written permission


Isaacson & Arfman, Inc.

|Engineer

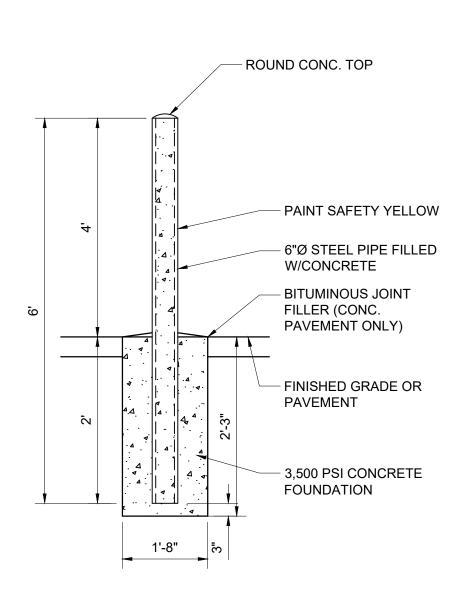

# **CONCRETE FILLED BOLLARD**

SCALE: N.T.S.

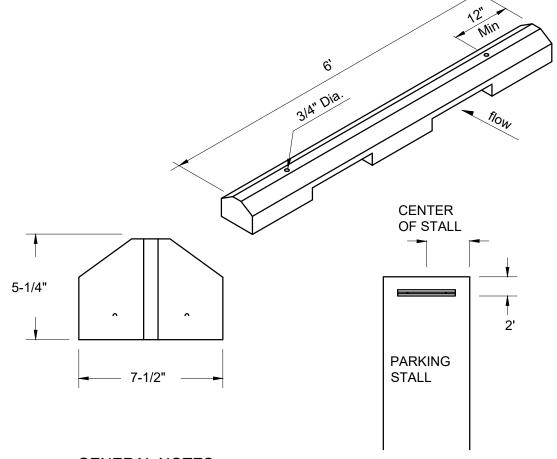


### **GENERAL NOTES**

- 1. WHEEL STOPS TO BE PLACED 2' BACK, CENTERED IN THE PARKING STALL WHEEL STOPS CAN BE PAINTED IN A CONTRASTING COLOR SUCH AS GRAY, YELLOW OR BLACK.
- 2. BLUE SHALL BE USED FOR HANDICAP PARKING STALLS.
- 3. INSTALL EACH WITH TWO DOWELS PER MANUFACTURERS


### **CONCRETE WHEEL STOP**

SCALE: N.T.S.

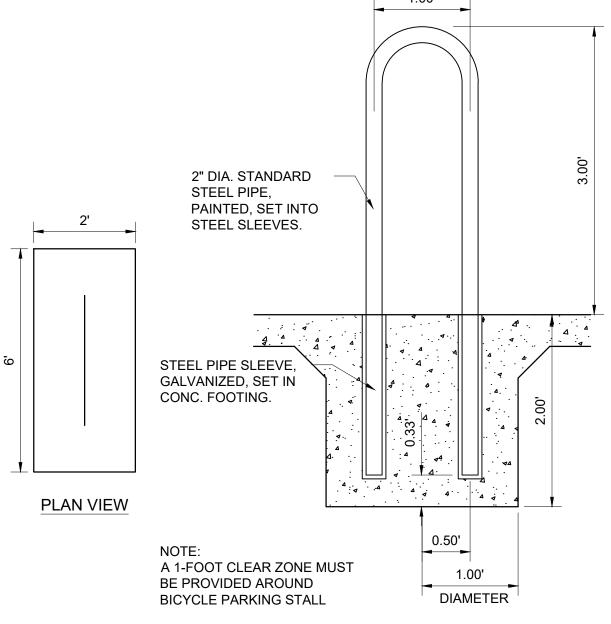


# **BICYCLE RACK**

SCALE: N.T.S.

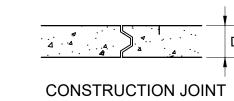

# - 1/2" PREMOLDED

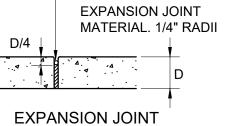

W/ 1/8" RADII. CONTRACTION / CONTROL

JOINT


- 1/4" TOOLED JOINT


### **GENERAL NOTES**

- 1. ODD-SHAPED AREAS OF PAVEMENT SHOULD BE AVOIDED TO MINIMIZE RANDOM CRACKING
- 2. LONGITUDINAL JOINT SPACING SHALL NOT EXCEED 12.5'
- 3. TRANSVERSE JOINT SPACING SHALL BE AT REGULAR INTERVALS OF 15'
- 4. OFFSETS AT RADIUS POINTS SHALL BE AT LEAST 1.5' WIDE


# **CONCRETE JOINTS**

SCALE: N.T.S.

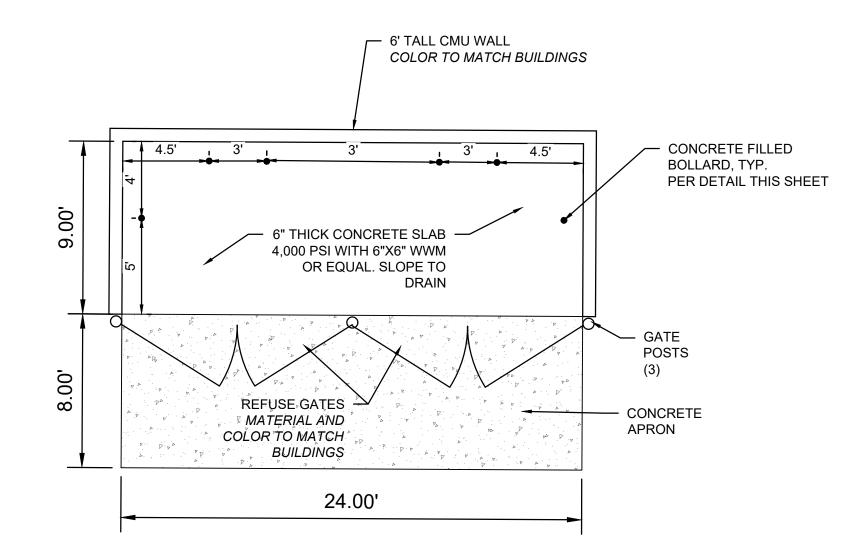

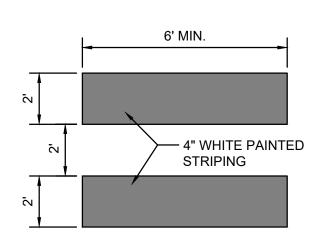


# PAINTED CROSSWALK MARKINGS

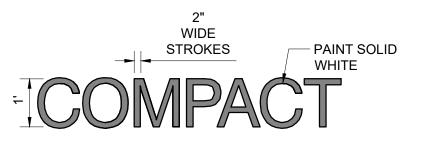

PAINTED 'COMPACT'

SCALE: N.T.S.

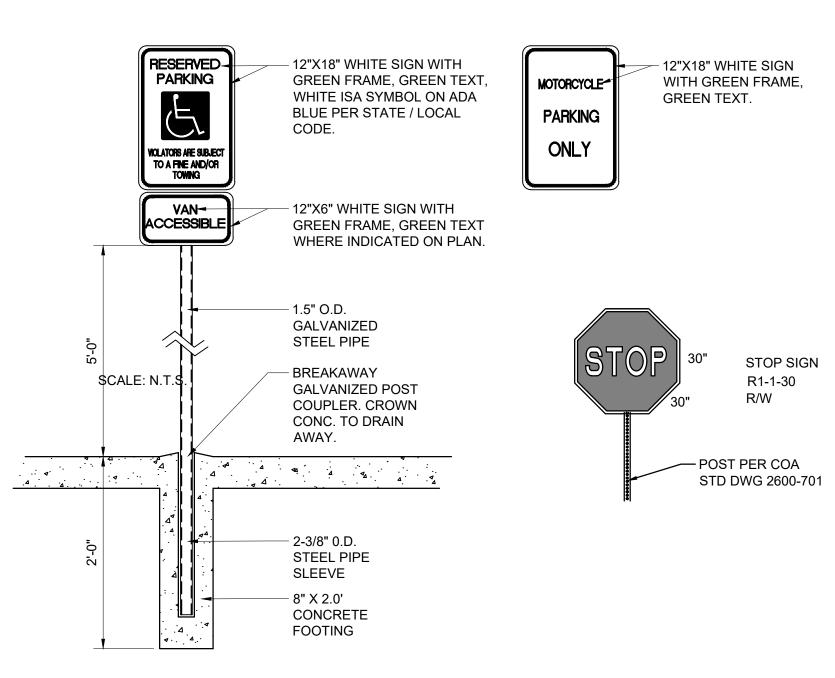

**SIGNAGE** 

SCALE: N.T.S.


SHEET NUMBER **CD-501** 

SHEET TITLE

SITE DETAILS

REFUSE ENCLOSURE

SCALE: N.T.S.

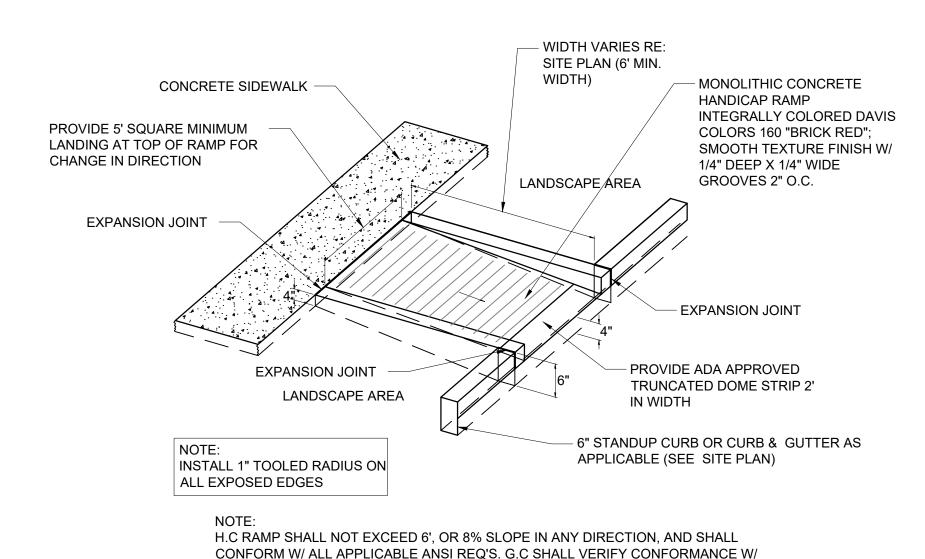


### ADA ACCESSIBLE RAMP NOTES

### **KEYED NOTES**

- A PCC LANDING AREA AT 2% SLOPE (MAX.) IN ALL DIRECTIONS.
- B PCC RAMP AT 8.3% MAX. SLOPE OR 15' LONG (MAX.) AND 2% MAX CROSS SLOPE.
- © 2' DETECTABLE WARNING SURFACE (TRUNCATED DOMES). CAST IN PLACE, REPLACEABLE.
- $\langle D \rangle$  6" HEADER CURB PER COA STD DWG #2415B.
- (E.) ADA PARKING SIGN. SEE DETAIL THIS SHEET.
- F. ADA PARKING STALL / ACCESS AISLE AT 2% SLOPE (MAX.) IN ALL DIRECTIONS

### **DETECTABLE WARNING SURFACE NOTES**

- 1. DESIGN PER ADA ACCESSIBILITY GUIDELINES (ADAAG).
- 2. PAYMENT FOR DETECTABLE WARNING SURFACE IS INCIDENTAL TO ADA ACCESSIBLE RAMP PAYMENT ITEM.
- 3. SUBMIT SPECS TO CONSTRUCTION ENGINEER FOR EVALUATION PRIOR TO CONSTRUCTION.
- 4. DETECTABLE WARNING SURFACE TO BE A PRODUCT THAT IS CAST-IN-PLACE AND REPLACABLE.
- 5. SEGMENTED DETECTABLE WARNING SURFACE AT BACK OF CURB TO BE CUT AND FIT PER MANUFACTURER'S INSTRUCTIONS. THE DETECTABLE WARNING SURFACE SHALL BE NO MORE THAN 5" FROM BACK OF CURB.

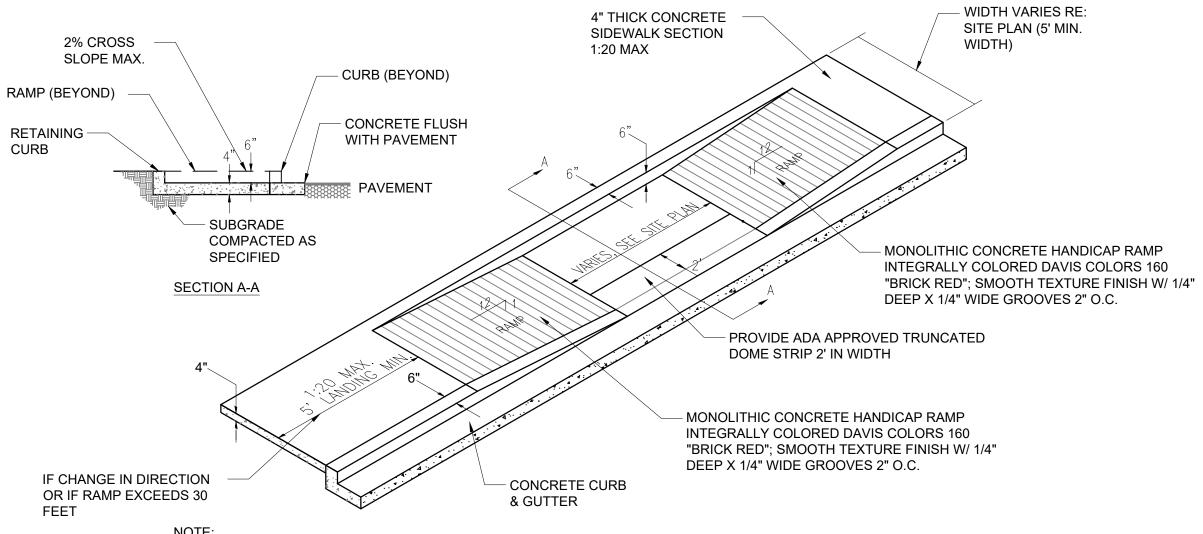

H.C RAMP SHALL NOT EXCEED 6', OR 8% SLOPE IN ANY DIRECTION, AND SHALL CONFORM W/ ALL APPLICABLE ANSI REQ'S. G.C SHALL VERIFY CONFORMANCE W/ ALL APPLICABLE ANSI REQ'S


# **ADA TAPERED RAMP DETAIL**

SCALE: N.T.S.

# PAINT FIELD ADA BLUE PAINT WHITE 2'-8" 3'-0"

SCALE: N.T.S.

**ACCESSIBILITY SYMBOL** 

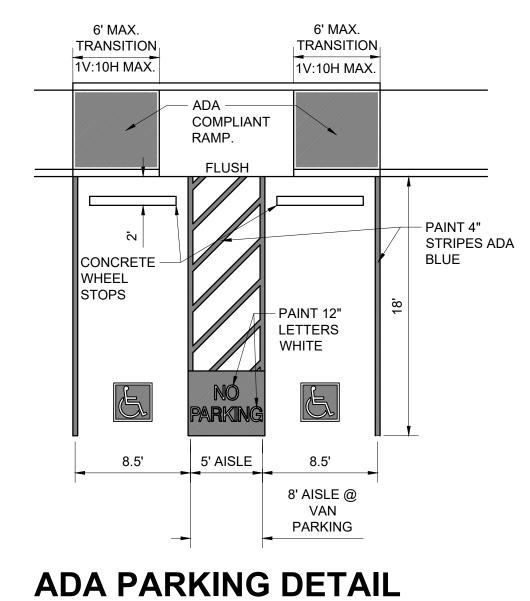

te Description

DESIGN
ISSUE: DEVELOPMENT
PROJECT NUMBER: IA 2471
FILE:

PROJECT NUMBER: BJB/tho
CHECKED BY: FCA

© 2020 Isaacson & Arfman, Inc.

This design, calculations, and concepts are owned by and

remain the property of Isaacson &

Arfman, Inc. and no part thereof

shall be utilized by any person,

firm or corporation for any purpose whatsoever except with

the written permission of Isaacson & Arfman, Inc.

e Rock Mexico

Eagle New N

querque,

San J Albuc

Engineer

SHEET TITLE

SCALE: N.T.S.

SITE ADA DETAILS


SHEET NUMBER

**CD-502** 

ADA CURBED RAMP DETAIL

ALL APPLICABLE ANSI REQ'S

SCALE: N.T.S.

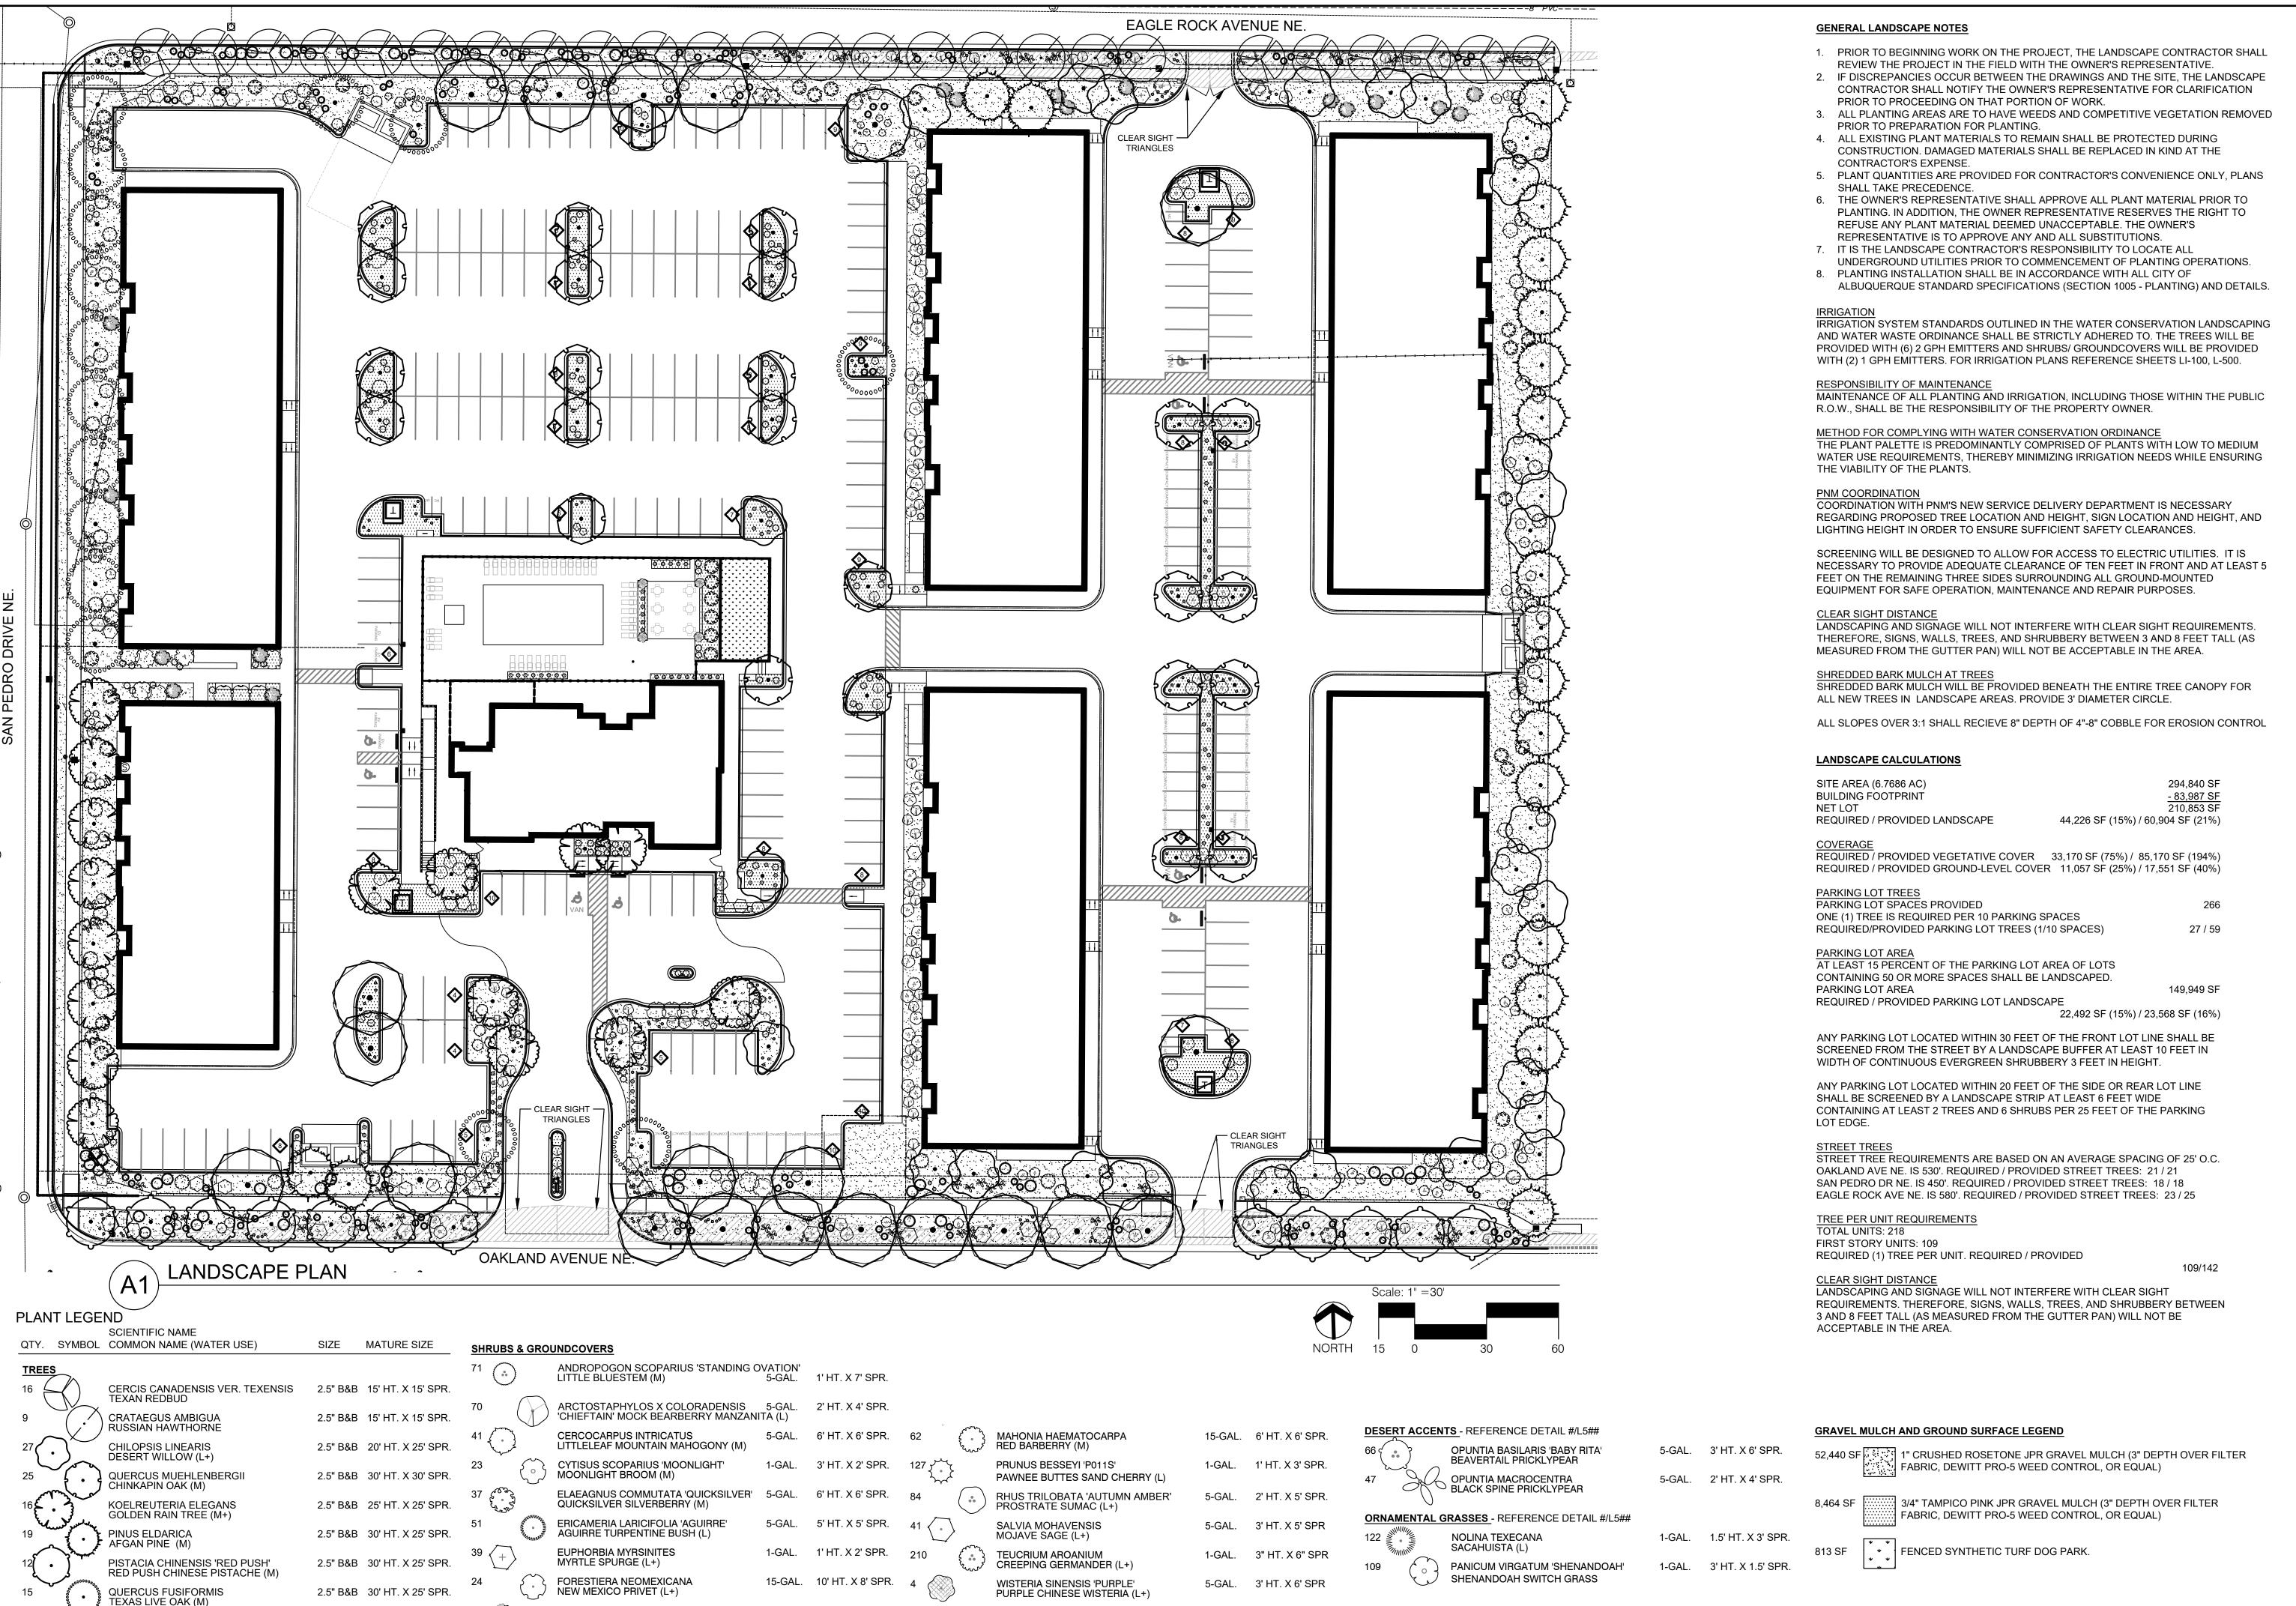

5-GAL. 4' HT. X 6' SPR.


MAHONIA AQUIFOLIUM 'COMPACTA'


COMPACT OREGON GRAPE (L+)

ULMUS JAPONICA X WILSONIANA

"MORTON' ACCOLADE ELM

2.5" B&B 35' HT. X 30' SPR.

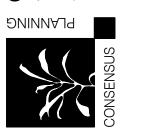

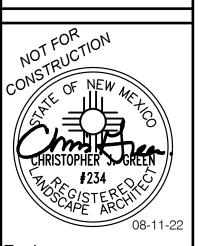

ngineer

Mexico


dn


SHEET TITLE

LANDSCAPE **PLAN** 

SHEET NUMBER

**LP100** 

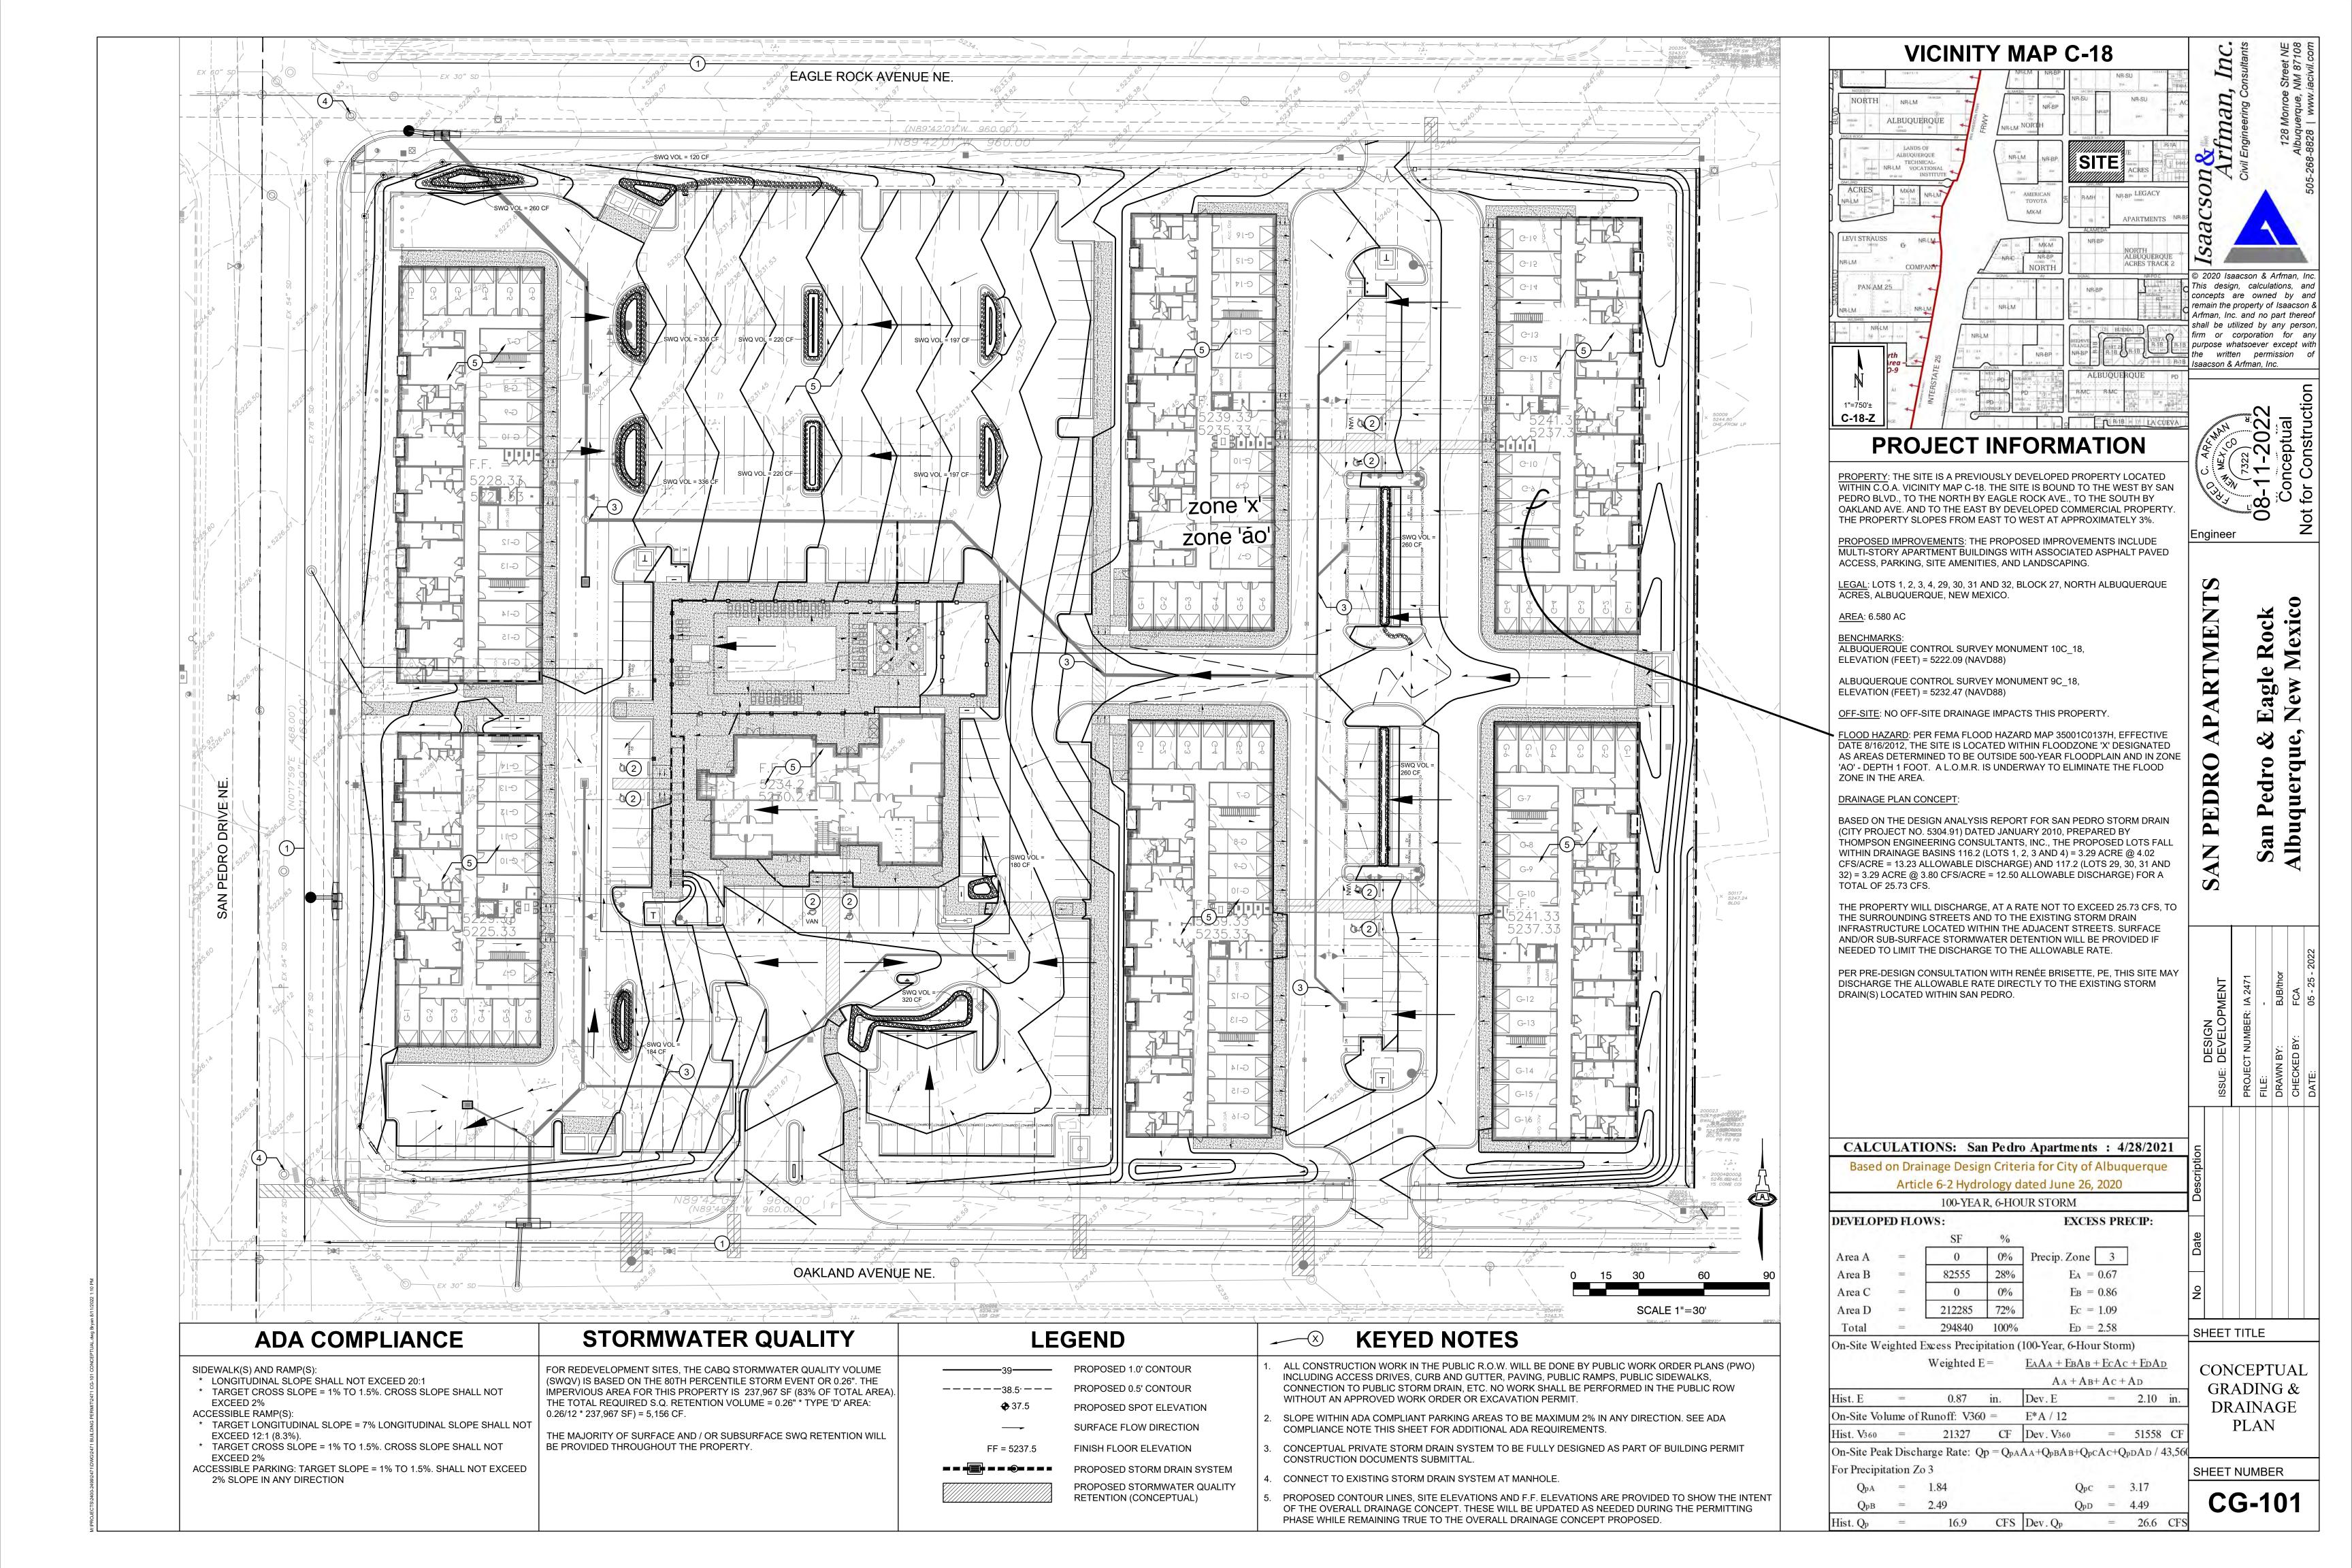

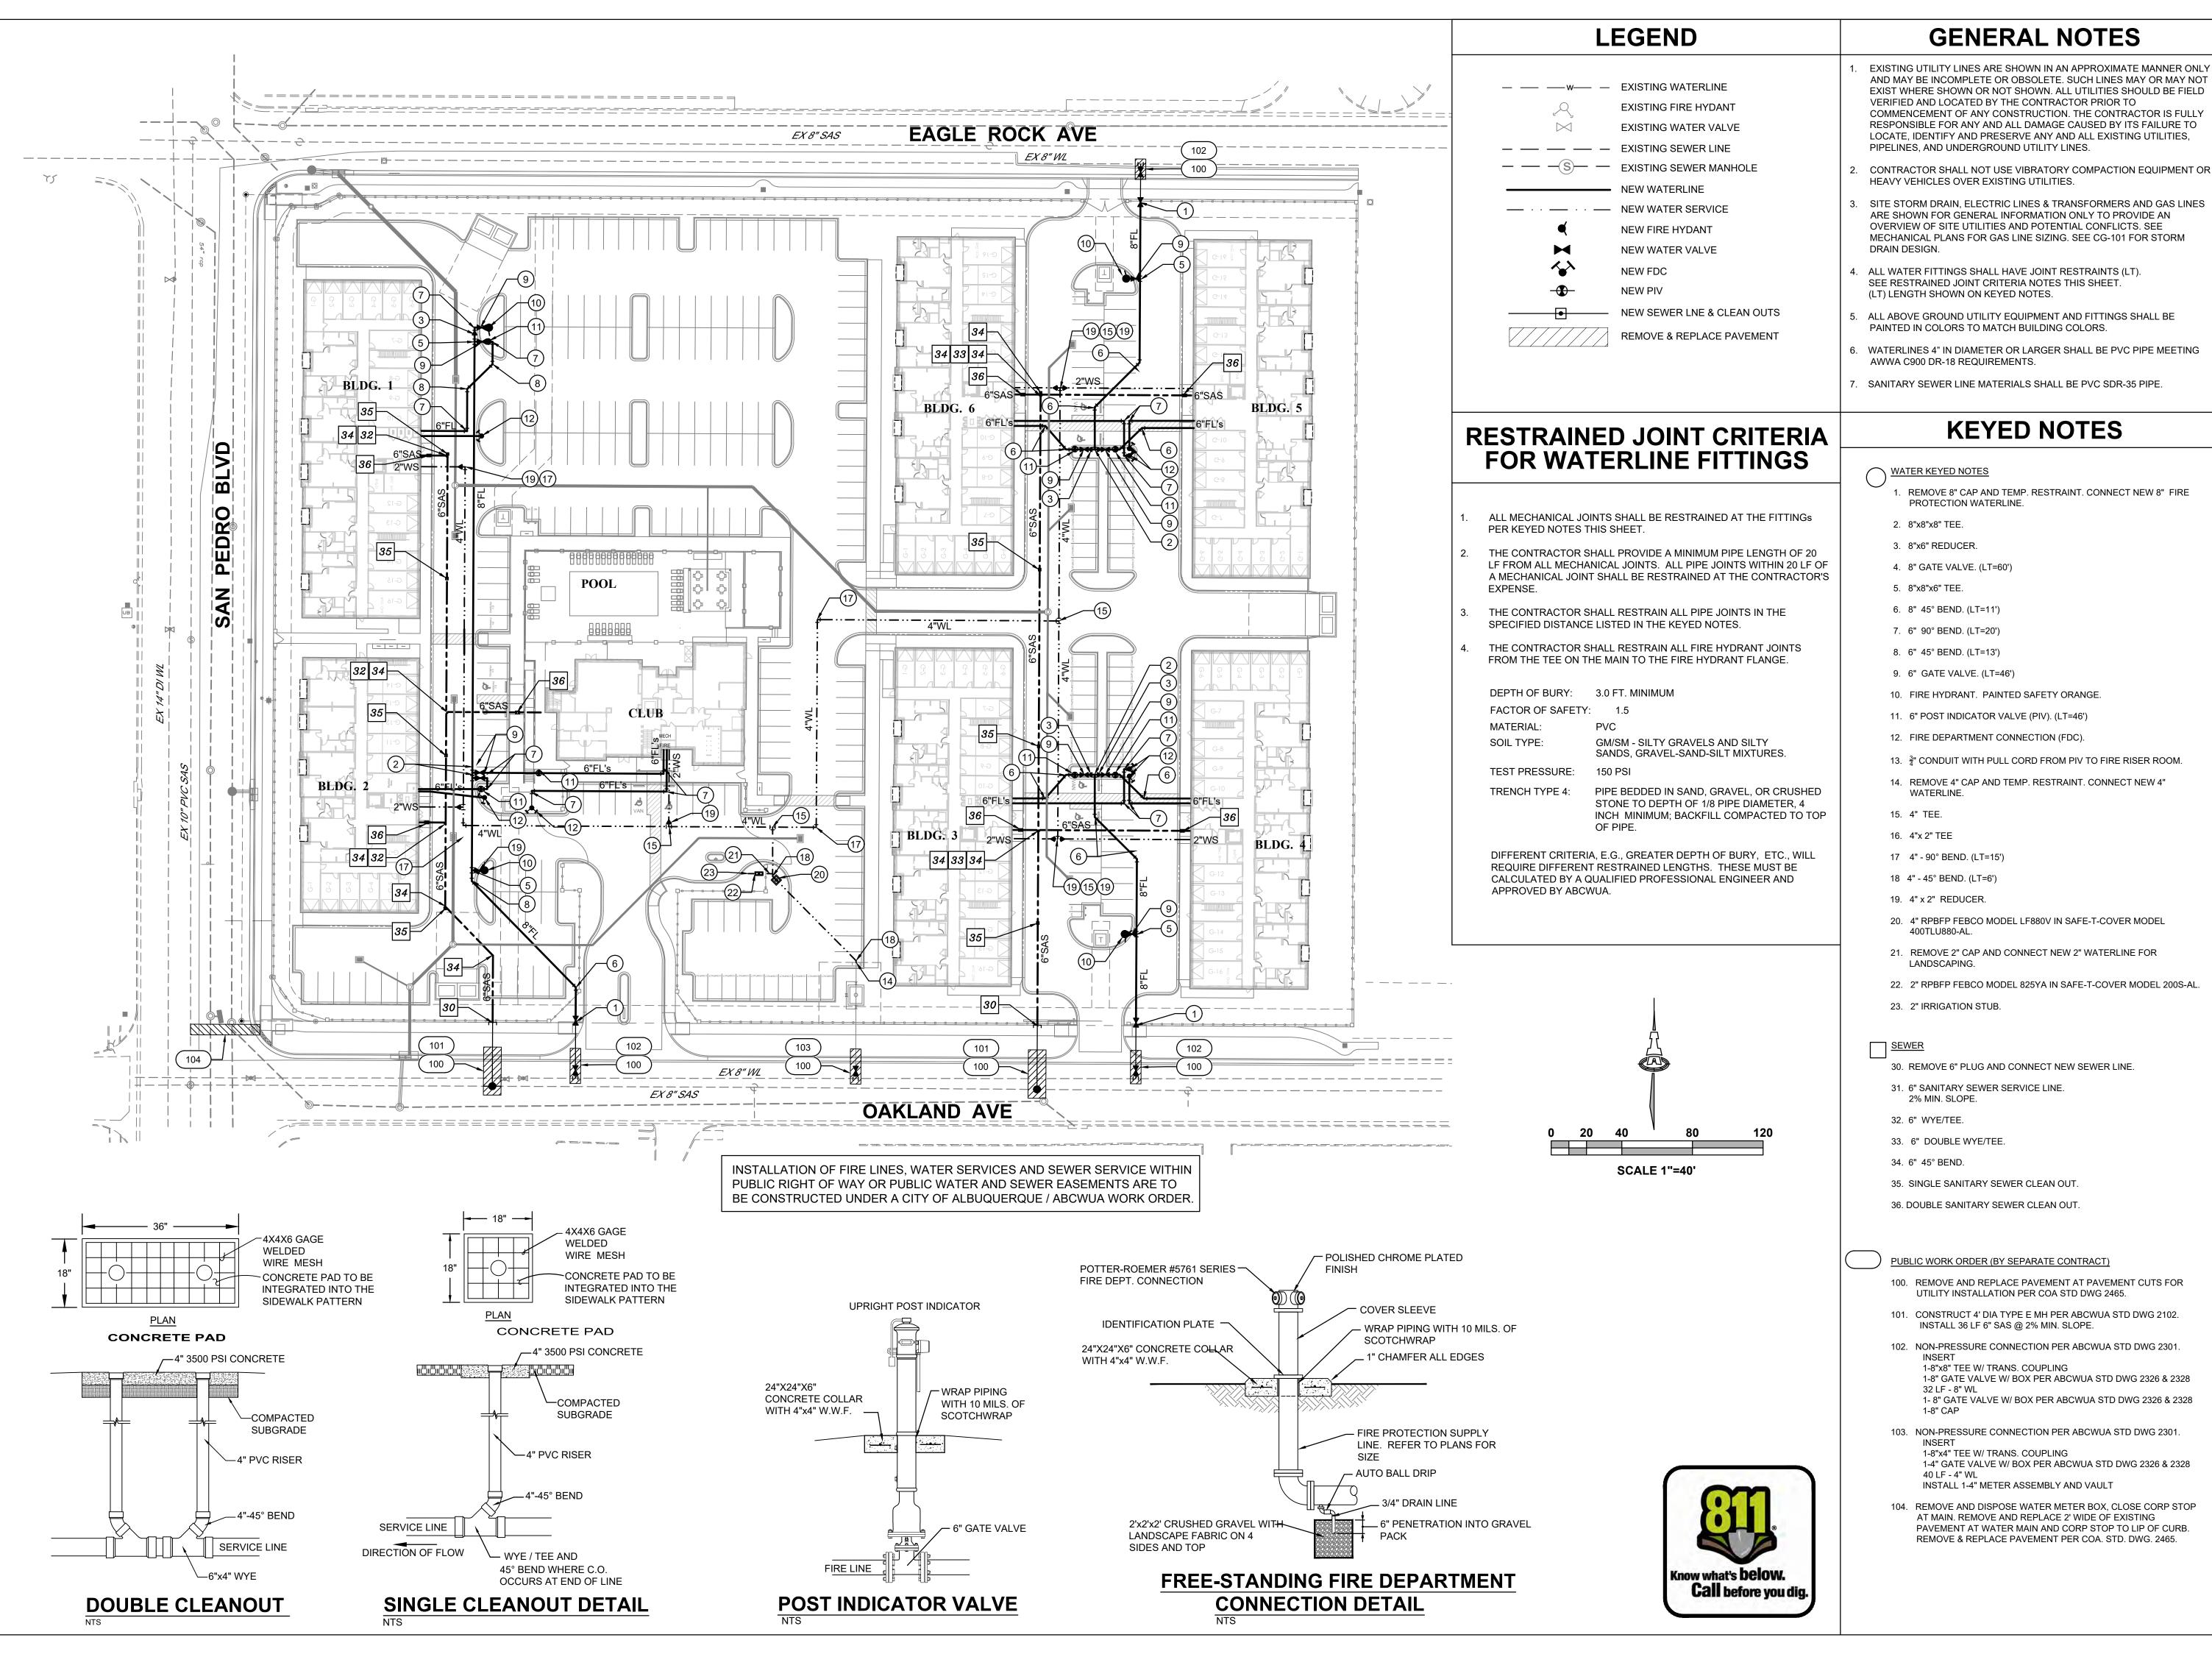

This design, calculations, and oncepts are owned by and emain the property of Isaacson & shall be utilized by any person, irm or corporation for any purpose whatsoever except with the written permission of Isaacson & Arfman, Inc.

08/11/2022 |Engineer

e Rock Mexico


**O** erqu

SHEET TITLE

CONCEPTUAL UTILITY PLAN

SHEET NUMBER

**CU-101** 

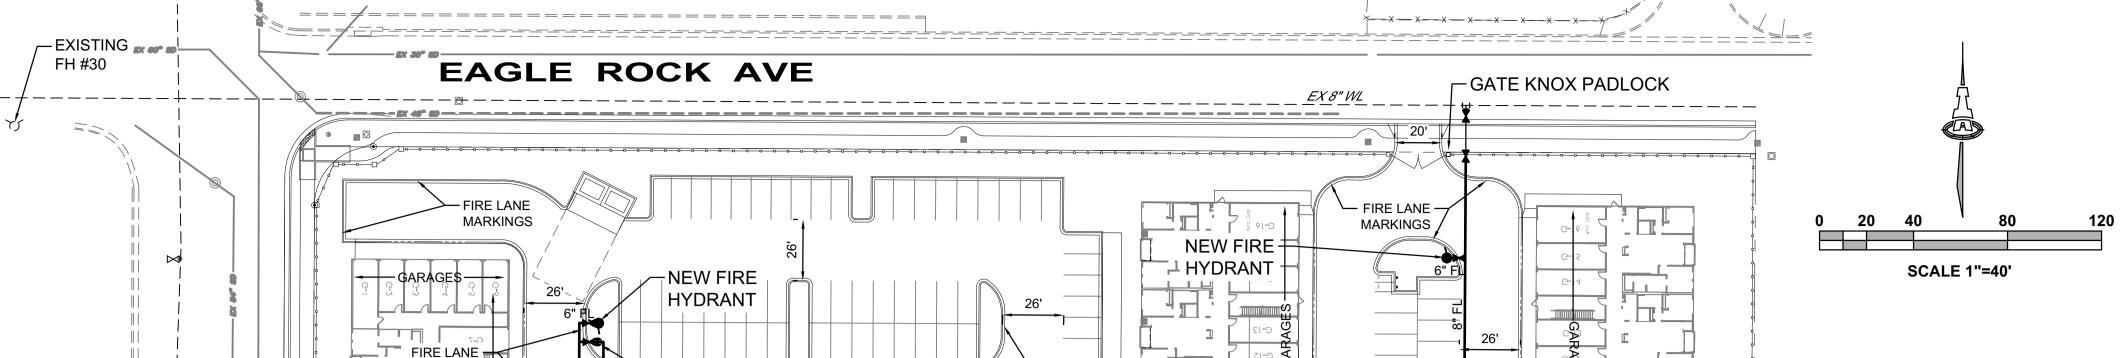



9320 SAN PEDRO DR N.E., ALBUQUERQUE, NM 87113

122 UNIT APARTMENT COMPLEX

ALL BUILDINGS ARE SPRINKELED, NFPA-13-R

FIRE FLOW IS 4250 / 2 = 2125 GPM.

MAX. BUILDING HEIGHT IS 41'-4  $\frac{1}{2}$ " NO STAND PIPE IS REQUIRED. HIGHEST 3RD FLOOR LEVEL IS 23'-3"

2 EXISTING FIRE HYDRANTS NEAR SITE

ALL FIRE DEPARTMENT CONNECTIONS SHALL HAVE A MINIMUM DISTANCE OF 3' FROM ANY PERMANENT OBJECTS.

ALL BUILDINGS HAVE KNOX BOXES AT **ENTRANCES** 

ADDRESS / DIRECTION BOARDS TO BE INSTALLED AT ALL ENTRANCES TO INDICATE

ALL GATES ARE ELECTRICALLY OPERATED WITH A KNOX KEY SWITCH. EMERGENCY ACCESS CRASH GATE FROM OAKLAND AVE.

ALL ACCESS ROADS AND FIRE LANES HAVE

ALL ACCESS ROADS AND FIRE PATHS WILL ACCOMMODATE A 28' MINIMUM TRUCK

FIRE APPARATUS ROADS SHALL HAVE AN UNOBSTRUCTED HEIGHT NOT LESS THAN 13'-6".

THERE ARE NO OVERHEAD OBSTRUCTIONS ON SITE TO PROHIBIT LADDER TRUCK **OPERATIONS** 

PREVIOUS FIRE 1 APPROVAL PERMIT NUMBER: FP 21-006042

OCCUPANCY GROUP R-2

ALL BUILDINGS ARE TYPE VA

4 NEW FIRE HYDRANTS

ALL BUILDINGS TO HAVE A PREMISS ID'S VISIBLE FROM ACCESS ROAD


LOCATION AND ADDRESS OF ALL BUILDINGS


WILL HAVE KNOX PADLOCK

GRADES LESS THAN 10% AND A LOAD CAPACITY OF 75,000 POUNDS.

TURNING RADIUS


APPROVED DATE: 06/16/22

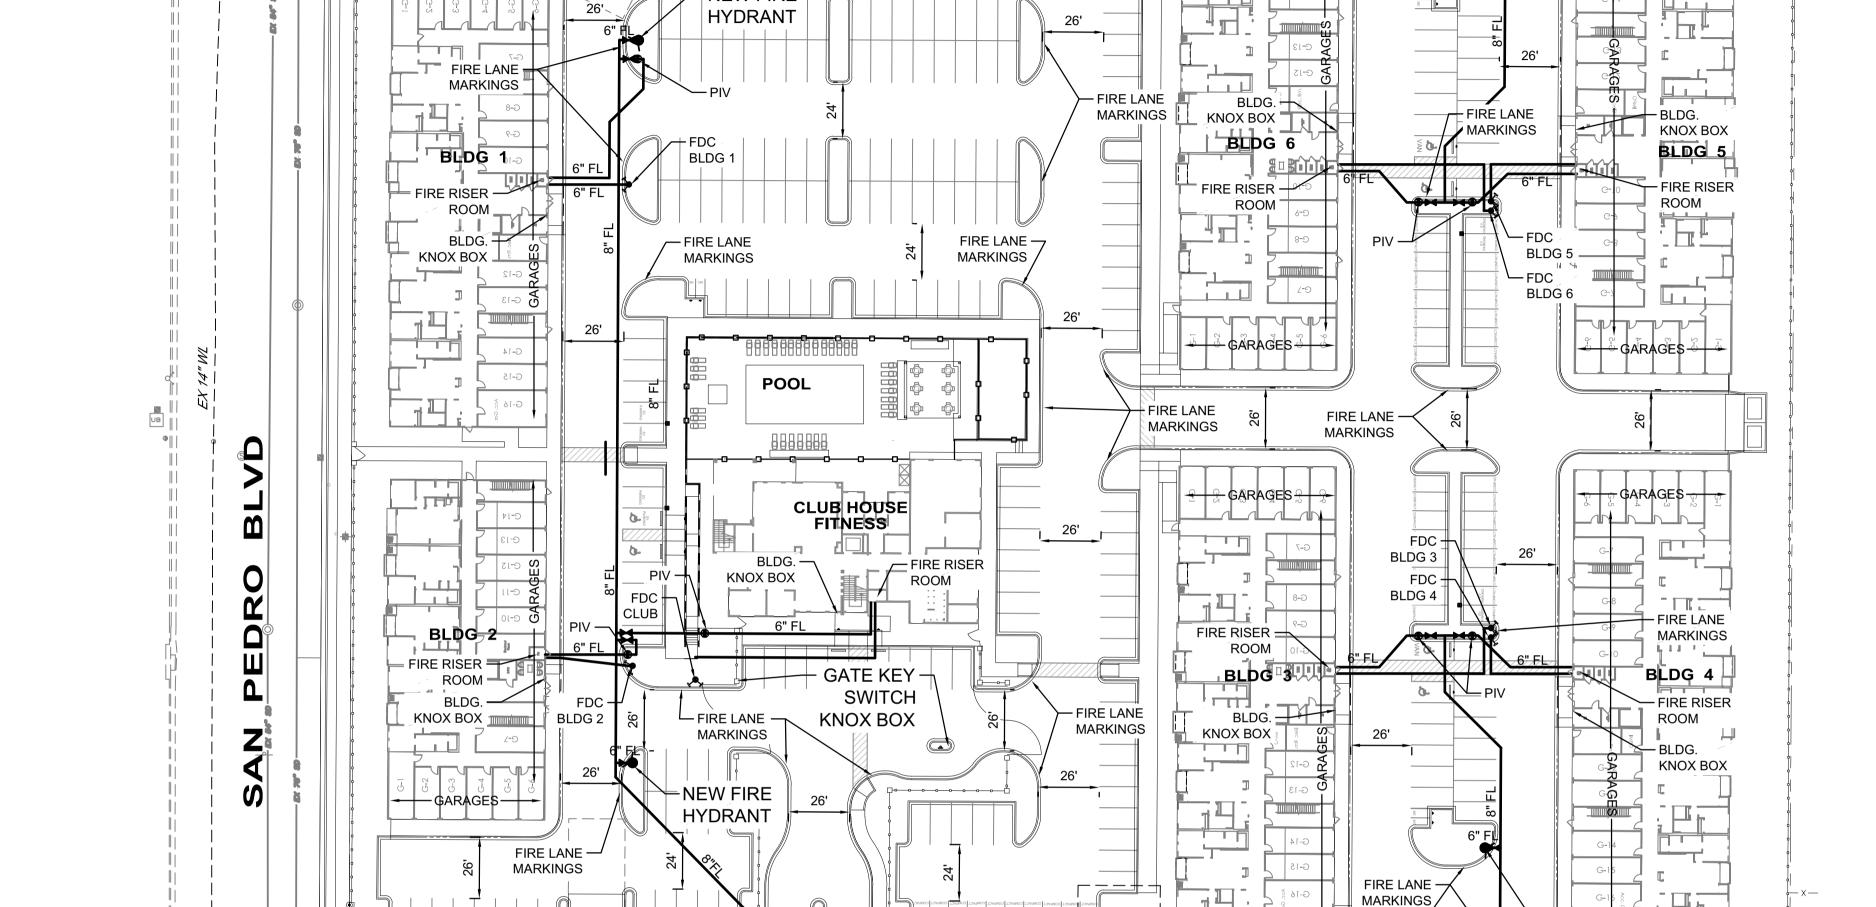

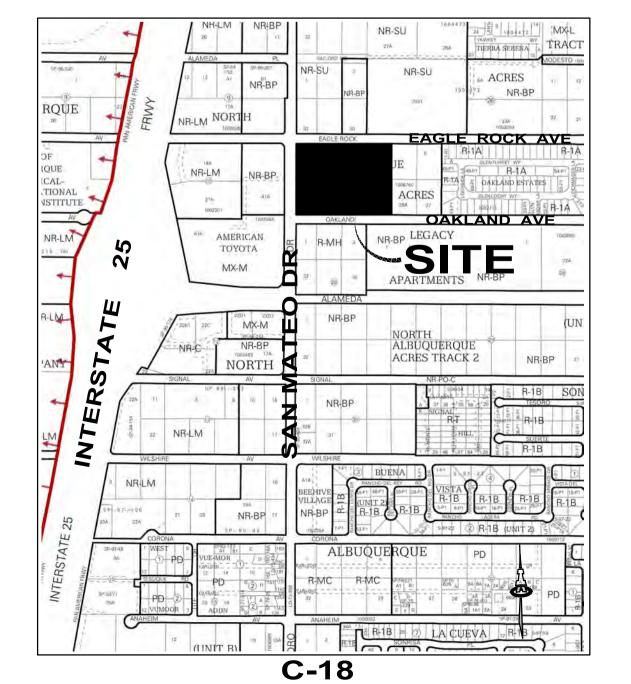

EXISTING -

FH #40

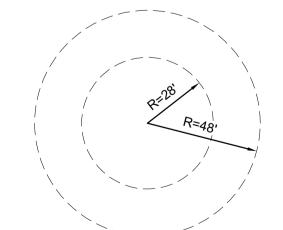

OAKLAND AVE

-NEW FIRE

HYDRANT

-GATE KNOX PADLOCK

SQ. FOOTAGE

13,460

10,187

6,500

EX 8" WL

BUILDING

1, 3-6

CLUB HOUSE / FITNESS

FIRE APPARATUS TURNING RADIUS

the written permission aacson & Arfman, Inc.

Engineer

San Albu SAN

SHEET TITLE **FIRE HYDRANT** LOCATION & ACCESS **PLAN** 

SHEET NUMBER

FIRE 1




FRONT ELEVATION SCALE= \frac{3}{32}": 1'-0"



LEFT ELEVATION


SCALE=  $\frac{3}{32}$ ": 1'-0"



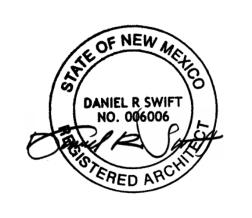

A1.01
EXTERIOR ELEVATIONS - BLDG A - 38 PLEX
EAGLE ROCK SITE



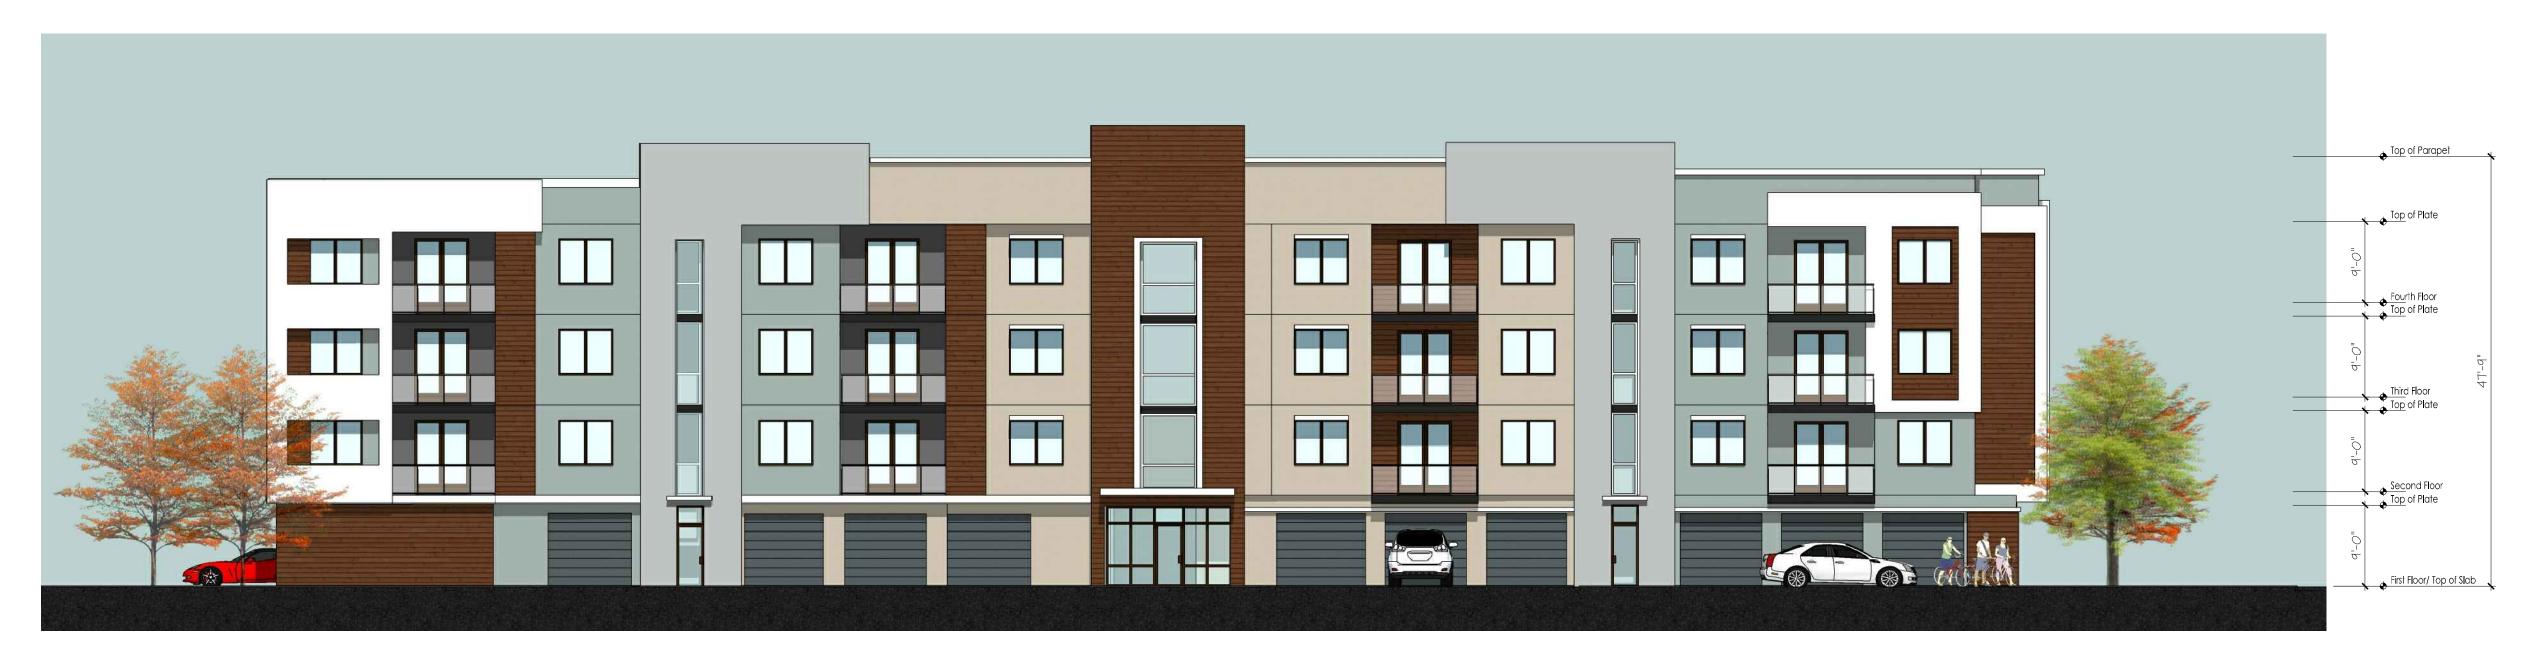

REAR ELEVATION

SCALE=  $\frac{3}{32}$ ": 1'-0"



RIGHT ELEVATION SCALE=  $\frac{3}{32}$ ": 1'-0"





A1.02
EXTERIOR ELEVATIONS - BLDG A - 38 PLEX
EAGLE ROCK SITE





FRONT ELEVATION SCALE=  $\frac{3}{32}$ ": 1'-0"



LEFT ELEVATION

SCALE=  $\frac{3}{32}$ ": 1'-0"





A2.01
EXTERIOR ELEVATIONS - BLDG B - 28 PLEX
EAGLE ROCK SITE





REAR ELEVATION

SCALE=  $\frac{3}{32}$ ": 1'-0"



RIGHT ELEVATION

SCALE=  $\frac{3}{32}$ ": 1'-0"





A2.02
EXTERIOR ELEVATIONS - BLDG B - 28 PLEX
EAGLE ROCK SITE





FRONT ELEVATION LEFT ELEVATION



REAR ELEVATION RIGHT ELEVATION





A3.01 EXTERIOR ELEVATIONS - COMMUNITY CLUBHOUSE EAGLE ROCK SITE





BLDG 1 & 3 - WEST ELEVATION - MAY 21 - 12 PM



BLDG 1 & 3 - WEST ELEVATION - MAY 21 - 9AM



BLDG 1 & 6 - EAST ELEVATION - MAY 21 - 12 PM



BLDG 1 & 3 - EAST ELEVATION - MAY 21 - 9AM



BLDG 1 & 3 - NORTH ELEV. - MAY 21 - 12 PM




BLDG 1 & 3 - SOUTH ELEV. - MAY 21 - 12 PM



BLDG 1 & 3 - NORTH ELEV. - MAY 21 - 9AM



BLDG 1 & 3 - SOUTH ELEV. - MAY 21 - 9AM

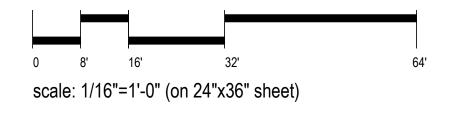

Frisco, Texas



# SS.01 SOLAR SHADE STUDY - BLDGs 1 & 3 EAGLE ROCK SITE





BLDG 1 & 3 - WEST ELEVATION - NOVEMBER 21 - 12 PM



BLDG 1 & 3 - WEST ELEVATION - MAY 21 - 4PM



BLDG 1 & 3 - EAST ELEVATION - NOVEMBER 21 - 12 PM



BLDG 1 & 3 - EAST ELEVATION - MAY 21 - 4PM



BLDG 1 & 3 - NORTH ELEV. - NOV. 21 - 12 PM




BLDG 1 & 3 - SOUTH ELEV. - NOV. 21 - 12 PM



BLDG 1 & 3 - NORTH ELEV. - MAY 21 - 4PM



BLDG 1 & 6 - SOUTH ELEV. - MAY 21 - 4PM

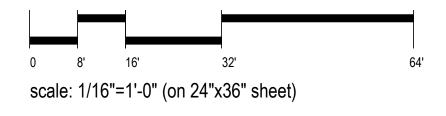

Frisco, Texas



SS.02
SOLAR SHADE STUDY - BLDG 1 & 3
EAGLE ROCK SITE







BLDG 2 - WEST ELEVATION - MAY 21 - 12 PM




BLDG 2 - WEST ELEVATION - MAY 21 - 9AM



BLDG 2 - EAST ELEVATION - MAY 21 - 12 PM




BLDG 2 - EAST ELEVATION - MAY 21 - 9AM

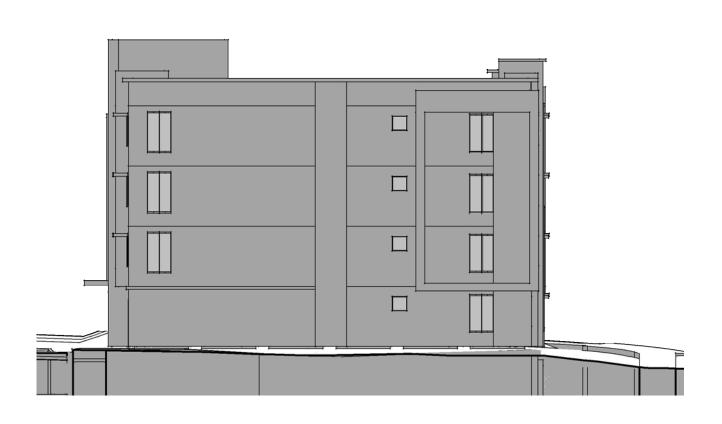


BLDG 2 - NORTH ELEV. - MAY 21 - 12 PM




BLDG 2- SOUTH ELEV. - MAY 21 - 12 PM

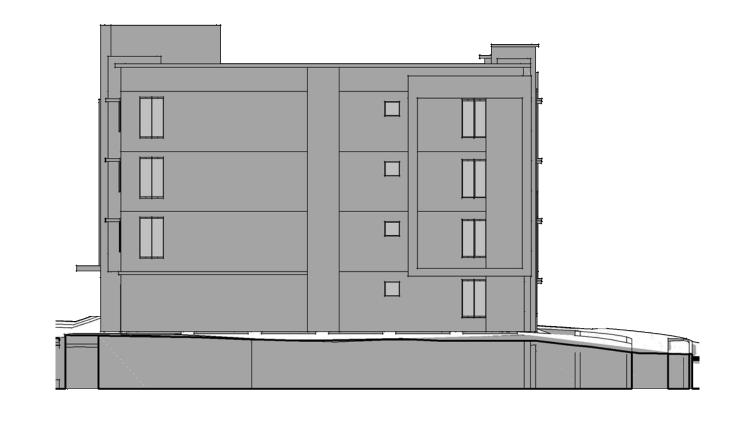


BLDG 2 - NORTH ELEV. - MAY 21 - 9AM

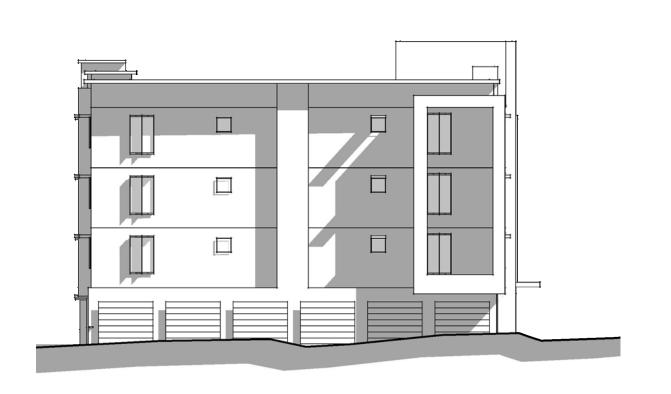

BLDG 2 - SOUTH ELEV. - MAY 21 - 9AM

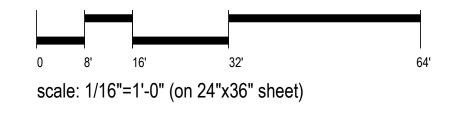

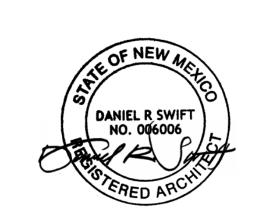







BLDG 2 - WEST ELEVATION - NOVEMBER 21 - 12 PM




BLDG 2 - WEST ELEVATION - MAY 21 - 4PM



BLDG 2 - EAST ELEVATION - NOVEMBER 21 - 12 PM




BLDG 2 - EAST ELEVATION - MAY 21 - 4PM

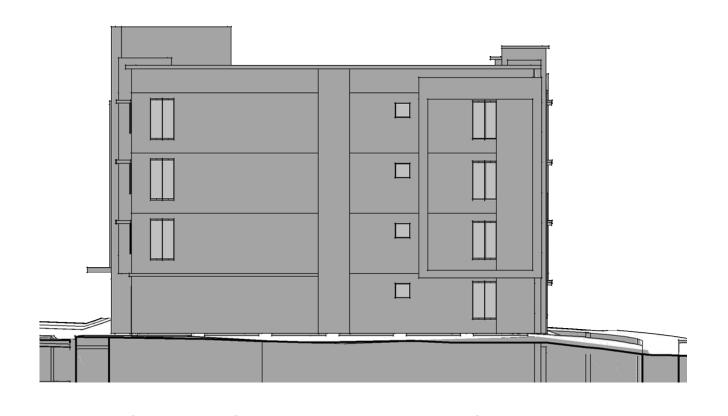


BLDG 2 - NORTH ELEV. - NOV. 21 - 12 PM




BLDG 2 - SOUTH ELEV. - NOV. 21 - 12 PM

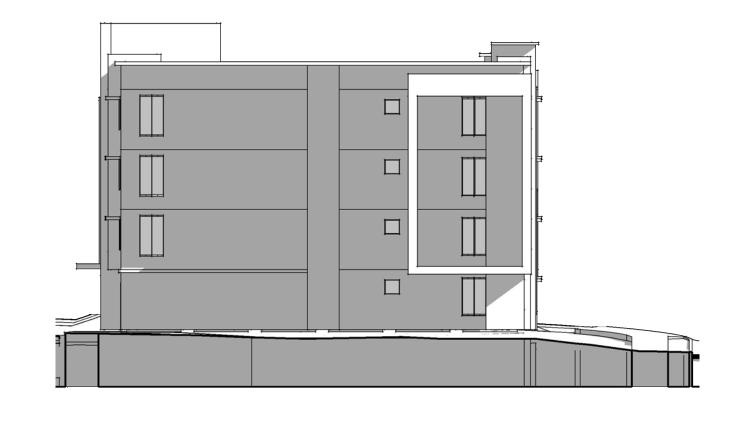


BLDG 2 - NORTH ELEV. - MAY 21 - 4PM

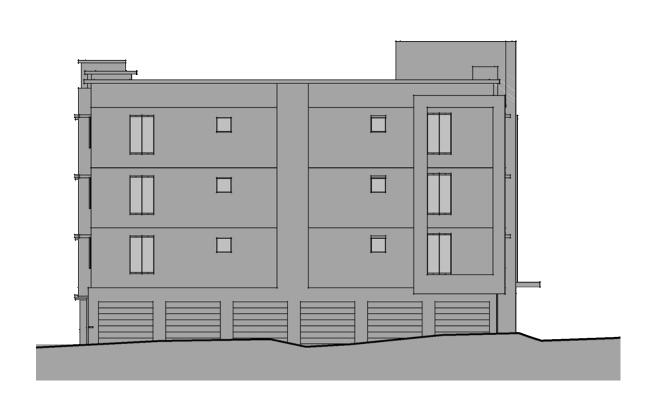

BLDG 2 - SOUTH ELEV. - MAY 21 - 4PM

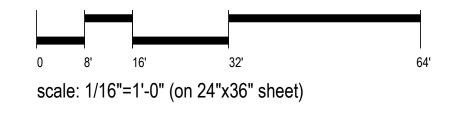

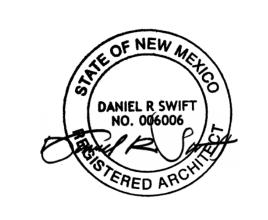









BLDG 4- WEST ELEVATION - MAY 21 - 12 PM




BLDG 4- WEST ELEVATION - MAY 21 - 9AM



BLDG 4 - EAST ELEVATION - MAY 21 - 12 PM




BLDG 4 - EAST ELEVATION - MAY 21 - 9AM

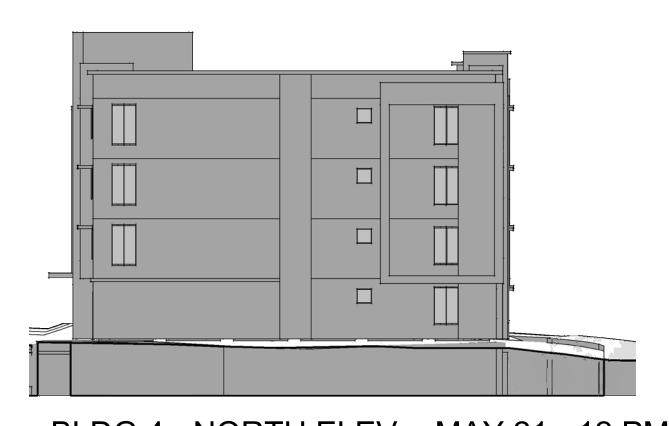

BLDG 4 - NORTH ELEV. - MAY 21 - 12 PM




BLDG 4 - SOUTH ELEV. - MAY 21 - 12 PM

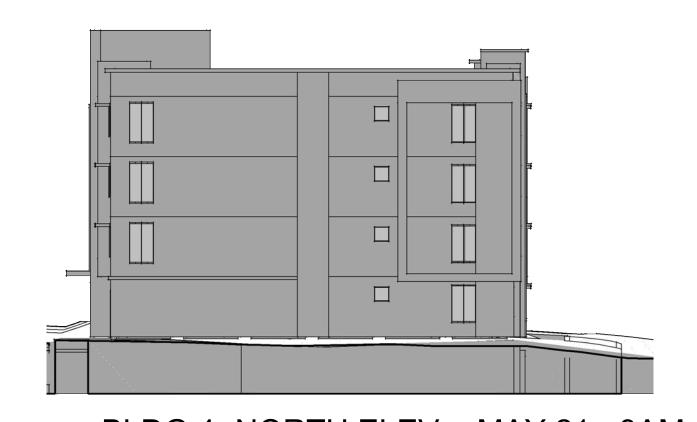


BLDG 4- NORTH ELEV. - MAY 21 - 9AM



BLDG 4 - SOUTH ELEV. - MAY 21 - 9AM

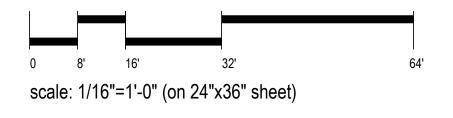

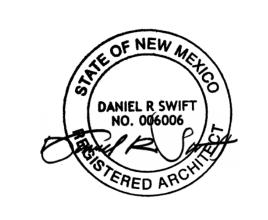









BLDG 4 - WEST ELEVATION - NOVEMBER 21 - 12 PM



BLDG 4 - WEST ELEVATION - MAY 21 - 4PM



BLDG 4 - EAST ELEVATION - NOVEMBER 21 - 12 PM




BLDG 4 - EAST ELEVATION - MAY 21 - 4PM



BLDG 4 - NORTH ELEV. - NOV. 21 - 12 PM




BLDG 4 - SOUTH ELEV. - NOV. 21 - 12 PM

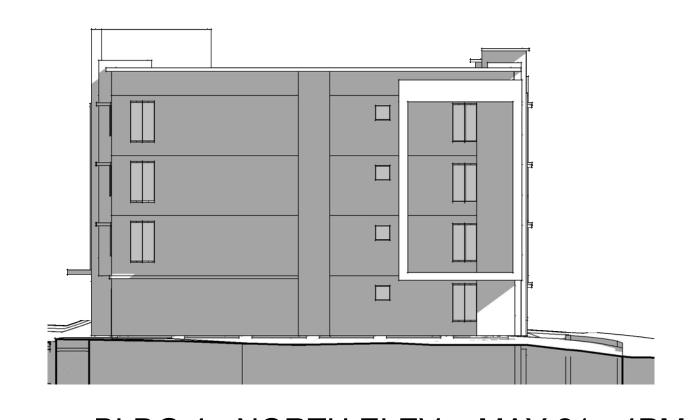

BLDG 4 - NORTH ELEV. - MAY 21 - 4PM



BLDG 4 - SOUTH ELEV. - MAY 21 - 4PM

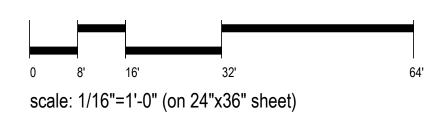











BLDG 5 - WEST ELEVATION - MAY 21 - 12 PM




BLDG 5 - WEST ELEVATION - MAY 21 - 9AM



BLDG 5 - EAST ELEVATION - MAY 21 - 12 PM




BLDG 5 - EAST ELEVATION - MAY 21 - 9AM

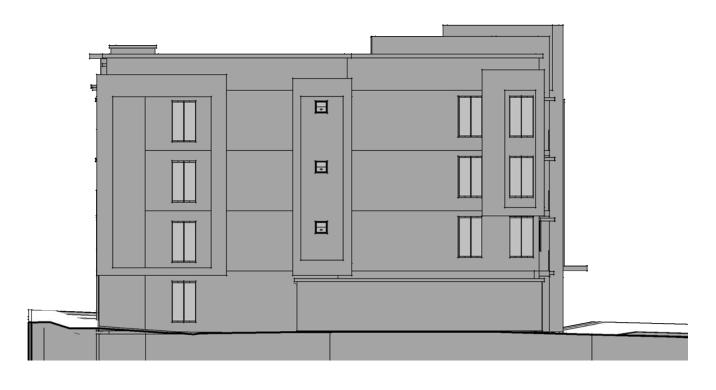

BLDG 5 - NORTH ELEV. - MAY 21 - 12 PM




BLDG 5 - SOUTH ELEV. - MAY 21 - 12 PM

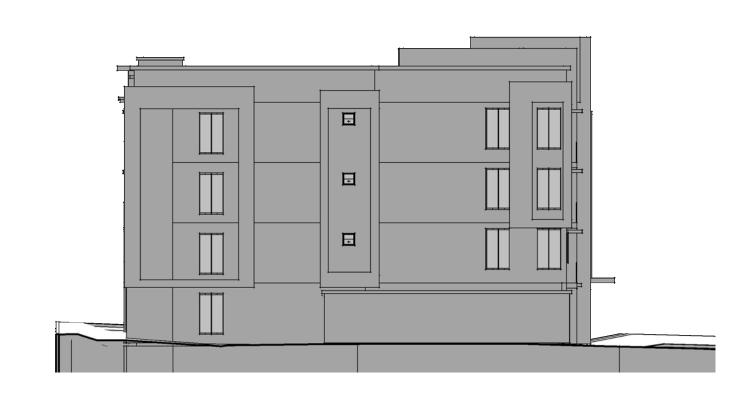

BLDG 5 - NORTH ELEV. - MAY 21 - 9AM



BLDG 5 - SOUTH ELEV. - MAY 21 - 9AM

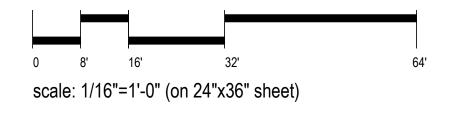









BLDG 5 - WEST ELEVATION - NOVEMBER 21 - 12 PM




BLDG 5 - WEST ELEVATION - MAY 21 - 4PM



BLDG 5 - EAST ELEVATION - NOVEMBER 21 - 12 PM




BLDG 5 - EAST ELEVATION - MAY 21 - 4PM

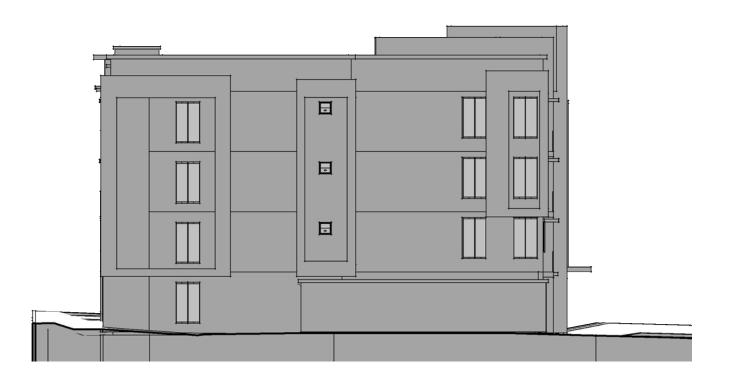

BLDG 5 - NORTH ELEV. - NOV. 21 - 12 PM




BLDG 5 - SOUTH ELEV. - NOV. 21 - 12 PM

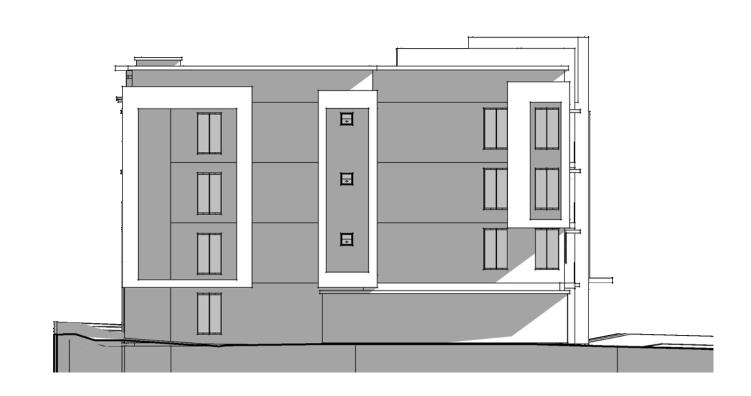


BLDG 5 - NORTH ELEV. - MAY 21 - 4PM



BLDG 5 - SOUTH ELEV. - MAY 21 - 4PM

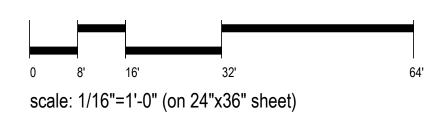



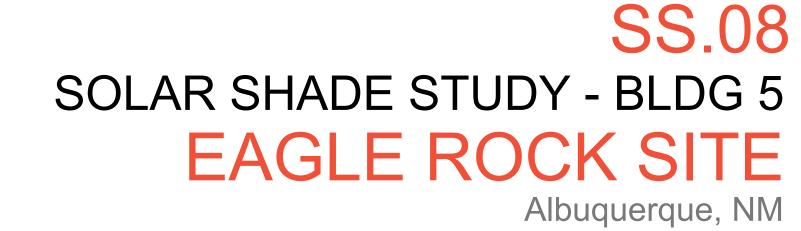





BLDG 6 - WEST ELEVATION - MAY 21 - 12 PM




BLDG 6 - WEST ELEVATION - MAY 21 - 9AM



BLDG 6 - EAST ELEVATION - MAY 21 - 12 PM




BLDG 6 - EAST ELEVATION - MAY 21 - 9AM

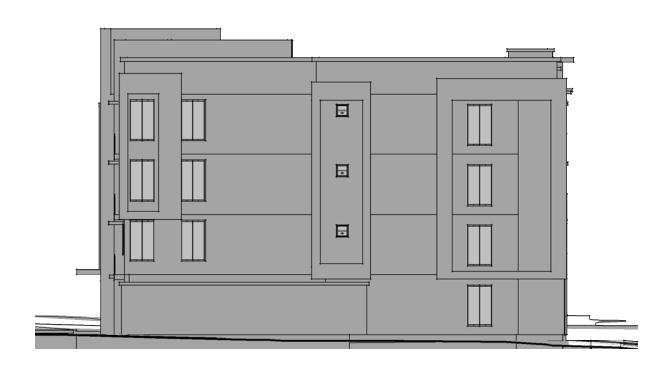


BLDG 6 - NORTH ELEV. - MAY 21 - 12 PM




BLDG 6 - SOUTH ELEV. - MAY 21 - 12 PM

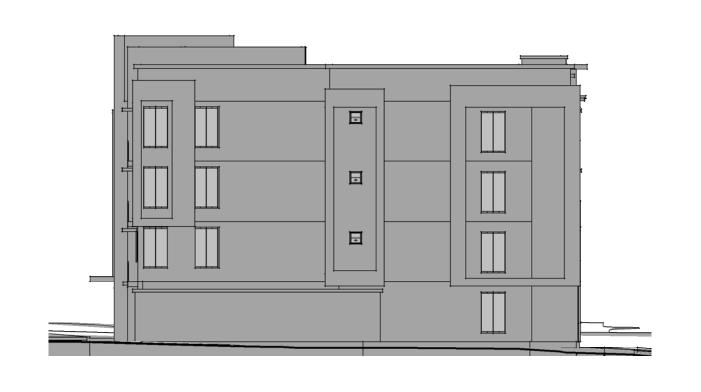

BLDG 6 - NORTH ELEV. - MAY 21 - 9AM

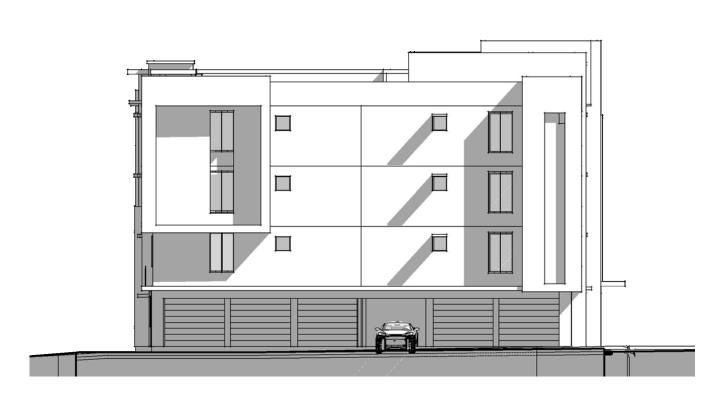

BLDG 6 - SOUTH ELEV. - MAY 21 - 9AM

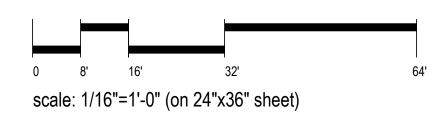











BLDG 6 - WEST ELEVATION - NOVEMBER 21 - 12 PM




BLDG 6 - WEST ELEVATION - MAY 21 - 4PM



BLDG 6 - EAST ELEVATION - NOVEMBER 21 - 12 PM



BLDG 6 - EAST ELEVATION - MAY 21 - 4PM

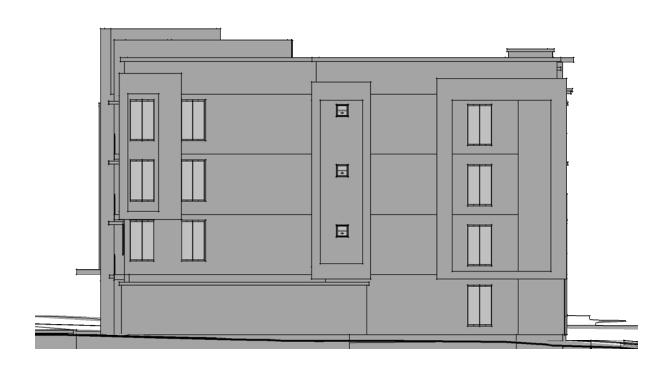

BLDG 6 - NORTH ELEV. - NOV. 21 - 12 PM




BLDG 6 - SOUTH ELEV. - NOV. 21 - 12 PM




BLDG 6 - NORTH ELEV. - MAY 21 - 4PM



BLDG 6 - SOUTH ELEV. - MAY 21 - 4PM

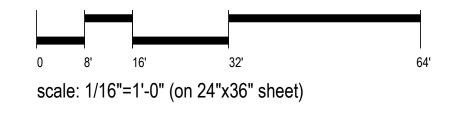

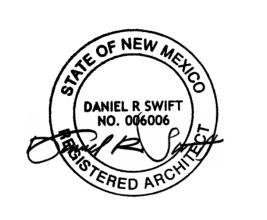












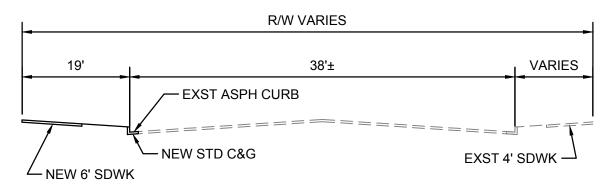


# OAKLAND AVE NE

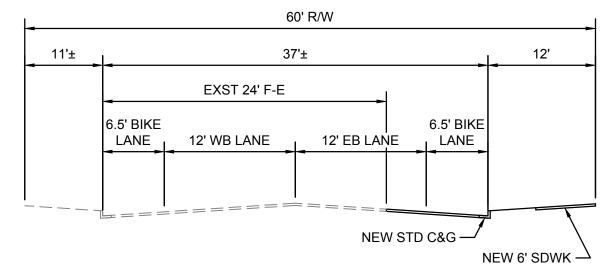

EAGLE ROCK AVE NE

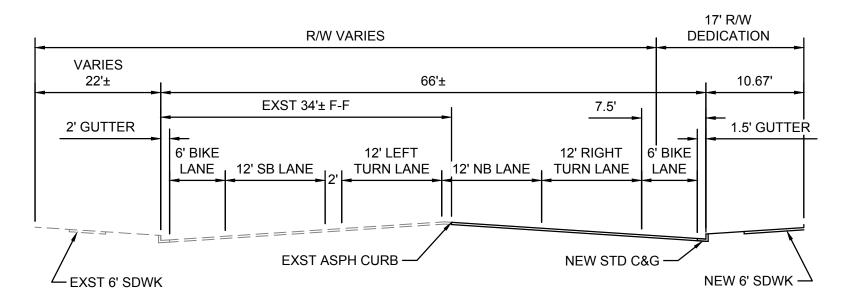

# SAN PEDRO DR NE

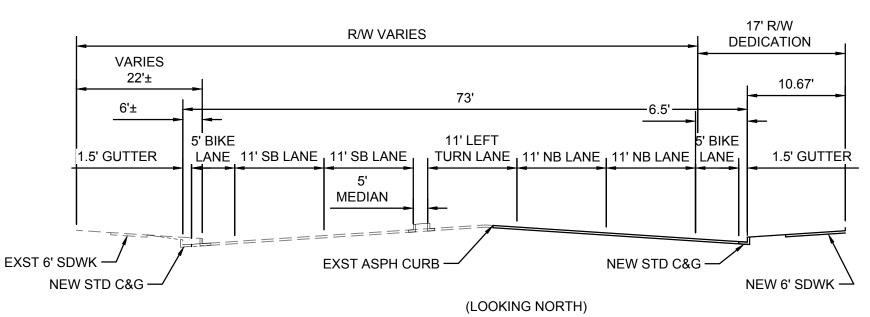

# FUTURE SAN PEDRO DR NE

### SAN PEDRO APARTMENTS STREET SECTIONS

07/21/2022



August 5, 2022

City of Albuquerque Planning Department 600 2<sup>nd</sup> Street NW Albuquerque, NM 87102

Re: Deviation Request for San Pedro Apartments Site Plan

Landscape Architecture Urban Design Planning Services

302 Eighth St. NW Albuquerque, NM 87102

(505) 764-9801 Fax 842-5495 cp@consensusplanning.com www.consensusplanning.com Dear Ms. Wolfley:

The purpose of this letter is to request approval of a Deviation of 2.5 feet to the minimum landscaped edge buffer width between industrial development and non-industrial development on behalf of GTA San Pedro, LLC (Applicant). The Applicant proposes to develop a 218-unit multi-family residential development on the property located at 9320 San Pedro Drive NE (see Figure 1 below). The legal description of the site is Lots 1 through 4 and 29 through 32, Block 27, Tract A, Unit B, North Albuquerque Acres. The location of the landscape buffer in question at the northeast corner of the site adjacent to Eagle Rock Avenue.



Figure 1: Site Location on San Pedro Drive between Oakland Avenue and Eagle Rock Avenue.

The site is zoned R-MH (Residential, Multi-family High Density), which allows for the proposed development permissively. The Environmental Planning Commission (EPC) approved the Zoning Map Amendment that facilitates the Site Plan in 2021. The site is in the North Albuquerque Community Planning Area and designated an Area of Consistency by the Comprehensive Plan.

### **PRINCIPALS**

James K. Strozier, FAICP Christopher J. Green, PLA, ASLA, LEED AP Jacqueline Fishman, AICP



### **Deviation Justification**

As previously described, a Deviation of 2.5 feet to the landscape buffer requirement at the northeast corner of the site is requested in conjunction with the Site Plan approval. Per IDO Section 6-4(P), the relevant decision-making body may approve a requested deviation within the limits of Table 6-4-1, if they determine the following criteria are met. The proposed request represents a Deviation of 10% of the 25-foot required buffer. Up to a maximum Deviation of 10% is allowable per Table 6-4-1 for "other numerical standards," of which the edge buffer width falls. The request is justified according to the criteria in IDO Section 14-16-6-4(P)(3) as described below (our responses are provided in italics following each of the criteria):

6-4(P)(3)(a) The applicant's site is subject to site constraints not generally shared by surrounding properties or the site was platted or developed in an unusual pattern when compared to abutting properties (e.g., the property was developed with orientation or access facing a different street than abutting lots) that would prevent the development of a permissive land use in a type of structure generally found on sites of a similar size in the surrounding area.

Applicant's Response: The subject site includes site constraints not generally shared by the surrounding properties. The property is located adjacent to the City of Albuquerque's Eagle Rock Convenience Center to the northeast of the site, which is only one of three Solid Waste convenience centers in the city. As a very popular service to the citizens of Albuquerque, there is significant traffic queuing around the subject site on the north and west sides of the property, and the City initiates roadway closures during peak times to manage these conditions. As such, and based on feedback from the Solid Waste Department, the Applicant has voluntarily agreed to limit resident and visitor access to the site to the south side only. The site also includes a significant elevation change from east to west, so the grading plans and building orientations are critical elements to the site design. In order to accommodate the entrances on the south side of the site with appropriate slopes entering and existing the property, the buildings cannot be shifted too far in that direction. These buildings are of similar size and scale to the other apartments in the surrounding area, including those to the south which only include landscape buffer areas along the northern edge between 15 and 22 feet in width.

6-4(P)(3)(b) The site constraints were not created by the actions of the property owner or another interested party.

Applicant's Response: These constraints were not created by actions of the property owner or other interested parties. Grading constraints are a function of the natural terrain, as well as the elevations that have been set by surrounding development, including the public roadways. Based on available case history, the previous use of the property pre-dates annexation by the City of Albuquerque, which is evidenced by the lack of roadway improvements along the site frontages. Further, the traffic issues leading to the proposed access limitations and requirements are not the fault of this property owner, but rather created by the presence of the City of



Albuquerque convenience center. The Applicant has shown a willingness to work within these constraints, but in doing so it creates practical difficulties with full compliance with the IDO requirements.

6-4(P)(3)(c) The request is for a single site and is not part of a pattern of similar requests for adjacent properties or for nearby sites by the same property owner or within the same subdivision, Framework Plan area, or Master Development Plan area.

Applicant's Response: This deviation request is for this single site and the proposed Site Plan. Adjacent properties contain different development types and are already built out. Other multi-family residential properties in the vicinity were constructed prior to adoption the IDO and this specific buffer requirement, so their buffers were not subject to these standards. Due to the subject site's location at the corner of San Pedro to the west and Eagle Rock to the north, this site is one of, if not, the most impacted by the traffic conditions.

6-4(P)(3)(d) The approval of the requested deviations will not cause material adverse impacts on surrounding properties.

Applicant's Response: Approval of the requested deviation will not cause material adverse impacts on surrounding properties. By approving this Deviation request, it helps facilitate the desired site access to limit impacts to the operations of the City's Eagle Rock Convenience Center. Further, in addition to the on-site landscape buffer the Convenience Center, which is what is being buffered, is separated from the subject site by an additional 60 feet due to the Eagle Rock Avenue roadway. This effectively increases the buffer between the uses from 22.5 feet to 82.5 feet.

6-4(P)(3)(e) The requested deviation is not for an Overlay zone standard, and the approval of any requested deviation will not result in a violation of any Overlay zone standard.

Applicant's Response: The subject site is not within an Overlay zone, so there are no Overlay zone standards that apply.

Based upon the information provided above and supporting documents within the application, we respectfully request approval of the Deviation in conjunction with the Site Plan being reviewed by the Development Review Board. Please do not hesitate to contact me if you have any questions or need any additional information.

Sincerely,

Michael Vos, ÁICP Senior Planner

Current DRC	
Project Number	

759287

#### FIGURE 12

### INFRASTRUCTURE LIST

(Rev. 2-16-18)

EXHIBIT "A"

# Date Site Plan Approved: Date Preliminary Plat Approved: Date Preliminary Plat Expires:

Date Submitted: 24-Jun-22

DRB Project No.: <u>PR-2021-005272</u> DRB Application No.: SI-2022-01239

### TO SUBDIVISION IMPROVEMENTS AGREEMENT DEVELOPMENT REVIEW BOARD (D.R.B.) REQUIRED INFRASTRUCTURE LIST

San Pedro Apartments					
PROPOSED NAME OF PLAT AND/OR SITE DEVELOPMENT PLAN					
Lots 1, 2, 3, 4, 29, 30, 31, and 32, Block 27, Tract A, Unit B, North Albuquerque Acres					
EXISTING LEGAL DESCRIPTION PRIOR TO PLATTING ACTION					

Following is a summary of PUBLIC/PRIVATE Infrastructure required to be constructed or financially guaranteed for the above development. This Listing is not necessarily a complete listing. During the SIA process and/or in the review of the construction drawings, if the DRC Chair determines that appurtenant items and/or unforeseen items have not been included in the infrastructure listing, the DRC Chair may include those items in the listing and related financial guarantee. Likewise, if the DRC Chair determines that appurtenant or non-essential items can be deleted from the listing, those items may be deleted as well as the related portions of the financial guarantees. All such revisions require approval by the DRC Chair, the User Department and agent/owner. If such approvals are obtained, these revisions to the listing will be incorporated administratively. In addition, any unforeseen items which arise during construction which are necessary to complete the project and which normally are the Subdivider's responsibility will be required as a condition of project acceptance and close out by the City.

Financially Guaranteed	Constructed Under	Size	Type of Improvement	Location	From	То		truction Cer vate P.E.	City Cnst Engineer
DRC #	DRC#	PAVING Std.	Curb & Gutter	Eagle Rock Ave. San Pedro Drive Oakland Ave.	San Pedro Drive Oakland Ave. San Pedro Dr.	NE Property Corner Eagle Rock Ave. SE Property Corner	1		
		7"	Arterial Pavement	San Pedro Drive	Oakland Ave.	Eagle Rock Ave.	1		
		3"	Residential Pavement	Eagle Rock Ave. Oakland Ave.	San Pedro Dr. San Pedro Dr.	NE Property Corner SE Property Corner	1		
		20' wide 26' wide 44' wide	PCC Valley Gut. & Fillets w/ ADA Ramps PCC Valley Gut. & Fillets w/ ADA Ramps PCC Valley Gut. & Fillets w/ ADA Ramps	Eagle Rock Ave. Eagle Rock Ave. Oakland Ave.	135' from NE Prop. C 295' from NE Prop. C 400' from SE Prop. C	Corner			
		6' 6'	PCC Sidewalk PCC Sidewalk	Eagle Rock Ave. San Pedro Dr Oakland Ave.	San Pedro Dr. Oakland Ave San Pedro Dr.	NE Property Corner Eagle Rock Ave. SE Property Corner	1		
		25' - 35'	Rem. & Disp. Asphalt Paving	San Pedro Dr.	Oakland Ave.	Eagle Rock Ave.	1		
		7 ea.	LED Street Lights *			P-11-11-11	/		
				•					

Financially	Financially Constructed						Construction Cer	
Guaranteed	Under	Size	Type of Improvement	Location	From To		Private	City Cnst
DRC#	DRC#					Inspecto	r P.E.	Engineer
		UTILITIES						
		8"	Private Fire Service Connection	Eagle Rock Ave.	157' From NE Property Corner			
		8"	Private Fire Service Connection	Oakland Ave.	113' from SE Property Corner			
		8"	Private Fire Service Connection	Oakland Ave.	428' from SE Property Corner			
		3"	Water Service & Vault	Oakland Ave.	274' from SE Property Corner		1	,
		4' dia.	SAS Manhole w/ 6" SAS Service Line	Oakland Ave.	173' from SE Property L Corner			1
		4' dia.	SAS Manhole w/ 6" SAS Service Line	Oakland Ave.	473' from SE Property Corner		<del></del>	
			Existing Water Service to be removed	Oakland Ave	NE corner of San Pedro Blvd intersect	tion /		
					·	/		
		STORM DR	AINAGE	•		1		
		30" dia.	RCP Storm Drain Pipe	Oakland Ave.	205' south of the NW Prop Corner		1	
								<u> </u>
						,	1	,
							_	
						,	1	,
	<u> </u>							·
						,	,	,
								· <del>- '</del>
						,	,	
				•				
				·	<del></del>			
				•				
		-				-		

Financially	Constructed						Const	Construction Certification		
Guaranteed	Under	Size	Type of Improvement Loca	Location	From	То		Private City		
DRC#	DRC#						Inspector	P.E.	Engineer	
	, ,						•			
							_   _ /			
		ll .					,	1	ı	
	<u> </u>				Approval of Creditable	Items:	Approval of	Creditable	tems:	
					Impact Fee Administra	tor Signature D	ate City User D	Dept. Signat	ure Date	
				NOTES						
		If the site is	s located in a floodplain, then the financi	•		approved by FEMA.				
				hts per City requirements	5.					
1	Water infrastructure i	ncludes valves,	fittings, fire hydrants and appurtenances			***				
2	Grading and drainage	certification rec	uired for release of IIA and financial guarant	ee						
3	* Street lights shall in	adude light noles	s, foundations, transformers, pull boxes, con-	duite and wiring				_		
3			a determined at DRC based on final design.	duits and willing.						
	Actual Humber of Str	secinglits shall be	s determined at DNO based on line design.							
4	Public roadway impro	vements include	es striping, directional arrows & lettering, sig	nage and other related iter	ns found on the approved PV	/O plans.				
				<u> </u>						
	AGENT / OWNER			DEVELOPMENT F	REVIEW BOARD MEMBER A	APPROVALS				
F	d O Aufrican DE	•								
i-re	d C. Arfman, PE							_		
	NAME (print)		DRB CHA	AIR - date	PAR	KS & RECREATION	I - date			
DAARI	SON & ARFMA	N INC								
IOAAC	FIRM	14, 1140.	TRANSPORTATION	DEVELOPMENT - date		AMAFCA - date		-		
- O		07.19.ZZ				7.5.1.C. 071 - 00.00				
Teno	-a letous	0/20/2022			-			_		
•	SIGNATURE - Hate		UT!LITY DEVEL	OPMENT - date	COD	E ENFORCEMENT	- date			
			CITY ENGI	NEER - date	-	dat		-		
			57.1. <u>2</u> .1.3.1				. <del>c</del>			
			DESIGN REV	/IEW COMMITTEE REVIS	SIONS					
	··									
	REVISION	DATE	DRC CHAIR	USER DE	PARTMENT	AG	ENT /OWNER			
									-	
	-								$\dashv$	
	1									