

### DEVELOPMENT REVIEW BOARD SUPPLEMENTAL SUBMITTAL

### (Deadline is Friday at noon unless noted on DRB calendar – late submittals will not be accepted unless approved by the DRB)

PROJECT NO. PR-2021-005390 Application No. SI-2021-00832 and VA-2021-00217

TO:

- $\times$  Planning Department/Chair
- $\times$  Hydrology
- $\underline{\times}$  Transportation Development
- $\underline{\times}$  ABCWUA
- $\times$  Code Enforcement
- $\underline{\times}$  Parks & Rec

\*(Please attach this sheet with each collated set for each board member)

### NOTE: ELECTRONIC VERSION (ie disk, thumbdrive) is Required. Submittal will not be accepted without.

DRB SCHEDULED HEARING DATE: <u>August 4, 2021</u> HEARING DATE OF DEFERRAL: <u>July 21, 2021</u>

SUBMITTAL

DESCRIPTION: <u>Revised Site Plan set and Infrastructure List for the proposed development along with comment responses</u> and deviation justification.

CONTACT NAME: Jackie Fishman, AICP and Michael Vos, AICP, Consensus Planning, Inc.

TELEPHONE: (505) 764-9801

EMAIL: fishman@consensusplanning.com vos@consensusplanning.com



### Memorandum

To: Jolene Wolfley and DRB Members, City of Albuquerque

From: Michael Vos, AICP, Consensus Planning, Inc.

Date: July 30, 2021

**Re:** Hiland Plaza Comment Responses and Supplemental Information (PR-2021-005390)

This memo outlines the updates made to the site plan for the Hiland Plaza project based on the comments received and reviewed at the July 21, 2021 DRB meeting. In addition, we have provided a justification for a 6-inch deviation to the fence height provided around the patio at the corner of Central Avenue and Jackson Street, as noted on the plans due to the building code requirement to provide a railing for the grade separation between the sidewalk and the patio.

### Code Enforcement

- 1. Property sits on multiple city parcels, a re-plat will be required.
  - a. A replat was submitted and approved by the DRB at the July 28, 2021 meeting with final sign-off delegated to Planning for minor conditions and to align with approval of the site plan.
- Provide Window/Door calculations for transparency: Section 3-4(I)((5)(b)1(b) and 3-4(I)(5)(b)(4)(c).
  - a. Notes have been added to the elevations regarding the variances to be approved by the ZHE for these sections.
- Provide floor plan (1st floor) as well as landscape notes to assure compliance with 4-3(B)(7)(a)(3)
   "In DT-UC-MS-PT areas, only ground floor dwelling units are used to calculate the required street trees."
  - a. The Landscape Architect is working on adding this calculation, but it should be noted that there are 64 trees provided on the site, which is nearly 70% of the total dwelling units in the entire project.
- 4. Provide widow detail "recessed" 5-11(D)(3) "In new multi-family residential development, windows shall be recessed not less than 2 inches and/or shall be surrounded by a window casing not less than 2 inches wide.
  - a. A note has been added to the elevations to address compliance with this standard.

### <u>Hydrology</u>

- 1. Hydrology has an approved conceptual grading and drainage plan with engineers stamp date of 6/1/21 (K17D120).
  - a. Understood.

### Transportation Development

1. The Transportation Department approves the sidewalk width waiver.

- a. Understood
- 2. Right-of-way dedication or a sidewalk easement is required for the new sidewalk prior to the site plan approval.
  - a. A plat consolidating the lots and dedicating right-of-way was approved by the DRB at the July 28, 2021 meeting.
- 3. Specify which ramps are being used around the handicapped spaces since the turndown sidewalk detail specifies a vertical separation between the pavement and the sidewalk.
  - a. Enlarged plans of ramps have been added on sheet C-102.
- 4. For the corner ramp at the northwest corner, have it line up with the crosswalk, and show existing crosswalk. Drawing 2441 is more appropriate to use that Drawing 2442 in this case.
  - a. This detail reference was changed.
- 5. Curb ramp located at the northeast corner does not line up with existing conditions. Adjust as necessary.
  - a. Ramp designed to be a merger of parallel and winged ramp. This is required to align with the limited slope path remaining across the access to Twisters to the east.
- 6. Provide complete detail for the ramp along the east side of the building with the handrail, showing all dimensioning. (The handrail detail provided is for the stair ramps.)
  - a. Enlarged plans of ramps added on sheet C-102.
- 7. Sidewalk detail shall call out a maximum 2% slope.
  - a. Note added.
- 8. Clear sight is a concern with the parallel parking, particularly looking to the left when pulling out of the entrance. Further analysis of this may result in a few parallel parking spaces being eliminated. Also provide distance between centerline on Silver and parallel parking.
  - a. A sight triangle exhibit was provided for the preliminary and final plat hearing on July 28, 2021.

### <u>ABCWUA</u>

- 1. Availability Statement #210332 has been issued and provides the conditions for service. *a.* Understood.
- 2. The proposed hydrant locations differ from those in the approved Availability Statement fire flow analysis. Please contact Utility Development at the number above to determine if the fire flows can be met with the currently proposed layout.
  - a. This has been addressed.
- 3. The water authority shall be provided access to the meter vault behind the gate.
  - a. The Water Authority will be provided access to the meter vault through the gates to the parking lot of this project.
- 4. Infrastructure List: No objections.
  - a. Understood.

### Parks and Recreation

- Please add note under tree planting detail per IDO section 5-6(C)(5)(e). Such as or similar: "Install organic wood chip mulch over rootball and to cover dripline. Generally, mulch should be held 4" back from tree trunk."
  - a. Construction Note #2 on the tree planting detail references this requirement.

### **Planning**

### July 13, 2021 Update:

- The waiver to 14-16-5-3(D)(3)(b)4 to allow a reduction of the sidewalk width on Jackson Street from the required 8-foot minimum to a 6-foot sidewalk is fully justified under IDO section 6-6(P)(3). The waiver will encourage flexibility, economy, and effective use of open space by lower concrete cost, adding landscaping area to give more tree space. The required 10-foot sidewalk is provided along Central Avenue. The 6-foot sidewalk meets the ADA requirements.
  - a. Understood.
- 2. The Landscape plan shows a mix of low and medium water use plants that are successful in Albuquerque. Landscape is provided above the requirements. Confirm planting details.
  - a. Understood. Planting details were updated based on Parks and Recreation comment.
- 3. Please address how the façade meets these standards
- 4. 5-11(D)(3) Windows In new multi-family residential development, windows shall be recessed not less than 2 inches and/or shall be surrounded by a window casing not less than 2 inches wide.
  - a. Note referencing this requirement has been added to the building elevation sheet.
- 5. 5-11(D)(2)(b) In UC-MS-PT areas, each floor of every façade that faces a public street shall contain a minimum of 20 percent of the façade in transparent windows and/or doors.
  - a. Note referencing this requirement has been added to the building elevation sheet. It should be noted that this requirement is superseded by the Nob Hill/Highland CPO requirements. We have also added notes regarding the variances to those requirements heard by the Zoning Hearing Examiner.
- 6. The 2020 Update of the IDO has some design considerations helpful to this project. Please consider how you could address these items.

The west elevation with a long building wing should account for strong solar radiation effects on this western facade. Consider using heat mitigation features for windows facing west (exterior or interior shades, recesses, specialized glazing, etc.). AND

Glare from direct sunlight through windows can be effectively diffused by tree canopies. Consider how the trees on the western landscape area could reduce western sun effects.

- a. These items were discussed at the DRB meeting on July 21, 2021 and the architect explained the types of windows glazing and insulation provided on this façade.
- 7. A platting action consolidating the 22 lots comprising the site must be approved prior to approval of the Site Plan.
  - a. The lot consolidation plat was approved by the DRB at the July 28, 2021 meeting and is pending final signature to align with this site plan request and infrastructure list.

### **Deviation Request**

A potential Deviation to the wall and fence height was discussed at the July 21, 2021 DRB meeting for the railing at the patio on the northeast corner of the site. Upon further review, this railing does extend into the street side yard on Jackson Street where height is limited for mixed-use to 3 feet in height. In addition, since this project is a mixed-use development rather than a strictly multi-family development it does not appear to qualify for the exception in IDO Section 5-7(D)(3)(c) that otherwise allows a 6-foot-tall fence when utilizing view fencing. As such, we are requesting approval of a Deviation of 6 inches as allowed in Table 6-4-1 Allowable Deviations with the following justification:

6-4(P)(3)(a) The applicant's site is subject to site constraints not generally shared by surrounding properties or the site was platted or developed in an unusual pattern when compared to abutting properties (e.g. the property was developed with orientation or access facing a different street than abutting lots) that would prevent the development of a permissive land use in a type of structure generally found on sites of a similar size in the surrounding area.

Applicant Response: The subject site includes site constraints not generally shared by the surrounding development, including its location on a corner lot and the grading required to create the proposed building pad and patio space where the railings are located. To the south of the patio, the grading slopes upward to the building pad, which pushes the residential unit entries to the east and thus extends the width of the street side yard area. This area is being utilized for landscaping purposes. If the building could be placed closer to Jackson Street, the street side yard would be minimized, and potentially this deviation would not be necessary because fences in other locations of the property are allowed to up to 8 feet tall. Compounding this matter, is a grade separation between the sidewalk and patio, which requires the developer to provide a railing at the specified height. This is for safety reasons and prevents someone from falling over the small ledge that is being created.

6-4(P)(3)(b) The site constraints were not created by the actions of the property owner or another interested party.

Applicant Response: These constraints were not created by this property owner and exist in the form of the topography and platting of this property and streets that were done by other parties many years in the past.

6-4(P)(3)(c) The request is for a single site and is not part of a pattern of similar requests for adjacent properties or for nearby sites by the same property owner or within the same subdivision, Framework Plan area, or Master Development Plan area.


Applicant Response: This request is unique due to the specific constraints of this site and proposed development. It is not part of a pattern of requests by this owner or for adjacent properties in the Nob Hill and Highland Area.

6-4(P)(3)(d) The approval of the requested deviations will not cause material adverse impacts on surrounding properties.

Applicant Response: This request will not create any material adverse impacts on surrounding properties. The deviation is only for 6 inches for safety purposes. The result is still for a short railing that is open and will not block any views or cause any impacts to clear sight at the Central Avenue and Jackson Street Intersection.

6-4(P)(3)(e) The requested deviation is not for an Overlay zone standard, and the approval of any requested deviation will not result in a violation of any Overlay zone standard. *Applicant Response: This request is not to an Overlay zone standard, but to the general wall and fence height standards in mixed-use areas.* 

For Visibility, landscaping, fencing, and signs shall not interfere with clear sight requirements. Therefore, signs, walls, trees, and shrubs between 3 and 8 feet in height (as measured from the gutter pan) are not allowed in the clear sight triangle.

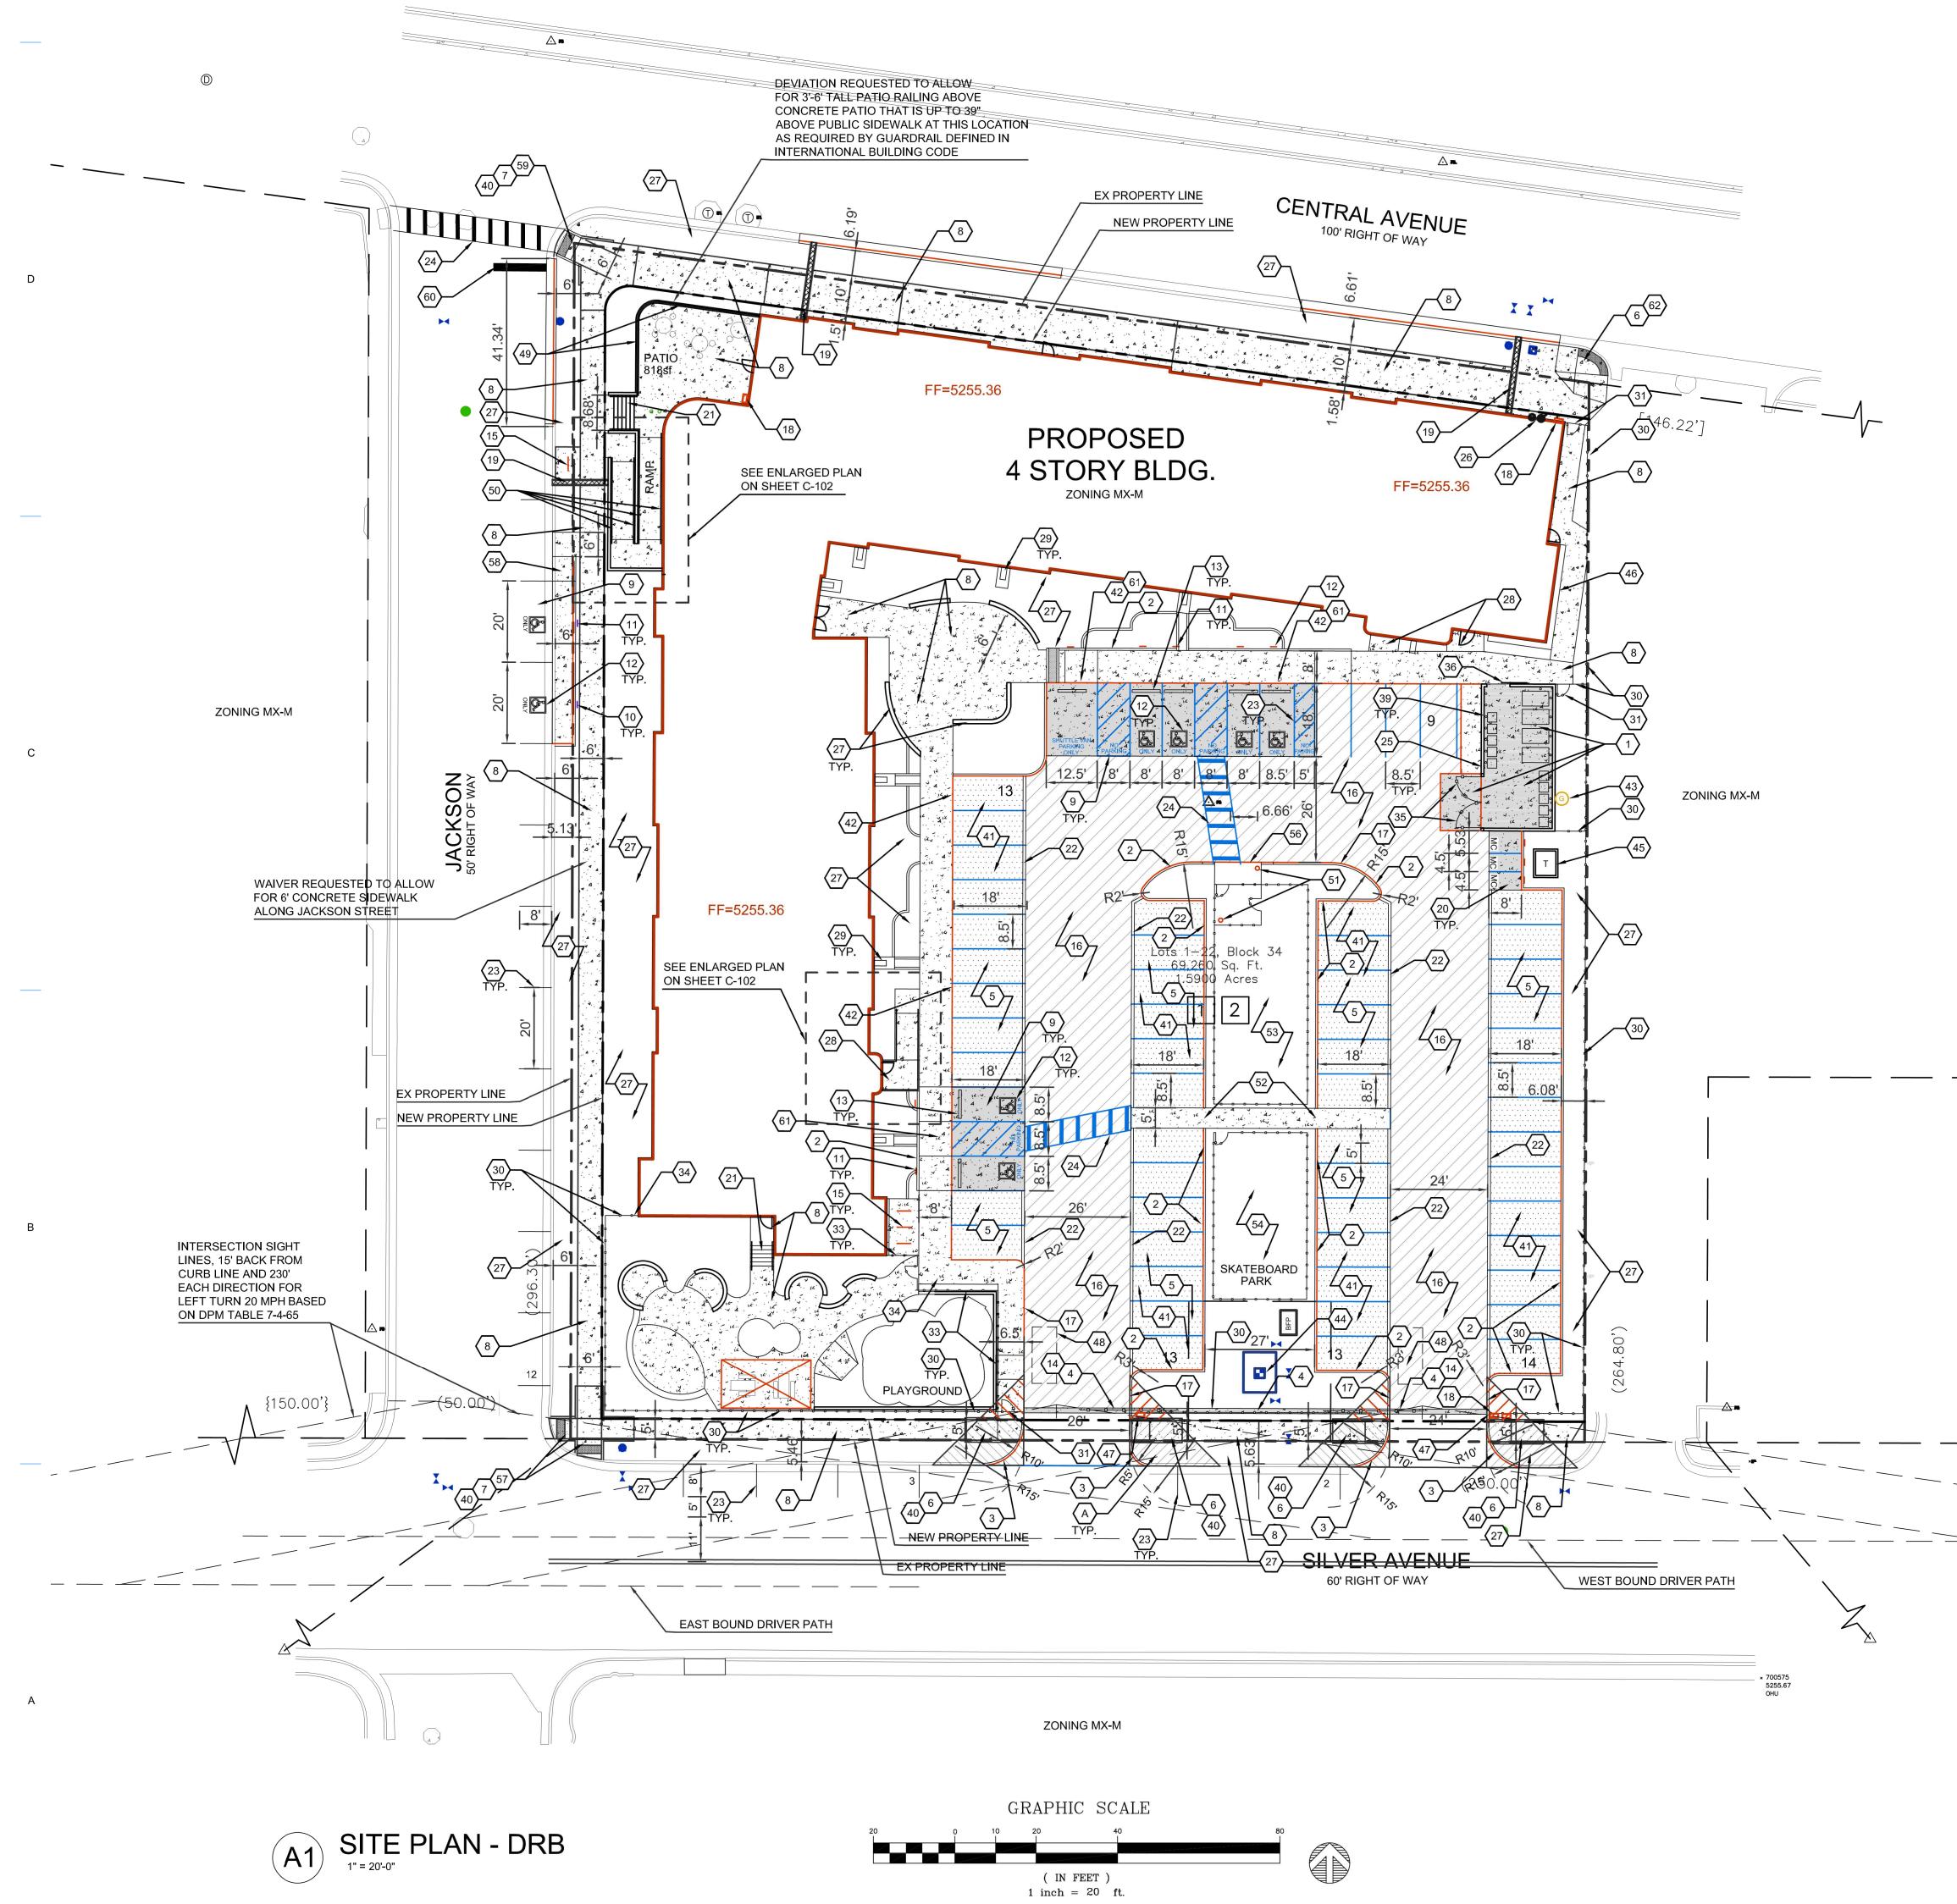

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### PROJECT TABULATED PARKING COUNTS AND OPEN SPACE

					On-Site	Open	Open						
	Number of			Req'd	Parking	Space	Space	НС	нс		MC	Bicycle	Bicycle
Space/Unit Type	Units	Use	GSF per unit	Parking	Provided	Req'd	Provided	Req'd	Provided	MC Req'd	Provided	Req'd	Provided
Leasing Office	1	Office	2000	3									
Commercial	1	Office/Retail	2000	3									
1 bdr, 1 ba	68	Residential	533	34		7650							
2 bdr, 2 ba	14	Residential	795	7		1995							
3 bdr, 2 ba	10	Residential	1016	5		1750							
Total	92			52	62	11395	17,150 sf	6	5 8	2	. 3	5	8
								6 VAN	8 VAN				
Notes:													
1. Parking require	d 1 space per DU,	with 50% reduction for	r UC-MS-PT		Table 5-5-2	1: Off-str	eet Parking F	Requirem	ents				
2. Bicycle parking	required, 3 space	es or 10% whichever is §	greater		Table 5-5-5	5: Bicycle	Parking Req	uirements	5				
3. Motorcycle park	ing required 1 sp	bace per 25 off street pa	arking.		Table 5-5-4	4: Motorc	ycle Parking	Requirem	nents				
4. Accessible Park	ing is based on 2	015NM Commercial Bui	lding Code, Tal	ole 1106.1	of Title 14, (	Chapter 7	, Part 2.						
			LIC MC DT	~		0.010.0	<b>CI</b>						

5. Open Space per table 2-4-5 including a 50% reduction for UC-MS-PT. Open space includes 9,616 sf of landscaping and 7,534 sf of sidewalk and patio space. 6. On Street Parking provided along Silver Avenue SE and Jackson Street SE is 17 including 2 ADA Stalls.

### **SITE PLAN GENERAL NOTES**

- A. MINI SIGHT TRIANGLE (11' ON EACH SIDE STARTING AT BACK OF SIDEWALK AND THEN EXTENDING TO FLOW LINE OF CURB PER DEVELOPMENT PROCESS MANUAL FIGURE 7.4.94), FOR ILLUSTRATIVE
- PURPOSED ONLY. B. LANDSCAPING, SIGNAGE, WALLS, FENCES, TREES AND SHRUBBERY BETWEEN 3 FEET AND 8 FEET TALL (AS MEASURED FROM THE GUTTER PAN) ARE NOT ALLOWED WITHIN THE CLEAR SITE TRIANGLE.
- ALL PARCELS SURROUNDING THE PROJECT SITE ARE MX-M ZONING.
  REFUSE WILL BE COLLECTED INTERNALLY BY A TRASH CHUTE AND COMPACTOR. MAINTENANCE STAFF WILL MOVE REFUSE TO THE REFUSE HOLDING YARD.
- E. RECYCLE MATERIALS WILL BE COLLECTING IN ROLLING BINS ON EACH FLOOR OF THE BUILDING AND WILL BE MOVED OUT TO HOLDING YARD BY MAINTENANCE STAFF.
- F. SOLID WASTE WILL BE PROVIDED A PROXIMITY CARD AND KEY PAD ACCESS CODES TO ENSURE ACCESS FOR REFUSE COLLECTION. G. ACCESS SHALL BE PROVED TO ABCWUA AS NECESSARY FOR WATER

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### SITE PLAN KEYED NOTES

METER VAULT FOR MAINTENANCE.

1. CONCRETE PAVEMENT PER DETAIL D3/C-501. CONCRETE HEADER CURB, 6" TALL, PER DETAIL A5/C-501.

- STANDARD CURB AND GUTTER PER DETAIL A5/C-501.
- 4. CONCRETE PAVEMENT STRIP 2' WIDE PER DETAIL D3/C-501. . GRAVEL PAVEMENT PER DETAIL D4/C-501.
- 6. CONCRETE CURB ACCESS RAMP PER DETAIL A1/C-501 AND TYPE C PARALLEL CURB ACCESS RAMP PER COA STANDARD DWG 2443. 7. DETECTABLE WARNING SURFACE PER DETAIL A3/C-501.
- 8. CONCRETE SIDEWALK PER DETAIL B4/C-501. 9. ADA RESERVED PARKING STALL PER DETAIL A1/C-502.
- 10. ADA RESERVED PARKING SIGN MOUNTED PER DETAIL C3/C-502 AND D2/C-502. 11. ADA VAN ACCESSIBLE RESERVED SIGN MOUNTED PER DETAIL
- C3/C-502 AND D2/C-502. 12. RESERVED PARKING SYMBOL PER DETAIL E3/C-502.
- 13. CONCRETE PARKING BLOCK PER DETAIL E4/C-502. 14. 24' SLIDING VEHICLE GATE PER DETAIL A5/C-504 WITH LIFT MASTER PROFESSIONAL MODEL SL3000101U HEAVY DUTY SLIDING GATE OPERATOR WITH 1-HP MOTOR ON 18"x34"x24" CONCRETE FOUNDATION. INSTALL PER MANUFACTURER RECOMMENDATIONS.
- 15. BICYCLE RACK PER DETAIL E5/C-502. 16. ASPHALT PAVEMENT PER DETAIL E2/C-501. 17. PAINT CURB RED WITH 6" TALL LETTERS READING "NO PARKING FIRE LANE".
- 18. FIRE DEPARTMENT KNOX BOX. 19. SIDEWALK CULVERT PER DETAIL B3/C-501.
- 20. MOTORCYCLE PARKING STALL WITH SIGNAGE AND PAVEMENT MARKINGS.
- 21. CONCRETE STAIR PER B4/C-502 AND HANDRAILS PER DETAILS A2/C-502. 22. CONCRETE CUT OFF WALL TO SEPARATE ASPHALT FROM GRAVEL
- PARKING, PER DETAIL A5/C-501. 23. 4" WIDE WHITE PARKING STRIPE.
- 24. CONTINENTAL CROSS WALK STRIPING. 25. REFUSE ENCLOSURE PER DETAIL A3/C-502.
- 26. FIRE RISER ROOM, SEE ARCHITECTURAL AND MECHANICAL PLANS. 27. LANDSCAPED AREA.
- 28. CONCRETE STOOP PER DETAIL C3/C-501. 29. CONCRETE SPLASH BLOCK PER DETAIL D6/C-501 AND CONCRETE
- RUNDOWN PER DETAIL D5/C-501. 30. 6' TALL PERIMETER FENCE PER DETAIL A5/C-504. 31. 6' TALL PERIMETER FENCE PERSONNEL GATE PER DETAIL A4/C-504. 32. 4' TALL PERIMETER FENCE PER DETAIL A5/C-504. 33. 4' TALL PERIMETER FENCE PERSONNEL GATE PER DETAIL A4/C-504.
- 34. CANTILEVERED FENCE END PER DETAIL A1/C-504. 35. REFUSE ENCLOSER GATE PER DETAIL D5/C-504.
- 36. ENCLOSURE GATE PER DETAIL A2/C-504. 37. CONCRETE VALLEY GUTTER PER DETAIL E1/C-502.
- 38. LIGHT POLE PER ELECTRICAL SHEET ES-101. 39. 6" STEEL BOLLARD PER DETAIL E1/C-501.
- 40. PAINT CURB YELLOW WHERE HEIGHT IS BETWEEN  $\frac{1}{4}$ " AND 6" TALL. 41. STORM WATER RETENTION POND, SEE GRADING PLANS. 42. TURN DOWN EDGE SIDEWALK PER DETAIL E3/C-501.
- 43. NATURAL GAS METER OR REGULATOR SEE UTILITY PLANS. 44. WATER METER VAULT. SEE UTILITY PLAN.
- 45. ELECTRICAL TRANSFORMER, SEE SHEET ES-101. 46. ELECTRICAL METER PACK. SEE ELECTRICAL PLANS.
- 47. KEY PAD FOR GATE OPERATOR. SEE ELECTRICAL PLANS FOR ADDITIONAL INFORMATION. 48. LOOP DETECTOR FOR AUTOMATIC GATE OPERATORS. SEE
- ELECTRICAL PLANS FOR DETAILS.
- 49. PATIO RAILING PER DETAIL C5/C-501 50. CONCRETE RAMP AND HANDRAILS PER DETAIL A2/C-502.
- 51. DOG WASTE STATION. SEE LANDSCAPING PLANS. 52. PROVIDE 5' WIDE OPENING IN CURB.
- 53. DOG PARK SURROUNDED BY 4' TALL FENCE PER DETAIL A5/C-504. 54. SKATE BOARD PARK AREA SURROUNDED BY 4' TALL FENCE PER DETAIL A5/C-504. 55. LOW SEAT WALL. SEE LANDSCAPING PLANS.
- 56. CONCRETE SIDEWALK TO BE FLUSH WITH ASPHALT. PROVIDE 3' LONG CURB TRANSITION FROM 6" TALL TO FLUSH ON EACH SIDE. 57. CONCRETE CURB ACCESS RAMP DETAIL A PAIRED PARALLEL CURB
- ACCESS RAMP WITH A COMMON LANDING PER COA STANDARD DWG 2445.
- 58. CONCRETE CURB ACCESS RAMP TYPE B PARALLEL CURB ACCESS RAMP PER COA STANDARD DWG 2443. 59. CONCRETE CURB ACCESS RAMP DETAIL B CORNER ACCESS RAMP
- PER COA STANDARD DWG 2441 60. 24" THERMOPLASTIC WHITE STOP BAR STRIPING.
- 61. CONCRETE CURB ACCESS RAMP TYPE A PARALLEL CURB ACCESS RAMP PER COA STANDARD DWG 2443
- 62. CONCRETE CURB ACCESS RAMP SIMILAR TO COA STANDARD DWG 2443 DETAIL B MODIFIED TO HAVE SLOPING WING INSTEAD OF HEADER CURB.



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C-102:	ENLARGED SITE PLA
LP-101:	LANDSCAPING PLAN
C-201:	SITE GRADING PLAN
C-301:	SITE UTILITY PLAN
A-201:	ELEVATIONS
C-501:	CIVIL DETAILS
C-502:	CIVIL DETAILS
C-503:	CIVIL DETAILS
C-504:	CIVIL DETAILS

PROJECT LOCATION: CENTRAL AVENUE SE AND JACKSON STREET SE

LEGAL DESCRIPTIONS: LOTS NUMBERED ONE (1) THROUGH TWENTY-TWO (22), INCLUSIVE, IN BLOCK NUMBERED THIRTY-FOUR (34) OF THE VALLEY VIEW ADDITION TO THE CITY OF ALBUQUERQUE, NEW MEXICO, AS THE SAME IS SHOWN AND DELINEATED ON THE MAP OF SAID ADDITION, FILED IN THE OFFICE OF THE COUNTY CLERK OF BERNALILLO COUNTY, NEW MEXICO, ON SEPTEMBER 2, 1911.

CONTAINING 1.59 ACRES

ZONE ATLAS PAGES: K-17-Z

EXISTING ZONING: MX-M MIXED USE MEDIUM DENSITY

PROPOSED USES: MULTI FAMILY RESIDENTIAL, WITH 92 UNITS AND TWO COMMERCIAL SPACES (APROX. 2,000 SF TOTAL)

### PROJECT NUMBER: Application Number:

PR-2021-005390 SI-2021-00832 - SITE PLAN

Is an Infrastrure List Required? (X) Yes () No If yes, then a set of approved DRC plans with a work order is required for any construction within Public Right-of-Way of for construction of public improvements.

DRB SITE DEVELOPMENT PLAN APPROVAL:

Traffic Engineering, Transportation Division	Date
ABCWUA	Date
Parks and Recreation Department	Date
City Engineer/Hydrology	Date
Code Enforcement	Date
* Environmental Health Department (conditional)	Date
Solid Waste Management	Date
DRB Chairperson, Planning Department	Date



# STAMP David Aube SITE PLAN - DRB


PROJECT NAME HILAND PLAZA

### 5000 CENTRAL AVENUE NE ALBUQUERQUE, NM 87108

REVISIONS NO. | DATE | DESCRIPTION Copyright: Design Group Drawn by Checked by DAA July 15, 2021 Date 2574 Project number SHEET TITLE SITE PLAN DRB

SHEET NUMBER

**SP-DRB** 

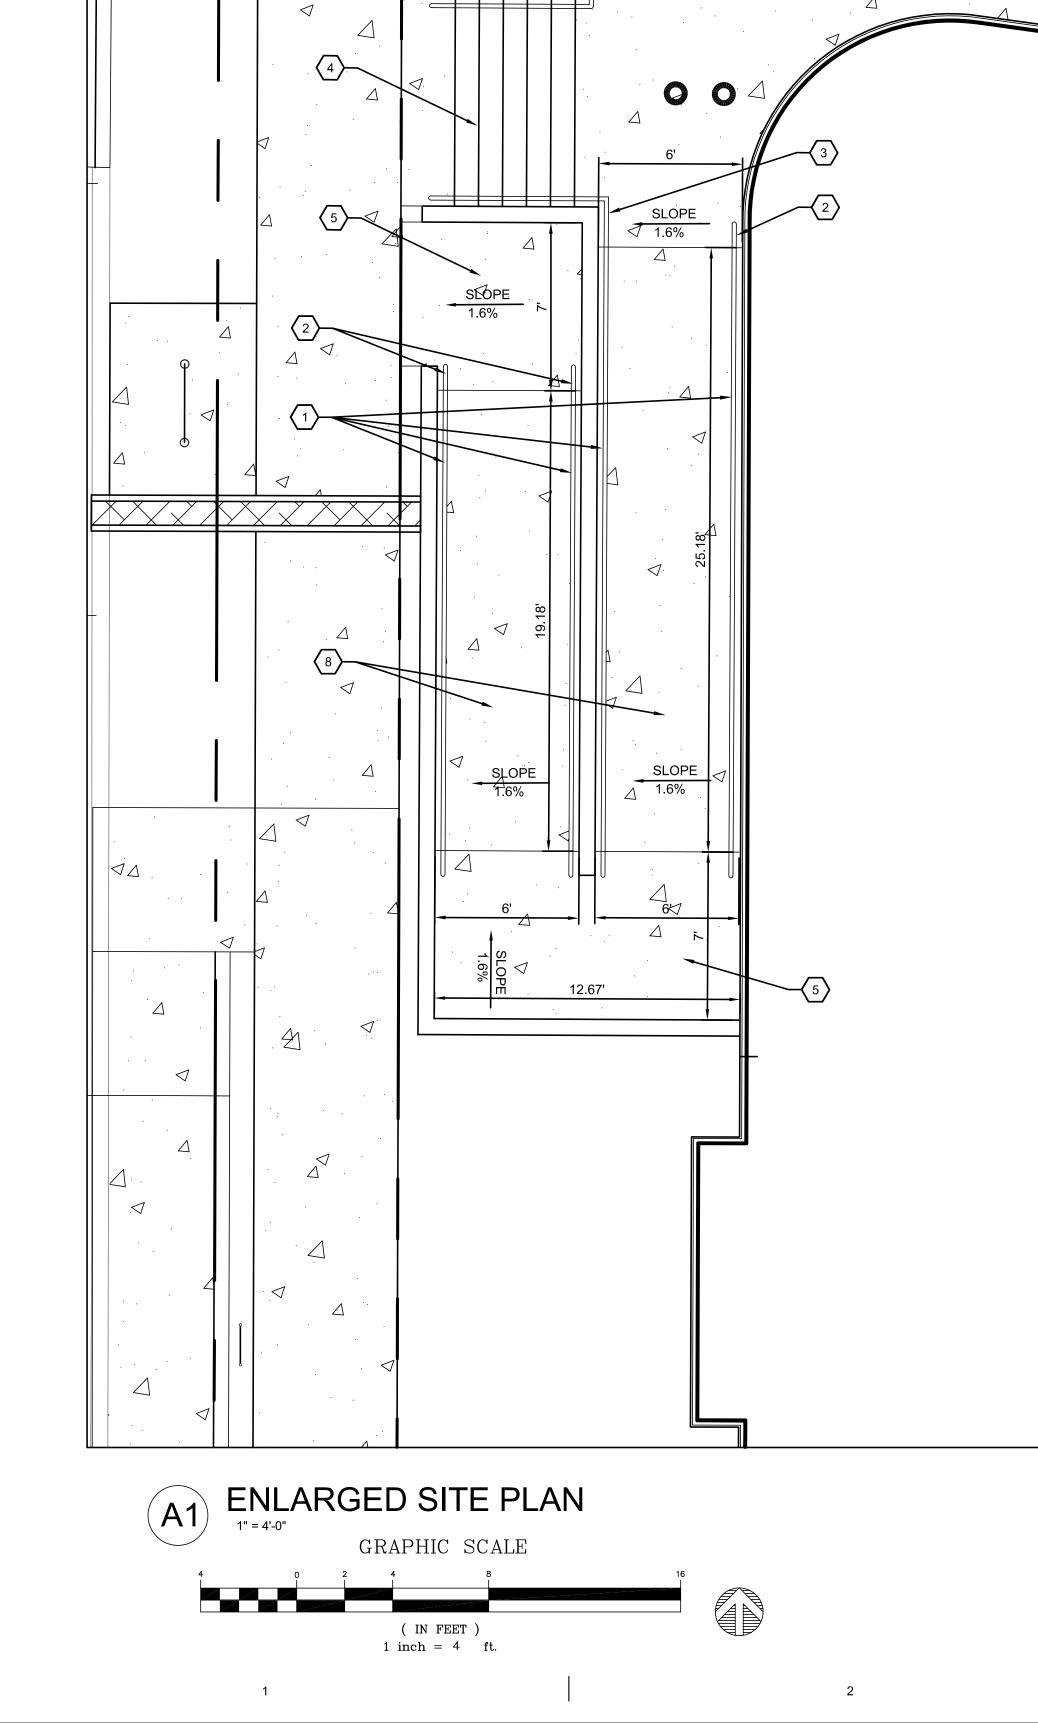

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### SITE PLAN GENERAL NOTES

### SITE PLAN KEYED NOTES

HANDRAIL PER DETAIL A2/C-502.
 12" EXTENSION OF HANDRAIL BEYOND THE GRADE BREAK OF RAMP.
 HANDRAIL TO EXTEND AND CONNECT TO HAND RAILING FOR


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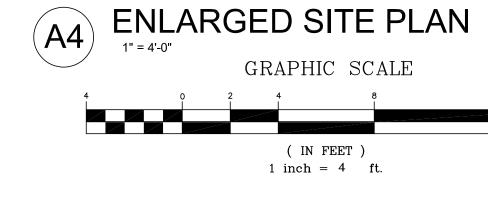
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- STAIRS.
- 4. CONCRETE STAIR PER B4/C-502 AND HANDRAILS PER DETAILS A2/C-502.
- CONCRETE LANDING. MAXIMUM SLOPE OF 2% ANY DIRECTION.
   CONCRETE SIDEWALK PER DETAIL B4/C-501.
   HANDRAIL TO EXTEND 4" FROM BUILDING.
   RAMP SLOPE 1:12 MAXIMUM.



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SHEET NUMBER

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5000 CENTRAL AVENUE NE ALBUQUERQUE, NM 87108

PROJECT NAME

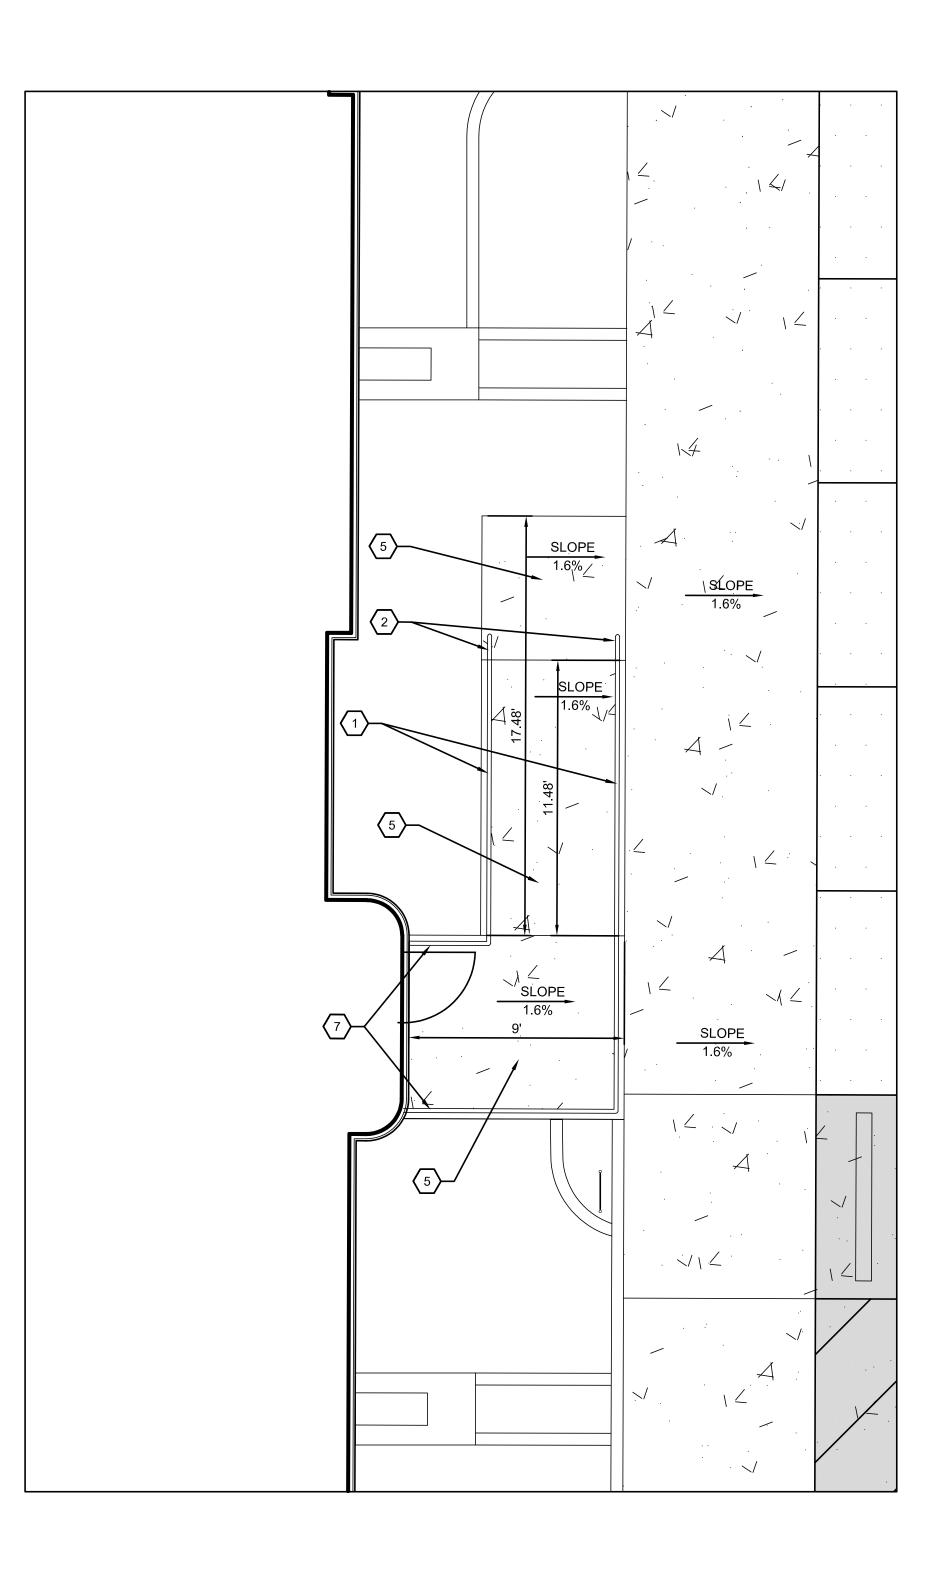HILAND PLAZA

David Aube Department, CN=David Aube Date: 2021.07.29 16:39:58-06'00' SITE PLAN - DRB

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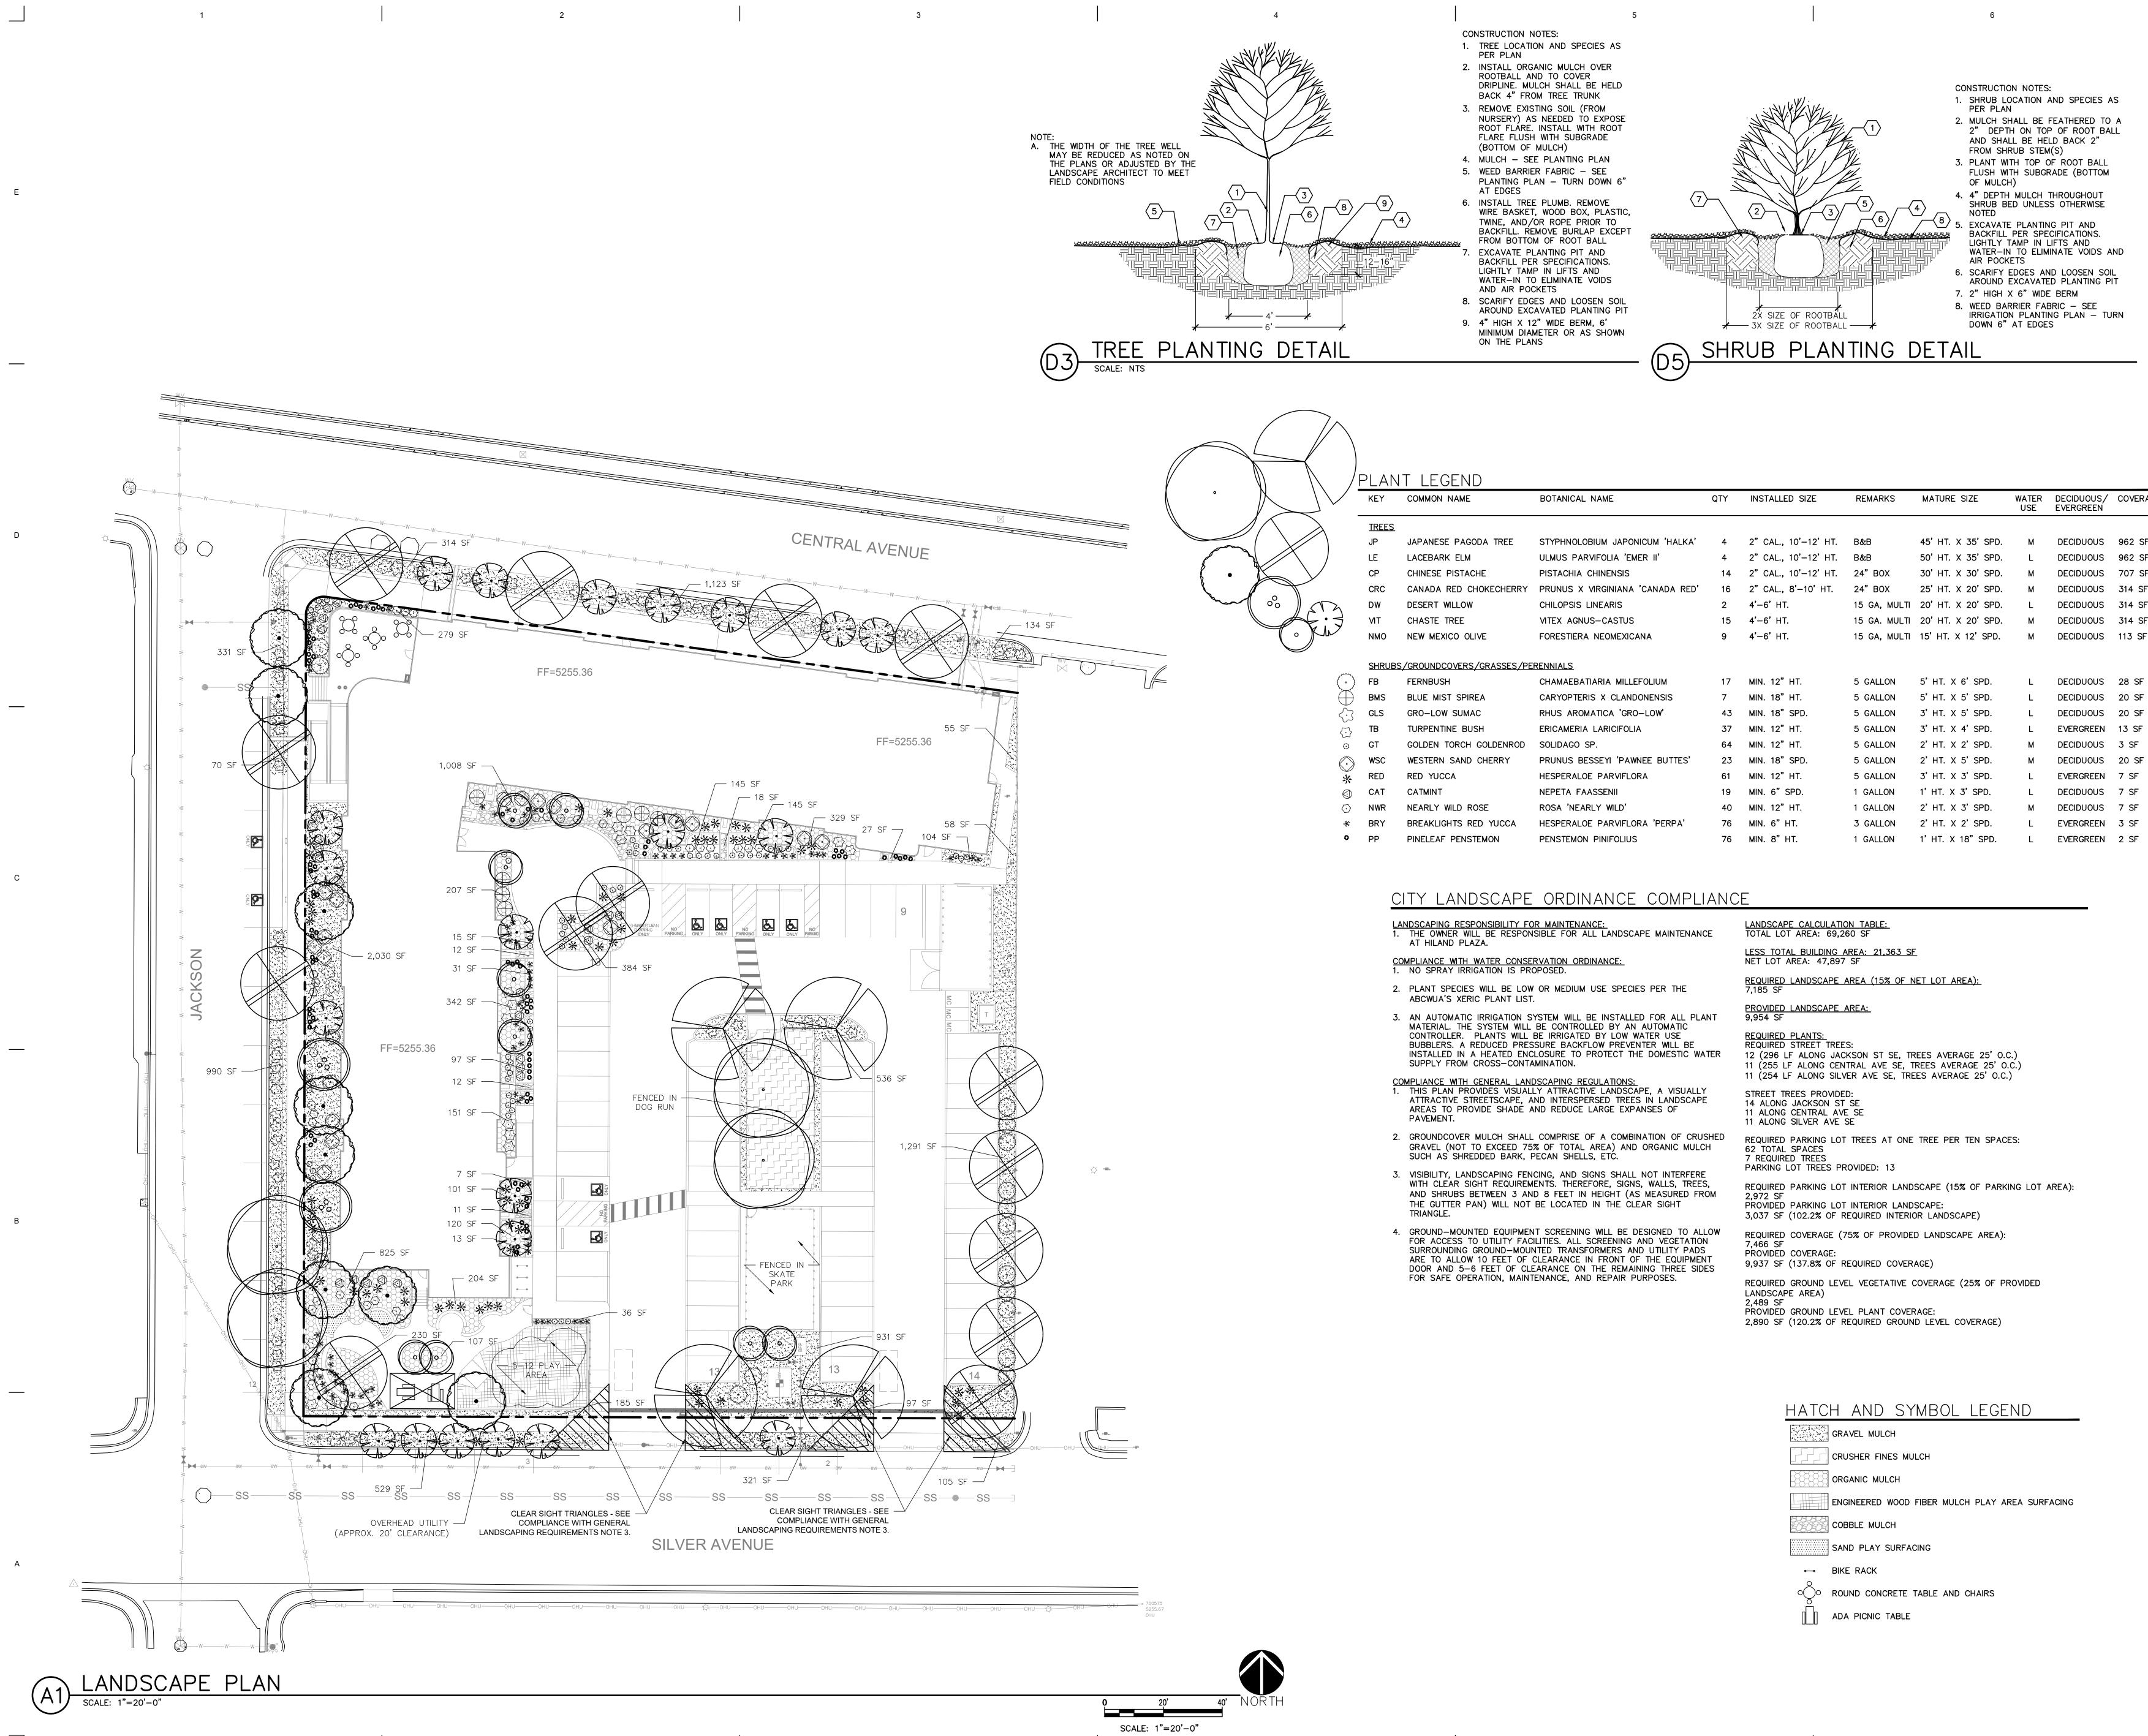
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CONSULTANT

120 Vassar Dr SE Suite 100 Albuquerque New Mexico 87106 T 505 242 6880 • F 505 242 6881

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MMON NAME	BOTANICAL NAME	QTY	INSTALLED SIZE	REMARKS	MATURE SIZE	WATER	DECIDUOUS/	COVERAGE
						USE	EVERGREEN	
PANESE PAGODA TREE	STYPHNOLOBIUM JAPONICUM 'HALKA'	4	2" CAL., 10'—12' HT.	B&B	45' HT. X 35' SPD.	м	DECIDUOUS	962 SF
CEBARK ELM	ULMUS PARVIFOLIA 'EMER II'	4	2" CAL., 10'—12' HT.	B&B	50'HT. X 35' SPD.	L	DECIDUOUS	962 SF
IINESE PISTACHE	PISTACHIA CHINENSIS	14	2" CAL., 10'–12' HT.	24" BOX	30' HT. X 30' SPD.	М	DECIDUOUS	707 SF
NADA RED CHOKECHERRY	PRUNUS X VIRGINIANA 'CANADA RED'	16	2" CAL., 8'—10' HT.	24" BOX	25' HT. X 20' SPD.	М	DECIDUOUS	314 SF
SERT WILLOW	CHILOPSIS LINEARIS	2	4'-6' HT.	15 GA, MULTI	20' HT. X 20' SPD.	L	DECIDUOUS	314 SF
ASTE TREE	VITEX AGNUS-CASTUS	15	4'-6' HT.	15 GA. MULTI	20' HT. X 20' SPD.	М	DECIDUOUS	314 SF
W MEXICO OLIVE	FORESTIERA NEOMEXICANA	9	4'-6' HT.	15 GA, MULTI	15' HT. X 12' SPD.	м	DECIDUOUS	113 SF
OUNDCOVERS/GRASSES/PE	RENNIALS							
RNBUSH	CHAMAEBATIARIA MILLEFOLIUM	17	MIN. 12" HT.	5 GALLON	5'HT. X 6' SPD.	L	DECIDUOUS	28 SF
UE MIST SPIREA	CARYOPTERIS X CLANDONENSIS	7	MIN. 18" HT.	5 GALLON	5' HT. X 5' SPD.	L	DECIDUOUS	20 SF
O-LOW SUMAC	RHUS AROMATICA 'GRO-LOW'	43	MIN. 18" SPD.	5 GALLON	3' HT. X 5' SPD.	L	DECIDUOUS	20 SF
RPENTINE BUSH	ERICAMERIA LARICIFOLIA	37	MIN. 12" HT.	5 GALLON	3' HT. X 4' SPD.	L	EVERGREEN	13 SF
LDEN TORCH GOLDENROD	SOLIDAGO SP.	64	MIN. 12" HT.	5 GALLON	2' HT. X 2' SPD.	М	DECIDUOUS	3 SF
STERN SAND CHERRY	PRUNUS BESSEYI 'PAWNEE BUTTES'	23	MIN. 18" SPD.	5 GALLON	2' HT. X 5' SPD.	М	DECIDUOUS	20 SF
D YUCCA	HESPERALOE PARVIFLORA	61	MIN. 12" HT.	5 GALLON	3' HT. X 3' SPD.	L	EVERGREEN	7 SF
TMINT	NEPETA FAASSENII	19	MIN. 6" SPD.	1 GALLON	1'HT. X 3' SPD.	L	DECIDUOUS	7 SF
ARLY WILD ROSE	ROSA 'NEARLY WILD'	40	MIN. 12" HT.	1 GALLON	2' HT. X 3' SPD.	м	DECIDUOUS	7 SF
EAKLIGHTS RED YUCCA	HESPERALOE PARVIFLORA 'PERPA'	76	MIN. 6"HT.	3 GALLON	2' HT. X 2' SPD.	L	EVERGREEN	3 SF
NELEAF PENSTEMON	PENSTEMON PINIFOLIUS	76	MIN. 8"HT.	1 GALLON	1'HT. X 18" SPD.	L	EVERGREEN	2 SF


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THE HARTMAN + MAJEWSKI DESIGN GROUP Architects • Engineers • Interior Design Planners • Urban Designers • LEED® 120 Vassar Dr SE Suite 100 Albuquerque New Mexico 87106 T 505 242 6880 • F 505 242 6881 CONSULTANT




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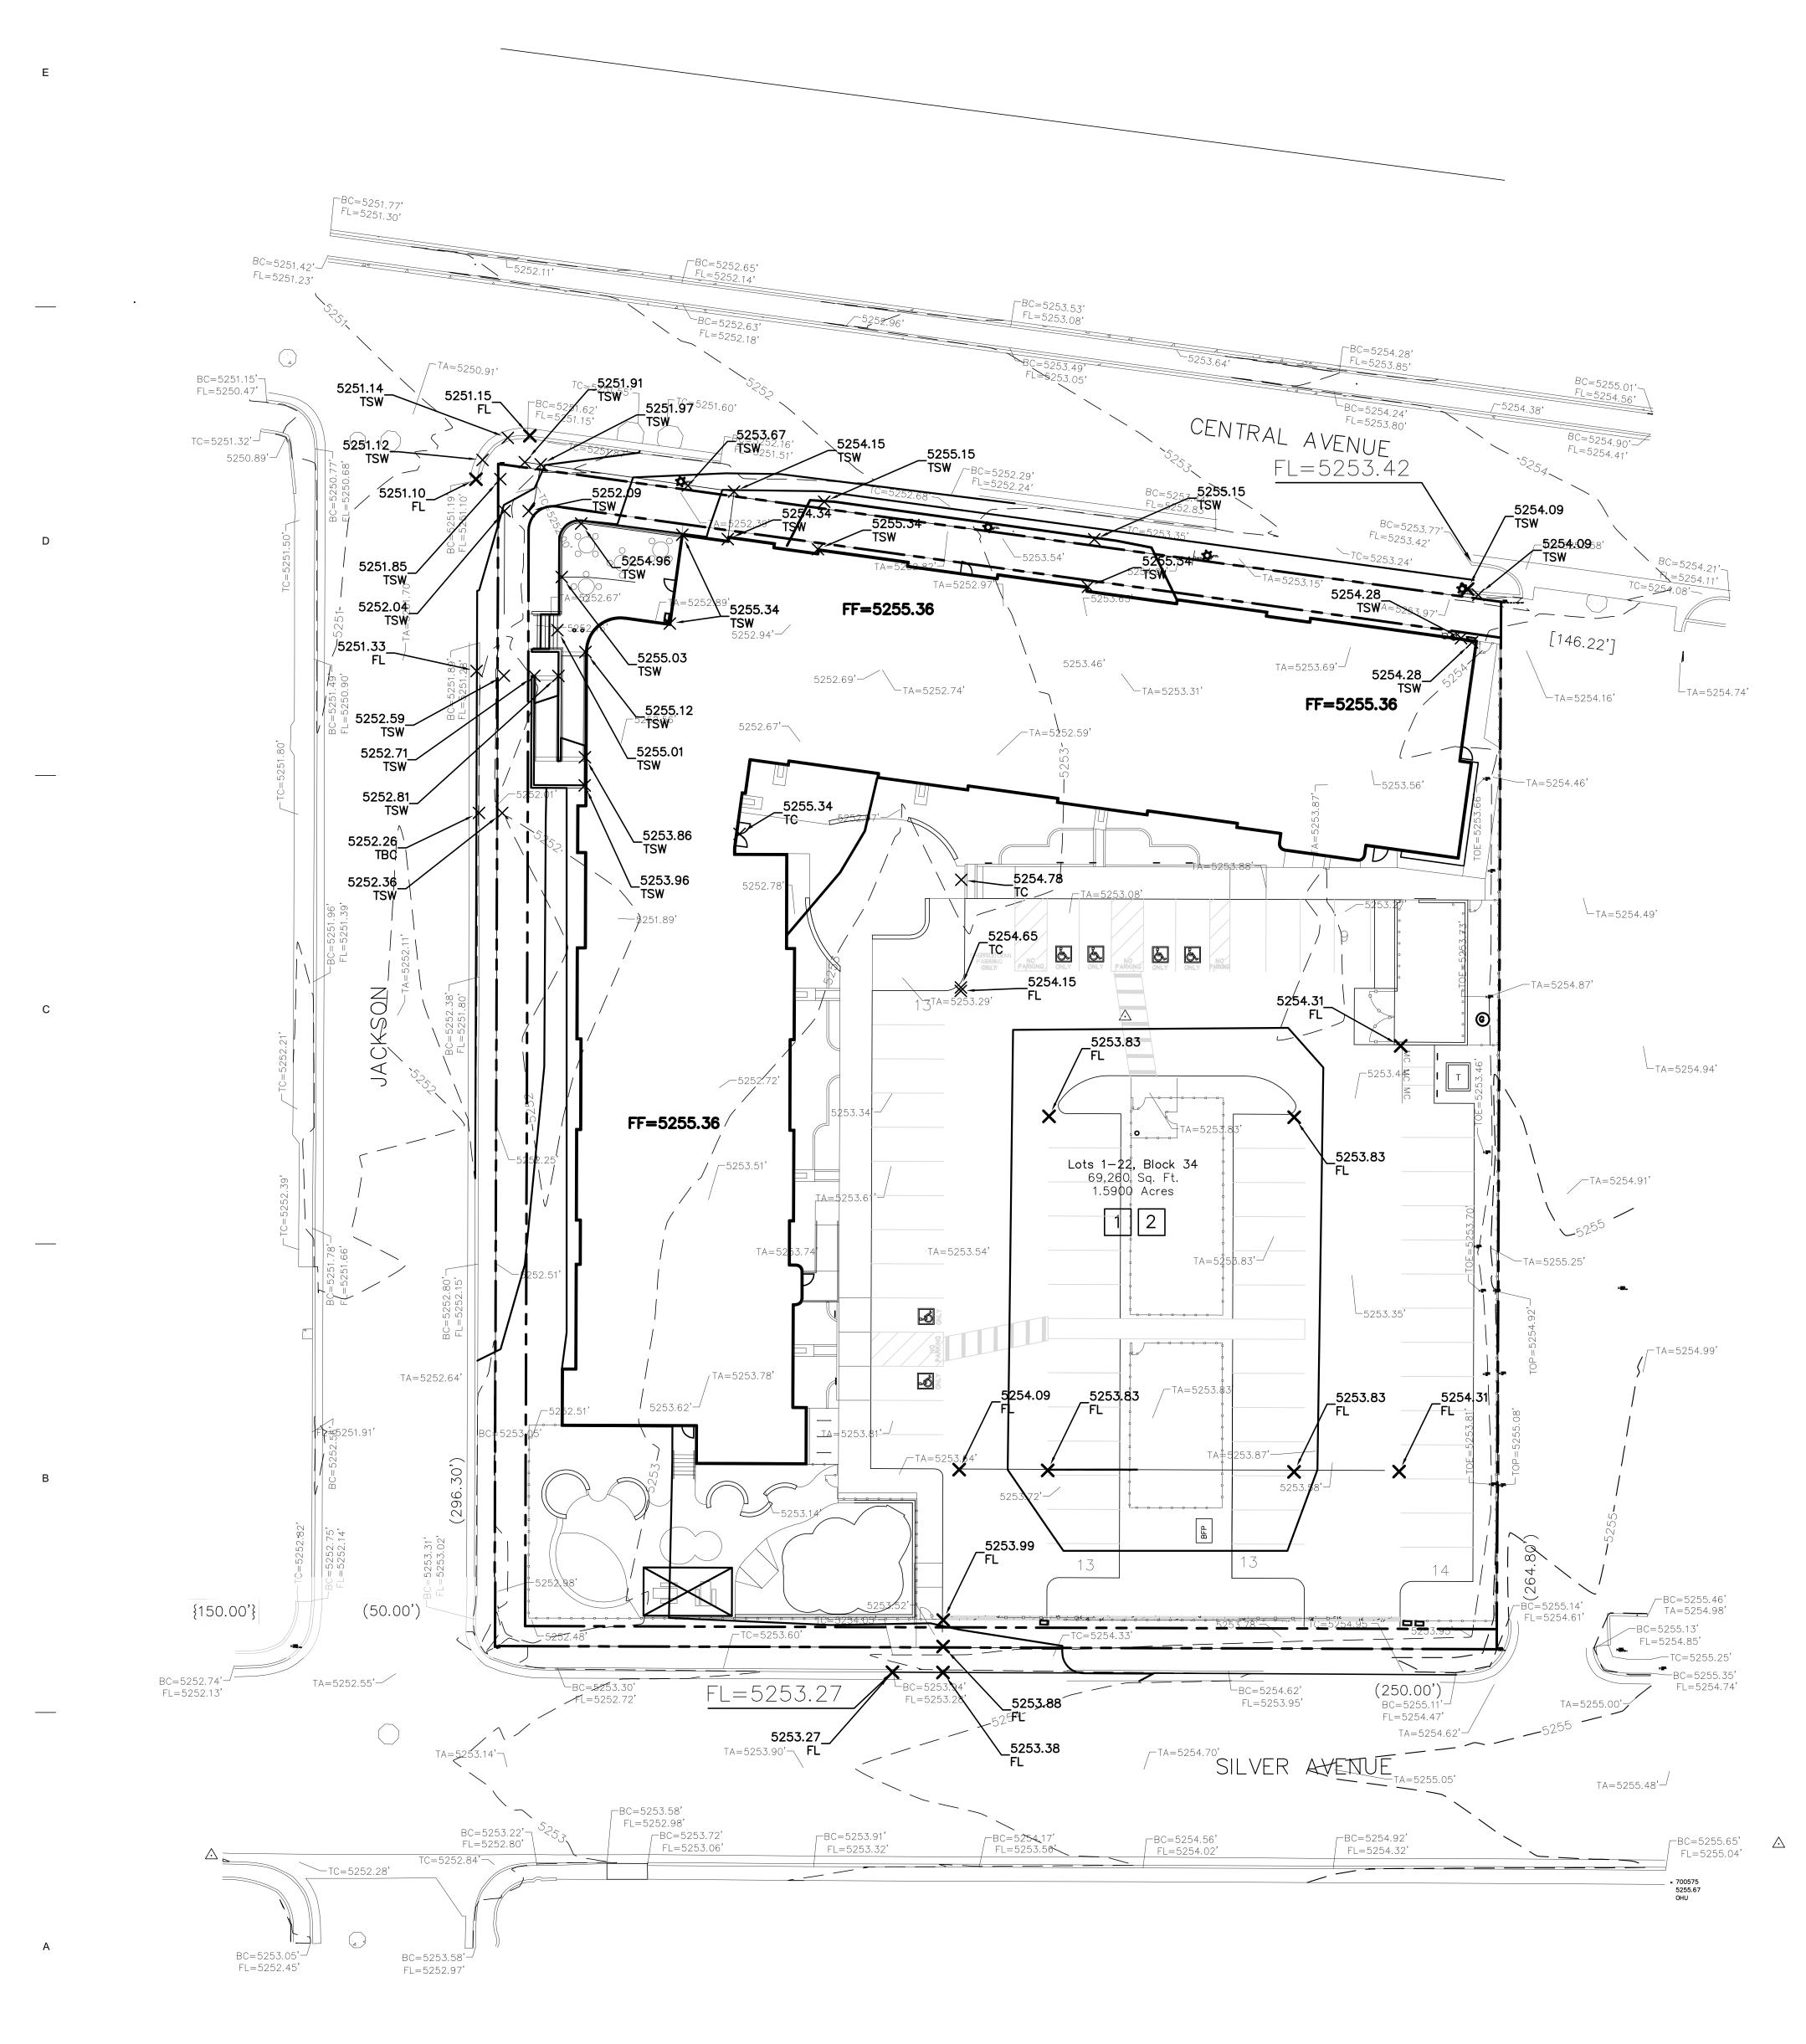


DRB SUBMITTAL PROJECT NAME HILAND PLAZA

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### **5000 CENTRAL AVENUE NE** ALBUQUERQUE, NM 87108

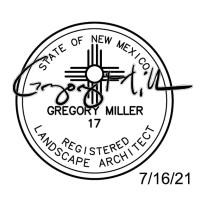

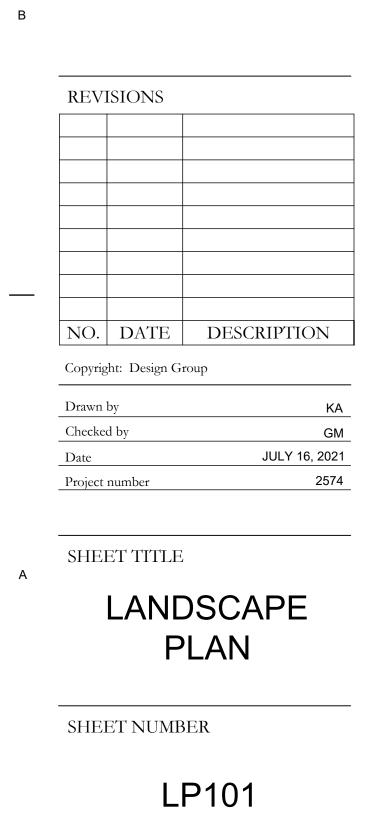

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A1 CONCEPTUAL SITE GRADING PLAN

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GRAPHIC SCALE

( IN FEET ) 1 inch = 20 ft.

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### **GRADING PLAN GENERAL NOTES**

5

I. SEE SHEET C-G01 FOR COMPLETE LIST OF GENERAL NOTES AND SYMBOL/LINETYPE LEGEND THAT APPLY TO ALL SHEETS.

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SHEET NUMBER

# CONCEPTUAL Site grading plan

SHEET TITLE

А

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NO.	DATE	DESCRIPTION
Copyrie	ht: Design Gr	oup
		L
Drawn	Ьу	DA
Checke	d by	DA
Date		July 15, 20
Ducient	number	257

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С

SITE PLAN - DRB

PROJECT NAME

HILAND PLAZA


5000 CENTRAL AVENUE NE ALBUQUERQUE, NM 87108

David Aube Gotton, Ostronom, Control Aubert, CN-David Aube Date: 2021.07.16 09:09:25-06'00'

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CONSULTANT



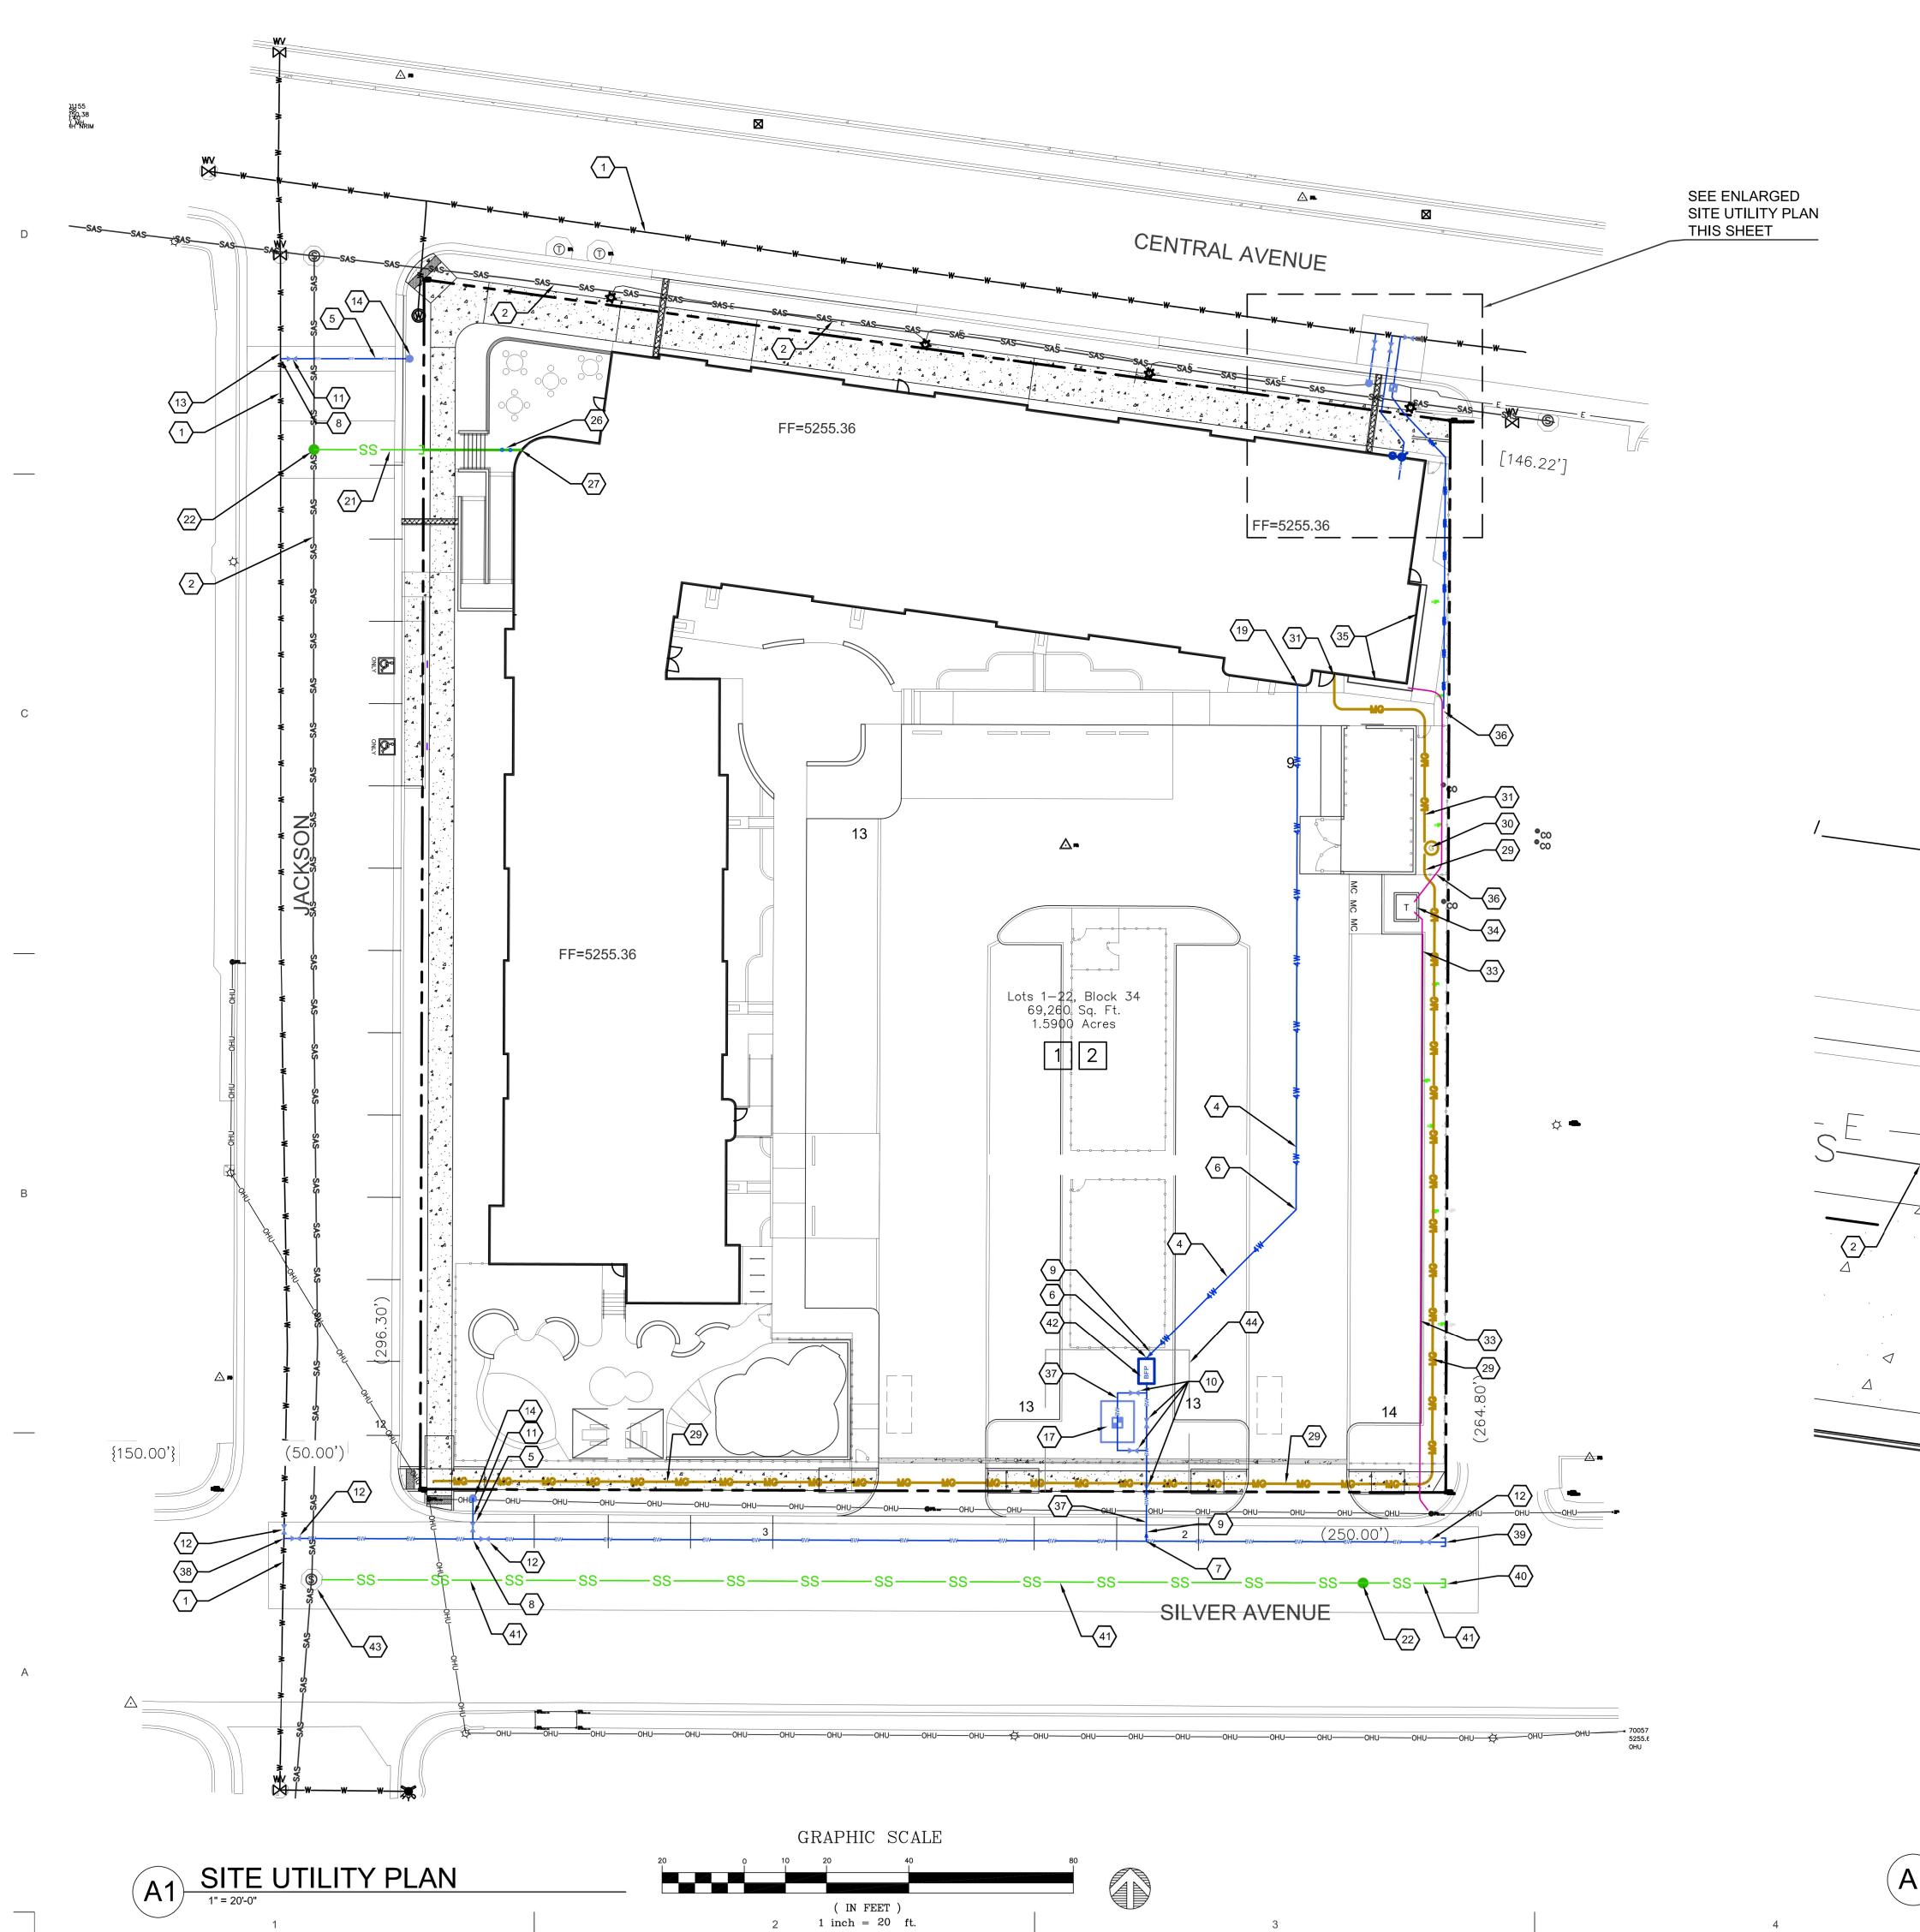

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### **UTILITY PLAN GENERAL NOTES**


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I. SEE SHEET C-G01 FOR COMPLETE LIST OF GENERAL NOTES AND SYMBOL/LINETYPE LEGEND THAT APPLY TO ALL SHEETS.

6

### **UTILITY PLAN KEYED NOTES** $\langle \# \rangle$

- 1. EXISTING PVC WATERLINE TO REMAIN.
- 2. EXISTING SANITARY SEWER LINE TO REMAIN. 3. WATER SUPPLY LINE, 1"Ø COPPER, PER DETAIL A5/C-503.
- 4. WATER SUPPLY LINE, 4"Ø PVC DR14, PER DETAIL A5/C-503.
- 5. WATER SUPPLY LINE, 6"Ø C900 DR14, PER DETAIL A5/C-503 WITH RESTRAINED JOINTS PER DETAIL A1/C-503. 6. BEND, 45°, MATERIAL AND SIZE TO MATCH THE CONNECTING WATER
- LINES. RESTRAIN JOINTS PER A1/C-503. 7. DUCTILE IRON TEE, 8"x8"x4", RESTRAIN JOINTS PER A1/C-503.
- 8. DUCTILE IRON TEE, 8"x8"x6", RESTRAIN JOINTS PER A1/C-503. 9. REDUCER, 4"x3".
- 10. GATE VALVE ASSEMBLY, 3"Ø, VALVE BOX AND CONCRETE COLLAR PER DETAIL C4/C-503. RESTRAIN JOINTS PER A1/C-503.
- 11. GATE VALVE ASSEMBLY, 6"Ø, VALVE BOX AND CONCRETE COLLAR PER DETAIL C4/C-503. RESTRAIN JOINTS PER A1/C-503.
- 12. GATE VALVE ASSEMBLY, 8"Ø, VALVE BOX AND CONCRETE COLLAR PER DETAIL C4/C-503. RESTRAIN JOINTS PER A1/C-503. 13. TRANSITION COUPLING.
- 14. FIRE HYDRANT PER DETAIL A4/C-503.
- 15. WALL MOUNTED FIRE DEPARTMENT CONNECTION. SEE FIRE SUPPRESSION PLANS.
- 16. WALL MOUNTED INDICATOR VALVE. SEE FIRE SUPPRESSION PLANS. 17. INSTALL 3" DOMESTIC WATER METER PER COA STD DWGS, 2370.
- 18. INSTALL 1" IRRIGATION WATER METER AND METER BOX PER COA STD DWGS, 2363 AND 2367. 19. CONNECT WATER LINE ONTO BUILDING WATER LINES, SEE PLUMBING
- SHEETS.
- 20. SANITARY SEWER LINE, 6"Ø, PER DETAIL D5/C-503. 21. SANITARY SEWER LINE, 8"Ø, PER DETAIL D5/C-503.
- 22. 4' Ø SANITARY SEWER MANHOLE PER COA STANDARD DRAWING 2102.
- 23. SANITARY SEWER WYE, 8"x8"x6".
- 24. SANITARY SEWER WYE, 8"X8"X8".
- 25. TERMINAL CLEANOUT PER DETAIL E1/C-503.
- 26. DOUBLE CLEANOUT PER DETAIL E3/C-503. 27. CONNECT SANITARY SEWER LINE ONTO BUILDING SEWER LINES, SEE PLUMBING SHEETS.
- 28. NOT USED. 29. NEW GAS LINE TO METER, SIZE TO BE DETERMINED BY NM GAS CO.
- 30. NATURAL GAS METER MANIFOLD AND METERS, SIZE TO BE DETERMINED BY NM GAS CO. 31. NEW NATURAL GAS YARD LINE. SEE MECHANICAL PLANS FOR SIZE
- REQUIREMENTS.
- 32. EXISTING NATURAL GAS LINE TO REMAIN.
- 33. PNM PRIMARY LINES. SEE ELECTRICAL SHEET ES-101. 34. ELECTRICAL TRANSFORMER. SEE ELECTRICAL SHEET ES-101.
- 35. SECONDARY LINES. SEE ELECTRICAL SHEET ES-101.
- 36. ELECTRICAL METER PACK. SEE ELECTRICAL SHEET ES-101.
- 37. WATER SUPPLY LINE, 3"Ø PVC SCH 40, PER DETAIL A5/C-503. 38. DUCTILE IRON TEE, 8"x8"x8", AND 8" TRANSITION COUPLING,
- RESTRAIN JOINTS PER A1/C-503. 39. 8" DUCTILE IRON END CAP. RESTRAIN JOINTS PER A1/C-503. 40. 8" PVC SRD 35 END CAP AND EMS.
- 41. 8" PVC SDR 35 SANITARY SEWER LINE.
- 45. 3" REDUCED PRESSURE ZONE BACKFLOW PREVENTOR, PER ACBWUA REQUIREMENTS. PROVIDE SAFE-T-COVER 300TD-AL INSULATED ENCLOSURE WITH 2 KW HEATER.
- 46. CONNECT NEW 8" SANITARY SEWER MANHOLE. RESHAPE SHELF AS REQUIRED FOR NEW CONNECTION.
- 47. EASEMENT AROUND WATER METER PER ABCWUA REQUIREMENTS.



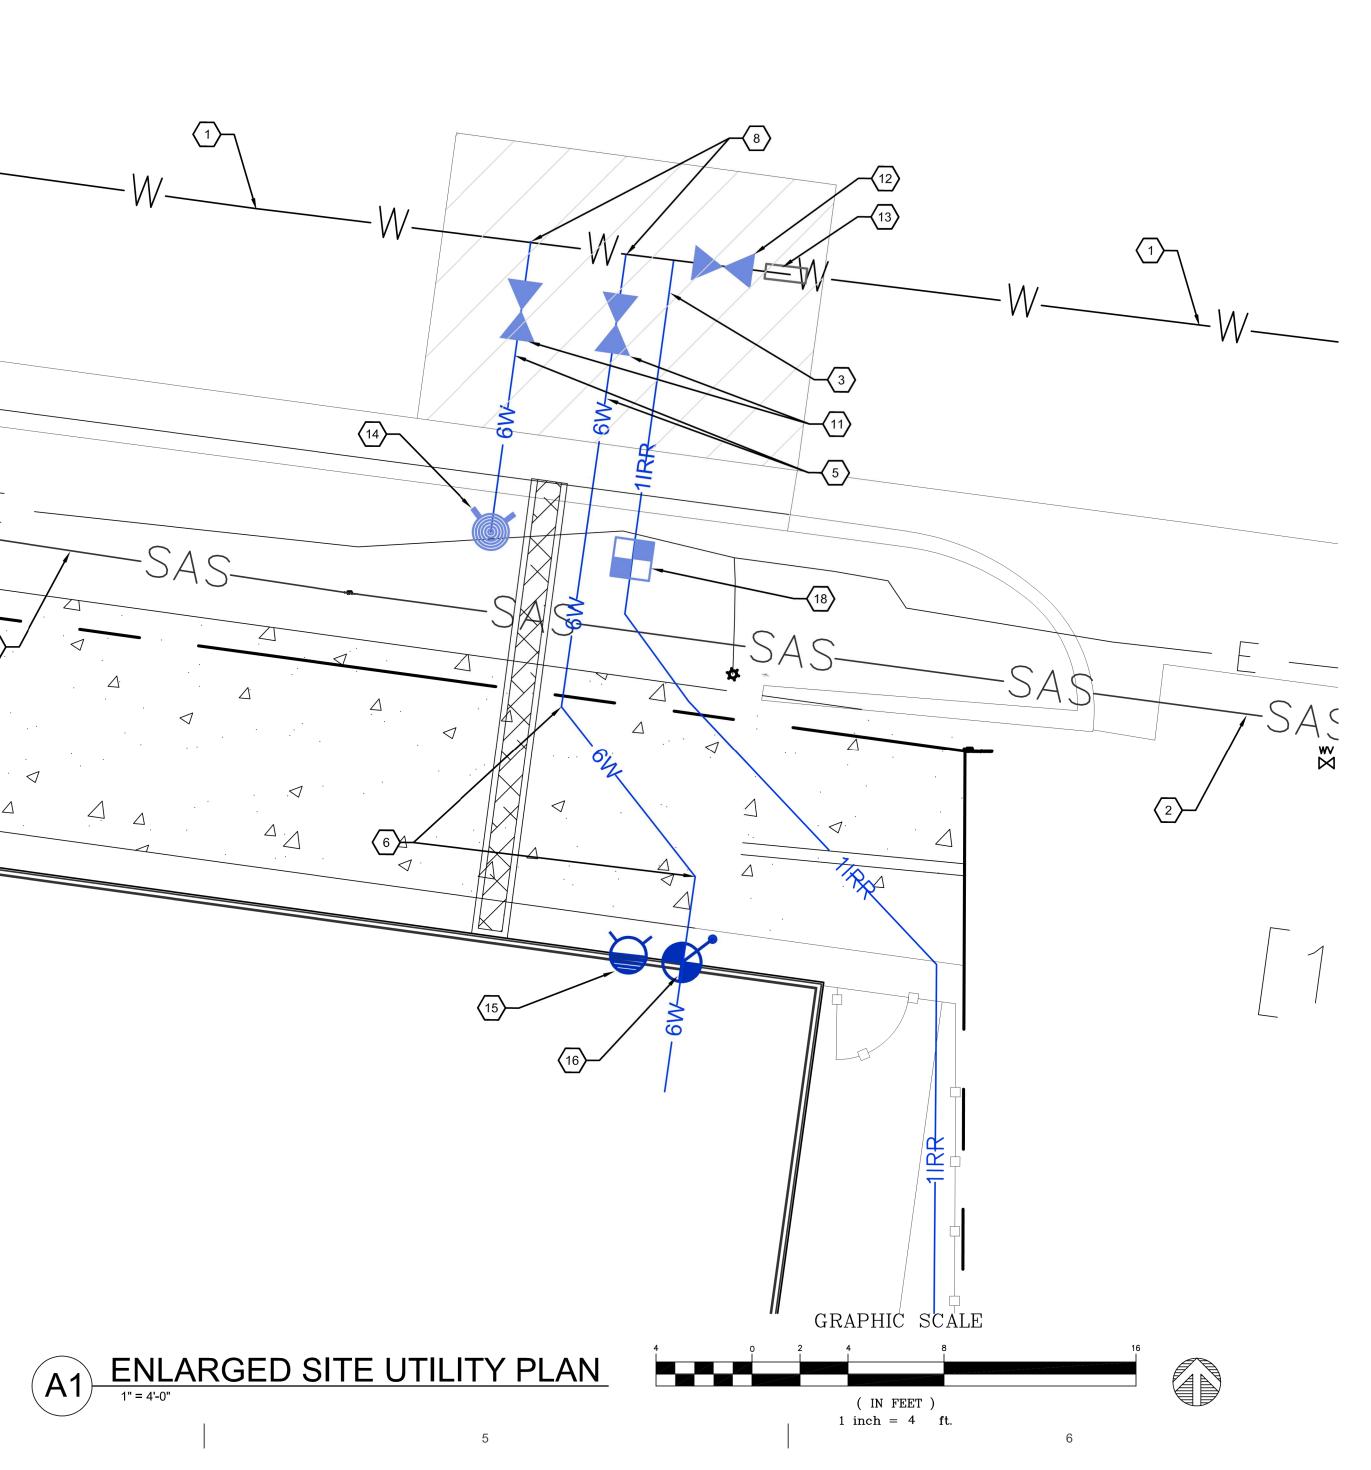



SHEET TITLE

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NO.	DATE	DESCRIPTION								
Copyright: Design Group										
Drawn	by	DAA								
Checke	d by	DAA								
Date		July 15, 2021								
Project	number	2574								

REVISIONS

ALBUQUERQUE, NM 87108

5000 CENTRAL AVENUE NE

SITE PLAN - DRB PROJECT NAME HILAND PLAZA

David Aube Department, CN=David Aube Date: 2021.07.16 09:09:31-06'00'

STAMP

CONSULTANT

THE HARTMAN + MAJEWSKI


DESIGN GROUP

Architects • Engineers • Interior Design


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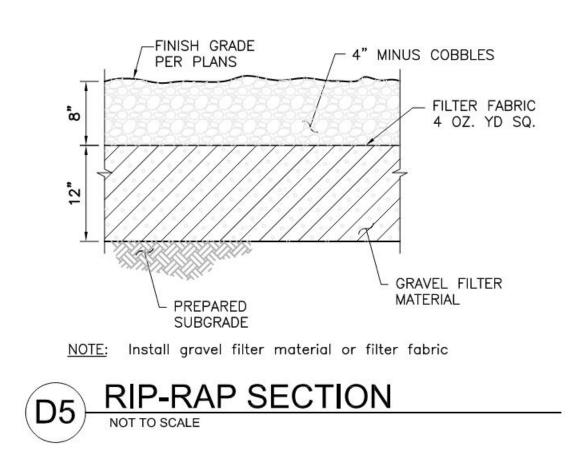
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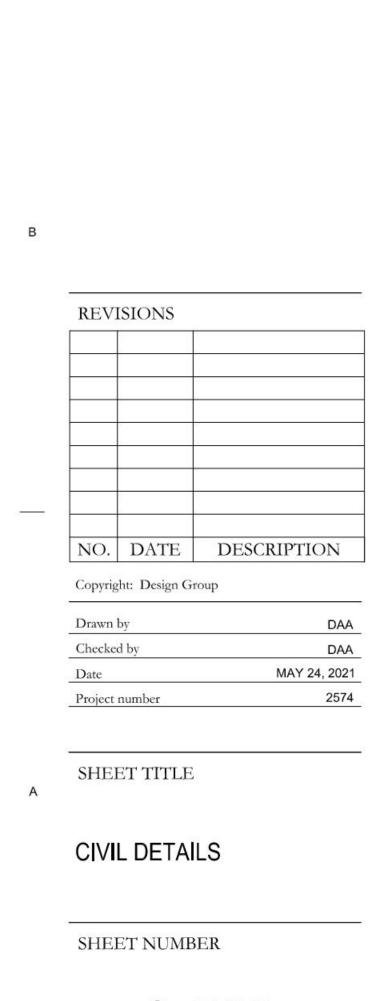





### 5000 CENTRAL AVENUE NE ALBUQUERQUE, NM 87108

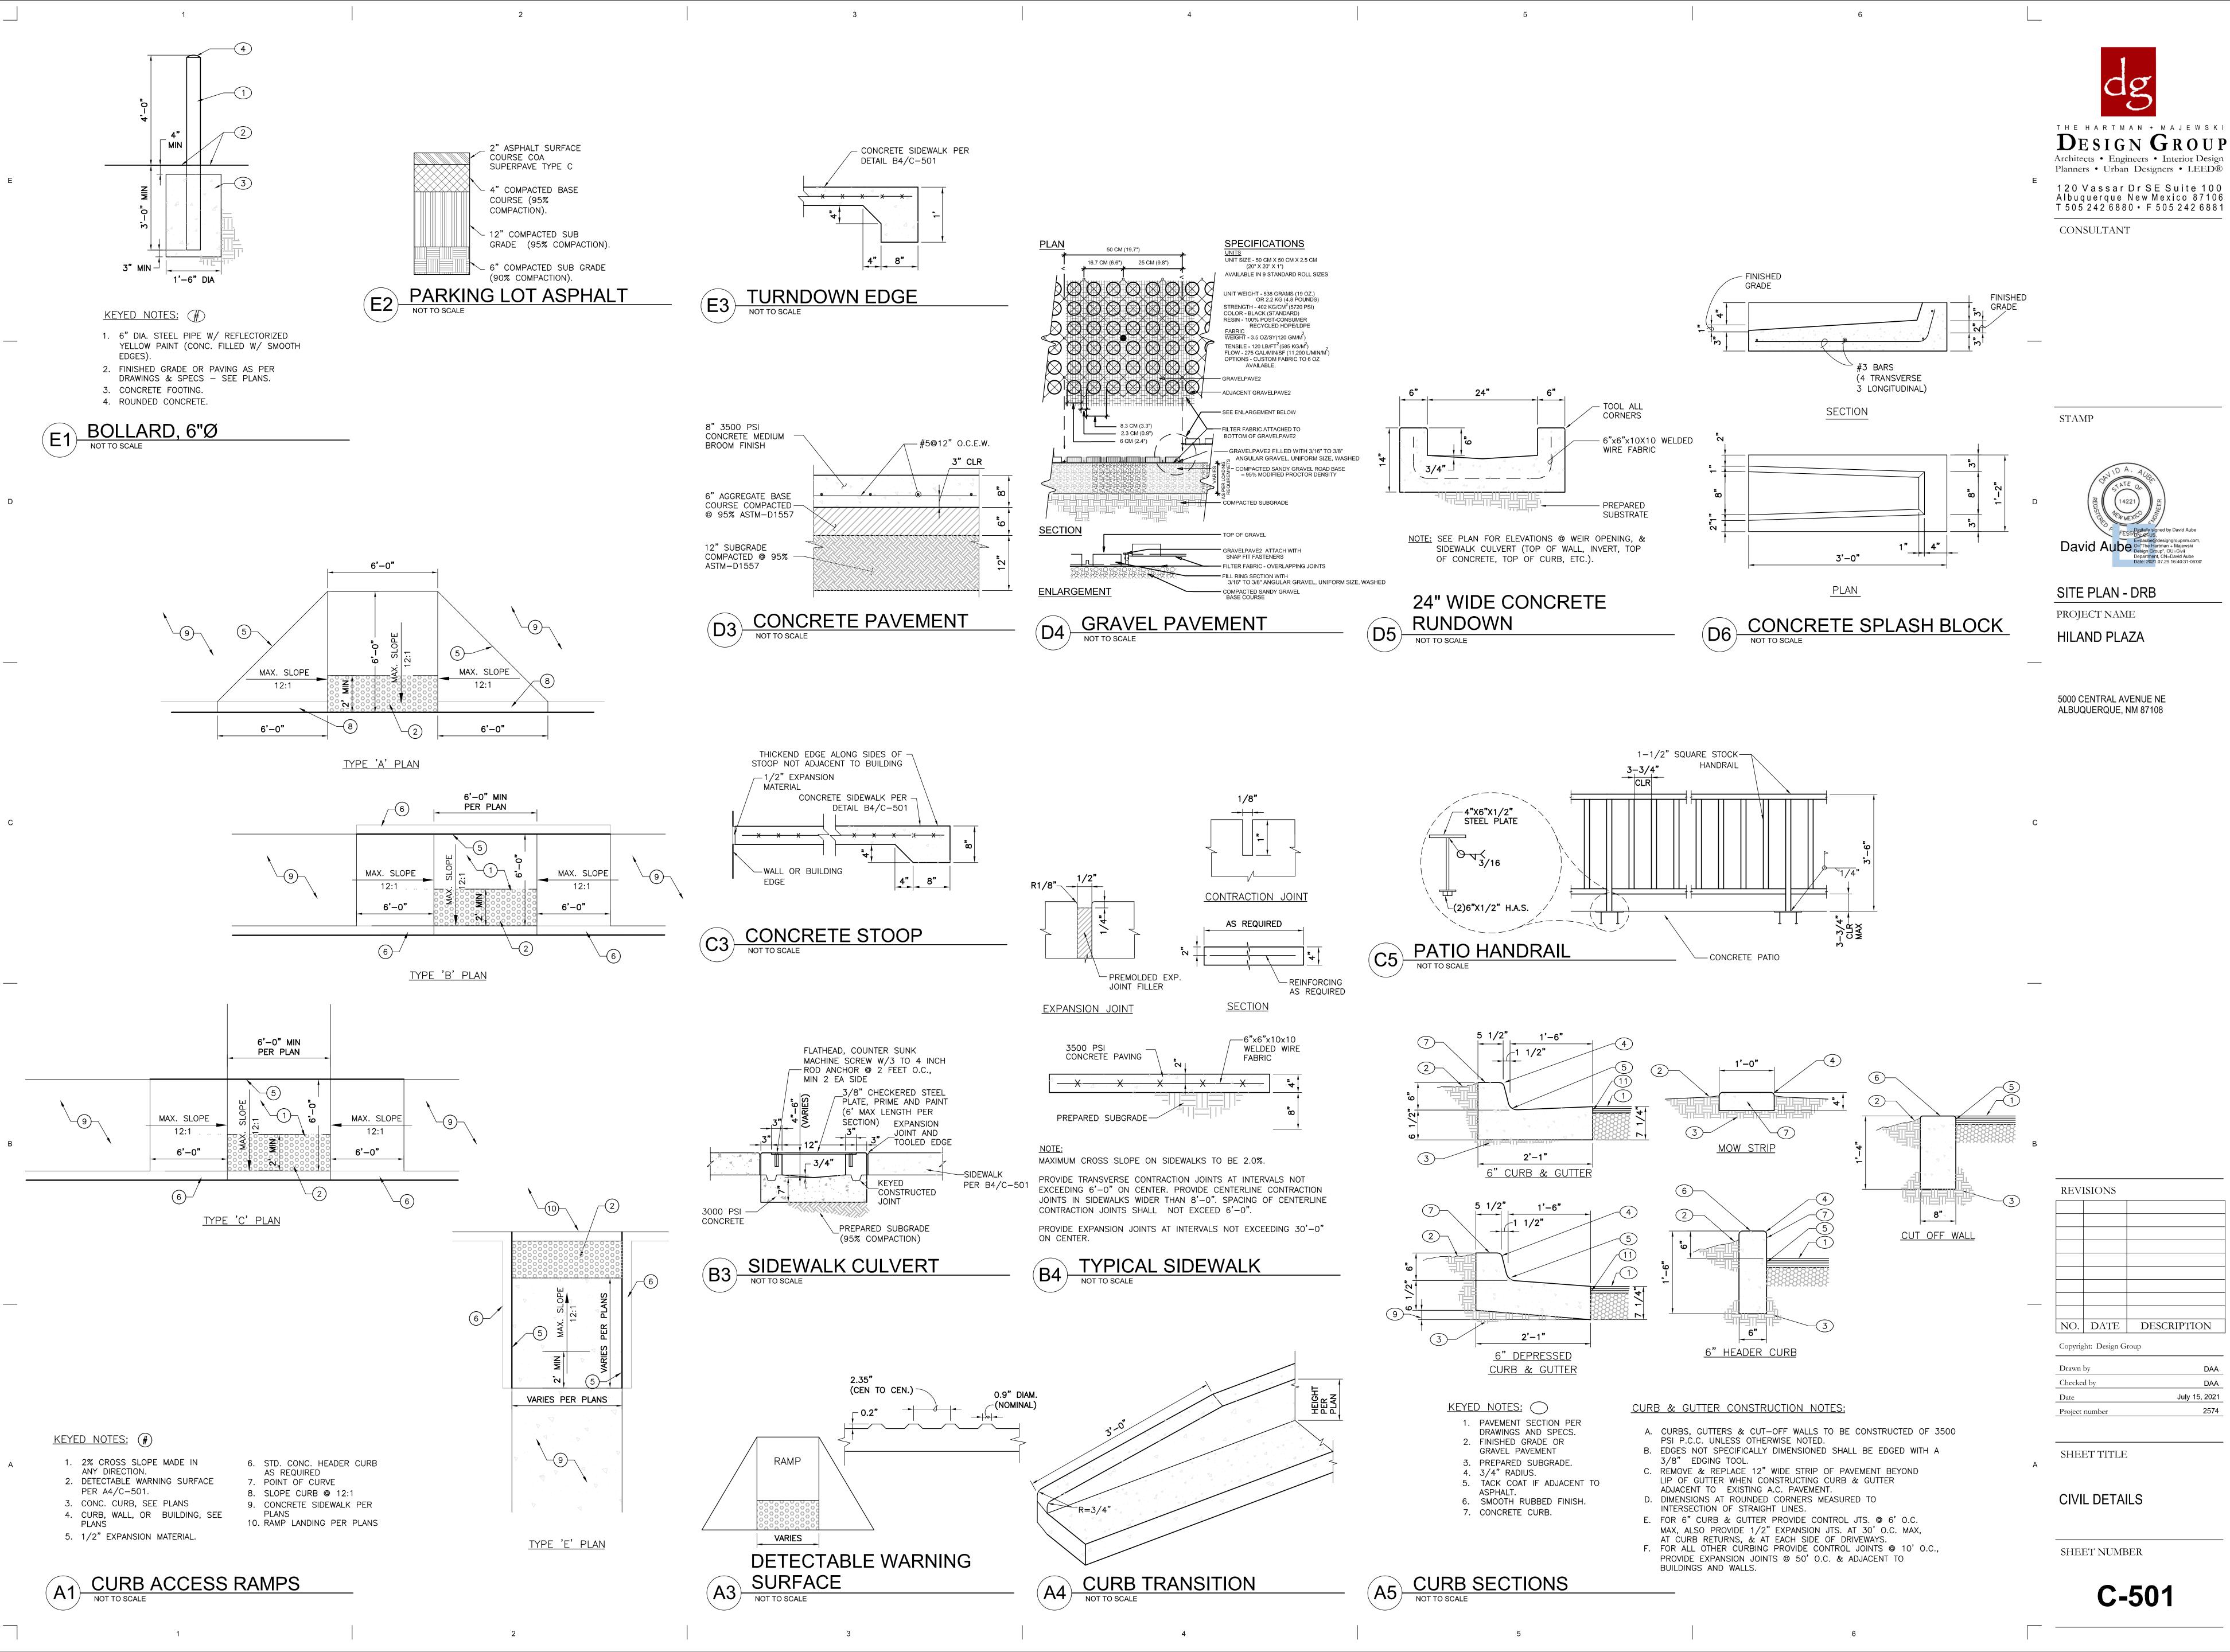
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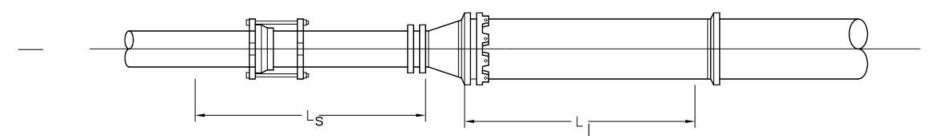
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C-502




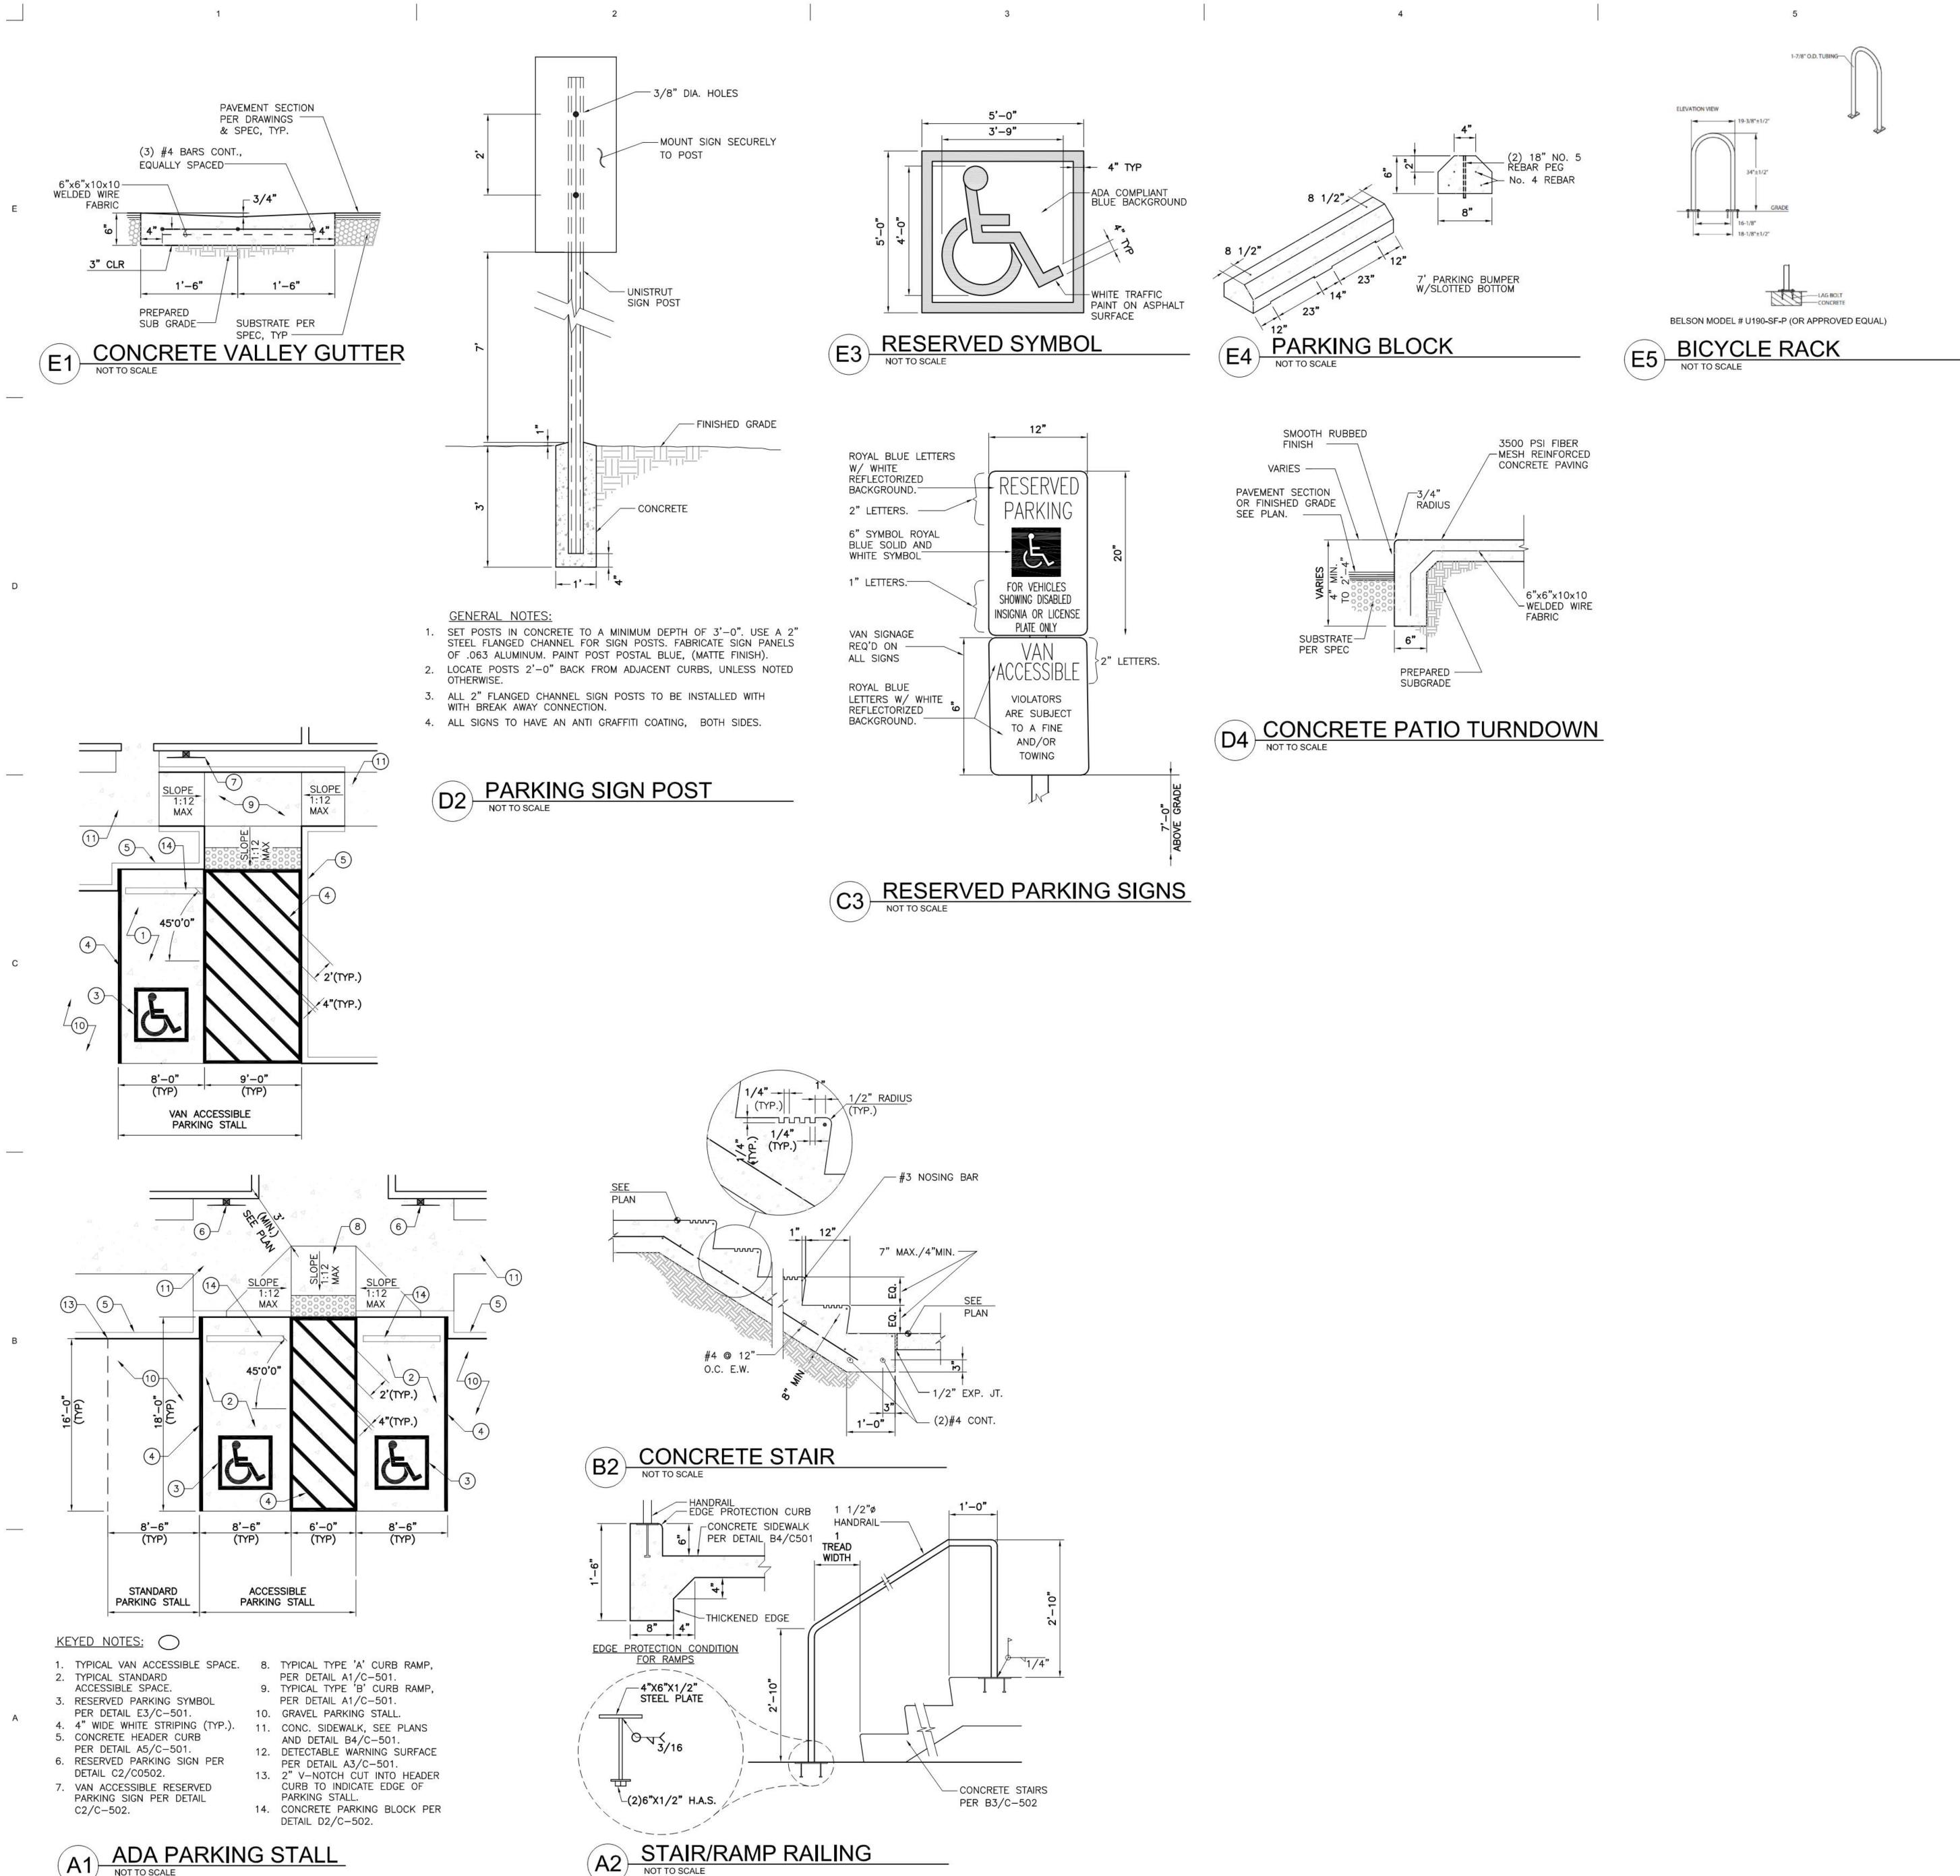

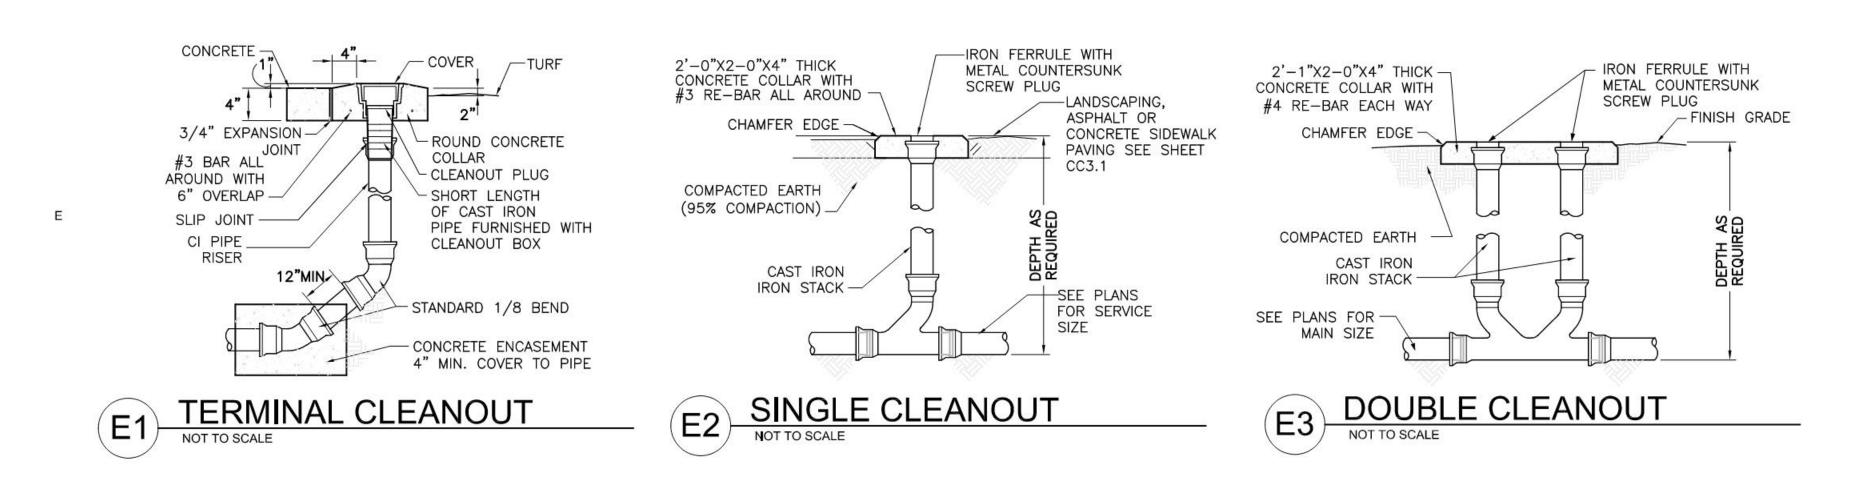


							<u>TEE</u>	S								
LINE	BRANCH SIZE 6"					BRANCH	H SIZE	8"		BRANCH	SIZE	10"		BRANCH	H SIZE	12"
SIZE	$L_{r} = 5'$	$L_{r} = 10^{3}$	'L <sub>r</sub> =15'	L <sub>r</sub> =20'	L =5'	$L_{r} = 10'$	L <sub>r</sub> =15'	Lr = 20'	L =5'	$L_{r} = 10'$	L <sub>r</sub> =15'	Lr = 20'	L =5'	$L_r = 10$	L <sub>r</sub> =15	'  L <sub>r</sub> =
		20 21	20 1			RESTRA	INED LE	ENGTH L <sub>E</sub>	, FEET	FOR A	SPECIF	TIED Lr		74 14		10 10
6"	36	18	FJO	FJO	58	44	30	16	75	64	53	41	-	-	-	-
8"	30	6	FJO	FJO	53	35	16	FJO	71	56	42	27	-			-
10"	24	FJO	FJO	FJO	48	24	1	FJO	67	48	29	10	86	70	54	38
12"	17	FJO	FJO	FJO	43	14	FJO	FJO	63	40	17	FJO	83	63	44	25
14"	FJO	FJO	FJO	FJO	21	FJO	FJO	FJO	39	12	FJO	FJO	56	33	11	FJ

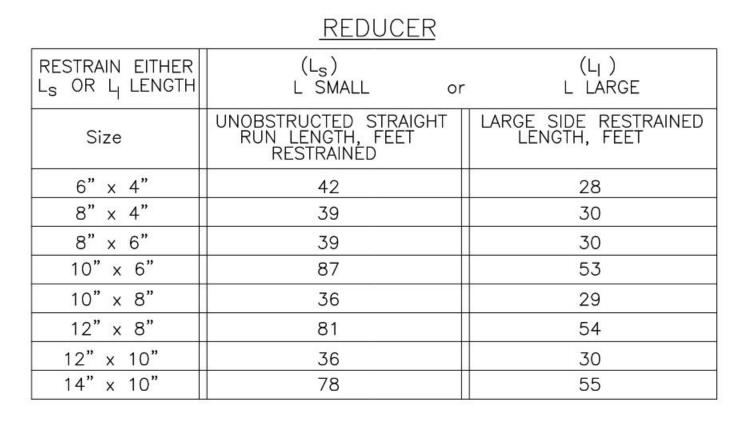
FJO: RESTRAINT REQUIRED AT FITTING JOINT ONLY

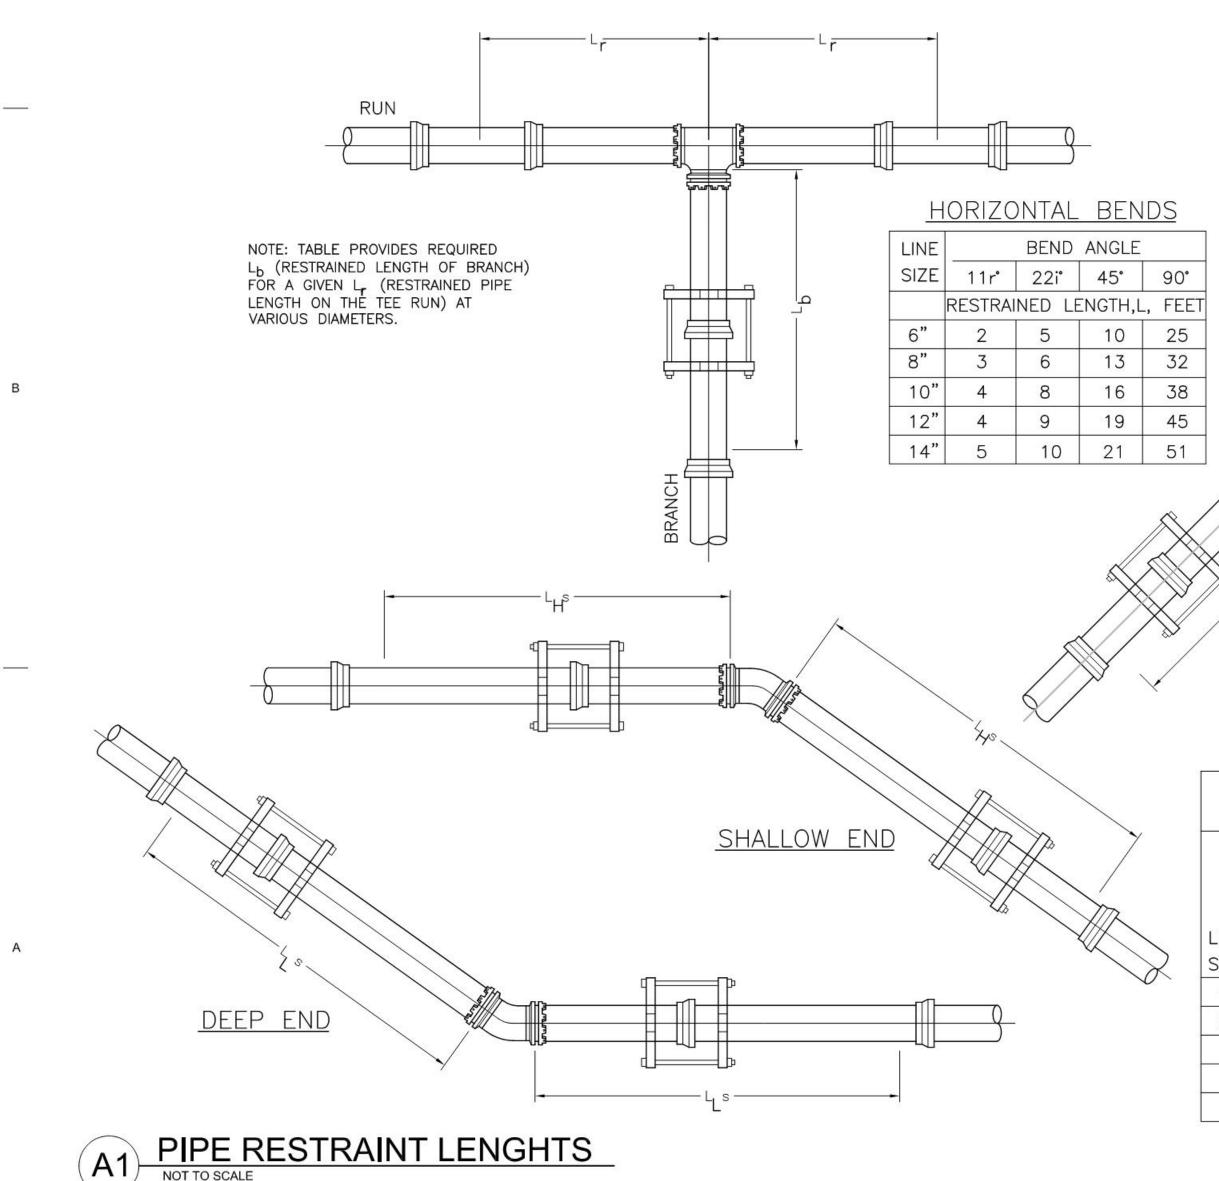



LINE	RESTRAINED LENGTH L,
SIZE	BOTH SIDES OF VALVE, FEET
4"	39
6"	55
8"	72
10"	86
12"	102
14"	116

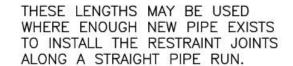

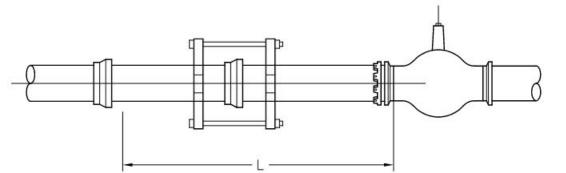


### THRUST RESTRAINT GENERAL NOTES

- . RESTRAINED PIPE LENGTHS FOR PVC USING EBAA IRON THRUST RESTRAINING SYSTEM.
- LENGTHS MAY OVERLAP TO DETERMINE GREATEST RESTRAINT LENGTH IN ANY ONE DIRECTION.
- CONTRACTOR SHALL MINIMIZE NUMBERS OF RESTRAINED JOINTS REQUIRED BY USING 20' LONG SECTIONS OF PIPE WITHIN THE RESTRAINED LENGTH WHERE POSSIBLE. DIVIDE LENGTH BY 20 AND TRUNCATE DECIMAL PORTION OF NUMBER TO DETERMINE THE NUMBER OF
- REQUIRED RESTRAINED JOINTS. SPECIAL CONSIDERATION MAY BE NEEDED TO
- MEET CERTAIN FIELD CONDITIONS. RESTRAINT LENGTHS MAY EXTEND INTO EXISTING
- WATER MAINS, REQUIRING RESTRAINED FITTINGS TO BE PLACED AT EXISTING WATERLINE JOINTS FOR THE LENGTH SPECIFIED IN THE TABLES ON THIS SHEET.
- 6. CONCRETE BLOCKING, PER COA STANDARD DRAWING 2320, SHALL BE USED IN LIEU OF RESTRAINED JOINTS AT ALL CAPS. DESIGN ASSUMPTIONS:
- SAFETY FACTOR: 1.5 PRESSURE: 150 PSI
- SOIL TYPE: GM & SM SILTY GRAVELS AND SILTY SANDS PIPE: PVC
- TRENCH TYPE: 3 (PIPE BEDDED IN 4 INCHES MINIMUM LOOSE SOIL. BACKFILL LIGHTLY CONSOLIDATED TO TOP OF THE PIPE.)

VERTICAL OFFSETS ADDITIONAL DESIGN PARAMETERS SHALLOW FND DEPTH = 3.0'

	$\frac{1}{\text{DEEP END DEPTH} = 6.0'}$												
		22	21° BEND			4	5° BEN	D					
	RESTRAINED LENGTH												
LINE	DEEP	END	SHALLOW	END	DEEP	END	SHALL	WC	END				
SIZE	L <sub>L</sub> S,	FEET	L <sub>H</sub> S, FE	ΕT	L <sub>L</sub> S,	FEET	L <sub>H</sub> S,	FEI	ET				
6"	13	3	11		ţ	5	23						
8"	6.1	3	14		-	7		30					
10"	4	ļ.	17		8	3	36						
12"	5	5	20		8	10	42						
14"	5	5	23		2	11		48					


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### CONSTRUCTION NOTES:

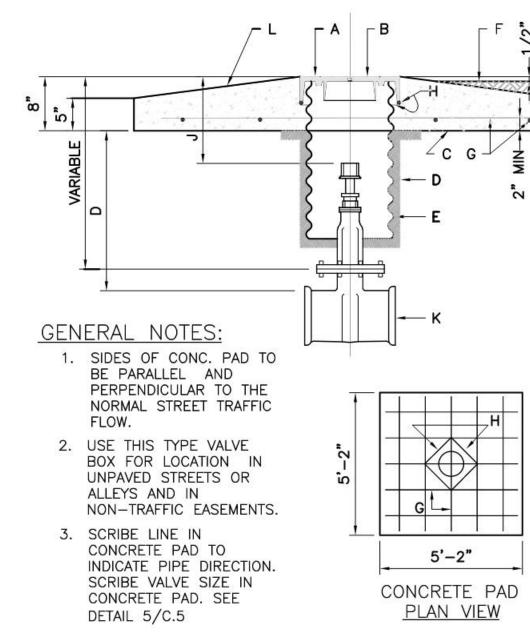- A. RING. B. COVER.
- C. PORTLAND CEMENT CONC. 3500 P.S.I.
- D. COMPACTED EARTH FILL, 95% OF MAX. DENSITY AS DETERMINED BY A.S.T.M. D-1557.
- E. 12" DIA. CORRUGATED GALV. CULVERT PIPE 14 GA. DIPPED IN COAL TAR ENAMEL OR COATED WITH POLYMERIC COATING. 3 MILS THICK MIN. MEETING REQUIREMENTS SET BY A.A.S.H.T.O.M 246. SEE DETAIL 6/C.5
- F. GROUND LEVEL. G. NO. 4 BARS AT 12" O.C. EACH WAY.
- H. NO. 4 BARS 1'-6" LONG.
- J. 2'-0" MAX., USE STEM EXTENSION AS NECESSARY. K. NEW OR EXISTING VALVE.
- L. SCRIBE IN THE FRESH CONCRETE THE SIZE OF THE VALVE.







### GENERAL NOTES:

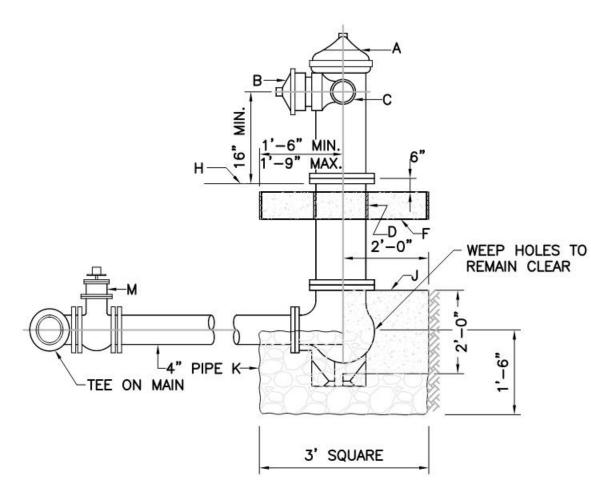- 1. NO OBSTRUCTIONS WILL BE PERMITTED WITHIN 3 FT.
- OF FIRE HYDRANT. 2. CONTRACTOR SHALL BE RESPONSIBLE FOR SETTING TOP FLANGE OF FIRE HYDRANT TO THE CONTROLLED
- ELEVATION LINE. 3. PUMPER NOZZLE TO BE SET FACING THE TRAVELED WAY, UNLESS OTHERWISE NOTED ON PLANS.
- CONSTRUCTION NOTES:
- A. FIRE HYDRANT PER SPEC'S
- B. PUMPER NOZZLE 4 1/2"
- C. HOSE NOZZLE 2 1/2" D. 1/2" EXPANSION JOINT MATERIAL
- F. 3'X3'X6" CONC. SQ. PAD, TO BE CONSTRUCTED
- AROUND FIRE HYDRANT'S CENTER LINE. H. CONTROLLED ELEV. LINE, LEVEL IN ALL DIRECTIONS
- J. CONC. THRUST BLOCK, APPROX. 2'X2'X3' TO BE POURED AGAINST UNDISTURBED EARTH, F.H. WEEP HOLE MUST BE UNOBSTRUCTED. K. GRAVEL DRAIN POCKET, COVER TOP SURFACE
- WITH TAR PAPER.
- M. IF VALVE IS REQUIRED, VALVE WILL BE CONNECTED TO TEE AT MAIN.
- **FIRE HYDRANT** A4 NOT TO SCALE

 $5' |L_r = 10' |L_r = 15' |L_r = 20'$ \_


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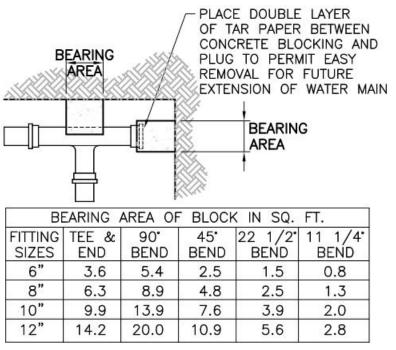


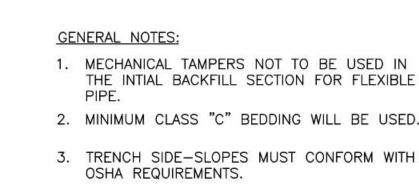


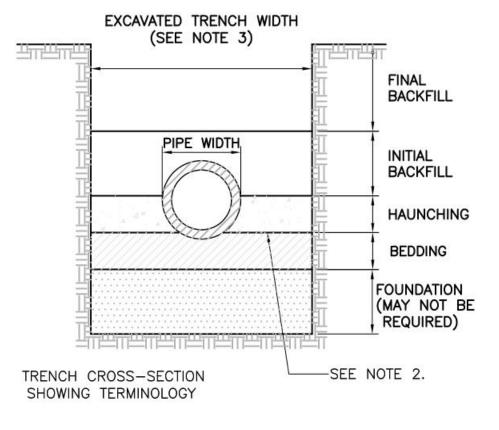






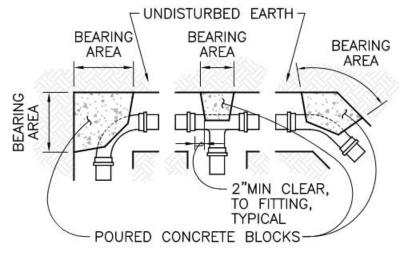

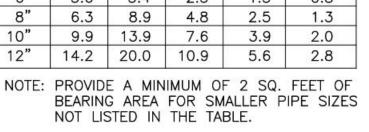



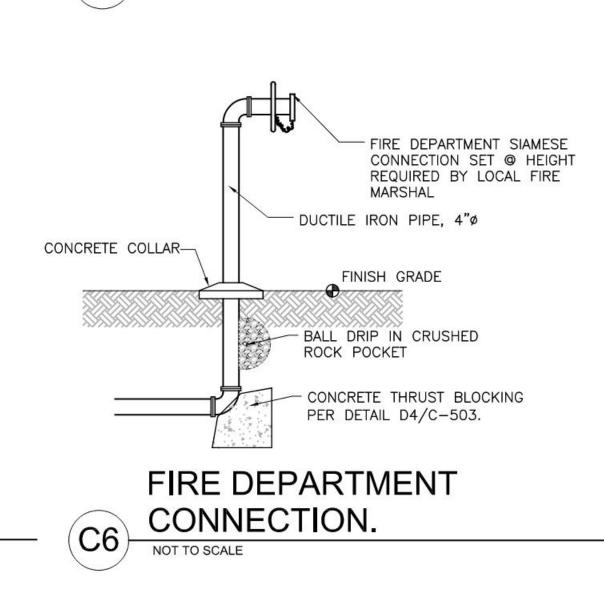


**BACKFLOW PREVENTER** 

AND HOT BOX

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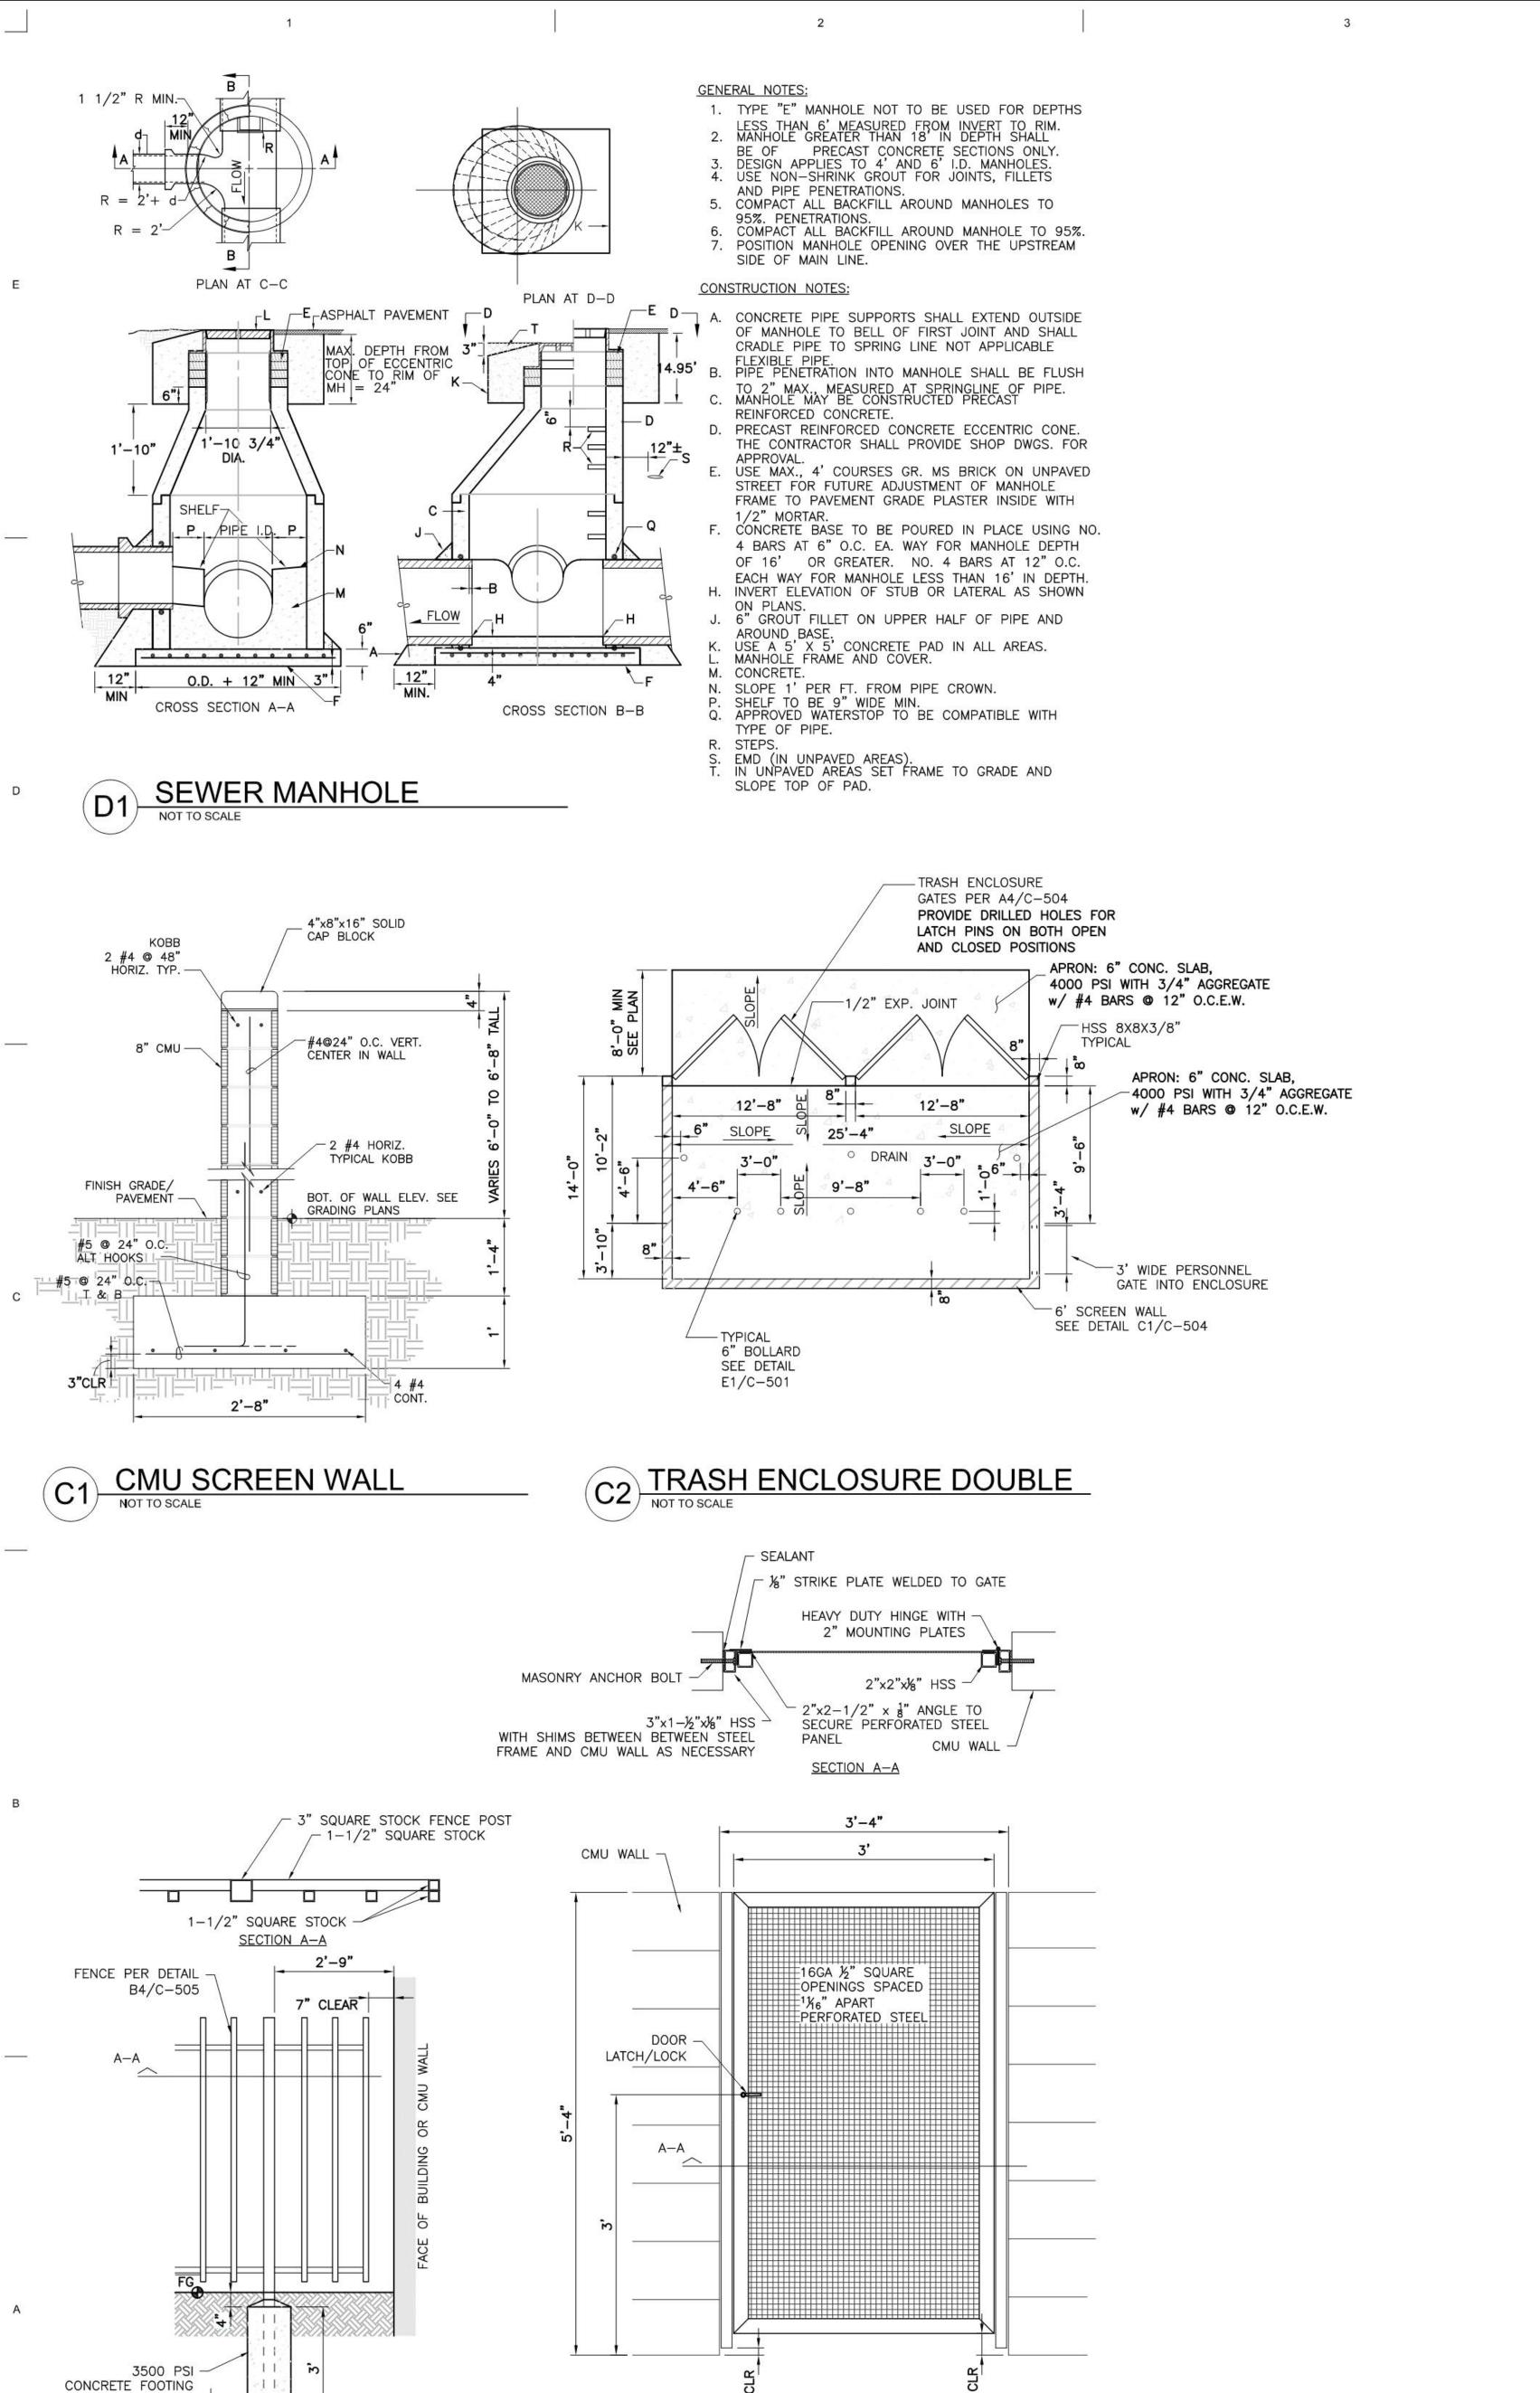
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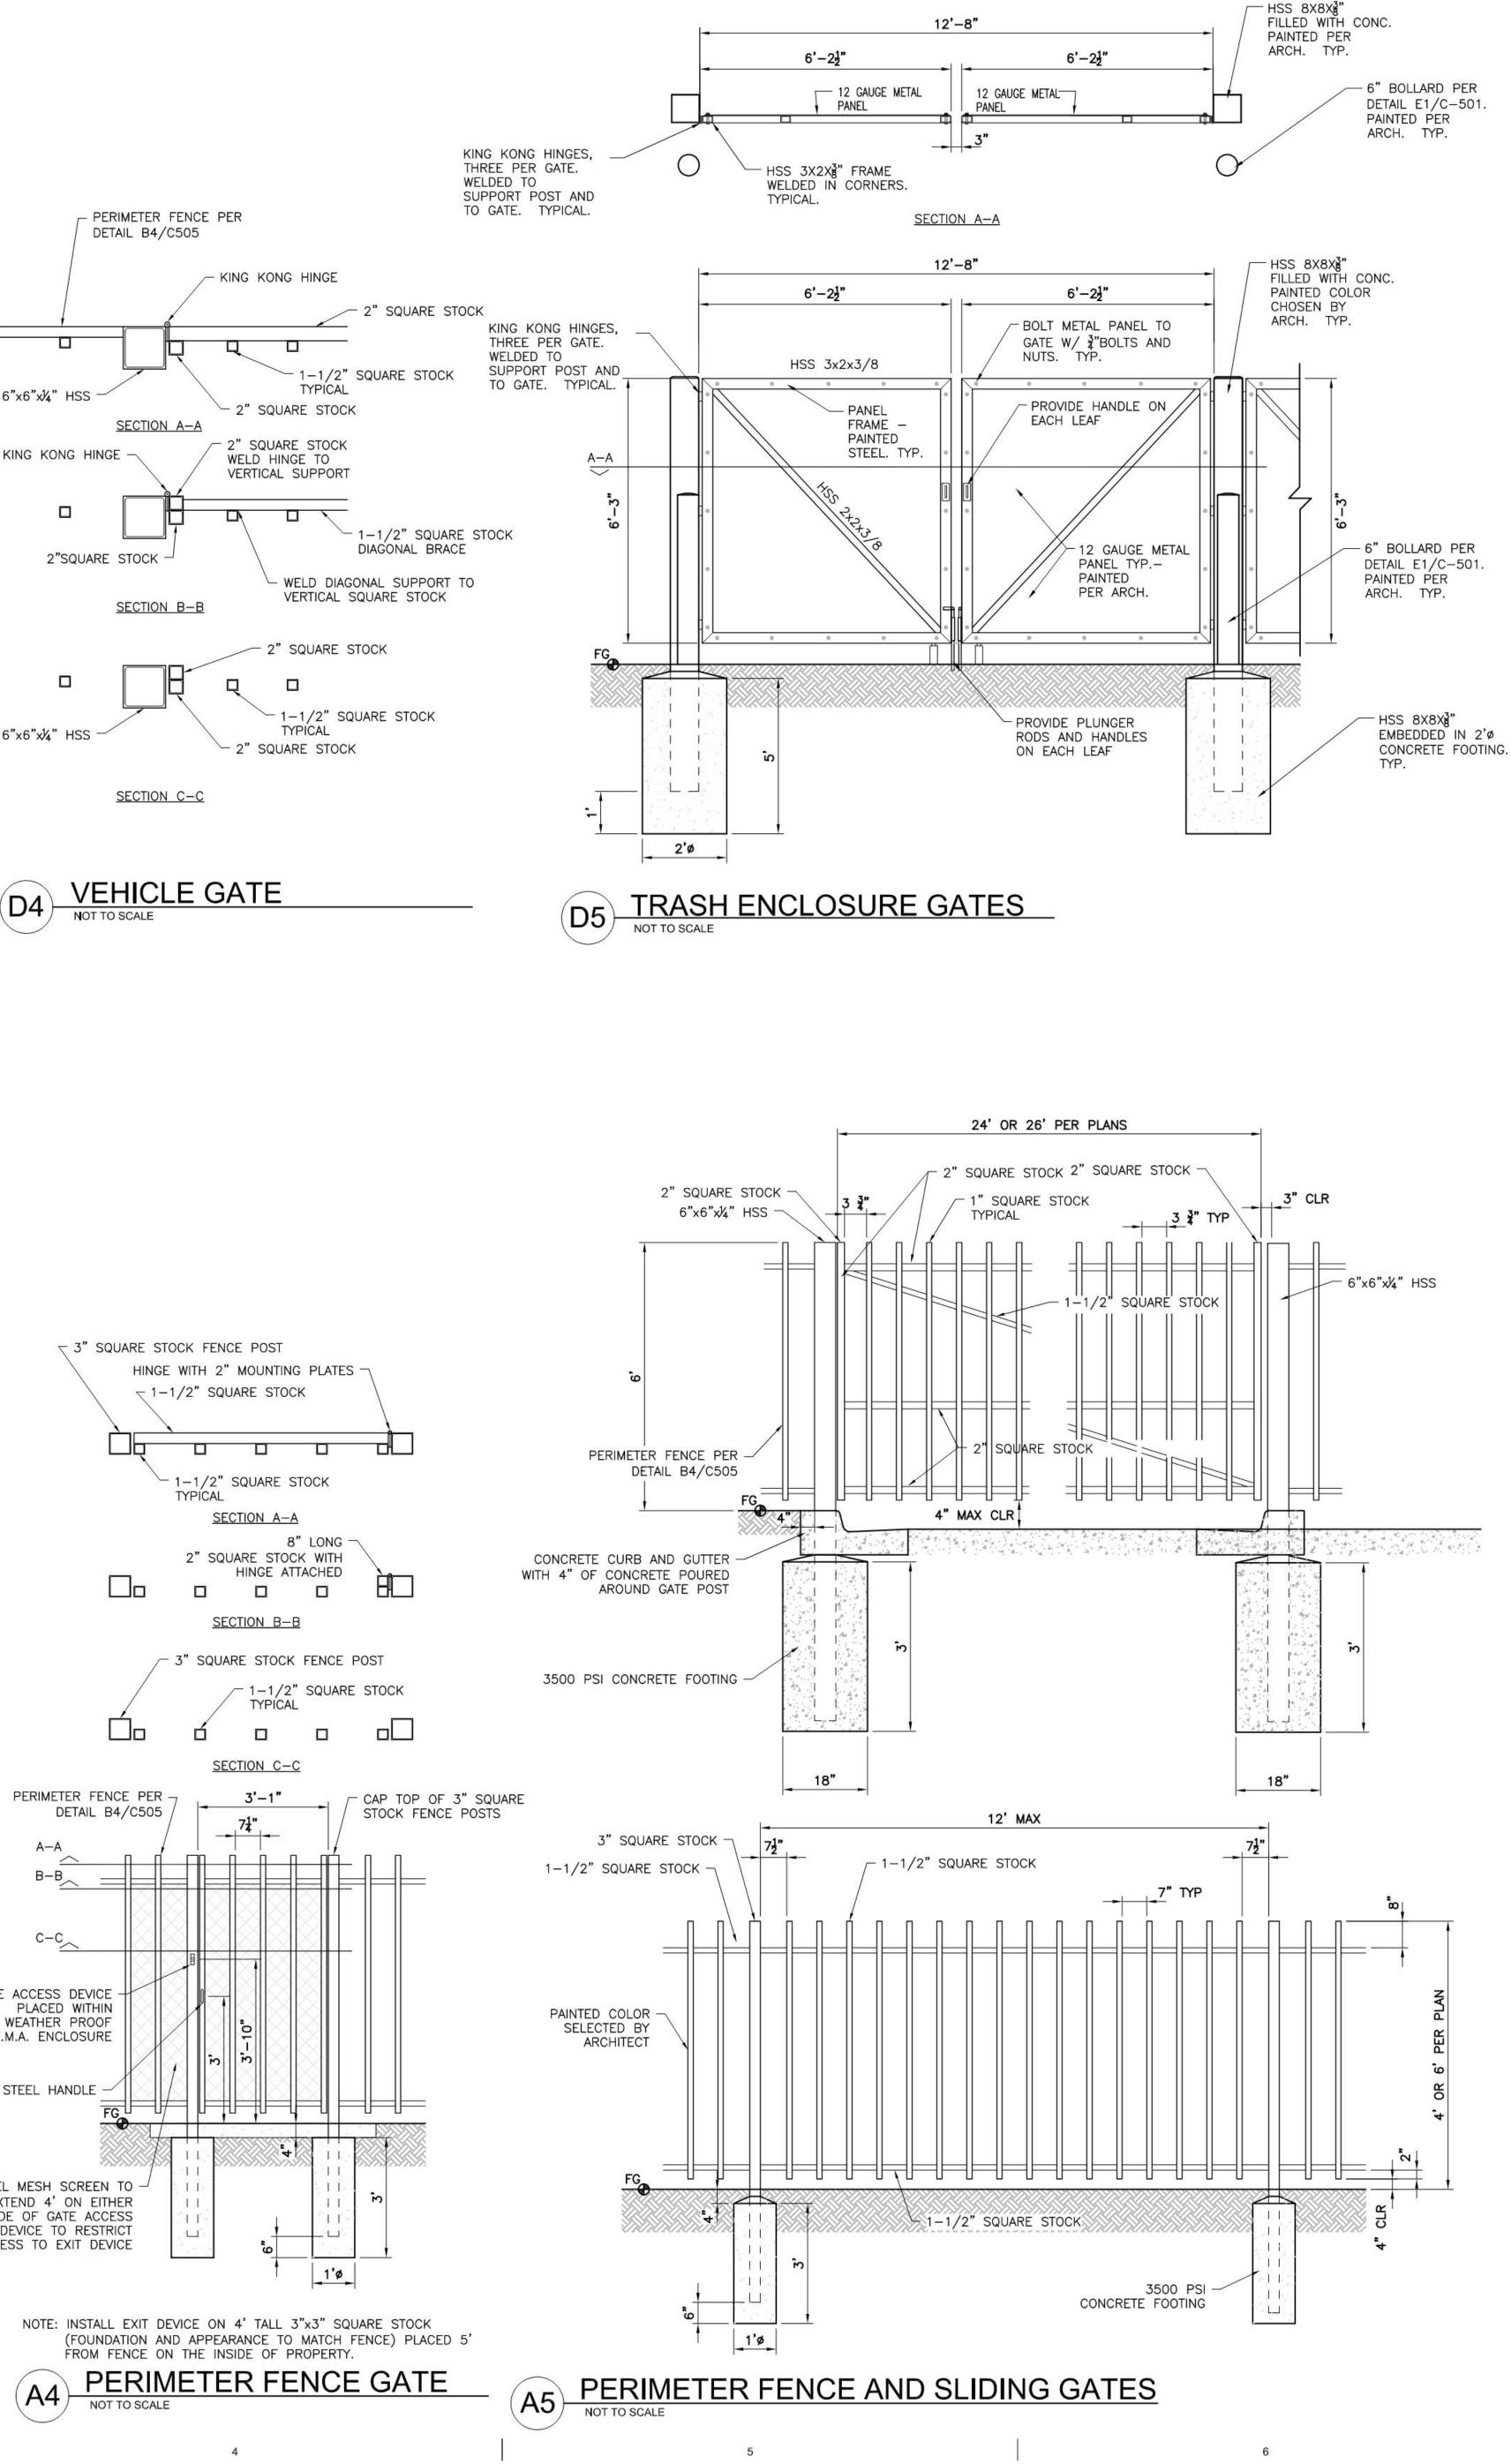
### 5000 CENTRAL AVENUE NE ALBUQUERQUE, NM 87108

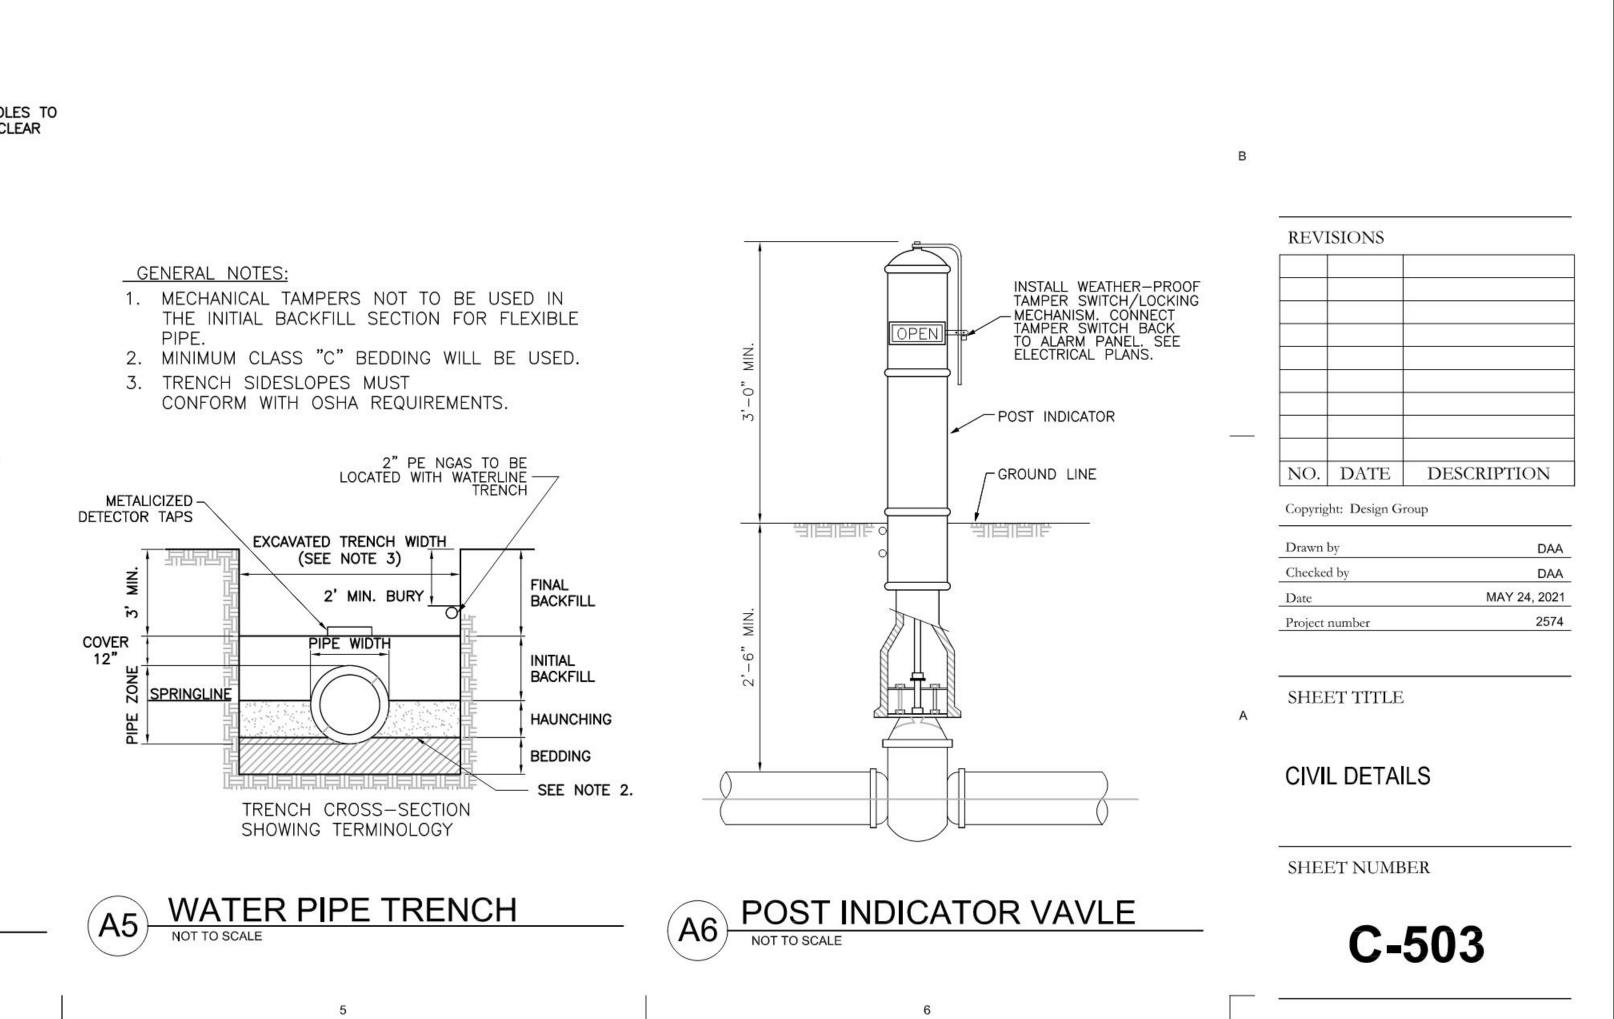


CANTILEVERED FENCE END NOT TO SCALE

1'ø

(A2) ENCLOSURE GATE






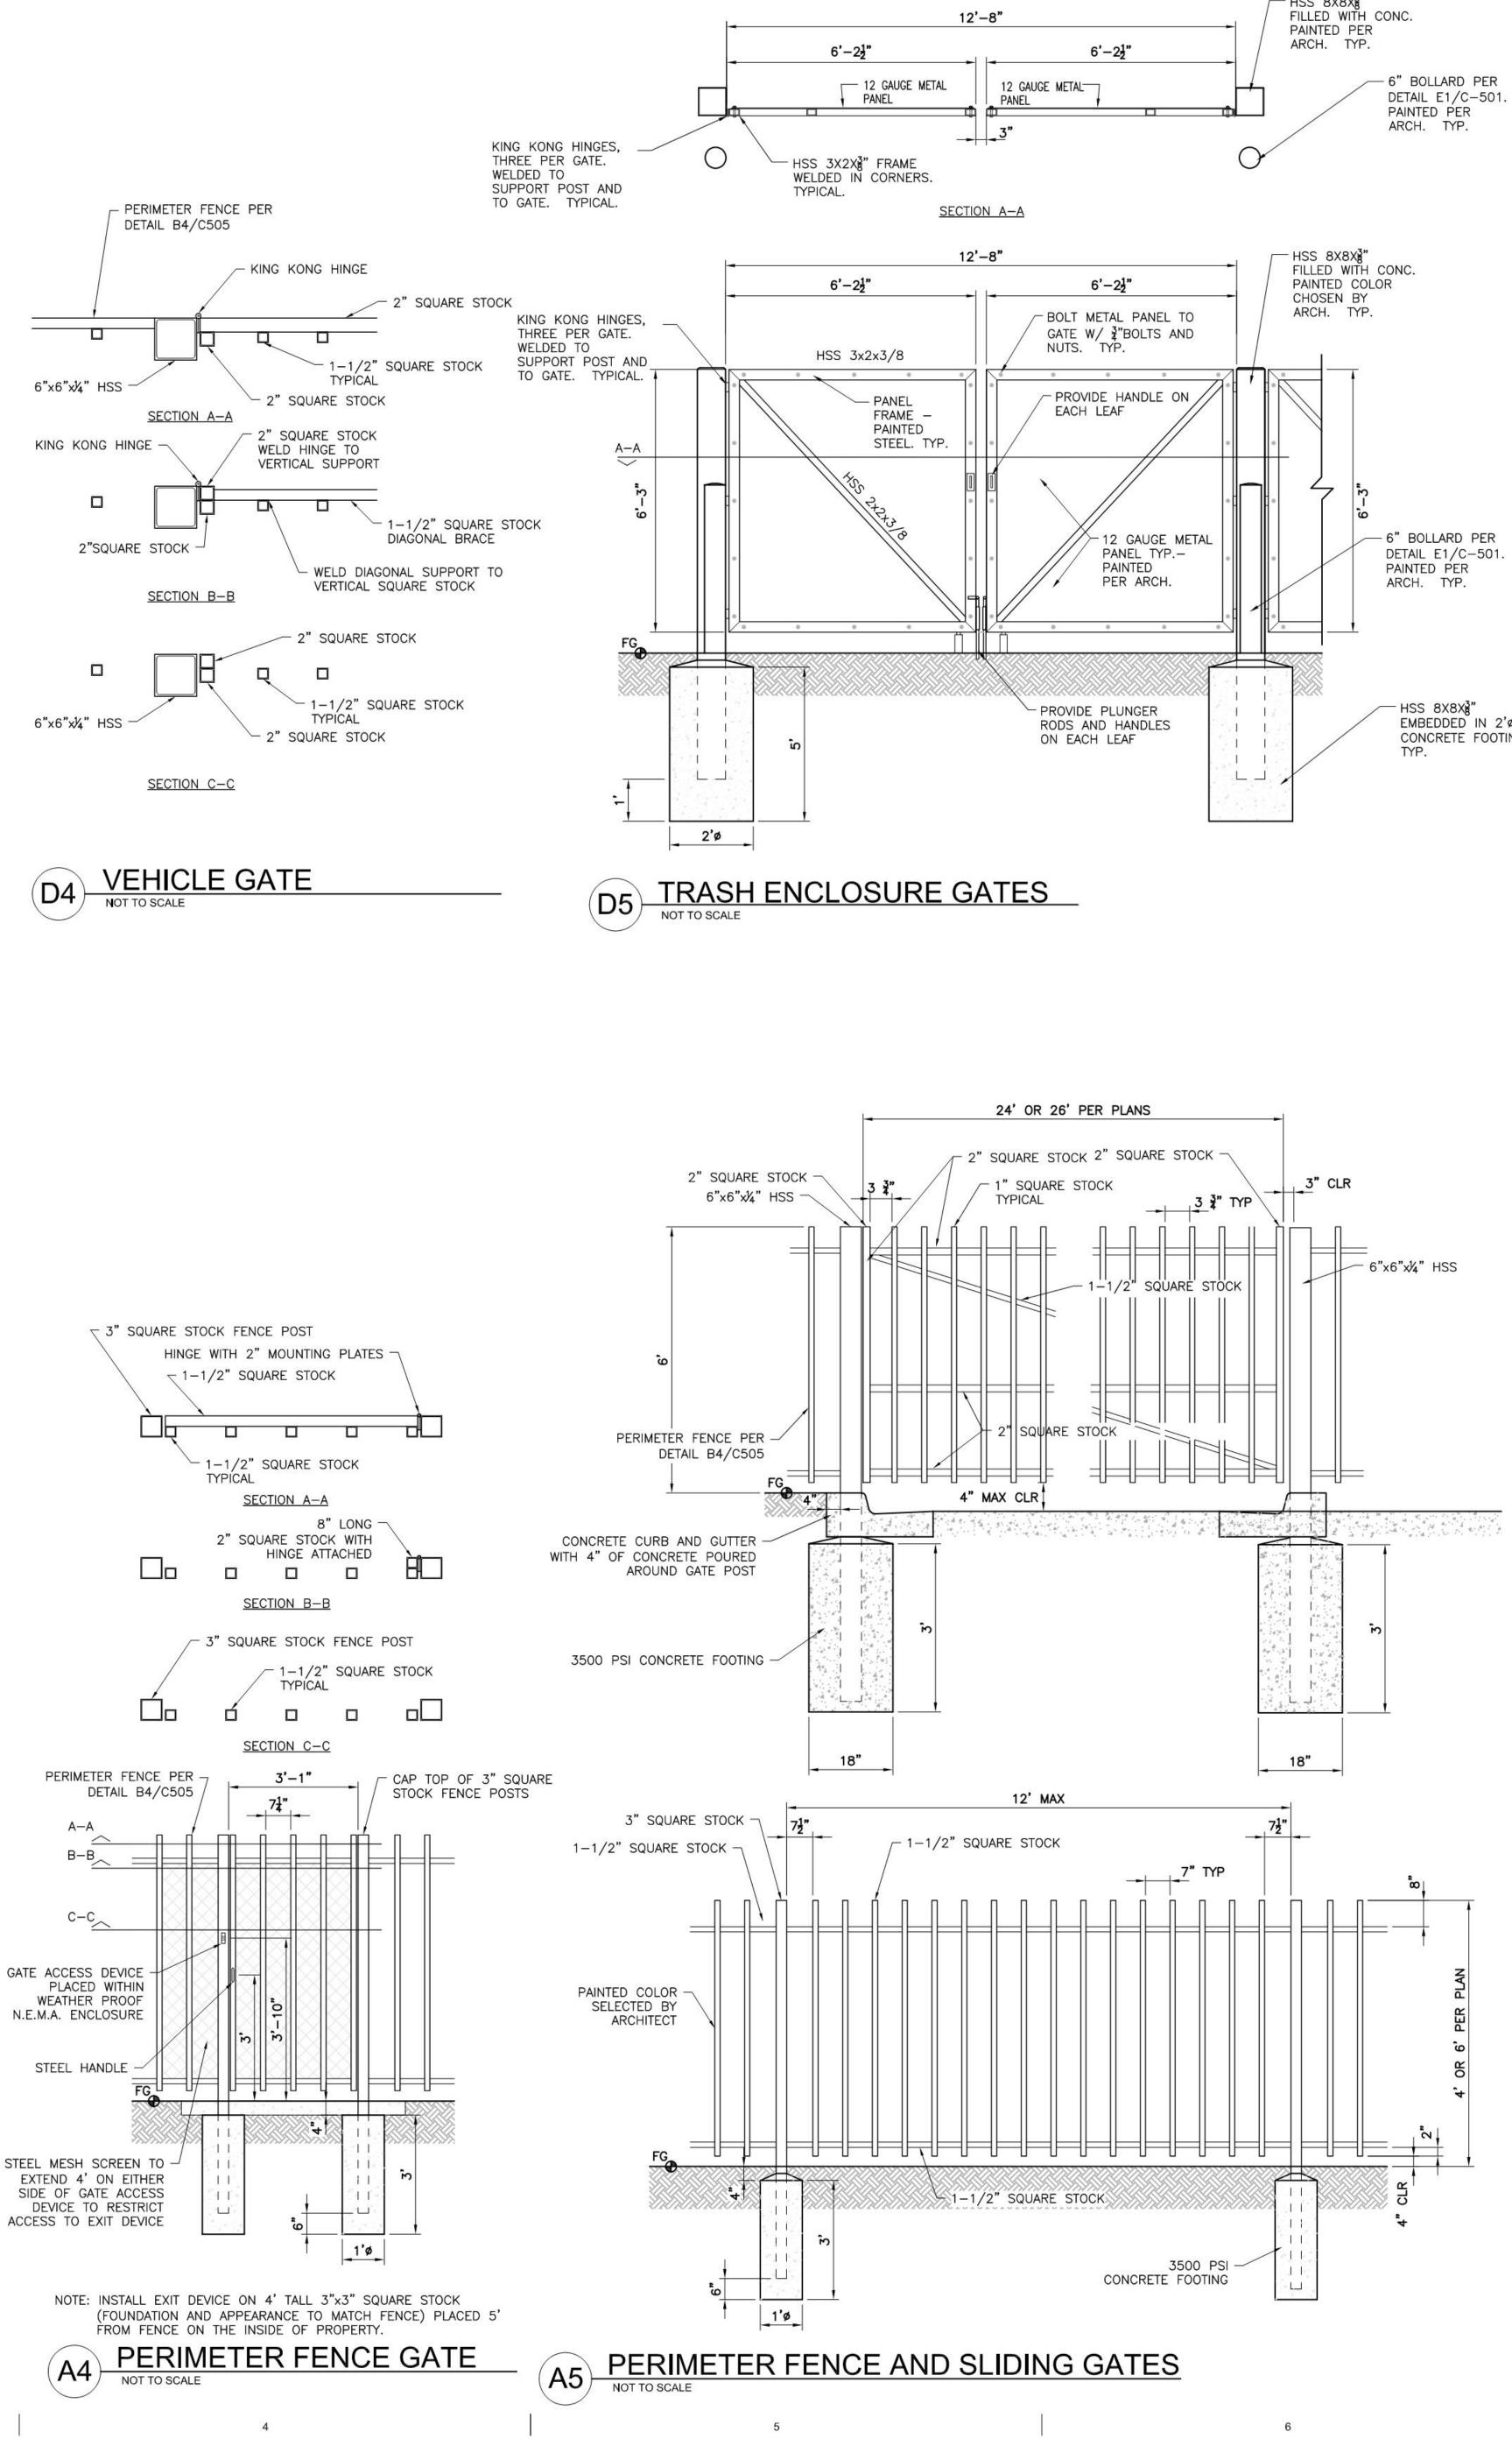


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### **5000 CENTRAL AVENUE NE** ALBUQUERQUE, NM 87108

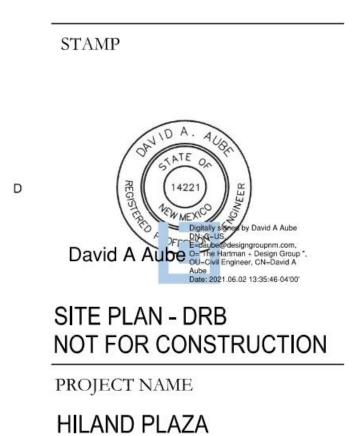

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# (A1) NORTH ELEVATIONS


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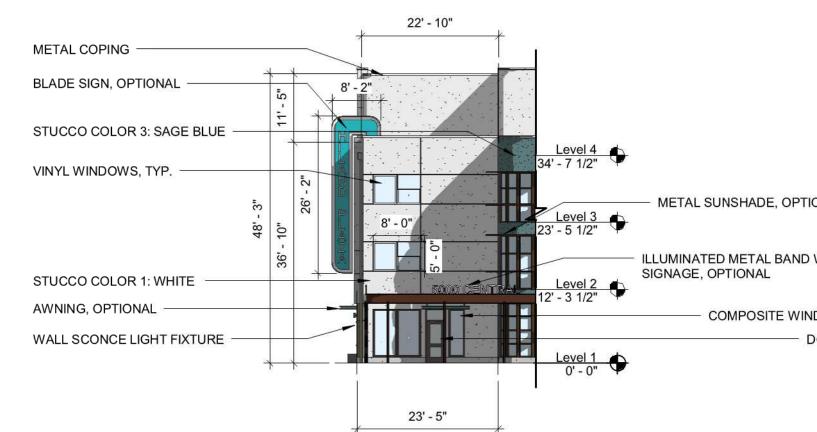
# SOUTH ELEVATION - WEST END

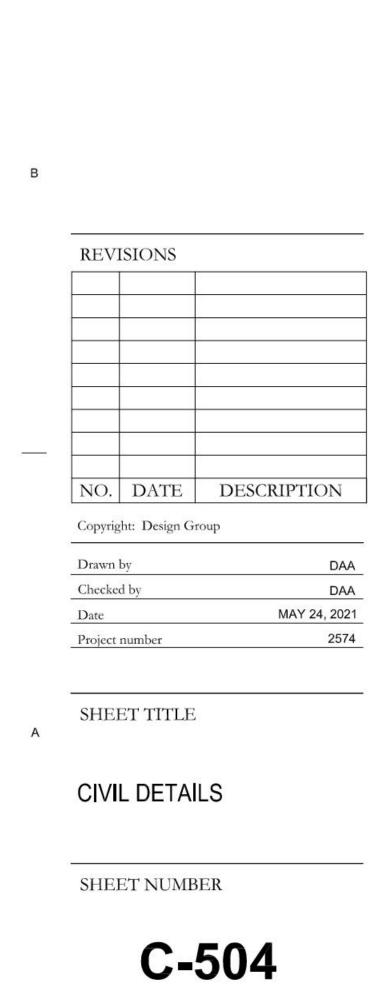


### EAST ELEVATION (C1)




### WEST ELEVATION - NORTH END (D11/16" = 1'-0"

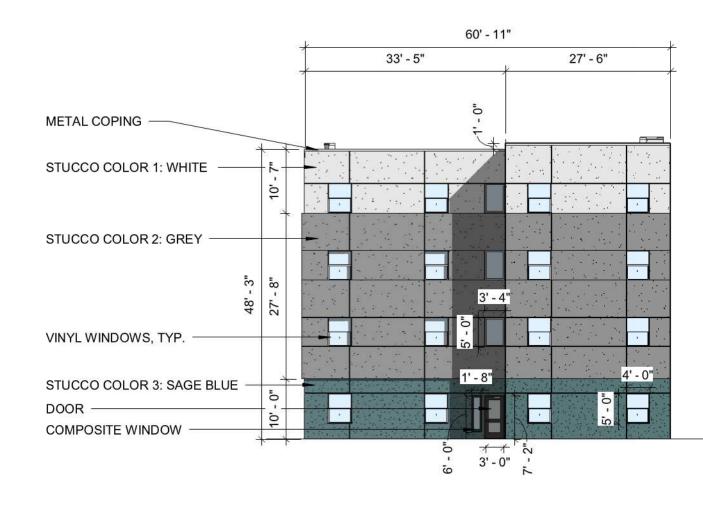

2

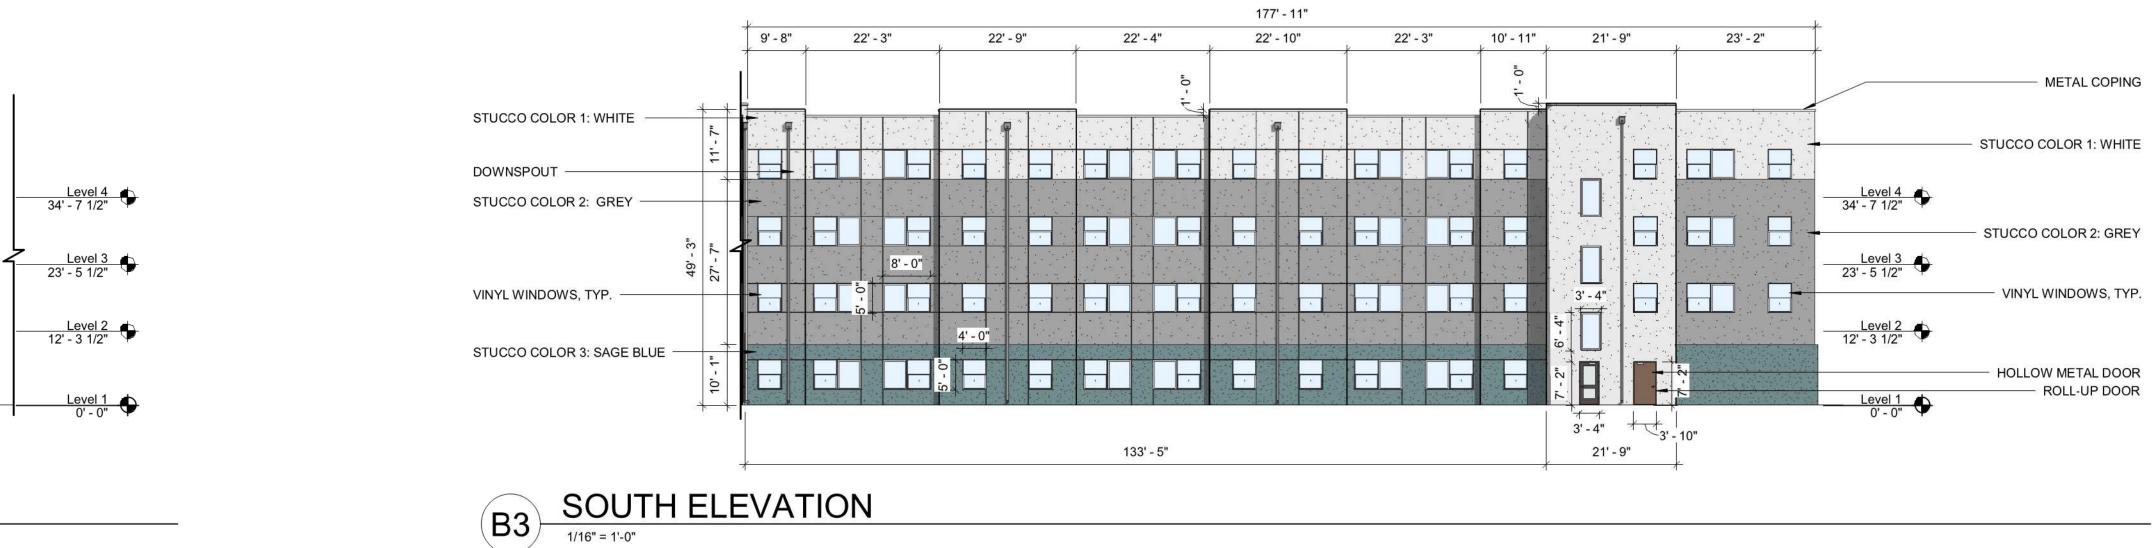

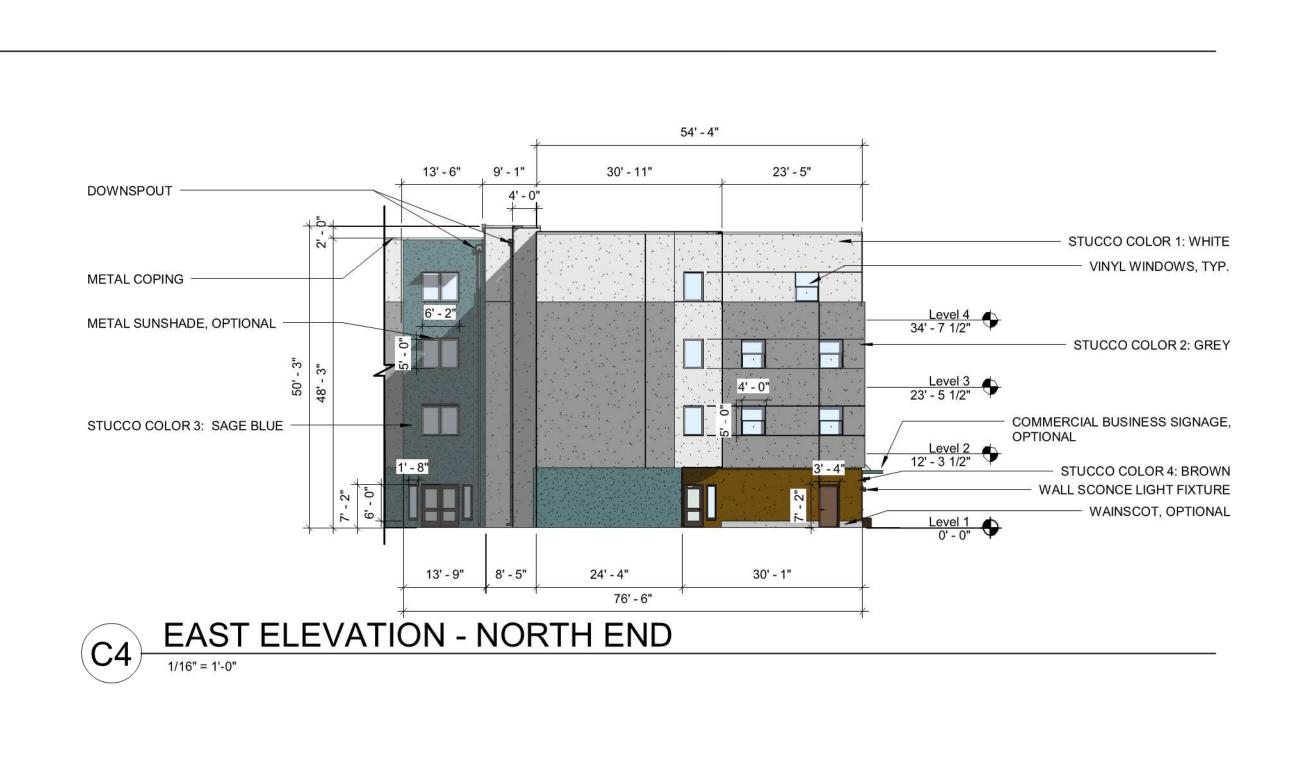

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						20	7' - 9"							
		20' - 5"	23' - 4"	12' - 0"	23' - 9"	22' - 8"	22' - 2"	22' - 11"	10' - 8"	26' - 1"	14' - 4"	9' - 5"		
	METAL COPING							· · · · · · · · · · · · · · · · · · ·		<u></u>				
	· · · · · · · · · · · · · · · · · · ·													
	METAL SUNSHADE, OPTIONAL	8' - 5"											Level 4 34' - 7 1/2"	
PTIONAL	VINYL WINDOWS, TYP.	· - 4"												VINYL WINDOWS, TYP.
ND WITH	STUCCO COLOR 1: WHITE		4'-0" 8'-0"							8'-0"	4' - 0"		Level 3 23' - 5 1/2"	STUCCO COLOR 2: GREY
													Level 2 12' - 3 1/2"	
WINDOW - DOOR	COMPOSITE WINOW												Level 1 0' - 0"	STUCCO COLOR 3: SAGE BLUE
	21	'-2" 47'-	0"	WA	INSCOT TILE, OPTIONA	ΛL.							0' - 0"	

4

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# BLADE SIGN, OPTIONAL - STUCCO COLOR 1: WHITE

— STOREFRONT

# WAINSCOT, OPTIONAL

5

0' 8' 16'

### GENERAL SHEET NOTES

- WINDOWS WILL BE RECESSED NOT LESS THAN 2 INCHES TO COMPLY WITH INTERGRATED DEVELOPMENT ORDINANCE (IDO) SECTION 5-11(D)(3). EACH FLOOR OF EVERY FACADE THAT FACES A PUBLIC STREET WILL CONTAIN A MINIMUM OF 20 PERCENT OF THE FACADE IN TRANSPARENT
- WINDOWS AND/OR DOORS TO COMPLY WITH INTERGRATED DEVELOPMENT ORDINANCE (IDO) SECTION 5-11(D)(2).
- VARIANCES OF 20% TO THE REQUIRED 60% GROUND FLOOR TRANSPARENT WINDOWS AND/OR DOORS IN IDO SECTIONS 3-4(I)(5)(B)1.B AND 3-4(I)(5)(B)4.C
- WERE APPROVED BY THE ZONING HEARING EXAMINER FOR THIS PROJECT (PR-2021-005535). VARIANCES OF 20% TO THE REQUIRED 40% SECOND FLOOR AND HIGHER TRANSPARENT WINDOWS AND/OR DOORS IN IDO SECTION 3-4(I)(5)(B)5.A D. WERE APPROVED BY THE ZONING HEARING EXAMINER FOR THIS PROJECT
- (PR-2021-005535). VARIANCES OF 6 INCHES TO THE MAXIMUM 30-INCH SILL HEIGHT IN IDO SECTIONS 3-4(I)(5)(B)4.C AND 3-4(I)(5)(B)5.C WERE APPROVED BY THE ZONING HEARING EXAMINER FOR THIS PROJECT (PR-2021-005535).

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**BUILDING ELEVATIONS** SHEET NUMBER

SHEET TITLE

NO.	DATE	DESCRIPTION									
Copyright: Design Group											
	Drawn by RH/JJ										
Drawn	by	RH/JJ									
Drawn Checke		RH/JJ VM									

REVISIONS

### HILAND PLAZA APARTMENTS LIMITED PARTNERSHIP LLLP

С

5000 CENTRAL AVENUE SE, ALBUQUERQUE, NM, 87106



STAMP

CONSULTANT



Albuquerque New Mexico 87106 T 505 242 6880 • F 505 242 6881

FIGURE 12

Date Submitted:\_7-16-21\_\_\_

Date Site Plan Approved:

### INFRASTRUCTURE LIST (Rev. 2-16-18)

EXHIBIT "A"

Date Preliminary Plat Approved:

Date Preliminary Plat Expires:\_\_\_\_\_

DRB Project No.: **PR-2021-005390** 

DRB Application No.:

TO SUBDIVISION IMPROVEMENTS AGREEMENT DEVELOPMENT REVIEW BOARD (D.R.B.) REQUIRED INFRASTRUCTURE LIST

Hiland Plaza

### PROPOSED NAME OF PLAT AND/OR SITE DEVELOPMENT PLAN

### LOTS NUMBERED ONE (1) THROUGH TWENTY-TWO (22), INCLUSIVE, IN BLOCK NUMBERED THIRTY-FOUR (34) OF THE VALLEY VIEW ADDITION TO THE CITY OF ALBUQUERQUE, NEW MEXICO, AS THE SAME IS SHOWN AND DELINEATED ON THE MAP OF SAID ADDITION, FILED IN THE OFFICE OF THE COUNTY CLERK OF BERNALILLO COUNTY, NEW MEXICO, ON SEPTEMBER 2, 1911

### EXISTING LEGAL DESCRIPTION PRIOR TO PLATTING ACTION

Following is a summary of PUBLIC/PRIVATE Infrastructure required to be constructed or financially guaranteed for the above development. This Listing is not necessarily a complete listing. During the SIA process and/or in the review of the construction drawings, if the DRC Chair determines that appurtenant items and/or unforeseen items have not been included in the infrastructure listing, the DRC Chair may include those items in the listing and related financial guarantee. Likewise, if the DRC Chair determines that appurtenant or non-essential items can be deleted from the listing, those items may be deleted as well as the related portions of the financial guarantees. All such revisions require approval by the DRC Chair, the User Department and agent/owner. If such approvals are obtained, these revisions to the listing will be incorporated administratively. In addition, any unforeseen items which arise during construction which are necessary to complete the project and which normally are the Subdivider's responsibility will be required as a condition of project acceptance and close out by the City.

							Cons	struction Cer	
Financially	Constructed	Size	Type of Improvement	Location	From	То	Priv		City Cnst
Guaranteed	Under						Inspector	P.E.	Engineer
DRC #	DRC #	<b></b>		01 1 05				,	,
		8"	Waterline	Silver Avenue SE	Jackson Street SE	East Property Line	/	/	
		8"	Sanitary Sewer	Silver Avenue SE	Jackson Street SE	East Property Line	,	1	1
		0			Jackson Sheet SL	Last Property Line	,	/	
		5'	Sidewalk	Silver Avenue SE	Jackson Street SE	East Property Line	/	1	/
							1	1	/
		6'	Sidewalk	Jackson Street	Silver Avenue SE	Central Avenue SE	1	1	/
							/	1	/
		10'	Sidewalk	Central Avenue SE	Jackson Street SE	East Property Line	/	1	/
							/	1	/
							/	/	/
		J					<u> </u>		

inancially	Constructed							Con	struction Cert	tification
uaranteed	Under	Size	Type of Improvement	Location	From	То		Pri	vate	City Cns
DRC #	DRC #							Inspector	P.E.	Engineer
								/	/	/
								1	1	/
1					Approval of Cred	table Items:		Approval o	of Creditable I	tems:
					Impact Fee Admi	strator Signature	Date	City User	Dept. Signat	ure Da
		11		NOTES		j				
		If the site i	is located in a floodplain, then the financ	ial guarantee will not be re	eleased until the LOM	R is approved by	FEMA.			
			Street li	ghts per City rquirements.						
1										
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3										
3	AGENT / OWNER			DEVELOPMENT R	REVIEW BOARD MEME	ER APPROVALS				
3 _ 	AGENT / OWNER			DEVELOPMENT R	REVIEW BOARD MEME	ER APPROVALS				
3 _ 	AGENT / OWNER David Aube			DEVELOPMENT R	EVIEW BOARD MEME	ER APPROVALS				
- 3 -			DRB CH	DEVELOPMENT R	EVIEW BOARD MEME	ER APPROVALS PARKS & RECRE		date		
	David Aube NAME (print)	<u>.</u>	DRB CH		REVIEW BOARD MEME			date		
-	David Aube NAME (print) H+M Design G	<u>.</u>		IAIR - date	REVIEW BOARD MEME	PARKS & RECRE	EATION - c	date		
The	David Aube NAME (print)	iroup	TRANSPORTATION		EVIEW BOARD MEME		EATION - c	date		
The	David Aube NAME (print) H+M Design G FIRM	Froup Digitally signed by David Auba	TRANSPORTATION	IAIR - date	EVIEW BOARD MEME	PARKS & RECRE	EATION - c	date		
The DA. AC	David Aube NAME (print) H+M Design G FIRM David Au	Deputy represent by David Autor Deputy represent by David Autor Conflict Internation - Majoreta Deputy of the Internation - Majoreta Deputy of the Internation - Majoreta Deputy of the Internation		IAIR - date DEVELOPMENT - date	REVIEW BOARD MEME	PARKS & RECRE AMAFCA	EATION - c - date			
The DA. AC	David Aube NAME (print) H+M Design G FIRM	Deputy represent by David Autor Deputy represent by David Autor Conflict Internation - Majoreta Deputy of the Internation - Majoreta Deputy of the Internation - Majoreta Deputy of the Internation		IAIR - date	REVIEW BOARD MEME	PARKS & RECRE	EATION - c - date			
The DA. AC	David Aube NAME (print) H+M Design G FIRM David Au SIGNATURE - date	Deputy represent by David Autor Deputy represent by David Autor Conflict Internation - Majoreta Deputy of the Internation - Majoreta Deputy of the Internation - Majoreta Deputy of the Internation		IAIR - date DEVELOPMENT - date	REVIEW BOARD MEME	PARKS & RECRE AMAFCA	EATION - c - date			
The DA. AC	David Aube NAME (print) H+M Design G FIRM David Au SIGNATURE - date	Deputy represent by David Autor Deputy represent by David Autor Configuration of the Stateman - Majowaki Our Gavid Department - Choka Depart Configuration of the Stateman - Majowaki Department - March Stateman - Majowaki Department -	TRANSPORTATION Property Comp. Transport of the second se	IAIR - date DEVELOPMENT - date LOPMENT - date	REVIEW BOARD MEME	PARKS & RECRE AMAFCA	EATION - c - date EMENT - d			
The D.A. AC	David Aube NAME (print) H+M Design G FIRM David Au SIGNATURE - date	Deputy represent by David Autor Deputy represent by David Autor Configuration of the Stateman - Majowaki Our Gavid Department - Choka Depart Configuration of the Stateman - Majowaki Department - March Stateman - Majowaki Department -	TRANSPORTATION Property Comp. Transport of the second se	IAIR - date DEVELOPMENT - date	REVIEW BOARD MEME	PARKS & RECRE AMAFCA	EATION - c - date			
The DA. AC	David Aube NAME (print) H+M Design G FIRM David Au	Deputy represent by David Autor Deputy represent by David Autor Configuration of the Stateman - Majowaki Our Gavid Department - Choka Depart Configuration of the Stateman - Majowaki Department - March Stateman - Majowaki Department -	TRANSPORTATION	IAIR - date DEVELOPMENT - date LOPMENT - date INEER - date		PARKS & RECRE AMAFCA	EATION - c - date EMENT - d			
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The DA. AC	David Aube NAME (print) H+M Design G FIRM David Au SIGNATURE - date	Diffuilly signed by David Aub Diffuilly signed by David Aub Out Good Department, CNAD Out Good Department, CNAD Department, CNAD	TRANSPORTATION Program con- was also UTILITY DEVE CITY ENG DESIGN	IAIR - date DEVELOPMENT - date LOPMENT - date INEER - date REVIEW COMMITTEE REV		PARKS & RECRE AMAFCA	EATION - c - date EMENT - d date	late		
The DA. AC	David Aube NAME (print) H+M Design G FIRM David Au SIGNATURE - date	Deputy represent by David Autor Deputy represent by David Autor Configuration of the Stateman - Majowaki Our Gavid Department - Choka Depart Configuration of the Stateman - Majowaki Department - March Stateman - Majowaki Department -	TRANSPORTATION	IAIR - date DEVELOPMENT - date LOPMENT - date INEER - date REVIEW COMMITTEE REV		PARKS & RECRE AMAFCA	EATION - c - date EMENT - d date			
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The DA. AC	David Aube NAME (print) H+M Design G FIRM David Au SIGNATURE - date	Diffuilly signed by David Aub Diffuilly signed by David Aub Out Good Department, CNAD Out Good Department, CNAD Department, CNAD	TRANSPORTATION Program con- was also UTILITY DEVE CITY ENG DESIGN	IAIR - date DEVELOPMENT - date LOPMENT - date INEER - date REVIEW COMMITTEE REV		PARKS & RECRE AMAFCA	EATION - c - date EMENT - d date	late		