

# DEVELOPMENT REVIEW BOARD SUPPLEMENTAL SUBMITTAL

# (Deadline is Friday at noon unless noted on DRB calendar – late submittals will not be accepted unless approved by the DRB)

PROJECT NO. PR-2021-005390

Application No. SI-2021-00832 and VA-2021-00217

TO:	
$\underline{ imes}$ Planning Department/Chair	
× Hydrology	
X Transportation Development	
X ABCWUA	
X Code Enforcement	
$\underline{ imes}$ Parks & Rec *(Please attach this sheet with each collated set for each board member)	
(Flease actually this sheet with each condition set for each source member)	
NOTE: ELECTRONIC VERSION (ie disk, thumbdrive) is Required. Submittal will not be accepted without.	
DRB SCHEDULED HEARING DATE: July 21, 2021 HEARING DATE OF DEFERRAL: June 30, 2021	
SUBMITTAL DESCRIPTION: Revised Site Plan set and Infrastructure List for the proposed development.	
	_
CONTACT NAME: Jackie Fishman, AICP and Michael Vos, AICP, Consensus Planning, Inc.	
CONTACT NAME: Jackie i istilian, Alor and Michael Vos, Alor, Consensus Flaming, Inc.	
TELEPHONE: (505) 764-9801 EMAIL: fishman@consensusplanning.com	
vos@consensusplanning.com	

For Visibility, landscaping, fencing, and signs shall not interfere with clear sight requirements. Therefore, signs, walls, trees, and shrubs between 3 and 8 feet in height (as measured from the gutter pan) are not allowed in the clear sight triangle.

### PROJECT TABULATED PARKING COUNTS AND OPEN SPACE

					On-Site	Open	Open						
	Number of			Req'd	Parking	Space	Space	HC	НС		MC	Bicycle	Bicycle
Space/Unit Type	Units	Use	GSF per unit	Parking	Provided	Req'd	Provided	Req'd	Provided	MC Req'd	Provided	Req'd	Provided
Leasing Office	1	Office	2000	3									
Commercial	1	Office/Retail	2000	3									
1 bdr, 1 ba	68	Residential	533	34		7650							
2 bdr, 2 ba	14	Residential	795	7		1995							
3 bdr, 2 ba	10	Residential	1016	5		1750							
Total	92			52	62	11395	17,150 sf	6	8	2	3	5	8

1. Parking required 1 space per DU, with 50% reduction for UC-MS-PT 2. Bicycle parking required, 3 spaces or 10% whichever is greater

Table 5-5-5: Bicycle Parking Requirements Table 5-5-4: Motorcycle Parking Requirements

Table 5-5-1: Off-street Parking Requirements

6 VAN 8 VAN

3. Motorcycle parking required 1 space per 25 off street parking. 4. Accessible Parking is based on 2015NM Commercial Building Code, Table 1106.1 of Title 14, Chapter 7, Part 2.

5. Open Space per table 2-4-5 including a 50% reduction for UC-MS-PT. Open space includes 9,616 sf of landscaping and 7,534 sf of sidewalk and patio space. 6. On Street Parking provided along Silver Avenue SE and Jackson Street SE is 17 including 2 ADA Stalls.

DESIGN GROUP Architects • Engineers • Interior Design Planners • Urban Designers • LEED®

120 Vassar Dr SE Suite 100 Albuquerque New Mexico 87106 T 505 242 6880 • F 505 242 6881 CONSULTANT

SIDEWALK AND THEN EXTENDING TO FLOW LINE OF CURB PER TABLE OF CONTENTS: DEVELOPMENT PROCESS MANUAL FIGURE 7.4.94), FOR

SP-DRB: SITE PLAN - DRB LANDSCAPING PLAN SITE GRADING PLAN C-301: SITE UTILITY PLAN **ELEVATIONS** C-501: CIVIL DETAILS C-502: CIVIL DETAILS C-503: CIVIL DETAILS

C-504:

PROJECT LOCATION:
CENTRAL AVENUE SE AND JACKSON STREET SE

CIVIL DETAILS

LEGAL DESCRIPTIONS:
LOTS NUMBERED ONE (1) THROUGH TWENTY-TWO (22), INCLUSIVE, IN BLOCK NUMBERED THIRTY-FOUR (34) OF THE VALLEY VIEW ADDITION TO THE CITY OF ALBUQUERQUE, NEW MEXICO, AS THE SAME IS SHOWN AND DELINEATED ON THE MAP OF SAID ADDITION, FILED IN THE OFFICE OF THE COUNTY CLERK OF BERNALILLO COUNTY, NEW MEXICO, ON SEPTEMBER 2, 1911.


CONTAINING 1.59 ACRES

**ZONE ATLAS PAGES:** K-17-Z

**EXISTING ZONING:** MX-M MIXED USE MEDIUM DENSITY

PROPOSED USES: MULTI FAMILY RESIDENTIAL, WITH 92 UNITS AND TWO COMMERCIAL SPACES (APROX. 2,000 SF

STAMP

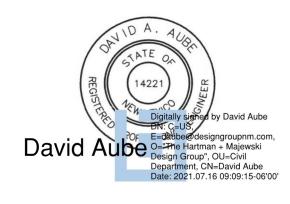

SITE PLAN - DRB PROJECT NAME

HILAND PLAZA

5000 CENTRAL AVENUE NE ALBUQUERQUE, NM 87108

PR-2021-005390 PROJECT NUMBER: SI-2021-00832 - SITE PLAN Application Number: Is an Infrastrure List Required? (X) Yes ( ) No If yes, then a set of approved DRC plans with a work order is required for any construction within Public Right-of-Way of for construction of public improvements. NO. | DATE | DESCRIPTION

ABCWUA Parks and Recreation Department City Engineer/Hydrology Code Enforcement \* Environmental Health Department (conditional)

DRB SITE DEVELOPMENT PLAN APPROVAL:

Solid Waste Management

DRB Chairperson, Planning Department

SHEET NUMBER

REVISIONS

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DAA

2574


July 15, 2021

Checked by

Project number

SHEET TITLE

SP-DRB

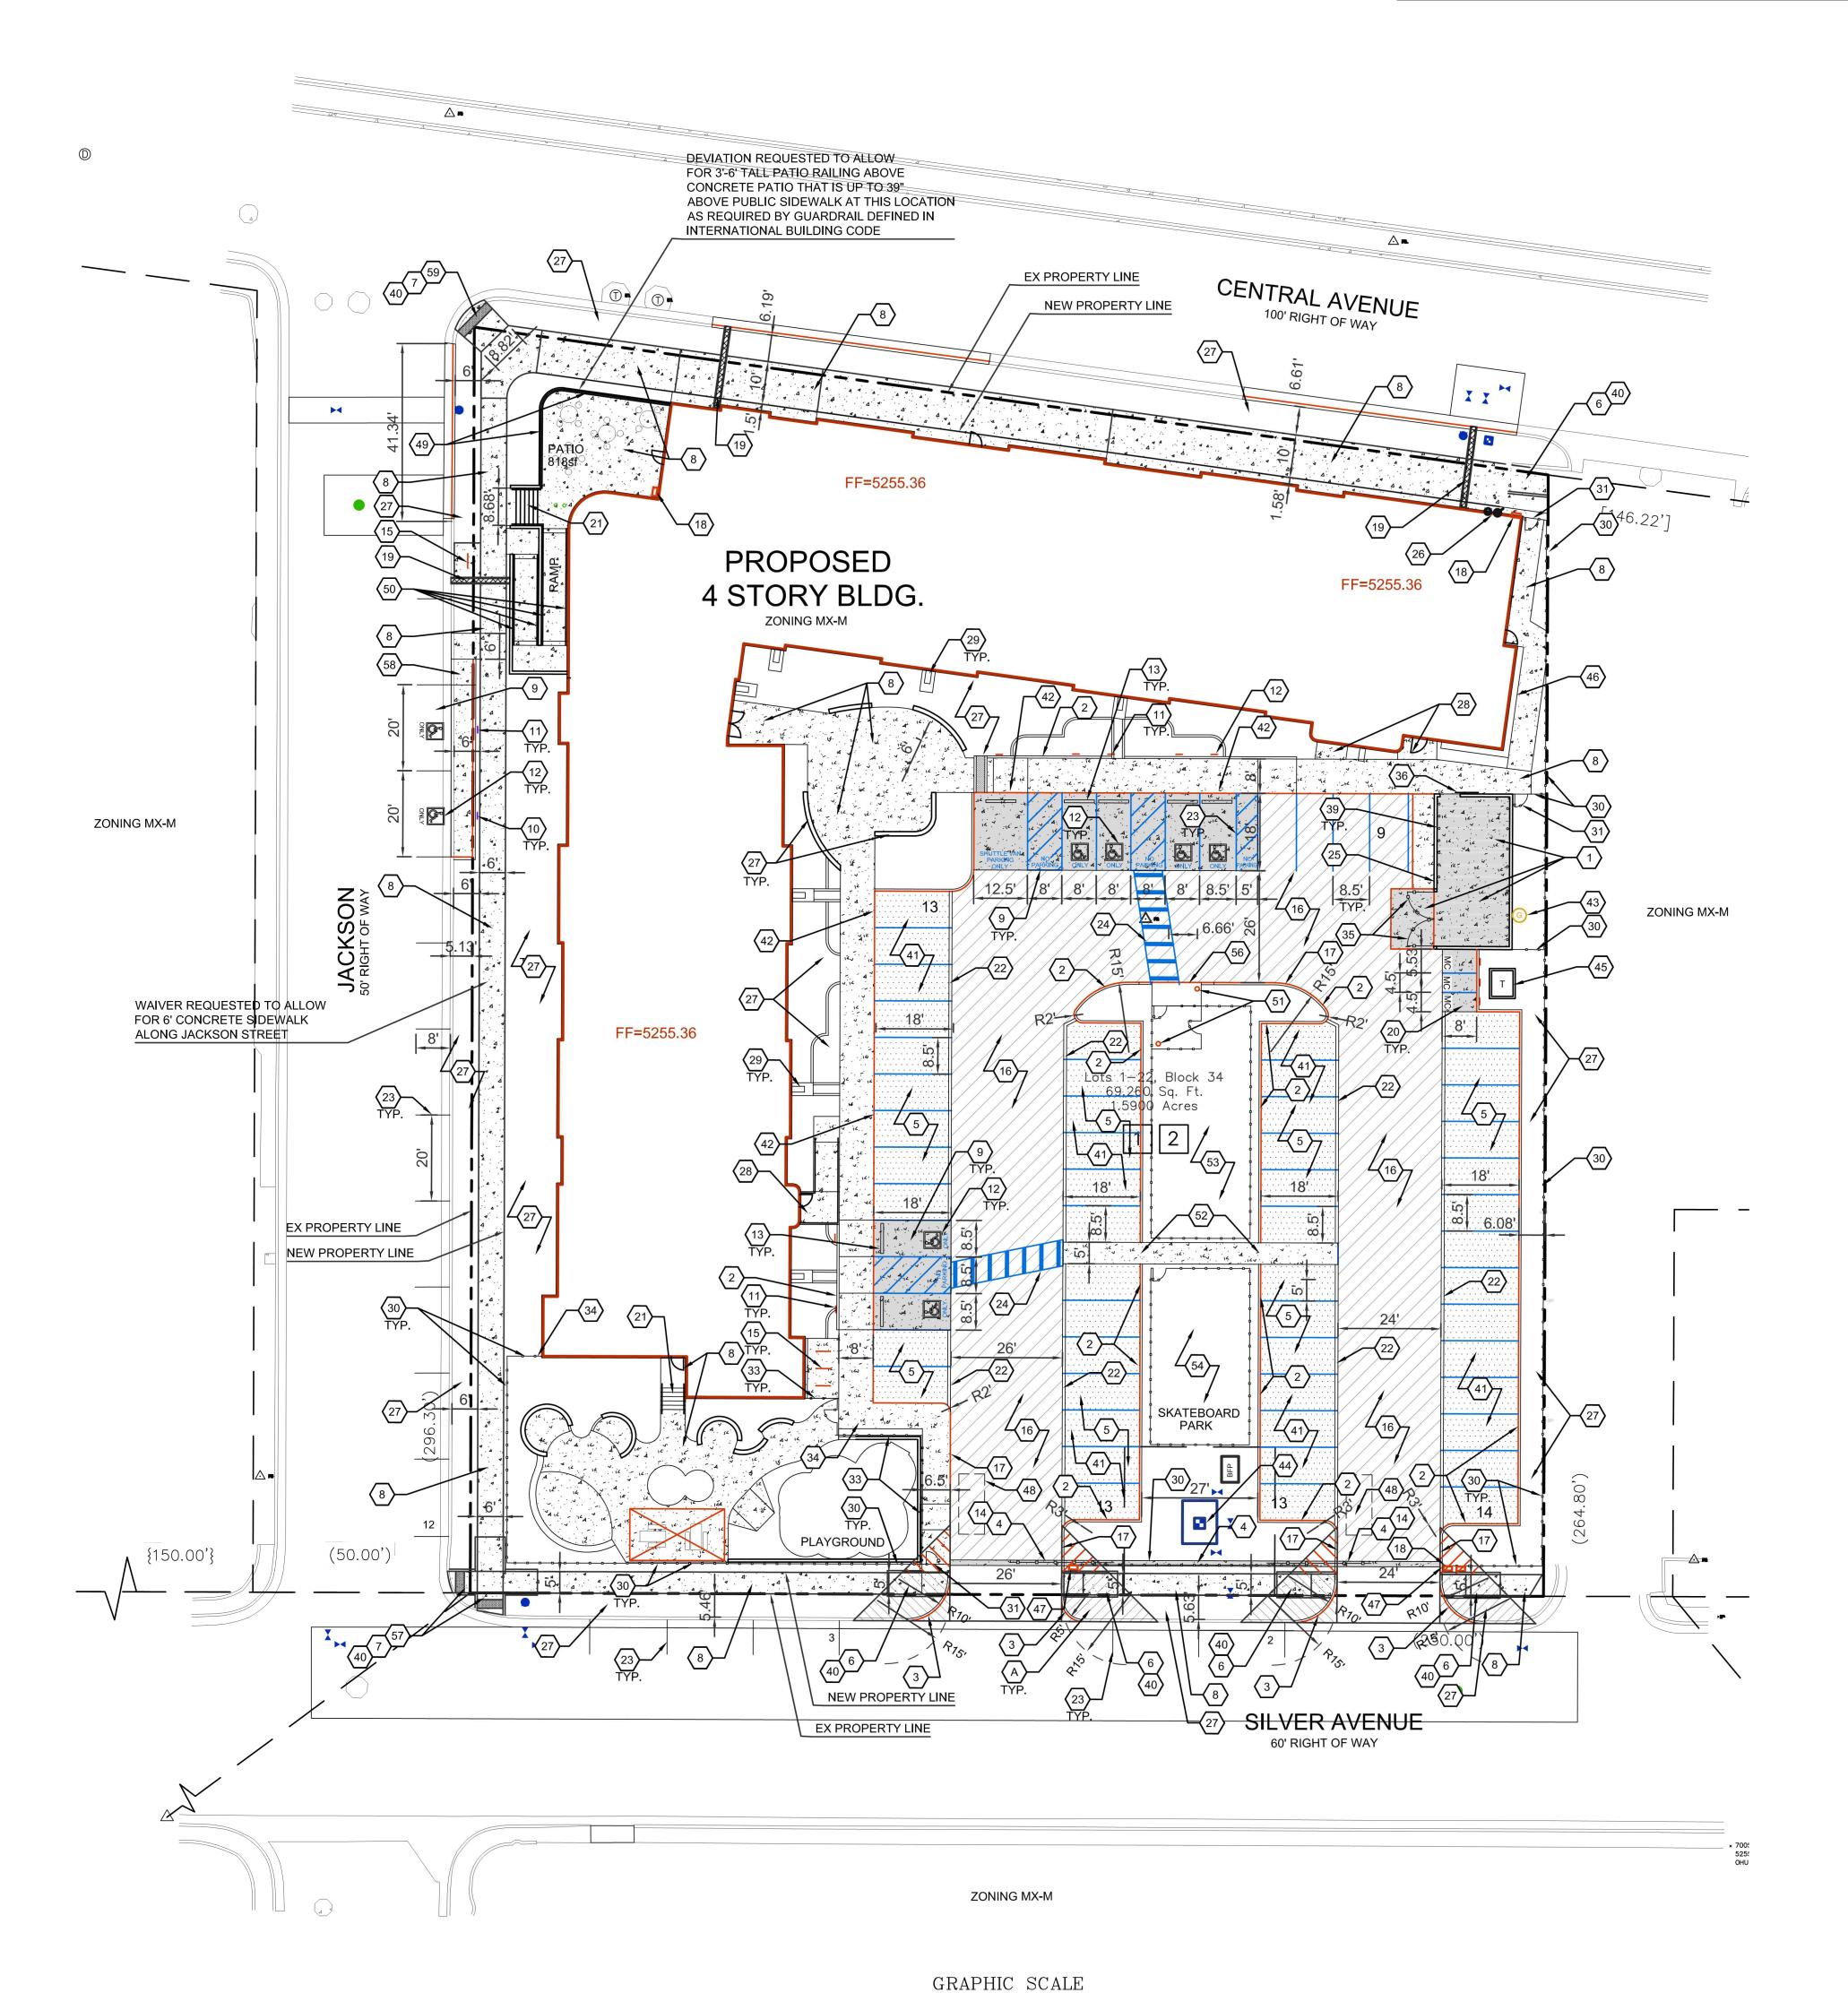

### BETWEEN 3 FEET AND 8 FEET TALL (AS MEASURED FROM THE GUTTER PAN) ARE NOT ALLOWED WITHIN THE CLEAR SITE C. ALL PARCELS SURROUNDING THE PROJECT SITE ARE MX-M ZONING. **SITE PLAN KEYED NOTES**

**SITE PLAN GENERAL NOTES** 

ILLUSTRATIVE PURPOSED ONLY.

CONCRETE PAVEMENT PER DETAIL D3/C-501. CONCRETE HEADER CURB, 6" TALL, PER DETAIL A5/C-501. STANDARD CURB AND GUTTER PER DETAIL A5/C-501.

4. CONCRETE PAVEMENT STRIP 2' WIDE PER DETAIL D3/C-501.

GRAVEL PAVEMENT PER DETAIL D4/C-501. 6. CONCRETE CURB ACCESS RAMP PER DETAIL A1/C-501 AND TYPE C PARALLEL CURB ACCESS RAMP PER COA STANDARD DWG 2443. DETECTABLE WARNING SURFACE PER DETAIL A3/C-501.


A. MINI SIGHT TRIANGLE (11' ON EACH SIDE STARTING AT BACK OF

B. LANDSCAPING, SIGNAGE, WALLS, FENCES, TREES AND SHRUBBERY

- CONCRETE SIDEWALK PER DETAIL B4/C-501. 9. ADA RESERVED PARKING STALL PER DETAIL A1/C-502. 10. ADA RESERVED PARKING SIGN MOUNTED PER DETAIL C3/C-502 AND
- 11. ADA VAN ACCESSIBLE RESERVED SIGN MOUNTED PER DETAIL C3/C-502 AND D2/C-502.
- 12. RESERVED PARKING SYMBOL PER DETAIL E3/C-502. 13. CONCRETE PARKING BLOCK PER DETAIL E4/C-502. 14. 24' SLIDING VEHICLE GATE PER DETAIL A5/C-504 WITH LIFT MASTER
- PROFESSIONAL MODEL SL3000101U HEAVY DUTY SLIDING GATE OPERATOR WITH 1-HP MOTOR ON 18"x34"x24" CONCRETE FOUNDATION. INSTALL PER MANUFACTURER RECOMMENDATIONS. 15. BICYCLE RACK PER DETAIL E5/C-502.
- 16. ASPHALT PAVEMENT PER DETAIL E2/C-501. 17. PAINT CURB RED WITH 6" TALL LETTERS READING "NO PARKING
- 18. FIRE DEPARTMENT KNOX BOX. 19. SIDEWALK CULVERT PER DETAIL B3/C-501.
- 20. MOTORCYCLE PARKING STALL WITH SIGNAGE AND PAVEMENT
- 21. CONCRETE STAIR PER B4/C-502 AND HANDRAILS PER DETAILS
- 22. CONCRETE CUT OFF WALL TO SEPARATE ASPHALT FROM GRAVEL
- PARKING, PER DETAIL A5/C-501. 23. 4" WIDE WHITE PARKING STRIPE.
- 24. CONTINENTAL CROSS WALK STRIPING. 25. REFUSE ENCLOSURE PER DETAIL A3/C-502. 26. FIRE RISER ROOM, SEE ARCHITECTURAL AND MECHANICAL PLANS.
- 27. LANDSCAPED AREA. 28. CONCRETE STOOP PER DETAIL C3/C-501.
- 29. CONCRETE SPLASH BLOCK PER DETAIL D6/C-501 AND CONCRETE RUNDOWN PER DETAIL D5/C-501.
- 30. 6' TALL PERIMETER FENCE PER DETAIL A5/C-504. 31. 6' TALL PERIMETER FENCE PERSONNEL GATE PER DETAIL A4/C-504.
- 32. 4' TALL PERIMETER FENCE PER DETAIL A5/C-504. 33. 4' TALL PERIMETER FENCE PERSONNEL GATE PER DETAIL A4/C-504.
- 34. CANTILEVERED FENCE END PER DETAIL A1/C-504. 35. REFUSE ENCLOSER GATE PER DETAIL D5/C-504.
- 36. ENCLOSURE GATE PER DETAIL A2/C-504. 37. CONCRETE VALLEY GUTTER PER DETAIL E1/C-502.
- 38. LIGHT POLE PER ELECTRICAL SHEET ES-101. 39. 6" STEEL BOLLARD PER DETAIL E1/C-501.
- 40. PAINT CURB YELLOW WHERE HEIGHT IS BETWEEN  $\frac{1}{4}$ " AND 6" TALL. 41. STORM WATER RETENTION POND, SEE GRADING PLANS. 42. TURN DOWN EDGE SIDEWALK PER DETAIL E3/C-501.
- 43. NATURAL GAS METER OR REGULATOR SEE UTILITY PLANS. 44. WATER METER VAULT. SEE UTILITY PLAN.
- 45. ELECTRICAL TRANSFORMER, SEE SHEET ES-101. 46. ELECTRICAL METER PACK. SEE ELECTRICAL PLANS.
- 47. KEY PAD FOR GATE OPERATOR. SEE ELECTRICAL PLANS FOR ADDITIONAL INFORMATION.
- 48. LOOP DETECTOR FOR AUTOMATIC GATE OPERATORS. SEE ELECTRICAL PLANS FOR DETAILS.
- 49. PATIO RAILING PER DETAIL C5/C-501. 50. CONCRETE RAMP AND HANDRAILS PER DETAIL A2/C-502. 51. DOG WASTE STATION. SEE LANDSCAPING PLANS.
- 52. PROVIDE 5' WIDE OPENING IN CURB. 53. DOG PARK SURROUNDED BY 4' TALL FENCE PER DETAIL A5/C-504. 54. SKATE BOARD PARK AREA SURROUNDED BY 4' TALL FENCE PER
- DETAIL A5/C-504. 55. LOW SEAT WALL. SEE LANDSCAPING PLANS. 56. CONCRETE SIDEWALK TO BE FLUSH WITH ASPHALT. PROVIDE 3'

ACCESS RAMP PER COA STANDARD DWG 2442.

- LONG CURB TRANSITION FROM 6" TALL TO FLUSH ON EACH SIDE.
- 57. CONCRETE CURB ACCESS RAMP DETAIL A PAIRED PARALLEL CURB ACCESS RAMP WITH A COMMON LANDING PER COA STANDARD
- 58. CONCRETE CURB ACCESS RAMP TYPE B PARALLEL CURB ACCESS RAMP PER COA STANDARD DWG 2443. 59. CONCRETE CURB ACCESS RAMP TYPE A PERPENDICULAR CURB

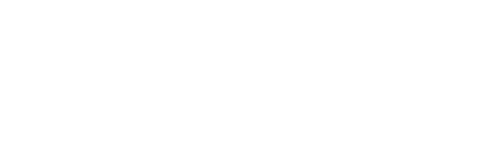




A5 ZONE ATLAS PAGE K-17-Z

1 inch = 20 ft.


A1 SITE PLAN - DRB

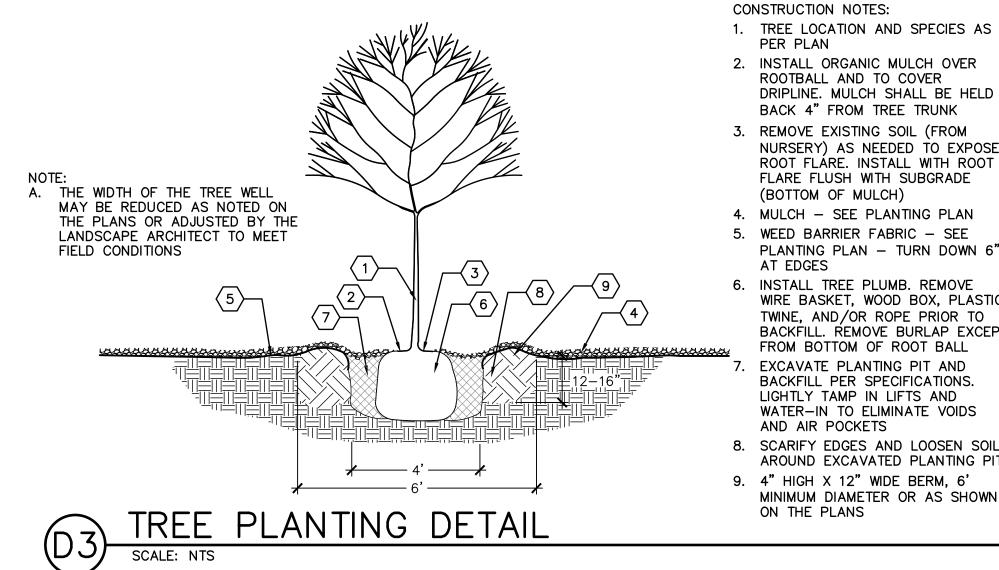

ROOTBALL AND TO COVER DRIPLINE. MULCH SHALL BE HELD BACK 4" FROM TREE TRUNK 3. REMOVE EXISTING SOIL (FROM NURSERY) AS NEEDED TO EXPOSE ROOT FLÁRE. INSTALL WITH ROOT FLARE FLUSH WITH SUBGRADE (BOTTOM OF MULCH) 4. MULCH - SEE PLANTING PLAN 5. WEED BARRIER FABRIC - SEE PLANTING PLAN — TURN DOWN 6" AT EDGES 6. INSTALL TREE PLUMB. REMOVE WIRE BASKET, WOOD BOX, PLASTIC, TWINE, AND/OR ROPE PRIOR TO

BACKFILL. REMOVE BURLAP EXCEPT FROM BOTTOM OF ROOT BALL EXCAVATE PLANTING PIT AND BACKFILL PER SPECIFICATIONS. LIGHTLY TAMP IN LIFTS AND WATER-IN TO ELIMINATE VOIDS AND AIR POCKETS

8. SCARIFY EDGES AND LOOSEN SOIL AROUND EXCAVATED PLANTING PIT 9. 4" HIGH X 12" WIDE BERM, 6' MINIMUM DIAMETER OR AS SHOWN ON THE PLANS

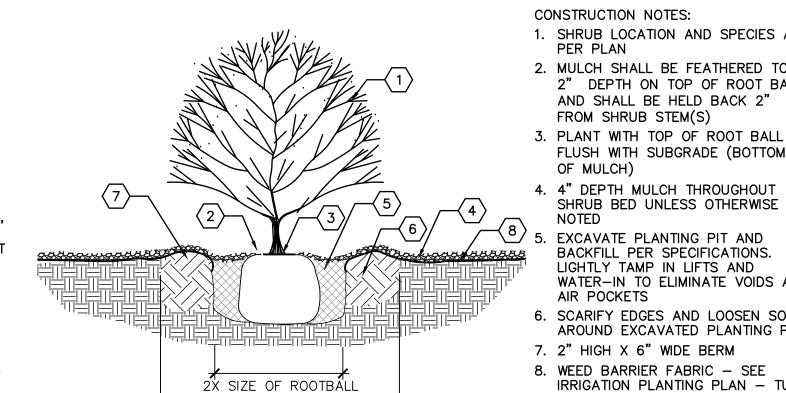

X SIZE OF ROOTBALL 

✓

X

CONSTRUCTION NOTES: 1. SHRUB LOCATION AND SPECIES AS PER PLAN

2. MULCH SHALL BE FEATHERED TO A 2" DEPTH ON TOP OF ROOT BALL AND SHALL BE HELD BACK 2" FROM SHRUB STEM(S)

FLUSH WITH SUBGRADE (BOTTOM OF MULCH) 4. 4" DEPTH MULCH THROUGHOUT

SHRUB BED UNLESS OTHERWISE NOTED 5. EXCAVATE PLANTING PIT AND BACKFILL PER SPECIFICATIONS. LIGHTLY TAMP IN LIFTS AND WATER-IN TO ELIMINATE VOIDS AND AIR POCKETS 6. SCARIFY EDGES AND LOOSEN SOIL AROUND EXCAVATED PLANTING PIT

L EVERGREEN 2 SF

7. 2" HIGH X 6" WIDE BERM 8. WEED BARRIER FABRIC - SEE IRRIGATION PLANTING PLAN - TURN DOWN 6" AT EDGES

SHRUB PLANTING DETAIL



505 268 2266

THE HARTMAN + MAJEWSKI

DESIGN GROUP

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CONSULTANT




DRB SUBMITTAL

PROJECT NAME

HILAND PLAZA

5000 CENTRAL AVENUE NE ALBUQUERQUE, NM 87108

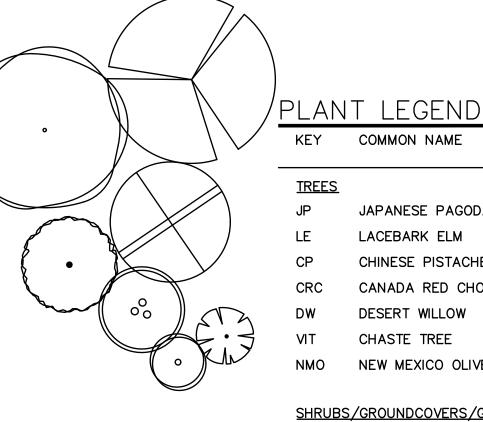

	KEY	COMMON NAME	BOTANICAL NAME	QTY	INSTALLED SIZE	REMARKS	MATURE SIZE	WATER USE	DECIDUOUS/ EVERGREEN	COVERAGE
$\searrow$	TREES									
	JP	JAPANESE PAGODA TREE	STYPHNOLOBIUM JAPONICUM 'HALKA'	4	2" CAL., 10'-12' HT.	B&B	45' HT. X 35' SPD.	М	DECIDUOUS	962 SF
)	LE	LACEBARK ELM	ULMUS PARVIFOLIA 'EMER II'	4	2" CAL., 10'-12' HT.	B&B	50' HT. X 35' SPD.	L	DECIDUOUS	962 SF
	CP	CHINESE PISTACHE	PISTACHIA CHINENSIS	14	2" CAL., 10'-12' HT.	24" BOX	30' HT. X 30' SPD.	М	DECIDUOUS	707 SF
	CRC	CANADA RED CHOKECHERRY	PRUNUS X VIRGINIANA 'CANADA RED'	16	2" CAL., 8'-10' HT.	24" BOX	25' HT. X 20' SPD.	М	DECIDUOUS	314 SF
Th	DW	DESERT WILLOW	CHILOPSIS LINEARIS	2	4'-6' HT.	15 GA, MULTI	20' HT. X 20' SPD.	L	DECIDUOUS	314 SF
: =	VIT	CHASTE TREE	VITEX AGNUS-CASTUS	15	4'-6' HT.	15 GA. MULTI	20' HT. X 20' SPD.	М	DECIDUOUS	314 SF
	NMO	NEW MEXICO OLIVE	FORESTIERA NEOMEXICANA	9	4'-6' HT.	15 GA, MULTI	15' HT. X 12' SPD.	М	DECIDUOUS	113 SF
ىسر	<u>SHRUBS</u>	/GROUNDCOVERS/GRASSES/PE	<u>RENNIALS</u>							
(+)	FB	FERNBUSH	CHAMAEBATIARIA MILLEFOLIUM	17	MIN. 12" HT.	5 GALLON	5' HT. X 6' SPD.	L	DECIDUOUS	28 SF
	BMS	BLUE MIST SPIREA	CARYOPTERIS X CLANDONENSIS	7	MIN. 18" HT.	5 GALLON	5' HT. X 5' SPD.	L	DECIDUOUS	20 SF
$\langle \cdot \rangle$	GLS	GRO-LOW SUMAC	RHUS AROMATICA 'GRO-LOW'	43	MIN. 18" SPD.	5 GALLON	3' HT. X 5' SPD.	L	DECIDUOUS	20 SF
$\bigcirc$	TB	TURPENTINE BUSH	ERICAMERIA LARICIFOLIA	37	MIN. 12" HT.	5 GALLON	3' HT. X 4' SPD.	L	EVERGREEN	13 SF
<u>о</u>	GT	GOLDEN TORCH GOLDENROD	SOLIDAGO SP.	64	MIN. 12" HT.	5 GALLON	2' HT. X 2' SPD.	М	DECIDUOUS	3 SF
$\odot$	WSC	WESTERN SAND CHERRY	PRUNUS BESSEYI 'PAWNEE BUTTES'	23	MIN. 18" SPD.	5 GALLON	2' HT. X 5' SPD.	М	DECIDUOUS	20 SF
*	RED	RED YUCCA	HESPERALOE PARVIFLORA	61	MIN. 12" HT.	5 GALLON	3' HT. X 3' SPD.	L	EVERGREEN	7 SF
	CAT	CATMINT	NEPETA FAASSENII	19	MIN. 6" SPD.	1 GALLON	1' HT. X 3' SPD.	L	DECIDUOUS	7 SF
$\odot$	NWR	NEARLY WILD ROSE	ROSA 'NEARLY WILD'	40	MIN. 12" HT.	1 GALLON	2' HT. X 3' SPD.	М	DECIDUOUS	7 SF
*	BRY	BREAKLIGHTS RED YUCCA	HESPERALOE PARVIFLORA 'PERPA'	76	MIN. 6" HT.	3 GALLON	2' HT. X 2' SPD.	L	EVERGREEN	3 SF

## CITY LANDSCAPE ORDINANCE COMPLIANCE

PENSTEMON PINIFOLIUS

LANDSCAPING RESPONSIBILITY FOR MAINTENANCE:

1. THE OWNER WILL BE RESPONSIBLE FOR ALL LANDSCAPE MAINTENANCE AT HILAND PLAZA.

COMPLIANCE WITH WATER CONSERVATION ORDINANCE: 1. NO SPRAY IRRIGATION IS PROPOSED.

2. PLANT SPECIES WILL BE LOW OR MEDIUM USE SPECIES PER THE ABCWUA'S XERIC PLANT LIST.

3. AN AUTOMATIC IRRIGATION SYSTEM WILL BE INSTALLED FOR ALL PLANT MATERIAL. THE SYSTEM WILL BE CONTROLLED BY AN AUTOMATIC CONTROLLER. PLANTS WILL BE IRRIGATED BY LOW WATER USE BUBBLERS. A REDUCED PRESSURE BACKFLOW PREVENTER WILL BE INSTALLED IN A HEATED ENCLOSURE TO PROTECT THE DOMESTIC WATER SUPPLY FROM CROSS-CONTAMINATION.

COMPLIANCE WITH GENERAL LANDSCAPING REGULATIONS: 1. THIS PLAN PROVIDES VISUALLY ATTRACTIVE LANDSCAPE, A VISUALLY ATTRACTIVE STREETSCAPE, AND INTERSPERSED TREES IN LANDSCAPE AREAS TO PROVIDE SHADE AND REDUCE LARGE EXPANSES OF PAVEMENT.

2. GROUNDCOVER MULCH SHALL COMPRISE OF A COMBINATION OF CRUSHED GRAVEL (NOT TO EXCEED 75% OF TOTAL AREA) AND ORGANIC MULCH SUCH AS SHREDDED BARK, PECAN SHELLS, ETC.

3. VISIBILITY, LANDSCAPING FENCING, AND SIGNS SHALL NOT INTERFERE WITH CLEAR SIGHT REQUIREMENTS. THEREFORE, SIGNS, WALLS, TREES, AND SHRUBS BETWEEN 3 AND 8 FEET IN HEIGHT (AS MEASURED FROM THE GUTTER PAN) WILL NOT BE LOCATED IN THE CLEAR SIGHT TRIANGLE.

4. GROUND-MOUNTED EQUIPMENT SCREENING WILL BE DESIGNED TO ALLOW FOR ACCESS TO UTILITY FACILITIES. ALL SCREENING AND VEGETATION SURROUNDING GROUND-MOUNTED TRANSFORMERS AND UTILITY PADS ARE TO ALLOW 10 FEET OF CLEARANCE IN FRONT OF THE EQUIPMENT DOOR AND 5-6 FEET OF CLEARANCE ON THE REMAINING THREE SIDES FOR SAFE OPERATION, MAINTENANCE, AND REPAIR PURPOSES.

<u>LANDSCAPE CALCULATION TABLE:</u>
TOTAL LOT AREA: 69,260 SF

LESS TOTAL BUILDING AREA: 21,363 SF NET LOT AREA: 47,897 SF

REQUIRED LANDSCAPE AREA (15% OF NET LOT AREA): 7,185 SF

PROVIDED LANDSCAPE AREA: 9,954 SF

REQUIRED PLANTS: REQUIRED STREET TREES:

12 (296 LF ALONG JACKSON ST SE, TREES AVERAGE 25' O.C.) 11 (255 LF ALONG CENTRAL AVE SE, TREES AVERAGE 25' O.C.) 11 (254 LF ALONG SILVER AVE SE, TREES AVERAGE 25' O.C.)

STREET TREES PROVIDED: 14 ALONG JACKSON ST SE 11 ALONG CENTRAL AVE SE

LANDSCAPE AREA)

11 ALONG SILVER AVE SE REQUIRED PARKING LOT TREES AT ONE TREE PER TEN SPACES:

62 TOTAL SPACES 7 REQUIRED TREES PARKING LOT TREES PROVIDED: 13

REQUIRED PARKING LOT INTERIOR LANDSCAPE (15% OF PARKING LOT AREA): 2,972 SF

PROVIDED PARKING LOT INTERIOR LANDSCAPE: 3,037 SF (102.2% OF REQUIRED INTERIOR LANDSCAPE)

REQUIRED COVERAGE (75% OF PROVIDED LANDSCAPE AREA): 7,466 SF

GRAVEL MULCH

COBBLE MULCH

■ BIKE RACK

ADA PICNIC TABLE

ORGANIC MULCH

CRUSHER FINES MULCH

SAND PLAY SURFACING

O O ROUND CONCRETE TABLE AND CHAIRS

PROVIDED COVERAGE: 9,937 SF (137.8% OF REQUIRED COVERAGE)

REQUIRED GROUND LEVEL VEGETATIVE COVERAGE (25% OF PROVIDED

2,489 SF PROVIDED GROUND LEVEL PLANT COVERAGE: 2,890 SF (120.2% OF REQUIRED GROUND LEVEL COVERAGE)

HATCH AND SYMBOL LEGEND

ENGINEERED WOOD FIBER MULCH PLAY AREA SURFACING

REVISIONS

NO. | DATE | DESCRIPTION

Copyright: Design Group

Checked by JULY 16, 2021

SHEET TITLE

Project number

LANDSCAPE PLAN

SHEET NUMBER

LP101

CENTRAL AVENUE FF=5255.36 FF=5255.36 1,008 SF — 58 SF — 10 67 7 \*\*\* \*\*\* \*\*\* 600 00 \*\*\* \*\*\* \*\*\* 600 104 SF ─┐ 12 SF — 31 SF — 342 SF -FF=5255.36 990 SF -12 SF — FENCED IN -DOG RUN 151 SF -1,291 SF - ×■ ×■ 120 SF — FENCED IN -SKATE \ PARK \*\*\*000 CLEAR SIGHT TRIANGLES - SEE -OVERHEAD UTILITY ---COMPLIANCE WITH GENERAL

(APPROX. 20' CLEARANCE) LANDSCAPING REQUIREMENTS NOTE 3.

LANDSCAPING REQUIREMENTS NOTE 3.

SILVER AVENUE

SCALE: 1"=20'-0"


LANDSCAPE PLAN

# **GRADING PLAN GENERAL NOTES**

 SEE SHEET C-G01 FOR COMPLETE LIST OF GENERAL NOTES AND SYMBOL/LINETYPE LEGEND THAT APPLY TO ALL SHEETS.




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SITE PLAN - DRB
PROJECT NAME

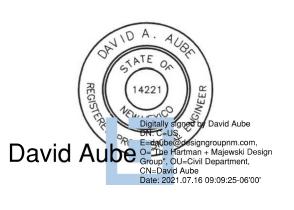HILAND PLAZA

5000 CENTRAL AVENUE NE ALBUQUERQUE, NM 87108




Drawn byDAAChecked byDAADateJuly 15, 2021Project number2574

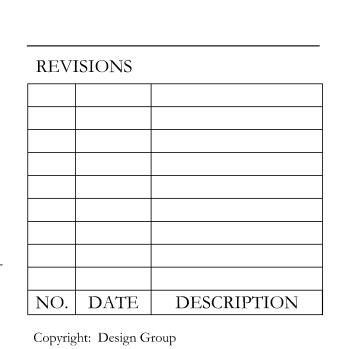SHEET TITLE

CONCEPTUAL SITE GRADING PLAN

SHEET NUMBER

C-201

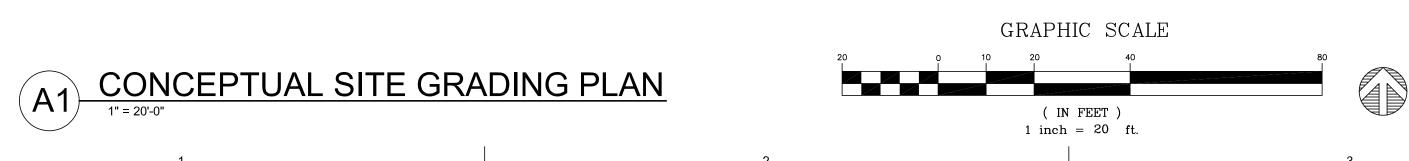

TC=5252.28'

FL=5252.45'

BC=5253.58'-

FL=5252.97'

BC=5251.15' FL=5250.47' CENTRAL AVENUE

FL=5253.42 TC=5251.32' 5250.89'— \_5254.09 / TSW **\_5254.09**58 5252.0**₹**\_ FF=5255.36 [146.22'] TA=5253.69' 5254.28\_ TSW 5252.69' L<sub>TA=5254.74</sub> TA=5254.16' FF=5255.36 5252.59\_ TSW \_5255.01 5252.71\_ TSW -TA=5254.46 5252.81\_ TSW \_5253.86 TSW 5254.78 TC \_5253.96 5252.78 TA=5254.49' \_\_\_TA=5254.87' \_5253.83 \_FL └TA=5254.94' FF=5255.36 \_5253.83 Lots 1—22, Block 34 69,260, Sq. Ft. / \_5253.51' TA=5254.91' TA=5253.54' -TA=5255.25 5253.35 \_TA=5254.99' /TA=5253.78 TA=5252.64' \_5253.99 \_BC=5255.46' {150.00'} (50.00') \_\_BC=5255.13' FL=5254.85' TC=5255.25' BC=5252.74' FL=5252.13' BC=5254.62' TA=5252.55' (250.00') BC=5255.11' FL = 5253.27FL=5253.95' FL=5254.47' **5253.27\_/**TA=5253.90'\( \textbf{FL} TA=5255.48' PBC=5253.58' FL=5252.98' PBC=5253.72' FL=5253.06' BC=5253.91' FL=5253.32' BC=5254.92' FL=5254.32' BC=5254.56' FL=5254.02'

( IN FEET ) 2 1 inch = 20 ft.

A1 SITE UTILITY PLAN

1" = 20'-0"

# **UTILITY PLAN GENERAL NOTES**

I. SEE SHEET C-G01 FOR COMPLETE LIST OF GENERAL NOTES AND SYMBOL/LINETYPE LEGEND THAT APPLY TO ALL SHEETS.

# **UTILITY PLAN KEYED NOTES**



- 1. EXISTING PVC WATERLINE TO REMAIN.
- 2. EXISTING SANITARY SEWER LINE TO REMAIN. 3. WATER SUPPLY LINE, 1"Ø COPPER, PER DETAIL A5/C-503.
- 4. WATER SUPPLY LINE, 4"Ø PVC DR14, PER DETAIL A5/C-503.
- 5. WATER SUPPLY LINE, 6"Ø C900 DR14, PER DETAIL A5/C-503 WITH RESTRAINED JOINTS PER DETAIL A1/C-503. 6. BEND, 45°, MATERIAL AND SIZE TO MATCH THE CONNECTING WATER
- LINES. RESTRAIN JOINTS PER A1/C-503.
- 7. DUCTILE IRON TEE, 8"x8"x4", RESTRAIN JOINTS PER A1/C-503. 8. DUCTILE IRON TEE, 8"x8"x6", RESTRAIN JOINTS PER A1/C-503.
- 9. REDUCER, 4"x3".
- 10. GATE VALVE ASSEMBLY, 3"Ø, VALVE BOX AND CONCRETE COLLAR PER DETAIL C4/C-503. RESTRAIN JOINTS PER A1/C-503.
- 11. GATE VALVE ASSEMBLY, 6"Ø, VALVE BOX AND CONCRETE COLLAR PER DETAIL C4/C-503. RESTRAIN JOINTS PER A1/C-503.
- 12. GATE VALVE ASSEMBLY, 8"Ø, VALVE BOX AND CONCRETE COLLAR
- PER DETAIL C4/C-503. RESTRAIN JOINTS PER A1/C-503. 13. TRANSITION COUPLING.
- 14. FIRE HYDRANT PER DETAIL A4/C-503.
- 15. WALL MOUNTED FIRE DEPARTMENT CONNECTION. SEE FIRE SUPPRESSION PLANS.
- 16. WALL MOUNTED INDICATOR VALVE. SEE FIRE SUPPRESSION PLANS. 17. INSTALL 3" DOMESTIC WATER METER PER COA STD DWGS, 2370. 18. INSTALL 1" IRRIGATION WATER METER AND METER BOX PER COA STD
- DWGS, 2363 AND 2367. 19. CONNECT WATER LINE ONTO BUILDING WATER LINES, SEE PLUMBING
- 20. SANITARY SEWER LINE, 6"Ø, PER DETAIL D5/C-503.
- 21. SANITARY SEWER LINE, 8"Ø, PER DETAIL D5/C-503.
- 22. 4' Ø SANITARY SEWER MANHOLE PER COA STANDARD DRAWING 2102.
- 23. SANITARY SEWER WYE, 8"x8"x6".
- 24. SANITARY SEWER WYE, 8"X8"X8".
- 25. TERMINAL CLEANOUT PER DETAIL E1/C-503.
- 26. DOUBLE CLEANOUT PER DETAIL E3/C-503. 27. CONNECT SANITARY SEWER LINE ONTO BUILDING SEWER LINES, SEE
- PLUMBING SHEETS.
- 28. NOT USED.
- 29. NEW GAS LINE TO METER, SIZE TO BE DETERMINED BY NM GAS CO. 30. NATURAL GAS METER MANIFOLD AND METERS, SIZE TO BE
- DETERMINED BY NM GAS CO.
- 31. NEW NATURAL GAS YARD LINE. SEE MECHANICAL PLANS FOR SIZE REQUIREMENTS.
- 32. EXISTING NATURAL GAS LINE TO REMAIN.
- 33. PNM PRIMARY LINES. SEE ELECTRICAL SHEET ES-101. 34. ELECTRICAL TRANSFORMER. SEE ELECTRICAL SHEET ES-101.
- 35. SECONDARY LINES. SEE ELECTRICAL SHEET ES-101.
- 36. ELECTRICAL METER PACK. SEE ELECTRICAL SHEET ES-101.
- 37. WATER SUPPLY LINE, 3"Ø PVC SCH 40, PER DETAIL A5/C-503. 38. DUCTILE IRON TEE, 8"x8"x8", AND 8" TRANSITION COUPLING,
- RESTRAIN JOINTS PER A1/C-503. 39. 8" DUCTILE IRON END CAP. RESTRAIN JOINTS PER A1/C-503.
- 40. 8" PVC SRD 35 END CAP AND EMS.
- 41. 8" PVC SDR 35 SANITARY SEWER LINE.
- 45. 3" REDUCED PRESSURE ZONE BACKFLOW PREVENTOR, PER ACBWUA REQUIREMENTS. PROVIDE SAFE-T-COVER 300TD-AL INSULATED ENCLOSURE WITH 2 KW HEATER.
- 46. CONNECT NEW 8" SANITARY SEWER MANHOLE. RESHAPE SHELF AS REQUIRED FOR NEW CONNECTION.
- 47. EASEMENT AROUND WATER METER PER ABCWUA REQUIREMENTS.



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SITE PLAN - DRB

PROJECT NAME

HILAND PLAZA

5000 CENTRAL AVENUE NE


ALBUQUERQUE, NM 87108


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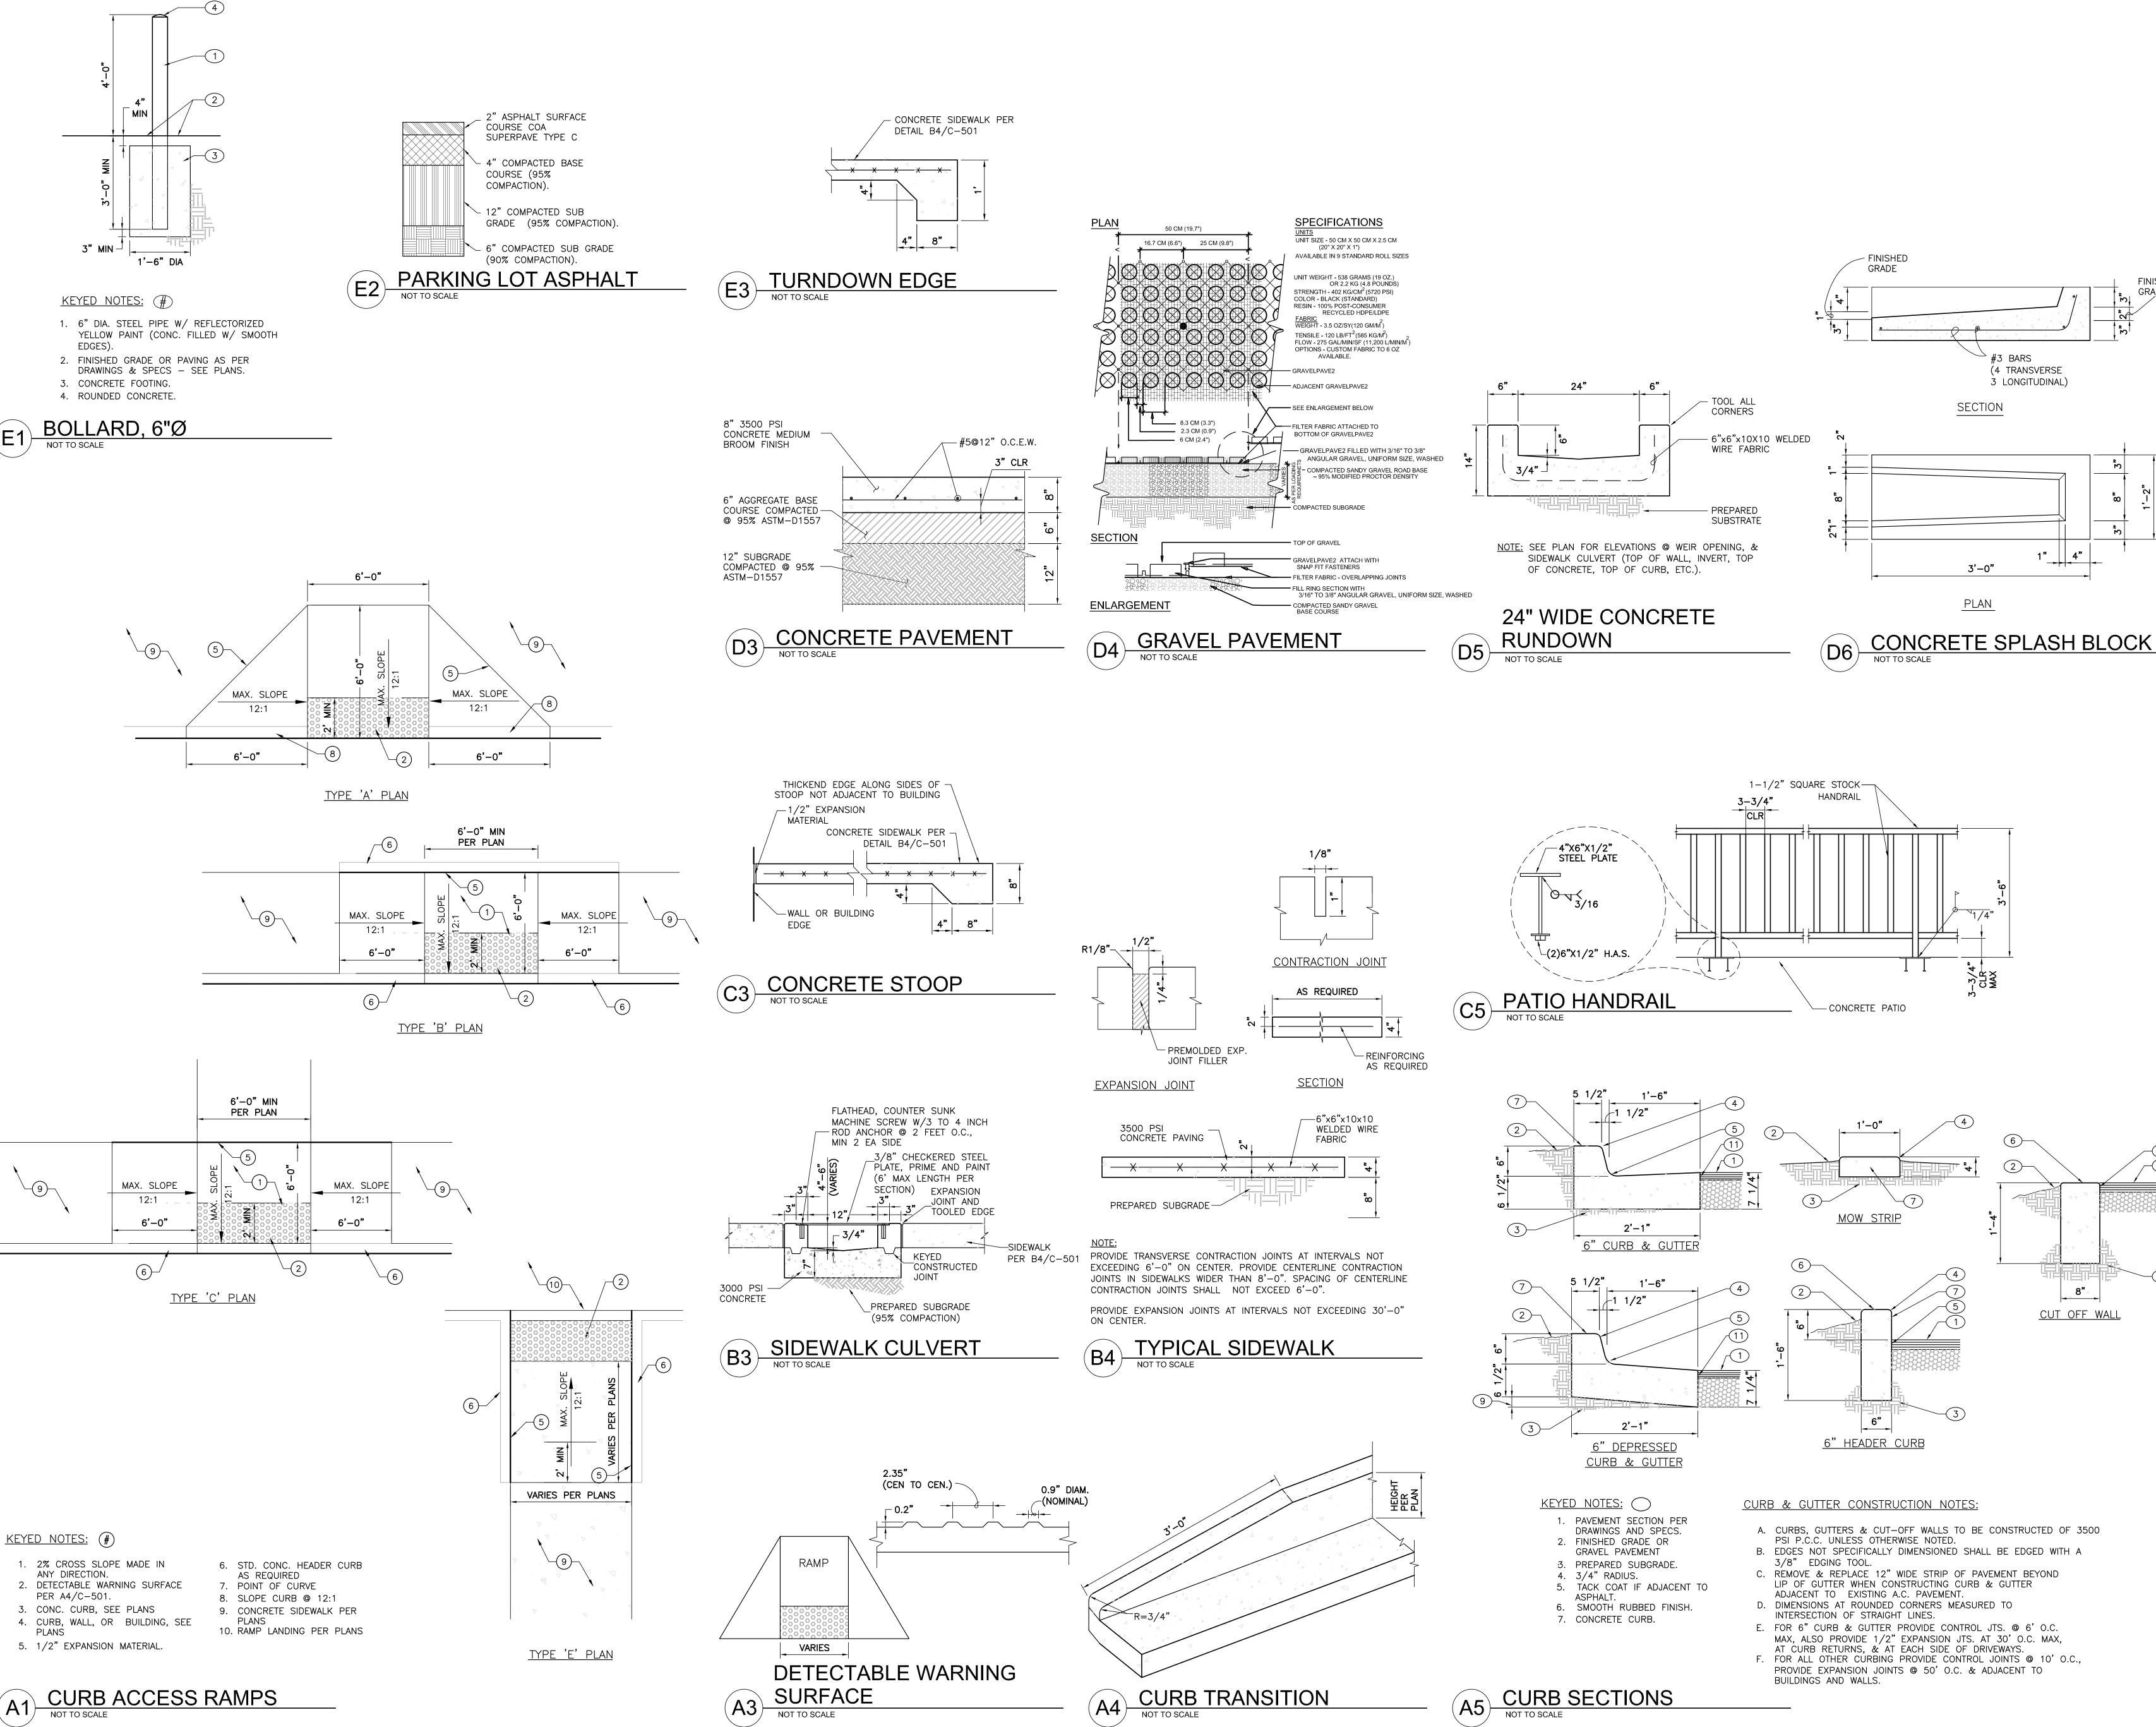
Drawn by	DAA
Checked by	DAA
Date	July 15, 2021
Project number	2574

SHEET TITLE

SITE UTILITY PLAN


SHEET NUMBER

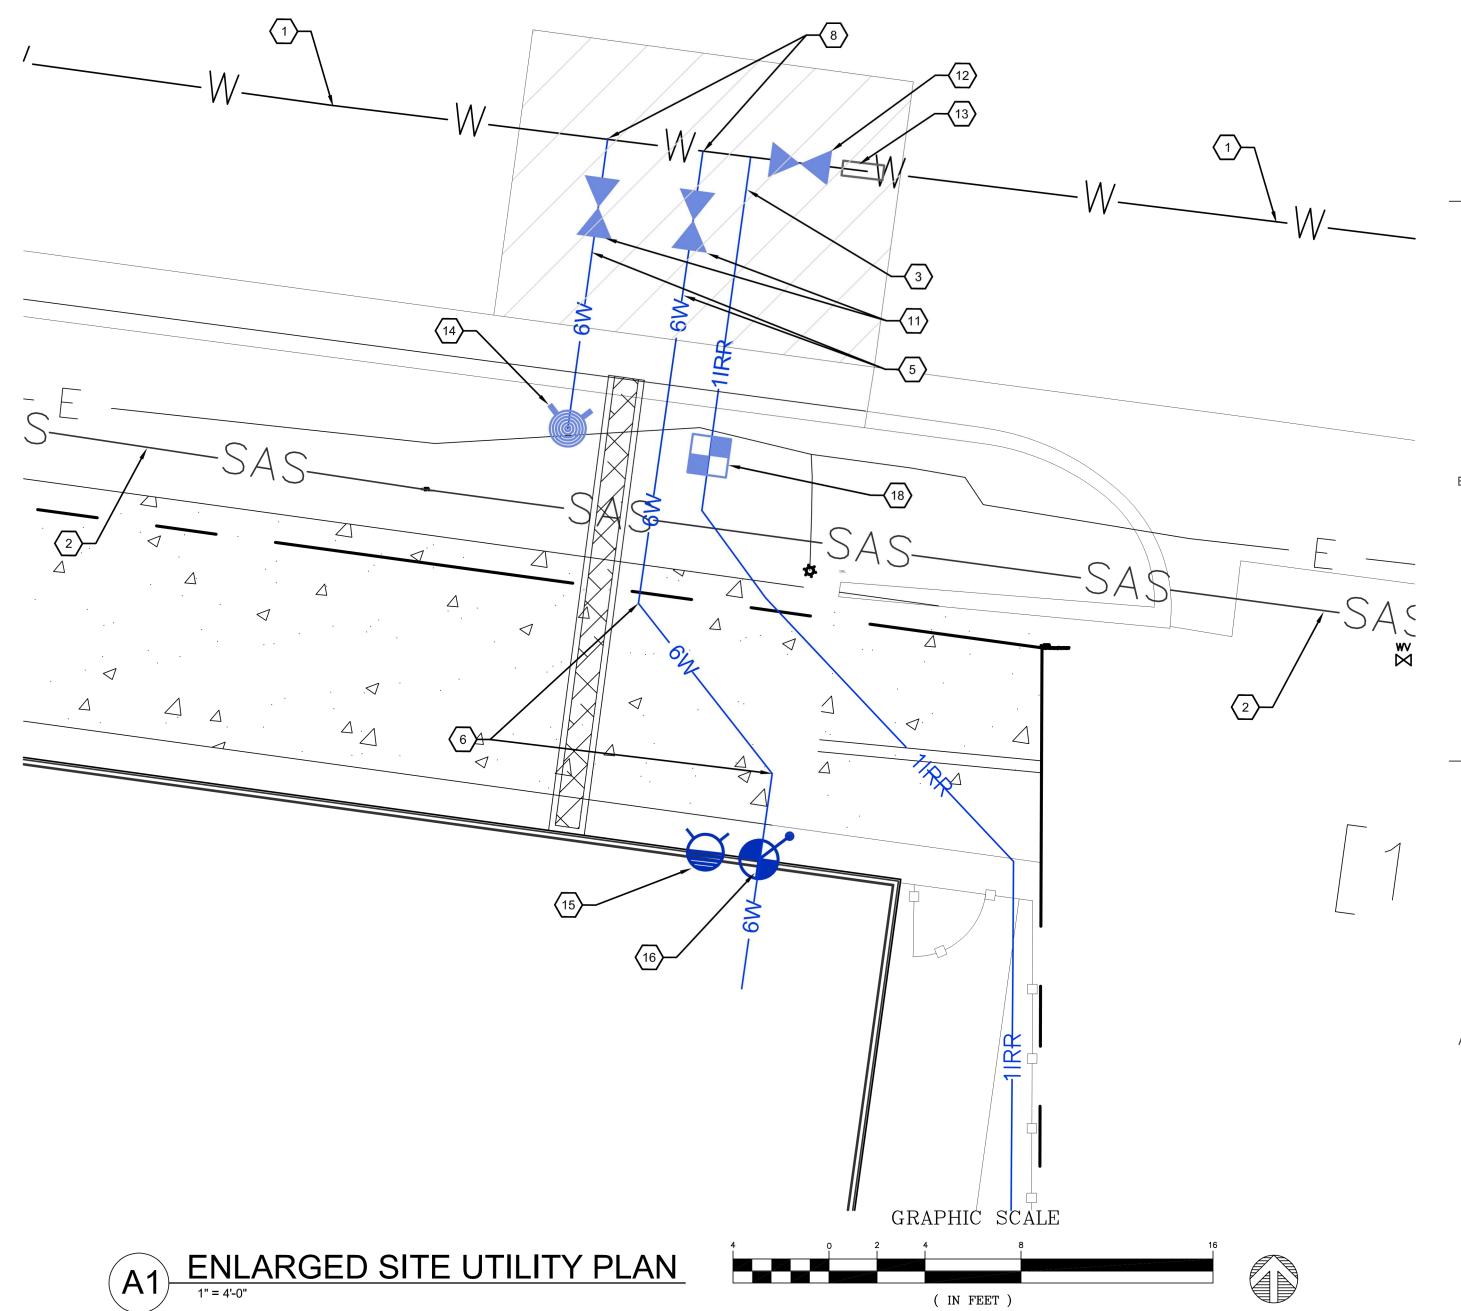C-301 ( IN FEET ) 1 inch = 4 ft.

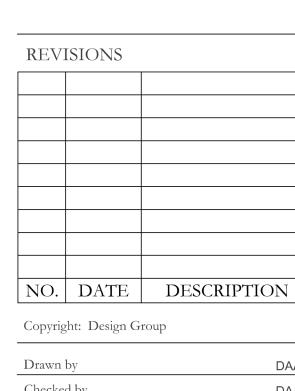

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CUT OFF WALL

- A. CURBS, GUTTERS & CUT-OFF WALLS TO BE CONSTRUCTED OF 3500
- B. EDGES NOT SPECIFICALLY DIMENSIONED SHALL BE EDGED WITH A
- C. REMOVE & REPLACE 12" WIDE STRIP OF PAVEMENT BEYOND LIP OF GUTTER WHEN CONSTRUCTING CURB & GUTTER
- E. FOR 6" CURB & GUTTER PROVIDE CONTROL JTS. @ 6' O.C. MAX, ALSO PROVIDE 1/2" EXPANSION JTS. AT 30' O.C. MAX, F. FOR ALL OTHER CURBING PROVIDE CONTROL JOINTS @ 10' O.C.,

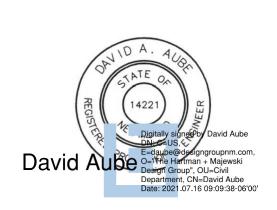NO. DATE DESCRIPTION Copyright: Design Group Drawn by Checked by DAA July 15, 2021 2574 Project number


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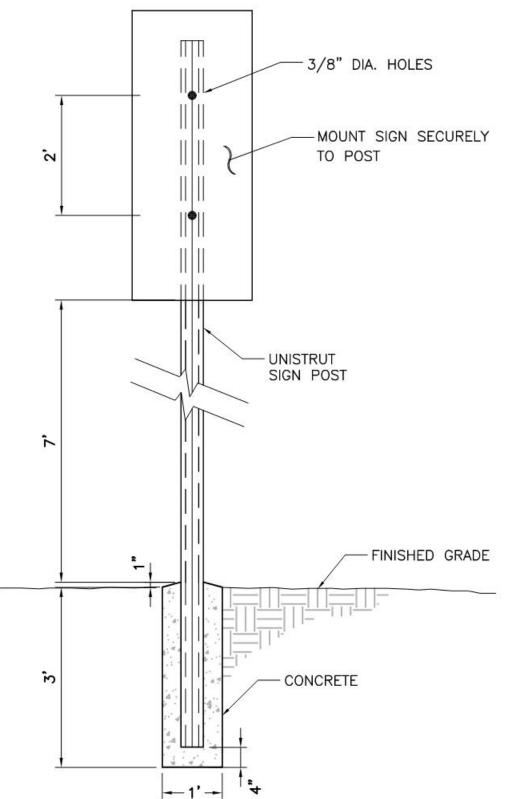
SHEET TITLE

REVISIONS

CIVIL DETAILS

C-501



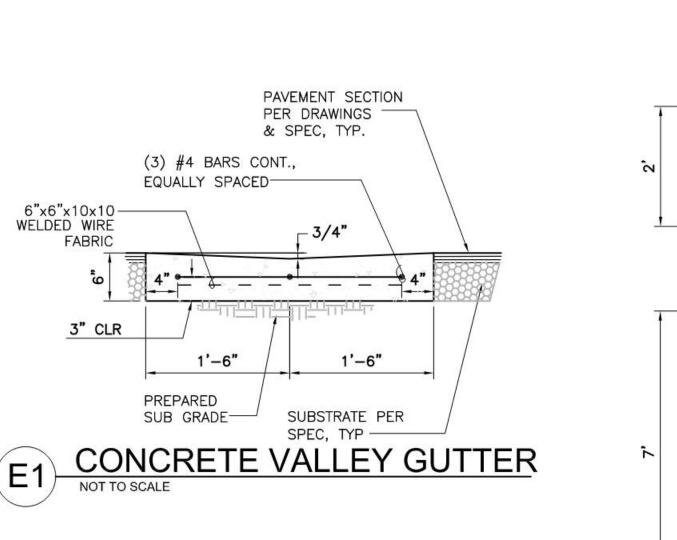




OTHERWISE.


- 1. SET POSTS IN CONCRETE TO A MINIMUM DEPTH OF 3'-0". USE A 2" STEEL FLANGED CHANNEL FOR SIGN POSTS. FABRICATE SIGN PANELS OF .063 ALUMINUM. PAINT POST POSTAL BLUE, (MATTE FINISH). 2. LOCATE POSTS 2'-0" BACK FROM ADJACENT CURBS, UNLESS NOTED
- 3. ALL 2" FLANGED CHANNEL SIGN POSTS TO BE INSTALLED WITH WITH BREAK AWAY CONNECTION.
- 4. ALL SIGNS TO HAVE AN ANTI GRAFFITI COATING, BOTH SIDES.




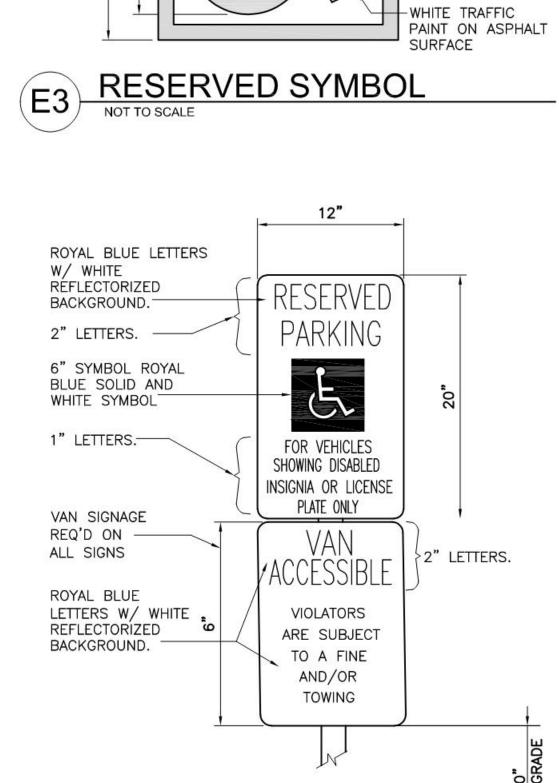


3'-9"




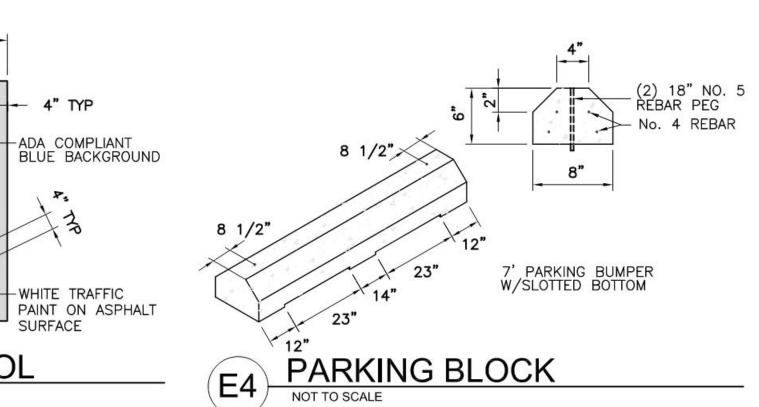

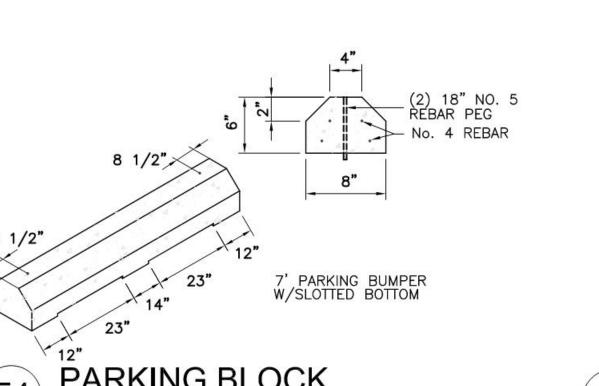


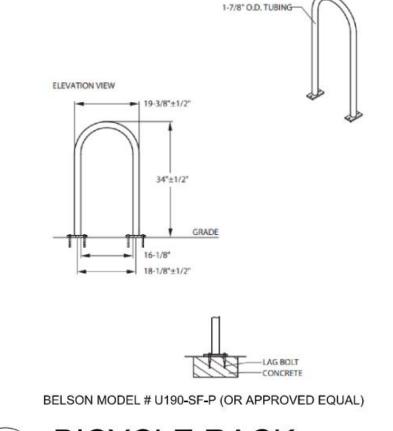

**BICYCLE RACK** 

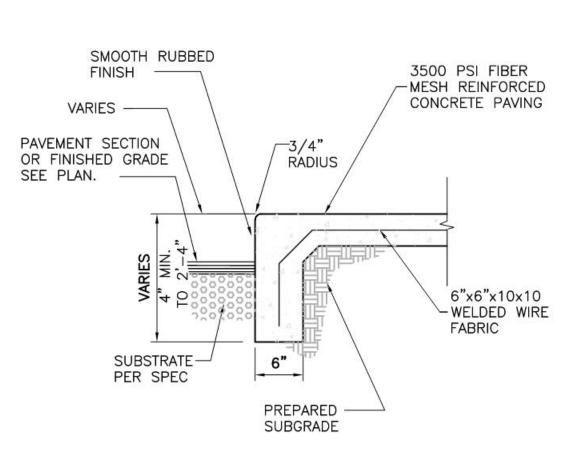

CONCRETE PATIO TURNDOWN

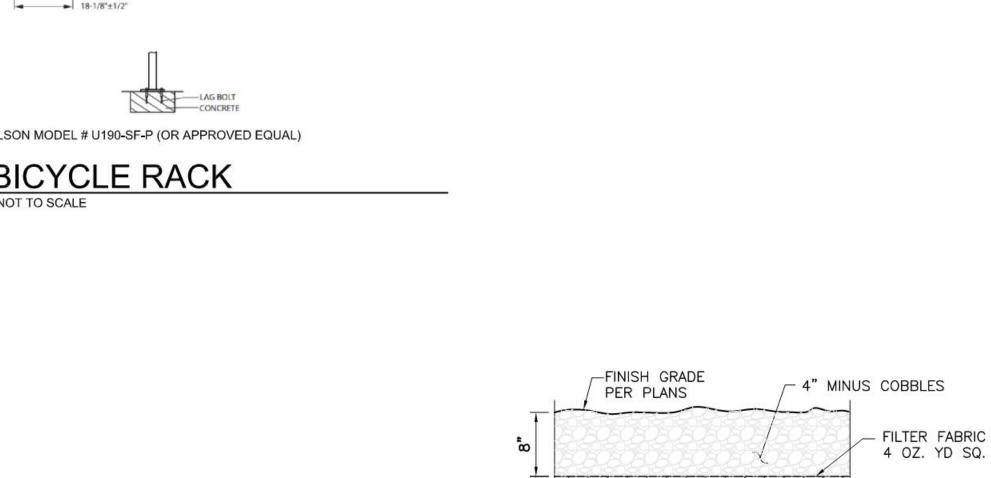


NOTE: Install gravel filter material or filter fabric RIP-RAP SECTION

- PREPARED

SUBGRADE

- GRAVEL FILTER

MATERIAL

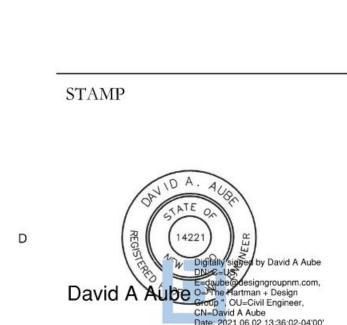

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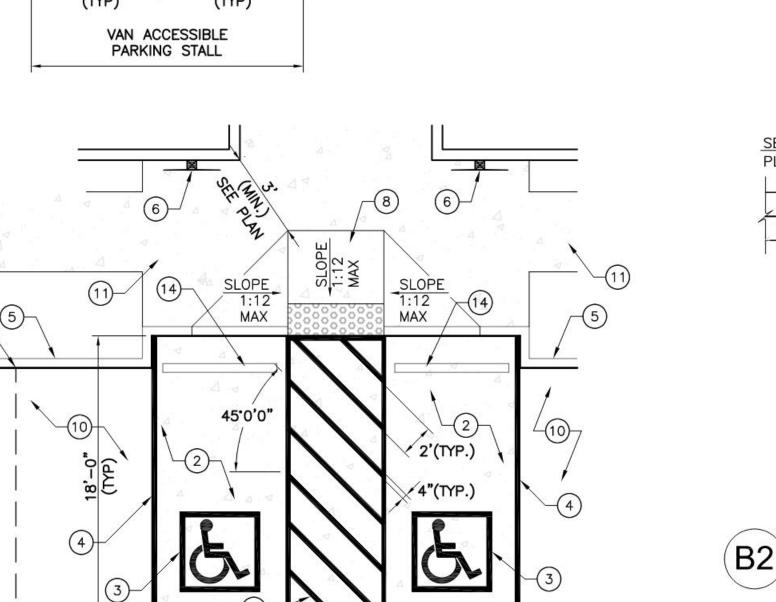
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SITE PLAN - DRB NOT FOR CONSTRUCTION

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## KEYED NOTES:

4

2. TYPICAL STANDARD

STANDARD PARKING STALL

- ACCESSIBLE SPACE. 3. RESERVED PARKING SYMBOL
- PER DETAIL E3/C-501. 5. CONCRETE HEADER CURB
- PER DETAIL A5/C-501. RESERVED PARKING SIGN PER DETAIL C2/C0502. 7. VAN ACCESSIBLE RESERVED PARKING SIGN PER DETAIL


NOT TO SCALE

C2/C-502.


- 1. TYPICAL VAN ACCESSIBLE SPACE. 8. TYPICAL TYPE 'A' CURB RAMP, PER DETAIL A1/C-501. 9. TYPICAL TYPE 'B' CURB RAMP,
- 10. GRAVEL PARKING STALL. 4. 4" WIDE WHITE STRIPING (TYP.). 11. CONC. SIDEWALK, SEE PLANS AND DETAIL B4/C-501. 12. DETECTABLE WARNING SURFACE

ACCESSIBLE PARKING STALL

- 13. 2" V-NOTCH CUT INTO HEADER CURB TO INDICATE EDGE OF PARKING STALL. 14. CONCRETE PARKING BLOCK PER
- PER DETAIL A1/C-501. PER DETAIL A3/C-501. DETAIL D2/C-502. ADA PARKING STALL

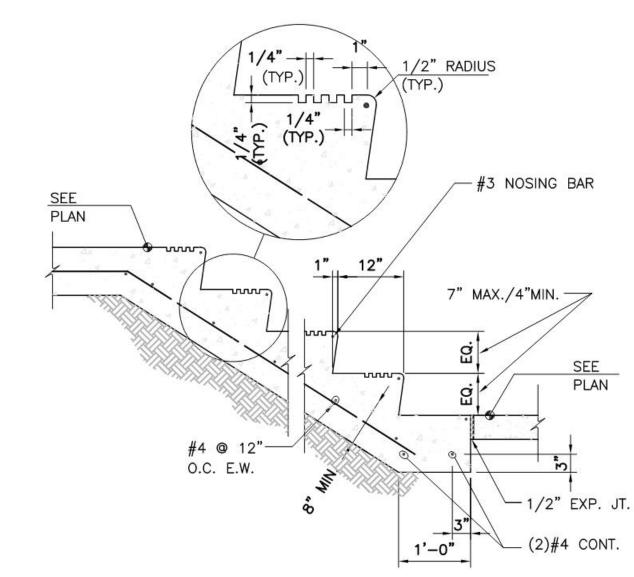

CONCRETE STAIR

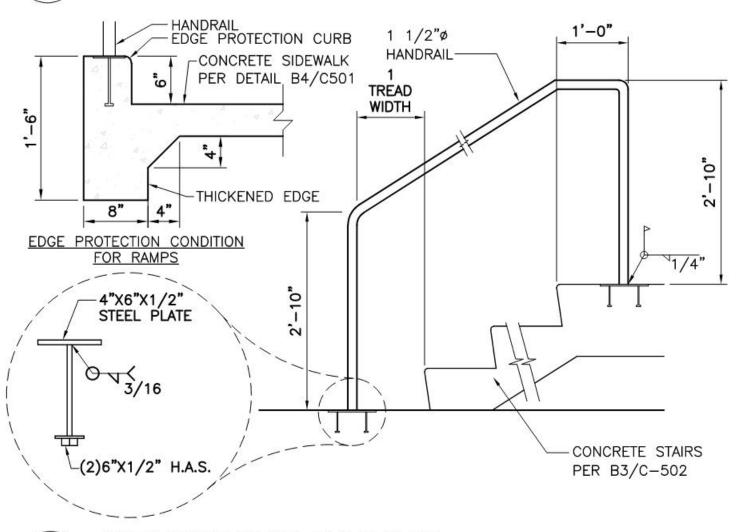

STAIR/RAMP RAILING

REVISIONS NO. DATE DESCRIPTION Copyright: Design Group


Drawn by	DAA
Checked by	DAA
Date	MAY 24, 2021
Project number	2574

CIVIL DETAILS

SHEET TITLE


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C-502

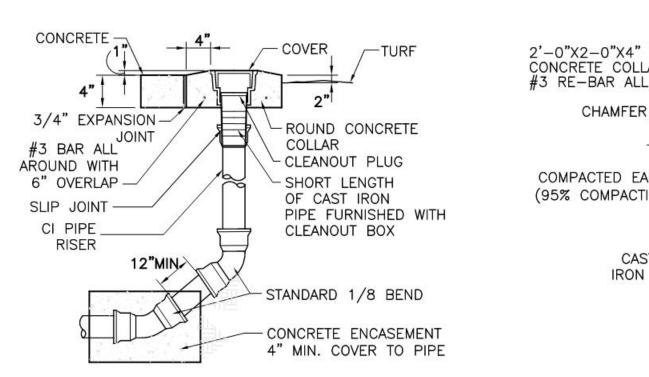


TERMINAL CLEANOUT

14" x 10"

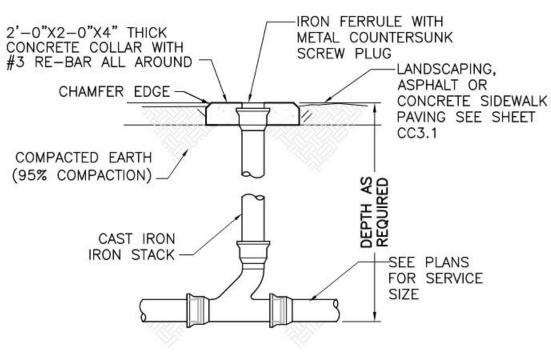


SINGLE CLEANOUT

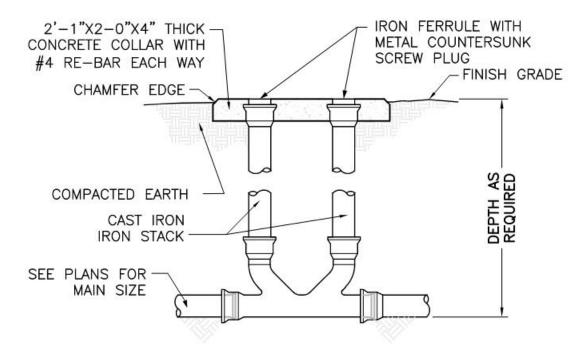


DOUBLE CLEANOUT


REDUCER											
RESTRAIN EITHER L <sub>s</sub> OR L <sub>I</sub> LENGTH	(L <sub>S</sub> ) L SMALL or	(L <sub>I</sub> ) L LARGE									
Size	UNOBSTRUCTED STRAIGHT RUN LENGTH, FEET RESTRAINED	LARGE SIDE RESTRAINED LENGTH, FEET									
6" x 4"	42	28									
8" x 4"	39	30									
8" x 6"	39	30									
10" x 6"	87	53									
10" x 8"	36	29									
12" x 8"	81	54									
12" x 10"	36	30									
T AN ENGRAP AN AN AND ANDREASA		(0.910) (0.01									

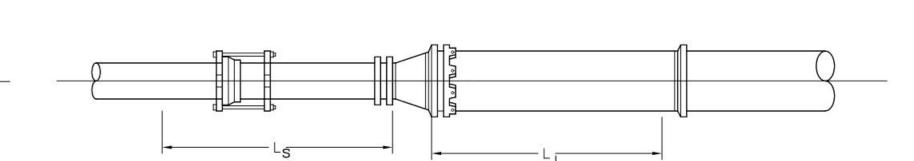

RUN

	GATE VALVES
LINE	RESTRAINED LENGTH L,
SIZE	BOTH SIDES OF VALVE, FEET
4"	39
6"	55
8"	72
10"	86
12"	102
14"	116

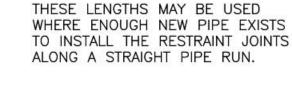

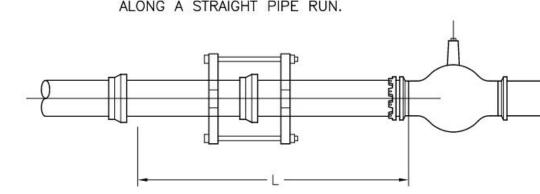

THRUST RESTRAINT GENERAL NOTES

							TEE	<u>:S</u>									1.
LINE	BRANCH SIZE 6" BRANCH SIZE 8"									BRANCH	SIZE	10"		BRANCH	I SIZE	12"	2
SIZE	L <sub>r</sub> =5'	L <sub>r</sub> =10	$L_r = 15$	L <sub>r</sub> =20'	L =5'	$L_r = 10'$	$L_r = 15'$	L <sub>r</sub> =20'	L =5'	$L_r = 10^{\circ}$	$L_r = 15$	L <sub>r</sub> =20'	L =5'	$L_r = 10'$	$L_r = 15$	L <sub>r</sub> =20'	
		95	20	50 AV		RESTRA	INED LE	ENGTH L	, FEET	FOR A	SPECIF	FIED Lr	55	X		S.	3
6"	36	18	FJO	FJ0	58	44	30	16	75	64	53	41	: <del></del> .	<del>-</del>	·—	_	
8"	30	6	FJ0	FJO	53	35	16	FJ0	71	56	42	27	) <del>-</del>	_	×	-	
10"	24	FJO	FJO	FJO	48	24	1	FJO	67	48	29	10	86	70	54	38	
12"	17	FJO	FJO	FJO	43	14	FJO	FJO	63	40	17	FJO	83	63	44	25	4
14"	FJO	FJO	FJO	FJO	21	FJO	FJO	FJ0	39	12	FJO	FJO	56	33	11	FJO	5
F10	DECTD	AINT DE	-0111050	AT CITT	NO 101	NIT ONL										.85	


1. RESTRAINED PIPE LENGTHS FOR PVC USING EBAA IRON THRUST RESTRAINING SYSTEM. 2. LENGTHS MAY OVERLAP TO DETERMINE GREATEST RESTRAINT LENGTH IN ANY ONE DIRECTION. 3. CONTRACTOR SHALL MINIMIZE NUMBERS OF RESTRAINED JOINTS REQUIRED BY USING 20' LONG SECTIONS OF PIPE WITHIN THE RESTRAINED LENGTH WHERE POSSIBLE. DIVIDE LENGTH BY 20 AND TRUNCATE DECIMAL PORTION OF NUMBER TO DETERMINE THE NUMBER OF REQUIRED RESTRAINED JOINTS.

4. SPECIAL CONSIDERATION MAY BE NEEDED TO MEET CERTAIN FIELD CONDITIONS. 5. RESTRAINT LENGTHS MAY EXTEND INTO EXISTING WATER MAINS, REQUIRING RESTRAINED FITTINGS TO BE PLACED AT EXISTING WATERLINE JOINTS FOR THE LENGTH SPECIFIED IN THE TABLES ON

THIS SHEET. 6. CONCRETE BLOCKING, PER COA STANDARD DRAWING 2320, SHALL BE USED IN LIEU OF RESTRAINED JOINTS AT ALL CAPS. DESIGN ASSUMPTIONS:

SAFETY FACTOR: 1.5 PRESSURE: 150 PSI SOIL TYPE: GM & SM - SILTY GRAVELS AND SILTY SANDS PIPE: PVC


TRENCH TYPE: 3 (PIPE BEDDED IN 4 INCHES MINIMUM LOOSE SOIL. BACKFILL LIGHTLY CONSOLIDATED TO TOP OF THE PIPE.)

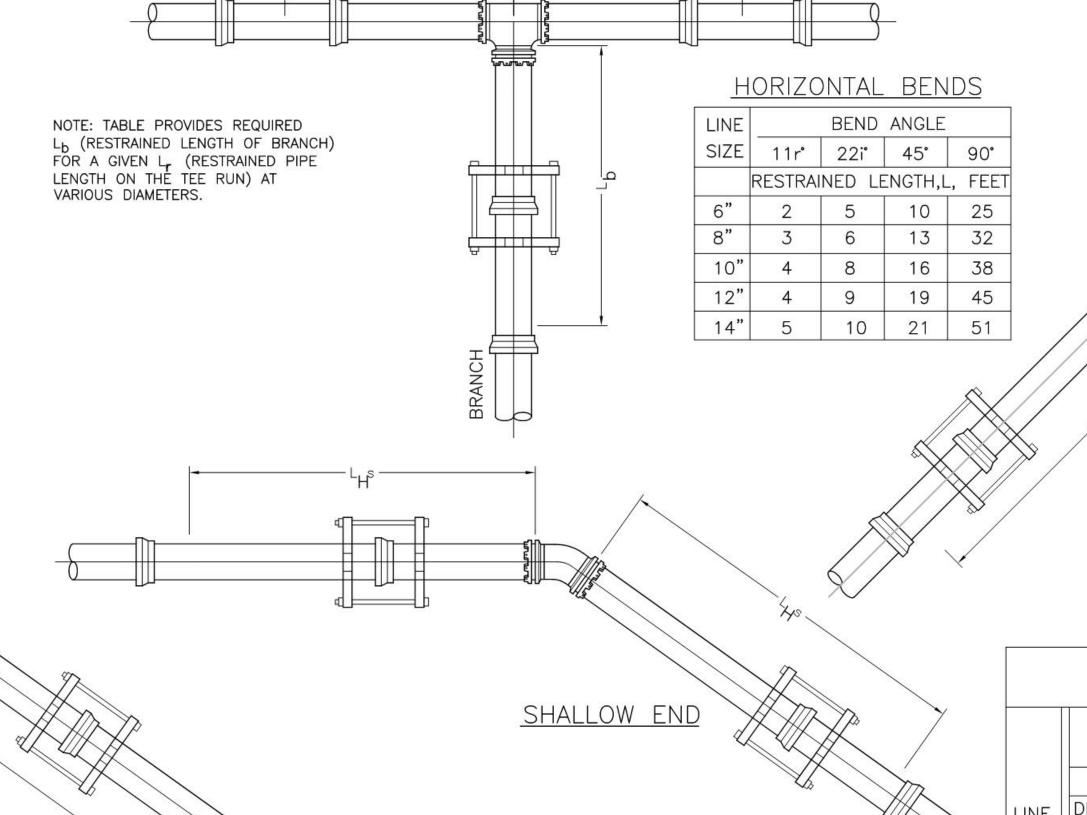

	VER	TICAL OFFS	<u>ETS</u>				
30	SHA	ONAL DESIGN F LLOW END DEP EP END DEPTH	TH = 3.0'	3			
	2	21° BEND	4:	5° BEND			
		RESTRAINED	LENGTH				
LINE	DEEP END	DEEP END SHALLOW END DEEP E		SHALLOW END			
SIZE	L <sub>L</sub> S, FEE	L <sub>H</sub> S, FEET	L <sub>L</sub> S, FEET	L <sub>H</sub> S, FEET			
6"	3	11	5	23			
8"	3	14	7	30			
10"	4	17	8	36			
12"	5	20	10	42			
14"	5	23	11 48				

PIPE RESTRAINT LENGHTS

DEEP END

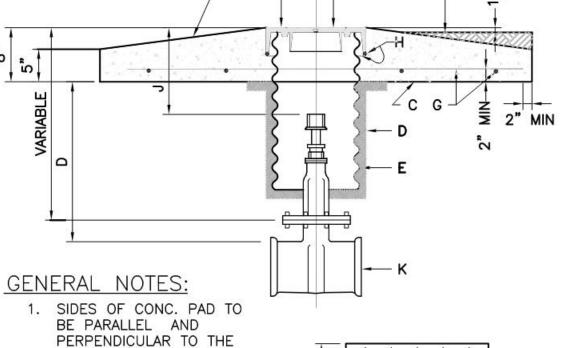

5'-2"

PLAN VIEW

PERPENDICULAR TO THE NORMAL STREET TRAFFIC FLOW. 2. USE THIS TYPE VALVE BOX FOR LOCATION IN UNPAVED STREETS OR ALLEYS AND IN NON-TRAFFIC EASEMENTS.

SCRIBE LINE IN CONCRETE PAD TO INDICATE PIPE DIRECTION SCRIBE VALVE SIZE IN CONCRETE PAD. SEE DETAIL 5/C.5


# CONCRETE PAD **CONSTRUCTION NOTES:**

- B. COVER. C. PORTLAND CEMENT CONC. 3500 P.S.I. D. COMPACTED EARTH FILL, 95% OF MAX. DENSITY AS DETERMINED BY A.S.T.M. D-1557.
- E. 12" DIA. CORRUGATED GALV. CULVERT PIPE 14 GA. DIPPED IN COAL TAR ENAMEL OR COATED WITH POLYMERIC COATING. 3 MILS THICK MIN. MEETING REQUIREMENTS SET BY A.A.S.H.T.O.M 246. SEE DETAIL 6/C.5
- F. GROUND LEVEL.

A. RING.

- G. NO. 4 BARS AT 12" O.C. EACH WAY. H. NO. 4 BARS 1'-6" LONG.
- J. 2'-0" MAX., USE STEM EXTENSION AS NECESSARY. K. NEW OR EXISTING VALVE.
- L. SCRIBE IN THE FRESH CONCRETE THE SIZE OF THE

# WATER VALVE BOX

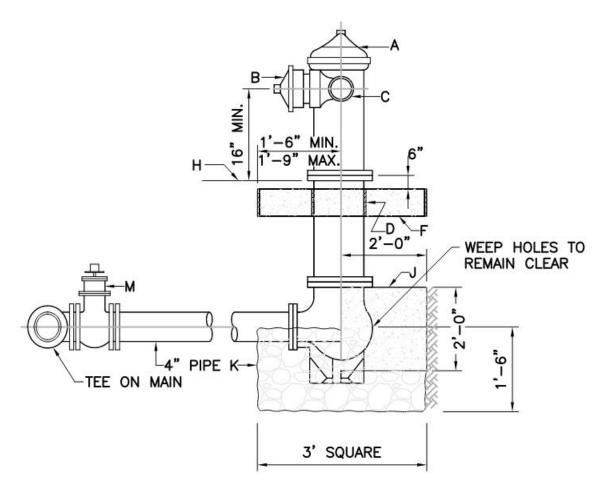

## **GENERAL NOTES:**

- 1. NO OBSTRUCTIONS WILL BE PERMITTED WITHIN 3 FT. OF FIRE HYDRANT.
- 2. CONTRACTOR SHALL BE RESPONSIBLE FOR SETTING TOP FLANGE OF FIRE HYDRANT TO THE CONTROLLED ELEVATION LINE.
- 3. PUMPER NOZZLE TO BE SET FACING THE TRAVELED WAY, UNLESS OTHERWISE NOTED ON PLANS.

# **CONSTRUCTION NOTES:**

- A. FIRE HYDRANT PER SPEC'S
- B. PUMPER NOZZLE 4 1/2" C. HOSE NOZZLE 2 1/2"
- D. 1/2" EXPANSION JOINT MATERIAL F. 3'X3'X6" CONC. SQ. PAD, TO BE CONSTRUCTED
- AROUND FIRE HYDRANT'S CENTER LINE. H. CONTROLLED ELEV. LINE, LEVEL IN ALL DIRECTIONS J. CONC. THRUST BLOCK, APPROX. 2'X2'X3' TO BE
- POURED AGAINST UNDISTURBED EARTH, F.H. WEEP HOLE MUST BE UNOBSTRUCTED.
- K. GRAVEL DRAIN POCKET, COVER TOP SURFACE


CONNECTED TO TEE AT MAIN.

WITH TAR PAPER. M. IF VALVE IS REQUIRED, VALVE WILL BE

# FIRE HYDRANT


### **GENERAL NOTES:**


- 1. MECHANICAL TAMPERS NOT TO BE USED IN THE INTIAL BACKFILL SECTION FOR FLEXIBLE
- 2. MINIMUM CLASS "C" BEDDING WILL BE USED.
- 3. TRENCH SIDE-SLOPES MUST CONFORM WITH OSHA REQUIREMENTS.

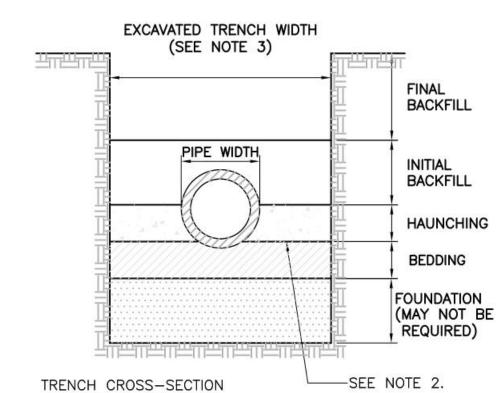

SEWER PIPE TRENCH

SHOWING TERMINOLOGY

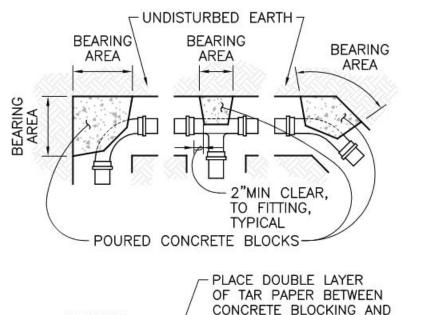

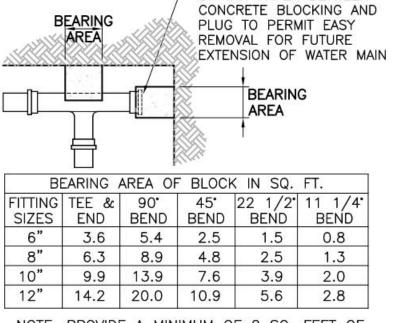


NOTE: PROVIDE A MINIMUM OF 2 SQ. FEET OF BEARING AREA FOR SMALLER PIPE SIZES NOT LISTED IN THE TABLE.

THRUST BLOCKING

# NOT TO SCALE

AND HOT BOX


**BACKFLOW PREVENTER** 

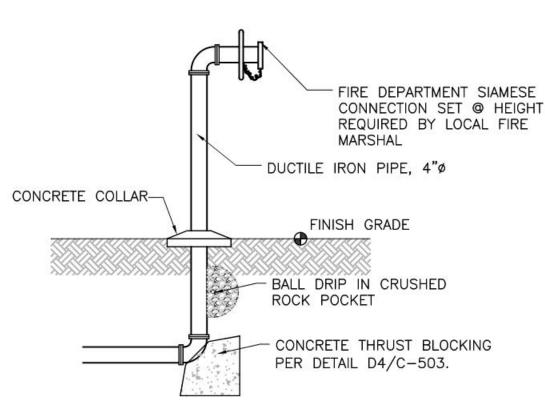


FIRE DEPARTMENT CONNECTION.

# GENERAL NOTES:

- 1. MECHANICAL TAMPERS NOT TO BE USED IN THE INITIAL BACKFILL SECTION FOR FLEXIBLE
- 2. MINIMUM CLASS "C" BEDDING WILL BE USED. 3. TRENCH SIDESLOPES MUST CONFORM WITH OSHA REQUIREMENTS.

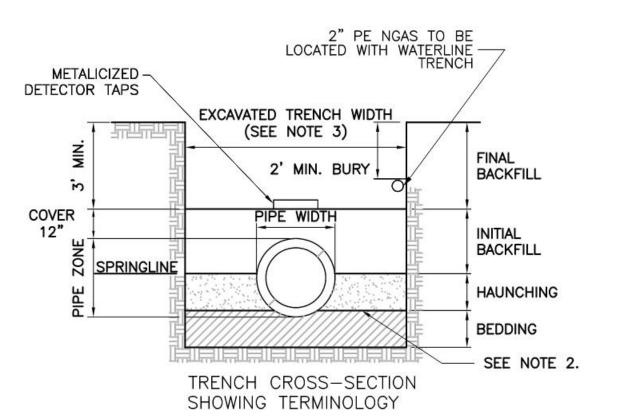

WATER PIPE TRENCH

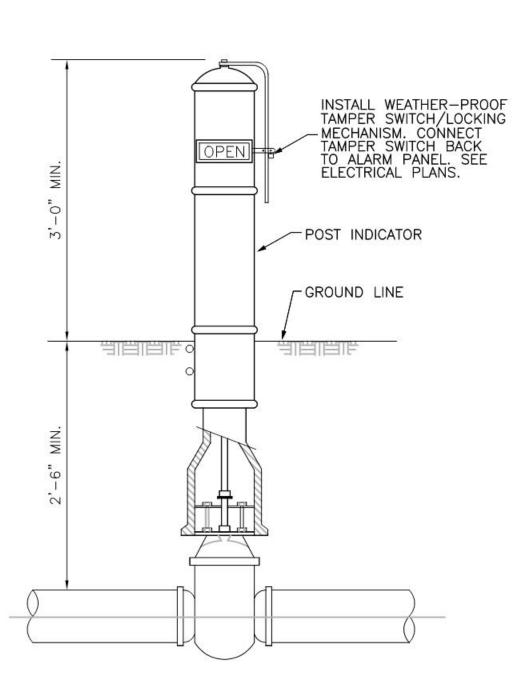

POST INDICATOR VAVLE

STAMP SITE PLAN - DRB NOT FOR CONSTRUCTION

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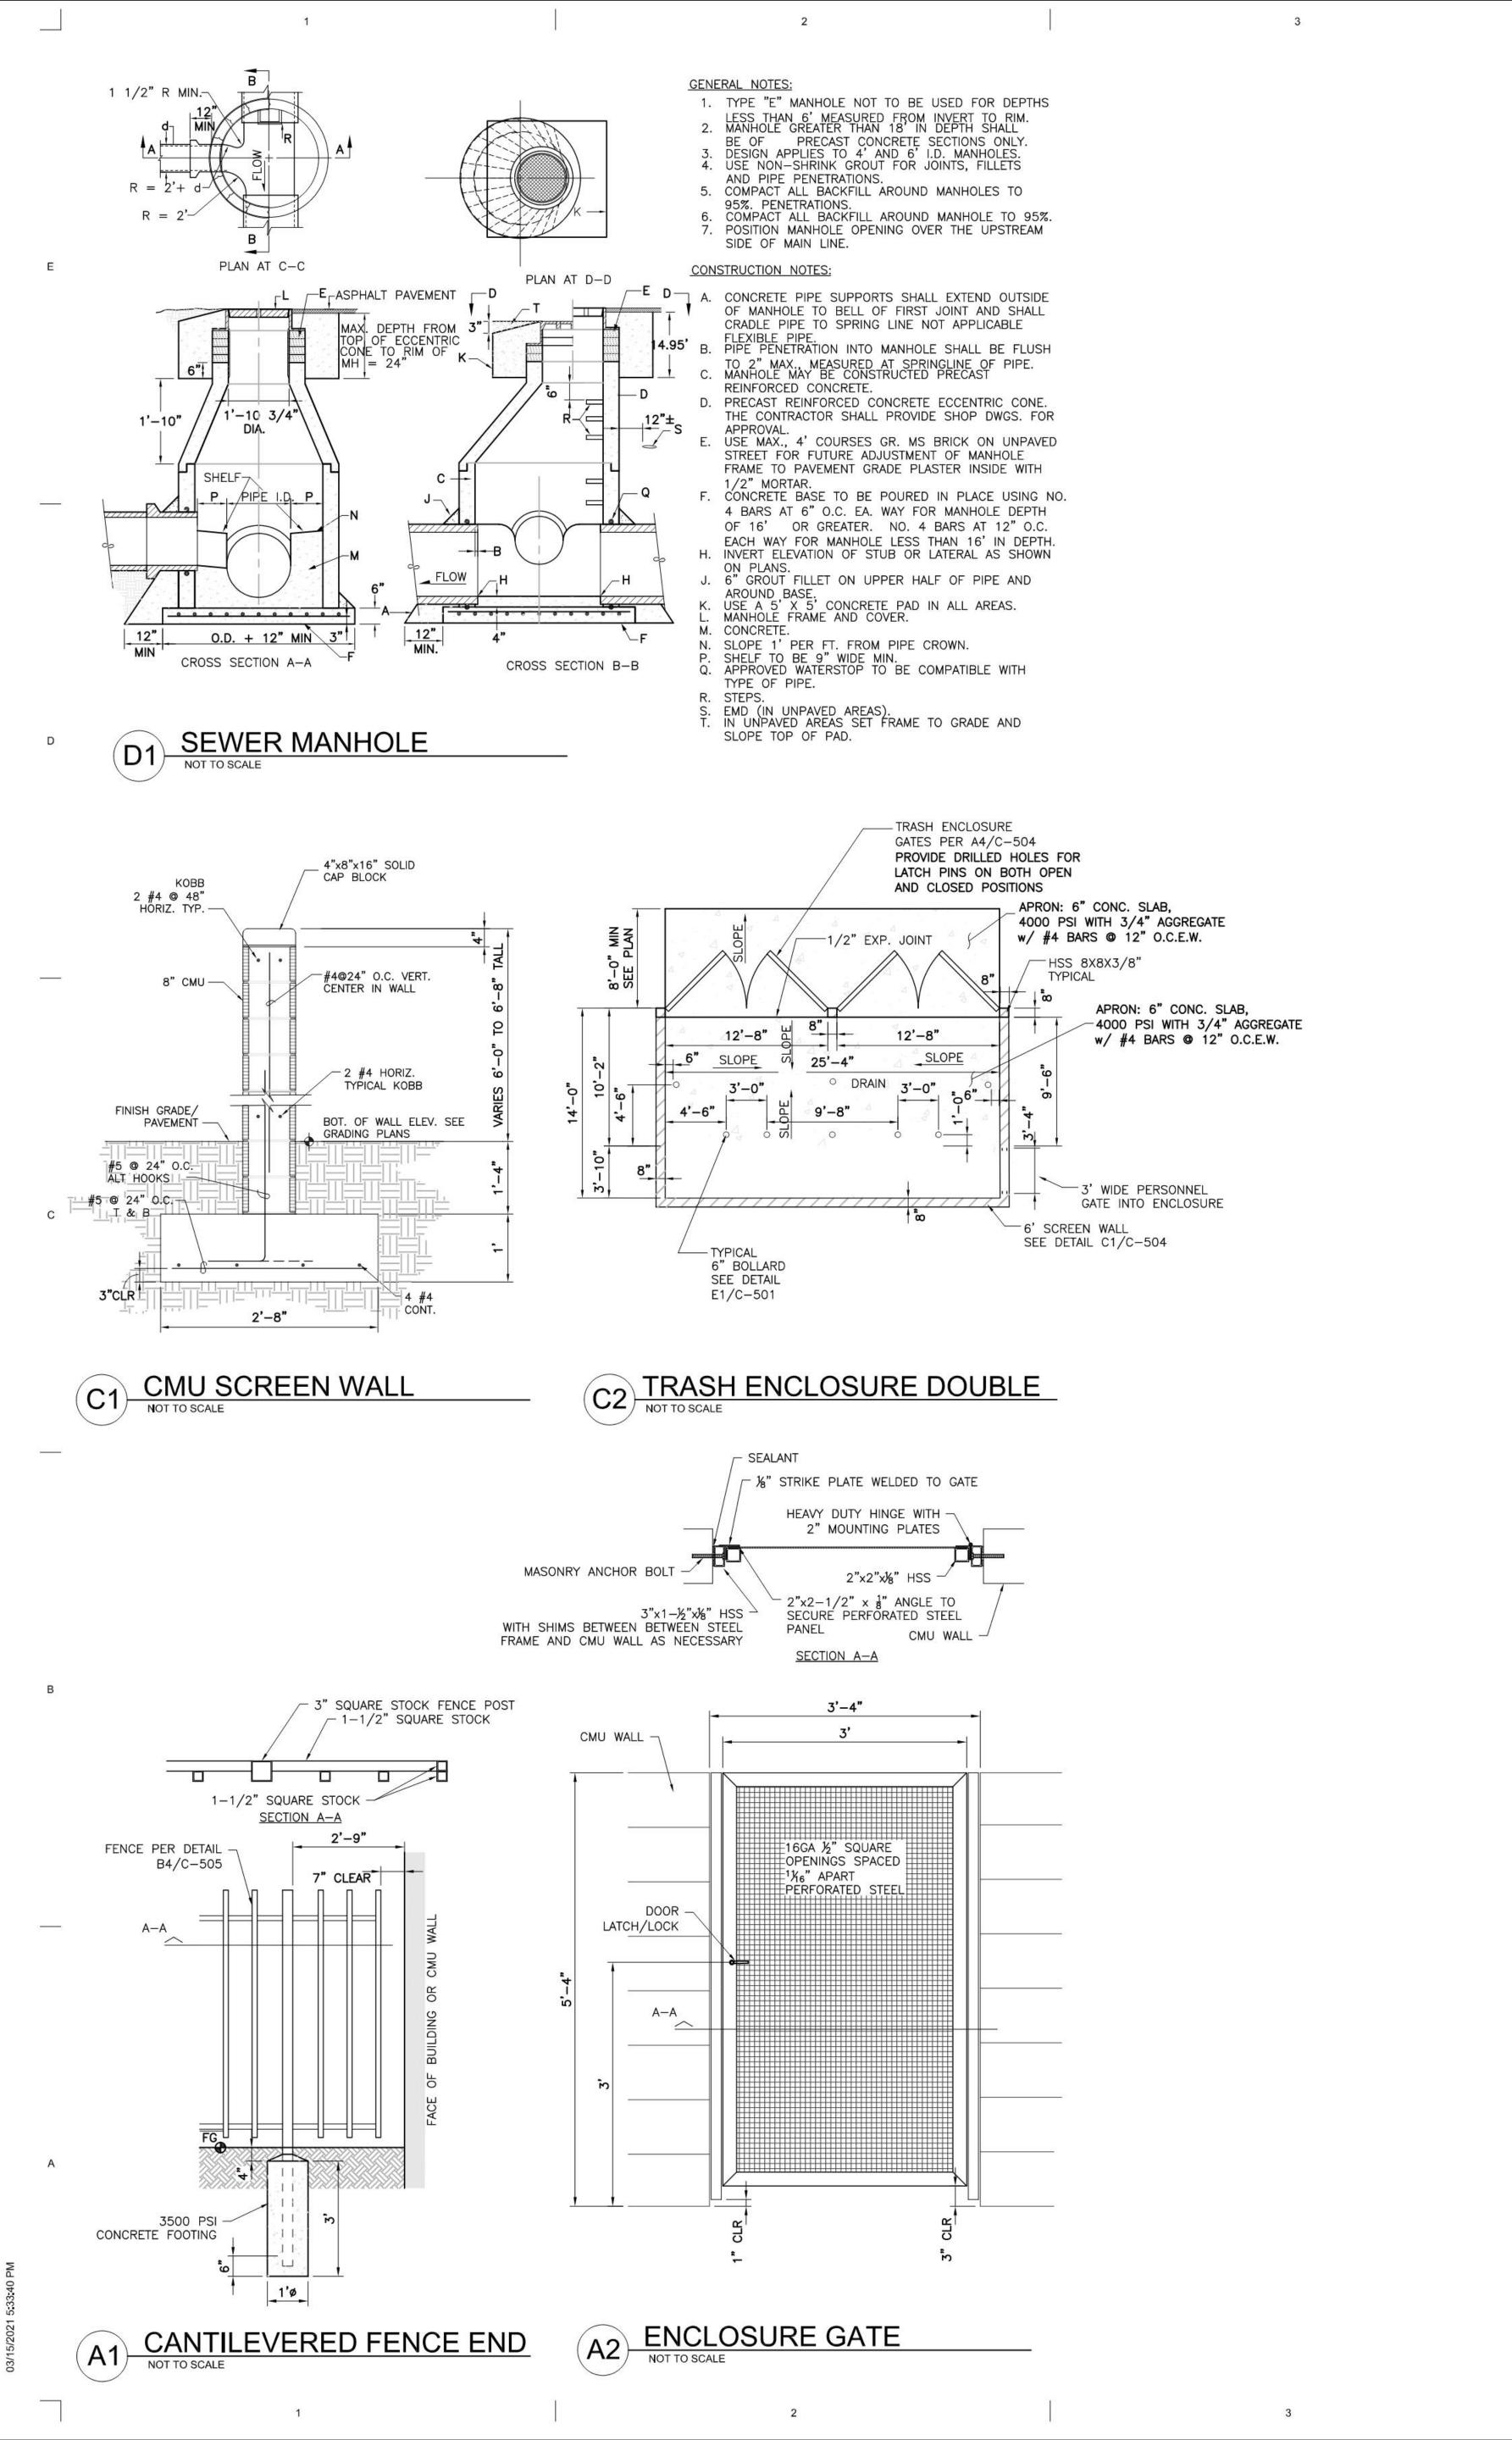
Drawn by Checked by DAA MAY 24, 2021 2574 Project number


SHEET TITLE

CIVIL DETAILS

SHEET NUMBER

C-503



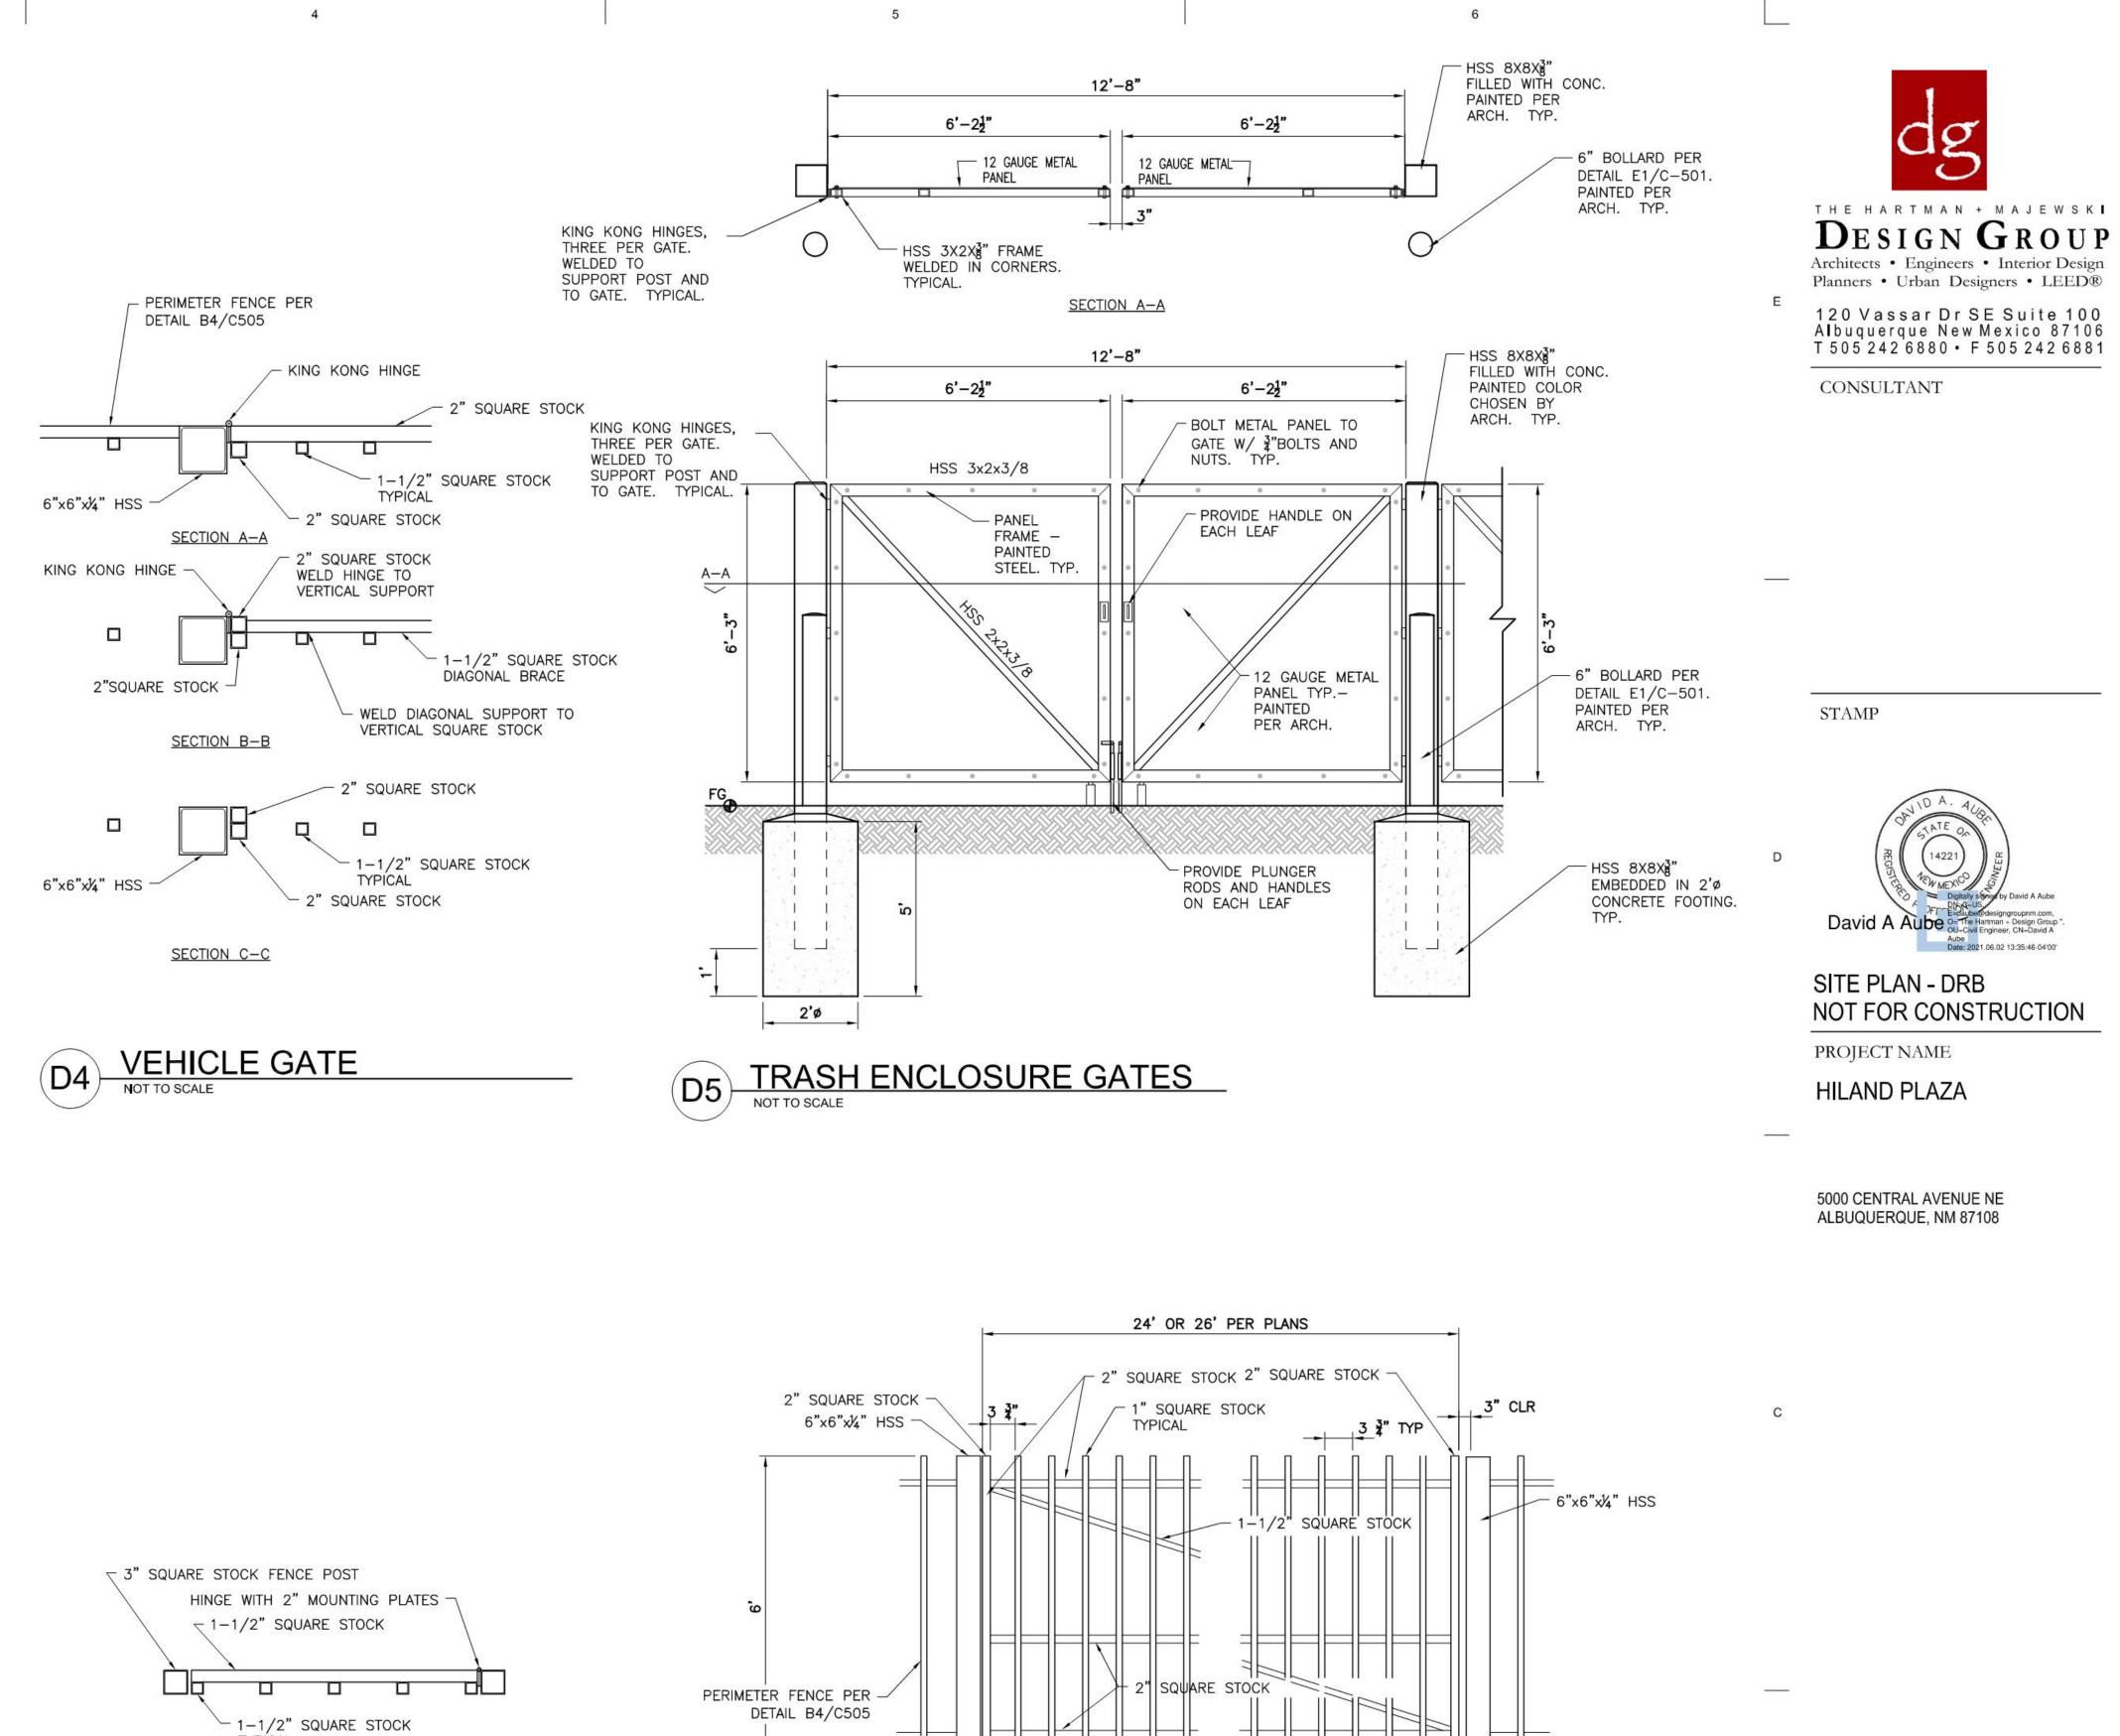

4" MAX CLR

12' MAX

1-1/2" SQUARE STOCK

PERIMETER FENCE AND SLIDING GATES

----

3500 PSI -

CONCRETE FOOTING

√ 1−1/2" SQUARE STOCK

الدابا ا

18"

TYPICAL

PERIMETER FENCE PER -

GATE ACCESS DEVICE -PLACED WITHIN

N.E.M.A. ENCLOSURE

STEEL HANDLE

STEEL MESH SCREEN TO

EXTEND 4' ON EITHER SIDE OF GATE ACCESS DEVICE TO RESTRICT

ACCESS TO EXIT DEVICE

WEATHER PROOF

DETAIL B4/C505

SECTION A-A

SECTION B-B

SECTION C-C

NOTE: INSTALL EXIT DEVICE ON 4' TALL 3"x3" SQUARE STOCK

FROM FENCE ON THE INSIDE OF PROPERTY.

(FOUNDATION AND APPEARANCE TO MATCH FENCE) PLACED 5'

PERIMETER FENCE GATE

2" SQUARE STOCK WITH

HINGE ATTACHED

SQUARE STOCK FENCE POST

8" LONG

- 1-1/2" SQUARE STOCK

CAP TOP OF 3" SQUARE

STOCK FENCE POSTS

CONCRETE CURB AND GUTTER -

AROUND GATE POST

3500 PSI CONCRETE FOOTING -

3" SQUARE STOCK -


1-1/2" SQUARE STOCK -


PAINTED COLOR -SELECTED BY

ARCHITECT

18"

WITH 4" OF CONCRETE POURED

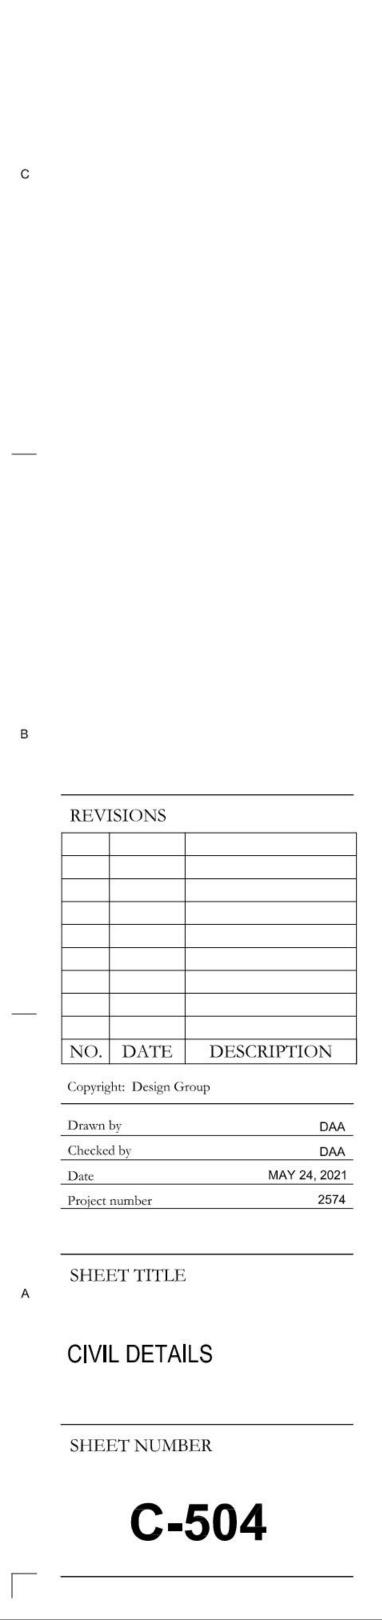

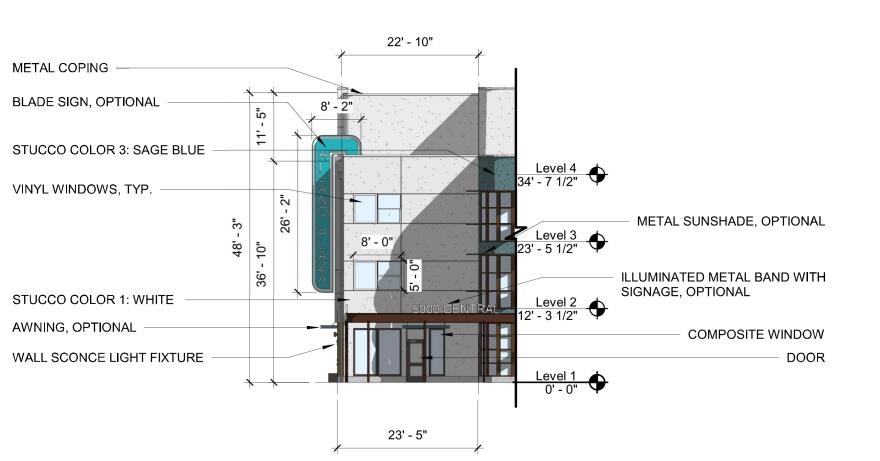



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STAMP

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HÍLAND PLAZA

DRB SUBMITTAL

5000 CENTRAL AVENUE SE, ALBUQUERQUE, NM, 87106

HILAND PLAZA

APARTMENTS LIMITED

PARTNERSHIP LLLP

PROJECT NAME

WEST ELEVATION - NORTH END


WEST ELEVATION






EAST ELEVATION

1/16" = 1'-0"

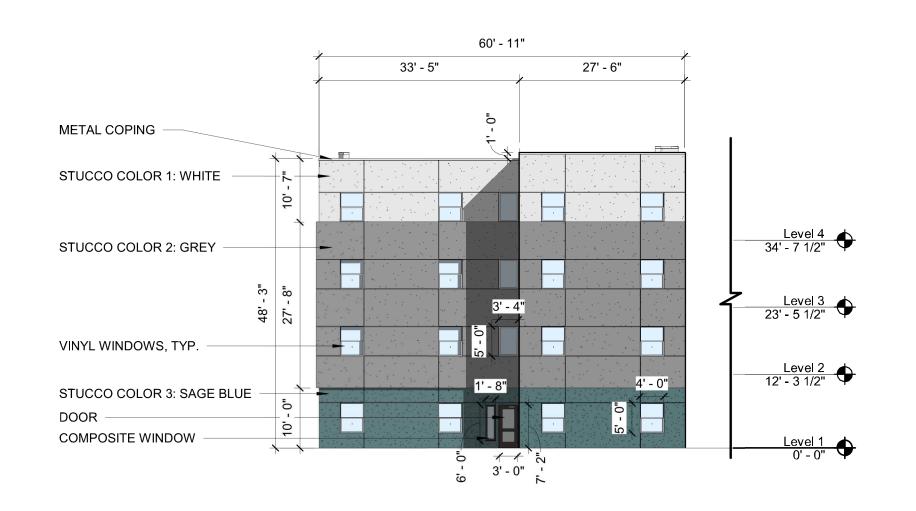

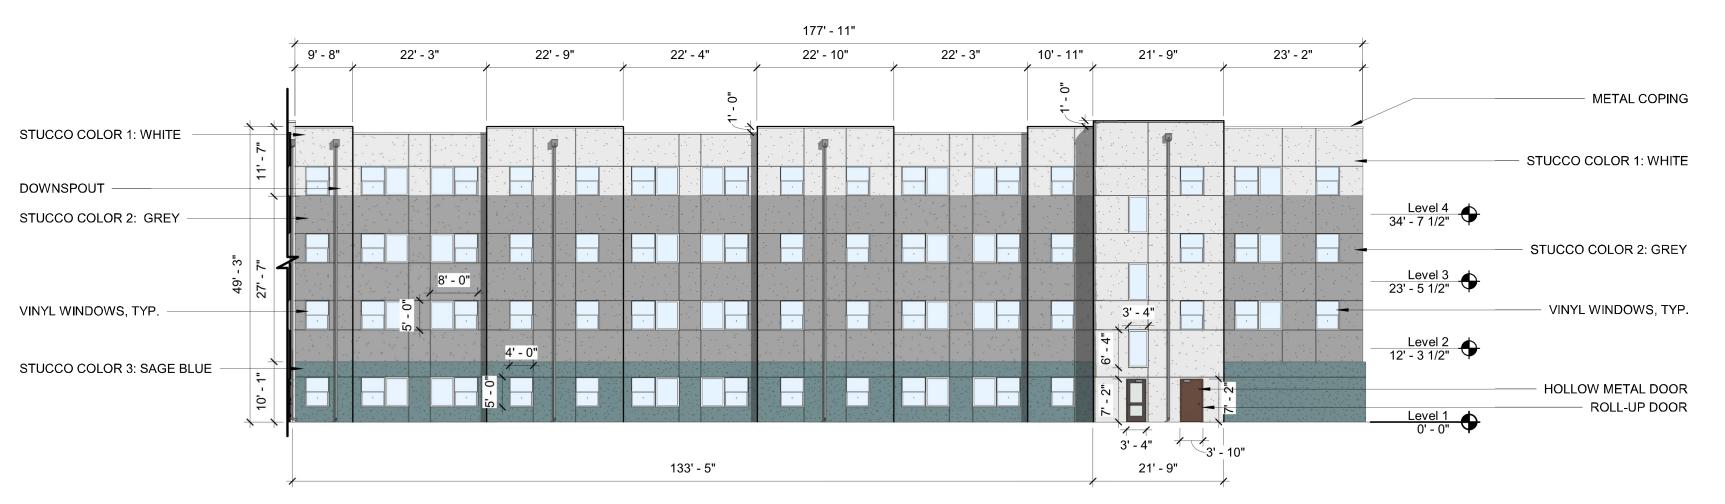

SOUTH ELEVATION - WEST END


1/16" = 1'-0"

B3 SOUTH ELEVATION

1/16" = 1'-0"



NORTH ELEVATIONS

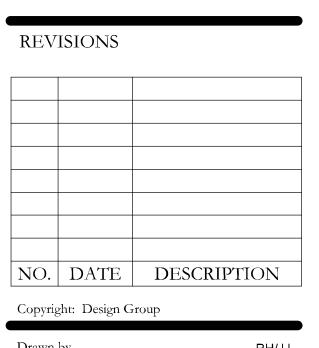

Checked by JULY 16, 2021 Project number

**BUILDING ELEVATIONS** 

SHEET NUMBER

201.1

Current DRC	
Project Number:	PR-2021-005390

#### FIGURE 12

Date Submitted:_ <b>7-16-21</b> _	
Date Site Plan Approved:	

### **INFRASTRUCTURE LIST**

(Rev. 2-16-18)

#### EXHIBIT "A"

Date Preliminary Plat Approved:

Date Preliminary Plat Expires:

DRB Project No.: PR-2021-005390

DRB Application No.:

#### TO SUBDIVISION IMPROVEMENTS AGREEMENT

### DEVELOPMENT REVIEW BOARD (D.R.B.) REQUIRED INFRASTRUCTURE LIST

Hiland Plaza

#### PROPOSED NAME OF PLAT AND/OR SITE DEVELOPMENT PLAN

LOTS NUMBERED ONE (1) THROUGH TWENTY-TWO (22), INCLUSIVE, IN BLOCK NUMBERED THIRTY-FOUR (34) OF THE VALLEY VIEW ADDITION TO THE CITY OF ALBUQUERQUE, NEW MEXICO, AS THE SAME IS SHOWN AND DELINEATED ON THE MAP OF SAID ADDITION, FILED IN THE OFFICE OF THE COUNTY CLERK OF BERNALILLO COUNTY, NEW MEXICO, ON SEPTEMBER 2, 1911

#### **EXISTING LEGAL DESCRIPTION PRIOR TO PLATTING ACTION**

Following is a summary of PUBLIC/PRIVATE Infrastructure required to be constructed or financially guaranteed for the above development. This Listing is not necessarily a complete listing. During the SIA process and/or in the review of the construction drawings, if the DRC Chair determines that appurtenant items and/or unforeseen items have not been included in the infrastructure listing, the DRC Chair may include those items in the listing and related financial guarantee. Likewise, if the DRC Chair determines that appurtenant or non-essential items can be deleted from the listing, those items may be deleted as well as the related portions of the financial guarantees. All such revisions require approval by the DRC Chair, the User Department and agent/owner. If such approvals are obtained, these revisions to the listing will be incorporated administratively. In addition, any unforeseen items which arise during construction which are necessary to complete the project and which normally are the Subdivider's responsibility will be required as a condition of project acceptance and close out by the City.

	ince and close out by							ıction Cer	
Financially	Constructed	Size	Type of Improvement	Location	From	То	Privat		City Cnst
Guaranteed	Under						Inspector	P.E.	Engineer
DRC #	DRC #	0.11		0.1.		B			,
		8"	Waterline	Silver Avenue SE	Jackson Street SE	East Property Line	<u> </u>	/	
		8"	Sanitary Sewer	Silver Avenue SE	Jackson Street SE	East Property Line		1	/
		Ŭ	Samery Sover	Onvoi / Worldo OE	Suckeen SuccessE	Last Froperty Line	<u> </u>		
		5'	Sidewalk	Silver Avenue SE	Jackson Street SE	East Property Line	/	1	/
l									
							/	1	/
			6.1		011 4 05	0 1 1 1 0 0 0		,	,
		6.	Sidewalk	Jackson Street	Silver Avenue SE	Central Avenue SE	<u> </u>	/	/
								1	/
					<del></del>				
		10'	Sidewalk	Central Avenue SE	Jackson Street SE	East Property Line	/	1	/
								_	
							/	1	/
								,	,
									/
		<u>]</u>							

Financially	Constructed							Cor	nstruction	n Certifi	cation
Guaranteed	Under	Size	Type of Improvement	Location	From	То		Pi	rivate		City Cnst
DRC#	DRC#							Inspector	P.E	≣.	Engineer
								/	1		1
		_						,	/		1
		_			Approval of Credita	ble Items:		Approval	of Credita	able Itei	ns:
					Impact Fee Admistr	ator Signature	 Date	City Use	r Dept. Si	ignatur	e Date
				NOTES				-			
		If the site is	located in a floodplain, then the financia			is approved by I	FEMA.				
4			Street lig	hts per City rquirements.							
1 -											
-											
2											
_											
3 _											
_											
	AGENT / OWNER			DEVELOPMENT R	EVIEW BOARD MEMBE	R APPROVALS					
				DEVELOPMENT R	EVIEW BOARD MEMBE	R APPROVALS					
	David Aube						ATION		_		
			DRB CHA			R APPROVALS	EATION - (	date	_		
The	David Aube	roup		AIR - date		ARKS & RECRE		date	_		
	David Aube NAME (print)	roup	DRB CHA	AIR - date				date	_		
	David Aube NAME (print) H+M Design G	Digitally signed by David Aube		AIR - date		ARKS & RECRE		date	_		
VID A. A	David Aube NAME (print) H+M Design G FIRM David Au	Digitally signed by David Aube DN: C=US, E=daube@designgroup O= The Hartman + Majewski Design Date: 2021.07.16 11:18:45-96:00		AIR - date DEVELOPMENT - date	. P	ARKS & RECRE	- date		_		
STATE OF	David Aube NAME (print) H+M Design G FIRM David Au SIGNATURE - date	Digitally signed by David Aube DN: C=US, E=daube@designgroup O= The Hartman + Majewski Design Date: 2021.07.16 11:18:45-96:00	TRANSPORTATION D	AIR - date DEVELOPMENT - date	. P	ARKS & RECRE	- date		_		
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STATE OF	David Aube NAME (print) H+M Design G FIRM David Au SIGNATURE - date	Digitally signed by David Aube DN: C=US, E=daube@designgroup O= The Hartman + Majewski Design Date: 2021.07.16 11:18:45-96:00	TRANSPORTATION D	AIR - date  DEVELOPMENT - date  OPMENT - date	. P	ARKS & RECRE	- date		_		
STATE ON (14221)	David Aube NAME (print) H+M Design G FIRM David Au SIGNATURE - date	Digitally signed by David Aube DN: C=US, E=daube@designgroup O= The Hartman + Majewski Design Date: 2021.07.16 11:18:45-96:00	TRANSPORTATION D  UTILITY DEVEL  CITY ENGIN	AIR - date  DEVELOPMENT - date  OPMENT - date		ARKS & RECRE	- date EMENT - c		_		
STATE ON (14221)	David Aube NAME (print) H+M Design G FIRM David Au SIGNATURE - date	Digitally signed by David Alaba Di C-Lill, E-class-de@lossingroups Di C-Lill, E-class-de@lossingroups District Control Control District 2021 07.16 11.18.44-9000	TRANSPORTATION D  UTILITY DEVEL  CITY ENGIN	NIR - date  DEVELOPMENT - date  OPMENT - date  NEER - date	. P	ARKS & RECRE	- date EMENT - c date	late	_		
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14221)	David Aube NAME (print)  H+M Design G FIRM  David Au  SIGNATURE - date	Digitally signed by David Alaba Di C-Lill, E-class-de@lossingroups Di C-Lill, E-class-de@lossingroups District Control Control District 2021 07.16 11.18.44-9000	TRANSPORTATION D  UTILITY DEVEL  CITY ENGIN	NIR - date  DEVELOPMENT - date  OPMENT - date  NEER - date	. P	ARKS & RECRE	- date EMENT - c date	late			
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