

- 2. ALL WORK DETAILED ON THESE PLANS TO BE PERFORMED, EXCEPT AS OTHERWISE STATED OR PROVIDED HEREON, SHALL BE CONSTRUCTED IN ACCORDANCE WITH CITY OF ALBUQUERQUE INTERIM STANDARD SPECIFICATIONS FOR PUBLIC WORKS CONSTRUCTION, 1985.
- 3. TWO WORKING DAYS PRIOR TO ANY EXCAVATION, CONTRACTOR MUST CONTACT LINE LOCATING SERVICE, 260-1990 (OR DIAL 811 LOCALLY), FOR LOCATION OF EXISTING UTILITIES.
- 4. PRIOR TO CONSTRUCTION, THE CONTRACTOR SHALL EXCAVATE AND VERIFY THE HORIZONTAL AND VERTICAL LOCATIONS OF ALL CONSTRUCTIONS. SHOULD A CONFLICT EXIST, THE CONTRACTOR SHALL NOTIFY THE ENGINEER SO THAT THE CONFLICT CAN BE RESOLVED WITH A MINIMUM AMOUNT OF DELAY.
- 5. BACK FILL COMPACTION SHALL BE ACCORDING TO RESIDENTIAL STREET USE. 6. MAINTENANCE OF THESE FACILITIES SHALL BE THE RESPONSIBILITY OF THE OWNER OF THE PROPERTY SERVED.

#### GENERAL NOTES - SITE PLANS:

1. THE CONTRACTOR SHALL FIELD VERIFY ALL EXISTING CONDITIONS PRIOR TO COMMENCING THIS WORK. IN CASE OF ANY DISCREPANCIES, THE ARCHITECT SHALL BE NOTIFIED IMMEDIATELY AND WORK SHALL NOT COMMENCE WITHOUT APPROVAL FROM THE ARCHITECT. 2. WRITTEN DIMENSIONS OF DRAWINGS SHALL HAVE PRECEDENCE OVER SCALED DIMENSIONS. THE GENERAL CONTRACTOR SHALL VERIFY AND BE RESPONSIBLE FOR ALL DIMENSIONS AND CONDITIONS AT THE BUILDING SITE, AND REPORT ANY DISCREPANCIES TO THE ARCHITECT PRIOR TO PROCEEDING WITH THE WORK.

3. GC AND LIGHTING CONTRACTOR TO ENSURE SITE LIGHTING FIXTURE HEADS HAVE THE CORRECT ORIENTATION. REFER TO PHOTOMETRIC DRAWINGS FOR HEAD PLACEMENT. 4. GC TO COORDINATE SITE SECURITY LAYOUT AND CONDUIT SIZE & LOCATION WITH THE OWNER. 5. GC TO ENSURE PAVING AT ALL EXITS SHALL NOT EXCEED A 2% MAX SLOPE IN ALL

- DIRECTIONS. 6. PAVING SHALL BE LOWER THAN THE BUILDING SLAB BY THE FOLLOWING AMOUNTS UNO:
- · 1/2" O ALL EXIT DOORS
- · 1/2" @ ALL SHOWROOM GLAZING LOCATIONS
- · 1 1/2" @ OVERHEAD DOORS · 1 1/2" OPRE-FAB METAL WALL PANELS

- (2) UNIDIRECTIONAL ACCESSIBLE RAMP
- (3) 6" CURB AND GUTTER (TYP) PER COA STD DWG 2415A
- 4 PARKING LOT LIGHT STANDARD (TYP) FULL CUTOFF LED'S, 25' HIGH
- (5) EXISTING BILLBOARD TO REMAIN
- (6) 6' VALLEY GUTTER PER COA STD DWG 2415B
- (7) MOTORCYCLE SPACE (4'X8' MIN) W/SIGN
- (8) DETENTION POND
- (9) NEW ASPHALT PAVING
- (10) 10' TRANSITION TO EXISTING ASPHALT PAVING
- (11) BICYCLE RACK, SEE SHEET DET-1 FOR DETAIL
- (12) TEMPORARY DESILTING POND
- (13) REMOVE AND REPLACE 230 LF EXISTING GUARD RAIL PER CURRENT NMDOT STANDARDS


- (15) DUMPSTER W/RECYCLING
- 16 PYLON SIGN BASE ELEV=5204.00, TOP ELEV=5227.00
- (17) MONUMENT SIGN
- (18) DIRECTIONAL SIGN
- 19 MULTI DIRECTIONAL ACCESSIBLE RAMP SEE DETAIL SHEET DET-1
- (20) 6' PEDESTRIAN CROSSING SEE DETAIL SHEET DET-1
- (21) NEW 6' CONCRETE SIDEWALK PER COA STD DW 2430
- (22) NEW 5' CONCRETE SIDEWALK PER COA STD DW 2430
- (23) SERVICE AREA PARKING SIGN
- (24) EMPLOYEE PARKING SIGN
- (25) SALES FLOOR PARKING SIGN

REQUIRED:	REQUIRED:	PROVIDED:
SALES FLOOR AREA Section 112-4 Note 12 1 Space per 500 sf	7,237 sf 15 Spaces	18
OFFICE AREA Section 112-4 Note2 3 Spaces per first 500 sf 1 Space per 200sf additional [8452 sf] Total	2,952 sf 3 Spaces 8 Spaces 11 Spaces	16
SERVICE AREA Section 112-4 Note 23 1 Space per Service Bay 1 Space per 300 sf Total	8456 sf 6 Spaces 29 Spaces 35 Spaces	36
TOTAL SPACES REQUIRED CARS	61 Spaces	70
Required minimum number of ACCESSIBLE PARKING SPACES based on combined total for customers and employees.	3 Required	4
NOTE: ALL REMAINING PARKING IS FOR VEHICLE	INVENTORY	365

STORAGE.

Environmental Planning Commission (EPC), dated, and and Conditions in the Official Notification of Decision are satisfied.  Is an Infrastructure List required? ( ) Yes ( ) No If Yes of approved DRC plans with a work order is required for any construction of public improvements.  DRB SITE DEVELOPMENT PLAN SIGNOFF APPROVAL:	
Jeanne Wolfenbarger	Jul 21, 2021
Traffic Engineer, Transportation Division  Blaine Carter  Blaine Carter (10) 21 2021 13:25 MDT)	Date
Water Utility Development	Date
Christina Sandoval (Jul 21, 2021 13:31 MDT)	Jul 21, 202
Parks & Recreation Department	Date
Einest armijo	Jul 21, 202
City Engineer N/A	Date
* Environmental Health Department (conditional) SEE NEXT SHEET	Date
Solid Waste Management	Date
VinstMoulto	Jul 21, 2021
Code Enforcement	Date
Thrailes	Nov 30, 2022
DRB Chairperson, Planning Department	Date

* Environme	ental Health, if necessary	
ENGINEER'S SEAL	AUTO NATION ALBUQUERQUE, NM	DRAWN BY
SITE PLAN FOR BUILDING PERMIT	ALDOGOLITOOL, INVI	DATE
	SITE PLAN FOR	7-20-21
	the contract of the contract o	DRAWING 2021010-SP
PROPERTY OF THE PROPERTY OF TH		SHEET #
7-20-21	ALBOQUERQUE, NEW MEXICO 67109	SP-1
RONALD R. BOHANNAN P.E. #7868	(505) 858-3100 www.tierrawestllc.com	JOB # 2021010

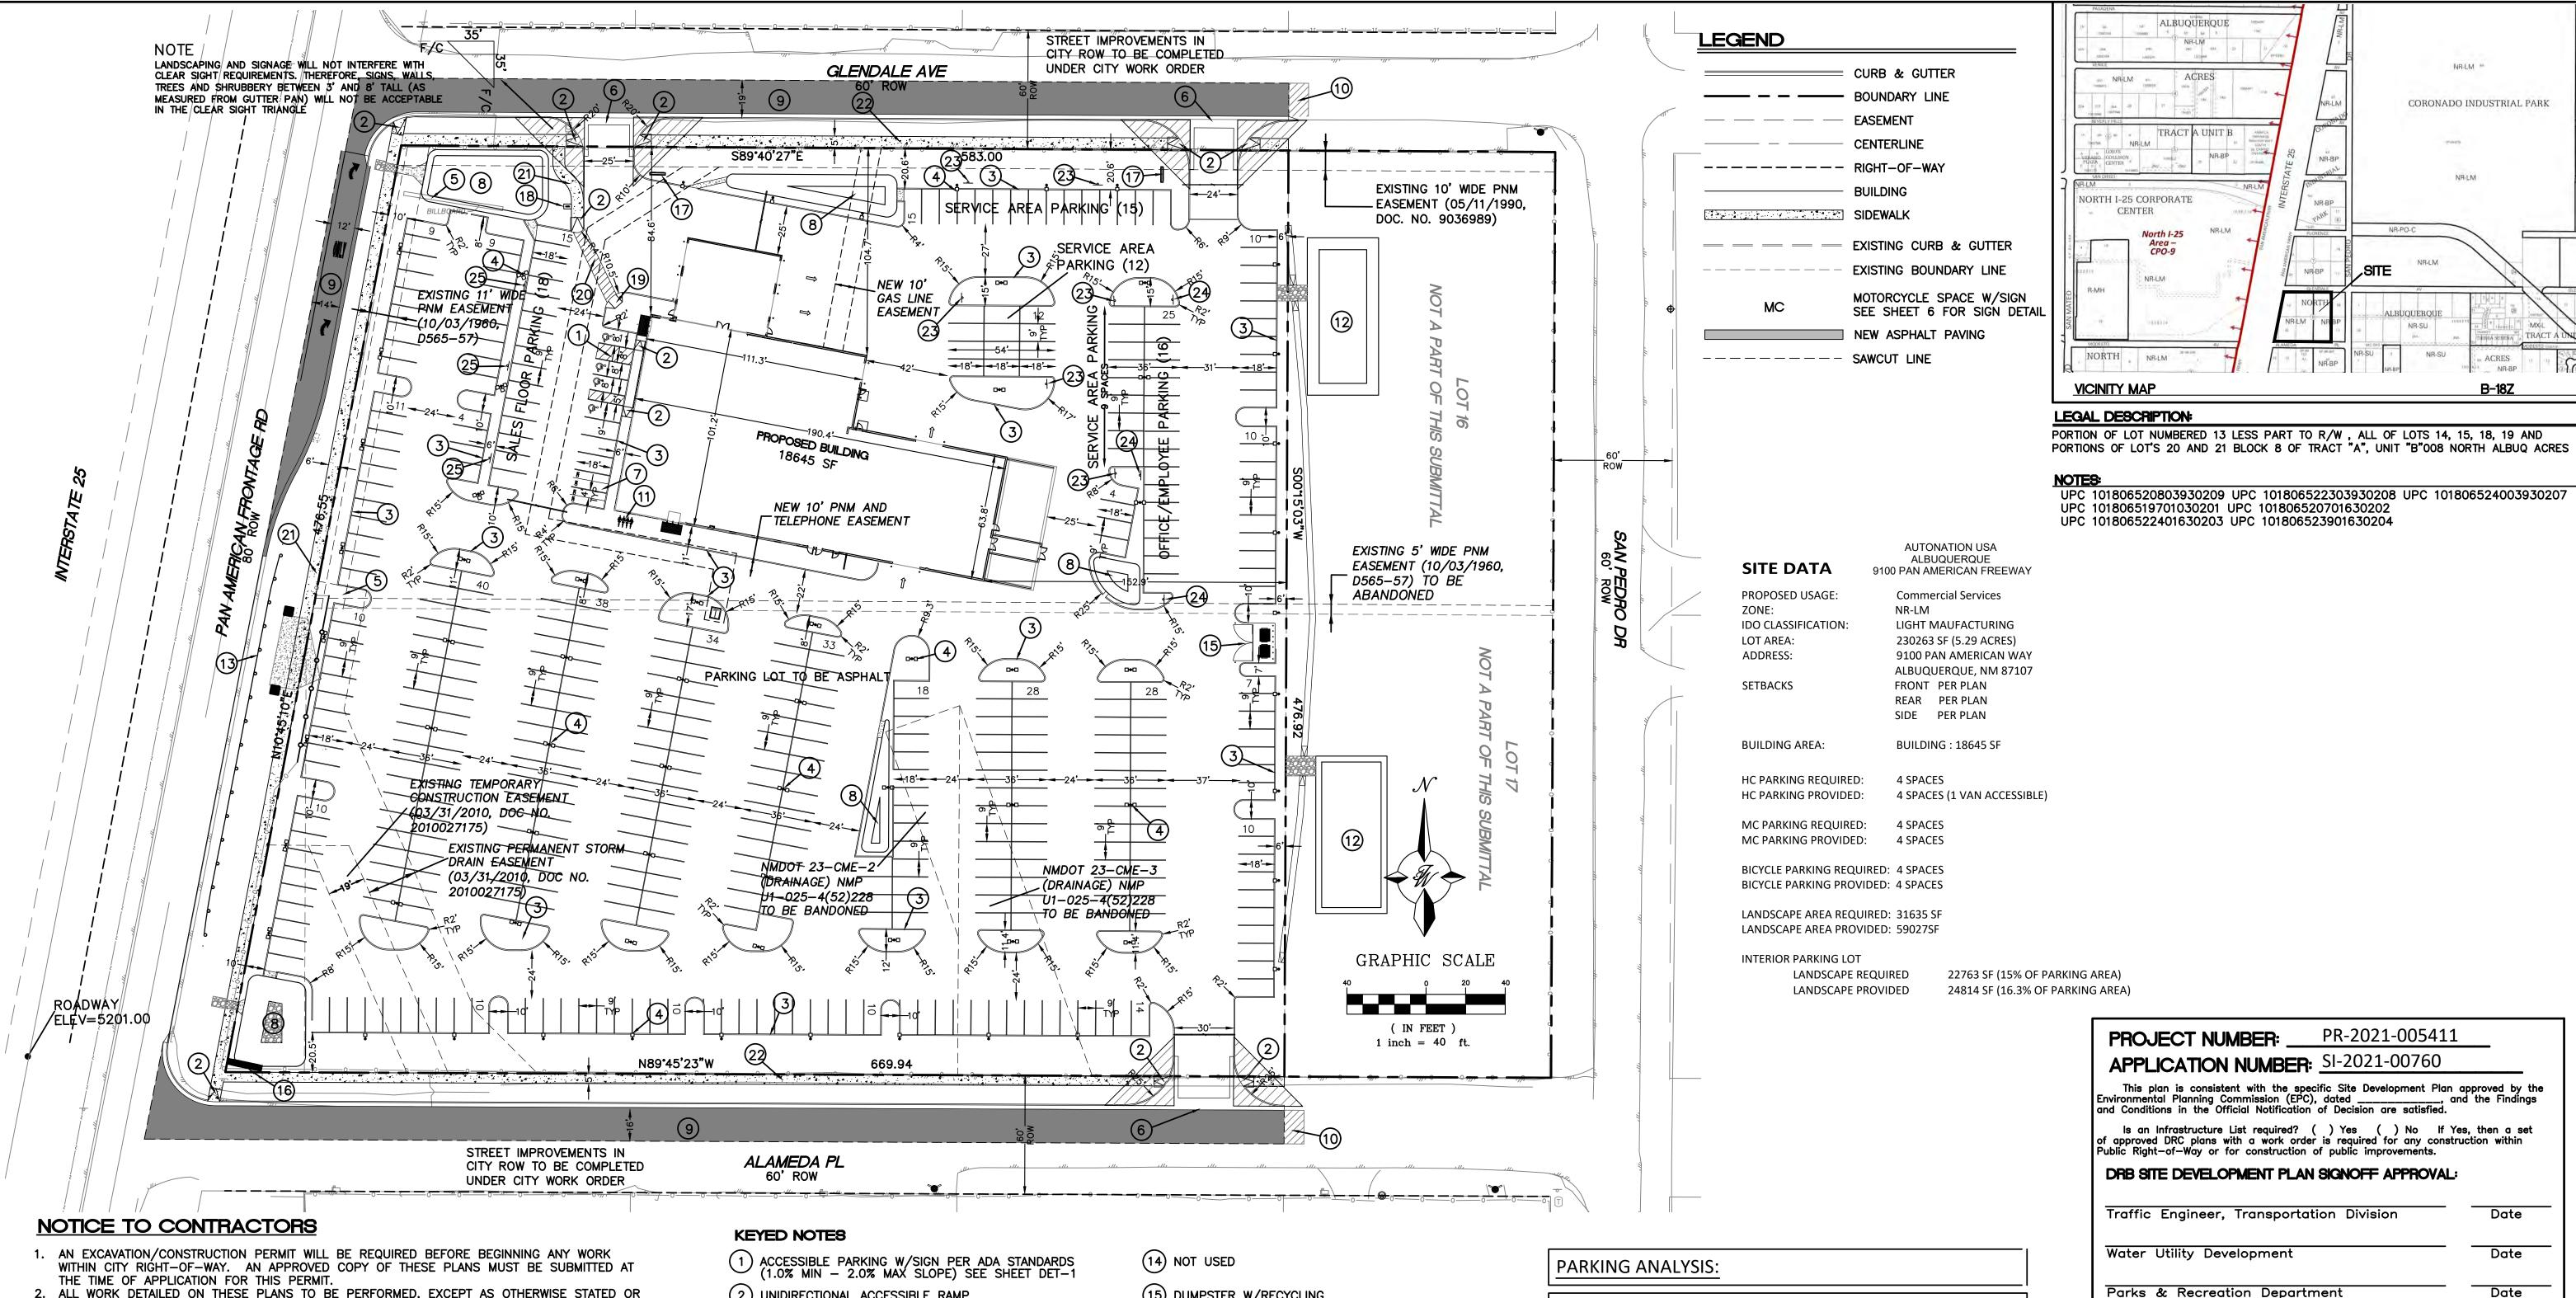

- 2. ALL WORK DETAILED ON THESE PLANS TO BE PERFORMED, EXCEPT AS OTHERWISE STATED OR PROVIDED HEREON, SHALL BE CONSTRUCTED IN ACCORDANCE WITH CITY OF ALBUQUERQUE INTERIM STANDARD SPECIFICATIONS FOR PUBLIC WORKS CONSTRUCTION, 1985.
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- 5. BACK FILL COMPACTION SHALL BE ACCORDING TO RESIDENTIAL STREET USE. 6. MAINTENANCE OF THESE FACILITIES SHALL BE THE RESPONSIBILITY OF THE OWNER OF THE PROPERTY SERVED.

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- ·1/2" @ ALL EXIT DOORS
- •1/2" @ ALL SHOWROOM GLAZING LOCATIONS · 1 1/2" @ OVERHEAD DOORS

·1 1/2" @PRE-FAB METAL WALL PANELS

- (2) UNIDIRECTIONAL ACCESSIBLE RAMP
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- (7) MOTORCYCLE SPACE (4'X8' MIN) W/SIGN
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- (11) BICYCLE RACK, SEE SHEET DET-1 FOR DETAIL
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- (18) DIRECTIONAL SIGN
- 19) MULTI DIRECTIONAL ACCESSIBLE RAMP SEE DETAIL SHEET DET-1
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- (23) SERVICE AREA PARKING SIGN
- (24) EMPLOYEE PARKING SIGN
- (25) SALES FLOOR PARKING SIGN


REFERENCE CHAPTER 112 OFF-STREET PARKING, SECTION 112-4 MINIMUM REQUIREMENT FOR SPACES.						
REQUIRED: REQUIRED: PROVIDED:						
SALES FLOOR AREA Section 112-4 Note 12 1 Space per 500 sf	7,237 sf 15 Spaces	18				
OFFICE AREA Section 112-4 Note2 3 Spaces per first 500 sf 1 Space per 200sf additional [8452 sf] Total	16					
SERVICE AREA Section 112-4 Note 23 1 Space per Service Bay 1 Space per 300 sf Total	8456 sf 6 Spaces 29 Spaces 35 Spaces	36				
TOTAL SPACES REQUIRED CARS 61 Spaces 70						
Required minimum number of ACCESSIBLE PARKING SPACES based on combined total for customers and employees.	3 Required	4				
NOTE: ALL REMAINING PARKING IS FOR VEHICLE STORAGE.	365					


SI-2021-00760	
cific Site Development Pl , dated of Decision are satisfied	
( ) Yes ( ) No I r is required for any col of public improvements.	f Yes, then a set nstruction within
SIGNOFF APPROVA	AL:
ion Division	Date
	Date
nent	Date
	Date
artment (condition	nal) Date
llegos	07-15-21
<del>'</del>	Date
	cific Site Development Pl , dated of Decision are satisfied ( ) Yes ( ) No I r is required for any color public improvements.  SIGNOFF APPROVA  cion Division

CORONADO INDUSTRIAL PARK


NR-BP

ENGINEER'S SEAL	AUTO NATION ALBUQUERQUE, NM	<i>DRAWN BY</i> pm
DR. BOHANA WMEXICO PZ	SITE PLAN FOR	<i>DATE</i> 7-13-21
( ( 7868 ) )	BUILDING PERMIT	<i>DRAWING</i> 2021010—SF
PROPERTY OF THE PROPERTY OF TH		SHEET #
7-13-21	TIERRA WEST, LLC  5571 MIDWAY PARK PL NE ALBUQUERQUE, NEW MEXICO 87109	SP-1
RONALD R. BOHANNAN P.E. #7868	(505) 858-3100 www.tierrawestllc.com	<i>JOB #</i> 2021010

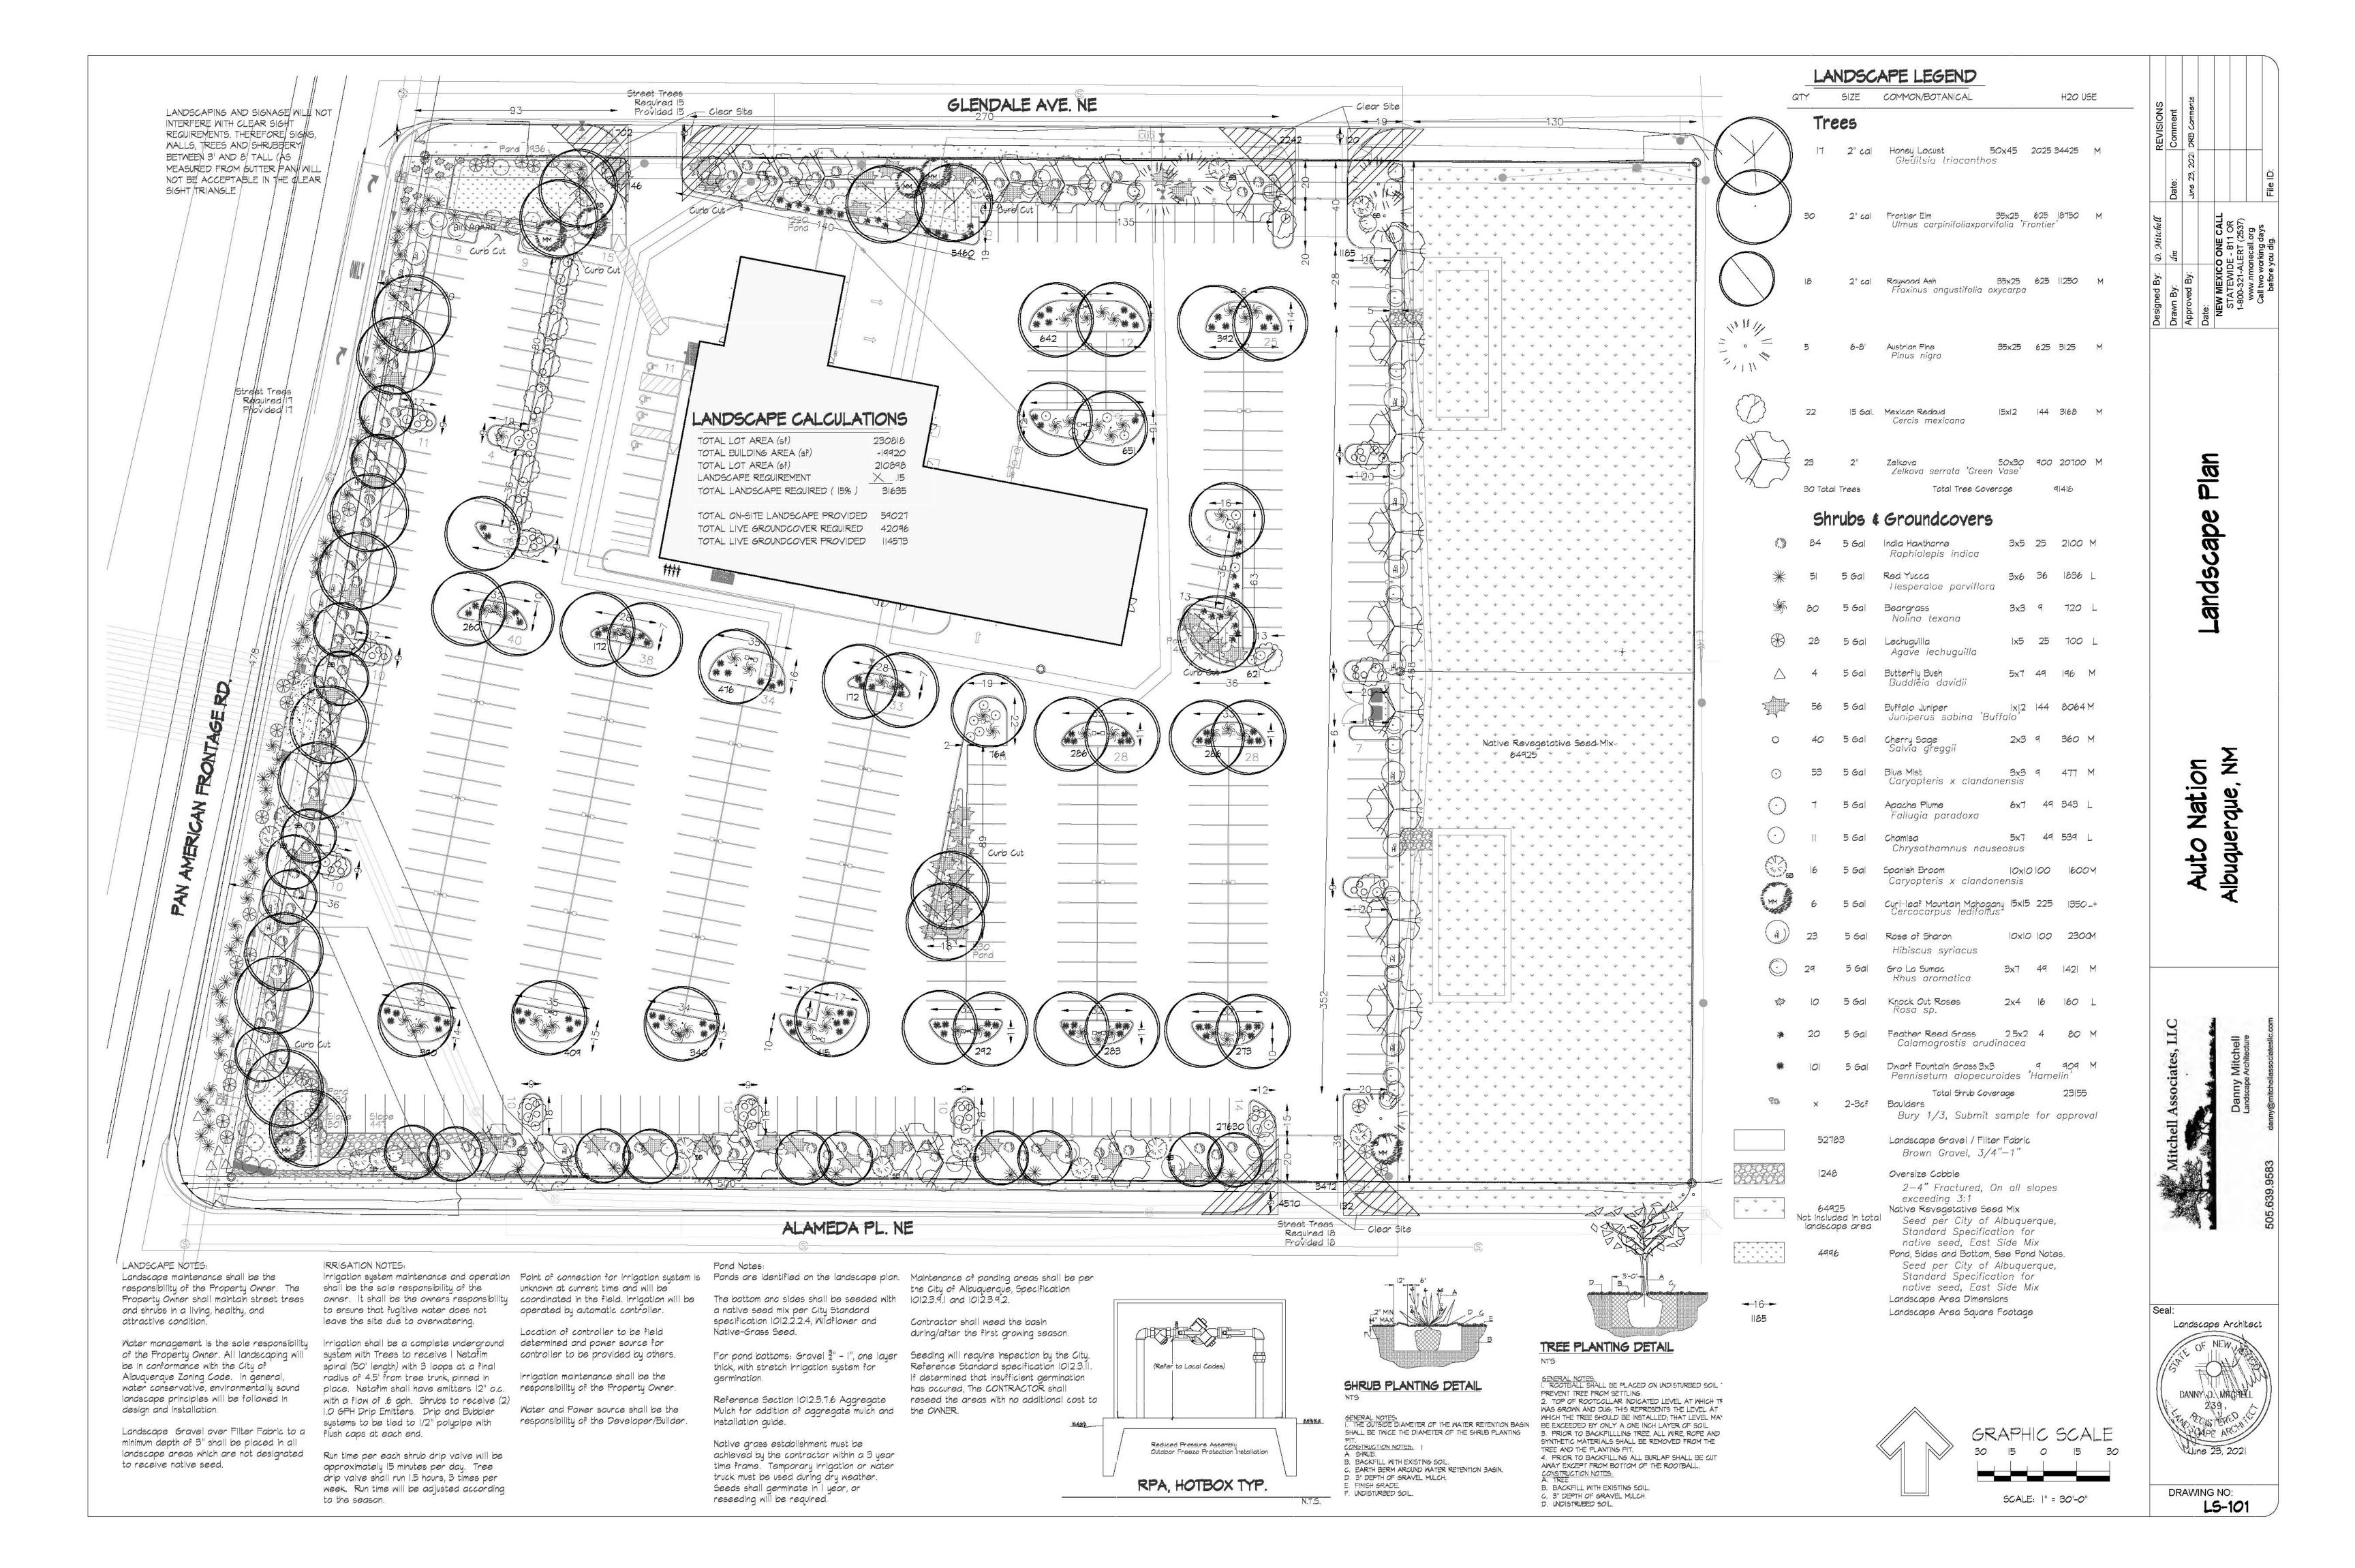

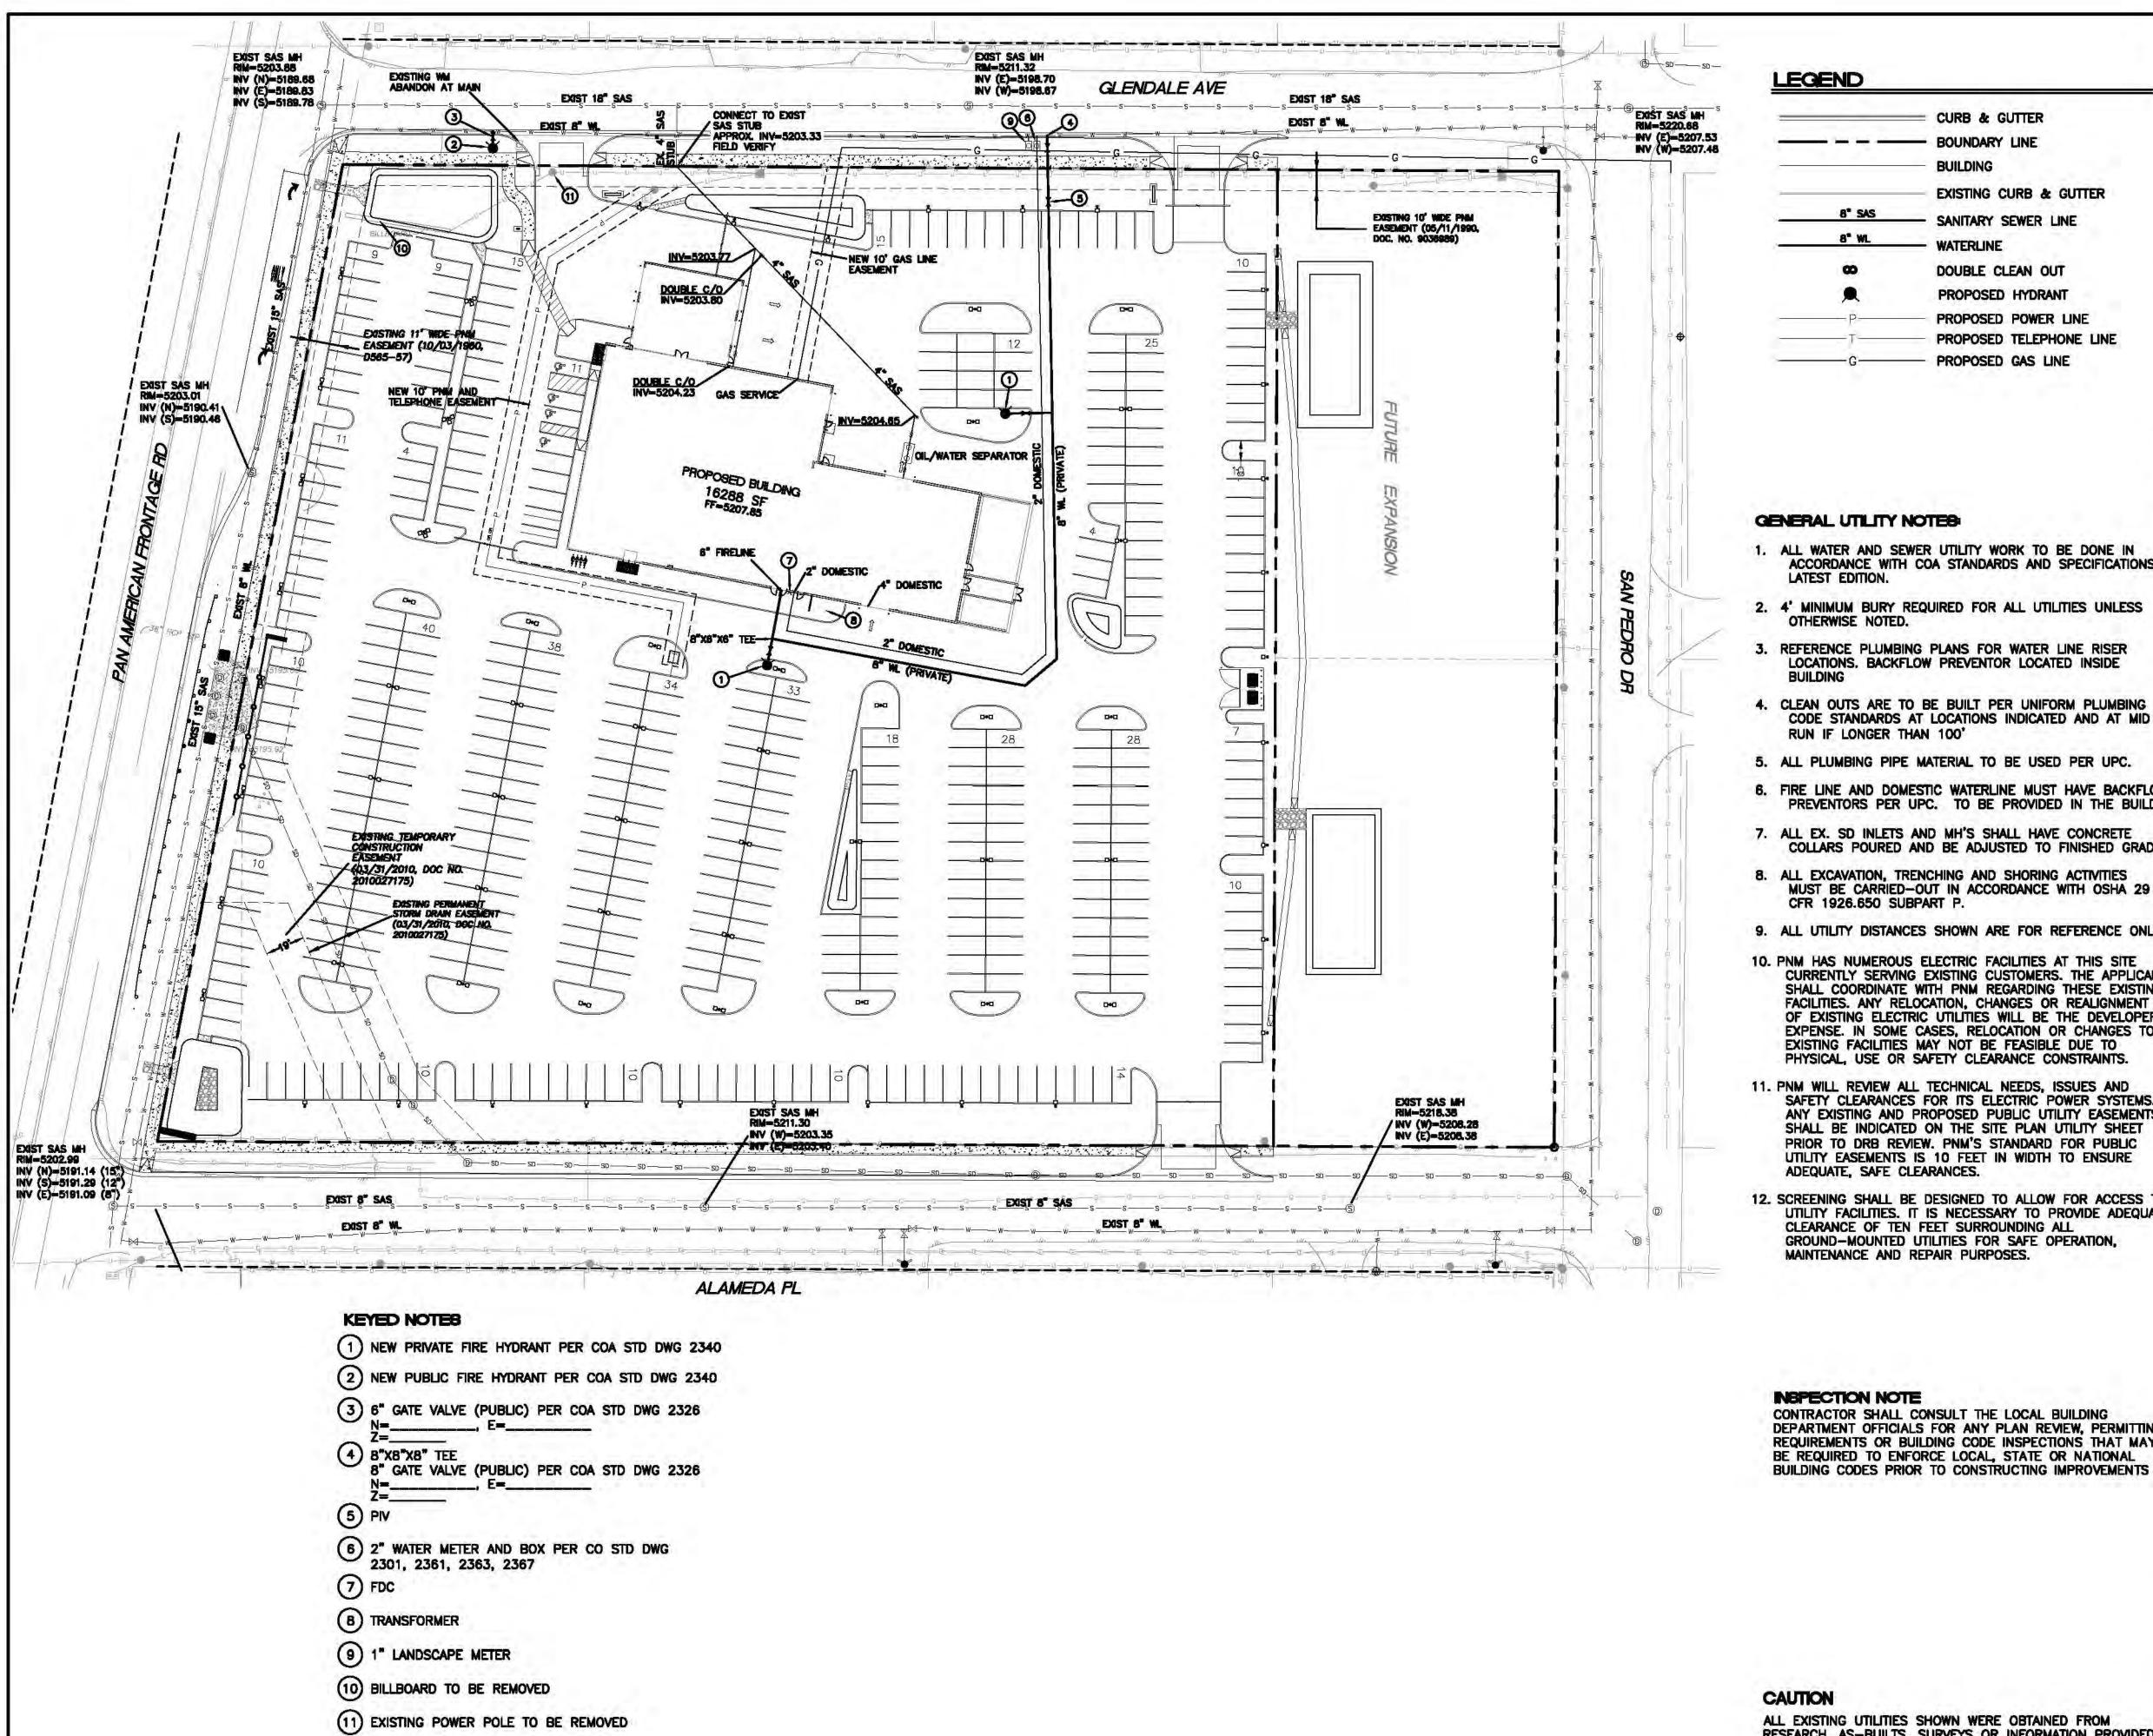

#### LEGEND

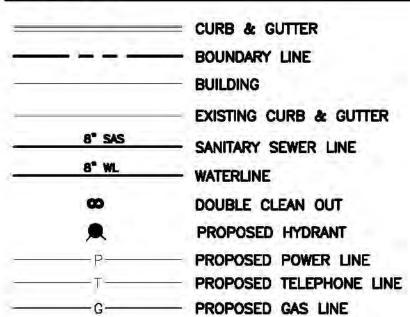

# 8" PVC 26-6371.81-01 8" PVC 26-4392,90-00 12" PVC 26-3824.90-96 8" PVC 26-3824.90-96 290 WATER SHUTOFF PLAN SHUTOFF VALVES 781, 791


THE CONTRACTOR SHALL COORDINATE WITH THE WATER AUTHORITY SEVEN (7) DAYS IN ADVANCE OF PERFORMING WORK THAT WILL AFFECT THE PUBLIC WATER OR SANITARY SEWER INFRASTRUCTURE. WORK REQUIRING SHUTOFF OF FACILITIES DESIGNATED AS MASTER PLAN FACILITIES MUST BE COORDINATED WITH THE WATER AUTHORITY 14 DAYS IN ADVANCE OF PERFORMING SUCH WORK. ONLY WATER AUTHORITY CREWS ARE AUTHORIZED TO OPERATE PUBLIC VALVES. SHUTOFF REQUESTS MUST BE MADE ONLINE AT

HTTP://ABCWUA.ORG/CONTENT/VIEW/463/729/.

#### **GENERAL UTILITY NOTES**

- 1. ALL WATER AND SEWER UTILITY WORK TO BE DONE IN ACCORDANCE WITH COA STANDARDS AND SPECIFICATIONS
- 2. 4' MINIMUM BURY REQUIRED FOR ALL UTILITIES UNLESS OTHERWISE NOTED.
- REFERENCE PLUMBING PLANS FOR WATER LINE RISER LOCATIONS, BACKFLOW PREVENTOR LOCATED INSIDE
- 4. CLEAN OUTS ARE TO BE BUILT PER UNIFORM PLUMBING CODE STANDARDS AT LOCATIONS INDICATED AND AT MID RUN IF LONGER THAN 100'
- 5. ALL PLUMBING PIPE MATERIAL TO BE USED PER UPC.
- 6. FIRE LINE AND DOMESTIC WATERLINE MUST HAVE BACKFLOW PREVENTORS PER UPC. TO BE PROVIDED IN THE BUILDING
- 7. ALL EX. SD INLETS AND MH'S SHALL HAVE CONCRETE COLLARS POURED AND BE ADJUSTED TO FINISHED GRADE.
- 8. ALL EXCAVATION, TRENCHING AND SHORING ACTIVITIES MUST BE CARRIED-OUT IN ACCORDANCE WITH OSHA 29 CFR 1926.650 SUBPART P.
- 9. ALL UTILITY DISTANCES SHOWN ARE FOR REFERENCE ONLY.
- 10. PNM HAS NUMEROUS ELECTRIC FACILITIES AT THIS SITE CURRENTLY SERVING EXISTING CUSTOMERS. THE APPLICANT SHALL COORDINATE WITH PNM REGARDING THESE EXISTING FACILITIES. ANY RELOCATION, CHANGES OR REALIGNMENT OF EXISTING ELECTRIC UTILITIES WILL BE THE DEVELOPER EXPENSE. IN SOME CASES, RELOCATION OR CHANGES TO EXISTING FACILITIES MAY NOT BE FEASIBLE DUE TO PHYSICAL, USE OR SAFETY CLEARANCE CONSTRAINTS.
- 11. PNM WILL REVIEW ALL TECHNICAL NEEDS, ISSUES AND SAFETY CLEARANCES FOR ITS ELECTRIC POWER SYSTEMS. ANY EXISTING AND PROPOSED PUBLIC UTILITY EASEMENTS SHALL BE INDICATED ON THE SITE PLAN UTILITY SHEET PRIOR TO DRB REVIEW. PNM'S STANDARD FOR PUBLIC UTILITY EASEMENTS IS 10 FEET IN WIDTH TO ENSURE ADEQUATE, SAFE CLEARANCES.
- 12. SCREENING SHALL BE DESIGNED TO ALLOW FOR ACCESS TO UTILITY FACILITIES. IT IS NECESSARY TO PROVIDE ADEQUATE CLEARANCE OF TEN FEET SURROUNDING ALL GROUND-MOUNTED UTILITIES FOR SAFE OPERATION, MAINTENANCE AND REPAIR PURPOSES.

#### INSPECTION NOTE CONTRACTOR SHALL CONSULT THE LOCAL BUILDING DEPARTMENT OFFICIALS FOR ANY PLAN REVIEW, PERMITTING REQUIREMENTS OR BUILDING CODE INSPECTIONS THAT MAY BE REQUIRED TO ENFORCE LOCAL, STATE OR NATIONAL

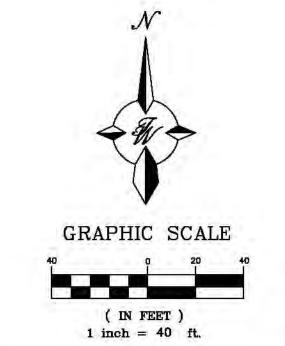

DRAWN BY pm

DATE 6-22-21

DRAWING 2021010-SP

SHEET #

MU-1

JOB #


2021010

#### CAUTION

ALL EXISTING UTILITIES SHOWN WERE OBTAINED FROM RESEARCH, AS-BUILTS, SURVEYS OR INFORMATION PROVIDED BY OTHERS. IT SHALL BE THE SOLE RESPONSIBILITY OF THE CONTRACTOR TO CONDUCT ALL NECESSARY FIELD INVESTIGATIONS PRIOR TO AND INCLUDING ANY EXCAVATION, TO DETERMINE THE ACTUAL LOCATION OF UTILITIES AND OTHER IMPROVEMENTS, PRIOR TO STARTING THE WORK. ANY CHANGES FROM THIS PLAN SHALL BE COORDINATED WITH AND APPROVED BY THE ENGINEER.

ENGINEER'S SEAL	AUTO NATION ALBUQUERQUE, NM
DR. BOHAND ON MEXICO 7868	MASTER UTILITY PLAN
6-22-21	TIERRA WEST, LLC  5571 MIDWAY PARK PL NE ALBUQUERQUE, NEW MEXICO 87109 (505) 858-3100
RONALD R. BOHANNAN P.E. #7868	(505) 858-3100 www.tierrawestllc.com

SEAL	_ (
OR. BOHA	
NATUR BOHANA ON MEXICO Z	N F
P. SIONAL ENGINE	-
ONALES	9 18

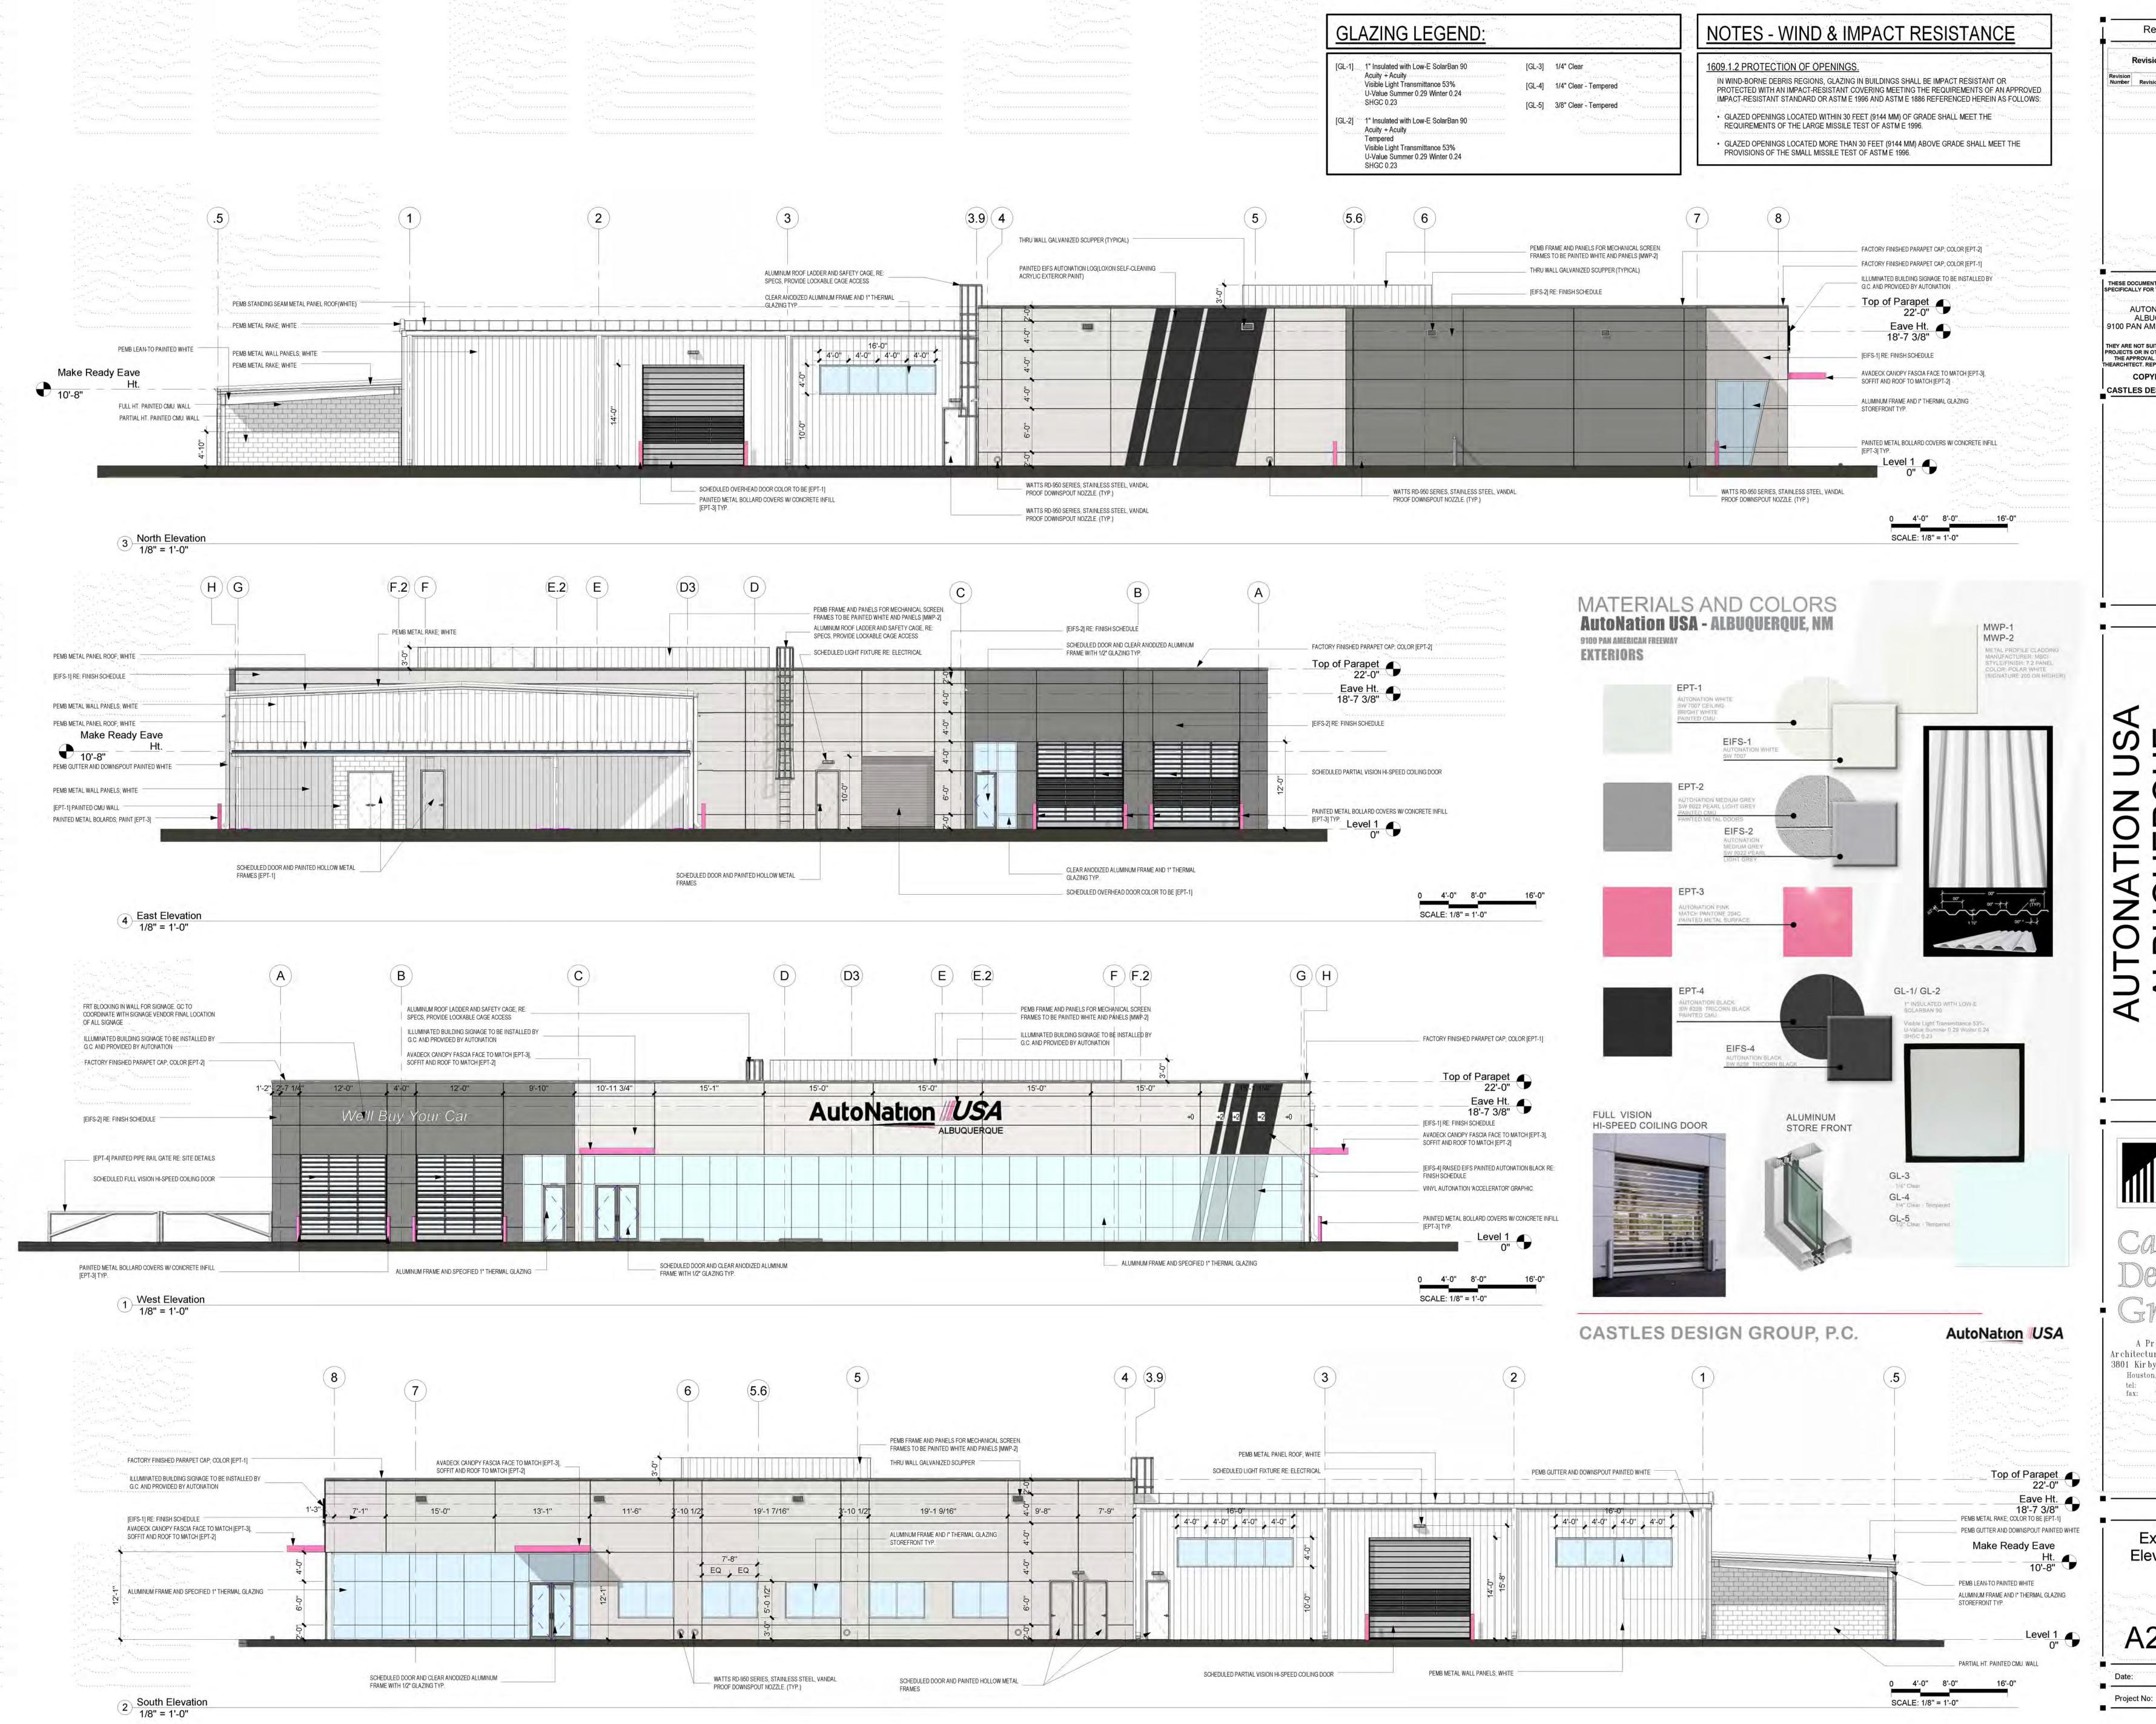

Revision Schedule
Revision Revision Description Revision Date

THESE DOCUMENTS HAVE BEEN PREPARED SPECIFICALLY FOR THE FOLLOWING PROJECT:

AUTONATION USA
ALBUQUERQUE
9100 PAN AMERICAN FREEWAY

THEY ARE NOT SUITABLE FOR USE ON OTHER PROJECTS OR IN OTHER LOCATIONS WITHOUT THE APPROVAL AND PARTICIPATION OF

THE APPROVAL AND PARTICIPATION OF IEARCHITECT. REPRODUCTION IS PROHIBITE COPYRIGHT 2021

CASTLES DESIGN GROUP, P.C.

ALBUQUERQUE

NO PAN AMERICAN FREEWAY


Million Castles Design Group


A Professional
Architectural Corporation
3801 Kirby Dr., Suite 600
Houston, Texas 77098
tel: 713 664 7974
fax: 713 664 9756

Exterior Elevations

A2.11

Project No: 202011-467

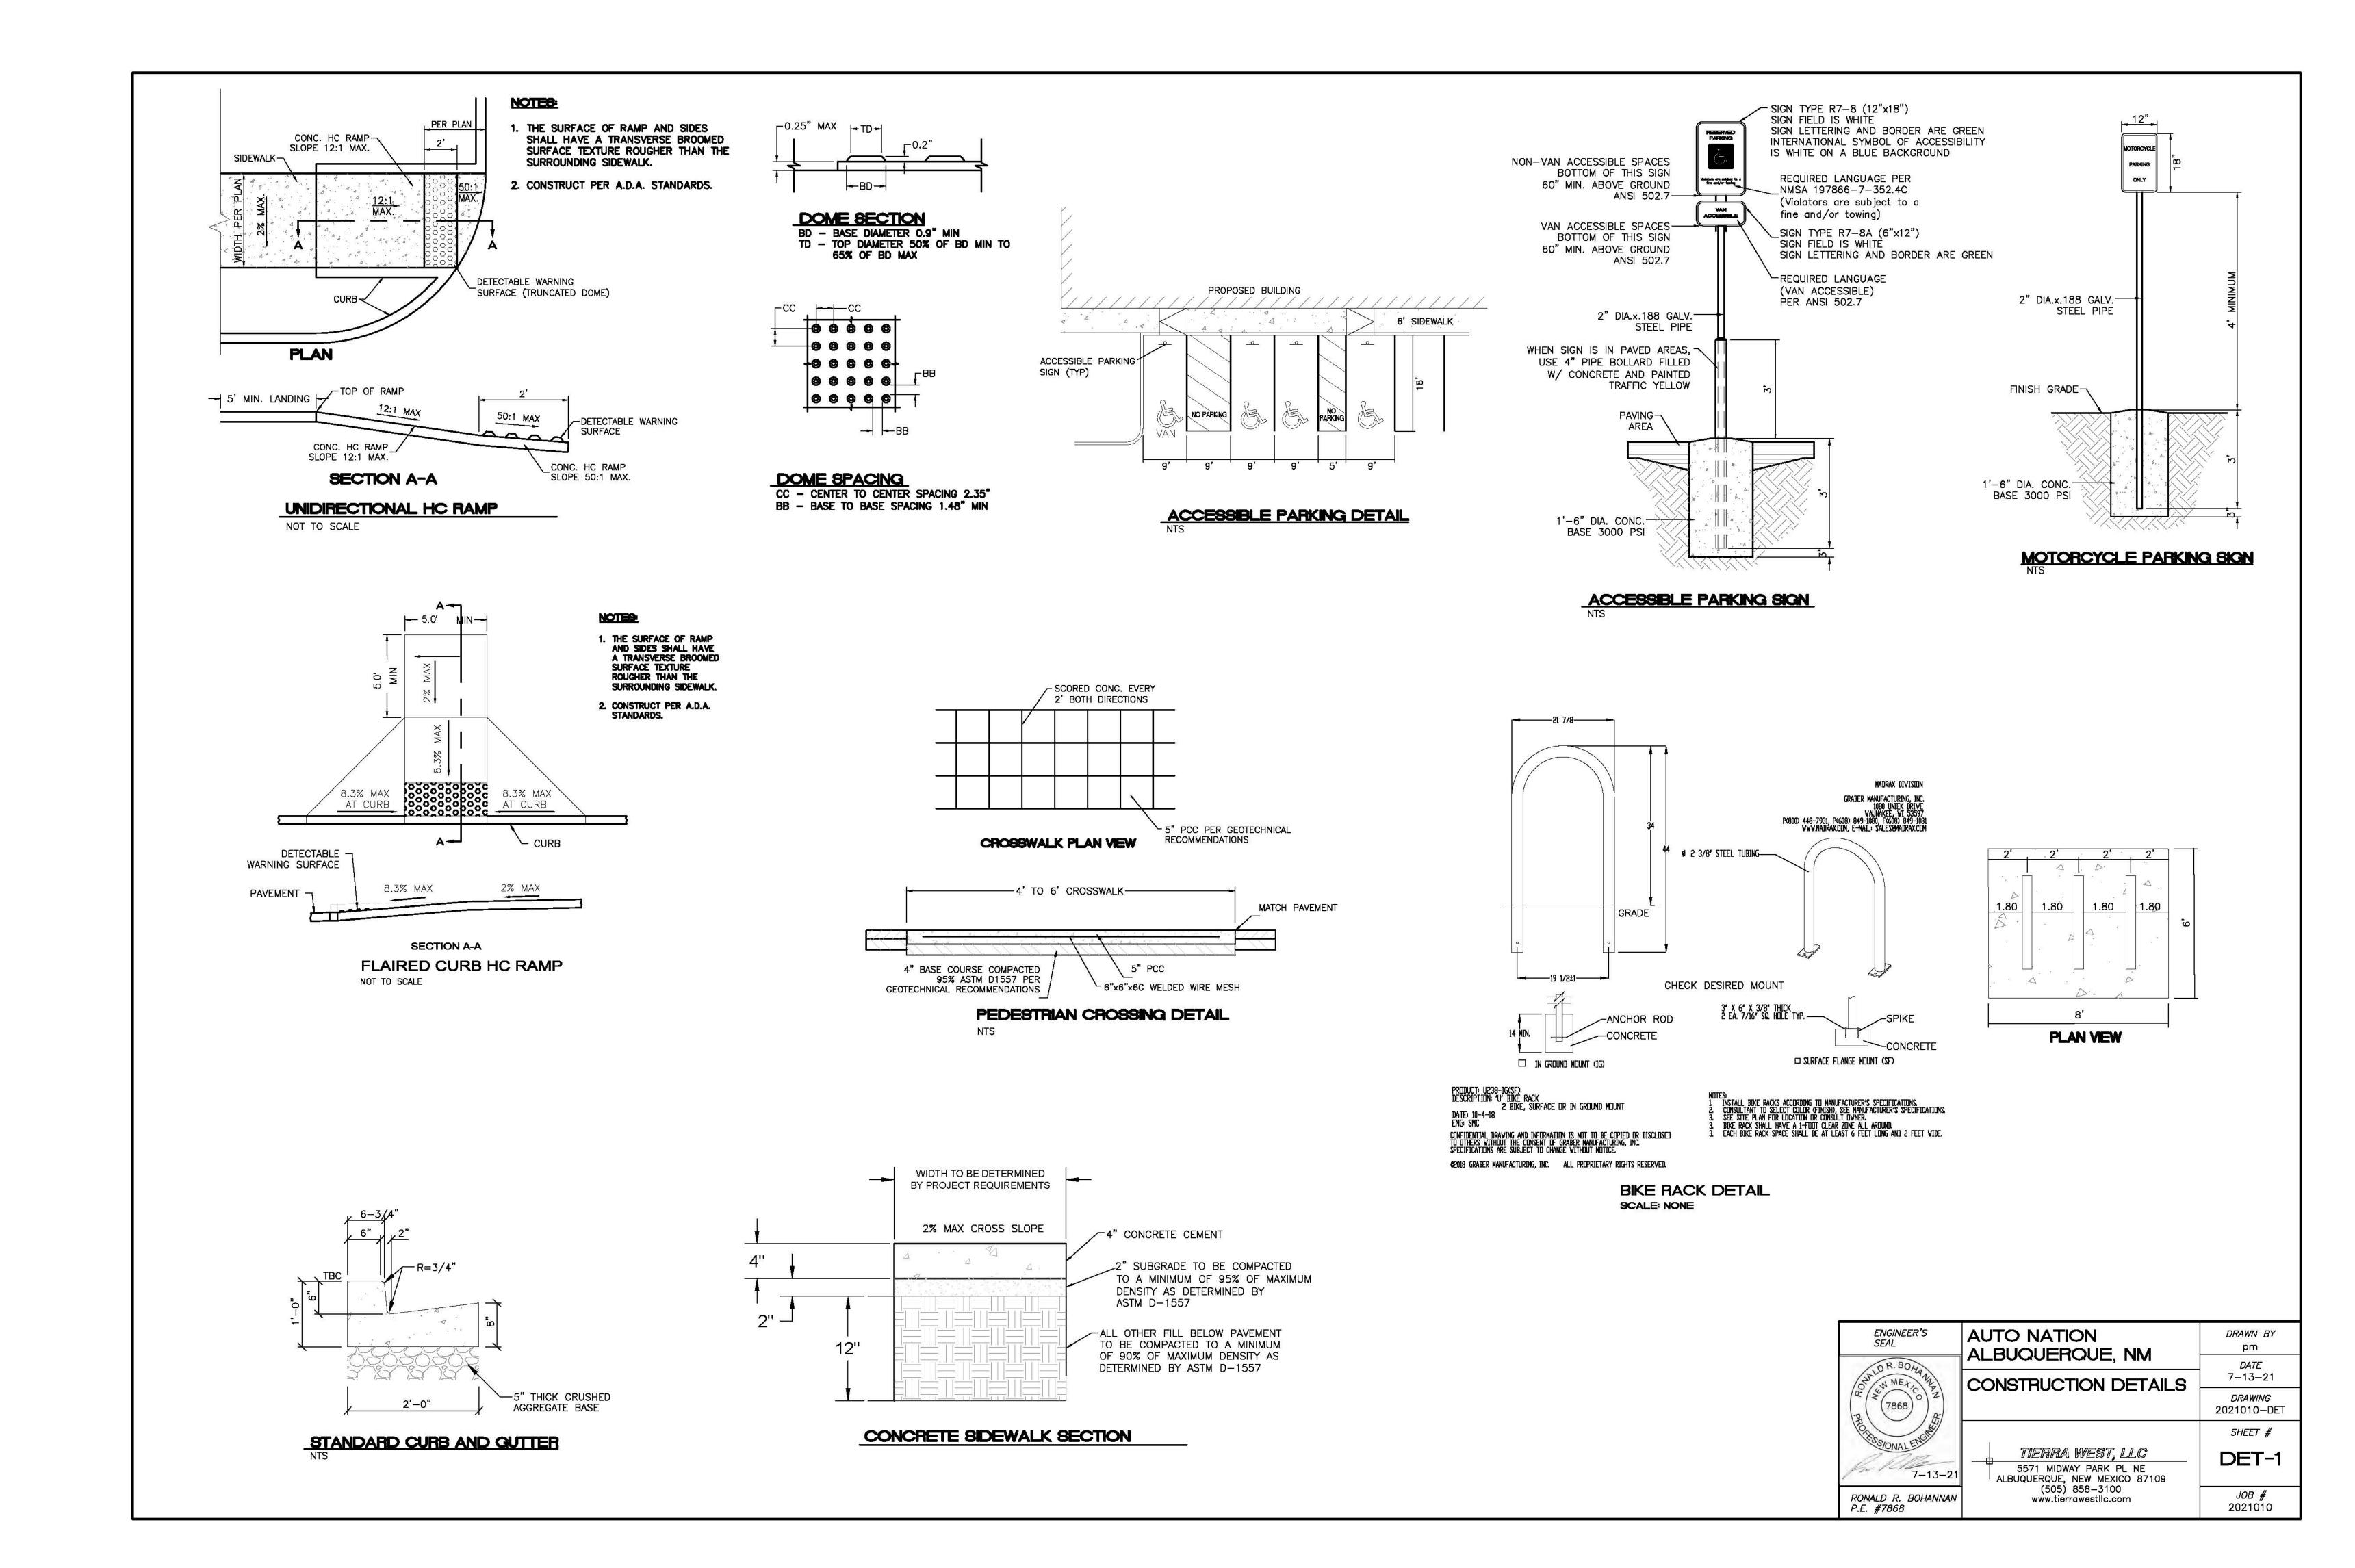

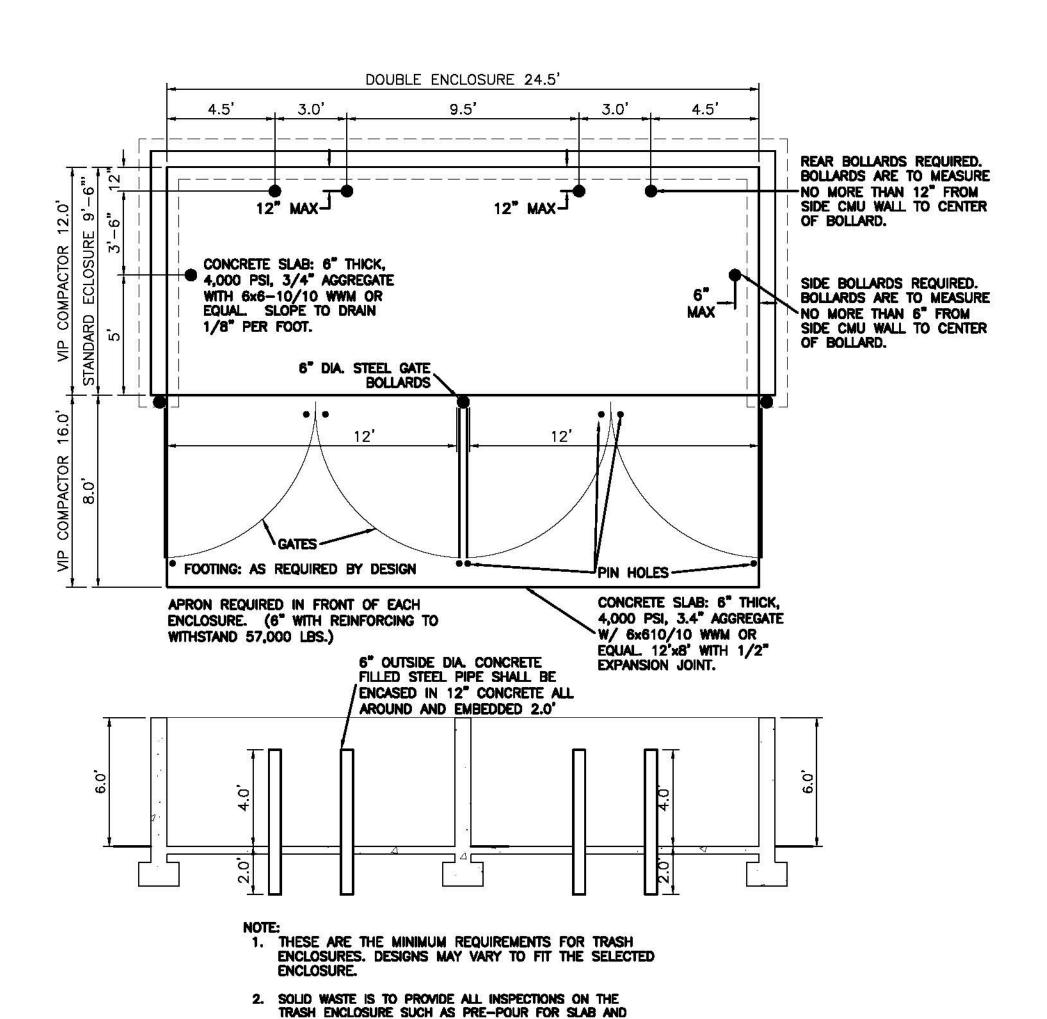


APRON, BOND BEAM, BOLLARD, AND FINAL INSPECTION WILL BE CONTINGENT FOR SOLID WASTE SIGN OFF FOR FINAL CO.


DOUBLE DUMPSTER - ENCLOSURE DETAIL

FINISH GRADE -


SERVICE AREA PARKING SIGN NTS

1'-6" DIA. CONC.-BASE 3000 PSI

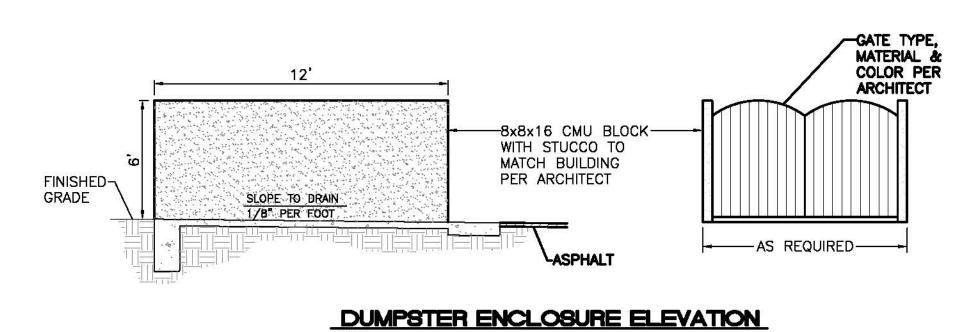

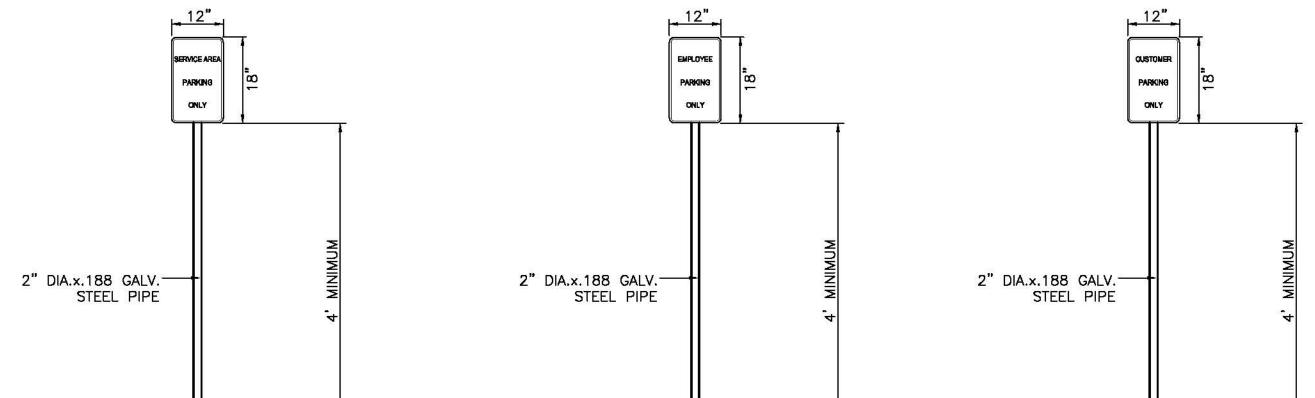

FINISH GRADE -

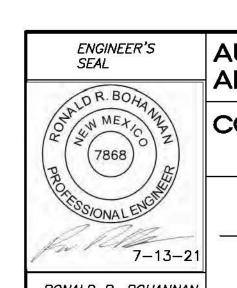

AUTO NATION  ALBUQUERQUE, NM	DRAWN BY	
CONSTRUCTION DETAILS	<i>DATE</i> 7–13–21	
CONSTRICTION DETAILS	<i>DRAWING</i> 2021010-DET	
	90700 S.J. (1987)	

TIERRA WEST, LLC 5571 MIDWAY PARK PL NE ALBUQUERQUE, NEW MEXICO 87109 (505) 858-3100 www.tierrawestllc.com

RONALD R. BOHANNAN P.E. **#**7868

SHEET # DET-2 *JOB #* 2021010

1'-6" DIA. CONC.-BASE 3000 PSI 1'-6" DIA. CONC.-BASE 3000 PSI EMPLOYEE PARKING SIGN NTS CUSTOMER PARKING SIGN

FINISH GRADE



## **Exterior Sign Package**

9100 PAN AMERICAN FREEWAY NE ALBUQUERQUE, NM S.O. #121410

Creaon Date: 05.14.2021

Last Revised: 06.11.2021



National Headquarters: 1077 West Blue Heron Blvd.
West Palm Beach, Florida 33404
800.772.7932
www.atlasbtw.com



### **Exterior Site Plan**

SOI AutoNaon US A C/Ltrs w/DBA FCOs

We'll Buy Your Car Channel Le ers

AutoNaon US A C/Ltrs


AutoNaon US A C/Ltrs

Pylon Sign

Monument Sign

Direconal Sign


Door Hours

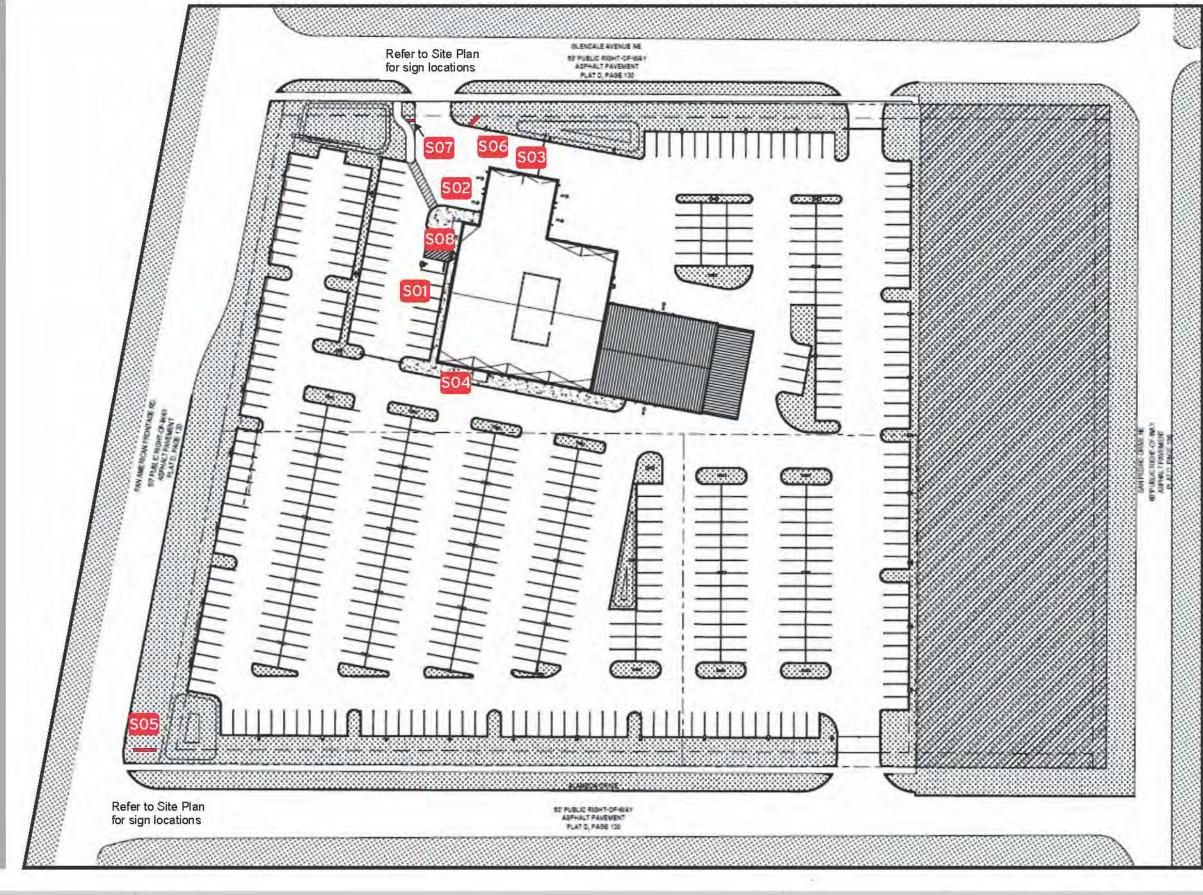



Date: 05/24/2021

Code: 25% of Building Front sq.ft. Building =  $4,182 \text{ s.f.} \times 25\% = 1,405.5 \text{ s.f.}$ 

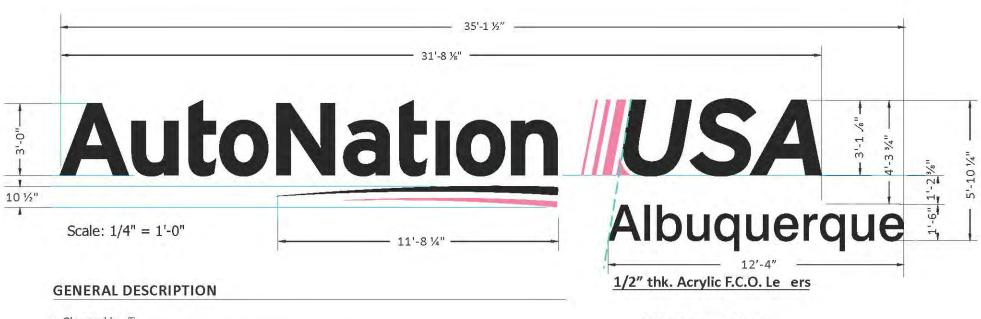

- Channelle 2
- All faces of .177" white (2406) acrylic or polycarbonate
- · Pink elements treated with full-coverage, 1st surface applicaon of tr anslucent pink vinyl (see
- Black elements treated with full-coverage, 1st surface applicaon of perf orated black (see color chart)
- Internal illuminaon of ALL components provided by white LED modules.
- "Denver North" 1/2" thick Acrylic F.C.O. Le
- · All components installed flush to exterior with non-corrosive fasteners (specific hardware TBD)

#### **COLOR SCHEDULE**

All Faces: 2406 White Acrylic or Polycarbonate

Trimcaps #1: Pre-finished Black

Trimcaps #2: Painted to match PMS #204 San

Returns #1: Pre-finished (black) Aluminum

Returns #2: Painted to Match PMS 204 Pink (san)

Vinyl Treatment #1: 3M 3635-222Black Perf. Vinyl

Vinyl Treatment #2: 3M 3630-68 Rose Mauve

1 .177" polycarbonate face

2 letter backs to be .080" aluminum

3 4" returns to be .040" aluminum

4 illumination to be provided by (see below)

6 mounting varies upon location and wall material

7 IP67 rated power supply

8 junction box


9 listed disconnect switch


10 primary power source

11 weep hole cover to be white pre-finished alum.

12 weep hole

This is a generic detail. Mounng det ails and power supply placement will vary.

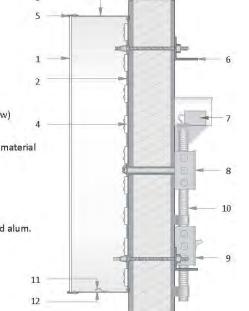

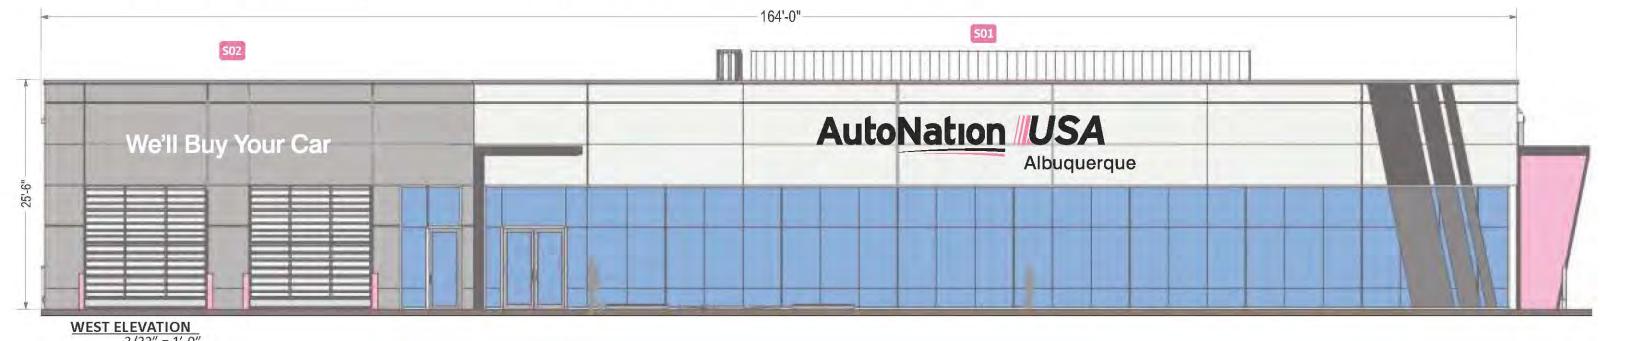



National Headquarters: 1077 West Blue Heron Blvd. West Palm Beach, Florida 33404 www.atlasbtw.com

Revisions:		
06.02.2021 - Pylon Position revision 06.11.2021 - Additional C/ltrs and revisions	- in	
Q6.11.2021 - Additional C/ltrs and revisions	in the second se	
iii.	100	
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	No.	


**AutoNation** 

PM: AQ Drawn By: EVS Address: 9100 PAN AMERICAN FREEWAY NE City State: ALBUQUERQUE, NM

Date: 05.24.2021 | Drawing Number: 121410

Page: 3

Code: 25% of Building Front sq.ft. Building =  $4,182 \text{ s.f. } \times 25\% = 1,405.5 \text{ s.f.}$ 

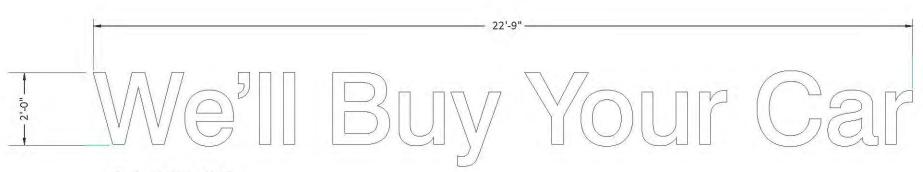

Scale: 3/8" = 1'-0"

#### **GENERAL DESCRIPTION**

- Channel le 🛽
- All faces of .177" white (2406) acrylic or polycarbonate
- Internal illuminaon of ALL components provided by white LED modules.
- All components installed flush to exterior with non-corrosive fasteners (specific hardware TBD)


#### **COLOR SCHEDULE**

All Faces: 2406 White Acrylic or Polycarbonate

Trimcaps #1: Pre-finished Black Returns #1: Pre-finished (black) Aluminum

1 .177" polycarbonate face 2 letter backs to be .080" aluminum 3 4" returns to be .040" aluminum 4 illumination to be provided by (see below) 5 1" trim cap 6 mounting varies upon location and wall material 7 IP67 rated power supply 8 junction box 9 listed disconnect switch 10 primary power source 11 weep hole cover to be white pre-finished alum. 12 weep hole This is a generic detail.

Mounng det ails and power supply placement will vary.

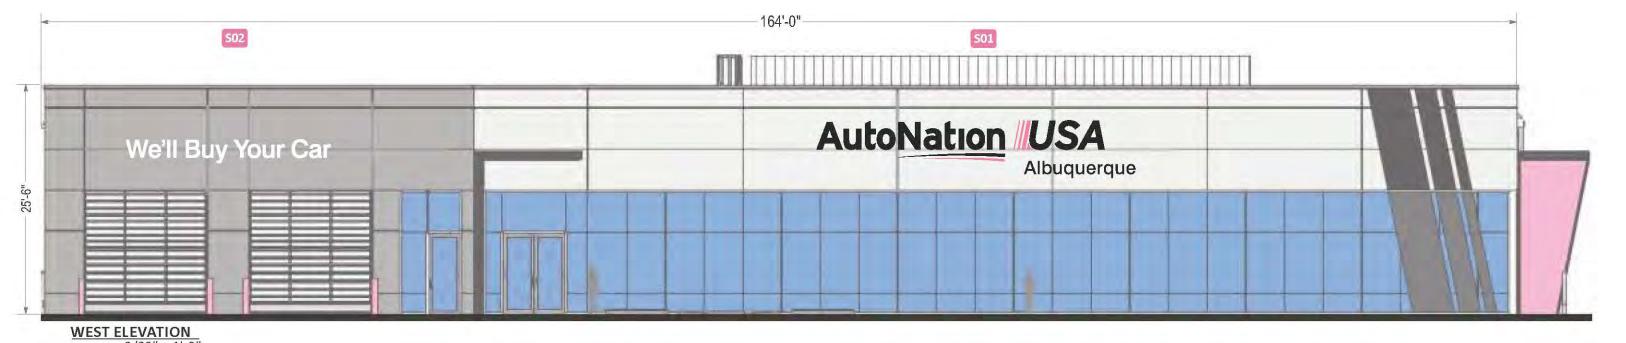



National Headquarters: 1077 West Blue Heron Blvd. West Palm Beach, Florida 33404 800.772.7932 www.atlasbtw.com

Revisions:		
06.02.2021 - Pylon Position revision	100	
Q6.11.2021 - Additional C/ltrs and revisions	100	
iii		
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	100	


**AutoNation** 

PM: AQ Drawn By: EVS Address: 9100 PAN AMERICAN FREEWAY NE

City State: ALBUQUERQUE, NM Date: 05.24.2021 | Drawing Number: 121410

Page: 4


Code: 25% of Building Frontsq.ft. Building = 3,251 s.f. x 25% =812.81 s.f

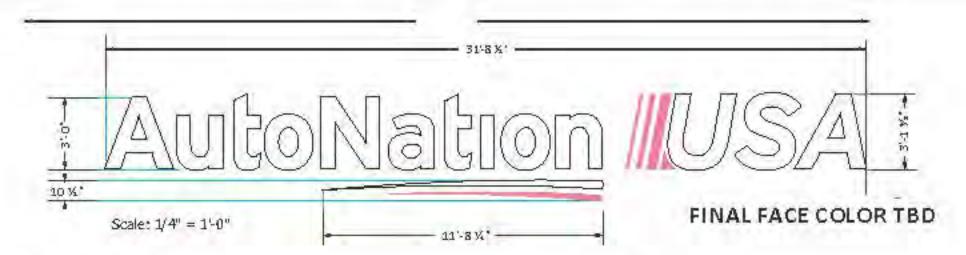

#### GENERAL DESCRIPTION

- · Channelle 8
- . All faces of .177" white (240.6) acrylic or polycarbonate
- Pinkelements treated with full-coverage, 1st surface applicaon of trianslucent pinkvinyl (see color chart)
- Internal illumination of ALL components provided by white LED modules.


#### COLOR SCHEDULE

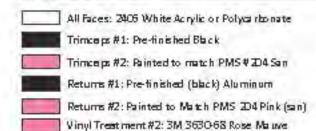

- 1 .177 polyce roo nate face.
- 2 letter back to be .000 a luminum
- 3 4' returns to be .040' eluminum
- 4 illumination to be provided by see below!
- 5 1'trimcep
- 6 mounting veries upon location and well material
- ? 1967 ented powersupply
- 2 junction box.
- 9 listed disconnects witch
- 10 primery powersounce
- 11 weep hole cover to be white pre-finished a lum.
- 12 weep hole

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Mouning declark and some some foreign.

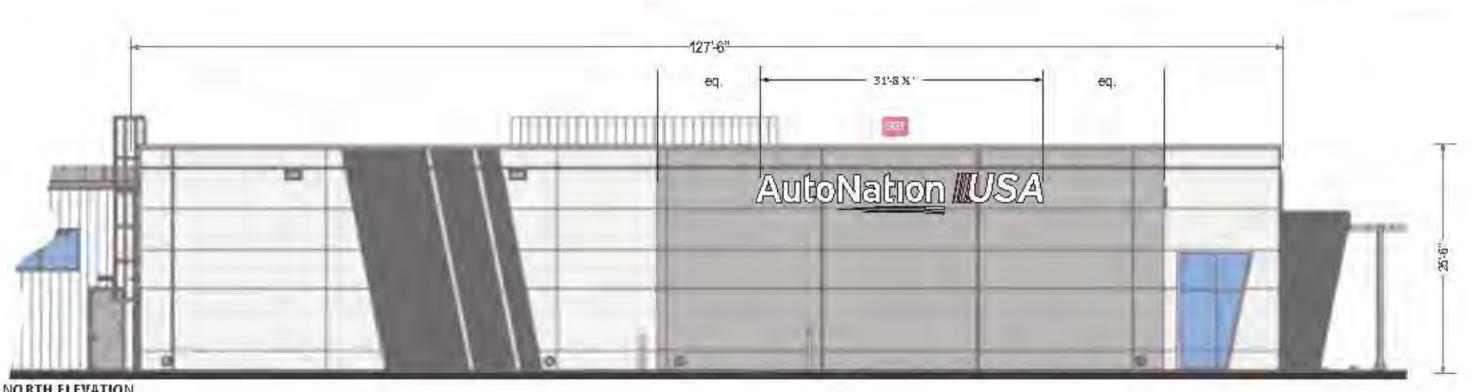

NORTH ELEVATION 3/32" = 1'-0"




National Headquarters: 1077 West Blue Heron Blvd. West Paim Beach, Florida 33404 800.772.7932 www.stlasbtw.com

Revisions:		PM: AQ	Address: 9100 Pa	
05 DZ 2021 - Pylo + Poskie + revseix			1 800,700	Cathinglian 27001
06.11 2021 - Addivional C/ko and evolune	Taylor.		Drawn By: EVS	City State: Albuq
		440	Dato: 05/24/2021	SC # 1214.10
		- A-	Deta: 05/24/2021	20 15 15 14 10

Address: 9100 Pan American Freeway NE Olly State: Albuquerque, NM

Paged 5

Code: 25% of Building Frontsq.ft. Building = 4,182 s.f. x 25% =1,405.5 s.f

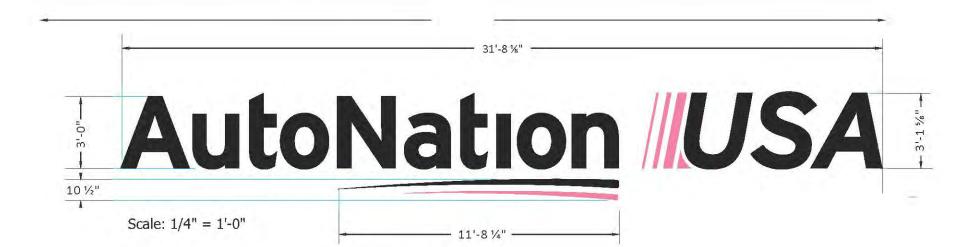

#### **GENERAL DESCRIPTION**

- Channelle 2
- All faces of .177" white (2406) acrylic or polycarbonate
- Pink elements treated with full-coverage, 1st surface application of trianslucent pink vinyl (see color chart)
- Black elements treated with full-coverage, 1st surface applicaon of perforated black (see color chart)
- Internal illuminaon of ALL components provided by white LED modules.
- "Denver North" 1/2" thick Acrylic F.C.O. Le
- · All components installed flush to exterior with non-corrosive fasteners (specific hardware TBD)

#### COLOR SCHEDULE

All Faces: 2406 White Acrylic or Polycarbonate

Trimcaps #1: Pre-finished Black

Trimcaps #2: Painted to match PMS #204 San

Returns #1: Pre-finished (black) Aluminum

Returns #2: Painted to Match PMS 204 Pink (san)

Winyl Treatment #1: 3M 3635-222Black Perf. Vinyl


Vinyl Treatment #2: 3M 3630-68 Rose Mauve


1 .177" polycarbonate face

- 2 letter backs to be .080" aluminum
- 3 4" returns to be .040" aluminum
- 4 illumination to be provided by (see below)
- 5 1" trim car
- 6 mounting varies upon location and wall material
- 7 IP67 rated power supply
- 8 junction box
- 9 listed disconnect switch
- 10 primary power source
- 11 weep hole cover to be white pre-finished alum.
- 12 weep hole

This is a generic detail.

Mounng det ails and power supply placement will vary.

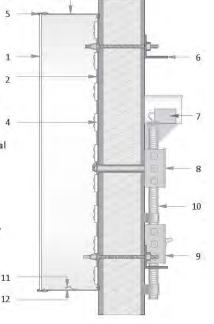

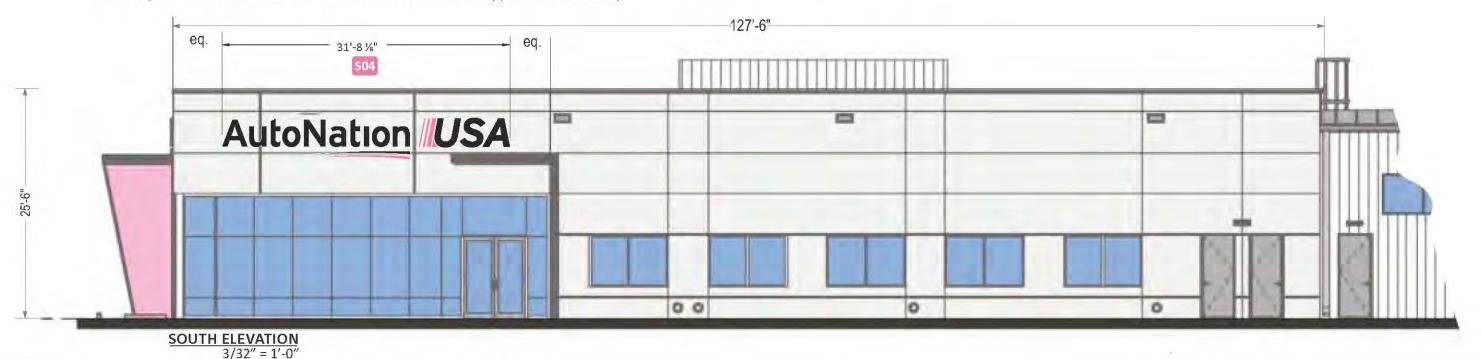

atlas

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 Revisions:

 06.02.2021 - Pylon Position revision
 ...

 06.11.2021 - Additional C/ltrs and revisions
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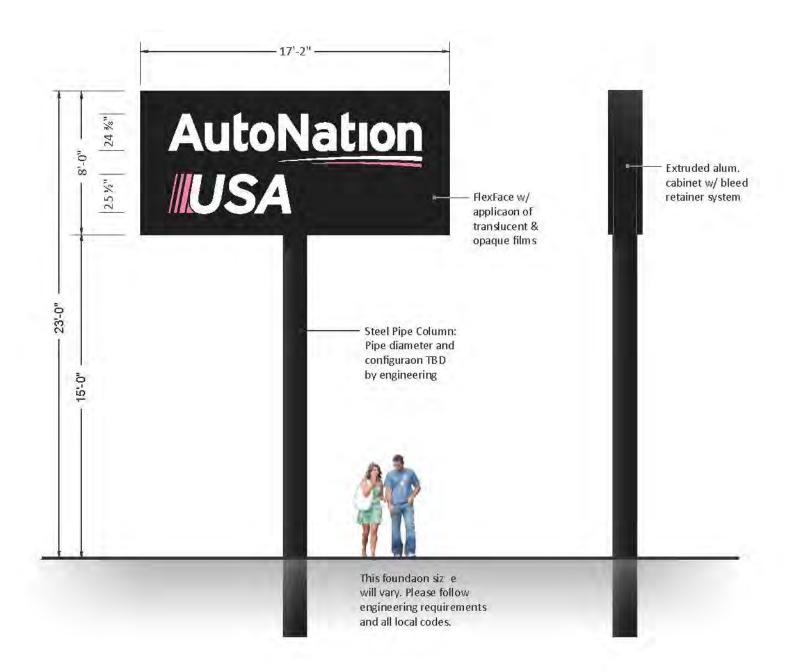
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PM: AQ Address: 9100 Pan American Freeway NE
Drawn By: EVS City State: Albuquerque, NM

Date: 05/24/2021 S.O. # 121410

Page# 6

Code: CODE ALLOWS 1 GROUND SIGN WITH 26' OAH, 300 SQ. FT WITH 5' SETBACK.





#### ANU-P-84 **GENERAL DESCRIPTION**

- . Double face, internally illuminated pylon sign featuring extruded aluminum cabinet with a bleed retainer and flexible faces.
- . Faces of 3M white, flexible substrate with 1st surface applicaon of tr anslucent pink & opaque black films
- Internal illuminaon by whit e LED modules
- · Cabinet installed onto steel column set in concrete foundaon. Siz e of foundaon v aries per local codes and criterea

#### **COLOR SCHEDULE**


Painted MP 923SP Black (san finish) Panaflex White Trans. Substrate 3M 7725-12 Opaque Black Vinyl

3M 3630-68 "Rose Mauve" Trans. Vinyl

White LED Modules (6500K)

#### **SQUARE FOOTAGE**

Proposed Sq. Feet: 7'-0" x 15'-0" = 105 Sq Feet

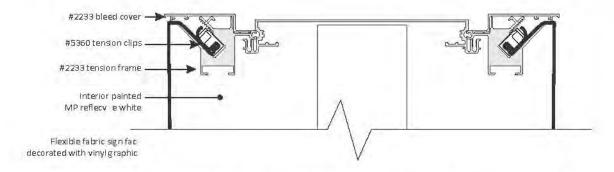

DF Wide Body with Bleed Face Retainer System



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Revisions:		
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06.11.2021 - Additional C/ltrs and revisions	311	A
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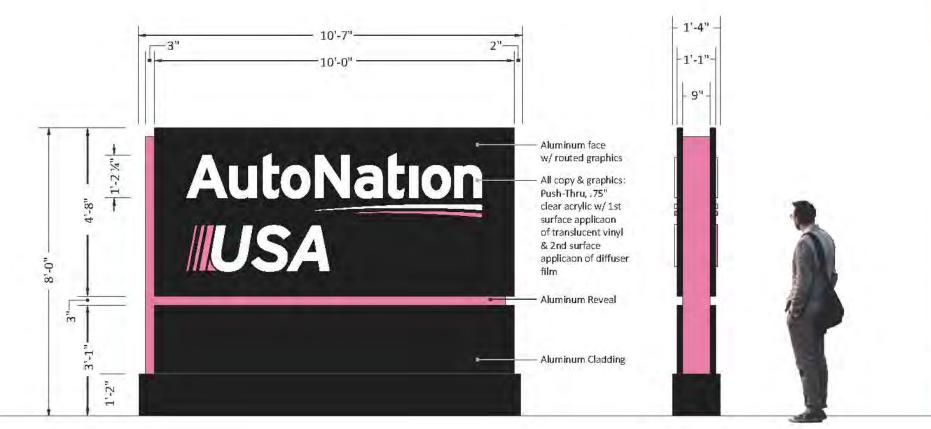
PM: AQ Drawn By: EVS

Address: 9100 PAN AMERICAN FREEWAY NE

City State: ALBUQUERQUE, NM Date: 05.24.2021 Drawing Number: 121410

Page: 7

Code: Only (1) Ground Sign allowed per property. Variance will be required





#### ANU-M-96 **GENERAL DESCRIPTION**

- Double face, internally illuminated monument sign featuring pushed-thru acrylic graphics, and painted aluminum cladding & reveal.
- Faces of aluminum with copy & graphics routed from faces and pushedthru with .750" clear acrylic with 1st surface applicaon of pink & whit e translucent film and a 2nd surface applicaon of diffuser film
- 3" Connuos r eveal to of aluminum & finished with pink enamel
- Internal illuminaon by whit e LED modules
- . Skirt/base and all cladding is of painted aluminum
- Monument sign set in concrete foundaon(s). Siz e of foundaon v aries per
- · local codes and criteria


www.atlasbtw.com

#### **COLOR SCHEDULE**



#### **SQUARE FOOTAGE**

Proposed Sq. Feet: 4'-8" x 10'-0" = 46.67 Sq Feet

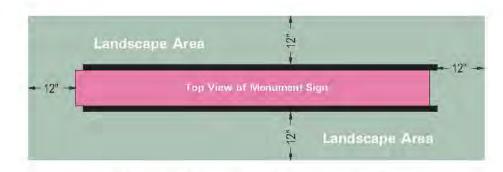

12" Perimeter around base of monument is to be reserved for landscaping - not grass





National Headquarters: 1077 West Blue Heron Blvd.	
West Palm Beach, Florida 33404	
800.772.7932	H
www.atlashtw.com	- 1


	Revisions:
/d.	06.02.2021 - Pylon Position revision
	06.11.2021 - Additional C/Itrs and re

Date: 05/24/2021

Code: CODE HAS NO RESTRICTIONS ON NUMBER, SQUARE FOOTAGE, MAXIMUM HEIGHT OR LOGO.

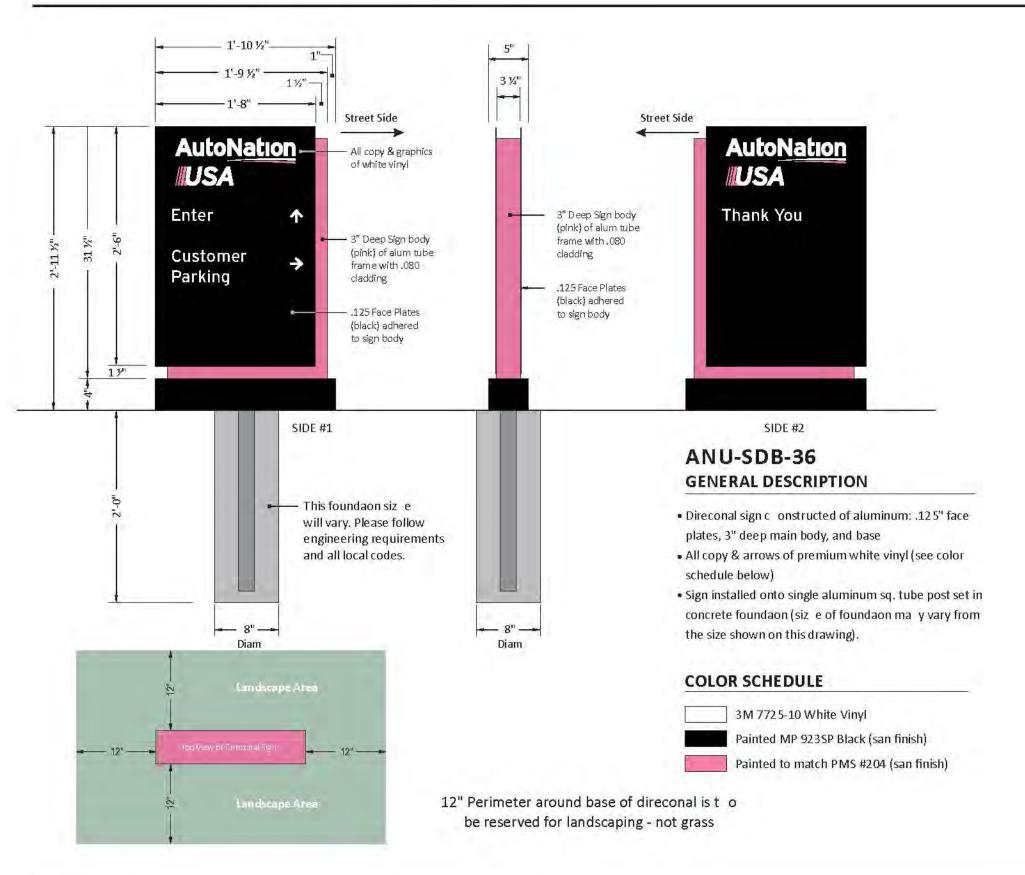

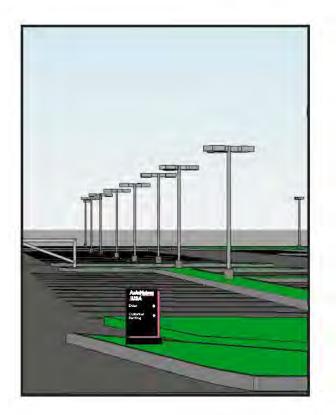

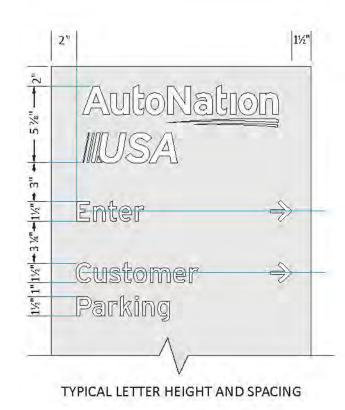



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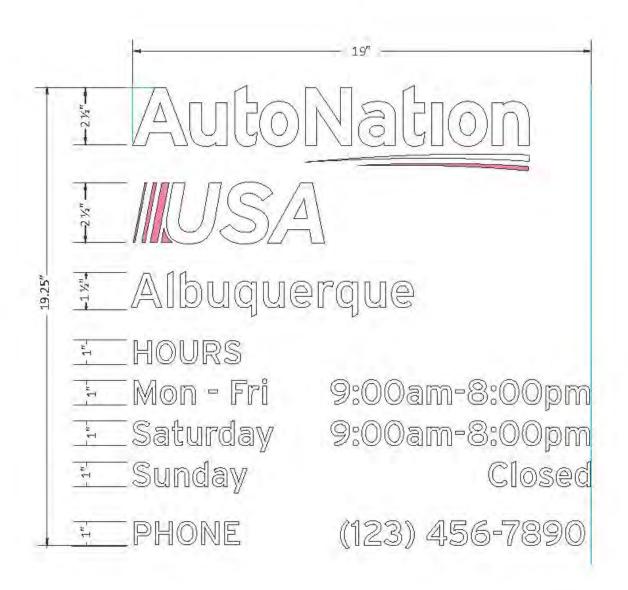
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06.02.2021 - Pylon Position revision	1506	hii	TIVE ACC
06.11.2021 - Additional C/ltrs and revisions	210	6.	Drawn Bv: EVS
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	100	100	Date. 03/24/2021

M: AQ Address: 9100 Pan American Freeway NE

Drawn By: EVS City State: Albuquerque, NM

S.O. # 121410

Page# 9





When there are double-Entry doors, the vinyl graphics will be placed on the right door

Page# 10

#### **General Specificaaons Color Specificaaons** White with pink vinyl copy and numbers 3M 7725-10 White vinyl · Vinyl applied to 1st surface 3M 3630-68 Rose Mauve



Revisions:		PM: AQ	Address: 9100 Pan American Freeway NE			
06.02.2021 - Pylon Position revision		pai	reactions. Stock all Attendant to		circuit i ceway	11
06.11.2021 - Additional C/ltrs and revisions	3/2	P440	Drawn By: EVS	City State: Albuquerque, NM		
		NA.				
	***	Sec	Date: 05/24/2021	S.O. # 121410	Page#	10

## PR-2021-005411\_SI-2021-00760\_Site\_Plan\_Ap proved\_7-21-21

Final Audit Report 2021-11-30

Created: 2021-11-29

By: Jay Rodenbeck (jrodenbeck@cabq.gov)

Status: Signed

Transaction ID: CBJCHBCAABAAdNK5QLsTTcEmDWeWFVj\_Jfr9CHdALKzl

## "PR-2021-005411\_SI-2021-00760\_Site\_Plan\_Approved\_7-21-21 " History

- Document created by Jay Rodenbeck (jrodenbeck@cabq.gov) 2021-11-29 10:46:46 PM GMT- IP address: 143.120.132.106
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- Document e-signed by Jolene Wolfley, CABQ Planning (jwolfley@cabq.gov)

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   2021-11-30 3:50:37 PM GMT