


# DEVELOPMENT REVIEW BOARD SUPPLEMENTAL SUBMITTAL

# (Deadline is Friday at noon unless noted on DRB calendar – late submittals will not be accepted unless approved by the DRB)

PROJECT NO. PR-2021-005411
Application No. SI-2021-00760
TO:  X Planning Department/Chair
<ul> <li>X Hydrology</li> <li>X Transportation Development</li> <li>X ABCWUA</li> <li>X Code Enforcement</li> <li>X Parks &amp; Rec</li> </ul>
*(Please attach this sheet with each collated set for each board member)
NOTE: ELECTRONIC VERSION (ie disk, thumbdrive) is Required. Submittal will not be accepted without.
NOTE. ELECTRONIC VERSION (le disk, thumburive) is required. Submittal will not be accepted without.
DRB SCHEDULED HEARING DATE: 07/14/2021 HEARING DATE OF DEFERRAL: 07/21/2021
SUBMITTAL DESCRIPTION: Revised site plan, sign package and infrastructure list
CONTACT NAME: Jon Niski

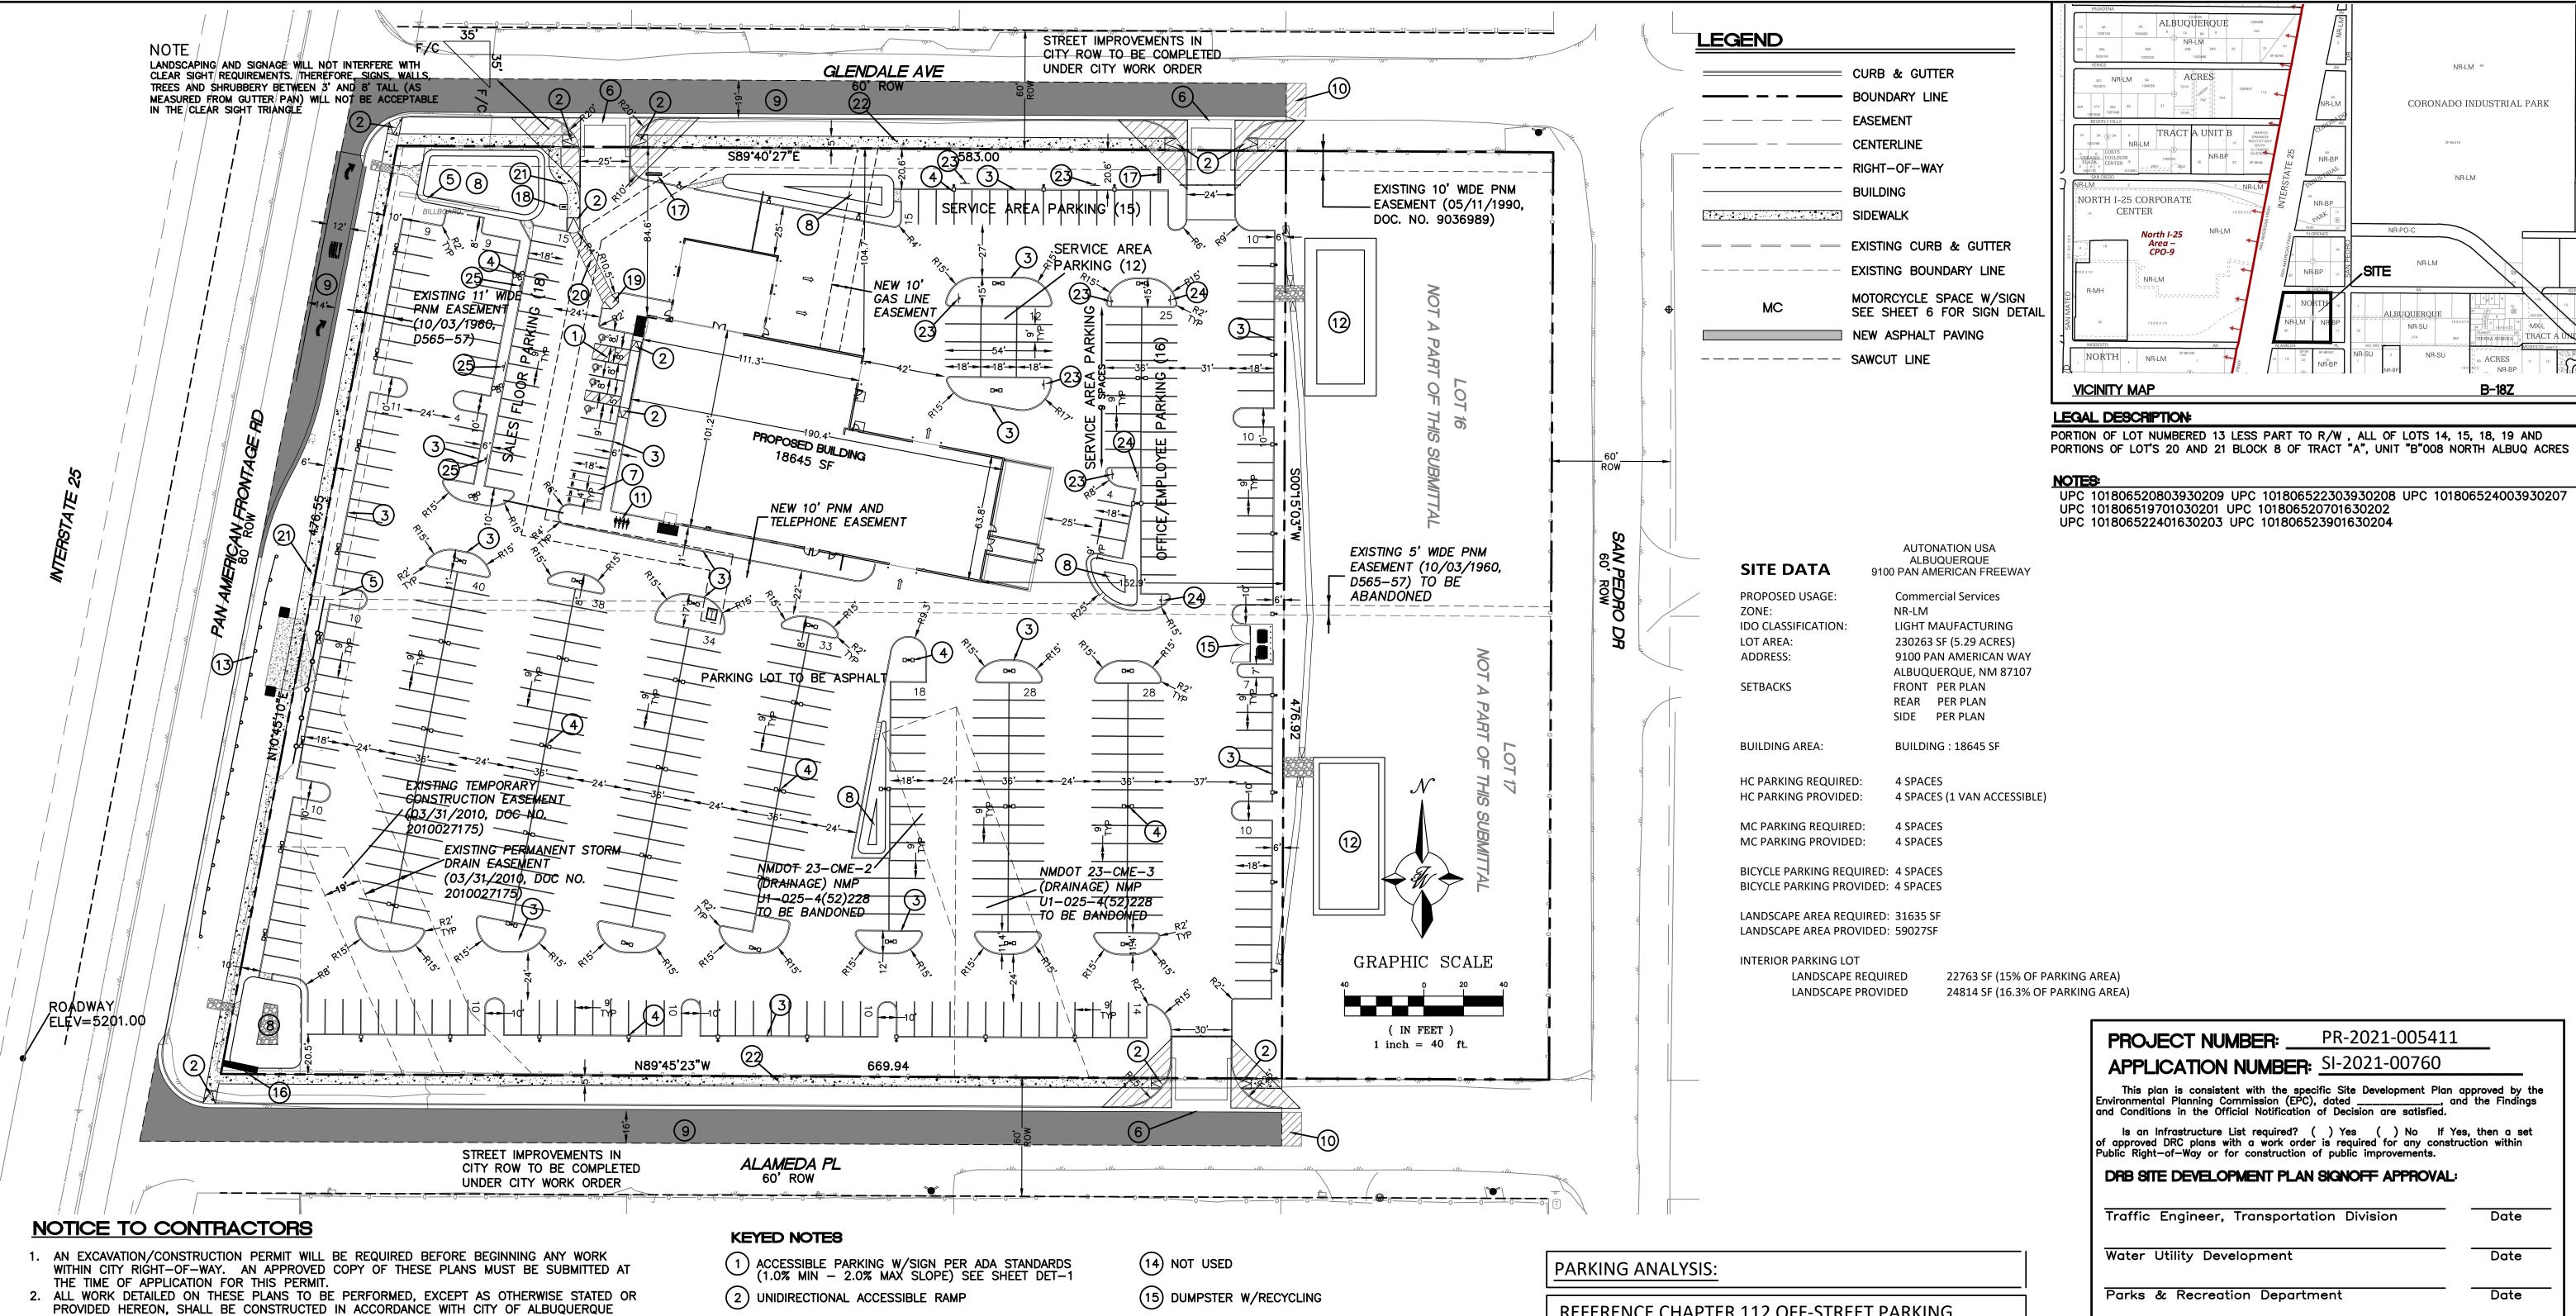

- PROVIDED HEREON, SHALL BE CONSTRUCTED IN ACCORDANCE WITH CITY OF ALBUQUERQUE INTERIM STANDARD SPECIFICATIONS FOR PUBLIC WORKS CONSTRUCTION, 1985.
- 3. TWO WORKING DAYS PRIOR TO ANY EXCAVATION, CONTRACTOR MUST CONTACT LINE LOCATING SERVICE, 260-1990 (OR DIAL 811 LOCALLY), FOR LOCATION OF EXISTING UTILITIES. 4. PRIOR TO CONSTRUCTION, THE CONTRACTOR SHALL EXCAVATE AND VERIFY THE HORIZONTAL
- AND VERTICAL LOCATIONS OF ALL CONSTRUCTIONS. SHOULD A CONFLICT EXIST, THE CONTRACTOR SHALL NOTIFY THE ENGINEER SO THAT THE CONFLICT CAN BE RESOLVED WITH A MINIMUM AMOUNT OF DELAY.
- 5. BACK FILL COMPACTION SHALL BE ACCORDING TO RESIDENTIAL STREET USE. 6. MAINTENANCE OF THESE FACILITIES SHALL BE THE RESPONSIBILITY OF THE OWNER OF THE PROPERTY SERVED.

# GENERAL NOTES - SITE PLANS:

1. THE CONTRACTOR SHALL FIELD VERIFY ALL EXISTING CONDITIONS PRIOR TO COMMENCING THIS WORK. IN CASE OF ANY DISCREPANCIES, THE ARCHITECT SHALL BE NOTIFIED IMMEDIATELY AND WORK SHALL NOT COMMENCE WITHOUT APPROVAL FROM THE ARCHITECT. 2. WRITTEN DIMENSIONS OF DRAWINGS SHALL HAVE PRECEDENCE OVER SCALED DIMENSIONS. THE GENERAL CONTRACTOR SHALL VERIFY AND BE RESPONSIBLE FOR ALL DIMENSIONS AND CONDITIONS AT THE BUILDING SITE, AND REPORT ANY DISCREPANCIES TO THE ARCHITECT PRIOR TO PROCEEDING WITH THE WORK.

3. GC AND LIGHTING CONTRACTOR TO ENSURE SITE LIGHTING FIXTURE HEADS HAVE THE CORRECT ORIENTATION. REFER TO PHOTOMETRIC DRAWINGS FOR HEAD PLACEMENT. 4. GC TO COORDINATE SITE SECURITY LAYOUT AND CONDUIT SIZE & LOCATION WITH THE OWNER. 5. GC TO ENSURE PAVING AT ALL EXITS SHALL NOT EXCEED A 2% MAX SLOPE IN ALL

- DIRECTIONS. 6. PAVING SHALL BE LOWER THAN THE BUILDING SLAB BY THE FOLLOWING AMOUNTS UNO:
- ·1/2" @ ALL EXIT DOORS
- •1/2" @ ALL SHOWROOM GLAZING LOCATIONS
- ·1 1/2" @ OVERHEAD DOORS

· 1 1/2" @PRE-FAB METAL WALL PANELS

- (3) 6" CURB AND GUTTER (TYP) PER COA STD DWG 2415A
- 4 PARKING LOT LIGHT STANDARD (TYP) FULL CUTOFF LED'S, 25' HIGH
- (5) EXISTING BILLBOARD TO REMAIN
- (6) 6' VALLEY GUTTER PER COA STD DWG 2415B
- (7) MOTORCYCLE SPACE (4'X8' MIN) W/SIGN
- (8) DETENTION POND
- (9) NEW ASPHALT PAVING
- (10) 10' TRANSITION TO EXISTING ASPHALT PAVING
- (11) BICYCLE RACK, SEE SHEET DET-1 FOR DETAIL
- (12) TEMPORARY DESILTING POND
- REMOVE AND REPLACE 230 LF EXISTING GUARD RAIL PER CURRENT NMDOT STANDARDS

- PYLON SIGN BASE ELEV=5204.00, TOP ELEV=5227.00
- (17) MONUMENT SIGN
- (18) DIRECTIONAL SIGN
- (19) MULTI DIRECTIONAL ACCESSIBLE RAMP SEE DETAIL SHEET DET-1
- (20) 6' PEDESTRIAN CROSSING SEE DETAIL SHEET DET-1
- (21) NEW 6' CONCRETE SIDEWALK PER COA STD DW 2430
- (22) NEW 5' CONCRETE SIDEWALK PER COA STD DW 2430
- (23) SERVICE AREA PARKING SIGN
- (24) EMPLOYEE PARKING SIGN
- (25) SALES FLOOR PARKING SIGN


SECTION 112-4 MINIMUM RE		•
REQUIRED:	REQUIRED:	PROVIDED:
SALES FLOOR AREA Section 112-4 Note 12 1 Space per 500 sf	7,237 sf 15 Spaces	18
OFFICE AREA Section 112-4 Note2 3 Spaces per first 500 sf 1 Space per 200sf additional [8452 sf] Total	2,952 sf 3 Spaces 8 Spaces 11 Spaces	16
SERVICE AREA Section 112-4 Note 23 1 Space per Service Bay 1 Space per 300 sf Total	8456 sf 6 Spaces 29 Spaces 35 Spaces	36
TOTAL SPACES REQUIRED CARS	61 Spaces	70
Required minimum number of ACCESSIBLE PARKING SPACES based on combined total for customers and employees.	3 Required	4
NOTE: ALL REMAINING PARKING IS FOR VEHICLE STORAGE.	INVENTORY	365


PROJECT NUMBER:		
APPLICATION NUMBER	: SI-2021-00760	
This plan is consistent with the sp invironmental Planning Commission (EPC and Conditions in the Official Notification	ecific Site Development Plan app C), dated, and n of Decision are satisfied.	proved by th the Findings
Is an Infrastructure List required? If approved DRC plans with a work ord Oublic Right—of—Way or for construction	( ) Yes ( ) No If Yes, er is required for any construct of public improvements.	then a set ion within
DRB SITE DEVELOPMENT PLA	N SIGNOFF APPROVAL:	
Traffic Engineer, Transporto	ation Division	Date
Water Utility Development		Date
Parks & Recreation Depart	ment	Date
City Engineer		Date
City Engineer  * Environmental Health Dep	partment (conditional)	
* Environmental Health Dep	•	
	•	Date

CORONADO INDUSTRIAL PARK

NR-BP

ENGINEER'S SEAL	AUTO NATION ALBUQUERQUE, NM	<i>DRAWN BY</i> pm
OR. BOHANA ON METICO Z	SITE PLAN FOR	<i>DATE</i> 7-13-21
( (7868 ) )	BUILDING PERMIT	<i>DRAWING</i> 2021010—SF
PROTEIN OF THE STONAL ENGINEER		SHEET #
7-13-21	5571 MIDWAY PARK PL NE ALBUQUERQUE, NEW MEXICO 87109	SP-1
RONALD R. BOHANNAN P.E. #7868	(505) 858-3100 www.tierrawestllc.com	<i>JOB #</i> 2021010

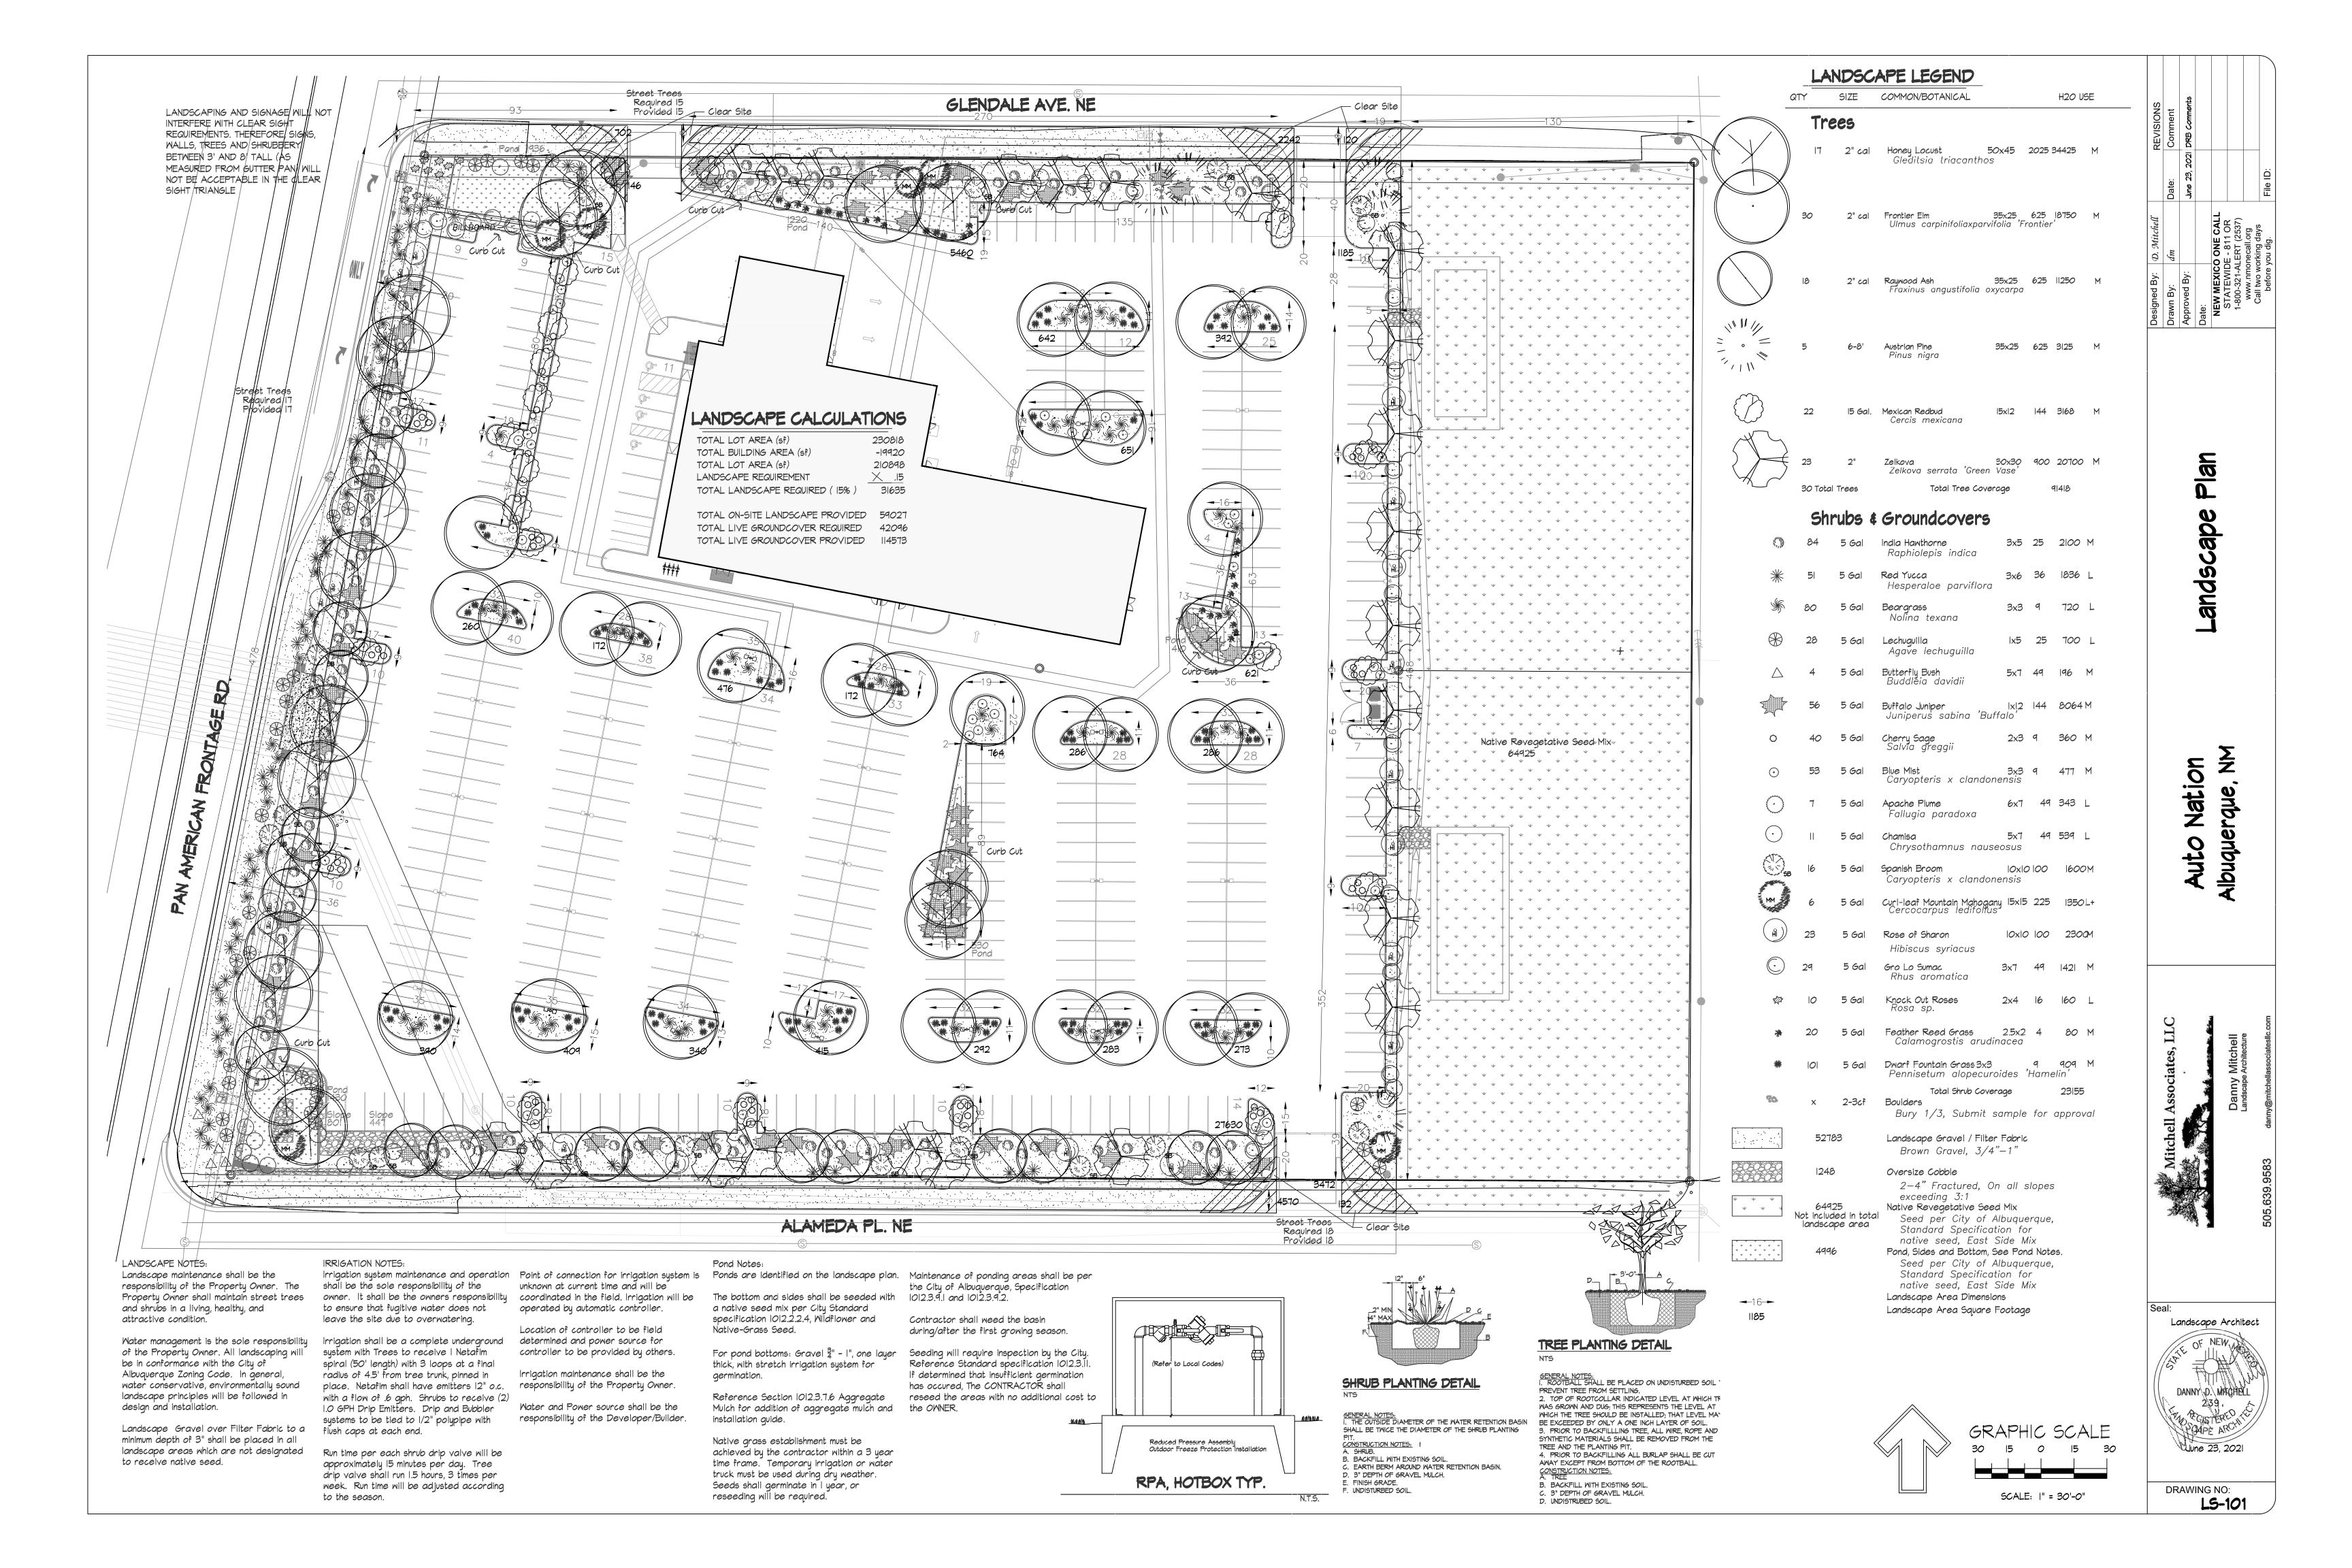

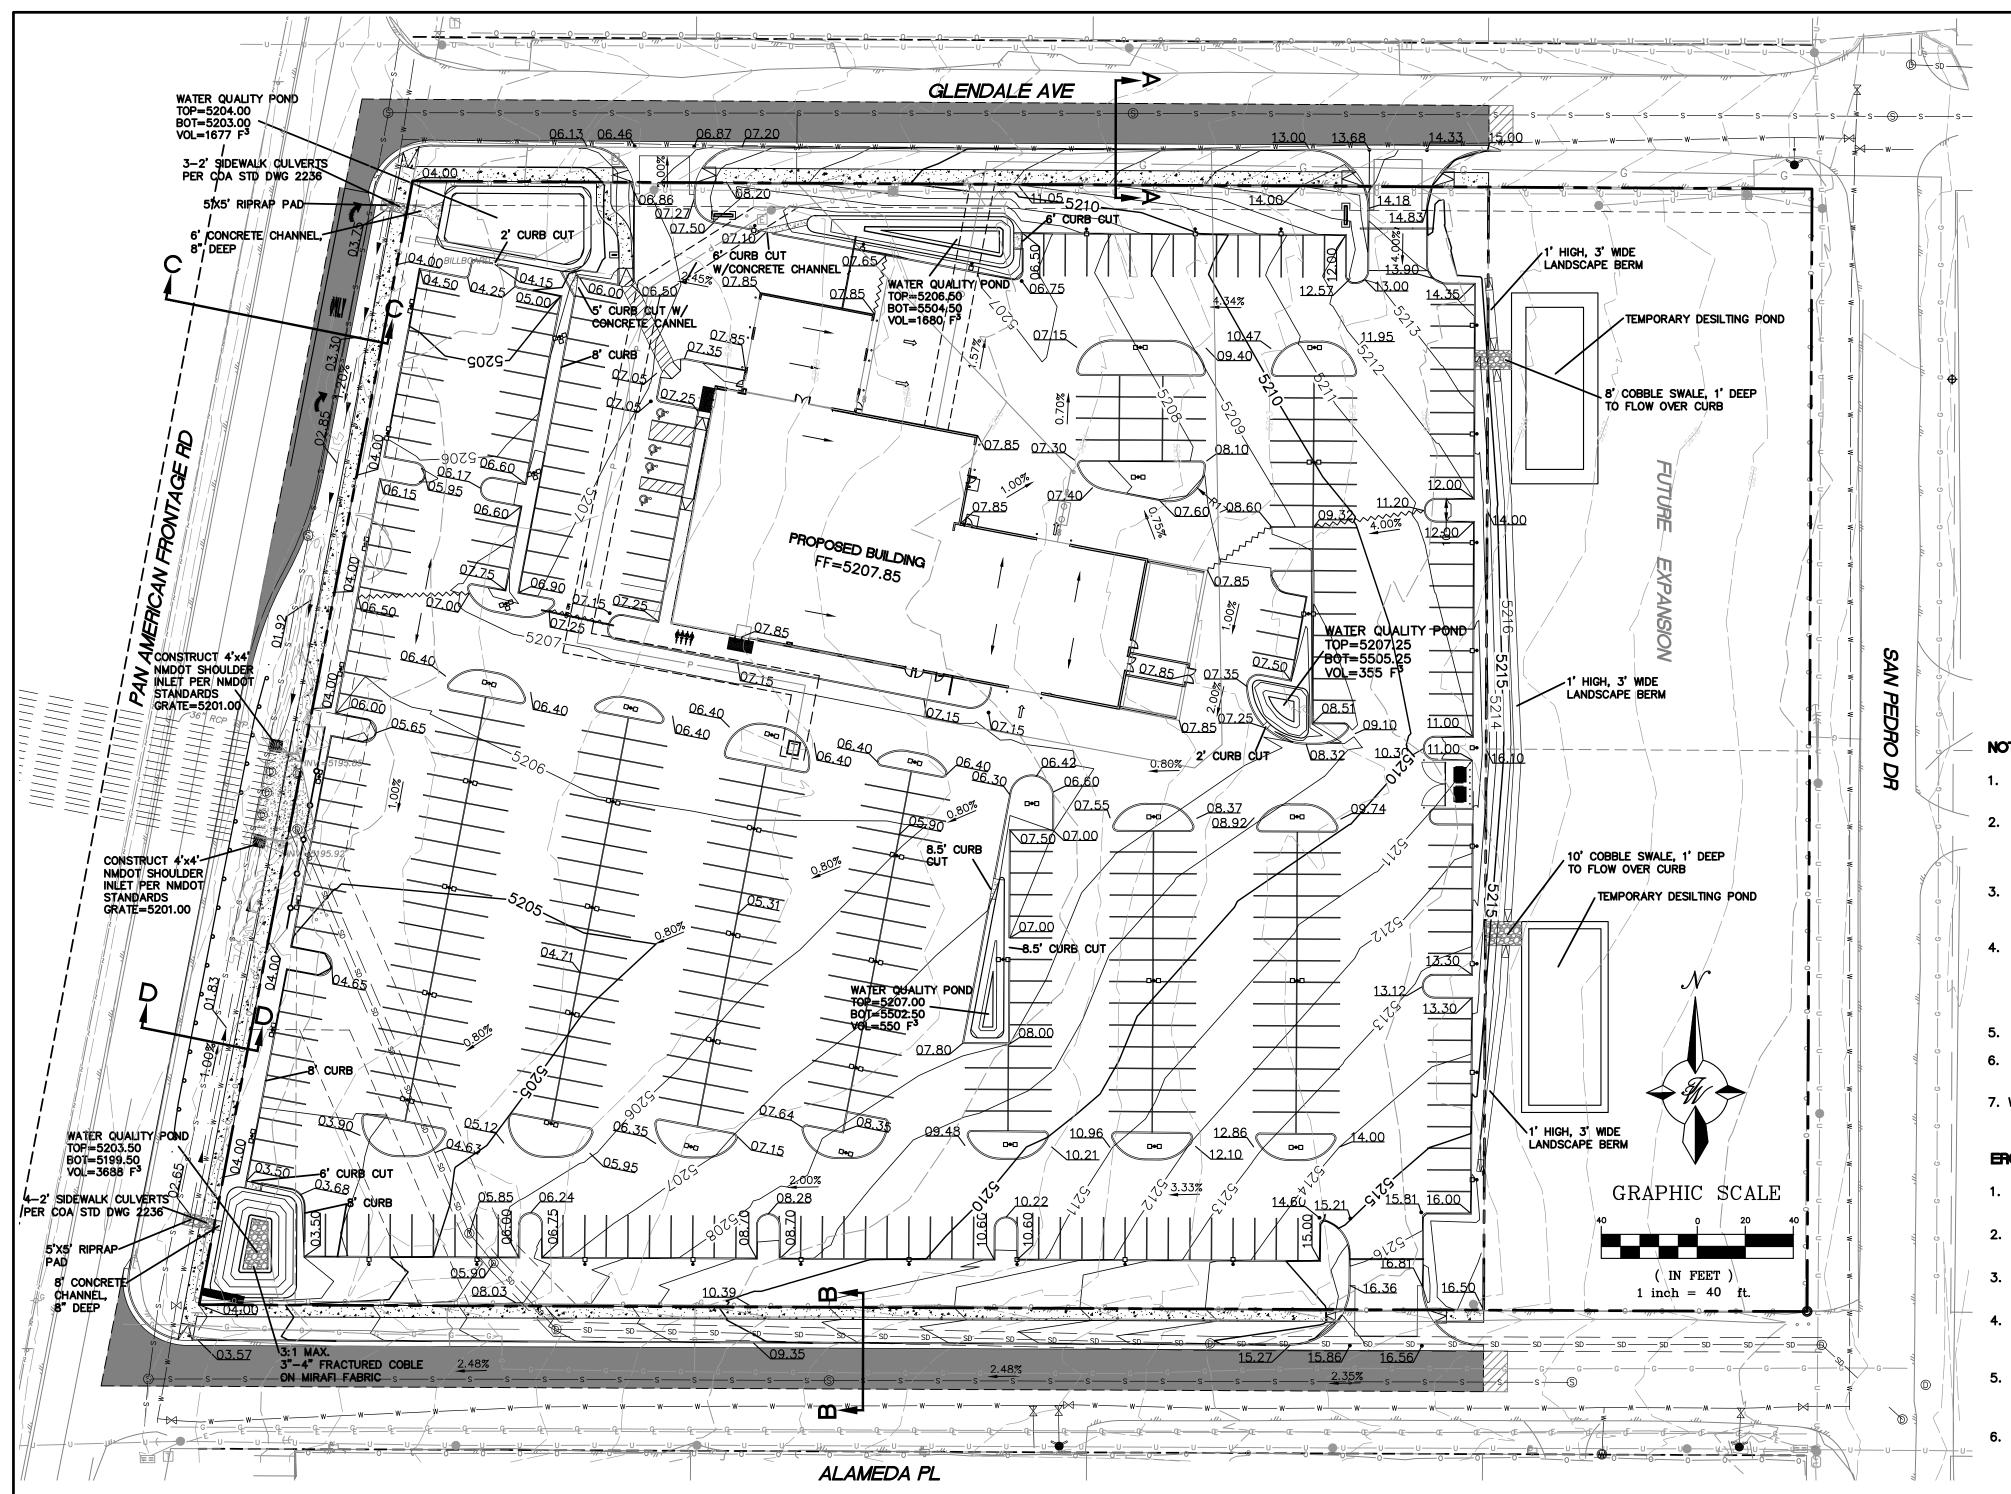

# SEE SHEET GR-3 FOR ROAD CROSS SECTIONS

# **EXISTING DRAINAGE:**

THIS SITE IS CURRENTLY VACANT AND IS LOCATED ON THE WEST SIDE OF SAN PEDRO BETWEEN GLENDALE AVENUE AND ALAMEDA PLACE. THE SITE IS BOUNDED BY ROADS ON ALL FOUR SIDES AND CONTAINS APPROXIMATELY 5.29 ACRES. THE SITE DRAINS FROM EAST TO WEST AND INTO A DRAINAGE SWALE ALONG THE EAST SIDE OF PAN AMERICAN FREEWAY. THE SWALE THEN DRAINS TO TWO EXISTING 36" RCP PIPES THAT DRAIN TO THE WEST UNDER INTERSTATE 25 AND INTO AN ARROYO. ACCORDING TO AN APPROVED DRAINAGE PLAN FOR THE SAN PEDRO STORM DRAIN PROJECT (CITY PROJECT NO. 5304.91) COMPLETED BY THOMPSON ENGINEERING IN JANUARY OF 2010, THIS SITE IS CONTAINED WITHIN BASIN 116.21. THAT BASIN ALSO INCLUDES 2 LOTS TO THE EAST OF THIS PROJECT THAT ARE OWNED BY THIS SAME LAND OWNER. THAT BASIN WAS DESIGNED TO DRAIN 30.0 CFS TO THE SAN PEDRO STORM SEWER. THE SITE IS NOT LOCATED WITH IN A FLOOD PLAIN AS SHOWN ON THE FIRM MAP. THIS PROJECT DOES RECEIVE OFFSITE FLOW FROM THE 2 LOTS TO THE EAST ALONG SAN PEDRO.

# PROPOSED DRAINAGE:

THE SITE WILL CONTINUE TO DRAIN FROM EAST TO WEST INTO THE EXISTING DRAINAGE SWALE ALONG PAN AMERICAN FREEWAY AND IS DIVIDED INTO THREE BASINS. THE OFFSITE LOTS TO THE EAST WILL CONTINUE TO DRAIN THROUGH THIS SITE VIA TEMPORARY DESILTING PONDS LOCATED ALONG THE PROPERTY LINE. BASIN OF—1 WILL DRAIN A 100YR, 6—HR FLOW OF 1.67 CFS TO BASIN "B" WHILE BASIN OF—2 WILL DRAIN A 100YR, 6—HR FLOW OF 4.10 CFS TO BASIN "C".

BASIN "B" WILL GENERATE A 100YR, 6-HR FLOW OF 4.47 CFS WHICH WILL BE DIRECTED TO A WATER QUALITY POND. BASIN "B" WILL PASS THROUGH THE OFFSITE FLOWS FROM BASIN OF-1. THE POND WILL CONTAIN THE REQUIRED WATER QUALITY VOLUME AND THEN OVERFLOW TO BASIN "A".

BASIN "A" WILL GENERATE A 100YR, 6—HR FLOW OF 2.36 CFS WHICH WILL BE DIRECTED TO A WATER QUALITY POND IN THE NORTHWEST CORNER OF THE PROJECT. BASIN "A" WILL PASS THROUGH THE FLOWS FROM BASIN "B" AND BASIN OF—1. THE POND WILL CONTAIN THE REQUIRED WATER QUALITY VOLUME AND THEN BE ALLOWED TO OVERFLOW INTO THE EXISTING DRAINAGE SWALE ALONG PAN AMERICAN FREEWAY AS IT DOES IN THE EXISTING CONDITION.

BASIN "C" WILL GENERATE A 100YR, 6-HR FLOW OF 14.26 CFS WHICH WILL BE DIRECTED TO TWO WATER QUALITY PONDS. BASIN "C" WILL PASS THROUGH THE FLOWS FROM BASIN OF-2. THE COMBINED VOLUME OF THE PONDS CONTAIN THE REQUIRED WATER QUALITY VOLUME. ALL FLOWS EVENTUALLY WILL PASS THROUGH THE WATER QUALITY POND LOCATED IN THE SOUTHWEST CORNER OF THE PROPERTY AND OVERFLOW INTO THE EXISTING DRAINAGE SWALE ALONG PAN AMERICAN FREEWAY AS IT DOES IN THE EXISTING CONDITION.

THE EXISTING DRAINAGE SWALE ALONG PAN AMERICAN FREEWAY WILL BE CLEANED AND LINED WITH COBBLE TO PREVENT EROSION. THE TOTAL DISCHARGE TO THE SWALE IS 26.86 CFS WHICH IS WELL BELOW THE 30.0 CFS ALLOWED PER THE APPROVED DRAINAGE ANALYSIS.

# 

CURB & GUTTER

FLOW ARROW

EXISTING CURB & GUTTER

EXISTING BOUNDARY LINE

EXISTING CONTOUR MAJOR

EXISTING CONTOUR MINOR


# NOTICE TO CONTRACTORS


**LEGEND** 

- 1. AN EXCAVATION/CONSTRUCTION PERMIT WILL BE REQUIRED BEFORE BEGINNING ANY WORK WITHIN CITY RIGHT-OF-WAY.
- 2. ALL WORK DETAILED ON THESE PLANS TO BE PERFORMED, EXCEPT AS OTHERWISE STATED OR PROVIDED HERON, SHALL BE CONSTRUCTED IN ACCORDANCE WITH CITY OF ALBUQUERQUE INTERIM STANDARD SPECIFICATIONS FOR PUBLIC WORKS CONSTRUCTION, 1985.
- 3. TWO WORKING DAYS PRIOR TO ANY EXCAVATION, CONTRACTOR MUST CONTACT LINE LOCATING SERVICE, 765-1234, FOR LOCATION OF EXISTING UTILITIES.
- 4. PRIOR TO CONSTRUCTION, THE CONTRACTOR SHALL EXCAVATE AND VERIFY THE HORIZONTAL AND VERTICAL LOCATIONS OF ALL CONNECTIONS. SHOULD A CONFLICT EXIST, THE CONTRACTOR SHALL NOTIFY THE ENGINEER SO THAT THE CONFLICT CAN BE RESOLVED WITH A MINIMUM AMOUNT OF DELAY.
- 5. BACKFILL COMPACTION SHALL BE ACCORDING TO TRAFFIC/STREET USE.
- 6. MAINTENANCE OF THESE FACILITIES SHALL BE THE RESPONSIBILITY OF THE OWNER OF THE PROPERTY SERVED.
- . WORK ON ARTERIAL STREETS SHALL BE PERFORMED ON A 24-HOUR BASIS.  $rac{\mathsf{M}}{3}$

# EROSION CONTROL NOTES:

- 1. CONTRACTOR IS RESPONSIBLE FOR OBTAINING A TOPSOIL DISTURBANCE PERMIT PRIOR TO BEGINNING WORK.
- 2. CONTRACTOR IS RESPONSIBLE FOR MAINTAINING RUN-OFF ON SITE DURING CONSTRUCTION.
- 3. CONTRACTOR IS RESPONSIBLE FOR CLEANING ALL SEDIMENT THAT GETS INTO EXISTING RIGHT-OF-WAY.
- 4. REPAIR OF DAMAGED FACILITIES AND CLEANUP OF SEDIMENT ACCUMULATIONS ON ADJACENT PROPERTIES AND IN PUBLIC FACILITIES IS THE RESPONSIBILITY OF THE CONTRACTOR.
- 5. ALL EXPOSED EARTH SURFACES MUST BE PROTECTED FROM WIND AND WATER EROSION PRIOR TO FINAL (CITY) ACCEPTANCE OF ANY PROJECT.
- 6. ALL SLOPES NOT STABILIZED AT THE END OF THE PROJECT SHALL BE STABILIZED IN ACCORDANCE WITH COA SPECS OR ₹ GRAVEL

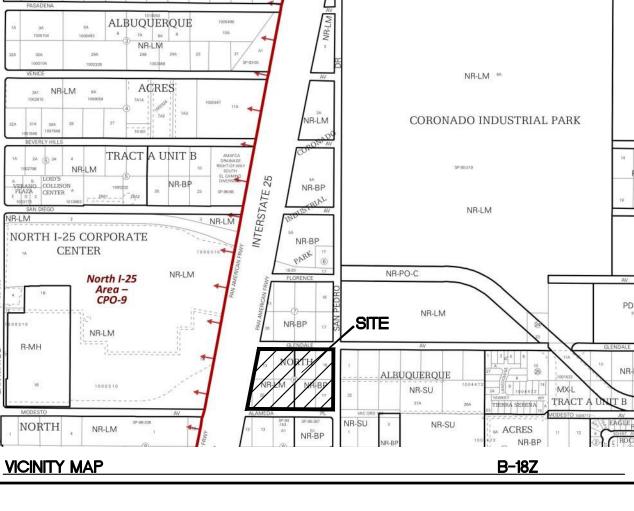

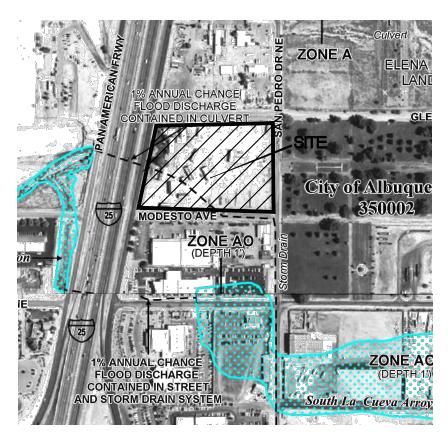

# PRIVATE DRAINAGE FACILITIES WITHIN CITY RIGHT-OF-WAY NOTICE TO CONTRACTOR (SPECIAL ORDER 19 '90-19')

35001C00129H

DRAWN BY

pm

DATE

7-13-21

DRAWING

2021010-GR

SHEET #

GR-1

JOB #

2021010

1. BUILD SIDEWALK CULVERT PER COA STD DWG 2236.

FIRM MAF

- CONTACT STORM DRAIN MAINTENANCE AT (505) 857-8033 TO SCHEDULE A
  MEETING PRIOR TO FORMING.
   AN EXCAVATION PERMIT WILL BE REQUIRED BEFORE BEGINNING ANY WORK WITHIN
- CITY RIGHT-OF-WAY.

  4. ALL WORK ON THIS PROJECT SHALL BE PERFORMED IN ACCORDANCE WITH

  ADDITIONAL STATE AND LOCAL LAWS BUILES AND RECULATIONS CONCERNING
- APPLICABLE FEDERAL, STATE AND LOCAL LAWS, RULES AND REGULATIONS CONCERNING CONSTRUCTION SAFETY AND HEALTH.

  5. TWO WORKING DAYS PRIOR TO ANY EXCAVATION, THE CONTRACTOR MUST
- CONTACT NEW MEXICO ONE CALL, DIAL "811" [OR (505) 260-1990] FOR THE LOCATION OF EXISTING UTILITIES.


  6. PRIOR TO CONSTRUCTION, THE CONTRACTOR SHALL EXCAVATE AND VERIFY THE
- LOCATIONS OF ALL OBSTRUCTIONS. SHOULD A CONFLICT EXIST, THE CONTRACTOR SHALL NOTIFY THE ENGINEER SO THAT THE CONFLICT CAN BE RESOLVED WITH A MINIMUM AMOUNT OF DELAY.
- 7. BACKFILL COMPACTION SHALL BE ACCORDING TO TRAFFIC/STREET USE.

  8. MAINTENANCE OF THE FACILITY SHALL BE THE RESPONSIBILITY OF THE OWNER OF THE PROPERTY BEING SERVED.
- THE PROPERTY BEING SERVED.

  9. WORK ON ARTERIAL STREETS MAY BE REQUIRED ON A 24—HOUR BASIS.
- 10. CONTRACTOR MUST CONTACT STORM DRAIN MAINTENANCE AT (505)
  857-8033 TO SCHEDULE A CONSTRUCTION INSPECTION. FOR EXCAVATING AND
  BARRICADING INSPECTIONS, CONTACT CONSTRUCTION COORDINATION AT (505) 924-3416.

# CAUTION

ALL EXISTING UTILITIES SHOWN WERE OBTAINED FROM RESEARCH, AS-BUILTS, SURVEYS OR INFORMATION PROVIDED BY OTHERS. IT SHALL BE THE SOLE RESPONSIBILITY OF THE CONTRACTOR TO CONDUCT ALL NECESSARY FIELD INVESTIGATIONS PRIOR TO AND INCLUDING ANY EXCAVATION, TO DETERMINE THE ACTUAL LOCATION OF UTILITIES AND OTHER IMPROVEMENTS, PRIOR TO STARTING THE WORK. ANY CHANGES FROM THIS PLAN SHALL BE COORDINATED WITH AND APPROVED BY THE ENGINEER.

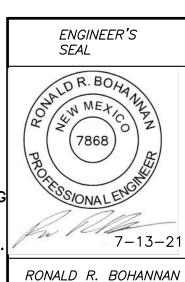

# AUTO NATION ALBUQUERQUE, NM CONCEPTUAL GRADING AND DRAINAGE PLAN TIERRA WEST, LLC

TIERRA WEST, LLC

5571 MIDWAY PARK PL NE
ALBUQUERQUE, NEW MEXICO 87109
(505) 858–3100
www.tierrawestlic.com

n-Site E					AACIA	IILEU L	Menior	d (Develo	peu	,						
	Basins							,	•	9.						
Į.									ļ		9	100-Year	55		10-Year	
Basin	Area	Area	Treat	tment A	Trea	tment B	Treat	ment C	Treat	ment D	Weighted E	Volume	Flow	Weighted E	Volume	Flow
	(sf)	(acres)	%	(acres)	%	(acres)	%	(acres)	%	(acres)	(in)	(ac-ft)	cfs	(in)	(ac-ft)	cfs
Α	26,610	0.61	0%	0	24%	0.15	0%	0.00	76%	0.46	1.963	0.100	2.36	1.220	0.062	1.4
В	49,337	1.13	0%	0	20%	0.23	0%	0.00	80%	0.91	2.024	0.191	4.47	1.268	0.120	2.6
С	154,430	3.55	0%	0	16%	0.57	0%	0.00	84%	2.98	2.085	0.616	14.26	1.316	0.389	8.6
_												Total	21.09			
Off-Site E	Basins															
											1.0	100-Year			10-Year	
Basin	Area	Area	Treat	tment A	Trea	tment B	Treat	ment C	Treat	ment D	Weighted E	Volume	Flow	Weighted E	Volume	Flow
	(sf)	(acres)	%	(acres)	%	(acres)	%	(acres)	%	(acres)	(in)	(ac-ft)	cfs	(in)	(ac-ft)	cfs
OF-1	17,982	0.41	0%	0	15%	0.06	0%	0.00	85%	0.35	2.101	0.072	1.67	1.329	0.046	1.0
OF-2	44,159	1.01	0%	0	15%	0.15	0%	0.00	85%	0.86	2.101	0.177	4.10	1.329	0.112	2.4
												Total	5.77			
quation	ns:															
						Excess Pre	cipitation,	E (inches)		Peak	Discharge (cf	s/acre)				
Veighted	d E = Ea*Aa + Eb*A	b + Ec*Ac	+ Ed*Ad	/ (Total Area	a)	Zone 2	100-Year	10 - Year		Zone 2	100-Year	10 - Year				
						Ea	0.62	0.15		Qa	1.71	0.41				
olume =	= Weighted D * Tota	l Area				Eb	0.80	0.30		Qb	2.36	0.95				
						Ec	1.03	0.48		Qc	3.05	1.59				
low = Q	a * Aa + Qb * Ab + 0	Oc * Ac + C	d * Ad			Ed	2.33	1.51		Q <sub>d</sub>	4.34	2.71				
						_u			<u> </u>	- u						
Vater Q	uality Calculations	<b>i</b>														
Basin	Impervious Area	SWQV	Storn	n Water	Stori	m Water										
	(sf)	(in)		Vol. (ft <sup>3</sup> )		Vol. (ac-ft)										
Α	20,224	0.42		708		.016										
В	39,470	0.42		381		.032										
С	129,721	0.42		540		.104										
	15,285	0.42		535		.012										

				Char	nnel Cap	acity				
	Top Width	Bottom Width	Depth	Area	WP	R	Slope	Q Provided	Q Required	Velocity
	(ft)	(ft)	(ft)	(ft^2)	(ft)		(%)	(cfs)	(cfs)	(ft/s)
Channel	3	3	0.67	2.01	4.34	0.4631	1	13.79	8.50	4.23
Channel	4	4	0.67	2.68	5.34	0.5019	1	19.40	18.36	6.85
Manning's Eq	uation:									
Q = 1.49/n * A * I		2)								
	Area									
R=	= D/4									
S=	Slope									
n=	0.013									

0.030

# **Curb Opening Capacity**

Weir Equation:

 $Q = CLH^{3/2}$ 

37,535 0.42

1314

Q=Flow C=2.95

L= Length of weir H = Height of Weir

Basin "A" Curb Openings

 $Q = 2.95*5.0*0.67^{3/2}$ 

Q = 8.90 cfs < Q = 8.50 cfs

Basin "B" Curb Openings

 $Q = 2.95*6*0.5^{3/2}$ 

Q = 6.26 cfs < Q = 6.14 cfs

Upper Basin "C" Curb Openings


 $Q = 2.95 * 8.5 * .5^{3/2}$ 

Q = 8.87 cfs < Q = 8.85 cfs

Lower Basin "C" Curb Openings

 $\mathbf{Q} = 2.95 * 11.5 * .67^{3/2}$ 

Q = 18.61 cfs < Q = 18.36 cfs

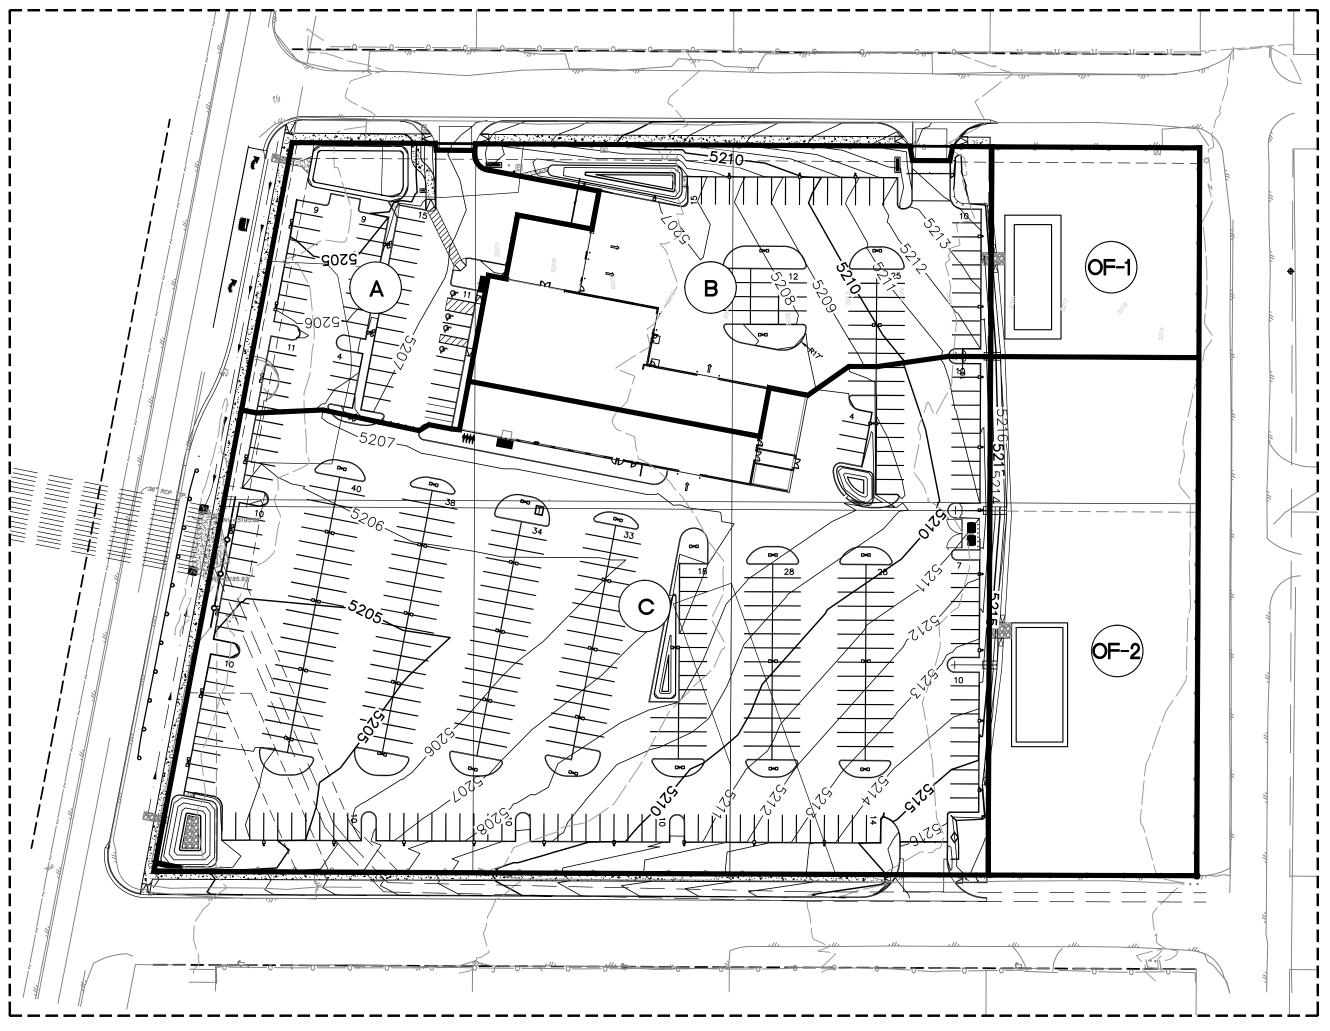

BASIN MAP



# CAUTION

ALL EXISTING UTILITIES SHOWN WERE OBTAINED FROM RESEARCH, AS-BUILTS, SURVEYS OR INFORMATION PROVIDED BY OTHERS. IT SHALL BE THE SOLE RESPONSIBILITY OF THE CONTRACTOR TO CONDUCT ALL NECESSARY FIELD INVESTIGATIONS PRIOR TO AND INCLUDING ANY EXCAVATION, TO DETERMINE THE ACTUAL LOCATION OF UTILITIES AND OTHER IMPROVEMENTS, PRIOR TO STARTING THE WORK. ANY CHANGES FROM THIS PLAN SHALL BE COORDINATED WITH AND APPROVED BY THE ENGINEER.


	ENGIN. SEAL	EER'S	3	
(NA)	DR. E	30HA	宝	
	(786	8)		
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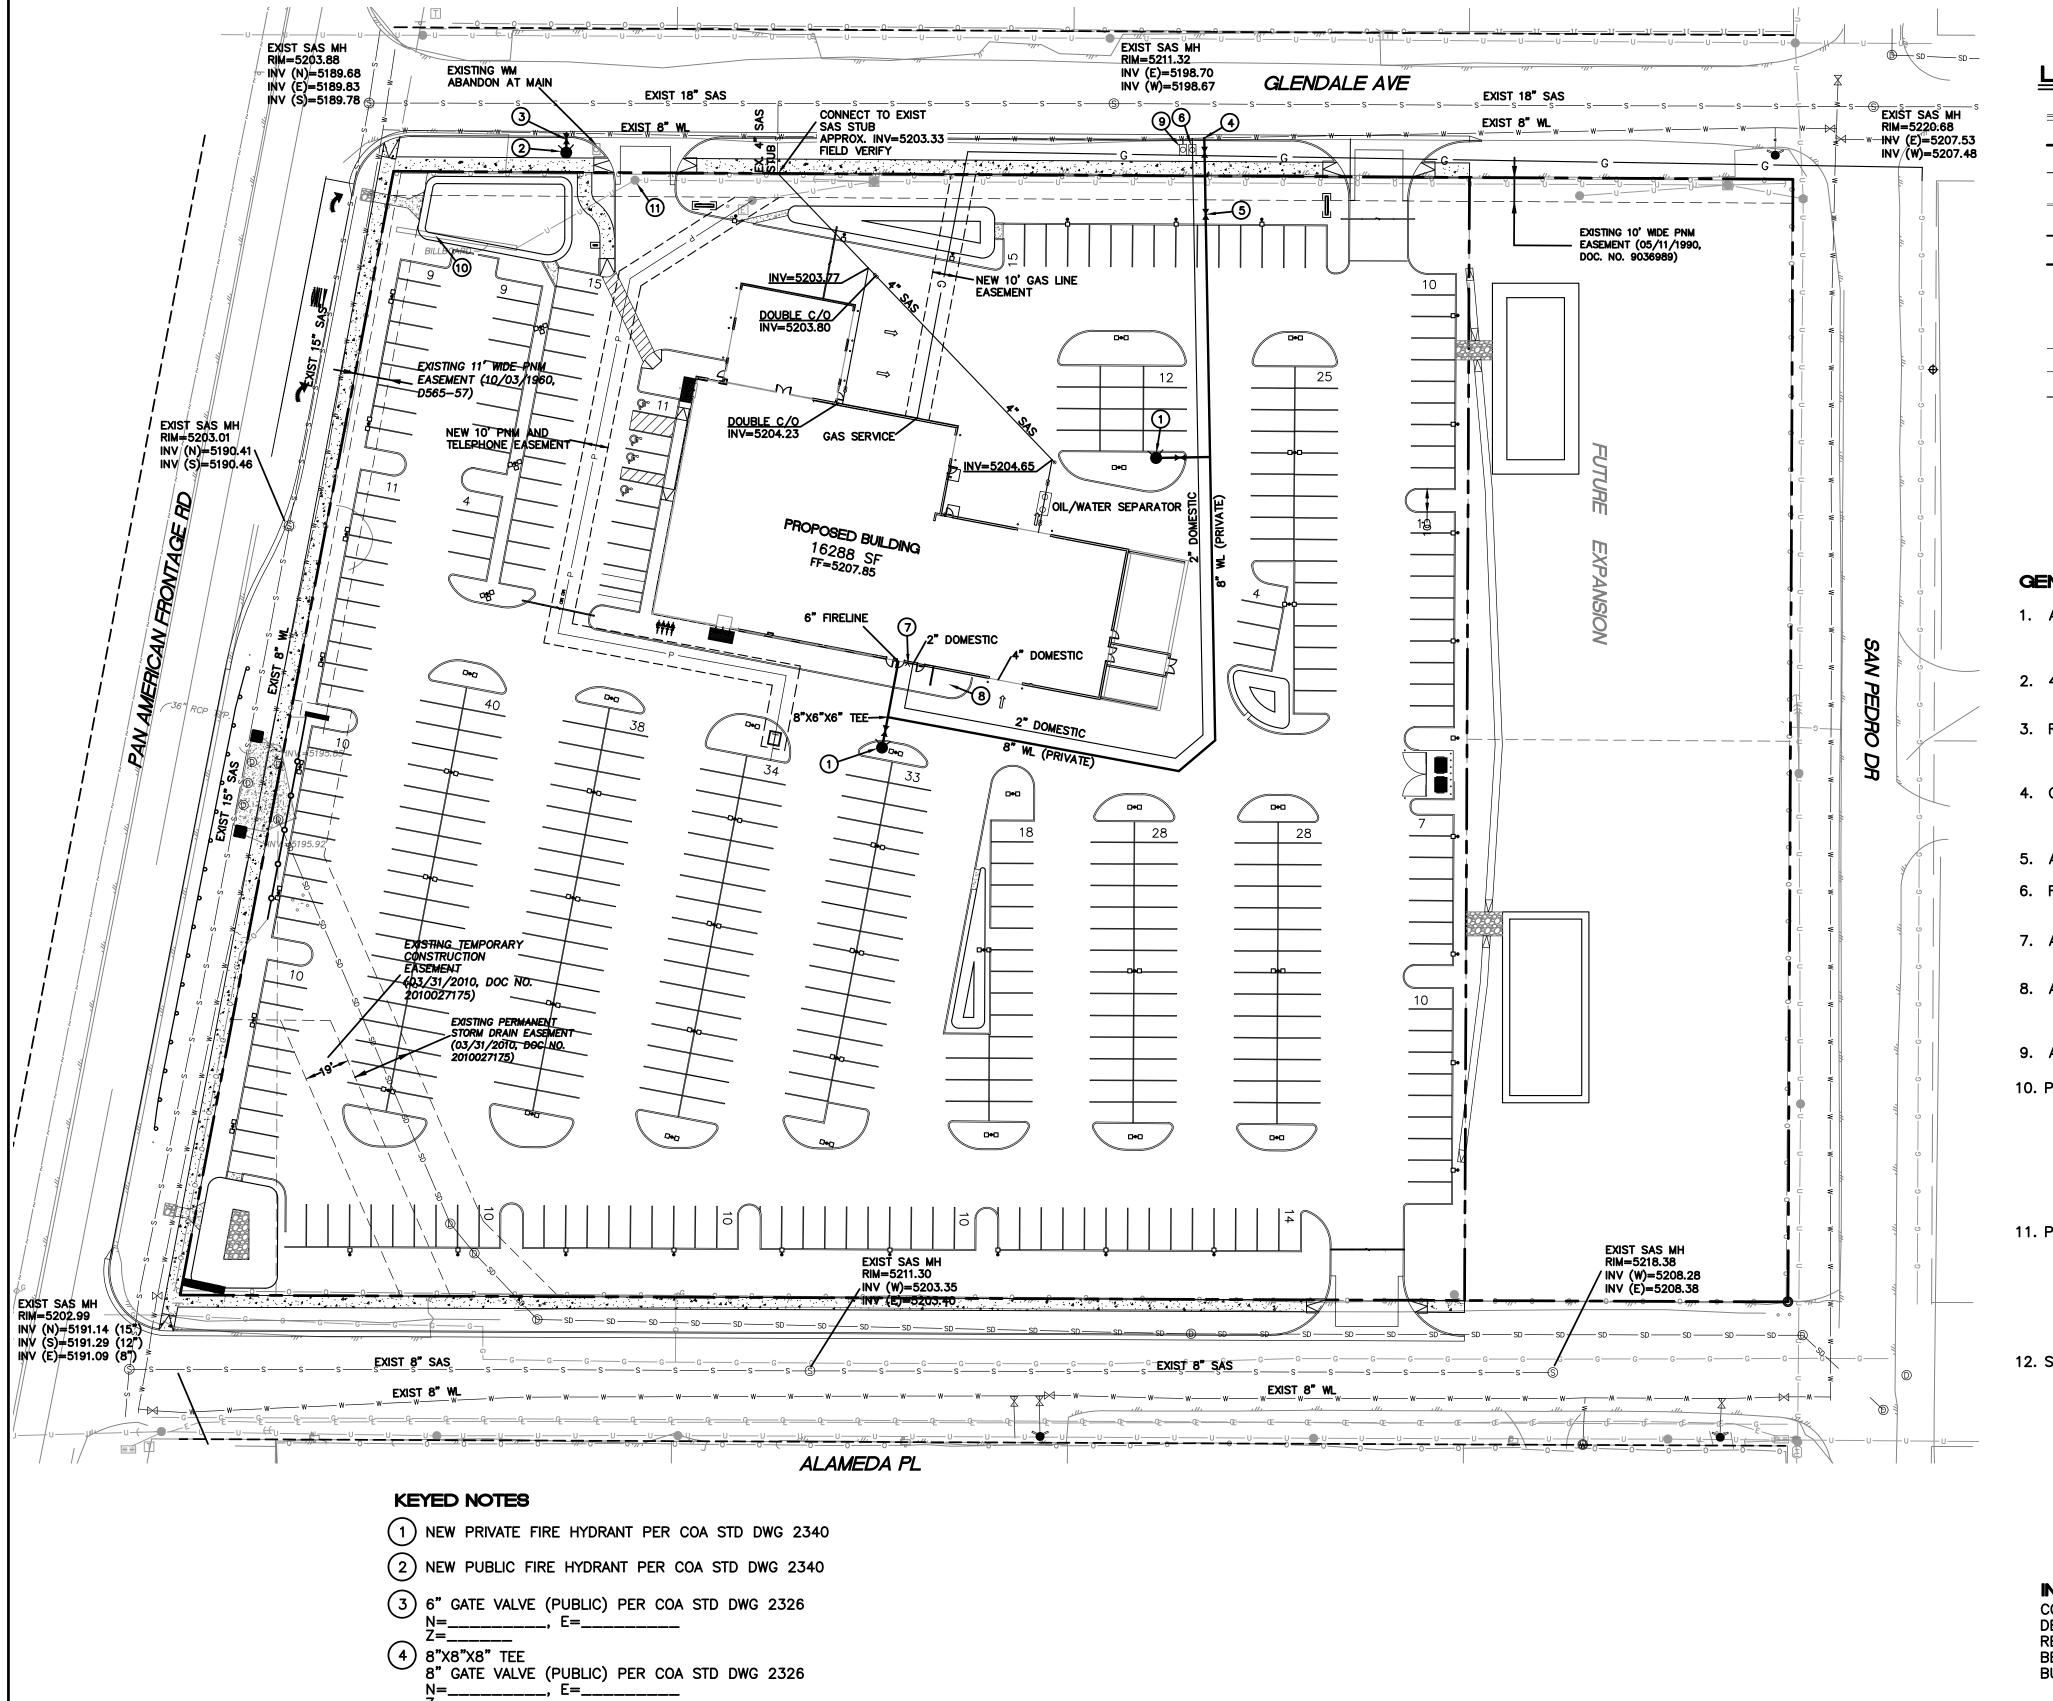
<u> </u>	AUTO NATION ALBUQUERQUE,
	CONCEPTUAL GR AND DRAINAGE P

P.E. #7868

DRAWN BY pm NM DATE 7-13-21 RADING DRAWING 2021010-GR SHEET #

TIERRA WEST, LLC GR-2 5571 MIDWAY PARK PL NE ALBUQUERQUE, NEW MEXICO 87109 (505) 858-3100 *JOB #* 2021010 www.tiérrawestllc.com



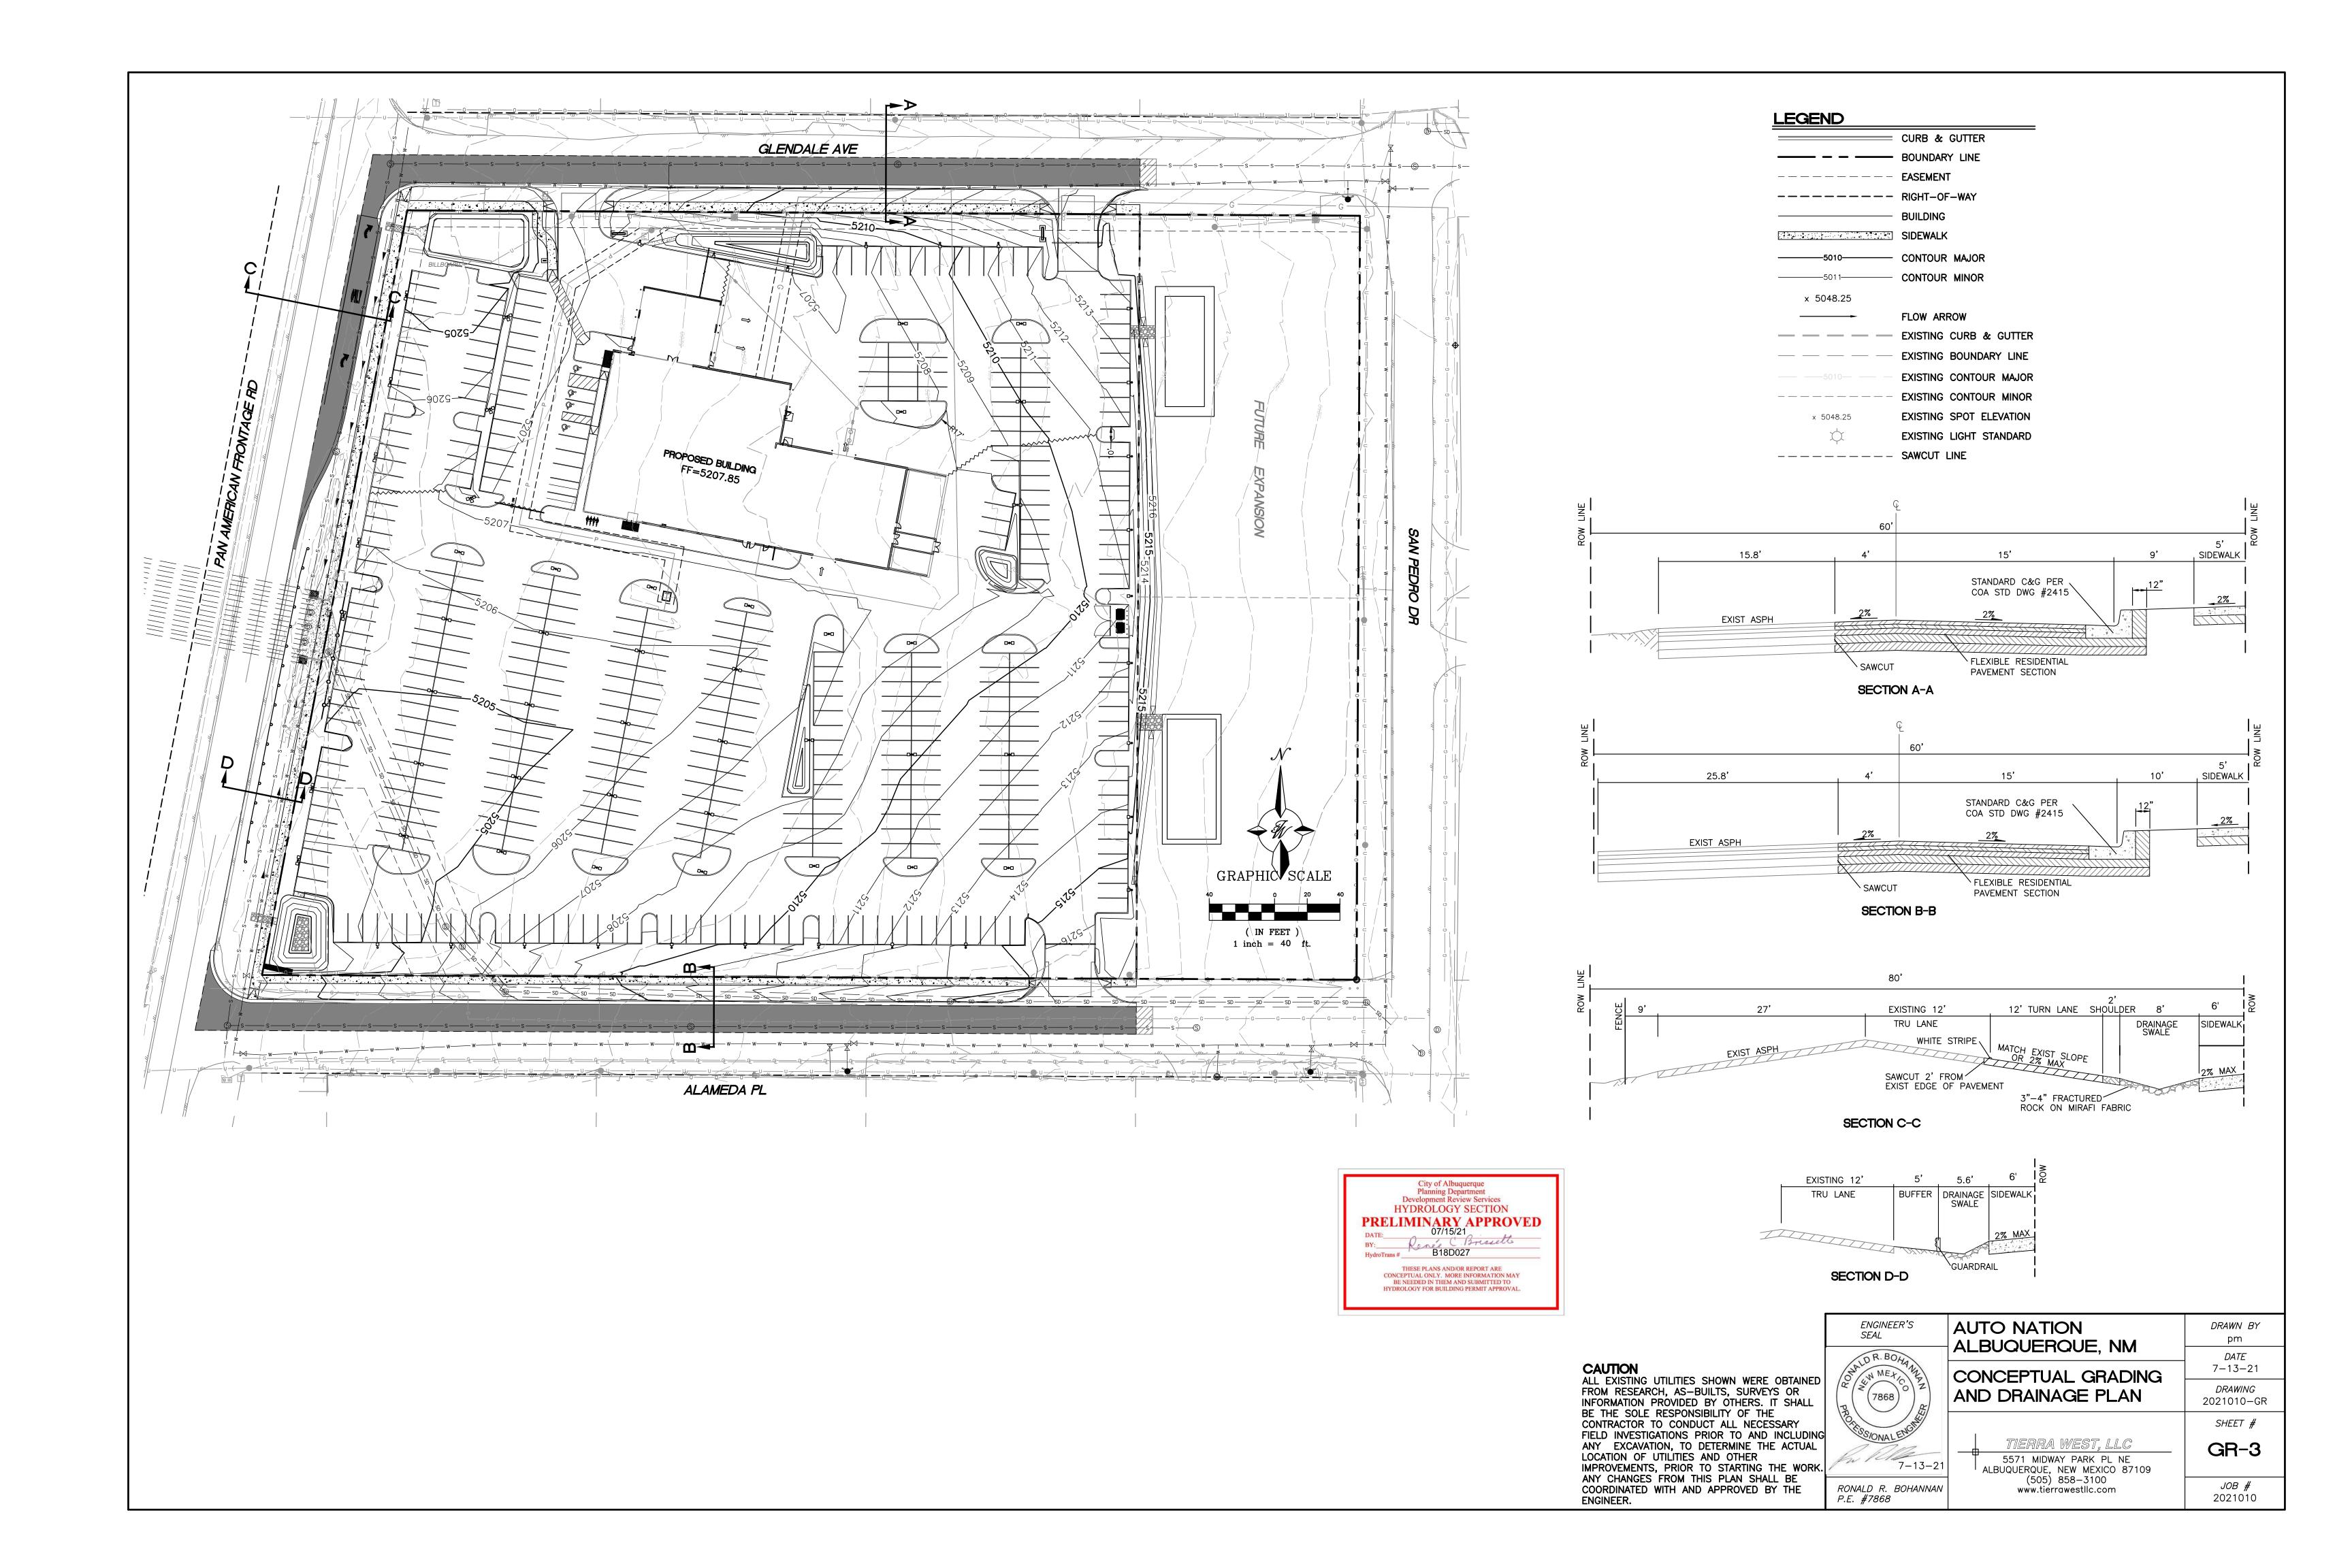

5 PIV

7 FDC

(8) TRANSFORMER

9) 1" LANDSCAPE METER


(10) BILLBOARD TO BE REMOVED

(11) EXISTING POWER POLE TO BE REMOVED

6 2" WATER METER AND BOX PER CO STD DWG

2301, 2361, 2363, 2367

### **LEGEND**

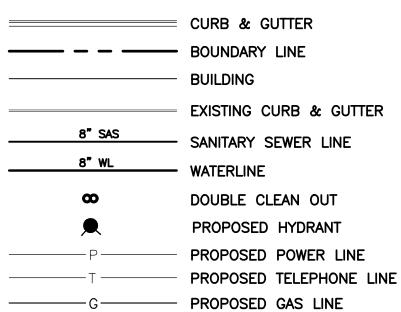

# BEVERLY HILLS 681 671 1 672 1 672 1 672 1 672 1 672 1 672 1 6892 FPPC 28-937 81-91 B8992 B892 B892 B892 B892 B892 B892 B892 B892 B89

THE CONTRACTOR SHALL COORDINATE WITH THE WATER AUTHORITY SEVEN (7) DAYS IN ADVANCE OF PERFORMING WORK THAT WILL AFFECT THE PUBLIC WATER OR SANITARY SEWER INFRASTRUCTURE. WORK REQUIRING SHUTOFF OF FACILITIES DESIGNATED AS MASTER PLAN FACILITIES MUST BE COORDINATED WITH THE WATER AUTHORITY 14 DAYS IN ADVANCE OF PERFORMING SUCH WORK. ONLY WATER AUTHORITY CREWS ARE AUTHORIZED TO OPERATE PUBLIC VALVES. SHUTOFF REQUESTS MUST BE MADE ONLINE AT


HTTP://ABCWUA.ORG/CONTENT/VIEW/463/729/.

#### GENERAL UTILITY NOTES:

- 1. ALL WATER AND SEWER UTILITY WORK TO BE DONE IN ACCORDANCE WITH COA STANDARDS AND SPECIFICATIONS LATEST EDITION.
- 2. 4' MINIMUM BURY REQUIRED FOR ALL UTILITIES UNLESS OTHERWISE NOTED.
- 3. REFERENCE PLUMBING PLANS FOR WATER LINE RISER LOCATIONS. BACKFLOW PREVENTOR LOCATED INSIDE BUILDING
- 4. CLEAN OUTS ARE TO BE BUILT PER UNIFORM PLUMBING CODE STANDARDS AT LOCATIONS INDICATED AND AT MID RUN IF LONGER THAN 100'
- 5. ALL PLUMBING PIPE MATERIAL TO BE USED PER UPC.
- 6. FIRE LINE AND DOMESTIC WATERLINE MUST HAVE BACKFLOW PREVENTORS PER UPC. TO BE PROVIDED IN THE BUILDING
- 7. ALL EX. SD INLETS AND MH'S SHALL HAVE CONCRETE COLLARS POURED AND BE ADJUSTED TO FINISHED GRADE.
- 8. ALL EXCAVATION, TRENCHING AND SHORING ACTIVITIES MUST BE CARRIED-OUT IN ACCORDANCE WITH OSHA 29 CFR 1926.650 SUBPART P.
- 9. ALL UTILITY DISTANCES SHOWN ARE FOR REFERENCE ONLY.
- 10. PNM HAS NUMEROUS ELECTRIC FACILITIES AT THIS SITE CURRENTLY SERVING EXISTING CUSTOMERS. THE APPLICANT SHALL COORDINATE WITH PNM REGARDING THESE EXISTING FACILITIES. ANY RELOCATION, CHANGES OR REALIGNMENT OF EXISTING ELECTRIC UTILITIES WILL BE THE DEVELOPER EXPENSE. IN SOME CASES, RELOCATION OR CHANGES TO EXISTING FACILITIES MAY NOT BE FEASIBLE DUE TO PHYSICAL, USE OR SAFETY CLEARANCE CONSTRAINTS.
- 11. PNM WILL REVIEW ALL TECHNICAL NEEDS, ISSUES AND SAFETY CLEARANCES FOR ITS ELECTRIC POWER SYSTEMS. ANY EXISTING AND PROPOSED PUBLIC UTILITY EASEMENTS SHALL BE INDICATED ON THE SITE PLAN UTILITY SHEET PRIOR TO DRB REVIEW. PNM'S STANDARD FOR PUBLIC UTILITY EASEMENTS IS 10 FEET IN WIDTH TO ENSURE ADEQUATE, SAFE CLEARANCES.
- 12. SCREENING SHALL BE DESIGNED TO ALLOW FOR ACCESS TO UTILITY FACILITIES. IT IS NECESSARY TO PROVIDE ADEQUATE CLEARANCE OF TEN FEET SURROUNDING ALL GROUND-MOUNTED UTILITIES FOR SAFE OPERATION, MAINTENANCE AND REPAIR PURPOSES.

# INSPECTION NOTE

CONTRACTOR SHALL CONSULT THE LOCAL BUILDING
DEPARTMENT OFFICIALS FOR ANY PLAN REVIEW, PERMITTING
REQUIREMENTS OR BUILDING CODE INSPECTIONS THAT MAY
BE REQUIRED TO ENFORCE LOCAL, STATE OR NATIONAL
BUILDING CODES PRIOR TO CONSTRUCTING IMPROVEMENTS

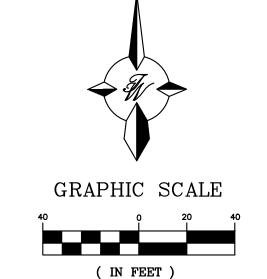

1 inch = 40 ft.

DRAWN BY

*DATE* 6-22-21

DRAWING

# CAUTION

ALL EXISTING UTILITIES SHOWN WERE OBTAINED FROM RESEARCH, AS—BUILTS, SURVEYS OR INFORMATION PROVIDED BY OTHERS. IT SHALL BE THE SOLE RESPONSIBILITY OF THE CONTRACTOR TO CONDUCT ALL NECESSARY FIELD INVESTIGATIONS PRIOR TO AND INCLUDING ANY EXCAVATION, TO DETERMINE THE ACTUAL LOCATION OF UTILITIES AND OTHER IMPROVEMENTS, PRIOR TO STARTING THE WORK. ANY CHANGES FROM THIS PLAN SHALL BE COORDINATED WITH AND APPROVED BY THE ENGINEER.

ENGINEER'S SEAL	4
OR BOW	4
TREAT TO R. BOHANTA NA MEXICO 7868	
6-22-21	
RONALD R. BOHANNAN P.E. #7868	

AUTO NATION ALBUQUERQUE, NM
MASTER UTILITY PLAN
TIERRA WEST, LLC

5571 MIDWAY PARK PL NE
ALBUQUERQUE, NEW MEXICO 87109
(505) 858-3100
www.tierrawestllc.com


2021010—SP

SHEET #

WEST, LLC

YAY PARK PL NE
NEW MEXICO 87109
858—3100
rrawestllc.com

JOB #
2021010

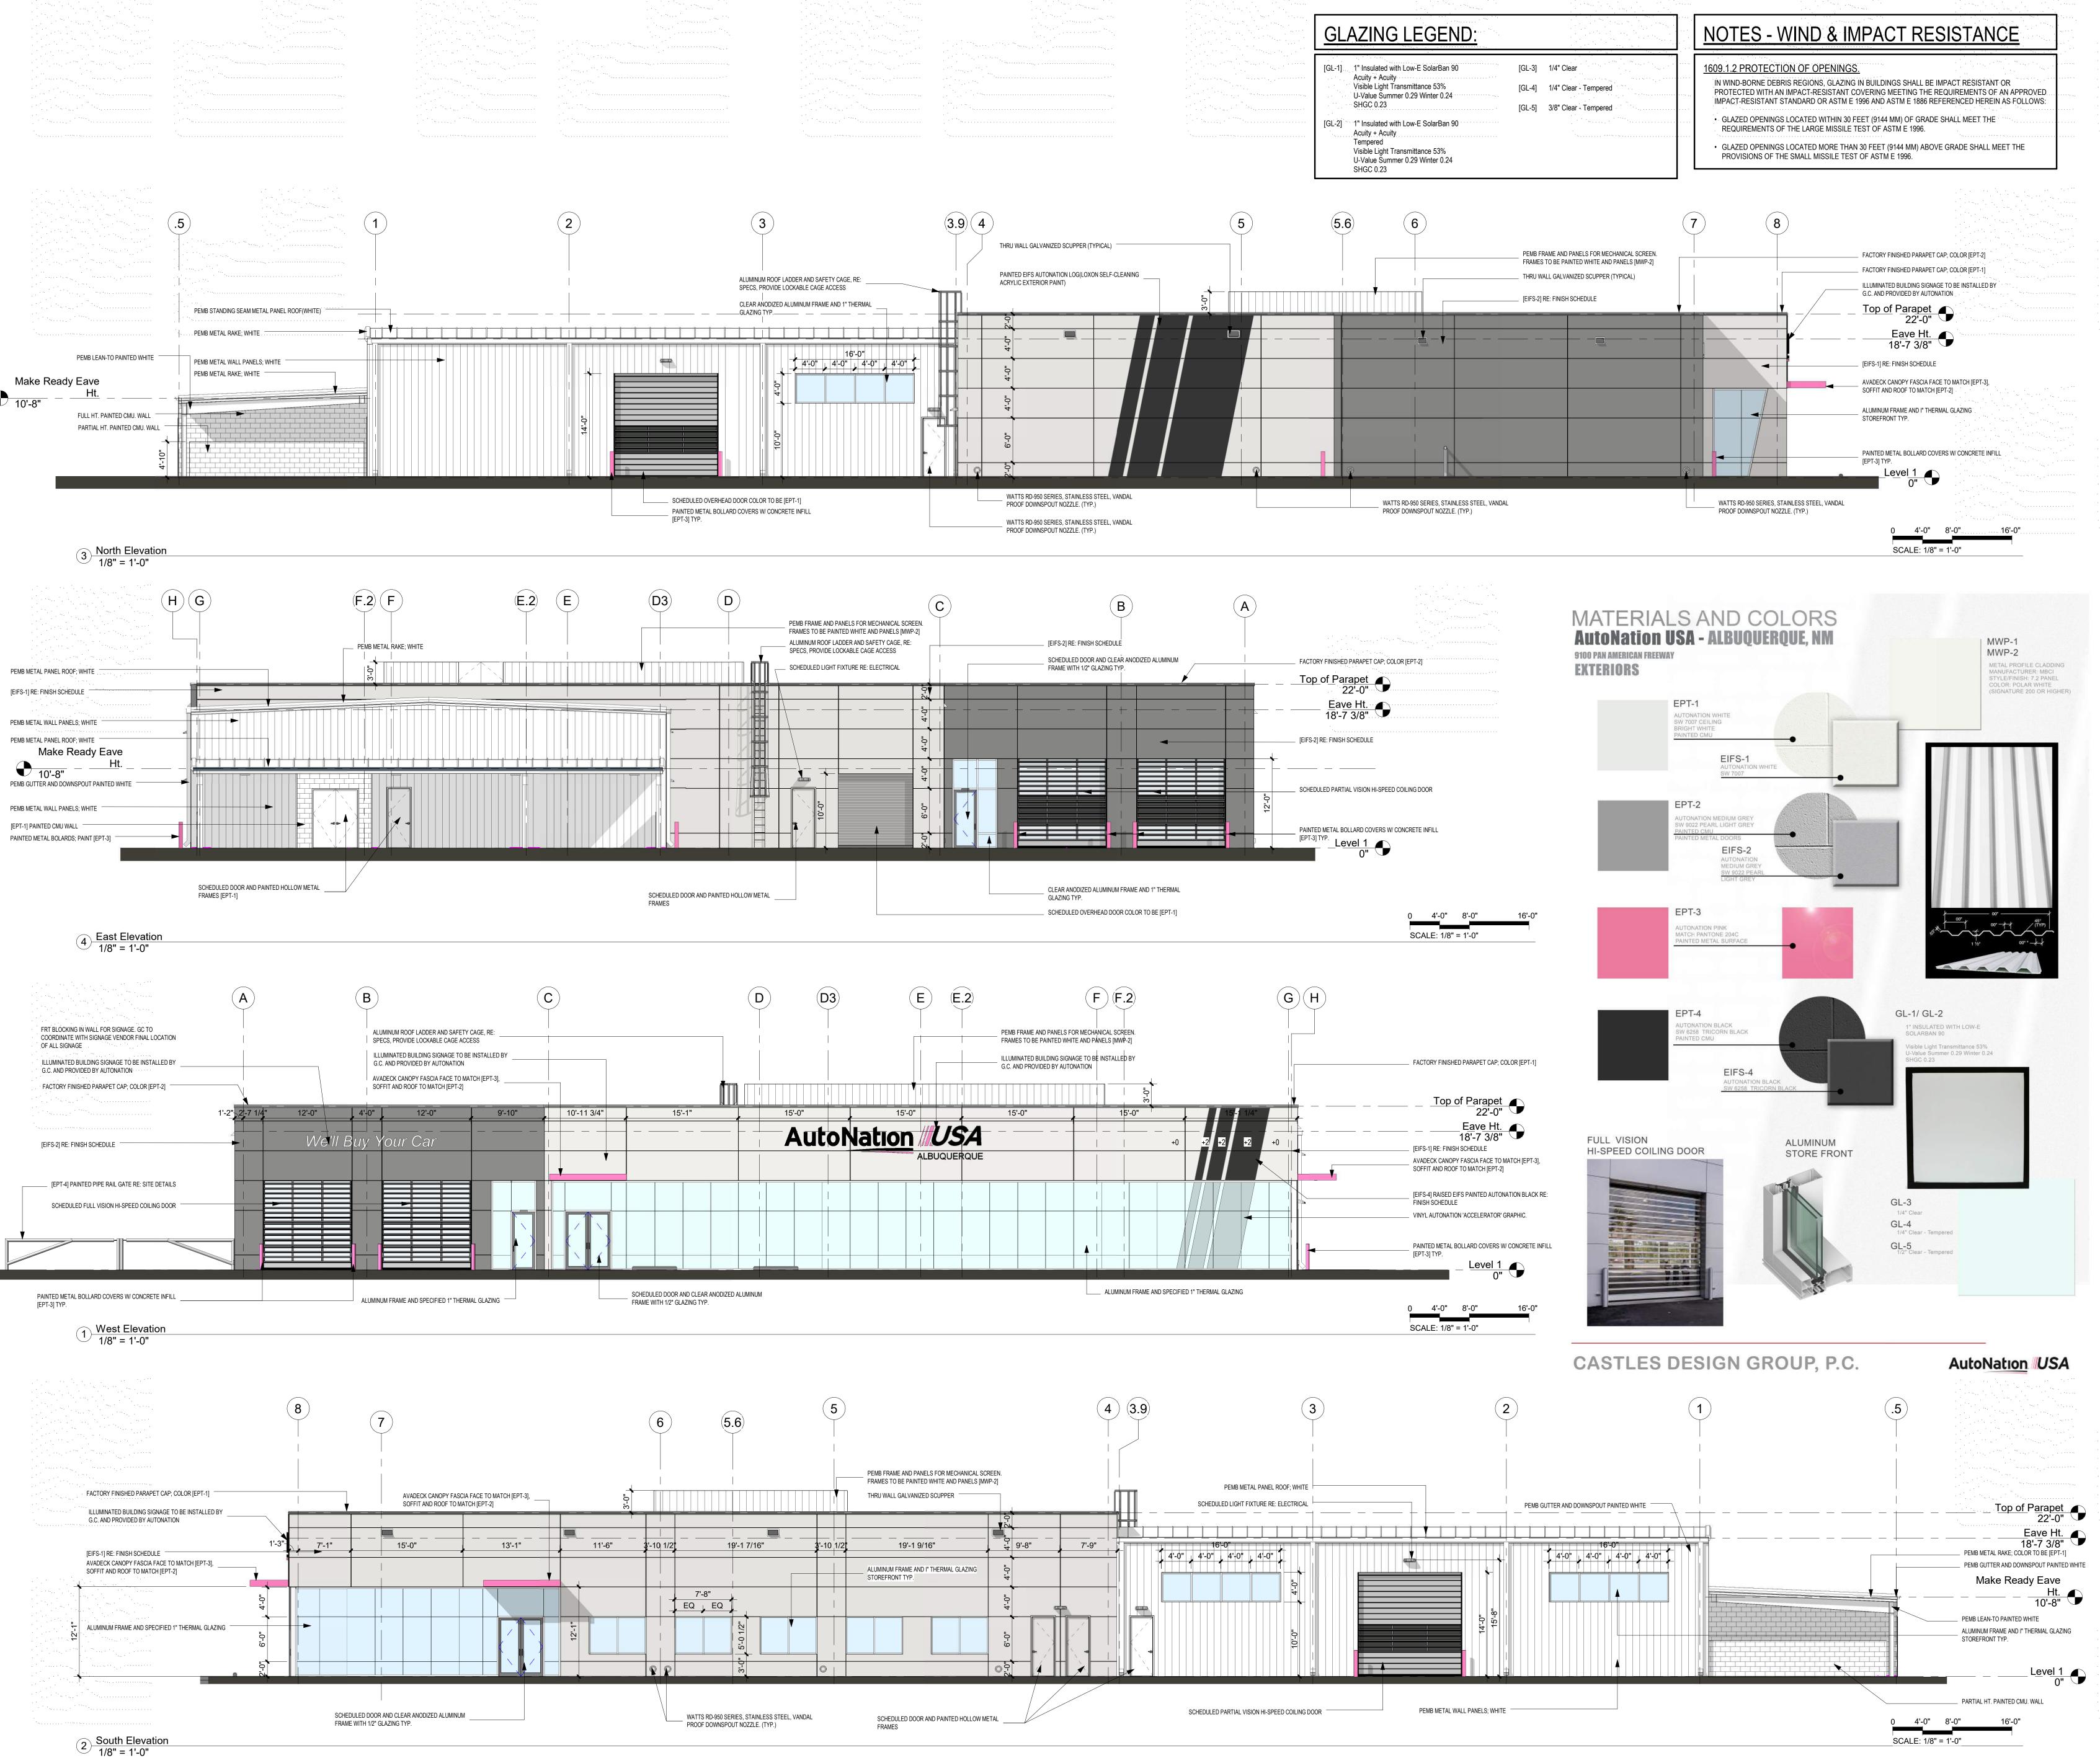

Revisions **Revision Schedule** Number Revision Description Date

THESE DOCUMENTS HAVE BEEN PREPARED SPECIFICALLY FOR THE FOLLOWING PROJECT: AUTONATION USA ALBUQUERQUE 100 PAN AMERICAN FREEWAY THEY ARE NOT SUITABLE FOR USE ON OTHER

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PROJECTS OR IN OTHER LOCATIONS WITHOUT THE APPROVAL AND PARTICIPATION OF


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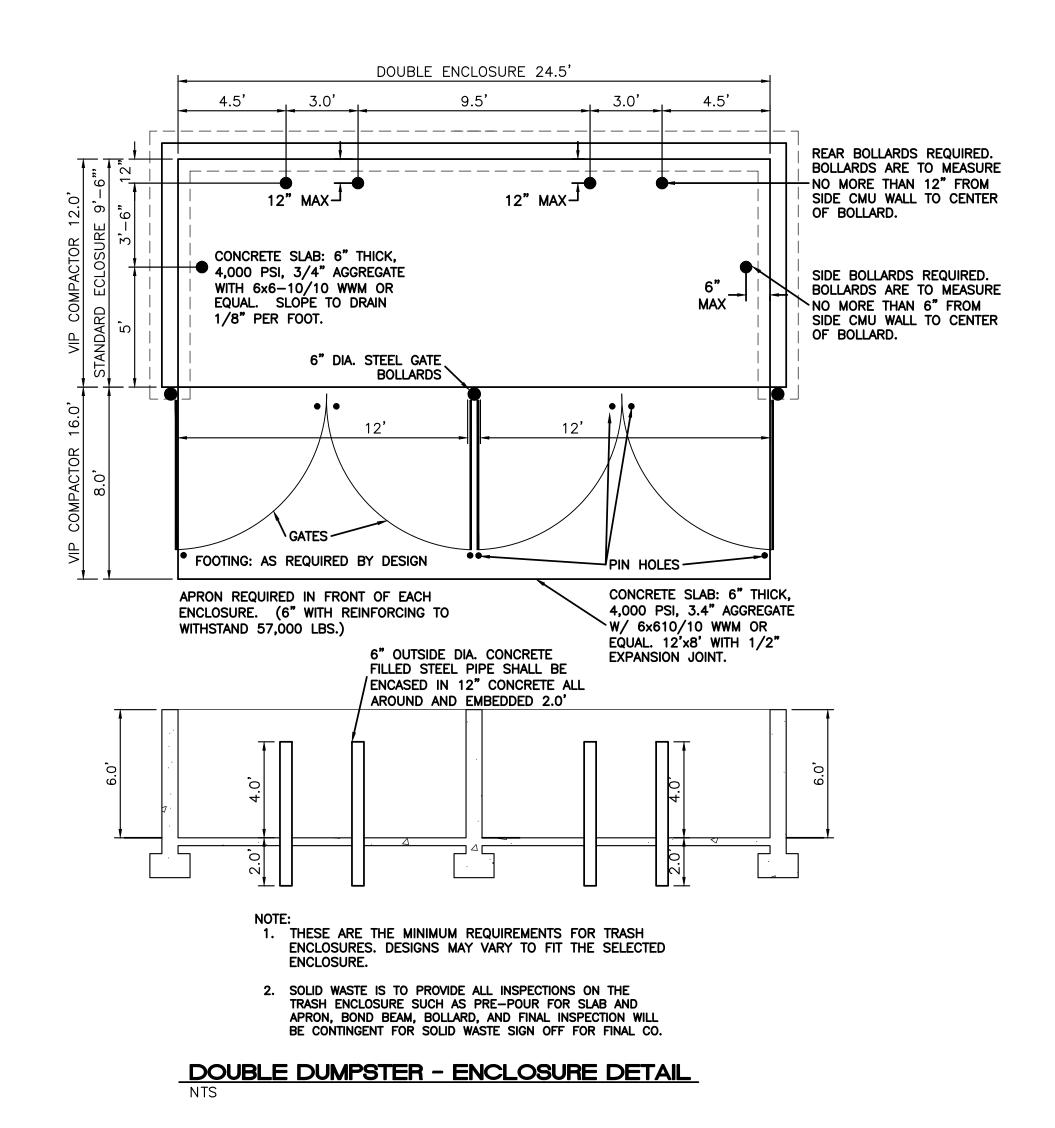
A Professional Architectural Corporation 3801 Kir by Dr., Suite 600 Houston, Texas 77098 tel: 713 664 7974 fax: 713 664 9756

> Exterior Elevations

Project No:

202011-467



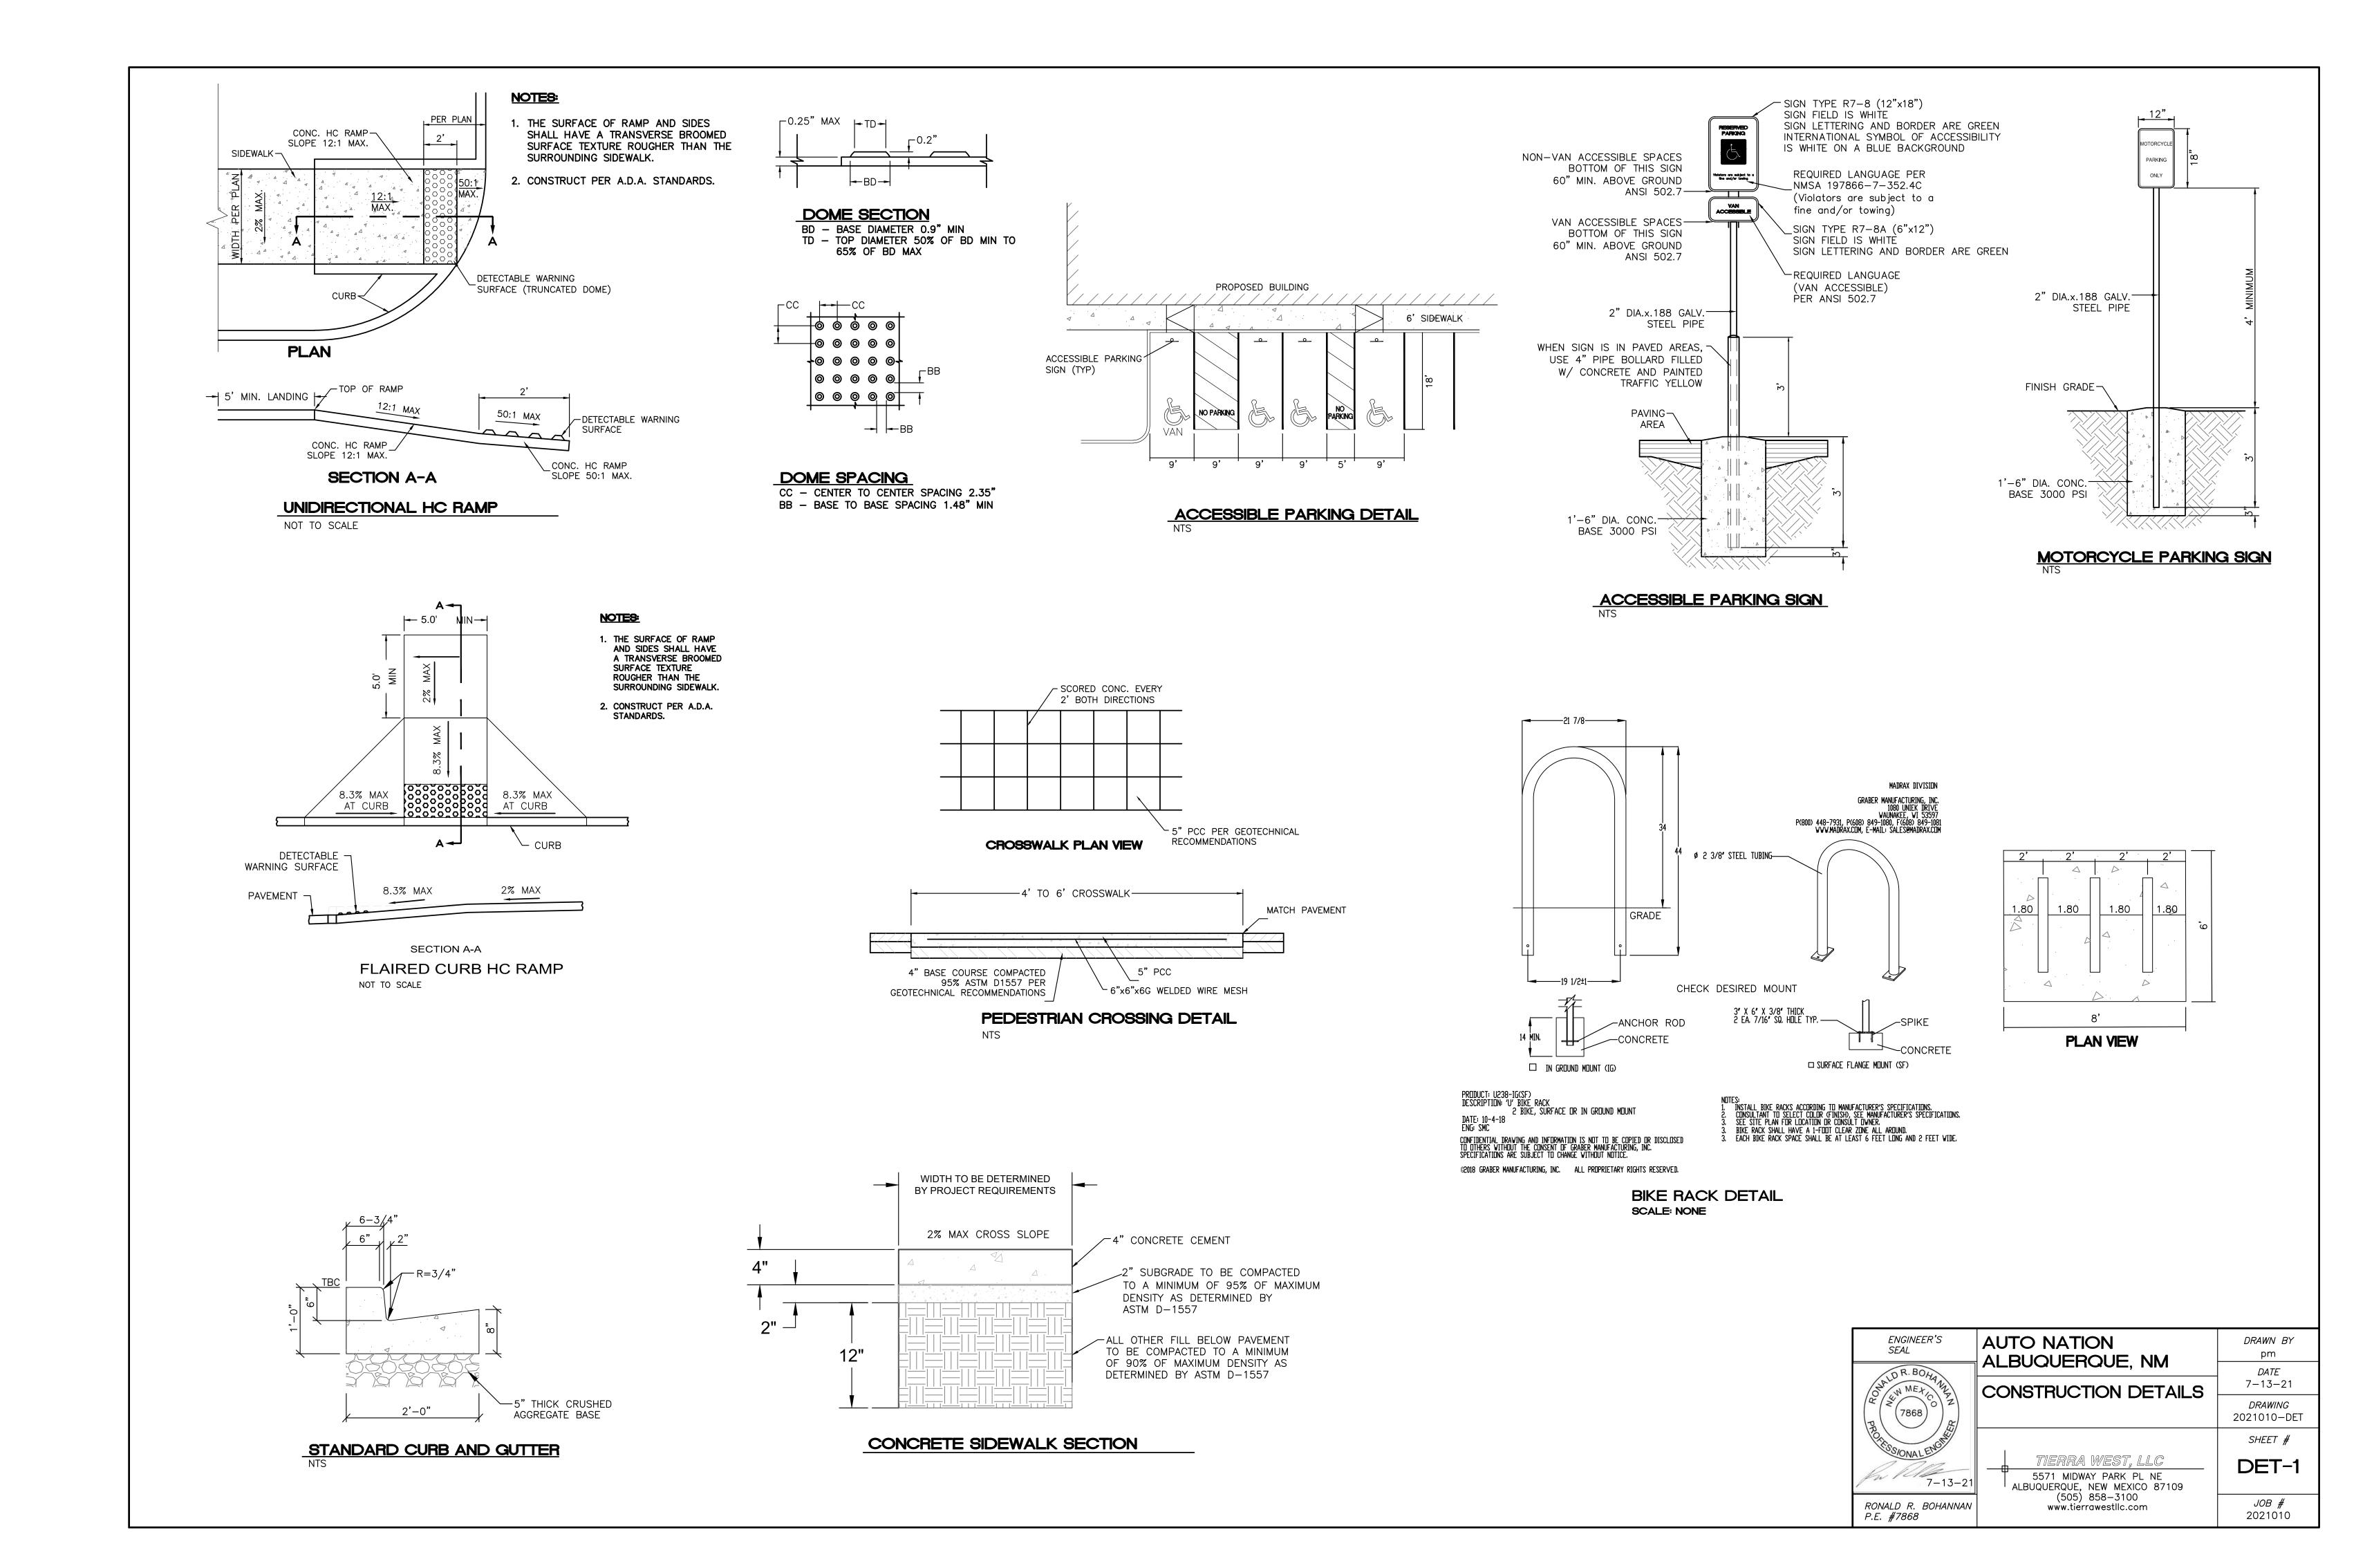

2" DIA.x.188 GALV.— STEEL PIPE

FINISH GRADE -


1'-6" DIA. CONC. BASE 3000 PSI


2" DIA.x.188 GALV.— STEEL PIPE

SERVICE AREA PARKING SIGN

FINISH GRADE -

1'-6" DIA. CONC.-BASE 3000 PSI

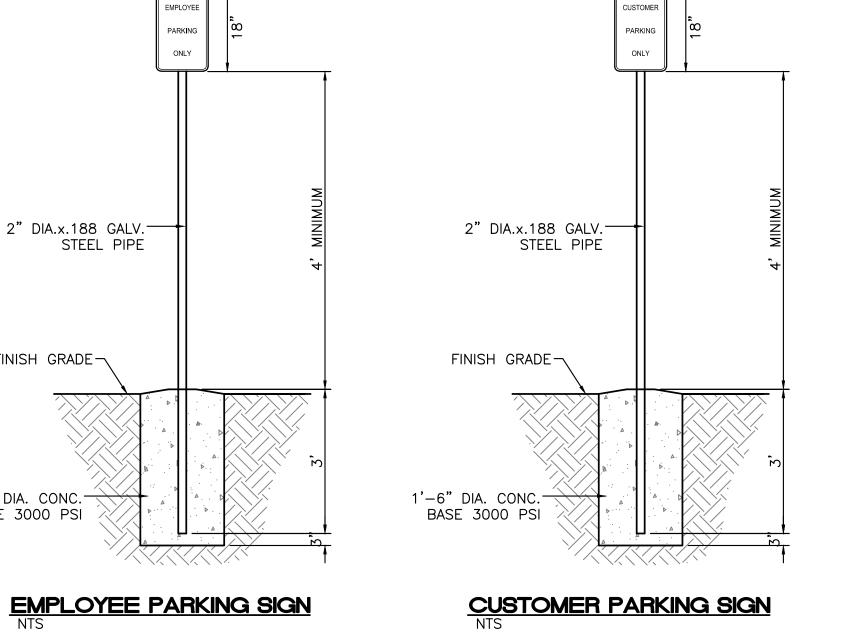

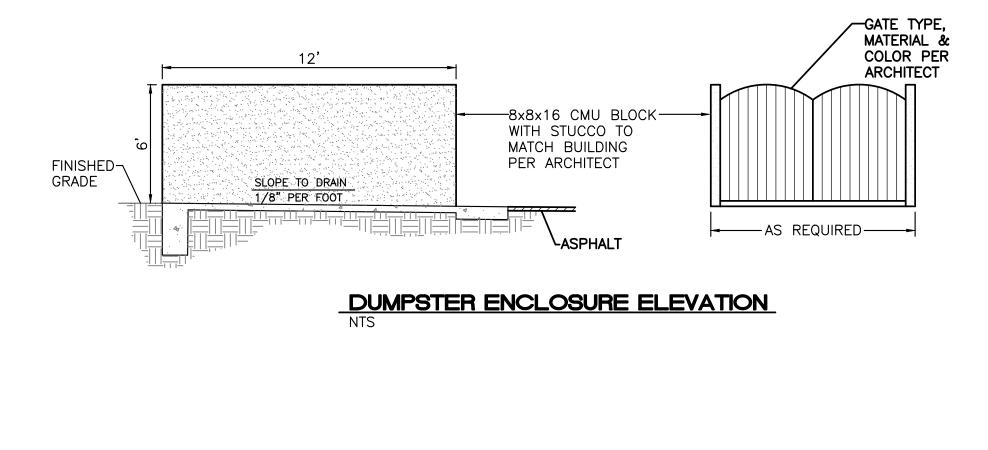

ENGINEER'S SEAL

7-13-21

RONALD R. BOHANNAN P.E. #7868

ON MEXICO (7868)

AUTO NATION

ALBUQUERQUE, NM

CONSTRUCTION DETAILS

TIERRA WEST, LLC

5571 MIDWAY PARK PL NE ALBUQUERQUE, NEW MEXICO 87109 (505) 858-3100

www.tiérrawestllc.com

DRAWN BY

pm

DATE 7-13-21

DRAWING 2021010-DET

SHEET #

DET-2

*JOB #* 2021010



# **Exterior Sign Package**

9100 PAN AMERICAN FREEWAY NE ALBUQUERQUE, NM S.O. #121410

Creation Date: 05.14.2021

Last Revised: 06.11.2021



National Headquarters: 1077 West Blue Heron Blvd.
West Palm Beach, Florida 33404
800.772.7932
www.atlasbtw.com

# Site Plan



# **Exterior Site Plan**

AutoNation USA C/Ltrs w/DBA FCOs

We'll Buy Your Car Channel Letters

AutoNation USA C/Ltrs


AutoNation USA C/Ltrs

Pylon Sign

Monument Sign

Directional Sign

**Door Hours** 

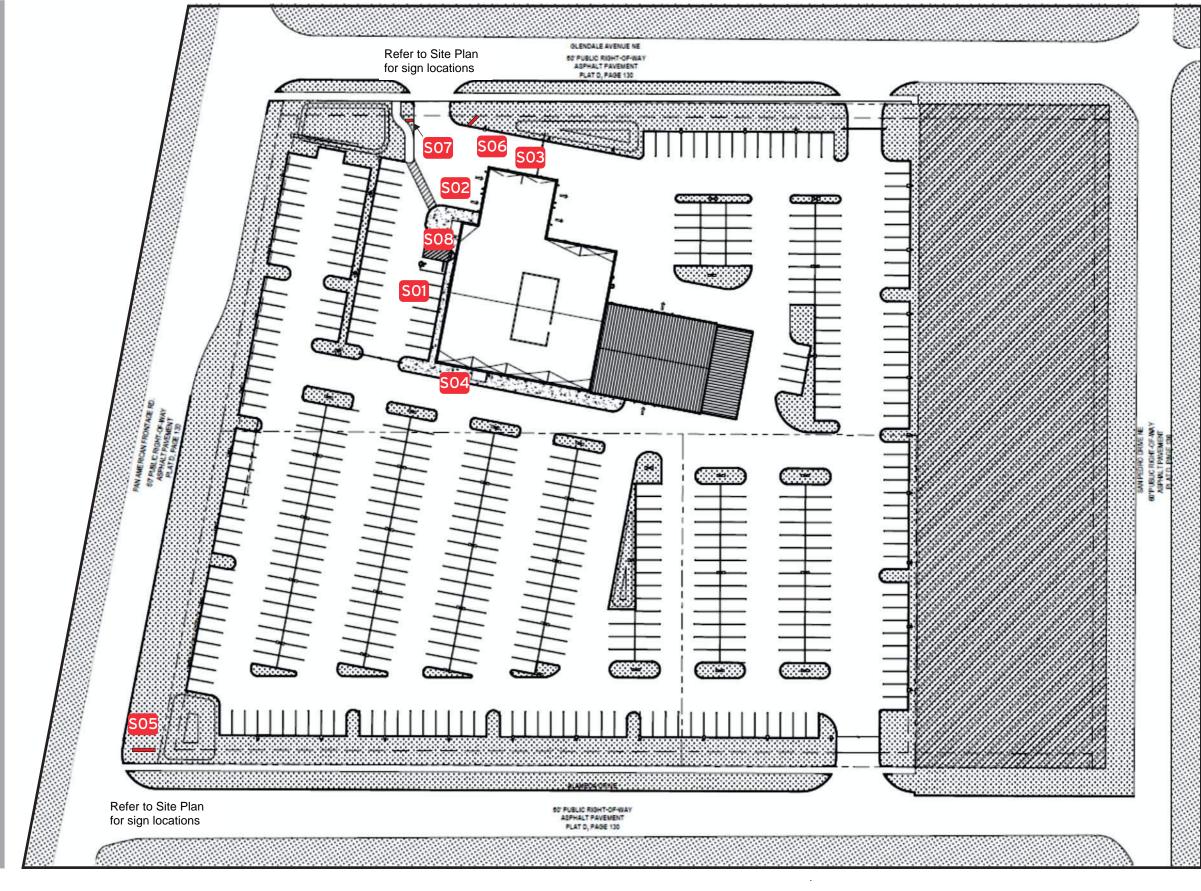




800.772.7932

www.atlasbtw.com

Code: 25% of Building Front sq.ft. Building = 4,182 s.f. x 25% = 1,405.5 s.f

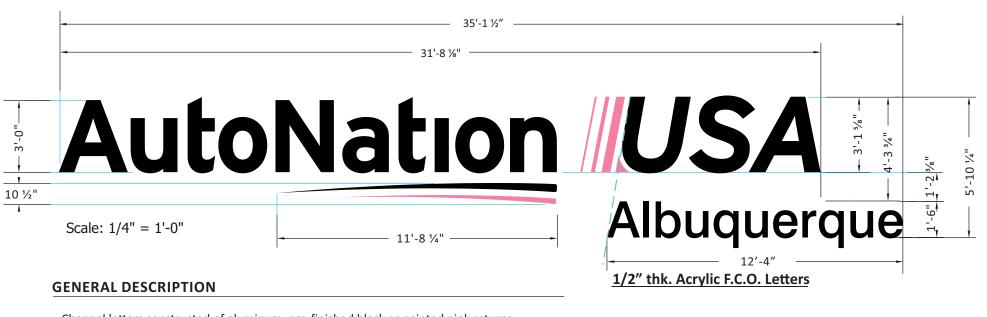

- Channel letters constructed of aluminum: pre-finished black or painted pink returns
- All faces of .177" white (2406) acrylic or polycarbonate
- Pink elements treated with full-coverage, 1st surface application of translucent pink vinyl (see color chart)
- Black elements treated with full-coverage, 1st surface application of perforated black (see color chart)
- Internal illumination of ALL components provided by white LED modules.
- "Denver North" 1/2" thick Acrylic F.C.O. Letters Painted Black Stud Mounted.
- All components installed flush to exterior with non-corrosive fasteners (specific hardware TBD)

#### COLOR SCHEDULE

All Faces: 2406 White Acrylic or Polycarbonate

Trimcaps #1: Pre-finished Black

Trimcaps #2: Painted to match PMS #204 Satin

Returns #1: Pre-finished (black) Aluminum

Returns #2: Painted to Match PMS 204 Pink (satin)

Vinyl Treatment #1: 3M 3635-222Black Perf. Vinyl

Vinyl Treatment #2: 3M 3630-68 Rose Mauve

.177" polycarbonate face
 letter backs to be .080" aluminum

3 4" returns to be .040" aluminum4 illumination to be provided by (see below)

5 1" trim ca

6 mounting varies upon location and wall material

7 IP67 rated power supply

8 junction box


9 listed disconnect switch


10 primary power source

11 weep hole cover to be white pre-finished alum.

12 weep hole

This is a generic detail. Mounting details and power supply placement will vary.

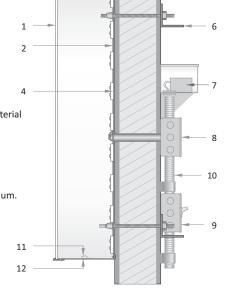

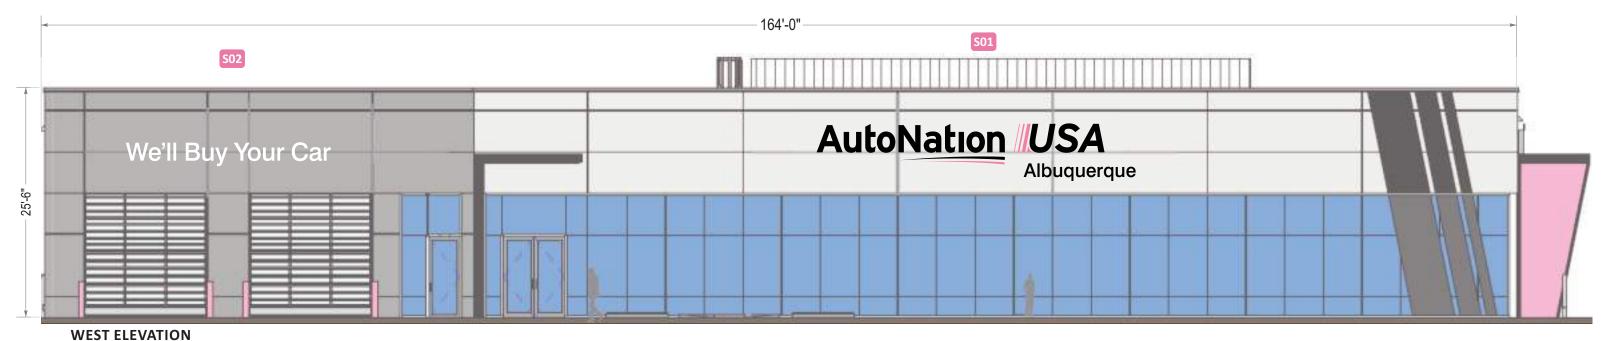



National Headquarters: 1077 West Blue Heron Blvd. West Palm Beach, Florida 33404 800.772.7932 www.atlasbtw.com

Revisions: 06.02.2021 - Pylon Position revision		
	•••	
Q6.11.2021 - Additional C/ltrs and revisions		∧
m		

**AutoNation** 

PM: AQ Address: 9100 PAN AMERICAN FREEWAY NE
Drawn By: EVS City State: ALBUQUERQUE, NM

Date: 05.24.2021 Drawing Number: 121410

Page: 3

Code: 25% of Building Front sq.ft. Building = 4,182 s.f. x 25% = 1,405.5 s.f



Scale: 3/8" = 1'-0"

#### **GENERAL DESCRIPTION**


- Channel letters constructed of aluminum: pre-finished black returns
- All faces of .177" white (2406) acrylic or polycarbonate
- Internal illumination of ALL components provided by white LED modules.
- All components installed flush to exterior with non-corrosive fasteners (specific hardware TBD)

#### **COLOR SCHEDULE**

All Faces: 2406 White Acrylic or Polycarbonate

Trimcaps #1: Pre-finished Black

Returns #1: Pre-finished (black) Aluminum

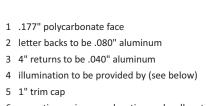

6 mounting varies upon location and wall material

7 IP67 rated power supply


8 junction box


9 listed disconnect switch

10 primary power source

11 weep hole cover to be white pre-finished alum.

12 weep hole
This is a generic detail.
Mounting details and power supply placement will vary.

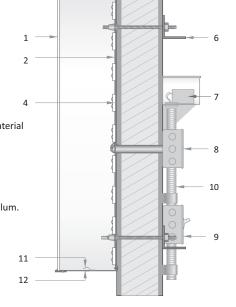

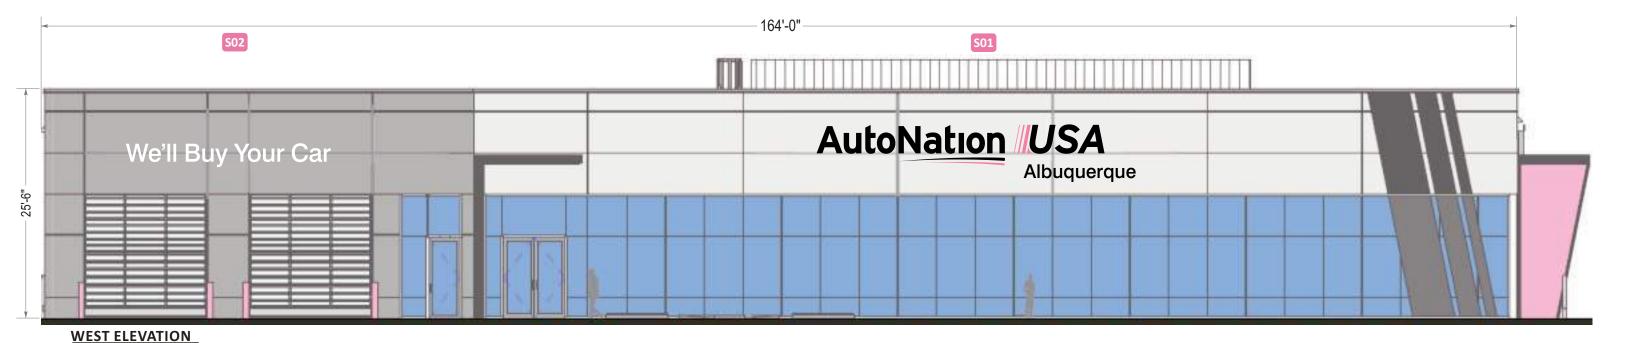



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Revisions:	
Q6.02.2021 - Pylon Position revision	
06.11.2021 - Additional C/ltrs and revisions	


**AutoNation** 

PM: AQ Address: 9100 PAN AMERICAN FREEWAY NE
Drawn By: EVS City State: ALBUQUERQUE, NM

Date: 05.24.2021 Drawing Number: 121410

Page: 4

Code: 25% of Building Front sq.ft. Building = 3,251 s.f. x 25% =812.81 s.f

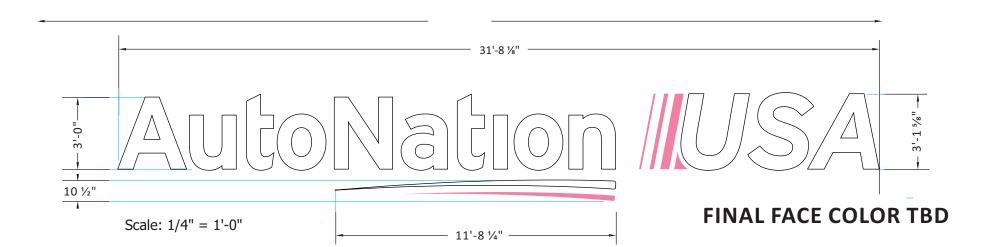



#### **GENERAL DESCRIPTION**

- Channel letters constructed of aluminum: pre-finished black or painted pink returns
- All faces of .177" white (2406) acrylic or polycarbonate
- · Pink elements treated with full-coverage, 1st surface application of translucent pink vinyl (see
- Internal illumination of ALL components provided by white LED modules.

#### **COLOR SCHEDULE** All Faces: 2406 White Acrylic or Polycarbonate Trimcaps #1: Pre-finished Black Trimcaps #2: Painted to match PMS #204 Satin Returns #1: Pre-finished (black) Aluminum

Returns #2: Painted to Match PMS 204 Pink (satin) Vinyl Treatment #2: 3M 3630-68 Rose Mauve

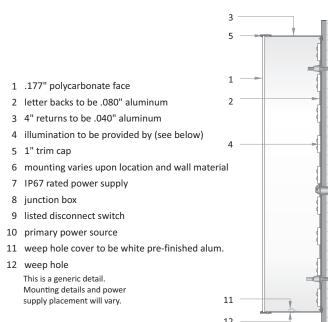

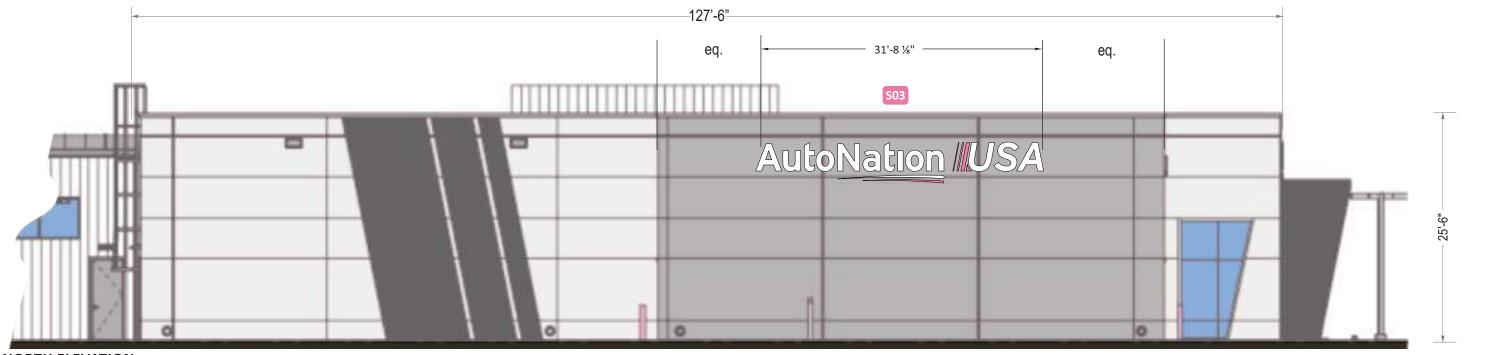

**NORTH ELEVATION** 

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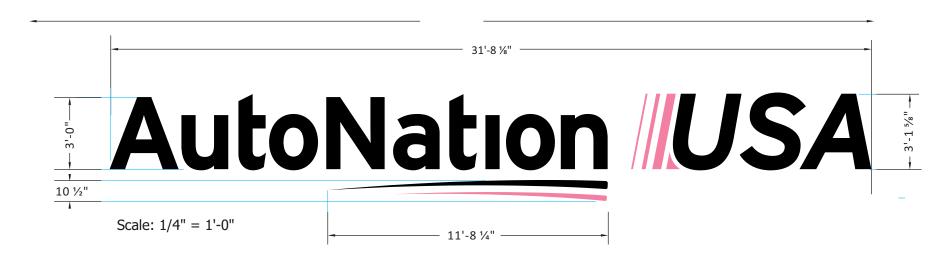
Revisions:  06.02.2021 - Pylon Position revision	PM: AQ	
00.02.2021 - Fylon Position Tevision		
06.11.2021 - Additional C/ltrs and revisions	 	Drawn By: <b>EVS</b>
	 	Date: <b>05/24/2021</b>
		Dale. <b>03/24/2021</b>

Address: 9100 Pan American Freeway NE City State: Albuquerque, NM

S.O. # 121410

Page# 5

Code: 25% of Building Front sq.ft. Building = 4,182 s.f. x 25% = 1,405.5 s.f



#### **GENERAL DESCRIPTION**

- Channel letters constructed of aluminum: pre-finished black or painted pink returns
- All faces of .177" white (2406) acrylic or polycarbonate
- Pink elements treated with full-coverage, 1st surface application of translucent pink vinyl (see color chart)
- Black elements treated with full-coverage, 1st surface application of perforated black (see color chart)
- Internal illumination of ALL components provided by white LED modules.
- "Denver North" 1/2" thick Acrylic F.C.O. Letters Painted Black Stud Mounted.
- · All components installed flush to exterior with non-corrosive fasteners (specific hardware TBD)

#### **COLOR SCHEDULE**

All Faces: 2406 White Acrylic or Polycarbonate

Trimcaps #1: Pre-finished Black


Trimcaps #2: Painted to match PMS #204 Satin


Returns #1: Pre-finished (black) Aluminum

Returns #2: Painted to Match PMS 204 Pink (satin)

Winyl Treatment #1: 3M 3635-222Black Perf. Vinyl

Vinyl Treatment #2: 3M 3630-68 Rose Mauve

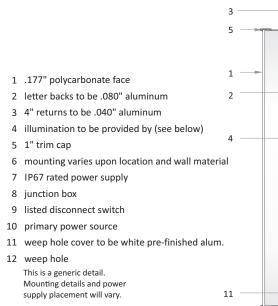

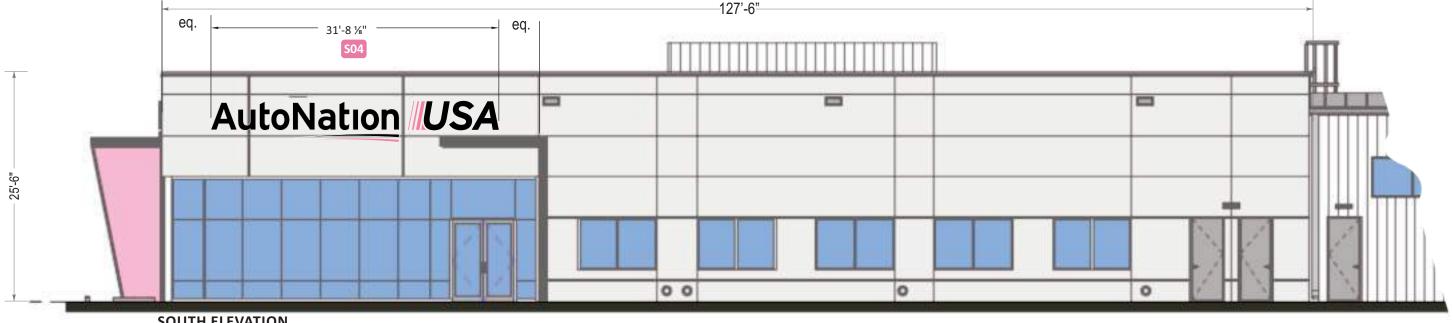

**SOUTH ELEVATION** 3/32" = 1'-0"



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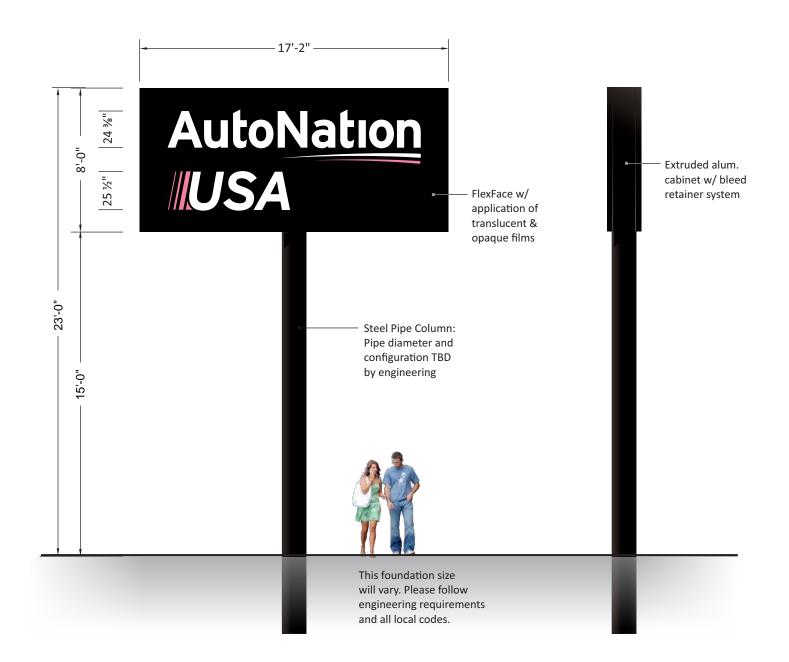
Revisions:		PM: AQ
6.02.2021 - Pylon Position revision		T IVI. AQ
6.11.2021 - Additional C/ltrs and revisions	 	Drawn By: <b>EVS</b>
	 	Date: <b>05/24/2021</b>
	 	Date: 03/24/2021

Address: 9100 Pan American Freeway NE
City State: Albuquerque, NM

Page#

S.O. # 121410

Code: CODE ALLOWS 1 GROUND SIGN WITH 26' OAH, 300 SQ. FT WITH 5' SETBACK.





#### ANU-P-84 **GENERAL DESCRIPTION**

- Double face, internally illuminated pylon sign featuring extruded aluminum cabinet with a bleed retainer and flexible faces.
- Faces of 3M white, flexible substrate with 1st surface application of translucent pink & opaque black films
- Internal illumination by white LED modules
- Cabinet installed onto steel column set in concrete foundation. Size of foundation varies per local codes and criterea


#### **COLOR SCHEDULE**

Painted MP 923SP Black (satin finish) Panaflex White Trans. Substrate 3M 7725-12 Opaque Black Vinyl 3M 3630-68 "Rose Mauve" Trans. Vinyl

White LED Modules (6500K)

#### **SQUARE FOOTAGE**

Proposed Sq. Feet: 7'-0" x 15'-0" = **105 Sq Feet** 

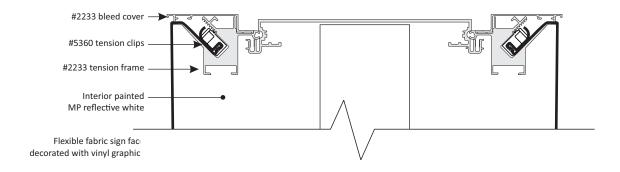

DF Wide Body with Bleed Face Retainer System



National Headquarters: 1077 West Blue Heron Blvd.

West Palm Beach, Florida 33404

Revisions:	
Q6.02.2021 - Pylon Position revision	
06.11.2021 - Additional C/ltrs and revisions	 Λ
	 _

**AutoNation** 

PM: AQ Address: 9100 PAN AMERICAN FREEWAY NE Drawn By: EVS City State: ALBUQUERQUE, NM

Date: 05.24.2021

Drawing Number: 121410

Page: 7


Code: Only (1) Ground Sign allowed per property. Variance will be required

Address: 9100 Pan American Freeway NE

Page# 8

City State: Albuquerque, NM

S.O. # 121410

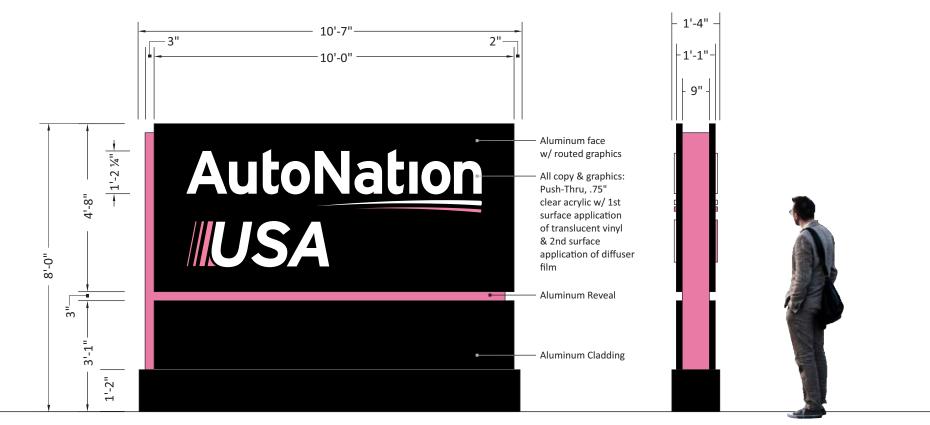



# ANU-M-96 GENERAL DESCRIPTION

- Double face, internally illuminated monument sign featuring pushed-thru acrylic graphics, and painted aluminum cladding & reveal.
- Faces of aluminum with copy & graphics routed from faces and pushedthru with .750" clear acrylic with 1st surface application of pink & white translucent film and a 2nd surface application of diffuser film
- 3" Continuos reveal to of aluminum & finished with pink enamel
- Internal illumination by white LED modules

National Headquarters: 1077 West Blue Heron Blvd.

- Skirt/base and all cladding is of painted aluminum
- Monument sign set in concrete foundation(s). Size of foundation varies per
- local codes and criteria

West Palm Beach, Florida 33404

www.atlasbtw.com

#### **COLOR SCHEDULE**

Painted MP 923SP Black (satin finish)

Clear Acrylic

Painted to match PMS 204 (satin finish)


3M 3630-20 White Trans. Vinyl

3M 3630-68 "Rose Mauve" Trans. Vinyl

White LED Modules (6500K)

#### SQUARE FOOTAGE


Proposed Sq. Feet: 4'-8" x 10'-0" = **46.67 Sq Feet** 

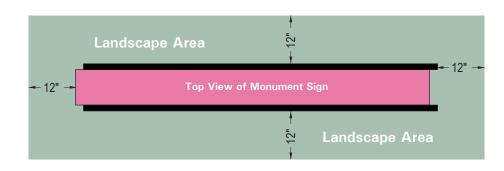



12" Perimeter around base of monument is to be reserved for landscaping - not grass



Revisions:		PM: AQ
06.02.2021 - Pylon Position revision	 	1 171. 714
06.11.2021 - Additional C/ltrs and revisions	 	Drawn Bv: EVS
	 	Date: 05/24/2021

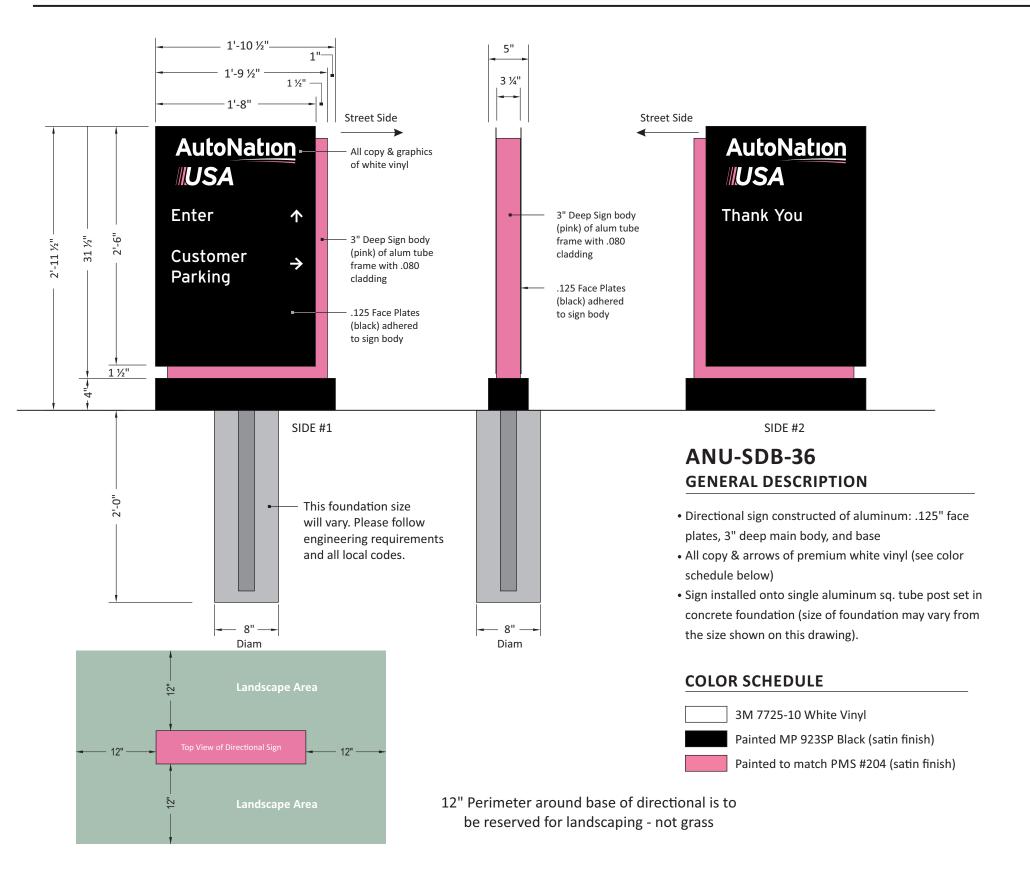

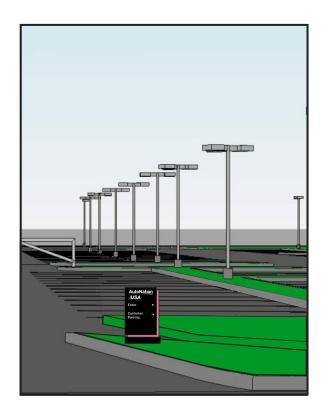

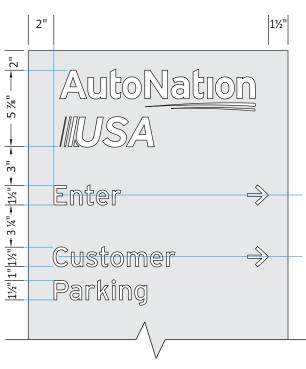

TYPICAL LETTER HEIGHT AND SPACING



National Headquarters: 1077 West Blue Heron Blvd.

06.02.2021 - Pylon Position revision 06.11.2021 - Additional C/ltrs and revisions PM: AQ Drawn By: EVS

Date: 05/24/2021

Address: 9100 Pan American Freeway NE

City State: Albuquerque, NM

S.O. # 121410


Page# 9



National Headquarters: 1077 West Blue Heron Blvd.

West Palm Beach, Florida 33404

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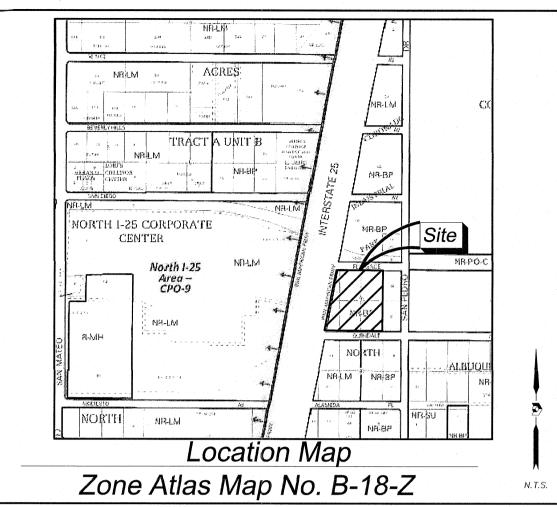
When there are double-Entry doors, the vinyl graphics will be placed on the right door

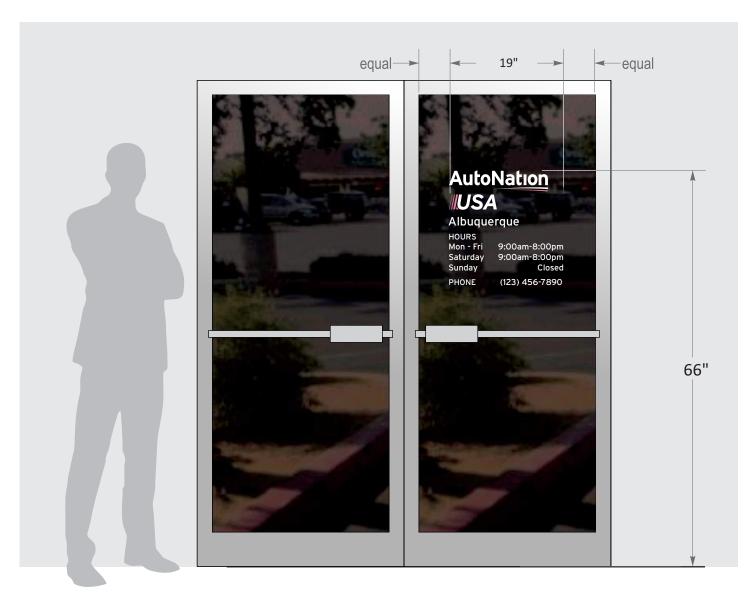Page# 10

#### **General Specificaations Color Specificaations** • White with pink vinyl copy and numbers 3M 7725-10 White vinyl • Vinyl applied to 1st surface 3M 3630-68 Rose Mauve



Revisions:		PM: AQ	Address: 9100 Pan American Freeway NE			
06.02.2021 - Pylon Position revision			1 IVI. AQ	Addicas. 5100 I all Allierican	Treeway	4L
06.11.2021 - Additional C/ltrs and revisions			Drawn Bv: EVS	City State: Albuquerque, NM		
				7		
			Date: <b>05/24/2021</b>	S.O. # <b>121410</b>	Page#	10
			Date. <b>03/24/2021</b>	0.0. // 121410	1 age //	



# Subdivision Data:

GROSS SUBDIVISION ACREAGE: 5.2896 ACRES± ZONE ATLAS INDEX NO: B-18-Z NO. OF TRACTS CREATED: 0 NO. OF LOTS CREATED: 1 MILES OF FULL-WIDTH STREETS CREATED: 0

# Drainage Facilities and/or

Detention Areas Maintained by Lot Owner

Areas designated on the accompanying plat as "drainage easements" are hereby dedicated by the owner as a perpetual easement for the common use and benefit of the various lots within the subdivisions for the purpose of permitting the conveyance of storm water runoff and the constructing and maintaining of drainage facilities in accordance with standards prescribed by the city of albuquerque. No fence, wall, planting, building or other obstruction may be placed or maintained in easement area without approval of the city engineer of the city of albuquerque. There also shall be no alteration of the grades or contours in said easement area without the approval of the city engineer. It shall be the duty of the lot owners of this subdivision to maintain said drainage easement and facilities at their cost in accordance with standards prescribed by the city of albuquerque. The city shall have the right to enter periodically to inspect the facilities. In the event said lot owners fail to adequately and properly maintain drainage easement and facilities, at any time following fifteen (15) days written notice to said lot owners, the city may enter upon said area, perform said maintenance, and the cost of performing said maintenance shall be paid by applicable lot owners proportionately on the basis of lot ownership, in the MAINTENANCE, AND THE COST OF PERFORMING SAID MAINTENANCE SHALL BE PAID BY APPLICABLE LOT OWNERS PROPORTIONATELY ON THE BASIS OF LOT OWNERSHIP. IN THE EVENT LOT OWNERS FAIL TO PAY THE COST OF MAINTENANCE WITHIN THIRTY (30) DAYS AFTER DEMAND FOR PAYMENT MADE BY THE CITY, THE CITY MAY FILE A LIEN AGAINST ALL LOTS IN THE SUBDIVISION FOR WHICH PROPORTIONATE PAYMENT HAS NOT BEEN MADE. THE OBLIGATIONS IMPOSED HEREIN SHALL BE BINDING UPON THE OWNER, HIS HEIRS, AND ASSIGNS AND SHALL RUN WITH ALL LOTS WITHIN THIS SUBDIVISION.

THE GRANTOR AGREES TO DEFEND, INDEMNIFY, AND HOLD HARMLESS, THE CITY, ITS OFFICIALS, AGENTS AND EMPLOYEES FROM AND AGAINST ANY AND ALL CLAIMS, ACTIONS, SUITS, OR PROCEEDINGS OF ANY KIND BROUGHT AGAINST SAID PARTIES FOR OR ON ACCOUNT OF ANY MATTER ARISING FROM THE DRAINAGE FACILITY PROVIDED FOR HEREIN OR THE GRANTOR'S FAILURE TO CONSTRUCT, MAINTAIN, OR MODIFY SAID DRAINAGE FACILITY.

# Dedication of Drainage Easements:

CITY CONSTRUCTS AND MAINTAINS A PERPETUAL EASEMENT ON THE AREAS DESIGNATED ON THIS PLAT AS "DRAINAGE EASEMENT" IS HEREBY DEDICATED TO THE CITY OF ALBUQUERQUE FOR THE PURPOSE OF PERMITTING THE CONVEYANCE OF STORM WATER RUNOFF AND FOR THE PURPOSE OF CONSTRUCTING, MAINTAINING, OPERATING, REMOVING, AND REPLACING STORM WATER DRAINAGE FACILITIES. NO FENCE, WALL, PLANTING, BUILDING, OR OTHER OBSTRUCTION MAY BE PLACED OR MAINTAINED IN SAID EASEMENT AREA AND THERE SHALL BE NO ALTERATION OF THE GRADES OR CONTOURS IN SAID DEDICATED AREA WITHOUT THE APPROVAL OF THE CITY ENGINEER OF THE CITY OF ALBUQUERQUE. NO OBSTRUCTIONS MAY BE PLACED IN EASEMENT AREA WHICH WOULD PREVENT INCRESS AND EGRESS TO SAME BY MAINTENANCE VEHICLES OR WHICH WOULD PREVENT VEHICLES TRAVELING ON DRAINAGE WAY FOR MAINTENANCE PURPOSES.

# Public Utility Easements

PUBLIC UTILITY EASEMENTS SHOWN ON THIS PLAT ARE GRANTED FOR THE COMMON JOINT USE OF:

A. PUBLIC SERVICE COMPANY OF NEW MEXICO ("PNM"), A NEW MEXICO COPPORATION, (PNM ELECTRIC) FOR INSTALLATION, MAINTENANCE AND SERVICE OF OVERHEAD AND UNDERGROUND ELECTRICAL LINES, TRANSFORMERS, AND OTHER EQUIPMENT AND RELATED FACILITIES REASONABLY NECESSARY TO PROVIDE ELECTRICAL SERVICES.

B. <u>NEW MEXICO GAS COMPANY</u> FOR INSTALLATION, MAINTENANCE, AND SERVICE OF NATURAL GAS LINES, VALVES AND OTHER EQUIPMENT AND FACILITIES REASONABLY NECESSARY TO PROVIDE NATURAL GAS SERVICES.

C. <u>QWEST CORPORATION D/B/A CENTURYLINK QC</u> FOR THE INSTALLATION, MAINTENANCE, AND SERVICE OF SUCH LINES, CABLE, AND OTHER RELATED EQUIPMENT AND FACILITIES REASONABLY NECESSARY TO PROVIDE COMMUNICATION SERVICES.

D. <u>CABLE TV</u> FOR THE INSTALLATION, MAINTENANCE, AND SERVICE OF SUCH LINES, CABLE, AND OTHER RELATED EQUIPMENT AND FACILITIES REASONABLY NECESSARY TO PROVIDE CABLE SERVICES.

LUDED IS THE RIGHT TO BUILD, REBUILD, CONSTRUCT, RECONSTRUCT, LOCATE, RELOCATE WITHIN THE EASEMENT CHANGE, REMOVE, REPLACE, MODIFY, RENEW, OPERATE AND MAINTAIN FACILITIES FOR PURPOSES DESCRIBED ABOVE. TOGETHER WITH FREE ACCESS TO, FROM AND OVER SAID EASEMENTS, WITH THE RIGHT AND PRIVILEGE OF GOING UPON, OVER AND ACROSS ADJOINING LANDS OF GRANTOR FOR THE PURPOSES SET FORTH HEREIN AND WITH THE RIGHT TO UTILIZE THE RIGHT OF WAY AND EASEMENT TO EXTEND SERVICES TO CUSTOMERS OF GRANTEE, INCLUDING SUFFICIENT WORKING AREA SPACE FOR ELECTRIC TRANSFORMERS, WITH THE RIGHT AND PRIVILEGE TO TRIM AND REMOVE TREES. SHRUBS OR BUSHES WHICH INTERFERE WITH THE PURPOSES SET FORTH HEREIN. NO BUILDING, SIGN, POOL (ABOVEGROUND OR SUBSURFACE), HOT TUB, CONCRETE OR WOOD POOL DECKING, OR OTHER STRUCTURE SHALL BE ERECTED OR CONSTRUCTED ON SAID EASEMENTS, NOR SHALL WELL BE DRILLED OR OPERATED THEREON. PROPERTY OWNERS SHALL BE SOLELY RESPONSIBLE FOR CORRECTING ANY VIOLATIONS OF NATIONAL ELECTRICAL SAFETY CODE BY CONSTRUCTION OF POOLS, DECKING, OR ANY STRUCTURES ADJACENT TO OR NEAR EASEMENTS SHOWN ON PLAT

EASEMENTS FOR ELECTRIC TRANSFORMER/SWITCHGEARS, AS INSTALLED, SHALL EXTEND TEN (10) FEET IN FRONT OF TRANSFORMER/SWITCHGEAR DOORS AND FIVE

#### Disclaimer

		RE	VISIONS	D/B/A
NO.	DATE	BY	DESCRIPTION	SEARCH
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IN APPROVING THIS PLAT, PUBLIC SERVICE COMPANY OF NEW MEXICO (PNM), QWEST CORPORATION CENTURYLINK QC AND NEW MEXICO GAS COMPANY (NMGC) DID NOT CONDUCT A TITLE H OF THE PROPERTIES SHOWN HEREON. CONSEQUENTLY, PNM, QWEST CORPORATION D/B/A IRYLINK QC AND NMGC DO NOT WAIVE OR RELEASE ANY EASEMENT OR EASEMENT RIGHTS HAVE BEEN GRANTED BY PRIOR PLAT, REPLAT OR OTHER DOCUMENT AND WHICH ARE NOT SPECIFICALLY DESCRIBED AND ON THIS PLAT.

OVED ON THE CONDITION THAT ALL RIGHTS OF THE MIDDLE RIO GRANDE CONSERVANCY CT IN FASEMENTS. RIGHTS OF WAY ASSESSMENTS AND LIENS, ARE FULLY RESERVED TO SAID . AND THAT IF PROVISION FOR IRRIGATION SOURCE AND EASEMENTS ARE NOT PROVIDED FOR SUBDIVIDER FOR THE SUBDIVISION, ADDITION, OR PLAT, SAID DISTRICT IS ABSOLVED OF ALL ATIONS TO FURNISH IRRIGATION WATERS AND SERVICES TO ANY PORTIONS THEREOF, OTHER FROM EXISTING TURNOUTS.

TREASURER'S CERTIFICATE

RECORDING STAMP

# Legal Description

A TRACT OF LAND LYING AND SITUATE WITHIN THE ELENA GALLEGOS GRANT, PROJECTED SECTION 12, TOWNSHIP 11 NORTH, RANGE 3 EAST, N.M.P.M., CITY OF ALBUQUERQUE, BERNALILLO COUNTY, NEW MEXICO, COMPRISING OF FORMER LOTS 13 (REMNANT PORTION), 14 15, 18, 19, 20 (REMNANT PORTION) AND 21 (REMNANT PORTION), BLOCK 8, TRACT A, UNIT B, NORTH ALBUQUERQUE ACRES, AS RECORDED APRIL 24, 1936, D—130, OF THE BERNALILLO COUNTY RECORDS, BEING MORE PARTICULARLY DESCRIBED BY NEW MEXICO STATE PLANE COORDINATE SYSTEM, GRID BEARINGS (NAD 83-CENTRAL ZONE) AND GROUND DISTANCES AS

BEGINNING AT THE SOUTHEAST CORNER OF THIS DESCRIBED LOT, BEING A NO. 5 REBAR WITH A PINK PLASTIC CAP MARKED "PS 11993" SET ON THE NORTH RIGHT OF WAY LINE OF ALAMEDA PLACE, N.E. (60-FOOT WIDE RIGHT OF WAY), WHENCE A.G.R.S. MONUMENT "10\_C18" BEARS S 67°01'08" E, 210.34 FEET;

THENCE FROM THE POINT OF BEGINNING, ALONG SAID NORTH RIGHT OF WAY LINE, N 89°45'23" W, 535.34 FEET TO A NO. 4 REBAR WITH A YELLOW PLASTIC CAP (ILLEGIBLE) FOUND AT THE INTERSECTION WITH THE EAST RIGHT OF WAY LINE OF NORTHBOUND PAN AMERICAN FRONTAGE ROAD N.E. (NMP F1-001-4(3)(4)(5), 80-F00T WIDE RIGHT OF WAY), FOR THE SOUTHWEST CORNER OF THIS LOT;

THENCE ALONG SAID EAST RIGHT OF WAY LINE, N 10'45'09" E, 476.71 FEET TO A 2-INCH IRON PIPE FOUND AT THE INTERSECTION WITH THE SOUTH RIGHT OF WAY LINE OF GLENDALE AVENUE, N.E. (60-FOOT WIDE RIGHT OF WAY), FOR THE NORTHWEST CORNER OF THIS LOT; THENCE ALONG SAID SOUTH RIGHT OF WAY LINE, S 89°40'27" E, 448.46 FEET TO A NO. 5 REBAR WITH A PINK PLASTIC CAP MARKED "PS 11993" SET FOR THE NORTHEAST CORNER

THENCE LEAVING SAID RIGHT OF WAY LINE, S 00"15"03" W, 468.07 FEET TO THE POINT OF BEGINNING, CONTAINING 5.2896 ACRES, MORE OR LESS.

# Purpose of Plat

THE PURPOSE OF THIS PLAT IS TO CONSOLIDATE THE EXISTING 7 LOTS INTO ONE NEW LOT. TO VACATE 2 EXISTING EASEMENTS AND TO GRANT 2 NEW EASEMENTS.

# Solar Note:

NO PROPERTY WITHIN THE AREA OF REQUESTED FINAL ACTION SHALL AT ANY TIME BE SUBJECT TO A DEED RESTRICTION, COVENANT, OR BINDING AGREEMENT PROHIBITING SOLAR COLLECTORS FROM BEING INSTALLED ON BUILDINGS OR ERECTED ON THE LOTS OF PARCELS WITHIN THE AREA OF THIS

# Free Consent

THE REPLAT SHOWN HEREON IS WITH THE FREE CONSENT AND IN ACCORDANCE WITH THE DESIRES OF THE UNDERSIGNED OWNER. EXISTING PUBLIC UTILITY EASEMENTS SHOWN HEREON FOR THE COMMON AND JOINT USE OF GAS, ELECTRICAL POWER AND COMMUNICATION SERVICES FOR BURIED AND/OR OVERHEAD DISTRIBUTION LINES, CONDUITS, AND PIPES FOR UNDERGROUND UTILITIES WHERE SHOWN OR INDICATED, AND INCLUDING THE RIGHT OF INGRESS AND EGRESS FOR CONSTRUCTION AND MAINTENANCE, AND THE RIGHT TO TRIM INTERFERING TREES AND SHRUBS. SAID OWNER DOES HEREBY CERTIFY THAT THIS SUBDIVISION IS THEIR FREE ACT AND DEED. SAID OWNERS WARRANT THAT THEY HOLD AMONG THEM COMPLETE AND INDEFEASIBLE TITLE IN FEE SIMPLE TO THE LAND

SAID OWNER DOES HEREBY GRANT ALL EASEMENTS AS SHOWN HEREON WITH LISTED BENEFICIARIES



ALBQUQUERQUE ANUSA, LLC A DELAWARE LIMITED LIABILITY COMPANY

# Acknowledgment

COUNTY OF BROWARD) SS

THIS INSTRUMENT WAS ACKNOWLEDGED BEFORE ME THIS 23 DAY OF SUDE CHARLES W. SABADASH III, ALBUQUERQUE ANUSA, LLC, A DELAWARE LIMITED LIABILITY COMPANY.



CHARLENE J. TOTING Notary Public - State of Commission # HH 34 \*\*

My Comm. Expires For \*\*



PRECISION

SURVEYS, INC.

OFFICE LOCATION: 9200 San Mateo Boulevard, NE Albuquerque, NM 87113 505,856,5700 PHONE

PROJECT INFORMATION CREW/TECH: DATE OF SURVEY MT/ML/JR 03/17-23/2021 DRAWN BY: CHECKED BY: 505.856.7900 FAX PSI JOB NO. SHEET NUMBER 216022P 1 OF 2

# Lot 21-A, Block 8 Tract A, Unit B North Albuquerque Acres

Plat of

Elena Gallegos Grant, Projected Section 12, Township 11 North, Range 3 East, N.M.P.M. Albuquerque, Bernalillo County, New Mexico June 2021

# Project No. PR-2021-005411 Application No. SD -2021-00100 Utility Approvals

PNM						DATE	
NEW MEXICO	GAS COMF	PANY				DATE	
QWEST CORP	ORATION D	/B/A CE	NTURYLI	NK QC		DATE	
COMCAST						DATE	

## City Annroyale

Loren N. Risenhoover P.S.	7/2/2021
CITY SURVEYOR	DATE
TRAFFIC ENGINEERING, TRANSPORTATION DEPARTMENT	DATE
A.B.C.W.U.A.	DATE
PARKS AND RECREATION DEPARTMENT	DATE
AMAFCA	DATE
CITY ENGINEER	DATE
DRB CHAIRPERSON, PLANNING DEPARTMENT	DATE
CODE ENFORCEMENT	DATE
MRGCD	DATE
NMDOT	DATE

# Surveyor's Certificate

I, LARRY W. MEDRANO, A LICENSED NEW MEXICO PROFESSIONAL LAND SURVEYOR UNDER THE LAWS OF THE STATE OF NEW MEXICO, HEREBY CERTIFY THAT THIS REPLAT WAS PREPARED FROM FIELD NOTES OF AN ACTUAL SURVEY MEETING THE MINIMUM REQUIREMENTS FOR MONUMENTATION AND SURVEYS OF THE CITY OF ALBUQUERQUE SUBDIVISION ORDINANCE AND THE MINIMUM STANDARDS FOR SURVEYING IN NEW MEXICO AND IS TRUE AND CORRECT TO THE BEST OF MY KNOWLEDGE AND BELIEF. NO ENCROACHMENTS EXIST EXCEPT AS NOTED ABOVE AND THAT ALL IMPROVEMENTS ARE SHOWN IN THEIR CORRECT LOCATION RELATIVE TO RECORD BOUNDARIES AS LOCATED BY THIS SURVEY.



		The second second second							
COORDINATE AND DIMENSION IN	FORMATION			PLSS INF	ORMATION			PROPERTY INFORMATION	
STATE PLANE ZONE: GRID /GROUND COOR GRID		ANDARD		LAND GRA	NT ALLEGOS			PROPERTY OWNER MELLOY BROTHERS MOTOR LTD CO	ADDRESS 9100 PAN AMERICAN FREEWAY, N.
NAD83 VERTICAL DATUM: NAVD88		ROTATION ANGLE: 0° 00' 00.00"	MATCHES DRAWING UNITS YES	SECTION	TOWNSHIP	RANGE	MEDIDIAN	CURRIVICIONINAME	•
CONTROL USED: ALBUQUERQUE GEODETIC REFE		N = 0	ALING AND/OR ROTATION:	12	11 NORTH	3 EAST	MERIDIAN NMPM	SUBDIVISION NAME NORTH ALBUQUERQUE ACRES, TRACT	A, UNIT B
COMBINED SCALE FACTOR:  GRID TO GROUND: 1.0003353099  GROUND TO GRID: 0.9996648025	DEADING ANNOTATION.	E = 0	ATION: ELEVATIONS VALID: YES	CITY ALBUQU	ERQUE	COUNTY BERNALILLO	STATE NM	101806520803930209 101806524003930207 101	1806522401630203 1806520701630202 1806519701030201

Current DRC

Project Number: 596282

#### FIGURE 12

#### INFRASTRUCTURE LIST

(Rev 2 to 18)

EXHIBIT "A"

Date Submitted 7/16/2021

Date Site Plan Approved \_\_\_\_\_

Date Preliminary Plat Approved \_\_\_\_\_

Date Preliminary Plat Expires \_\_\_\_\_

DRB Project No. PR-2021-005411

DRB Application No SI-2021-00760

# TO SUBDIVISION IMPROVEMENTS AGREEMENT DEVELOPMENT REVIEW BOARD (D.R.B.) REQUIRED INFRASTRUCTURE LIST

	Lot 21-A, Block 8, Tract A, Unit B, North Albuquerque Acres
<u> </u>	PROPOSED NAME OF PLAT AND/OR SITE DEVELOPMENT PLAN

Lots 13-15 and Lots 21-23, Block 8, Tract A, Unit B, North Albuquerque Acres
EXISTING LEGAL DESCRIPTION PRIOR TO PLATTING ACTION

Following is a summary of PUBLIC/PRIVATE Infrastructure required to be constructed or financially guaranteed for the above development. This Listing is not necessarily a complete listing. During the SIA process and/or in the review of the construction drawings if the DRC Chair determines that appurtenant items and/or unforeseen items have not been included in the infrastructure listing, the DRC Chair determines that appurtenant or non-essential items can be deleted from the listing those items may be deleted as we list the related portions of the financial guarantees. All such revisions require approval by the DRC Chair the User Department and agent/owner. If such approvals are obtained, these revisions to the listing will be incorporated administratively. In addition, any unforteseen items which anse during construction which are necessary to complete the project and which normally are the Subdivider's responsibility with be required as a condition of

project accepta	ance and close out	by the City					Comple	ruction Cer	aidi a a al a u
Financially	Constructed	Size	Type of Improvement	Location	From	To	Priva		City Cnst
Guaranteed	Under						Inspector	P.E.	Engineer
DRC#	DRC#	1	TRANSPORTATIO						
		15' Lane	Pavement, Curb & Gutter	Glendale Ave. NE	Pan American	East Properly Line	<u> </u>	1	
		4' Transition	and associated striping						
		5' Wide	S dewalk	Glendale Ave. NE	Pan American	455' W. of Pan American		1	
		15' Lane	Pavement, Curb & Gutter	Alameda Place NE	Pan American	East Property Line	1,	ſ	1
	<del> </del>	4' Transition	and associated striping						
		5'Wide	Sidewalk	Alameda Place NE	Pan American	566' W. of Pan	,	ı	
						American			
		25' Wide	Access Driveway Plus ADA Ramps	Glendale Ave. NE	83' East of Pan	148' East of Pan			
<del>,</del>			Full Access		American	American			
		24' Wide	Access Driveway Plus ADA Ramps	Glendale Ave. NE	384' East of Pan	456' East of Pan			
			Full Access		American	American			
		30' Wide	Access Driveway Plus ADA Ramps	Alamda Place NE	487' East of Pan	567' East of Pan			
<u> </u>			Full Access		American	American			
L				04054054			<u> </u>		

Financially	Constructed		WATER AND SA		Construction Certification				
Guaranteed	Under	Size	Type of Improvement	Location	From	Το	Priva		City Crist
DRC#	DRC#						Inspector	P.E.	Engineer
		6"	Fire Hydrant	Glendaie Ave NE	83' East of Pan Amencan	Entrance Curb Return	<u>'</u>	<u> </u>	·
		2"	Domestic Water Service and meter	Glendale Ave NE	345' East of Pan American	Lat 21-A	<i>'</i>		<u></u>
		1"	Landscape Water Service and meter	Glendale Ave NE	345' East of Pan American	Lot 21-A	/		
		6"	Fire Line	Glendale Ave NE	345 East of Pan American	Lot 21-A			
		2					/		
		İ	NMDOT PROPE	RTY FRONTAGE IMPROVE	MENTS*				
		12'	140' Right Turn Lane + Transition with associated striping	Pan American	Glendale Ave NE	150' south of Glendale Ave NE			
		6' Wide	Sidewalk	Pan American	Alameda Place NE	Glendale Ave NE			
		2' Sidewalk Culverts	3- sidewalk culverts and 6'x6' rip-rap pad	Northwest corner of site on	Pan Amencan Frontage	,	,		
		2' Sidewalk Culverts	4- sidewalk culverts and 8'x8' rip-rap pad	Southwest corner of site or	n Pan American Fronlagi	9			
		4'x4'	Drop inlet	Pan American	North side of junction	box	1		
		4'x4'	Drap inlet	Pan American	South side of junction	box			
		]	*Any additional comments from NMDOT's	plan review shall be included			[		

The items lis	ited below are on th Items listed below a	ne CCIP and appr are subject to the	oved for Impact Fee credit	ts. Signatures fr ts.	om the Impact Fee Adm	ninistrator and the City L	lser Department	is require	ed prior to DF	RB approval	of this	
Financially	ncially Constructed									Construction Certification		
Guaranteed	Under	Size	Type of Improve	nent	Location	From	To		Priv	•	City Crist	
DRC#	DRC#		•, ,				-		Inspector	P.E.	Engineer	
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									<del></del>	<del></del> -		
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		-				Approval of Creditable Items:			Approval of Creditable Items:			
						Impact Fee Admistr	ator Signature	Date	City User [	Pept. Signati	ıre Date	
					NOTES				,	-,,		
If the site is located in a floodplain, then the financial guarantee will not be released until the LOMR is approved by FEMA.												
Street lights per City rquirements.												
1												
-	Mative Grass Seed with Aggregate Mulich of equal (Music Satisfy the Trinal Stabilization Criteria CGP 2.2.14 b)											
-						7						
The property owner/developer must continue seft-inspections and BM maintenance until the EPA's Final Stabilization Criteria is sat sfied and approved by the												
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City Stormwater Quality Section (Code 14-5-2-1(C)(1)												
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	AGENT / OWNER	<del></del>			DEVEL COLLEGE							
	AGENT / OWNER		<u> </u>		DEVELOPMENT	EVIEW BOARD MEMBE	RAPPROVALS					
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Ro	nald R. Bohani	nan										
NAME (print)				DRB CHAIR - date		P.	PARKS & RECREATION - date					
-		^										
•	lierra West, LL	C		TO AN COORTATION DEVEL OPINENT July								
	FIRM	,		TRANSPORTATION DEVELOPMENT - date			AMAFCA -	date				
14		7/16	12021									
<del></del>	SIGNATURE - date			UTILITY DEVELOPMENT - date			CODE ENFORCEMENT - date					
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				CITY ENGINEER - date			- date					
				DESIGN RE	VIEW COMMITTEE REV	ISIONS						
					Tommitteller			<del></del>				
	REVISION DATE		DBC CHAIR	DRC CHAIR USER DEPAR		PARTMENT	TMENT AGENT				٦	
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