

#### SHEET KEYED NOTES

- TRASH COMPACTOR ENCLOSURE WITH GATE, REF: C1/SDP1.2 ACCESSIBLE PARKING WITH ACCESSIBLE SIGNAGE AND STRIPING, REF:
- ACCESSIBLE RAMP, REF: D5/SDP1.2 BIKE PARKING PER IDO SECTION 5-5(E) AND DPM STANDARDS, 10% OF REQUIRED OFF-STREET PARKING AND DPM STANDARD WITH TWO-POINT BIKE
- MOTORCYCLE PARKING PER IDO SECTION 5-5(D) AND DPM STANDARDS.
- SHADE STRUCTURE 6' WIDE CONCRETE SIDEWALK PER COA IDO STANDARDS, REF: B4/SDP1.2
- NEW CONCRETE CURB AND GUTTER, REF: A2/SDP1.2
- PARKING STRIPING 4" WIDE, COLOR WHITE
- 10. 6' WIDE PAINTED CROSSWALK
- 11. 6' WIDE ACCESSIBLE PATHWAY FROM PUBLIC R.O.W. 5% MAX SLOPE WITH 2%
- MAX CROSS SLOPE
- 12. OUTDOOR GRILLING AREA.
- 13. OUTDOOR SEATING AREA.
- 14. CMU RETAINING WALL, SEE CIVIL AND B2/SDP1.2
- REQUIREMENTS. THEREFORE SIGNS, WALLS AND PLANTING BETWEEN 3 FEET AND 8 FEET TALL (AS MEASURED FROM THE GUTTER PAN) WILL NOT BE PERMITTED IN THE CLEAR SIGHT TRIANGLE.
- 16. NEW TRANSIT SHELTER TO BE CONSTRUCTED PER CITY STANDARD DETAIL
- 17. PROVIDE ADA ACCESSIBLE CONNECTION FROM THE PRIVATE DRIVE TO THE EXISTING ASPHALT TRAIL.
- 18. RESURFACE EXISTING TRAIL ADJACENT TO THIS PROPERTY AND AS
- INDICATED BY THE SOLID GRAY HATCH. REF: C4/ SDP1.3
- 19. RECYCLE ENCLOSURE, REF: D5/SDP1.2 20. ACCESSIBLE RAMP, REF: D5/SDP1.3
- 21. ELECTRICAL VEHICLE CHARGING STATION.
- 22. FOR PATIO WALLS AT GRADE, REF: A4/SDP1.2
- 23. DOG PARK. ABCWUA IS NOT RESPONSIBLE FOR REPLACING OR REPAIRING DAMAGED TURF OR OTHER SITE FEATURES IF MAINTENANCE IS REQUIRED IN THE EASEMENT.
- 24. PAINTED CROSSWALK, REF: D3/SDP1-3
- 26. ABCWUA IS NOT RESPONSIBLE FOR REPLACING OR REPAIRING DAMAGED SIDEWALK, CURB AND GUTTER, OR OTHER SITE FEATURES DAMAGED BY MAINTENANCE IN THIS EASEMENT.

#### **EASEMENT NOTES**

- 10' ABCWUA EASEMENT (06-28-1990, 90C-151)
- 20' ABCWUA EASEMENT (06-28-1990, 90C-151) 30' ABCWUA EASEMENT (06-28-1990, 90C-151)
- 10' PUE (07-25-1988, C37-012)
- 10' PUE (06-28-1990, 90C-151)
- 100' PNM POWERLINE EASEMENT (05-06-1957, D385-303)
- EASEMENT ENCROACHMENT AGREEMENT (01-23-1990, 1990005847) EASEMENT ENCROACHMENT AGREEMENT (02-10-2005, 2005020108)
- 8. 15' PUE (02-10-1992, 1992011652)
- 9. 10' PUE (06-28-1990, 90C-151)
- 10. 10' NMGCO EASEMENT (03-21-1991, 1991019534)
- 11. 30' PRIVATE ACCESS EASEMENT (06-03-1999, 99C-133) 12. PUBLIC SIDEWALK EASEMENT (12-18-2007, 2007C-347)
- 13. 20' ABCWUA PUBLIC WATERLINE EASEMENT (GRANTED TO ABCWUA BY THIS PLAT)
- 14. 35' X 35' ABCWUA PUBLIC WATERLINE EASEMENT (GRANTED TO ABCWUA BY THIS 15. ABCWUA PUBLIC WATERLINE AND SANITARY SEWER EASEMENT (GRANTED TO
- ABCWUA BY THIS PLAT)

#### **GENERAL SHEET NOTES**

- A. DIMENSIONS ARE TO FACE OF CURB, OR WALL, OR EDGE OF PAVEMENT UNLESS OTHERWISE NOTED.
- B. SITE PLAN SHALL COMPLY WITH LOCAL, FEDERAL AND ACCESSIBILITY STANDARDS & GUIDELINES, INCLUDING THE INTERNATIONAL FIRE CODE (IFC) 2015.
- ALL CURBS AND ACCESSIBLE RAMPS WILL BE DESIGNED AND BUILT ACCORDING TO THE CITY OF ALBUQUERQUE STANDARDS.
- ALL LIGHT FIXTURES AND LIGHTING DESIGN SHALL COMPLY WITH THE CITY OF ALBUQUERQUE INTEGRATED DEVELOPMENT ORDINANCE (IDO): SECTION 14-16-5-8 OUTDOOR LIGHTING.
- STREETS, PARKING SPACES AND ASSOCIATED DRIVES TO BE ASPHALT UNLESS **NOTED OTHERWISE**
- LANDSCAPE AND SIGNAGE WILL NOT INTERFERE WITH CLEAR SIGHT REQUIREMENTS. THEREFORE SIGNS, WALLS AND PLANTING BETWEEN 3 FEET AND 8 FEET TALL (AS MEASURED FROM THE GUTTER PAN) WILL NOT BE PERMITTED IN
- AN ACCESSIBLE ROUTE, IN COMPLIANCE WITH ACCESSIBILITY STANDARDS OF THE PROJECT, CONNECTS FROM THE BUILDING TO ACCESSIBLE PARKING SPACES AND TO ALL SITE AMENITIES AS REQUIRED.
- APPLICATION TO EPC WAS SUBMITTED ON MAY 6, 2021. THE 2019 INTEGRATED DEVELOPMENT ORDINANCE GOVERNS.

#### PROJECT DATA

THE CLEAR SIGHT TRIANGLE.

IDO - MIXED-USE - MEDIUM INTENSITY ZONE DISTRICT (MX-M)

**LEGAL DESCRIPTION:** TR A-2-A-A PLAT OF TRACTS A-2-A-A & B-1-A THE PLAZA AT PASEO DEL NORTE CONT 7.0867 AC

**SITE AREA:** 7.08 ACRES **ZONE ATLAS**: C-13-Z

**SETBACKS:** FRONT= 5' MIN, INTERIOR= 0', REAR= 15'

**BUILDING HEIGHT:** MAXIMUM ALLOWED: 48'-0"

ACTUAL HEIGHT: 48'-0" SPRINKLED: YES, NFPA 13R **BUILDING OCCUPANCY:** R-2

ADA PARKING PROVIDED = 14 SPACES

CONSTRUCTION TYPE: TYPE VA PARKING CALCULATIONS: (TABLE 5-5-1)

1.5 SPACES / DWELLING UNITS: 218 X 1.5 = 327 SPACES MINUS PARKING CREDIT OF 5% FOR TRANSIT RIDER SHELTER = 327\*.05 = 17, 327-17 = 310 SPACES

REQUIRED) ELECTRIC VEHICLE CHARGING STATIONS REQUIRED: 6 SPACES

CHARGING STATION CREDIT = 6X2 = 12 SPACES REQUIRED SPACES = 298 SPACES

PROVIDED PARKING = 303 TOTAL SPACES (34 GARAGE, 98 COVERED)

ADA PARKING REQUIRED: 1 SPACE PER UNIT REQUIRED TO BE ADA 218 UNITS X .02 = 4.36 = 5 SPACES REQUIRED

BICYCLE PARKING REQUIRED = 30 SPACES

(10% OF OFF STREET PARKING = 304 X 0.10 = 30 SPACES) BICYCLE PARKING PROVIDED

#### OPEN SPACE CALCULATIONS

TABLE 2-4-5 / MX-M ZONING USABLE OPEN SPACE 1 BD: 225 SF PER UNIT 225 SF x 119 UNITS = 26,775 SF

2 BD: 285 SF PER UNIT 285 SF x 72 UNITS = 20,520 SF 3 BD: 350 SF PER UNIT

350 SF x 27 UNITS = 9,450 SF

56,745 SF REQUIRED OPEN SPACE PROVIDED OPEN SPACE: 80,740 SF

VICINITY MAP PROJECT SITE PLAZA AT PASEO DEL NORTE Coors H Boulevard + CPO-2

Dec 6, 2022

Dec 6, 2022

Dec 7, 2022

Dec 6, 2022

Dec 6, 2022

Date

Date

Date

Date

Date

Date

Date

Date

Dec 9, 2022

LEGEND LANDSCAPE AREA

PROPERTY LINE

FIRE HYDRANT

BIKE RACK

SIDEWALK RAMP (ARROW POINTS DOWN) TRANSFORMER WITH SAFETY BOLLARDS & 6" THICK CONCRETE PAD PER PNM STANDARDS

PERIMETER FENCE

ACCESSIBLE PARKING WITH ACCESSIBLE SIGNAGE AND STRIPING, REF: A3/SDP1.2, A4/SDP1.2 & B4/SDP1.2.

■ LIGHT POLE

SHEET NO.

10.12.2021 MAJOR AMENDMENT

AG, JF

RAW, HFG

10/21/2022

20-0286

DRAWN BY

DATE

REVIEWED BY

PROJECT NO.

DRAWING NAME

SITE PLAN

PERICH

ARCHITECTURE

INSPIRATION


DESIGN

ARCHITECT

**ENGINEER** 

**PROJECT** 

SABATINI

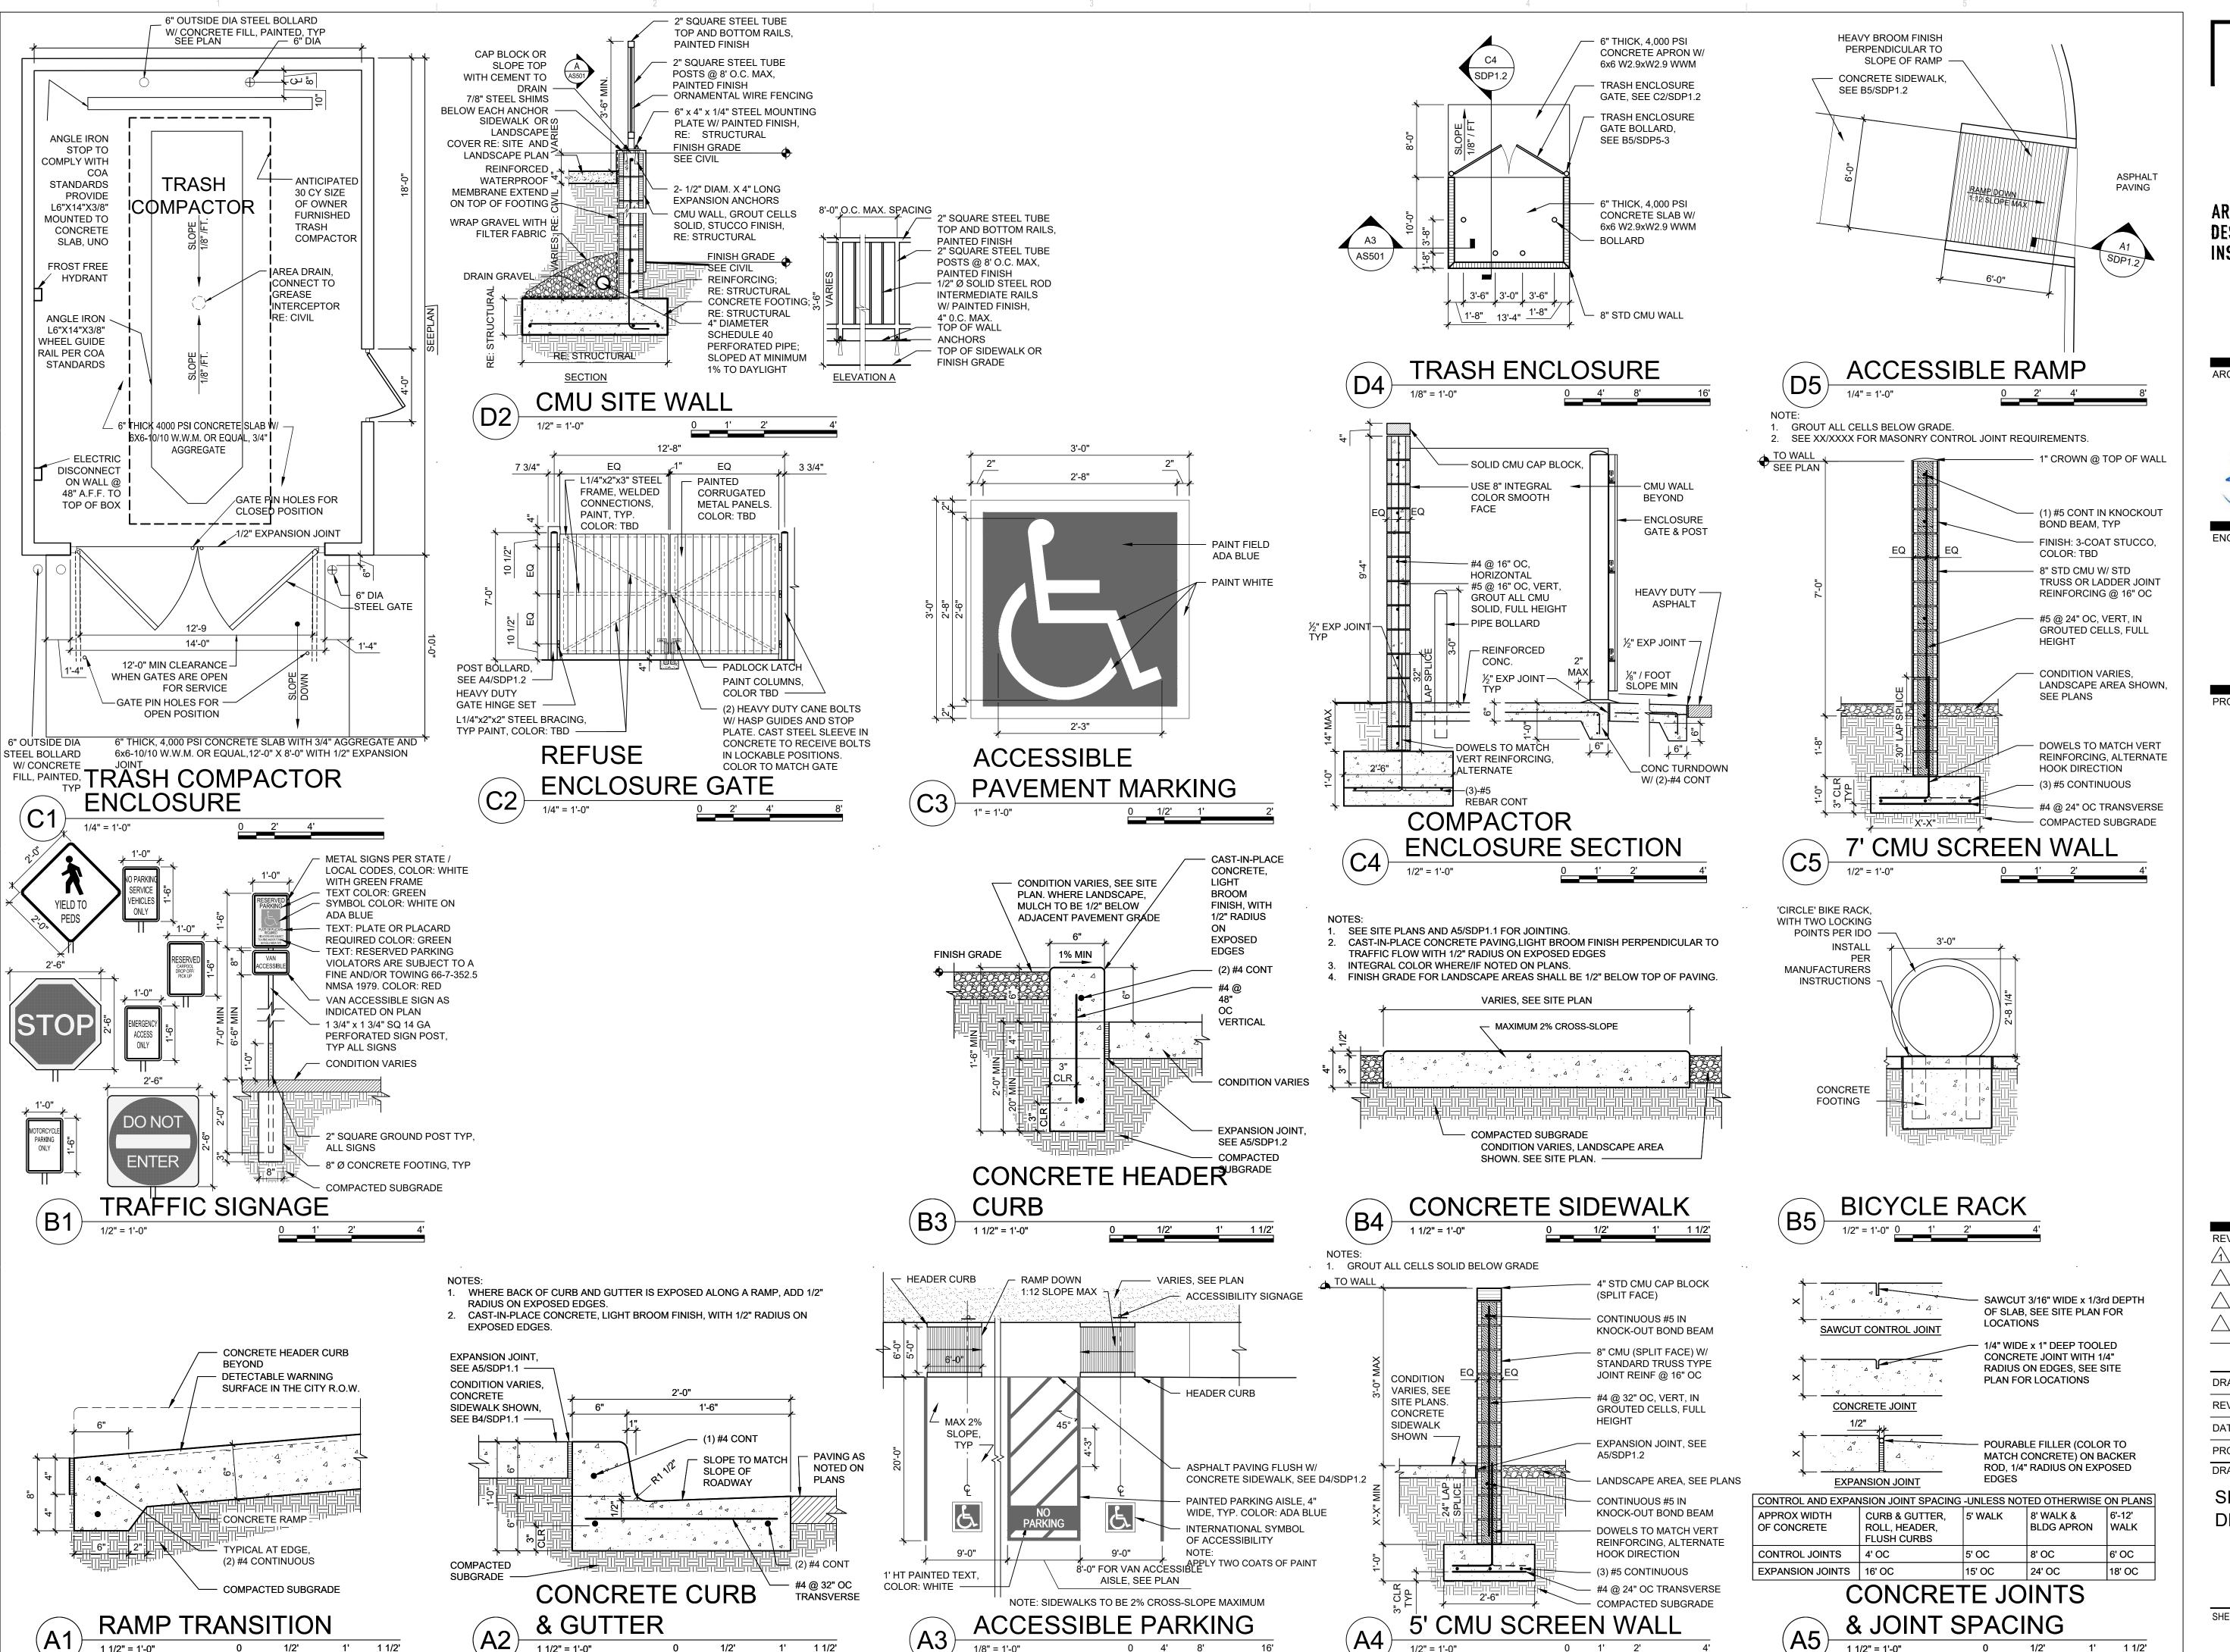

ARCHITECTURE DESIGN INSPIRATION

ARCHITECT

OF NEW METO

HANNAH FEIL

GREENHOOD

No. 5594

ERED ARCHITECT

ENGINEER


PROJECT

SEDONA WEST EAGLE RANCH ROAD ALBUQUERQUE, NM 87114

DRAWN BY
D/P/S
REVIEWED BY
D/P/S
DATE
10/21/2022
PROJECT NO.
20-0286
DRAWING NAME

SITE DETAILS

SHEET NO.
SDP1.2

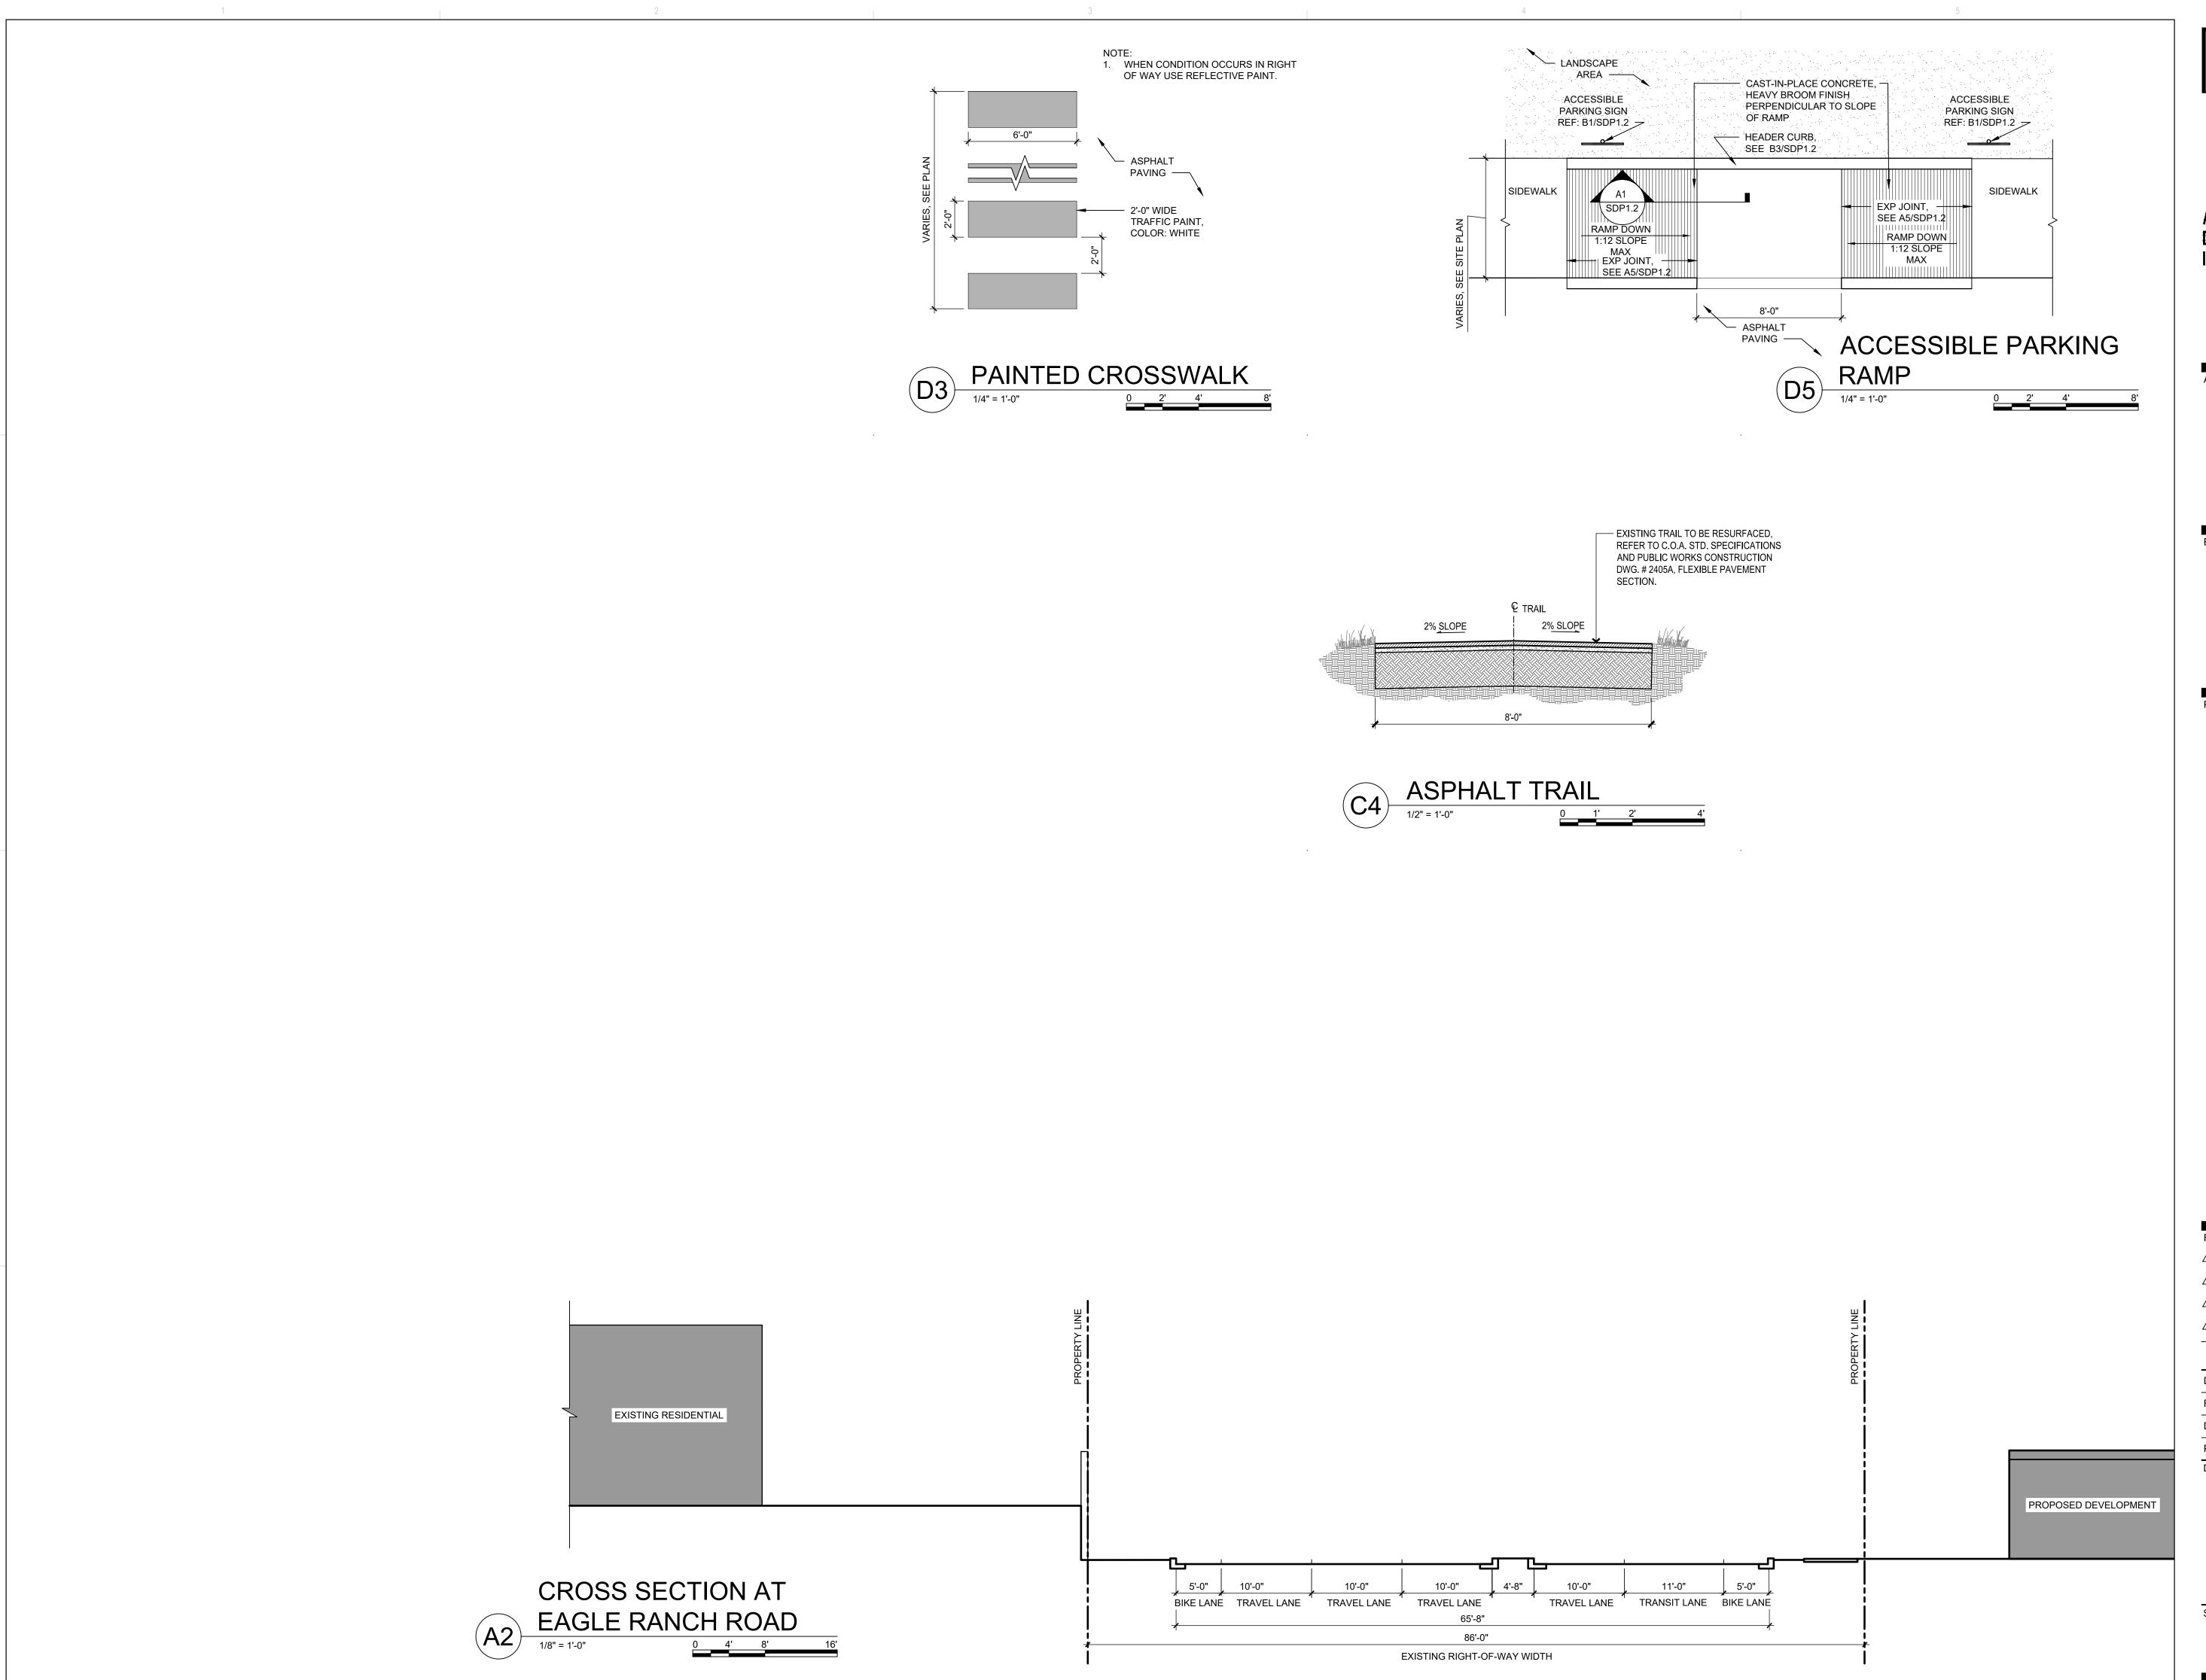

ARCHITECTURE DESIGN INSPIRATION

ENGINEER

PROJECT

SEDONA WEST EAGLE RANCH ROAD ALBUQUERQUE, NM 87114

DRAWN BY	D/P/S
REVIEWED BY	D/P/S
DATE	10/21/2022
PROJECT NO.	20-0286
DRAWING NAME	_
SITE	
<b>DETAILS</b>	

SHEET NO.
SDP1.3

#### PROJECT BENCHMARK

AN 3 1/4" AGRS ALUMINUM DISK STAMPED "11\_C13", SET FLUSH IN THE NORTHEAST CONCRETE BRIDGE ABUTMENT OF PASEO DEL NORTE OVER COORS BOULEVARD NW. ELEVATION = 5031.88 FEET (NAVD 1988)

#### TEMPORARY BENCHMARK #201 (T.B.M.)

A 60d NAIL, SET IN CONCRETE JOINT NEAR THE NORTHWEST CORNER OF THE PROJECT SITE APPROXIMATELY 22.8' SOUTHWEST OF THE NORTHWEST PROPERTY CORNER, AS SHOWN ON THIS SHEET. ELEVATION = 5072.42 FEET (NAVD 1988)

#### TEMPORARY BENCHMARK #202 (T.B.M.)

A 60d NAIL, SET IN CONCRETE JOINT NEAR THE SOUTHWEST CORNER OF THE PROJECT SITE APPROXIMATELY 21.3' NORTHEAST OF THE TOP OF A WHEEL CHAIR RAMP, AS SHOWN ON THIS SHEET.

ELEVATION = 5076.20 FEET (NAVD 1988)

#### TEMPORARY BENCHMARK #203 (T.B.M.)

A MAG NAIL W/WASHER. SET IN ASPHALT PAVEMENT NEAR THE CENTER OF THE PROJECT SITE APPROXIMATELY 1.1' EAST OF THE EAST ASPHALT CURB, AS SHOWN ON THIS

ELEVATION = 5056.78 FEET (NAVD 1988)

#### TEMPORARY BENCHMARK #204 (T.B.M.)

A MAG NAIL W/WASHER, SET IN ASPHALT PAVEMENT NEAR THE NORTHEAST CORNER OF THE PROJECT SITE APPROXIMATELY 26.6' SOUTH OF THE SOUTHEAST CORNER OF A CONCRETE PAD, AS SHOWN ON THIS SHEET.

#### TEMPORARY BENCHMARK #205 (T.B.M.)

A MAG NAIL W/WASHER, SET IN ASPHALT PAVEMENT NEAR THE SOUTHEAST CORNER OF THE PROJECT SITE APPROXIMATELY 1.4' SOUTHWEST OF THE END OF A CONCRETE CURB LIP, AS SHOWN ON THIS SHEET. ELEVATION = 5049.36 FEET (NAVD 1988)

#### **GRADING AND DRAINAGE:**

THE PROJECT SITE CURRENTLY SLOPES FROM NORTHEAST TO SOUTHWEST. THE STORMWATER RUNOFF FROM THE WEST HALF OF THE SITE IS INTERCEPTED BY AN EXISTING PAVED, CURBED ACCESS ROAD THAT DRAINS TO TWO (2) EXISTING STORM DRAIN INLETS. THESE INLETS DISCHARGE TO AN EXISTING 24" PUBLIC SUBSURFACE STORM DRAIN SYSTEM THAT EXTENDS THROUGH THE SITE FROM NORTH TO SOUTH, ENLARGING TO A 36" RCP STORM DRAIN ALONG THE SOUTH PERIMETER OF THE PROPERTY. THIS PUBLIC STORM DRAIN SYSTEM CONTINUES SOUTHWEST PROJECT SITE AND ULTIMATELY DISCHARGES TO A PUBLIC STORMWATER DETENTION BASIN AT THE "PLAZA AT PASEO DEL NORTE UPPER DETENTION POND", LOCATED NEAR THE SOUTHEAST TERMINATION OF PARADISE BLVD NW, AND IMMEDIATELY SOUTH OF THE EAGLE RANCH APARTMENTS COMPLEX. THE EXISTING PUBLIC STORM DRAIN SYSTEM AND STORMWATER DETENTION POND FACILITY WAS DEVELOPED PER THE 1989 MARKET CENTER WEST (PLAZA AT PASEO DEL NORTE) MASTER PLAN (UPDATED 2007) AND CONSTRUCTED AS PART OF THE PHASE 1 DEVELOPMENT FOR THIS SITE IN 1990. THE STORMWATER DETENTION POND IS SIŽED TO ACCEPT THE FULLY DEVELOPED STORMWATER RUNOFF GENERATED BY THIS SITE (DENOTED AS PORTIONS OF BASIN A IN THE MASTER PLAN DRAINAGE REPORT). IN THE MASTER PLAN, BASINS A-1, A-2 AND A-3 WERE CALCULATED TO GENERATE 24.6 CFS, 16.6 CFS, AND 4.5 CFS RESPECTIVELY (QTOTAL = 45.7 CFS) IN THE FULLY DEVELOPED CONDITION THAT IS FREE DISCHARGED TO THE EXISTING PUBLIC STORM DRAIN IMPROVEMENTS. THIS PROPOSED 2021 SEDONA WEST DEVELOPMENT SITE IS 7.1 AC. 65% OF THE BASIN A 11 AC SITE. THEREFORE, THE ALLOWABLE DISCHARGE FOR THIS SITE IS 65% OF THE 45.7 CFS ALLOWABLE FREE DISCHARGE RATE, EQUAL TO 29.7 CFS.

EASEMENTS

PAGE 12.

PAGE 151.

PAGE 151.

905847.

DOC. # 8849100.

PAGE 7909, DOC. #91019534.

DETERMINED BASED UPON EASEMENT ANNOTATION.

BY PLATS OF RECORD REFERENCED HEREON.

(1) 10' PNM AND US WEST EASEMENT GRANTED BY PLAT FILED JULY 25, 1988, BOOK C37,

2. 10' PNM AND US WEST EASEMENT GRANTED BY PLAT FILED JUNE 28, 1990, BOOK 90C,

3. 10' EASEMENT GRANTED TO N.M. UTILITIES BY PLAT FILED JUNE 28, 1990, BOOK 90C,

4. 20' EASEMENT GRANTED TO N.M. UTILITIES BY PLAT FILED JUNE 28, 1990, BOOK 90C,

5. 30' EASEMENT GRANTED TO N.M. UTILITIES BY PLAT FILED JUNE 28, 1990, BOOK 90C,

6. APPROXIMATE LOCATION OF 100' PNM POWER LINE EASEMENT FILED MAY 06, 1957, BOOK

N.M. UTILITY CO., FILED JANUARY 23, 1990, BOOK 90-2, PAGES 1325-1327, DOC. #

7. 15' UTILITY EASEMENT GRANTED HORIZION-ALBUQUERQUE PROPERTIES AND PNM DATED

8. 8' BIKE LANE AND ASSOCIATED 12' EASEMENT, REFERENCED BY PREVIOUS PLATTING

PNM, FILED FEBRUARY 10, 2005, BOOK A-92, PAGE 31, DOC. #2005020108.

9. 10' GAS COMPANY OF NEW MEXICO EASEMENT, FILED MARCH 21, 1991, BOOK A91-4,

(11) POSSIBLE LOCATION OF 50' ROADWAY EASEMENT RESERVED BY WARRANTY DEED FILED

10. APPROXIMATE LOCATION PUBLIC SIDEWALK EASEMENT GRANTED BY PLAT FILED DECEMBER

18, 2007, BOOK 2007C, PAGE 347, DOC. #2007169358. EXACT LOCATION CANNOT BE

NOVEMBER 19, 1959, BOOK D-513, PAGE 189. EASEMENT NOT DEPICTED OR REFERENCED

D385. PAGE 3031. SUBJECT TO EASEMENT ENCROACHMENT AGREEMENT BETWEEN PNM AND

MARCH 27, 1961, RECORDED FEBRUARY 10, 1992, BOOK 92-3, PAGE 4164, N.M. UTILITIES

ACTIONS, AND SITE DEVELOPMENT PLAN DATED 06-19-2007, FILE NO. 2-83-93-1, ALSO

REFERENCED BY ENCROACHMENT AGREEMENT BETWEEN THE CITY OF ALBUQUERQUE AND

DISCLAIMS ALL INTEREST TO ABOVE REFERENCED EASEMENT RECORDED JUNE 01, 1988,

THE PROPOSED SITE DEVELOPMENT WILL MAINTAIN THE GENERAL DRAINAGE PATTERNS FOR THE SITE WITH OVERALL SITE GRADE SLOPING FROM NORTHEAST TO SOUTH WEST. ROOF DRAINAGE AND LOCALIZED PAVEMENT AREAS WILL BE SERVED BY NEW PRIVATE SUBSURFACE PIPED STORM DRAIN SYSTEMS THAT WILL OUTFALL TO THE EXISTING PUBLIC STORM DRAIN SYSTEM. THE PROJECT WILL RESULT IN AN INCREASE IN DEVELOPED STORMWATER RUNOFF GENERATED DUE TO THE NEW IMPERVIOUS AREAS. CALCULATIONS BASED ON THE CURRENT DPM PROCEDURE FOR A 40 ACRE OR SMALLER SITE SHOWN BELOW DEMONSTRATE THAT THE PROPOSED PEAK DISCHARGE FOR A 100 YEAR, 6 HOUR STORM EVENT GENERATED BY THE FULLY DEVELOPED SITE WILL BE 26.9 CFS. WHICH IS LESS THAN THE ALLOWABLE MASTER PLAN FREE DISCHARGE RATE OF 29.7 CFS NOTED ABOVE.

DUE TO THE GENERAL SLOPE OF THE SITE FROM WEST TO EAST, AND COORDINATION COMPROMISES TO THE SITE DEVELOPMENT WITH THE NEIGHBORING PROPERTY OWNERS. THIS SITE AS FULLY DEVELOPED WILL NOT BE ABLE TO INCLUDE PONDING IMPROVEMENTS NECESSARY TO COMPLY WITH THE CITY OF ALBUQUERQUE DPM AND CURRENT STORMWATER QUALITY ORDNANCE REQUIREMENTS TO CAPTURE AND TREAT THE FIRST FLUSH STORM EVENT GENERATED BY THE SITE. CALCULATIONS INCLUDED BELOW DEMONSTRATE THE REQUIRED STORMWATER QUALITY VOLUME GENERATED BY THE DEVELOPED SITE TO BE 8,510 CF. AS SUCH, THIS PROJECT ANTICIPATES UTILIZING THE ALTERNATIVE 'PAYMENT-IN-LIEU' OPTION NOTED IN THE COA DPM SECTION 6-12(C)(1), TO BE COORDINATED WITH THE CITY HYDROLOGY ENGINEER.

#### **CALCULATIONS:**

I. SITE CHARACTERISTICS

Α.	PRECIPITATION ZONE -	<u>1</u>			
В.	$P_{100.6HR} = P_{360} =$	2.17 IN			
C.	TOTAL PROJECT AREA (A <sub>T</sub> ) =	310,241 SF			
	TO THE PROBLET AREA (AT) -	7.12 AC			
D. LA	ND TREATMENTS				
1.	EXISTING	LAND TREATMENT		DEVELOPED	LAND TREATME
	PROJECT SITE	310,241 <b>SF</b>		PROJECT SITE	310,241
	PROJECT SITE	7.12 AC		PROJECT SITE	7.12
	LAND TREATMENT	AREA (SF/AC)	%	LAND TREATMENT	AREA (SF//
	Δ			Δ	

263,079 SF 85% 6.04 AC 0.77 AC 33,620 SF 0.77 AC 47,162 SF 243,000 SF 5.58 AC 1.08 AC

#### **HYDROLOGY**

#### A. EXISTING CONDITION 100 YEAR STORM

1. PROJECT SITE a. VOLUME 100-YR, 6-HR

 $WT_F = (E_A \cdot A_A + E_B \cdot A_B + E_C \cdot A_C + E_D \cdot A_D)/A_T$  $\Rightarrow$  (0.55 · 0.00) + (0.73 · 6.04) + (0.95 · 0.00) + (2.24 · 1.08)/7.12 =  $\Rightarrow$  (0.96/12) • 7.12 = **0.5698 AC-FT =** 24,820 CF  $V_{100.6 \text{ HR}} = (E_W/12) \cdot A_T$ b. PEAK DISCHARGE 100-YR

 $Q_{100} = Q_A \cdot A_A + Q_B \cdot A_B + Q_C \cdot A_C + Q_D \cdot A_D$  $\Rightarrow$  (1.54 • 0.00) + (2.16 • 6.04) + (2.87 • 0.00) + (4.12 • 1.08) =

#### B. <u>DEVELOPED CONDITION 100 YEAR STORM</u>

1. PROJECT SITE a. VOLUME 100-YR, 6-HR

> $WT_E = (E_A \cdot A_A + E_B \cdot A_B + E_C \cdot A_C + E_D \cdot A_D)/A_T$  $\Rightarrow$  (0.55 • 0.00) + (0.73 • 0.77) + (0.95 • 0.77) + (2.24 • 5.58)/7.12 =  $\Rightarrow$  (1.94/12) • 7.12 = 1.1514 AC-FT = 50,160 CF  $V_{100.6 \text{ HR}} = (E_W/12) \cdot A_T$

b. STORM WATER QUALITY VOLUME (FIRST FLUSH) GENERATED  $V_{SWQV} = ((P_{SWQV})/12) \cdot A_D$  $\Rightarrow$  ((0.42)/12) • (5.58) = 0.1952 AC-FT =

c. STORM WATER QUALITY - PAYMENT IN LIEU VARIANCE REQUEST ⇒ \$8.00 PER CF FIRST FLUSH GENERATE x 8510 CF =

 $Q_{100} = Q_A \cdot A_A + Q_B \cdot A_B + Q_C \cdot A_C + Q_D \cdot A_D$  $\Rightarrow$  (1.54 • 0.00) + (2.16 • 0.77) + (2.87 • 0.77) + (4.12 • 5.58) =

d. PEAK DISCHARGE 100-YR

C. COMPARISON 100 YEAR STORM 1. PROJECT SITE

> a. VOLUME 100-YR, 6-HR b. PEAK DISCHARGE 100-YR  $\Delta Q_{100} = 26.9 - 17.5 =$

(INCREASE)

\*29.7 CFS FREE DISCHARGE ALLOWED PER PLAZA AT PASEO DEL NORTE MASTER PLAN > DEVELOPED 26.9 CFS GENERATE

THIS IS NOT A BOUNDARY SURVEY OR A RIGHT-OF-WAY SURVEY, APPARENT PROPERTY CORNERS. RIGHT-OF-WAY LINES. OR PROPERTY LINES AS SHOWN ARE DERIVED FROM RECORD SURVEY PLATS. RIGHT-OF-WAY MAPS, OR DEEDS REFERENCED HEREON AND ARE NOT GUARANTEED OR TO BE RELIED ON FOR THE ESTABLISHMENT OF PROPERTY LINES. THE BOUNDARY INFORMATION DEPICTED BY THIS PLAN IS BASED UPON A BOUNDARY SURVEY PREPARED BY HIGH MESA CONSULTING GROUP, NMPS 11184, DATED 03/24/2021 (2021.012.1). THE TOPOGRAPHIC INFORMATION DEPICTED HEREON IS BASED UPON THE TOPOGRAPHIC AND UTILITY SURVEY PREPARED BY

HIGH MESA CONSULTING GROUP, NMPS NO. 11184, DATED 03/24/2021 (2021.012.1).

2021.012.2

HIGH MESA Consulting Group

17.5 CFS

8,510 CF

\$68,080.00

26.9 CFS

6010-B Midway Park Blvd. NE • Albuquerque, New Mexico 87109 Phone: 505.345.4250 • Fax: 505.345.4254 • www.highmesacg.com

**DEKKER** PERICH SABATINI

ARCHITECTURE **DESIGN** INSPIRATION

ARCHITECT

**ENGINEER** 

\*THIS PLAN SUPERCEDES 06-04-2021 PLAN PROJECT

SITE DEVELOPMENT **PLAN** 

REVISIONS

DRAWN BY J.Y.R. **REVIEWED BY** G.M. 08/06/2021 PROJECT NO. 19-0058

CONCEPTUAL **GRADING PLAN** 

DRAWING NAME

SHEET NO.

CG-101

#### **EASEMENTS**

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- W FRD -- -- W FRD -- -- -

- SAS — — — SAS — — — -

-SD----SD----

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- PAGE 151. 6. APPROXIMATE LOCATION OF 100' PNM POWER LINE EASEMENT FILED MAY 06, 1957, BOOK D385, PAGE 3031. SUBJECT TO EASEMENT ENCROACHMENT AGREEMENT BETWEEN PNM AND
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- MARCH 27, 1961, RECORDED FEBRUARY 10, 1992, BOOK 92-3, PAGE 4164. N.M. UTILITIES DISCLAIMS ALL INTEREST TO ABOVE REFERENCED EASEMENT RECORDED JUNE 01, 1988, DOC. # 8849100. 8. 8' BIKE LANE AND ASSOCIATED 12' EASEMENT, REFERENCED BY PREVIOUS PLATTING ACTIONS, AND SITE DEVELOPMENT PLAN DATED 06-19-2007, FILE NO. 2-83-93-1, ALSO
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- PAGE 7909, DOC. #91019534. 10. APPROXIMATE LOCATION PUBLIC SIDEWALK EASEMENT GRANTED BY PLAT FILED DECEMBER 18, 2007, BOOK 2007C, PAGE 347, DOC. #2007169358. EXACT LOCATION CANNOT BE DETERMINED BASED UPON EASEMENT ANNOTATION.
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#### TEMPORARY BENCHMARK #201 (T.B.M.)

A 60d NAIL, SET IN CONCRETE JOINT NEAR THE NORTHWEST CORNER OF THE PROJECT SITE APPROXIMATELY 22.8' SOUTHWEST OF THE NORTHWEST PROPERTY CORNER, AS SHOWN ON THIS SHEET.

ELEVATION = 5072.42 FEET (NAVD 1988)

#### TEMPORARY BENCHMARK #202 (T.B.M.)

A 60d NAIL, SET IN CONCRETE JOINT NEAR THE SOUTHWEST CORNER OF THE PROJECT SITE APPROXIMATELY 21.3' NORTHEAST OF THE TOP OF A WHEEL CHAIR RAMP, AS SHOWN ON THIS SHEET. ELEVATION = 5076.20 FEET (NAVD 1988)

#### TEMPORARY BENCHMARK #203 (T.B.M.)

A MAG NAIL W/WASHER, SET IN ASPHALT PAVEMENT NEAR THE CENTER OF THE PROJECT SITE APPROXIMATELY 1.1' EAST OF THE EAST ASPHALT CURB, AS SHOWN ON THIS

ELEVATION = 5056.78 FEET (NAVD 1988)

#### TEMPORARY BENCHMARK #204 (T.B.M.)

A MAG NAIL W/WASHER, SET IN ASPHALT PAVEMENT NEAR THE NORTHEAST CORNER OF THE PROJECT SITE APPROXIMATELY 26.6' SOUTH OF THE SOUTHEAST CORNER OF A CONCRETE PAD, AS SHOWN ON THIS SHEET.

#### ELEVATION = 5052.58 FEET (NAVD 1988)TEMPORARY BENCHMARK #205 (T.B.M.)

A MAG NAIL W/WASHER, SET IN ASPHALT PAVEMENT NEAR THE SOUTHEAST CORNER OF THE PROJECT SITE APPROXIMATELY 1.4' SOUTHWEST OF THE END OF A CONCRETE CURB LIP, AS SHOWN ON THIS SHEET.

#### **KEYED NOTES:**

ELEVATION = 5049.36 FEET (NAVD 1988)

- NEW METERED DOMESTIC WATER SERVICE CONNECTION TO EXISTING 12" PUBLIC WATER MAIN
- NEW DOMESTIC WATER SERVICE WITH LARGE METER VAULT NEW DOMESTIC WATER SERVICE BACKFLOW PREVENTER IN HEATED
- NEW UNMETERED FIRE PROTECTION SERVICE CONNECTION TO EXISTING 12"
- PUBLIC WATER MAIN NEW FIRE PROTECTION LINE BACKFLOW PREVENTER IN HEATED ENCLOSURE
- NEW FIRE HYDRANT
- NEW SANITARY SEWER SERVICE CONNECTION TO EXISTING 8" PUBLIC SANITARY SEWER MAIN
- NEW SANITARY SEWER MANHOLE RELOCATE / REPLACE EXISTING PUBLIC FIRE HYDRANT (TO REMAIN PUBLIC)
- 2 10 REMOVE PUBLIC FIRE HYDRANT, REPLACE WITH NEW PRIVATE FIRE HYDRANT



THIS IS NOT A BOUNDARY SURVEY OR A RIGHT-OF-WAY SURVEY. APPARENT

PROPERTY CORNERS, RIGHT-OF-WAY LINES, OR PROPERTY LINES AS SHOWN

ARE DERIVED FROM RECORD SURVEY PLATS, RIGHT-OF-WAY MAPS, OR DEEDS

REFERENCED HEREON AND ARE NOT GUARANTEED OR TO BE RELIED ON FOR

THE BOUNDARY INFORMATION DEPICTED BY THIS PLAN IS BASED UPON A


BOUNDARY SURVEY PREPARED BY HIGH MESA CONSULTING GROUP, NMPS

PREPARED BY HIGH MESA CONSULTING GROUP, NMPS NO. 11184, DATED

11184, DATED 03/24/2021 (2021.012.1). THE TOPOGRAPHIC INFORMATION DEPICTED HEREON IS BASED UPON THE TOPOGRAPHIC AND UTILITY SURVEY

THE ESTABLISHMENT OF PROPERTY LINES.

03/24/2021 (2021.012.1).

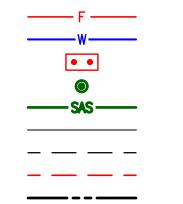

PROPOSED FIRE HYDRANT PROPOSED FIRE LINE PROPOSED WATER LINE NEW BACKFLOW PREVENTER PROPOSED SANITARY SEWER MANHOLE PROPOSED SANITARY SEWER PROPOSED STORM DRAIN EXISTING EASEMENT LINE PROPOSED EASEMENT LINE EXISTING PROPERTY LINE

PROPOSED PROPERTY LINE EXISTING STORM DRAIN MANHOLE EXISTING SANITARY MANHOLE

2021.012.2


HIGH MESA Consulting Group

6010-B Midway Park Blvd. NE • Albuquerque, New Mexico 87109 Phone: 505.345.4250 • Fax: 505.345.4254 • www.highmesacg.com DEKKER PERICH SABATINI

**ARCHITECTURE** DESIGN INSPIRATION

ARCHITECT

**ENGINEER** 

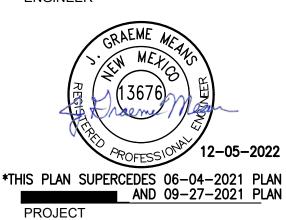

SEDONA V LE RANCH ALBUQ ALBUQUERQUE, I

SITE DEVELOPMENT **PLAN** 

REVISIONS

2 ABCWUA FINAL DRB COMMENT 1 DRB COMMENT UPDATE


DRAWN BY J.Y.R. **REVIEWED BY** G.M. 08/06/2021 PROJECT NO. 19-0058

CONCEPTUAL WATER AND **SANITARY SEWER PLAN** 

DRAWING NAME

SHEET NO.

CU-101

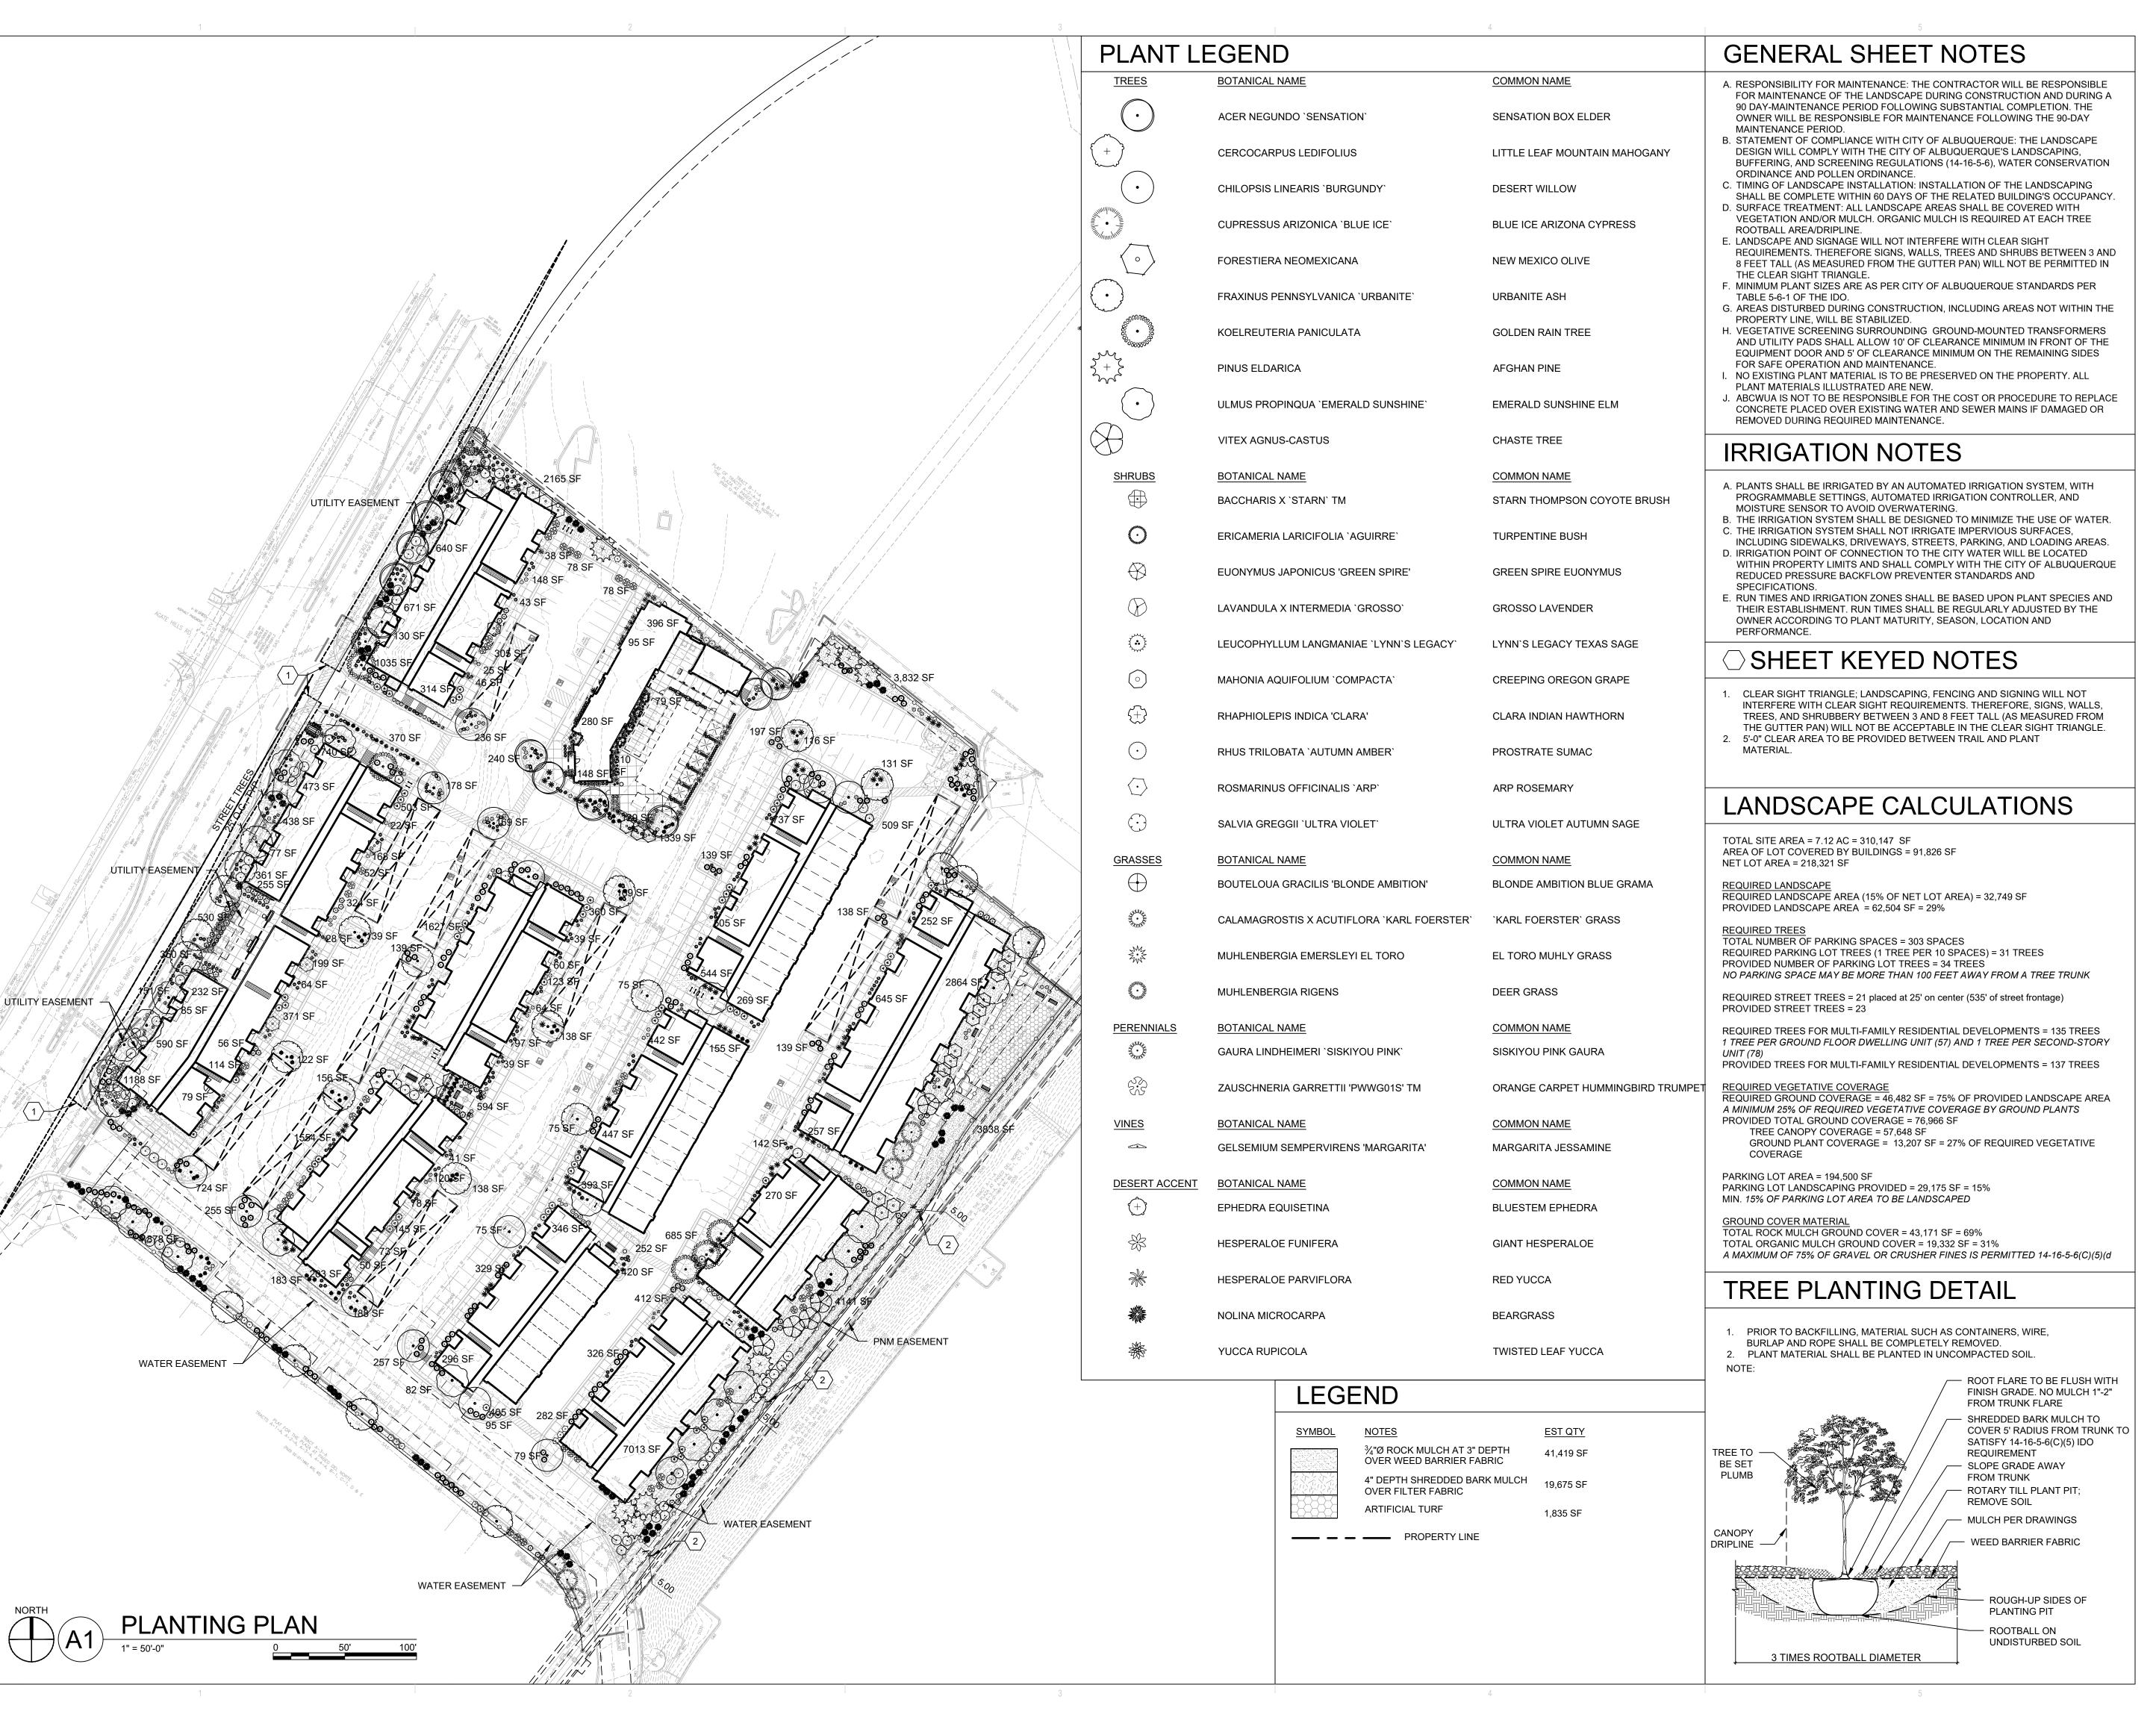

ARCHITECTURE DESIGN **INSPIRATION** 

ARCHITECT



**ENGINEER** 

PROJECT

REVISIONS

DRAWING NAME

DRAWN BY **REVIEWED BY** CM DATE 10/21/2022 PROJECT NO. 20-0286

PLANTING PLAN



- A. ALL ROOF MOUNTED MECHANICAL EQUIPMENT SHALL BE SCREENED BY PARAPET WALL AND NOT BE VISIBLE WHEN VIEWED FROM 5' ABOVE GRADE AT ANY PROPERTY LINE.
- B. ALL DIMENSIONS SHOWN ARE TO OUTSIDE FACE OF FINISH UNLESS OTHERWISE NOTED.
- C. BUILDING IDENTIFICATION SIGNAGE TO BE A MINIMUM OF 18" HIGH CHARACTERS WITH A MINIMUM OF 3" BRUSH STROKE WITH CONTRASTING ALUMINUM COLORS LIT FROM DUSK UNTIL DAWN AS WELL AS DAYLIGHT HOURS, PER
- 2009 IFC. MOUNT AT 15'-20' ABOVE FINISH FLOOR.
- D. ALL IDO REQUIREMENTS WILL BE MET PER SECTION 5-11(E)(2); REF: BUILDING FLOOR PLAN SHEETS FOR
- ADDITIONAL INFORMATION. E. ROOF DRAINAGE BY WAY OF EXTERNAL DOWNSPOUTS.

### SHEET KEYNOTES (X)

- 1. FIELD COLOR NEUTRAL WARM WHITE STUCCO FINISH MATERIAL
- 2. ACCENT COLOR/MATERIAL #1 DARK MASONRY VENEER 3. ACCENT COLOR/MATERIAL #2 - DARK GRAY - ACCENT PANELIZED FIBER CEMENT BOARD
- 4. ACCENT COLOR #3 LIGHT GRAY ACCENT STUCCO FINISH 5. ACCENT COLOR #4 - RUST TONE - ACCENT STUCCO FINISH
- 6. ACCENT COLOR #5- BLUE TONE ACCENT STUCCO FINISH 7. NOT USED
- 8. ACCENT COLOR #7 YELLOW TONE ACCENT STUCCO FINISH
- 9. FIBER CEMENT BOARD FACIA TO MATCH MASONRY VENEER 10. PREFINISHED METAL COPING - COLOR TO MATCH ADJACENT MATERIAL OR STANDARD NEUTRAL COLOR
- 11. GUARDRAIL METAL CUSTOM FABRICATED
- 12. BUILDING IDENTIFICATION SIGNAGE FOR WAYFINDING 13. RESIDENTIAL WINDOWS (OPERABLE, LOW-E GLASS) - FRAME
- COLOR: BLACK 14. WINDOW AWNING - METAL CUSTOM FABRICATED
- 15. PATIO WALL CMU
- 16. GARAGE OVERHEAD DOOR
- 17. METAL UNIT ENTRY DOOR 18. METAL PATIO GATE
- 19. STEEL COLUMN PAINTED 20. STEEL DOWNSPOUT
- 21. EXTERIOR STEEL STAIR
- 22. PATIO DOOR WITH LIGHT 23. ALUMINUM STOREFRONT




**LEGEND** 



INSPIRATION

**KEY PLAN** 

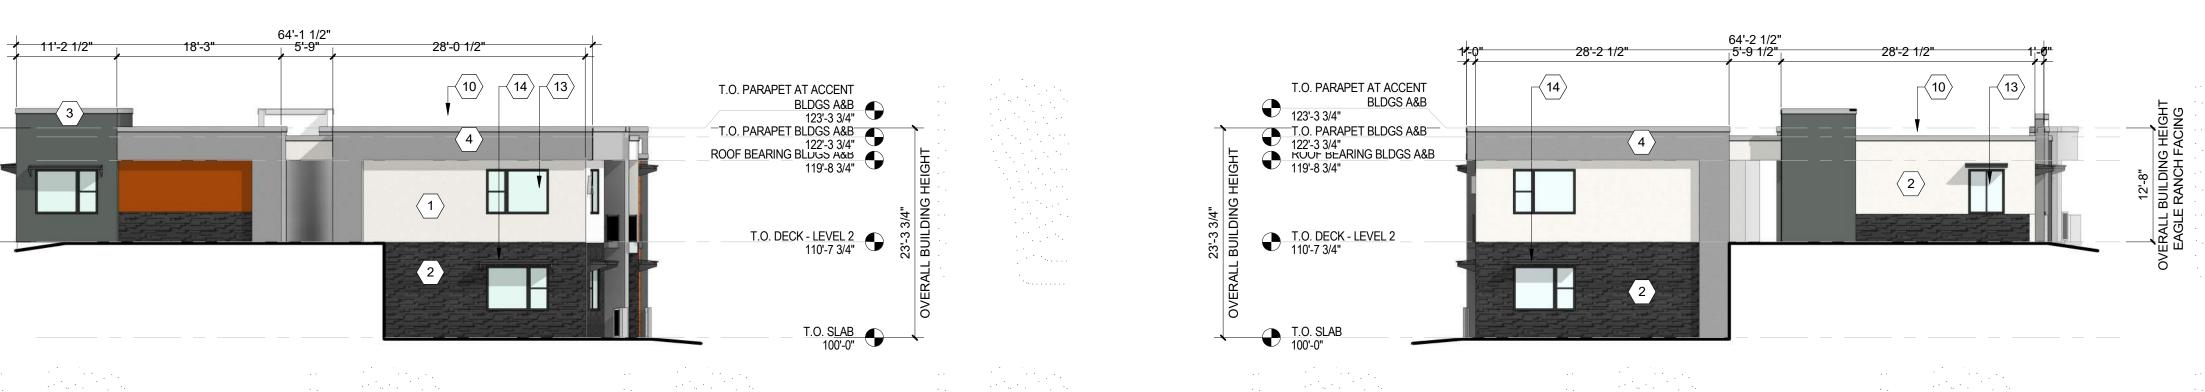


**BUILDING A - SOUTH ELEVATION** 


COMPLIANCE WITH SECTION 5-7(D): CMU WALLS 3'-0" IN HEIGHT 5-7(D)(1)

COMPLIANCE WITH SECTION 5-11(D): PRIMARY BUILDING ENTRANCE COMPLIES WITH 5-11(D)(1) RECESSED WINDOWS 2" WITH 2" CASING 5-11(D)(3)

COMPLIANCE WITH SECTION 5-11(E)(2): PROVIDE WINDOWS ON UPPER FLOORS 5-11(E)(2)(a&b)2&3 PROVIDE AWNINGS OVER WINDOWS 5-11(E)(2)(a&b)2&3 CHANGE IN COLOR EVERY 50 FT 5-11(E)(2)(a)3 RECESSED WINDOWS 2" AT UPPER FLOORS 5-11(E)(2)(b)1 GROUND FLOOR STREET-FACING FACADE CONTAINS MINIMUM OF 30 PERCENT TRANSPARENT WINDOWS/DOORS 5-11(E)(2)(b) 2

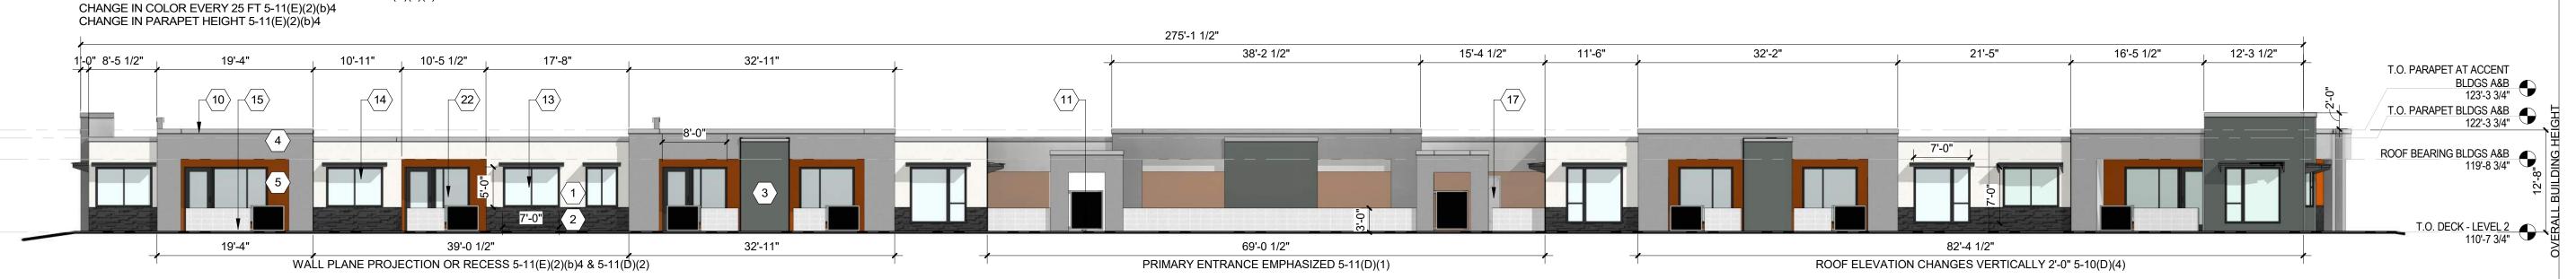

BUILDING A - WEST ELEVATION(STREET-FACING FACADE)

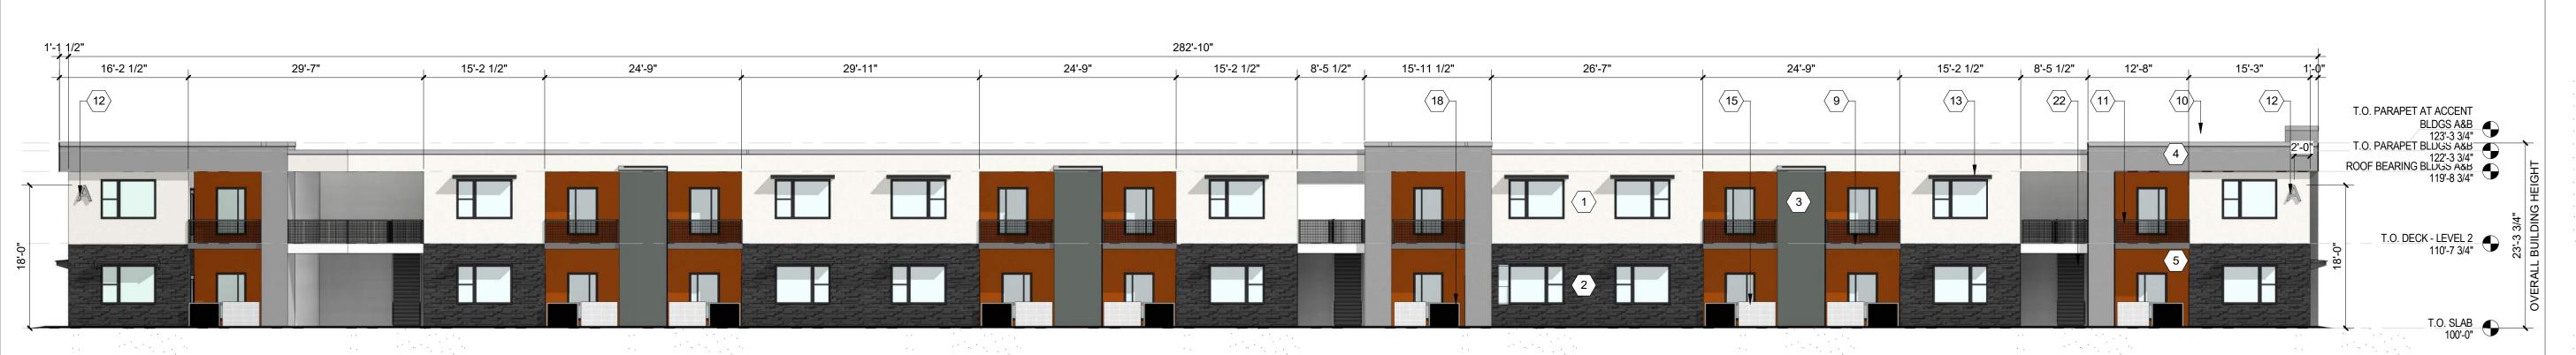



PROJECT

EAGLE RANG ALBUQUERQUI

**DESIGN REVIEW** BOARD (DRB) MINOR SITE PLAN **AMENDMENT** 

REVISIONS DRAWN BY VM, AG **REVIEWED BY** 10/12/2021 20-0286 PROJECT NO:

DRAWING NAME

EXTERIOR **ELEVATIONS -BUILDING A** 

SHEET NO

**SDP5.1** 

- A. ALL ROOF MOUNTED MECHANICAL EQUIPMENT SHALL BE SCREENED BY PARAPET WALL AND NOT BE VISIBLE WHEN VIEWED FROM 5' ABOVE GRADE AT ANY PROPERTY LINE.
- B. ALL DIMENSIONS SHOWN ARE TO OUTSIDE FACE OF FINISH UNLESS OTHERWISE NOTED.
- C. BUILDING IDENTIFICATION SIGNAGE TO BE A MINIMUM OF 18" HIGH CHARACTERS WITH A MINIMUM OF 3" BRUSH STROKE WITH CONTRASTING ALUMINUM COLORS LIT FROM DUSK UNTIL DAWN AS WELL AS DAYLIGHT HOURS, PER
- 2009 IFC. MOUNT AT 15'-20' ABOVE FINISH FLOOR.
- D. ALL IDO REQUIREMENTS WILL BE MET PER SECTION 5-11(E)(2); REF: BUILDING FLOOR PLAN SHEETS FOR
- ADDITIONAL INFORMATION. E. ROOF DRAINAGE BY WAY OF EXTERNAL DOWNSPOUTS.

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- 1. FIELD COLOR NEUTRAL WARM WHITE STUCCO FINISH MATERIAL
- 2. ACCENT COLOR/MATERIAL #1 DARK MASONRY VENEER 3. ACCENT COLOR/MATERIAL #2 - DARK GRAY - ACCENT PANELIZED FIBER CEMENT BOARD
- 4. ACCENT COLOR #3 LIGHT GRAY ACCENT STUCCO FINISH
- 5. ACCENT COLOR #4 RUST TONE ACCENT STUCCO FINISH 6. ACCENT COLOR #5- BLUE TONE - ACCENT STUCCO FINISH
- 7. NOT USED 8. ACCENT COLOR #7 - YELLOW TONE - ACCENT STUCCO FINISH
- 10. PREFINISHED METAL COPING COLOR TO MATCH ADJACENT MATERIAL OR STANDARD NEUTRAL COLOR
- 9. FIBER CEMENT BOARD FACIA TO MATCH MASONRY VENEER
- COLOR: BLACK

12. BUILDING IDENTIFICATION SIGNAGE FOR WAYFINDING

13. RESIDENTIAL WINDOWS (OPERABLE, LOW-E GLASS) - FRAME

14. WINDOW AWNING - METAL CUSTOM FABRICATED

11. GUARDRAIL - METAL CUSTOM FABRICATED

- 15. PATIO WALL CMU
- 16. GARAGE OVERHEAD DOOR
- 17. METAL UNIT ENTRY DOOR
- 18. METAL PATIO GATE
- 19. STEEL COLUMN PAINTED 20. STEEL DOWNSPOUT
- 21. EXTERIOR STEEL STAIR
- 22. PATIO DOOR WITH LIGHT 23. ALUMINUM STOREFRONT
- ACCENT COLOR/MATERIAL #2 DARK GRAY ACCENT PANELIZED FIBER CEMENT BOARD



ACCENT STUCCO FINISH


STUCCO FINISH

MASONRY VENEER

FIELD COLOR - NEUTRAL WARM WHITE

ACCENT COLOR/MATERIAL #1 - DARK

**LEGEND** 

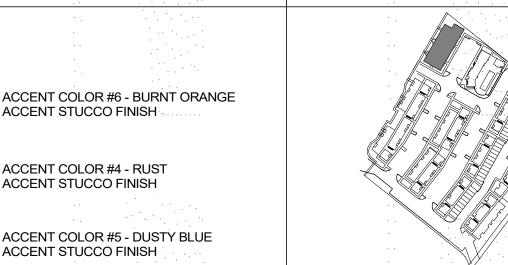

ACCENT STUCCO FINISH

ACCENT COLOR #4 - RUST

ACCENT STUCCO FINISH


ACCENT STUCCO FINISH

T.O. SLAB-L.2


**KEY PLAN** 

PERICH SABATINI ARCHITECTURE DESIGN

INSPIRATION

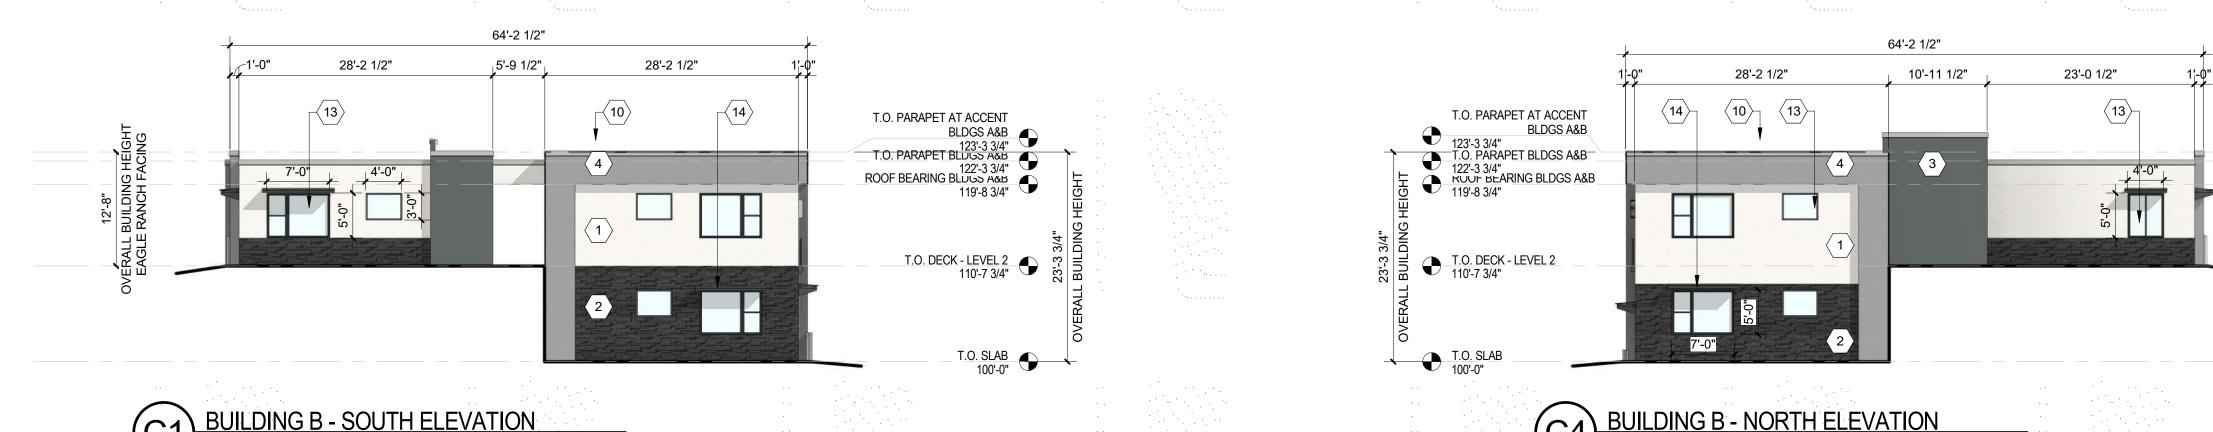

108'-6 1/2" ROOF ELEVATION CHANGES VERTICALLY 2'-0" 5-10(D)(4) COMPLIANCE WITH SECTION 5-7(D): CMU WALLS 3'-0" IN HEIGHT 5-7(D)(1) 157'-2" COMPLIANCE WITH SECTION 5-11(D): 22'-2 1/2" 5'-11 1/2" 11'-8 1/2" 14'-10 1/2" 29'-10 1/2" 11'-9 1/2" PRIMARY BUILDING ENTRANCES COMPLY WITH 5-11(D)(1) T.O. PARAPET AT ACCENT
BLDGS A&B
123'-3 3/4" RECESSED WINDOWS 2" WITH 2" CASING 5-11(D)(3) COMPLIANCE WITH SECTION 5-11(E)(2): PROVIDE WINDOWS ON UPPER FLOORS 5-11(E)(2)(a&b)2&3 T.O. PARAPET BLDGS A&B 122'-3 3/4" PROVIDE AWNINGS OVER WINDOWS 5-11(E)(2)(a&b)2&3 CHANGE IN COLOR EVERY 50 FT 5-11(E)(2)(a)3 RECESSED WINDOWS 2" AT UPPER FLOORS 5-11(E)(2)(b)1 GROUND FLOOR STREET-FACING FACADE CONTAINS MINIMUM OF 30 PERCENT TRANSPARENT WINDOWS/DOORS 5-11(E)(2)(b) 2 CHANGE IN COLOR EVERY 25 FT 5-11(E)(2)(b)4 CHANGE IN PARAPET HEIGHT 5-11(E)(2)(b)4 7'-0" 22'-2 1/2" WALL PLANE PROJECTION OR RECESS 5-11(E)(2)(b)4 & 5-11(D)(2)

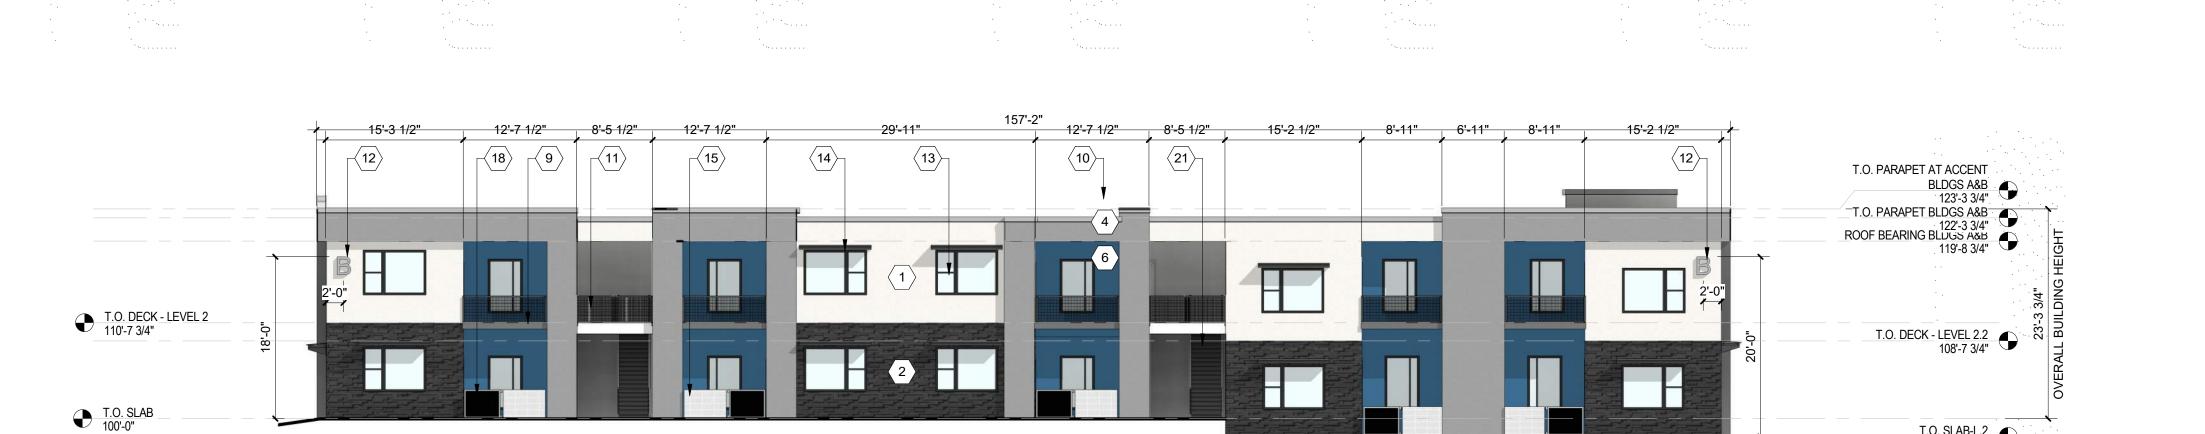



(B2) BUILDING B - WEST ELEVATION (STREET-FACING FACADE)



PROJECT

EAGLE RAN

**DESIGN REVIEW** BOARD (DRB) MINOR SITE PLAN **AMENDMENT** 

<sup>1</sup> √√√√√√√√√√√√√√√√√√√√√√√√√√√√√√√√√√√√	
$\Delta$ $\Delta$ $\Delta$	
DRAWN BY	VM, AG
REVIEWED BY	HFG
DATE	10/12/2021

EXTERIOR **ELEVATIONS -BUILDING B** 

DRAWING NAME

SHEET NO SDP5.2

- A. ALL ROOF MOUNTED MECHANICAL EQUIPMENT SHALL BE SCREENED BY PARAPET WALL AND NOT BE VISIBLE WHEN VIEWED FROM 5' ABOVE GRADE AT ANY PROPERTY LINE.
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- 2009 IFC. MOUNT AT 15'-20' ABOVE FINISH FLOOR. D. ALL IDO REQUIREMENTS WILL BE MET PER SECTION
- 5-11(E)(2); REF: BUILDING FLOOR PLAN SHEETS FOR
- ADDITIONAL INFORMATION. E. ROOF DRAINAGE BY WAY OF EXTERNAL DOWNSPOUTS.

#### SHEET KEYNOTES (X)


- 1. FIELD COLOR NEUTRAL WARM WHITE STUCCO FINISH MATERIAL
- 2. ACCENT COLOR/MATERIAL #1 DARK MASONRY VENEER 3. ACCENT COLOR/MATERIAL #2 - DARK GRAY - ACCENT PANELIZED
- FIBER CEMENT BOARD 4. ACCENT COLOR #3 - LIGHT GRAY - ACCENT STUCCO FINISH
- 5. ACCENT COLOR #4 RUST TONE ACCENT STUCCO FINISH 6. ACCENT COLOR #5- BLUE TONE - ACCENT STUCCO FINISH 7. NOT USED
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- 12. BUILDING IDENTIFICATION SIGNAGE FOR WAYFINDING 13. RESIDENTIAL WINDOWS (OPERABLE, LOW-E GLASS) - FRAME
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- 18. METAL PATIO GATE
- 19. STEEL COLUMN PAINTED 20. STEEL DOWNSPOUT
- 21. EXTERIOR STEEL STAIR 22. PATIO DOOR WITH LIGHT 23. ALUMINUM STOREFRONT


#### FIELD COLOR - NEUTRAL WARM WHITE STUCCO FINISH ACCENT COLOR/MATERIAL #1 - DARK MASONRY VENEER ACCENT STUCCO FINISH ACCENT COLOR/MATERIAL #2 - DARK GRAY ACCENT COLOR #4 - RUST ACCENT PANELIZED FIBER CEMENT BOARD ACCENT STUCCO FINISH


ACCENT COLOR #3 - LIGHT GRAY

ACCENT STUCCO FINISH


**LEGEND** 

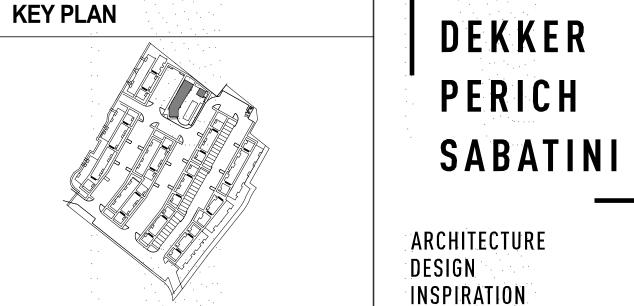

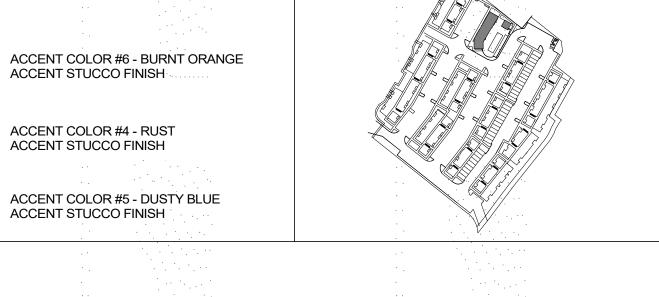

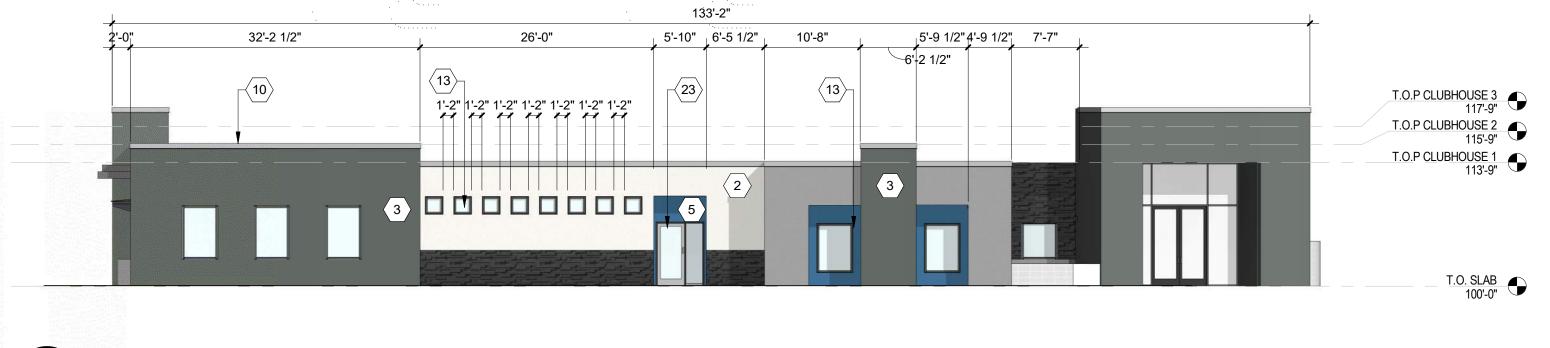


CLUBHOUSE - NORTH ELEVATION

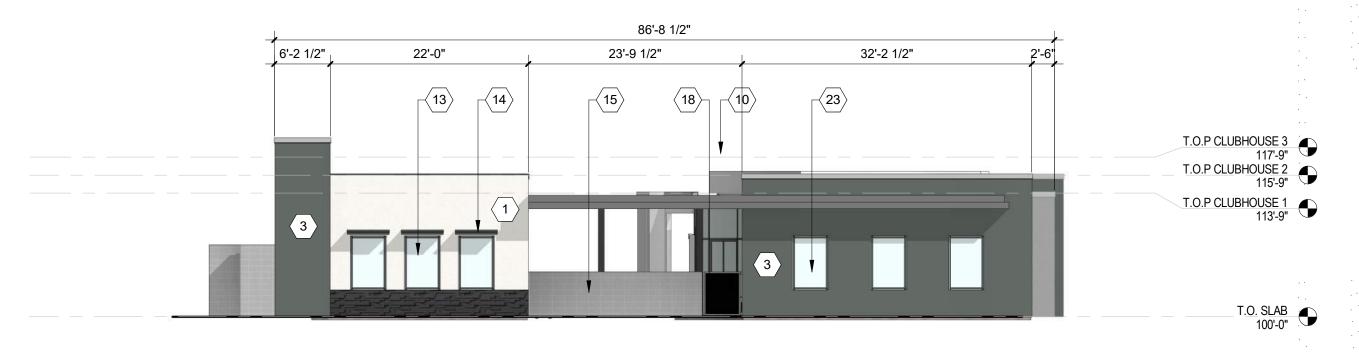


C4) CLUBHOUSE - EAST ELEVATION

3/32" = 1'-0"

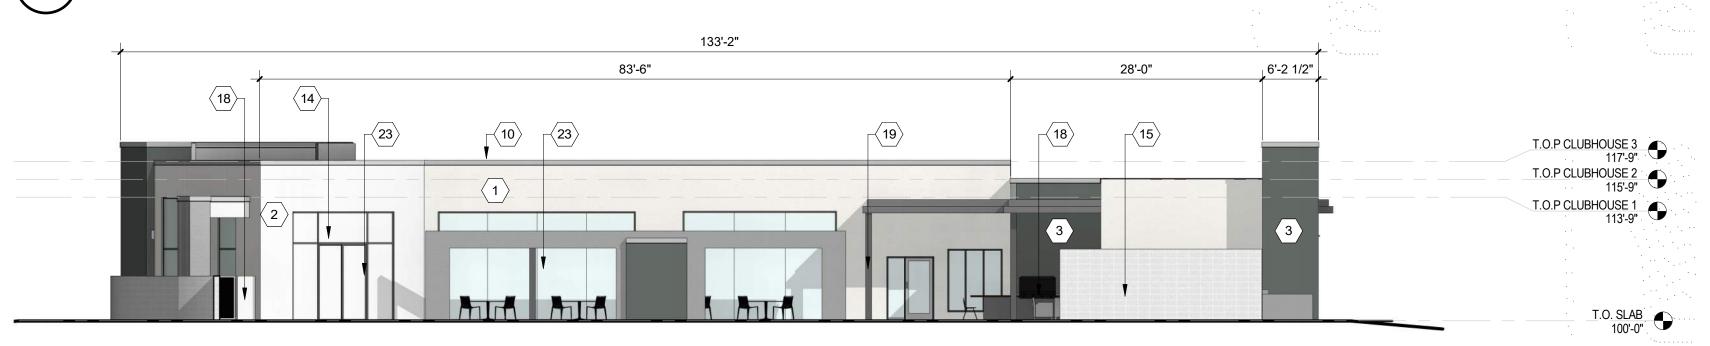

(A2) CLUBHOUSE - WEST ELEVATION

3/32" = 1'-0"

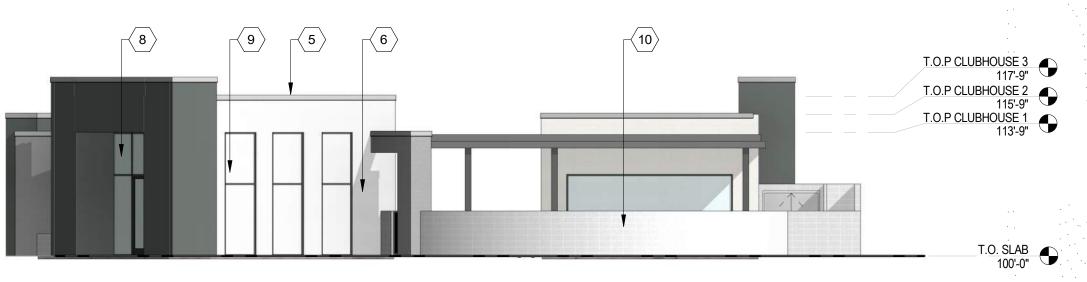

BLDG C WEST ELEVATION-DRB



PROJECT

EAGLE RANC ALBUQUERQUE SEDON/

**DESIGN REVIEW** BOARD (DRB) MINOR SITE PLAN **AMENDMENT** 

REVISIONS DRAWN BY Author **REVIEWED BY** Approver DATE 10/12/2021 PROJECT NO: 20-0286

DRAWING NAME

EXTERIOR **ELEVATIONS -**CLUBHOUSE

SHEET NO

**SDP5.3** 



ARCHITECTURE DESIGN INSPIRATION

HANNAH FEIL GREENHOOD No. 5594

PROJECT

SEDONA WEST
EAGLE RANCH ROAD
ALBUQUERQUE, NM 87112

DESIGN REVIEW BOARD (DRB) MINOR SITE PLAN AMENDMENT

DRAWN BY VM, AG
REVIEWED BY HFG
DATE 10/12/2021
PROJECT NO: 20-0286

DRAWING NAME

EXTERIOR
ELEVATIONS BUILDING D

SDP5.4

- A. ALL ROOF MOUNTED MECHANICAL EQUIPMENT SHALL BE SCREENED BY PARAPET WALL AND NOT BE VISIBLE WHEN VIEWED FROM 5' ABOVE GRADE AT ANY PROPERTY LINE.
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- D. ALL IDO REQUIREMENTS WILL BE MET PER SECTION 5-11(E)(2); REF: BUILDING FLOOR PLAN SHEETS FOR
- ADDITIONAL INFORMATION. E. ROOF DRAINAGE BY WAY OF EXTERNAL DOWNSPOUTS.

#### SHEET KEYNOTES (X)

- 1. FIELD COLOR NEUTRAL WARM WHITE STUCCO FINISH MATERIAL
- 2. ACCENT COLOR/MATERIAL #1 DARK MASONRY VENEER 3. ACCENT COLOR/MATERIAL #2 - DARK GRAY - ACCENT PANELIZED FIBER CEMENT BOARD
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- 6. ACCENT COLOR #5- BLUE TONE ACCENT STUCCO FINISH 7. NOT USED
- 8. ACCENT COLOR #7 YELLOW TONE ACCENT STUCCO FINISH 9. FIBER CEMENT BOARD FACIA - TO MATCH MASONRY VENEER
- 10. PREFINISHED METAL COPING COLOR TO MATCH ADJACENT MATERIAL OR STANDARD NEUTRAL COLOR
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- 13. RESIDENTIAL WINDOWS (OPERABLE, LOW-E GLASS) FRAME COLOR: BLACK
- 14. WINDOW AWNING METAL CUSTOM FABRICATED
- 15. PATIO WALL CMU
- 16. GARAGE OVERHEAD DOOR
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- 18. METAL PATIO GATE
- 19. STEEL COLUMN PAINTED 20. STEEL DOWNSPOUT
- 21. EXTERIOR STEEL STAIR
- 22. PATIO DOOR WITH LIGHT 23. ALUMINUM STOREFRONT

#### FIELD COLOR - NEUTRAL WARM WHITE STUCCO FINISH ACCENT COLOR #6 - BURNT ORANGE ACCENT COLOR/MATERIAL #1 - DARK MASONRY VENEER ACCENT STUCCO FINISH ACCENT COLOR/MATERIAL #2 - DARK GRAY ACCENT COLOR #4 - RUST ACCENT PANELIZED FIBER CEMENT BOARD ACCENT STUCCO FINISH

ACCENT COLOR #5 - DUSTY BLUE


ACCENT STUCCO FINISH

**LEGEND** 



**KEY PLAN** 


DESIGN INSPIRATION

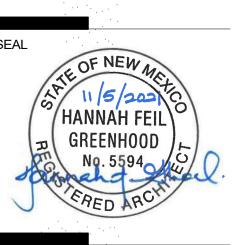

PROJECT

EAGLE RANC ALBUQUERQUE SEDON/

**DESIGN REVIEW** BOARD (DRB) MINOR SITE PLAN **AMENDMENT** 

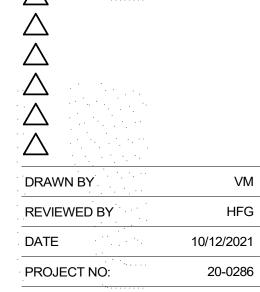


DRAWING NAME

REVISIONS

EXTERIOR **ELEVATIONS -BUILDING E** 

SHEET NO SDP5.5

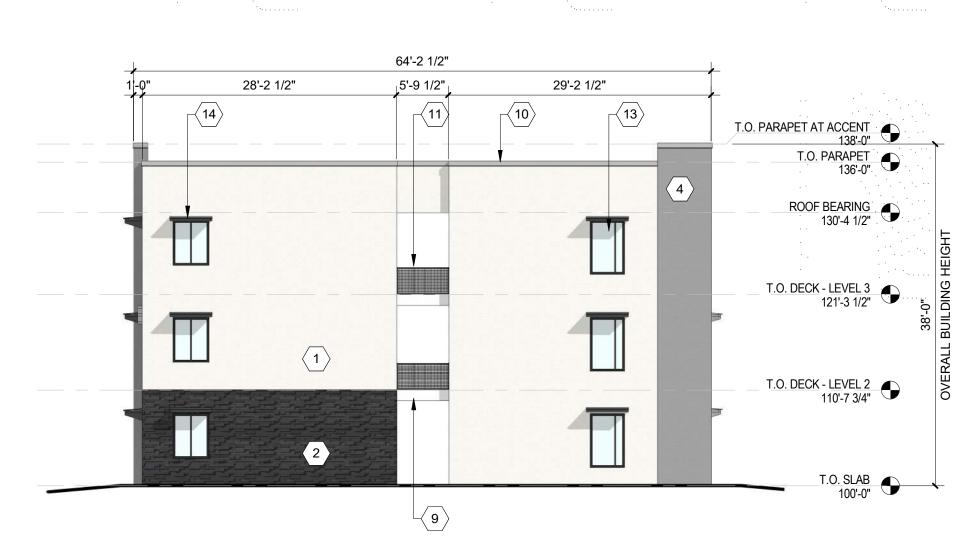

64'-2 1/2" 28'-2 1/2" 28'-2 1/2" 5'-9 1/2" 14  $\langle 10 \rangle_{\Box}$ T.O. PARAPET AT ACCENT 138'-0" ROOF BEARING 130'-4 1/2" T.O. DECK - LEVEL 3 121'-3 1/2" T.O. DECK - LEVEL 2

ACCENT COLOR #3 - LIGHT GRAY


ACCENT STUCCO FINISH

**BUILDING E - SOUTH ELEVATION** 

**BUILDING E - NORTH ELEVATION** 191'-9 1/2" 11'-6 1/2" 16'-5 1/2" 20'-9" 16'-5 1/2" 22'-5" 16'-5 1/2" 20'-9" 16'-5 1/2" 22'-5" 16'-5 1/2" 10'-7 1/2" **13 12** (12)  $-\langle 11 \rangle$ T.O. PARAPET AT ACCENT T.O. PARAPET 136'-0" ROOF BEARING 130'-4 1/2" T.O. DECK - LEVEL 3 121'-3 1/2" T.O. DECK - LEVEL 2 110'-7 3/4"

B2 BUILDING E - WEST ELEVATION

3/32" = 1'-0"

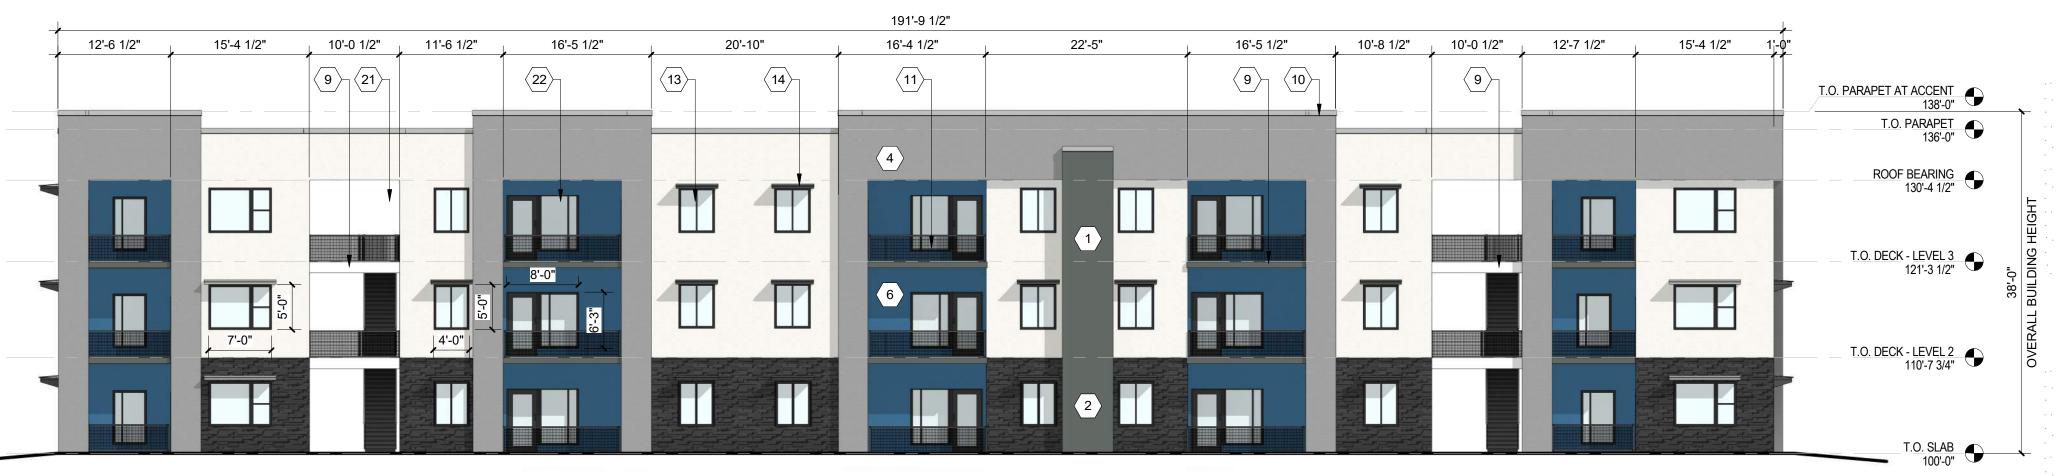

(A2) BUILDING E - EAST ELEVATION

3/32" = 1'-0"

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- ADDITIONAL INFORMATION. E. ROOF DRAINAGE BY WAY OF EXTERNAL DOWNSPOUTS.

#### SHEET KEYNOTES (X)

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- 8. ACCENT COLOR #7 YELLOW TONE ACCENT STUCCO FINISH 9. FIBER CEMENT BOARD FACIA - TO MATCH MASONRY VENEER
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- 12. BUILDING IDENTIFICATION SIGNAGE FOR WAYFINDING
- 13. RESIDENTIAL WINDOWS (OPERABLE, LOW-E GLASS) FRAME COLOR: BLACK
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- 15. PATIO WALL CMU
- 16. GARAGE OVERHEAD DOOR
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- 19. STEEL COLUMN PAINTED
- 20. STEEL DOWNSPOUT 21. EXTERIOR STEEL STAIR
- 22. PATIO DOOR WITH LIGHT 23. ALUMINUM STOREFRONT

STUCCO FINISH ACCENT COLOR/MATERIAL #1 - DARK ACCENT COLOR #6 - BURNT ORANGE MASONRY VENEER ACCENT STUCCO FINISH ACCENT COLOR/MATERIAL #2 - DARK GRAY ACCENT COLOR #4 - RUST ACCENT PANELIZED FIBER CEMENT BOARD ACCENT STUCCO FINISH ACCENT COLOR #5 - DUSTY BLUE ACCENT COLOR #3 - LIGHT GRAY

ACCENT STUCCO FINISH

FIELD COLOR - NEUTRAL WARM WHITE


ACCENT STUCCO FINISH

**LEGEND** 




DESIGN INSPIRATION

**KEY PLAN** 

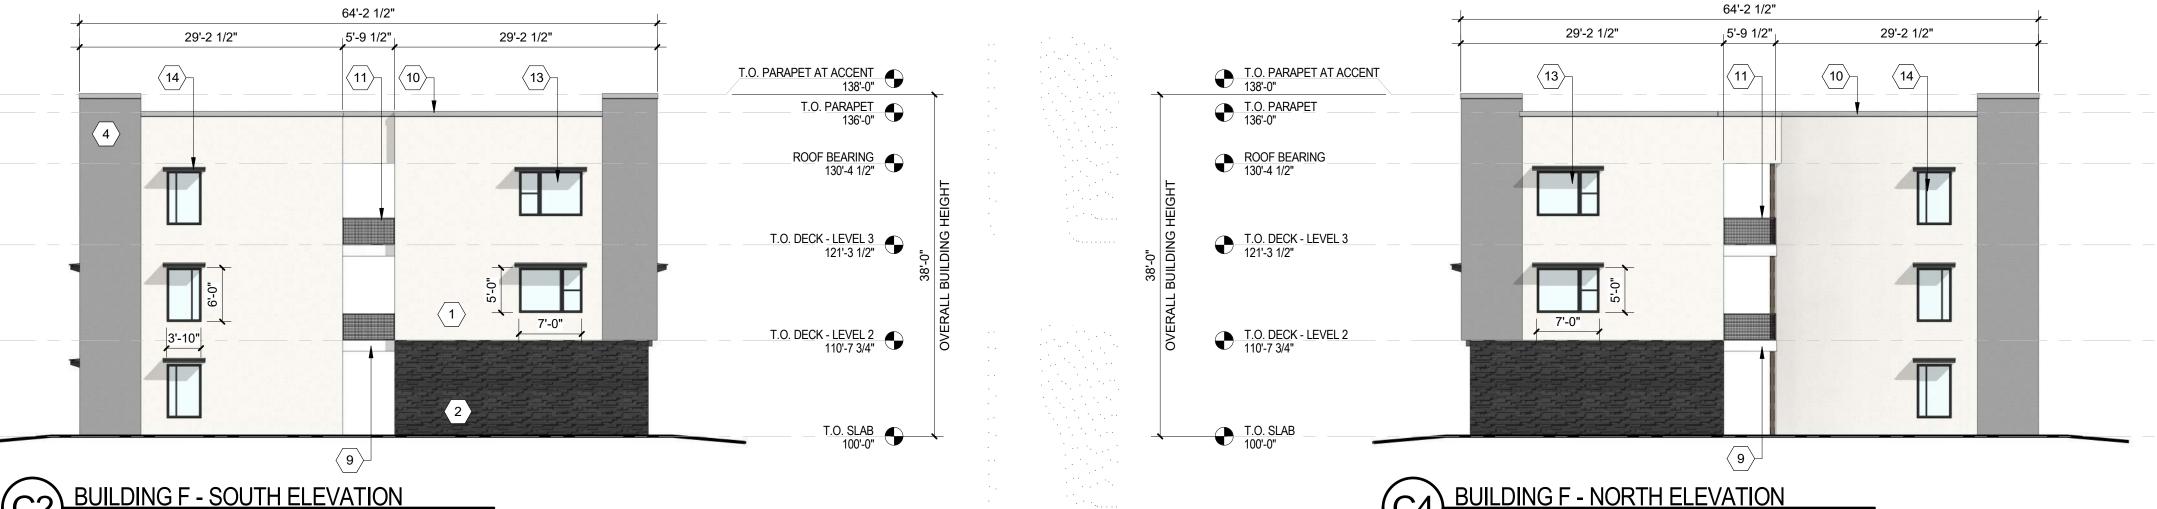

156'-2" 10'-3" 12'-7 1/2" 15'-4" 8'-5 1/2" 34'-9 1/2" 23'-2" 15'-2 1/2" 8'-5 1/2" 15'-2 1/2" 12'-8 1/2" (9)  $\langle 21 \rangle$  $\langle 13 \rangle \langle 12 \rangle$  $\langle 17 \rangle_{\Box}$  $\lceil \sqrt{12} \rangle$  $\langle 11 \rangle_{\Box}$ T.O. PARAPET AT ACCENT T.O. PARAPET 136'-0" ROOF BEARING 130'-4 1/2" T.O. DECK - LEVEL 3 121'-3 1/2" T.O. DECK - LEVEL 2 110'-7 3/4" T.O. SLAB 100'-0"

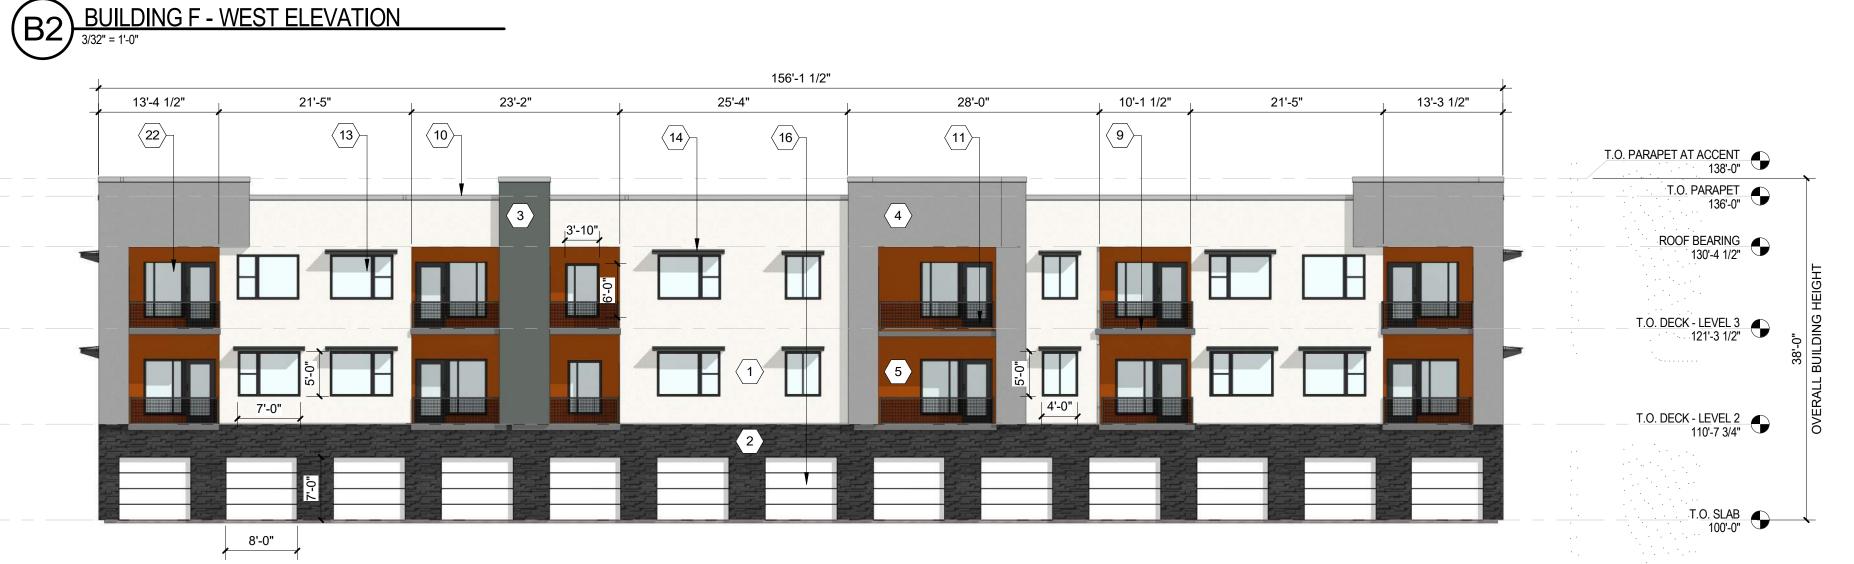



PROJECT

EAGLE RANC ALBUQUERQUE SEDON/

**DESIGN REVIEW** BOARD (DRB) MINOR SITE PLAN **AMENDMENT** 

REVISIONS DRAWN BY **REVIEWED BY** 

VM

HFG

10/12/2021

20-0286

DRAWING NAME

PROJECT NO:


EXTERIOR **ELEVATIONS -BUILDING F** 

SHEET NO SDP5.6


- A. ALL ROOF MOUNTED MECHANICAL EQUIPMENT SHALL BE SCREENED BY PARAPET WALL AND NOT BE VISIBLE WHEN VIEWED FROM 5' ABOVE GRADE AT ANY PROPERTY LINE.
- B. ALL DIMENSIONS SHOWN ARE TO OUTSIDE FACE OF FINISH UNLESS OTHERWISE NOTED.
- C. BUILDING IDENTIFICATION SIGNAGE TO BE A MINIMUM OF 18" HIGH CHARACTERS WITH A MINIMUM OF 3" BRUSH STROKE WITH CONTRASTING ALUMINUM COLORS LIT FROM DUSK UNTIL DAWN AS WELL AS DAYLIGHT HOURS, PER 2009 IFC. MOUNT AT 15'-20' ABOVE FINISH FLOOR.
- D. ALL IDO REQUIREMENTS WILL BE MET PER SECTION 5-11(E)(2); REF: BUILDING FLOOR PLAN SHEETS FOR
- ADDITIONAL INFORMATION. E. ROOF DRAINAGE BY WAY OF EXTERNAL DOWNSPOUTS.


#### SHEET KEYNOTES (X)

- 1. FIELD COLOR NEUTRAL WARM WHITE STUCCO FINISH MATERIAL
- 2. ACCENT COLOR/MATERIAL #1 DARK MASONRY VENEER 3. ACCENT COLOR/MATERIAL #2 - DARK GRAY - ACCENT PANELIZED FIBER CEMENT BOARD
- 4. ACCENT COLOR #3 LIGHT GRAY ACCENT STUCCO FINISH 5. ACCENT COLOR #4 - RUST TONE - ACCENT STUCCO FINISH 6. ACCENT COLOR #5- BLUE TONE - ACCENT STUCCO FINISH
- 7. NOT USED 8. ACCENT COLOR #7 - YELLOW TONE - ACCENT STUCCO FINISH
- 9. FIBER CEMENT BOARD FACIA TO MATCH MASONRY VENEER 10. PREFINISHED METAL COPING - COLOR TO MATCH ADJACENT MATERIAL OR STANDARD NEUTRAL COLOR
- 11. GUARDRAIL METAL CUSTOM FABRICATED
- 12. BUILDING IDENTIFICATION SIGNAGE FOR WAYFINDING 13. RESIDENTIAL WINDOWS (OPERABLE, LOW-E GLASS) - FRAME
- COLOR: BLACK 14. WINDOW AWNING - METAL CUSTOM FABRICATED
- 15. PATIO WALL CMU
- 16. GARAGE OVERHEAD DOOR 17. METAL UNIT ENTRY DOOR
- 18. METAL PATIO GATE
- 19. STEEL COLUMN PAINTED
- 21. EXTERIOR STEEL STAIR
- 22. PATIO DOOR WITH LIGHT 23. ALUMINUM STOREFRONT
- 20. STEEL DOWNSPOUT

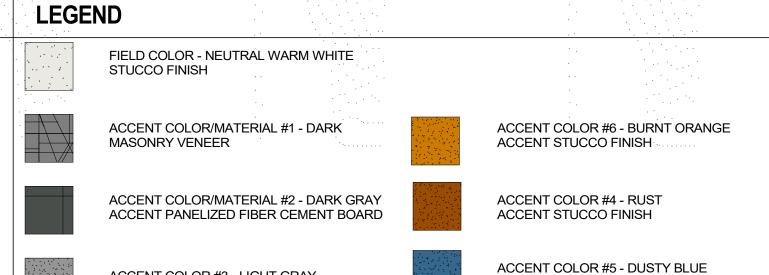


ACCENT STUCCO FINISH

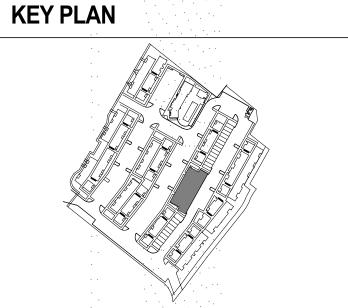

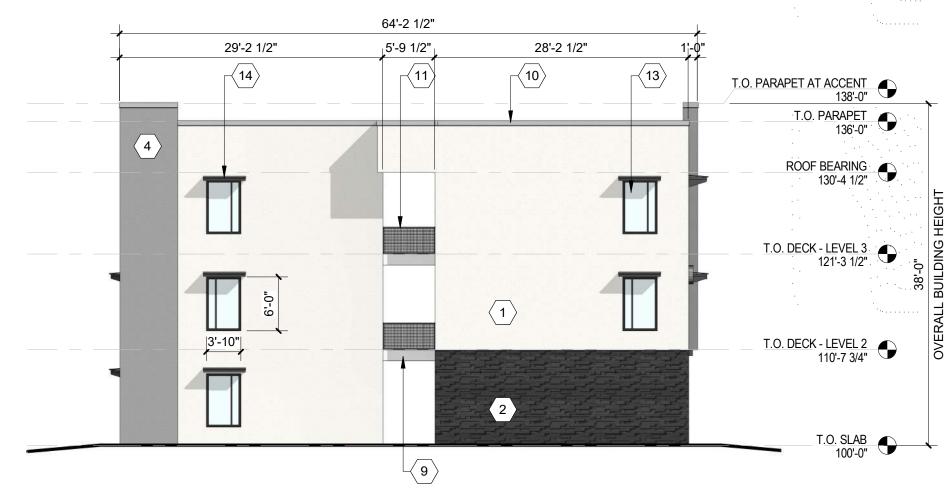

BUILDING G - SOUTH ELEVATION

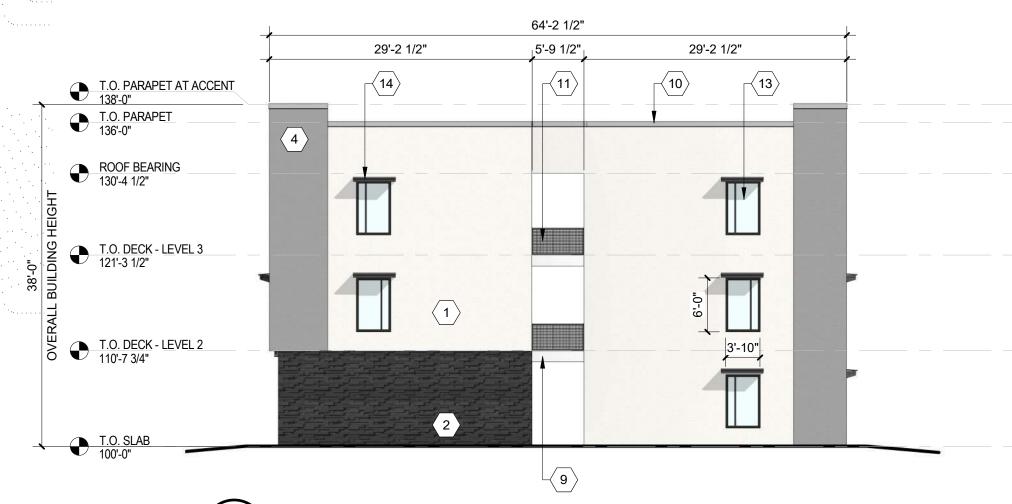

ACCENT COLOR #3 - LIGHT GRAY

ACCENT STUCCO FINISH

**BUILDING G - NORTH ELEVATION** 







PERICH SABATINI

ARCHITECTURE DESIGN INSPIRATION



PROJECT

EAGLE RANC ALBUQUERQUE

**DESIGN REVIEW** BOARD (DRB) MINOR SITE PLAN **AMENDMENT** 

REVISIONS DRAWN BY **REVIEWED BY** 10/12/2021 20-0286 PROJECT NO:

DRAWING NAME

EXTERIOR **ELEVATIONS -BUILDING G** 

SHEET NO

VM


- A. ALL ROOF MOUNTED MECHANICAL EQUIPMENT SHALL BE SCREENED BY PARAPET WALL AND NOT BE VISIBLE WHEN VIEWED FROM 5' ABOVE GRADE AT ANY PROPERTY LINE.
- B. ALL DIMENSIONS SHOWN ARE TO OUTSIDE FACE OF FINISH UNLESS OTHERWISE NOTED.
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- D. ALL IDO REQUIREMENTS WILL BE MET PER SECTION 5-11(E)(2); REF: BUILDING FLOOR PLAN SHEETS FOR
- ADDITIONAL INFORMATION. E. ROOF DRAINAGE BY WAY OF EXTERNAL DOWNSPOUTS.


#### SHEET KEYNOTES (X)

- 1. FIELD COLOR NEUTRAL WARM WHITE STUCCO FINISH MATERIAL
- 2. ACCENT COLOR/MATERIAL #1 DARK MASONRY VENEER 3. ACCENT COLOR/MATERIAL #2 - DARK GRAY - ACCENT PANELIZED FIBER CEMENT BOARD
- 4. ACCENT COLOR #3 LIGHT GRAY ACCENT STUCCO FINISH 5. ACCENT COLOR #4 - RUST TONE - ACCENT STUCCO FINISH
- 6. ACCENT COLOR #5- BLUE TONE ACCENT STUCCO FINISH 7. NOT USED
- 8. ACCENT COLOR #7 YELLOW TONE ACCENT STUCCO FINISH 9. FIBER CEMENT BOARD FACIA - TO MATCH MASONRY VENEER
- 10. PREFINISHED METAL COPING COLOR TO MATCH ADJACENT MATERIAL OR STANDARD NEUTRAL COLOR
- 11. GUARDRAIL METAL CUSTOM FABRICATED
- 12. BUILDING IDENTIFICATION SIGNAGE FOR WAYFINDING
- 13. RESIDENTIAL WINDOWS (OPERABLE, LOW-E GLASS) FRAME COLOR: BLACK
- 14. WINDOW AWNING METAL CUSTOM FABRICATED
- 15. PATIO WALL CMU
- 16. GARAGE OVERHEAD DOOR
- 17. METAL UNIT ENTRY DOOR
- 18. METAL PATIO GATE 19. STEEL COLUMN PAINTED
- 20. STEEL DOWNSPOUT
- 21. EXTERIOR STEEL STAIR
- 22. PATIO DOOR WITH LIGHT 23. ALUMINUM STOREFRONT


FIELD COLOR - NEUTRAL WARM WHITE STUCCO FINISH ACCENT COLOR/MATERIAL #1 - DARK ACCENT COLOR #6 - BURNT ORANGE MASONRY VENEER ACCENT STUCCO FINISH ACCENT COLOR/MATERIAL #2 - DARK GRAY ACCENT COLOR #4 - RUST ACCENT PANELIZED FIBER CEMENT BOARD ACCENT STUCCO FINISH ACCENT COLOR #5 - DUSTY BLUE

ACCENT STUCCO FINISH

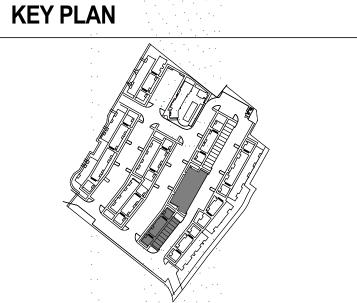

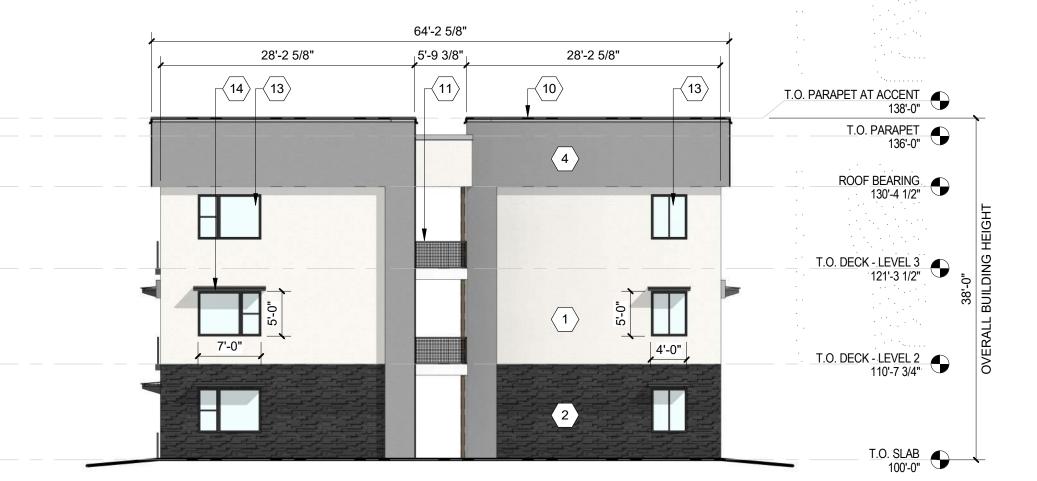

BUILDING H - SOUTH ELEVATION

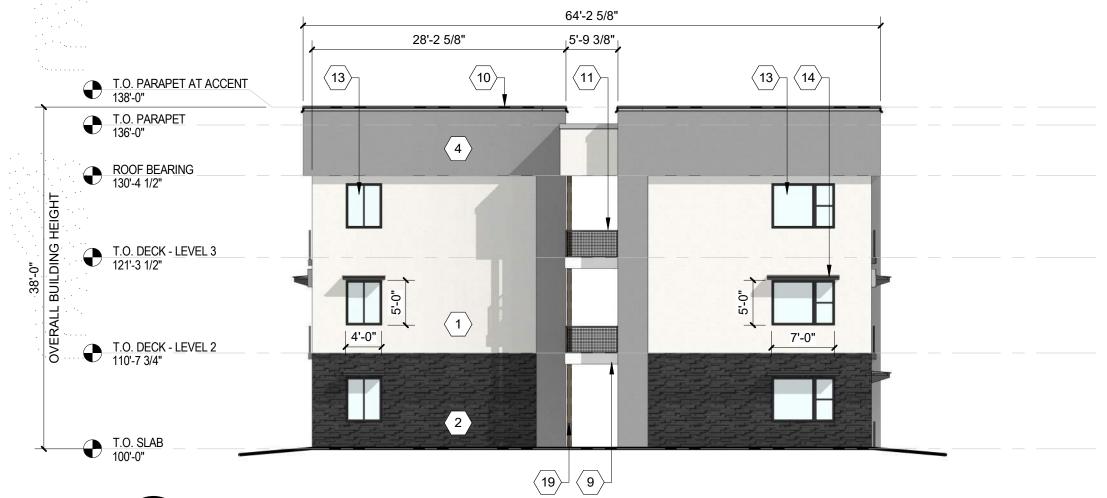


ACCENT COLOR #3 - LIGHT GRAY


ACCENT STUCCO FINISH

**BUILDING H - NORTH ELEVATION** 

**LEGEND** 

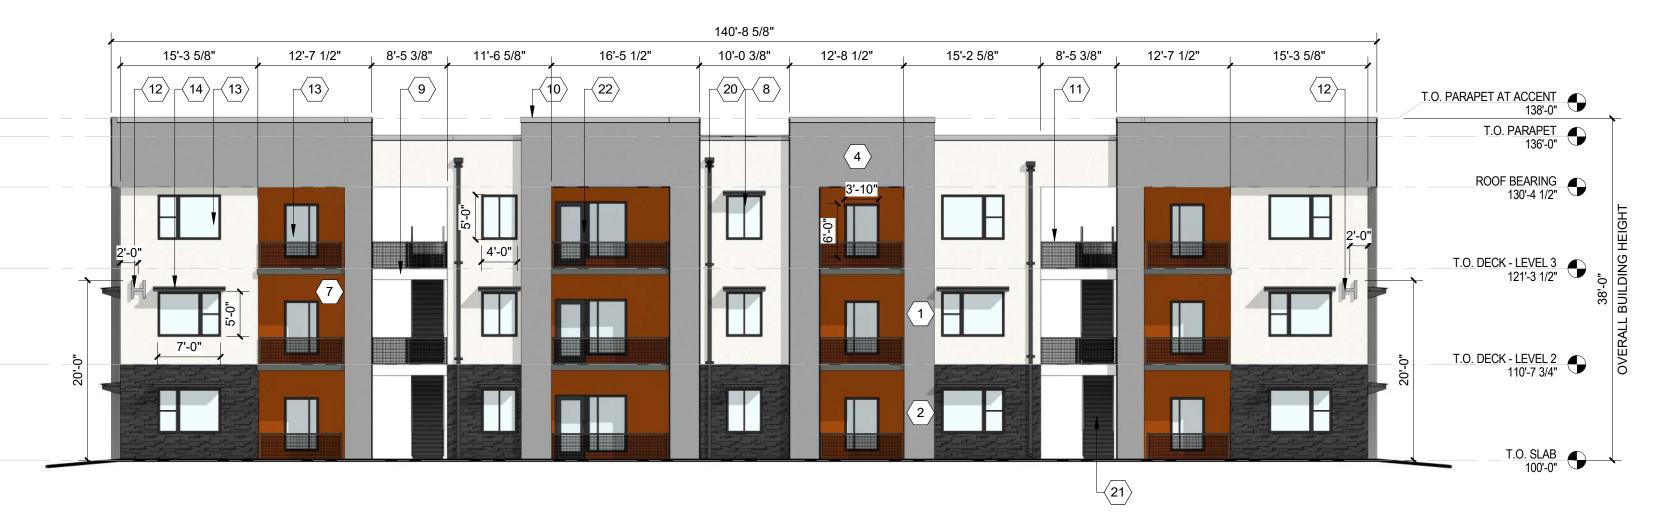


B2) BUILDING H WEST ELEVATION
3/32" = 1'-0"

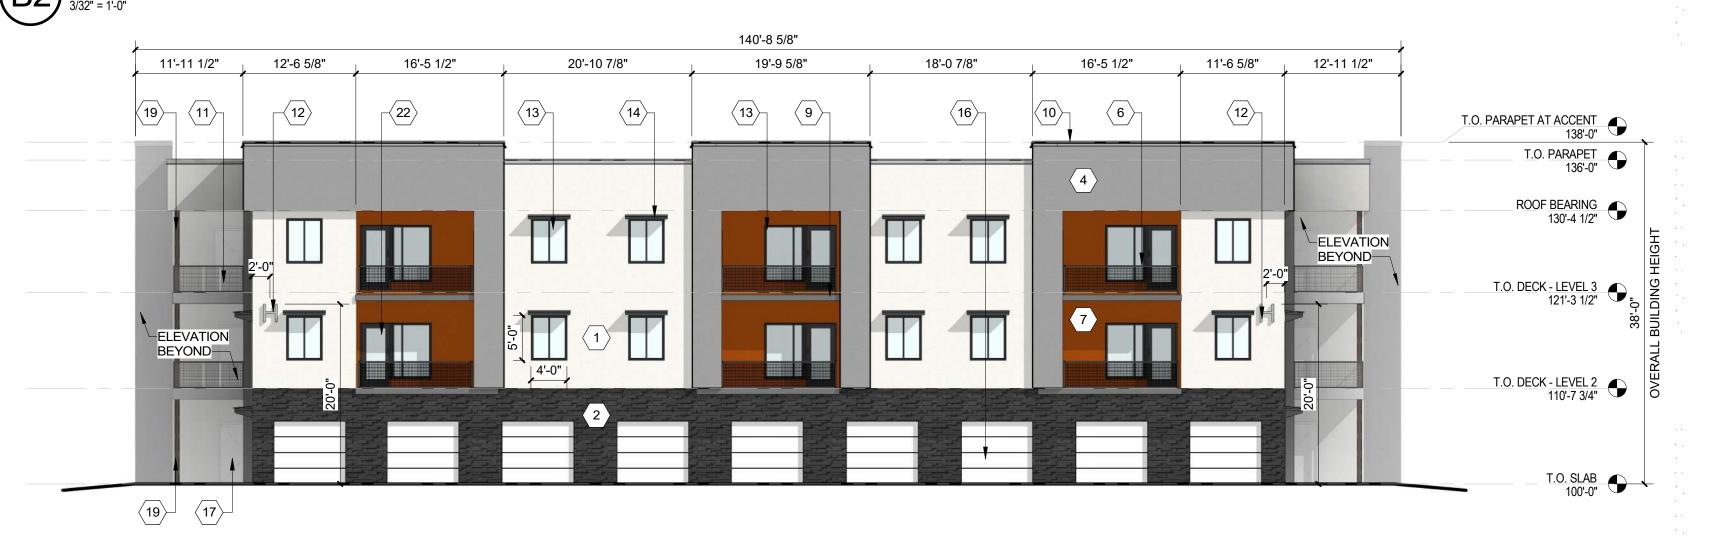



PERICH SABATINI

ARCHITECTURE DESIGN INSPIRATION

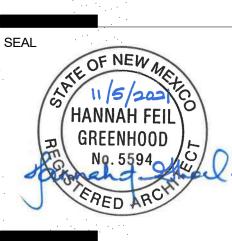

PROJECT

EAGLE RANG ALBUQUERQUI SEDON/

**DESIGN REVIEW** BOARD (DRB)
MINOR SITE PLAN **AMENDMENT** 

REVISIONS DRAWN BY Author **REVIEWED BY** Approver 10/12/2021 PROJECT NO: 20-0286

DRAWING NAME EXTERIOR

**ELEVATIONS -BUILDING H** 

SHEET NO SDP5.8

- A. ALL ROOF MOUNTED MECHANICAL EQUIPMENT SHALL BE SCREENED BY PARAPET WALL AND NOT BE VISIBLE WHEN VIEWED FROM 5' ABOVE GRADE AT ANY PROPERTY LINE.
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- 2009 IFC. MOUNT AT 15'-20' ABOVE FINISH FLOOR. D. ALL IDO REQUIREMENTS WILL BE MET PER SECTION 5-11(E)(2); REF: BUILDING FLOOR PLAN SHEETS FOR
- ADDITIONAL INFORMATION. E. ROOF DRAINAGE BY WAY OF EXTERNAL DOWNSPOUTS.

#### SHEET KEYNOTES (X)

- 1. FIELD COLOR NEUTRAL WARM WHITE STUCCO FINISH MATERIAL
- 2. ACCENT COLOR/MATERIAL #1 DARK MASONRY VENEER 3. ACCENT COLOR/MATERIAL #2 - DARK GRAY - ACCENT PANELIZED FIBER CEMENT BOARD
- 4. ACCENT COLOR #3 LIGHT GRAY ACCENT STUCCO FINISH 5. ACCENT COLOR #4 - RUST TONE - ACCENT STUCCO FINISH
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- 13. RESIDENTIAL WINDOWS (OPERABLE, LOW-E GLASS) FRAME COLOR: BLACK
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- 15. PATIO WALL CMU
- 16. GARAGE OVERHEAD DOOR
- 17. METAL UNIT ENTRY DOOR 18. METAL PATIO GATE
- 19. STEEL COLUMN PAINTED
- 20. STEEL DOWNSPOUT 21. EXTERIOR STEEL STAIR
- 22. PATIO DOOR WITH LIGHT
- 23. ALUMINUM STOREFRONT

ACCENT COLOR/MATERIAL #1 - DARK ACCENT COLOR #6 - BURNT ORANGE MASONRY VENEER ACCENT STUCCO FINISH ACCENT COLOR/MATERIAL #2 - DARK GRAY ACCENT COLOR #4 - RUST ACCENT PANELIZED FIBER CEMENT BOARD ACCENT STUCCO FINISH ACCENT COLOR #5 - DUSTY BLUE

ACCENT STUCCO FINISH


**LEGEND** 


FIELD COLOR - NEUTRAL WARM WHITE


ACCENT COLOR #3 - LIGHT GRAY


ACCENT STUCCO FINISH


STUCCO FINISH

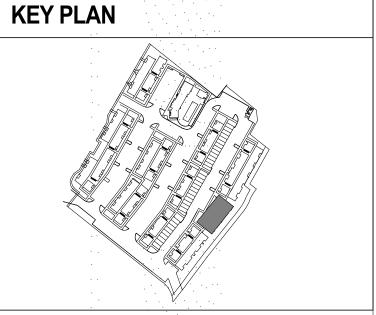


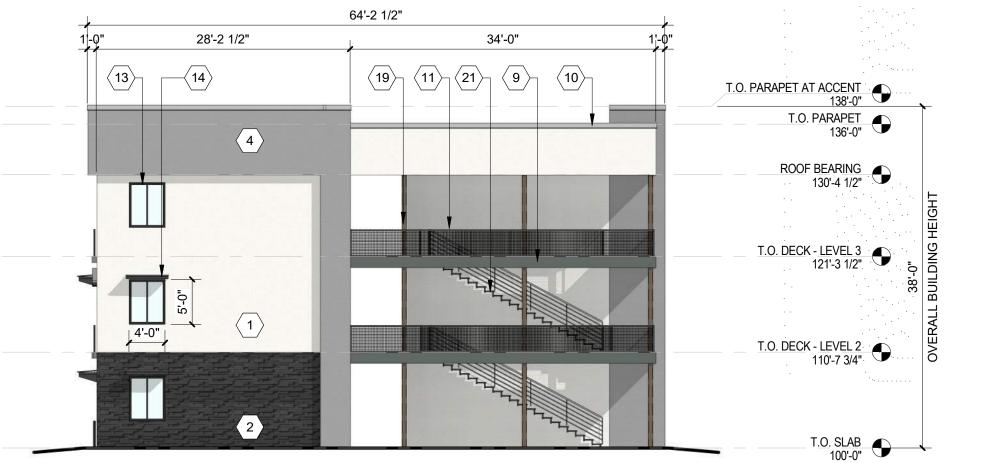

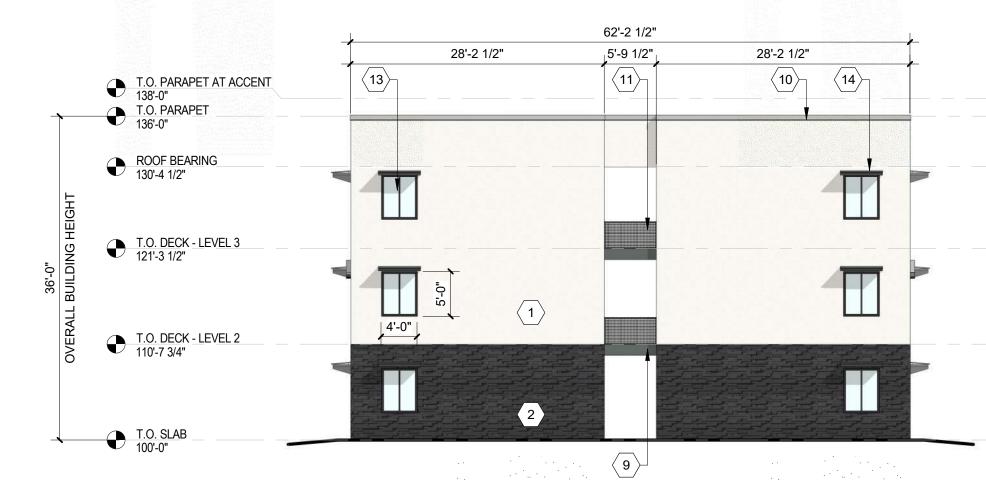

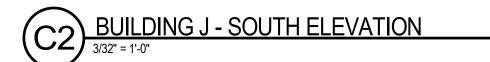

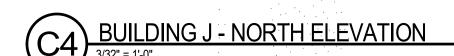

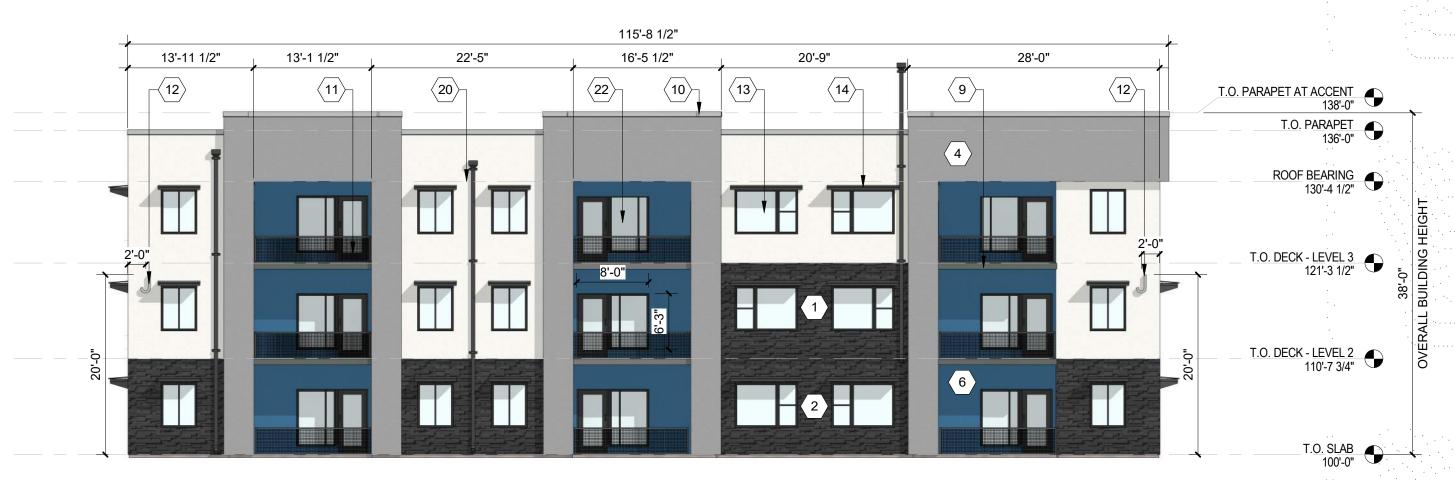





BUILDING J - EAST ELEVATION

3/32" = 1'-0"

PERICH SABATINI

ARCHITECTURE DESIGN INSPIRATION



PROJECT

EAGLE RANG ALBUQUERQUI SEDON/

**DESIGN REVIEW** BOARD (DRB) MINOR SITE PLAN **AMENDMENT** 

REVISIONS DRAWN BY **REVIEWED BY** 10/12/2021 PROJECT NO:

DRAWING NAME EXTERIOR **ELEVATIONS -BUILDING J** 

SHEET NO

**SDP5.9** 

VM, JF


20-0286

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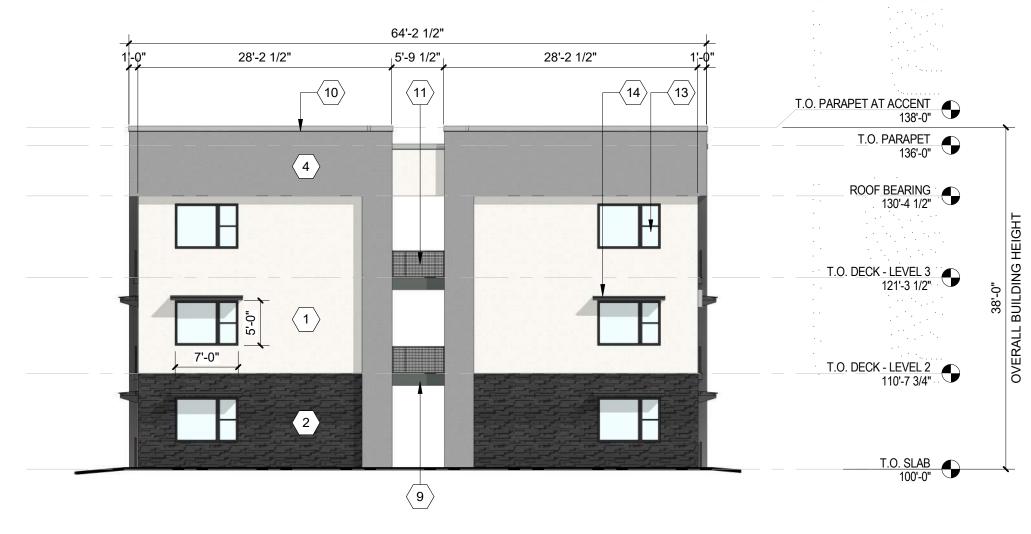
#### SHEET KEYNOTES (X)

- 1. FIELD COLOR NEUTRAL WARM WHITE STUCCO FINISH MATERIAL
- 2. ACCENT COLOR/MATERIAL #1 DARK MASONRY VENEER 3. ACCENT COLOR/MATERIAL #2 - DARK GRAY - ACCENT PANELIZED
- FIBER CEMENT BOARD 4. ACCENT COLOR #3 - LIGHT GRAY - ACCENT STUCCO FINISH
- 5. ACCENT COLOR #4 RUST TONE ACCENT STUCCO FINISH 6. ACCENT COLOR #5- BLUE TONE - ACCENT STUCCO FINISH
- 7. NOT USED 8. ACCENT COLOR #7 - YELLOW TONE - ACCENT STUCCO FINISH
- 10. PREFINISHED METAL COPING COLOR TO MATCH ADJACENT MATERIAL OR STANDARD NEUTRAL COLOR
- 9. FIBER CEMENT BOARD FACIA TO MATCH MASONRY VENEER 20. STEEL DOWNSPOUT
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- COLOR: BLACK 14. WINDOW AWNING - METAL CUSTOM FABRICATED
- 15. PATIO WALL CMU
- 16. GARAGE OVERHEAD DOOR 17. METAL UNIT ENTRY DOOR
- 18. METAL PATIO GATE
- 19. STEEL COLUMN PAINTED
  - 21. EXTERIOR STEEL STAIR
    - 22. PATIO DOOR WITH LIGHT 23. ALUMINUM STOREFRONT

**LEGEND** FIELD COLOR - NEUTRAL WARM WHITE STUCCO FINISH ACCENT COLOR #6 - BURNT ORANGE ACCENT COLOR/MATERIAL #1 - DARK MASONRY VENEER ACCENT STUCCO FINISH ACCENT COLOR/MATERIAL #2 - DARK GRAY ACCENT COLOR #4 - RUST ACCENT PANELIZED FIBER CEMENT BOARD ACCENT STUCCO FINISH ACCENT COLOR #5 - DUSTY BLUE ACCENT COLOR #3 - LIGHT GRAY ACCENT STUCCO FINISH ACCENT STUCCO FINISH

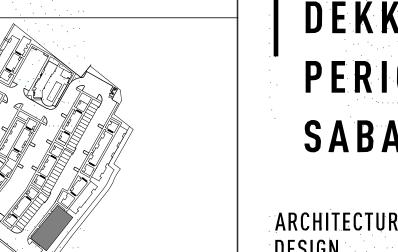


**KEY PLAN** 





BUILDING K - NORTH ELEVATION

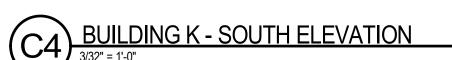



**BUILDING K - WEST ELEVATION** 




BUILDING K - EAST ELEVATION

3/32" = 1'-0"

PERICH SABATINI

ARCHITECTURE DESIGN INSPIRATION

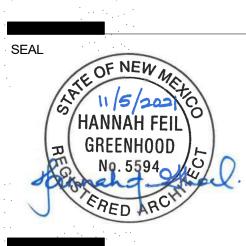

PROJECT

EAGLE RAN SEDON/

**DESIGN REVIEW** BOARD (DRB) MINOR SITE PLAN **AMENDMENT** 

REVISIONS DRAWN BY **REVIEWED BY** 10/12/2021 PROJECT NO:


VM

20-0286

DRAWING NAME EXTERIOR


**ELEVATIONS -BUILDING K** 

SHEET NO SDP5.10

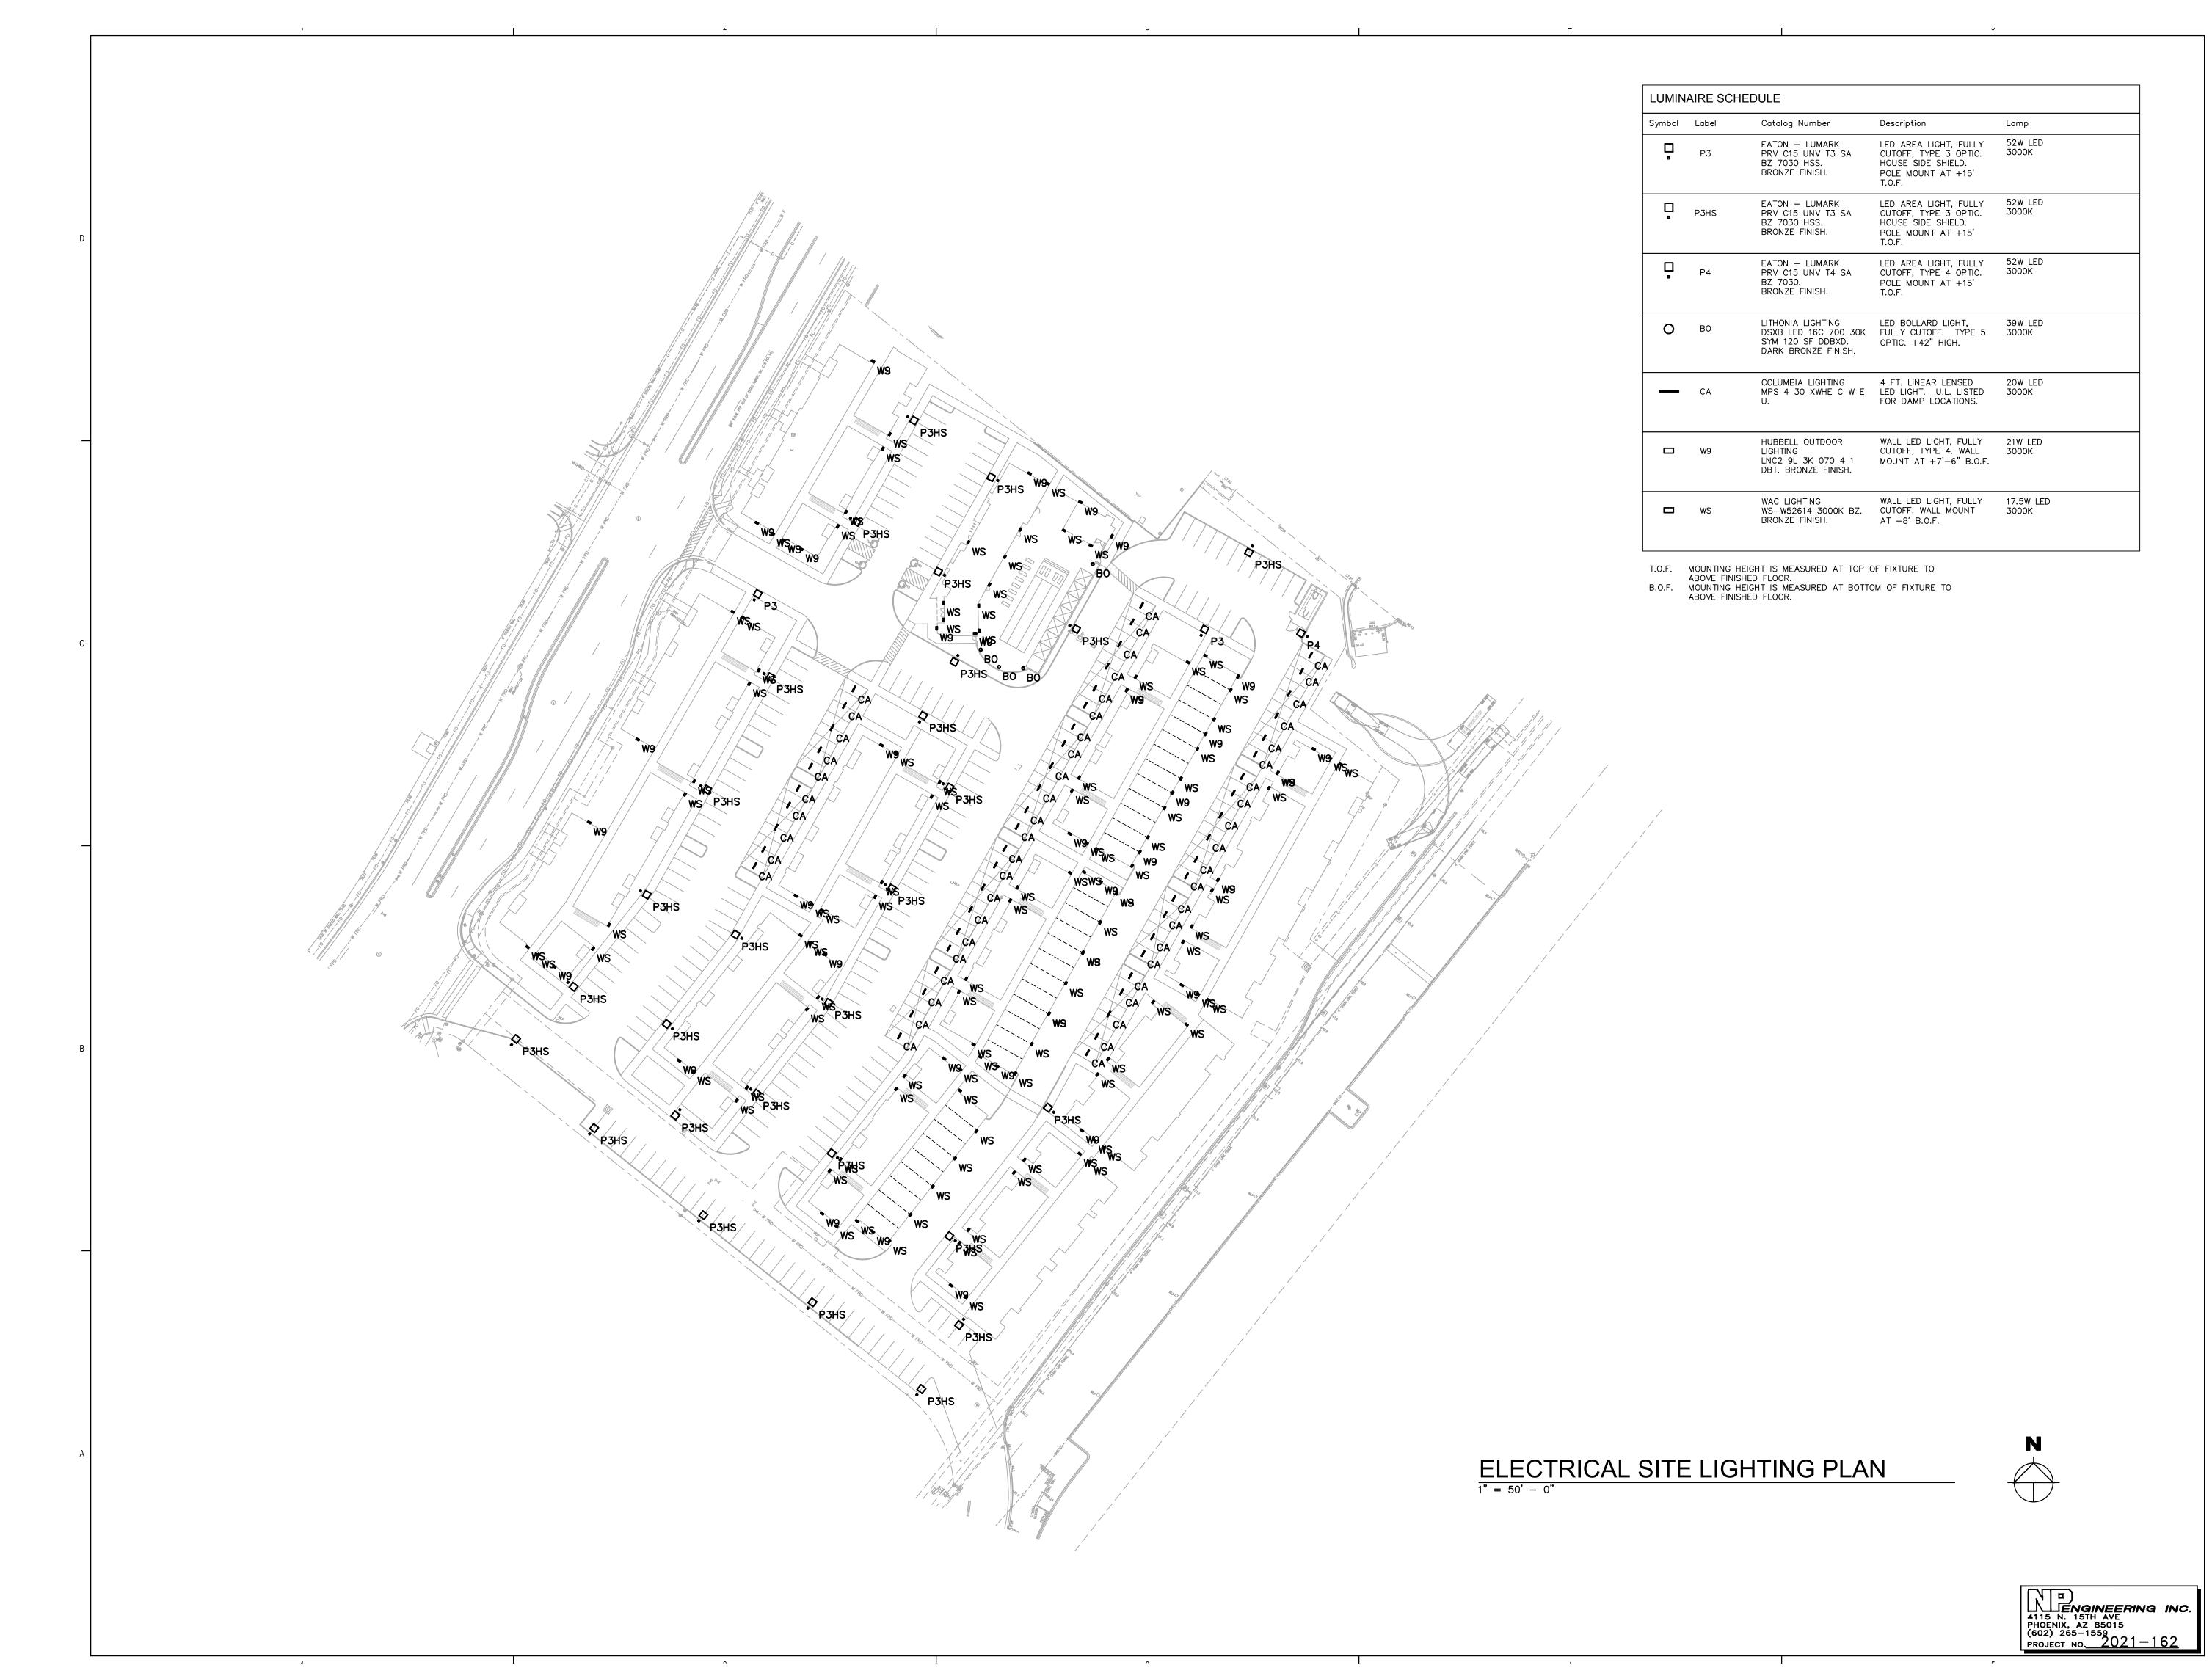

ARCHITECTURE DESIGN **INSPIRATION** 

ARCHITECT

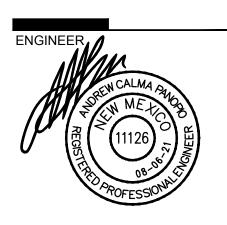

PROJECT

## SITE DEVELOPMENT PLAN

DRAWN BY REVIEWED BY

04/16/2021

PROJECT NO. DRAWING NAME

**ELECTRICAL SITE** LIGHTING PLAN

SHEET NO.

		LUMINAIRE SCHEDULE  Symbol Label Qty Catalog Number Description
		P3 2 PRV C15 UNV T3 SA CUTOFF, TYPE 3 OPTION BZ 7030 HSS. HOUSE SIDE SHIELD. BRONZE FINISH. POLE MOUNT AT +15' T.O.F.
D		P3HS 28 PRV C15 UNV T3 SA CUTOFF, TYPE 3 OPTION BZ 7030 HSS. HOUSE SIDE SHIELD. BRONZE FINISH. POLE MOUNT AT +15' T.O.F.
		P4 1 PRV C15 UNV T4 SA CUTOFF, TYPE 4 OPTION BZ 7030. POLE MOUNT AT +15' BRONZE FINISH. T.O.F.
	\$\\\\\\\\\\\\\\\\\\\\\\\\\\\\\\\\\\\\\	O BO 4 LITHONIA LIGHTING LED BOLLARD LIGHT, DSXB LED 16C 700 30K FULLY CUTOFF. TYPE SYM 120 SF DDBXD. OPTIC. +42" HIGH. DARK BRONZE FINISH.
	**************************************	COLUMBIA LIGHTING 4 FT. LINEAR LENSED  CA 53 MPS 4 30 XWHE C W E LED LIGHT. U.L. LISTE  U. FOR DAMP LOCATIONS
	$\begin{array}{c ccccccccccccccccccccccccccccccccccc$	HUBBELL OUTDOOR WALL LED LIGHT, FULL CUTOFF, TYPE 4. WALL CUTOFF, TYPE 4.
	0.00.0 0.00.1 0.00.4 0.00.4 0.00.0	WAC LIGHTING WALL LED LIGHT, FULL  WS 108 WS-W52614 3000K BZ. CUTOFF. WALL MOUNT BRONZE FINISH. AT +8' B.O.F.
	0.00 0.00 0.00 0.00 0.00 0.00 0.00 0.0	T.O.F. MOUNTING HEIGHT IS MEASURED AT TOP OF FIXTURE TO ABOVE FINISHED FLOOR.  B.O.F. MOUNTING HEIGHT IS MEASURED AT BOTTOM OF FIXTURE TO ABOVE FINISHED FLOOR.
С	\$\\ \begin{align*} \b	STATISTICS
	3.2 2.7 1.5 0.5 0.4 0.6 0.0 0.5 0.9 1.2 1.3 1.5 1.5 1.5 1.5 1.5 1.5 1.5 1.5 1.5 1.5	Description Symbol Avg Max M SITE CALCS + 2.0 fc 37.6 fc 0.
	75 48 4.2 5.6 5.3 5.4 5.9 5.8 5.8 5.0 5.1 5.1 5.2 5.8 5.8 5.0 5.4 5.8 5.0 5.4 5.8 5.0 5.4 5.8 5.0 5.4 5.8 5.0 5.4 5.8 5.0 5.4 5.8 5.0 5.4 5.8 5.0 5.4 5.8 5.0 5.8 5.0 5.8 5.0 5.8 5.0 5.0 5.0 5.0 5.0 5.0 5.0 5.0 5.0 5.0	SPILL LIGHT AT +6 FT. ABOVE PROPERTY LINE  ** 2.5 fc
	7 0 0 0 2 7 W9 0.8 7 1.1 1.0 0.6 0.3 1.4 2.6 0.5 0.1 WS 1.1 1.0 0.6 0.3 1.4 2.6 0.5 0.1 WS 1.1 1.0 0.6 0.3 1.4 2.6 0.5 0.1 WS 1.1 1.0 0.6 0.3 1.4 2.6 0.5 0.1 WS 1.1 1.0 0.5 0.5 0.3 0.7 0.5 0.4 0.5 0.5 0.5 0.5 0.5 0.5 0.5 0.5 0.5 0.5	
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Б	1.2 1.5 1.1 2.2 1.5 1.8 2.3 1.8 1.1 1.5 1.5 1.8 1.1 1.5 1.5 1.8 1.1 1.5 1.5 1.5 1.5 1.5 1.5 1.5 1.5 1.5	
В	50.0 50.0 50.0 50.0 50.0 50.0 50.0 50.0	
	## 12 12 12 12 13 13 15 12 13 15 12 13 13 15 12 13 13 15 12 13 13 15 12 13 13 15 12 13 13 15 12 13 13 15 12 13 13 15 12 13 13 15 12 13 13 15 12 13 13 15 12 13 13 15 12 13 13 15 12 13 13 15 12 13 13 15 12 13 15 13 13 15 12 13 15 13 13 15 12 13 15 13 13 15 12 13 15	
	0.5 1.5 1.4 2.4 2.5 1.5 1.7 1.0 1.5 1.9 1.6 1.5 1.9 1.6 1.5 1.9 1.6 1.5 1.5 1.7 1.9 1.6 1.5 1.5 1.5 1.5 1.5 1.5 1.5 1.5 1.5 1.5	
	1.1 WS. 1.6 0.8 2.8 WS	
	5.2 3.0 5.1 2.3 5.9 5.8 5.8 5.7 1.2 2.6 5 W9 5.0 5.7 1.9 5.7 5.7 5.7 5.7 5.7 5.7 5.7 5.7 5.7 5.7	
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	$\begin{array}{cccccccccccccccccccccccccccccccccccc$	
A	ELECTRIC	AL SITE PHOTOMETRIC PLAN


Symbol	Label	Qty	Catalog Number	Description	Lamp	Lumens	LLF
	Р3	2	EATON — LUMARK PRV C15 UNV T3 SA BZ 7030 HSS. BRONZE FINISH.	LED AREA LIGHT, FULLY CUTOFF, TYPE 3 OPTIC. HOUSE SIDE SHIELD. POLE MOUNT AT +15' T.O.F.	52W LED 3000K	Absolute	0.88
	P3HS	28	EATON — LUMARK PRV C15 UNV T3 SA BZ 7030 HSS. BRONZE FINISH.	LED AREA LIGHT, FULLY CUTOFF, TYPE 3 OPTIC. HOUSE SIDE SHIELD. POLE MOUNT AT +15' T.O.F.	52W LED 3000K	Absolute	0.88
	P4	1	EATON — LUMARK PRV C15 UNV T4 SA BZ 7030. BRONZE FINISH.	LED AREA LIGHT, FULLY CUTOFF, TYPE 4 OPTIC. POLE MOUNT AT +15' T.O.F.	52W LED 3000K	Absolute	0.88
0	ВО	4	LITHONIA LIGHTING DSXB LED 16C 700 30K SYM 120 SF DDBXD. DARK BRONZE FINISH.	LED BOLLARD LIGHT, FULLY CUTOFF. TYPE 5 OPTIC. +42" HIGH.	39W LED 3000K	Absolute	0.95
_	CA	53	COLUMBIA LIGHTING MPS 4 30 XWHE C W E U.	4 FT. LINEAR LENSED LED LIGHT. U.L. LISTED FOR DAMP LOCATIONS.	20W LED 3000K	Absolute	0.90
	W9	35	HUBBELL OUTDOOR LIGHTING LNC2 9L 3K 070 4 1 DBT. BRONZE FINISH.	WALL LED LIGHT, FULLY CUTOFF, TYPE 4. WALL MOUNT AT +7'-6" B.O.F.	21W LED 3000K	Absolute	0.90
	WS	108	WAC LIGHTING WS-W52614 3000K BZ. BRONZE FINISH.	WALL LED LIGHT, FULLY CUTOFF. WALL MOUNT AT +8' B.O.F.	17.5W LED 3000K	1255	0.95

STATISTICS						
Description	Symbol	Avg	Max	Min	Max/Min	Avg/Min
SITE CALCS	+	2.0 fc	37.6 fc	0.0 fc	N/A	N / A
SPILL LIGHT AT +6 FT. ABOVE PROPERTY LINE	*	0.1 fc	0.7 fc	0.0 fc	N/A	N/A

PERICH SABATINI ARCHITECTURE

DEKKER

DESIGN INSPIRATION

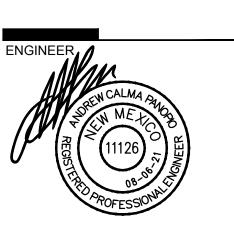

PROJECT

SITE DEVELOPMENT PLAN

REVISIONS

DRAWN BY REVIEWED BY DATE


04/16/2021 PROJECT NO. 19-0058 DRAWING NAME


ELECTRICAL SITE PHOTOMETRIC PLAN

SHEET NO.

ENGINEERING INC.
4115 N. 15TH AVE
PHOENIX, AZ 85015
(602) 265-1559
PROJECT NO. 2021-162



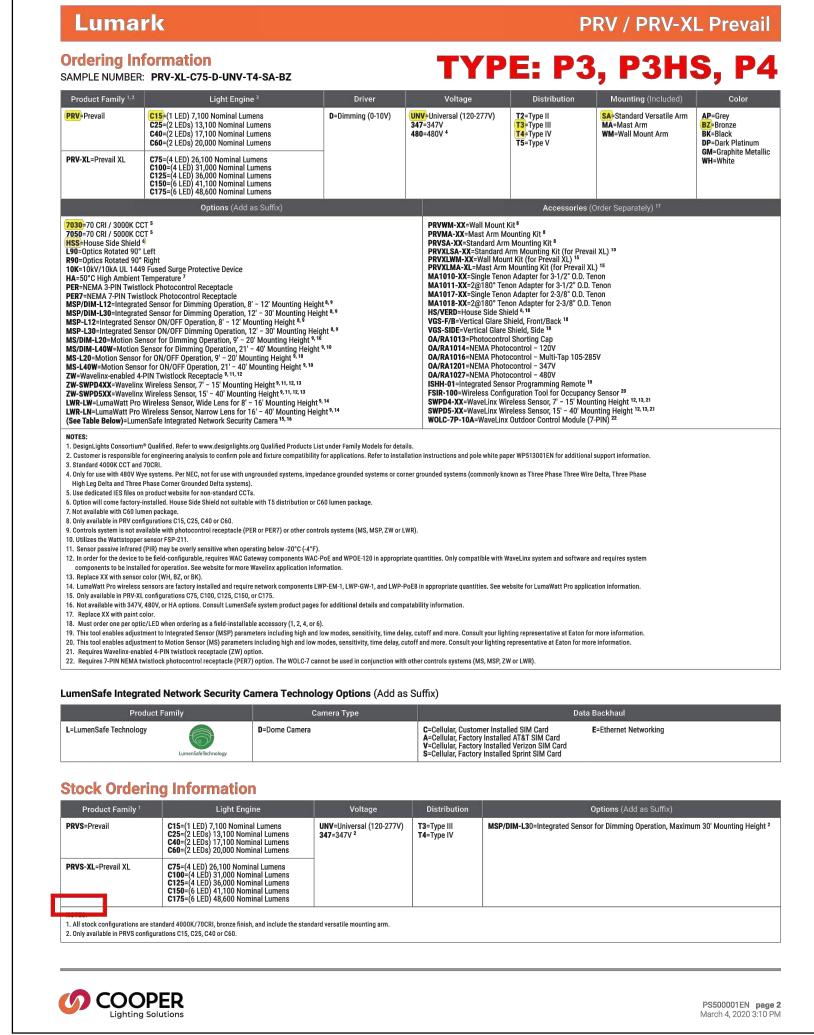


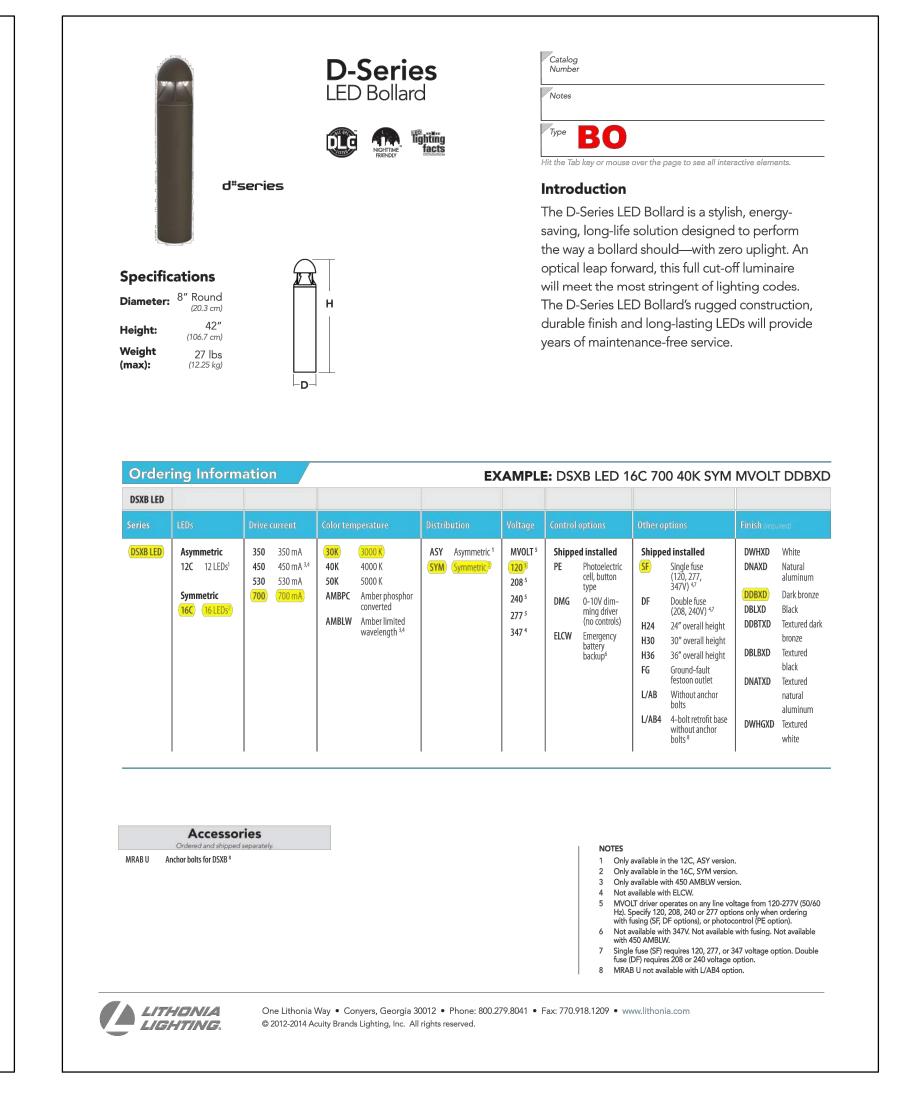



ARCHITECTURE DESIGN INSPIRATION

ARCHITECT

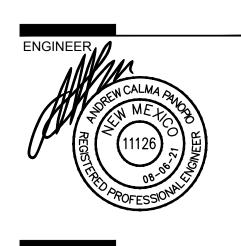

PROJECT

DONA WEST SLE RANCH ROAD QUERQUE, NM 87114

#### SITE DEVELOPMENT PLAN

DRAWN BY

REVIEWED BY

DATE 04/16/2021

PROJECT NO. 19-0058

DRAWING NAME


ELECTRICAL SITE LIGHTING CUT SHEETS


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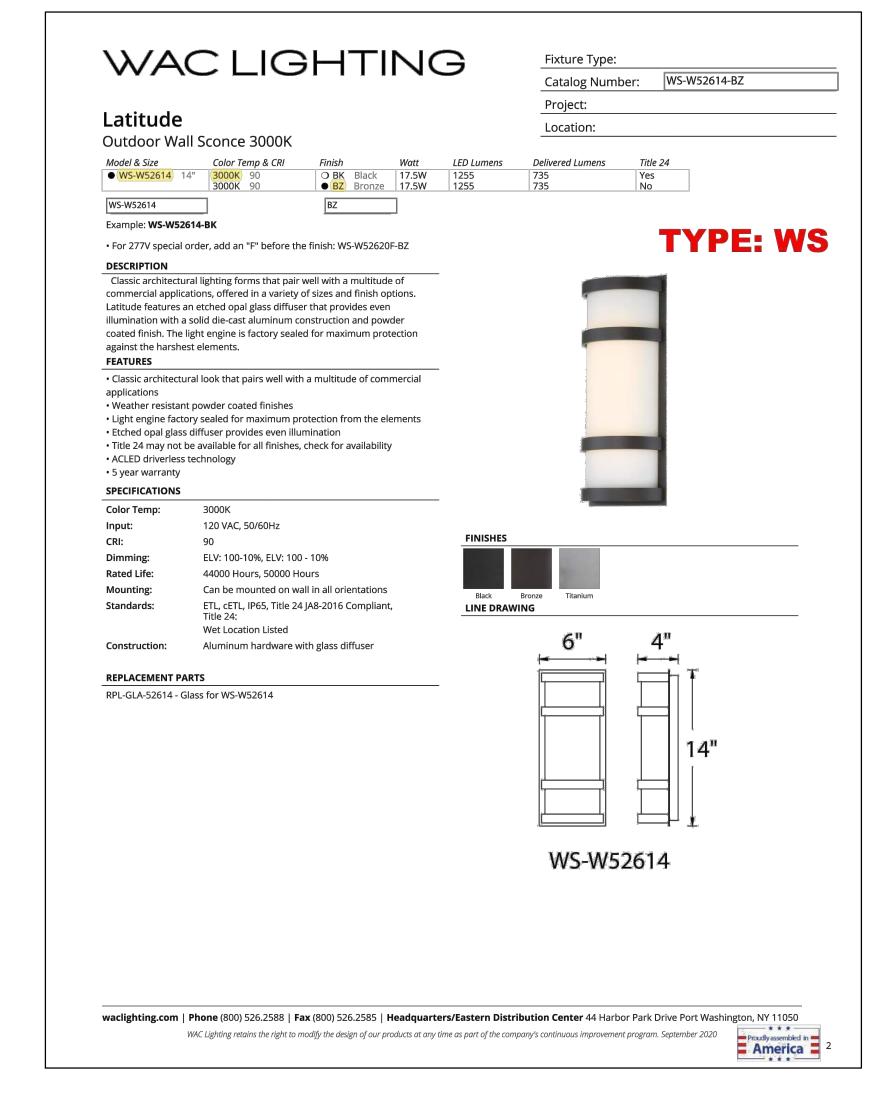
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4115 N. 15TH AVE
PHOENIX, AZ 85015
(602) 265-1559
PROJECT NO. 2021-162

E3






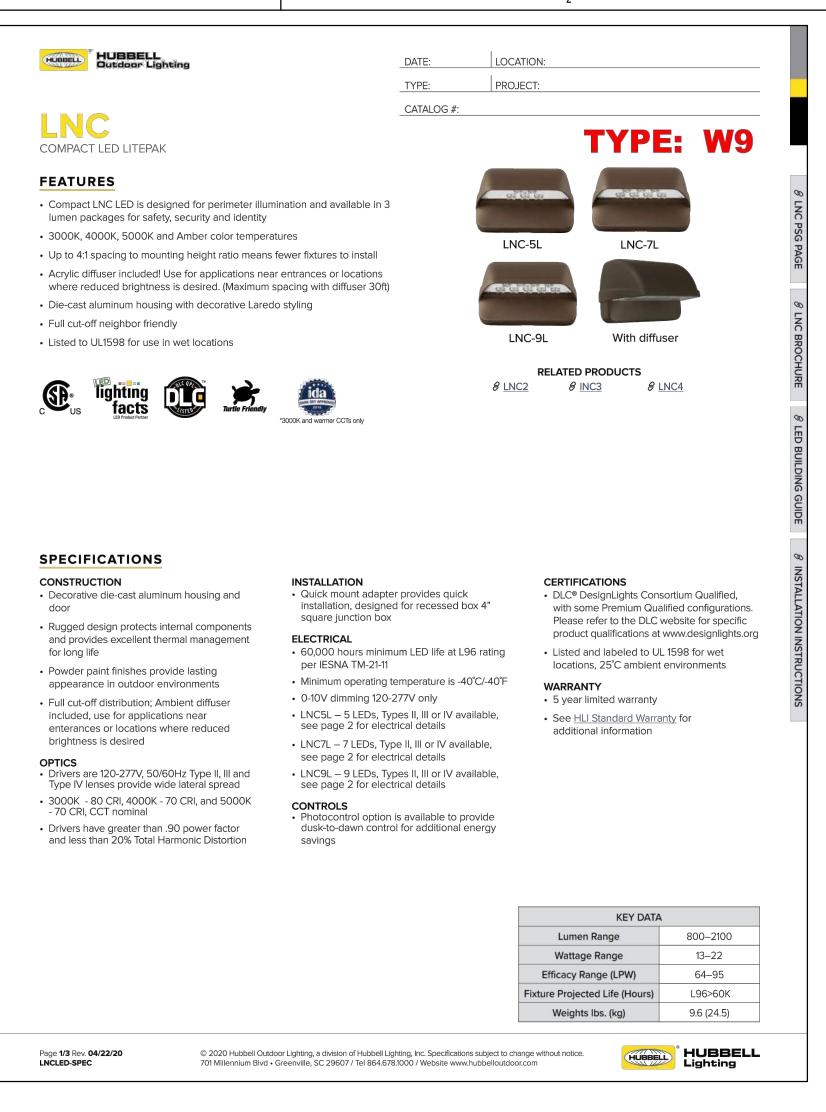

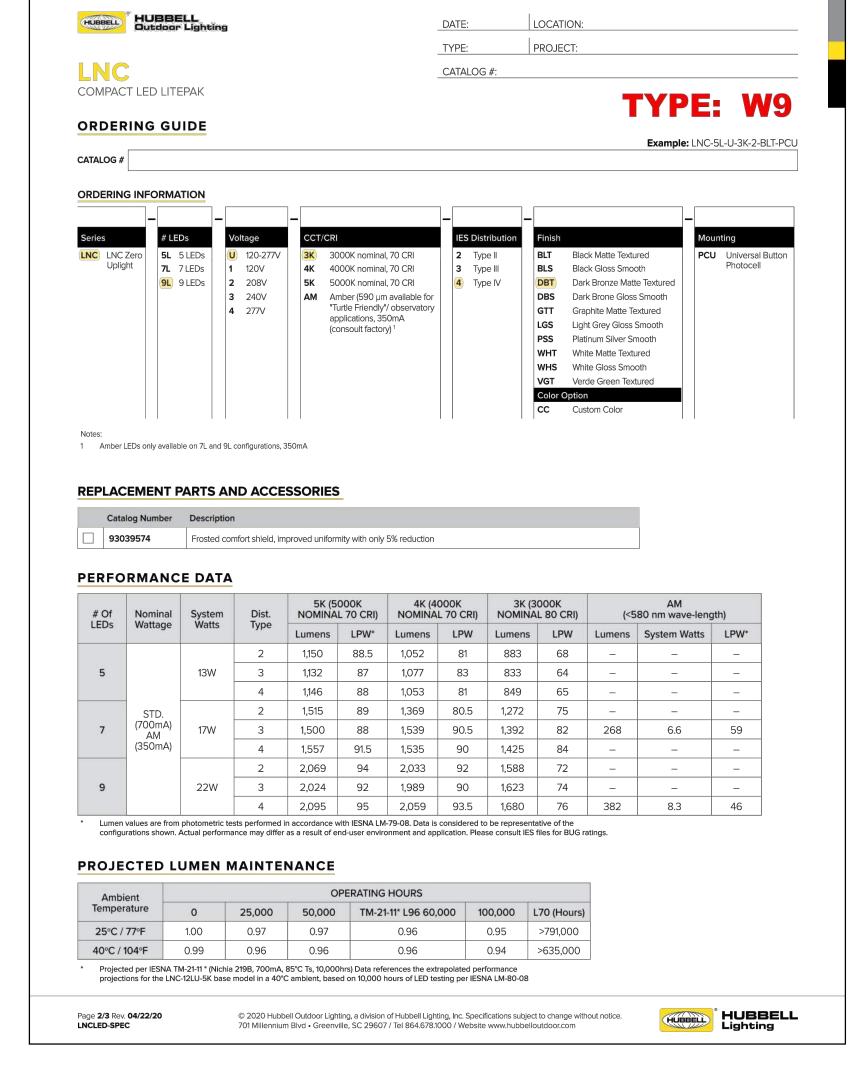

ARCHITECTURE DESIGN INSPIRATION

ARCHITECT

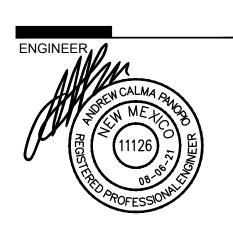

PROJECT

SEDONA WEST EAGLE RANCH ROAD ALBUQUERQUE, NM 87114

SITE DEVELOPMENT PLAN

REVISIONS	
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DRAWN BY

REVIEWED BY

DATE 04/16/2021

PROJECT NO. 19-0058


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ELECTRICAL SITE LIGHTING CUT SHEETS

SHEET NO.

EZ OF

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4115 N. 15TH AVE
PHOENIX, AZ 85015
(602) 265-1559
PROJECT NO. 2021-162

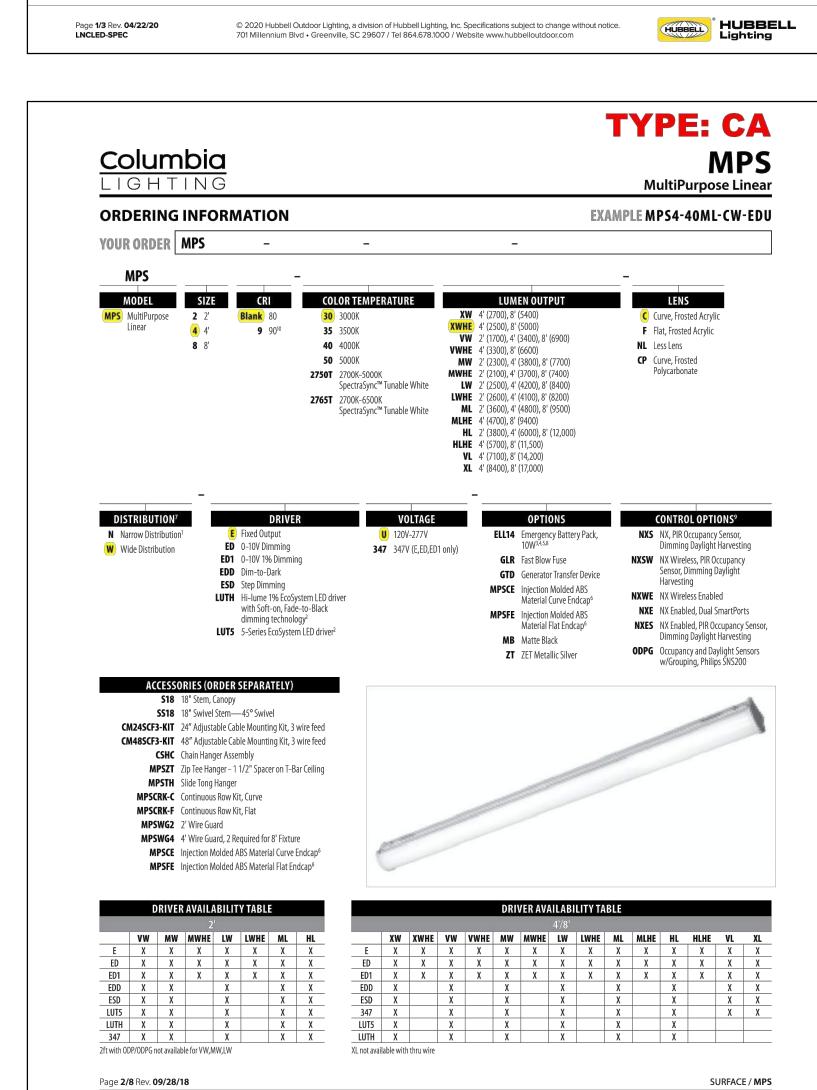

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Final Audit Report 2022-12-10

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By: Jay Rodenbeck (jrodenbeck@cabq.gov)

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Transaction ID: CBJCHBCAABAATicT2\_ZPanbcz3-owt6uBv3n5HMVyoca

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