

### DEVELOPMENT REVIEW BOARD SUPPLEMENTAL SUBMITTAL

### (Deadline is Friday at noon unless noted on DRB calendar – late submittals will not be accepted unless approved by the DRB)

| PROJECT NO. PR-2021-005442   |   |
|--|---|
| Application No. SI-2021-01714  |   |
| TO:  X Planning Department/Chair Hydrology X Transportation Development X ABCWUA X Code Enforcement X Parks & Rec *(Please attach this sheet with each collated set for each board member) |   |
| NOTE: ELECTRONIC VERSION (ie disk, thumbdrive) is Required. Submittal will not be accepted without.  |   |
| DRB SCHEDULED HEARING DATE: 10/20/2021 HEARING DATE OF DEFERRAL: 11/17/2021  |   |
| SUBMITTAL Revised drawings in response to agency comments.   |   |
|  |   |
|  |   |
|  |   |
|  | _ |
| CONTACT NAME: Anthony Santi  |   |
| TELEPHONE: 505-761-9700 EMAIL: anthonys@dpsdesign.org  |   |

#### RECORDING REQUESTED BY AND AFTER RECORDING RETURN TO:

Stoel Rives LLP 600 University St. Ste. 3600 Seattle, WA 98101 Attn: Sallie Lin

#### DECLARATION OF ACCESS EASEMENT

THIS DECLARATION OF ACCESS EASEMENT ("*Declaration*") is made as of \_\_\_\_\_\_\_, 2021 (the "*Effective Date*"), by Sedona West, LLC, a New Mexico limited liability company ("*Declarant*").

#### RECITALS

- A. Declarant is the owner of a parcel of real property in Bernalillo County, New Mexico, which real property is legally described on the attached <u>Exhibit A</u> (the "*Property*").
- B. Declarant intends to construct a multi-family residential project (the "*Project*") on the Property. For the purposes of this Declaration, the Project includes any revisions or modifications to the Project.
- C. Declarant intends to declare a vehicular access easement over and across a portion of the Property (the "Access Drive"), as more particularly described herein. After completion of construction of the Access Drive and the Project, the general public and emergency vehicles shall be permitted to use the Access Drive for the limited purposes described herein, subject to the terms and conditions herein.

#### **DECLARATION**

NOW, THEREFORE, Declarant covenants and agrees, on behalf of itself and its heirs, successors, and assigns, as follows:

1. <u>Grant of Easement</u>. Declarant hereby declares a non-exclusive ingress and egress access easement (the "*Easement*") over, upon, and across the Access Drive, as legally described in the attached as <u>Exhibit B</u> ("*Easement Area*"), subject to the terms, conditions, and limitations contained herein. The Easement may only be used by (a) emergency vehicles, (b) vehicles of the general public that are accessing the shopping center located on Coors Boulevard (the "*Easement Users*"). Pedestrians are not permitted to use the Access Drive. Use of the Easement is subject to the rights of any other users and permittees of the Easement Area, including but not limited to the residents and occupants of the Project.

- 2. Limitations on Use of the Easement Area. The Easement is limited as follows:
- (a) The speed limit for all vehicles is 15 miles per hour. Declarant may post signs indicating the speed limit.
- (b) In order to discourage non-permitted cut-through traffic, Declarant may post signs indicating that cut-through traffic is not permitted.
- (c) Traffic calming measures, including but not limited to speed humps, speed table, and textured paving, may be installed by Declarant at any time.
- (d) Commercial trucks are prohibited. Declarant may post signs indicating no commercial vehicles are permitted.
- (e) Hours of use of the Easement Area may be limited to normal business hours only. Declarant may post signs indicating permitted hours of use (e.g. 7 AM to 10 PM).
  - (f) No vehicular parking is permitted.

Declarant reserves the right to impose additional limitations on the use of the Easement Area, as may be needed to avoid adverse impacts to the condition of the Access Drive or the safety and/or security of residents and occupants of the Project.

- 3. <u>Covenants Running with Land.</u> The Easement and the restrictions hereby imposed shall be deemed easements, restrictions and covenants running with the land and shall inure to the benefit of and be binding upon, Declarant and its successors and assigns; provided, however, and notwithstanding the foregoing, the Easement and rights granted hereunder may be terminated by Declarant and its successors and assigns, pursuant to any misuse, expansion of use, adverse use, or overburdening of, the Easement Area, as determined in the sole discretion of Declarant, and its successors and assigns, including, without limitation, pursuant to limitations of the Easement described in Section 2 above.
- 4. <u>Assumption of Risk; No Warranty</u>. Declarant is providing the Easement Area AS-IS, WHERE-IS and WITHOUT WARRANTY. The use of the Easement shall be limited to the uses set forth in this Declaration, and the Easement User's rights under this Declaration shall not be exercised in any manner which (exigent circumstances, to the extent necessary, excepted), unreasonably interferes with (i) any other purposes for which the Property is being, or will be, used, or (ii) with any and all existing rights and easements relating to Declarant or the Property or any part thereof. Any use of the Easement Area is at the Easement Users sole risk.
- 5. <u>Term.</u> This Declaration shall commence on the date of its recording.
- 6. <u>Access During Construction</u>. The Project and the Access Drive have not yet been constructed on the Property. During construction of the Project and the Access Drive, any rights to use the Easement Area shall be subject to the requirements of the construction of the Project and the Access Drive. After the completion of the construction of the Project and the Access Drive, Declarant may record an update to this Declaration to provide the as-built location of the Access Drive to the extent reconstructed or modified in the Easement Area.

- 7. <u>Governing Law</u>. This Declaration shall be governed by and construed in accordance with the internal laws of the State of New Mexico.
- 8. <u>Not a Public Dedication.</u> Nothing herein contained shall be deemed to be a gift or dedication of any portion of the Property, the Easement Area, or the Access Drive to the general public or for any public purposes whatsoever, it being the intention of the Declarant that this Declaration shall be strictly limited to and for the purposes herein expressed. The right of the public or any person to make any use whatsoever of the Easements, or any portion thereof (other than any use expressly allowed by a written or recorded map, agreement, deed or dedication) is by permission, and subject to the control of the owner of the affected Property in accordance in this Declaration. This Declaration does not create any rights in any third party.

[No further text.]

| written.   |                                   |
|--|-----------------------------------|
| DECLARANT:   |                                   |
| Sedona West, LLC, a New Mexico limited liability company |                                   |
| By:<br>Name:<br>Title:                                   |                                   |
| STATE OF NEW MEXICO                                      |                                   |
| COUNTY OF BERNILILLO                                     |                                   |
| This record was acknowledged befo                        | , 2021, by of Sedona West, LLC, a |
| New Mexico limited liability company.                    |                                   |
|  | he State of New Mexico apires:    |
|  |                                   |

IN WITNESS WHEREOF, this Declaration is executed on the day and year first above

#### **EXHIBIT A**

#### Legal Description of the Property

The land referred to herein below is situated in the County of Bernalillo, State of NM, and is described as follows:

Tract A-2-A-A, of The Plaza at Paseo Del Norte, City of Albuquerque, Town of Alameda Grant, Bernalillo County, New Mexico, as shown on the Plat of Tracts A-2-A-A & B-1-A The Plaza at Paseo Del Norte, filed in the Office of the County Clerk of Bernalillo County, New Mexico, on December 18, 2007, in Plat Book 2007C, Page 347, as Document No. 2007169358.

#### EXHIBIT B

#### Legal Description of Easement Area

[to be attached]





#### SHEET KEYED NOTES

- TRASH COMPACTOR ENCLOSURE WITH GATE, REF:
- ACCESSIBLE PARKING WITH ACCESSIBLE SIGNAGE AND
- BIKE PARKING PER IDO SECTION 5-5(E) AND DPM STANDARDS, 10% OF REQUIRED OFF-STREET PARKING AND DPM STANDARD WITH TWO-POINT BIKE LOCKING, REF:
- 6' WIDE CONCRETE SIDEWALK PER COA IDO STANDARDS,
- NEW CONCRETE CURB AND GUTTER, REF: A2/SDP1.2
- PARKING STRIPING 4" WIDE, COLOR WHITE
- 11. 6' WIDE ACCESSIBLE PATHWAY FROM PUBLIC R.O.W. 5% MAX
- 12. OUTDOOR GRILLING AREA.
- 14. CMU RETAINING WALL, SEE CIVIL AND B2/SDP1.2 15. LANDSCAPE AND SIGNAGE WILL NOT INTERFERE WITH CLEAR SIGHT REQUIREMENTS. THEREFORE SIGNS, WALLS
- PERMITTED IN THE CLEAR SIGHT TRIANGLE. . NEW TRANSIT SHELTER TO BE CONSTRUCTED PER CITY
- STANDARD DETAIL 2535.
- . PROVIDE ADA ACCESSIBLE CONNECTION FROM THE PRIVATE DRIVE TO THE EXISTING ASPHALT TRAIL.
- 8. RESURFACE EXISTING TRAIL ADJACENT TO THIS PROPERTY AND AS INDICATED BY THE SOLID GRAY HATCH. REF: C4/
- 19. RECYCLE ENCLOSURE, REF: D5/SDP1.2
- 20. ACCESSIBLE RAMP, REF: D5/SDP1.3
- 21. ELECTRICAL VEHICLE CHARGING STATION. 22. FOR PATIO WALLS AT GRADE, REF: A4/SDP1.2
- 23. DOG PARK. ABCWUA IS NOT RESPONSIBLE FOR REPLACING OR REPAIRING DAMAGED TURF OR OTHER SITE FEATURES IF MAINTENANCE IS REQUIRED IN THE EASEMENT.
- 24. PAINTED CROSSWALK, REF: D3/SDP1-3

#### **EASEMENT NOTES**

- 10' ABCWUA EASEMENT (06-28-1990, 90C-151)
- 20' ABCWUA EASEMENT (06-28-1990, 90C-151) 3. 30' ABCWUA EASEMENT (06-28-1990, 90C-151)
- 10' PUE (07-25-1988, C37-012)
- 10' PUE (06-28-1990, 90C-151)
- 100' PNM POWERLINE EASEMENT (05-06-1957, D385-303) EASEMENT ENCROACHMENT AGREEMENT (01-23-1990, 1990005847)
- EASEMENT ENCROACHMENT AGREEMENT (02-10-2005, 2005020108)
- 12' BIKE PATH EASEMENT (02-27-1997, 97C-065) 8. 15' PUE (02-10-1992, 1992011652)
- 9. 10' PUE (06-28-1990, 90C-151)
- 10. 10' NMGCO EASEMENT (03-21-1991, 1991019534)
- 11. 30' PRIVATE ACCESS EASEMENT (06-03-1999, 99C-133) 12. PUBLIC SIDEWALK EASEMENT (12-18-2007, 2007C-347)
- 13. 20' ABCWUA PUBLIC WATERLINE EASEMENT (GRANTED TO ABCWUA BY THIS PLAT)
- 14. 35' X 35' ABCWUA PUBLIC WATERLINE EASEMENT (GRANTED TO ABCWUA BY THIS 15. ABCWUA PUBLIC WATERLINE AND SANITARY SEWER EASEMENT (GRANTED TO
- ABCWUA BY THIS PLAT)

#### **GENERAL SHEET NOTES**

- A. DIMENSIONS ARE TO FACE OF CURB, OR WALL, OR EDGE OF PAVEMENT UNLESS OTHERWISE NOTED.
- B. SITE PLAN SHALL COMPLY WITH LOCAL, FEDERAL AND ACCESSIBILITY STANDARDS & GUIDELINES, INCLUDING THE INTERNATIONAL FIRE CODE (IFC) 2015. C. ALL CURBS AND ACCESSIBLE RAMPS WILL BE DESIGNED AND BUILT ACCORDING
- TO THE CITY OF ALBUQUERQUE STANDARDS. ALL LIGHT FIXTURES AND LIGHTING DESIGN SHALL COMPLY WITH THE CITY OF ALBUQUERQUE INTEGRATED DEVELOPMENT ORDINANCE (IDO): SECTION 14-16-5-8
  - OUTDOOR LIGHTING.
- STREETS, PARKING SPACES AND ASSOCIATED DRIVES TO BE ASPHALT UNLESS NOTED OTHERWISE
- LANDSCAPE AND SIGNAGE WILL NOT INTERFERE WITH CLEAR SIGHT REQUIREMENTS. THEREFORE SIGNS, WALLS AND PLANTING BETWEEN 3 FEET AND 8 FEET TALL (AS MEASURED FROM THE GUTTER PAN) WILL NOT BE PERMITTED IN THE CLEAR SIGHT TRIANGLE.
- AN ACCESSIBLE ROUTE, IN COMPLIANCE WITH ACCESSIBILITY STANDARDS OF THE PROJECT, CONNECTS FROM THE BUILDING TO ACCESSIBLE PARKING SPACES AND TO ALL SITE AMENITIES AS REQUIRED.
- APPLICATION TO EPC WAS SUBMITTED ON MAY 6, 2021. THE 2019 INTEGRATED DEVELOPMENT ORDINANCE GOVERNS.

#### PROJECT DATA

IDO - MIXED-USE - MEDIUM INTENSITY ZONE DISTRICT (MX-M)

**LEGAL DESCRIPTION:** TR A-2-A-A PLAT OF TRACTS A-2-A-A & B-1-A THE PLAZA AT PASEO DEL NORTE CONT 7.0867 AC

**SITE AREA:** 7.08 ACRES **ZONE ATLAS:** C-13-Z

**SETBACKS:** FRONT= 5' MIN, INTERIOR= 0', REAR= 15'

**BUILDING HEIGHT:** MAXIMUM ALLOWED: 48'-0" ACTUAL HEIGHT: 48'-0"

SPRINKLED: YES, NFPA 13R **BUILDING OCCUPANCY: R-2 CONSTRUCTION TYPE:** TYPE VA

**PARKING CALCULATIONS:** (TABLE 5-5-1) 1.5 SPACES / DWELLING UNITS: 218 X 1.5 = 327 SPACES MINUS PARKING CREDIT OF 5% FOR TRANSIT RIDER SHELTER = 327\*.05 = 17, 327-17 = 310 SPACES

REQUIRED) ELECTRIC VEHICLE CHARGING STATIONS REQUIRED: 6 SPACES CHARGING STATION CREDIT = 6X2 = 12 SPACES

REQUIRED SPACES = 298 SPACES PROVIDED PARKING = 303 TOTAL SPACES (34 GARAGE, 98 COVERED)

ADA PARKING REQUIRED: 1 SPACE PER UNIT REQUIRED TO BE ADA 218 UNITS X .02 = 4.36 = 5 SPACES REQUIRED ADA PARKING PROVIDED = 6 SPACES

BICYCLE PARKING REQUIRED = 30 SPACES (10% OF OFF STREET PARKING = 304 X 0.10 = 30 SPACES) BICYCLE PARKING PROVIDED = 30 SPACES


#### OPEN SPACE CALCULATIONS

TABLE 2-4-5 / MX-M ZONING USABLE OPEN SPACE

1 BD: 225 SF PER UNIT 225 SF x 119 UNITS = 26,775 SF 2 BD: 285 SF PER UNIT 285 SF x 72 UNITS = 20,520 SF

3 BD: 350 SF PER UNIT 350 SF x 27 UNITS = 9,450 SF

56,745 SF REQUIRED OPEN SPACE PROVIDED OPEN SPACE: 80,740 SF

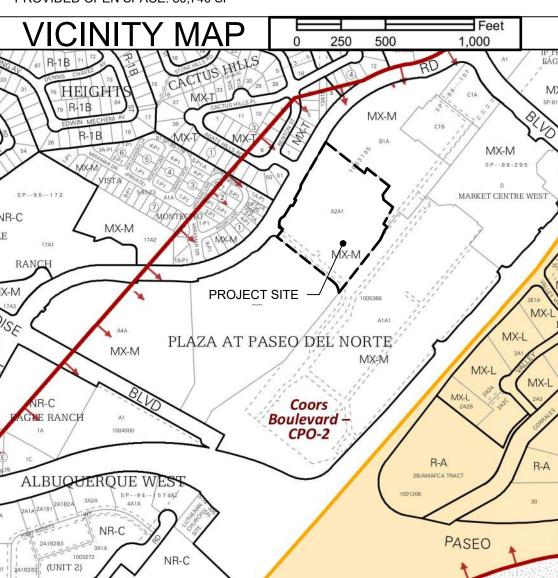

## LEGEND

LANDSCAPE AREA

Date

Date

Date

Date

Date

Date

Date

Date

PROPERTY LINE → FIRE HYDRANT

> BIKE RACK SIDEWALK RAMP (ARROW POINTS DOWN)

TRANSFORMER WITH SAFETY BOLLARDS & 6" THICK CONCRETE PAD PER PNM STANDARDS

PERIMETER FENCE ACCESSIBLE PARKING WITH ACCESSIBLE SIGNAGE AND STRIPING, REF: A3/SDP1.2, A4/SDP1.2 & B4/SDP1.2.

COMPACT PARKING; REF: D5/SDP1.3

← 6" BOLLARD WITH SIGN

# PERICH SABATINI

ARCHITECTURE DESIGN **INSPIRATION** 

ARCHITECT



**ENGINEER** 

PROJECT

10.12.2021 MAJOR AMENDMENT


DRAWN BY AG, JF REVIEWED BY RAW, HFG 10/29/2021

PROJECT NO. DRAWING NAME

SITE PLAN

**SDP1.1** 

20-0286

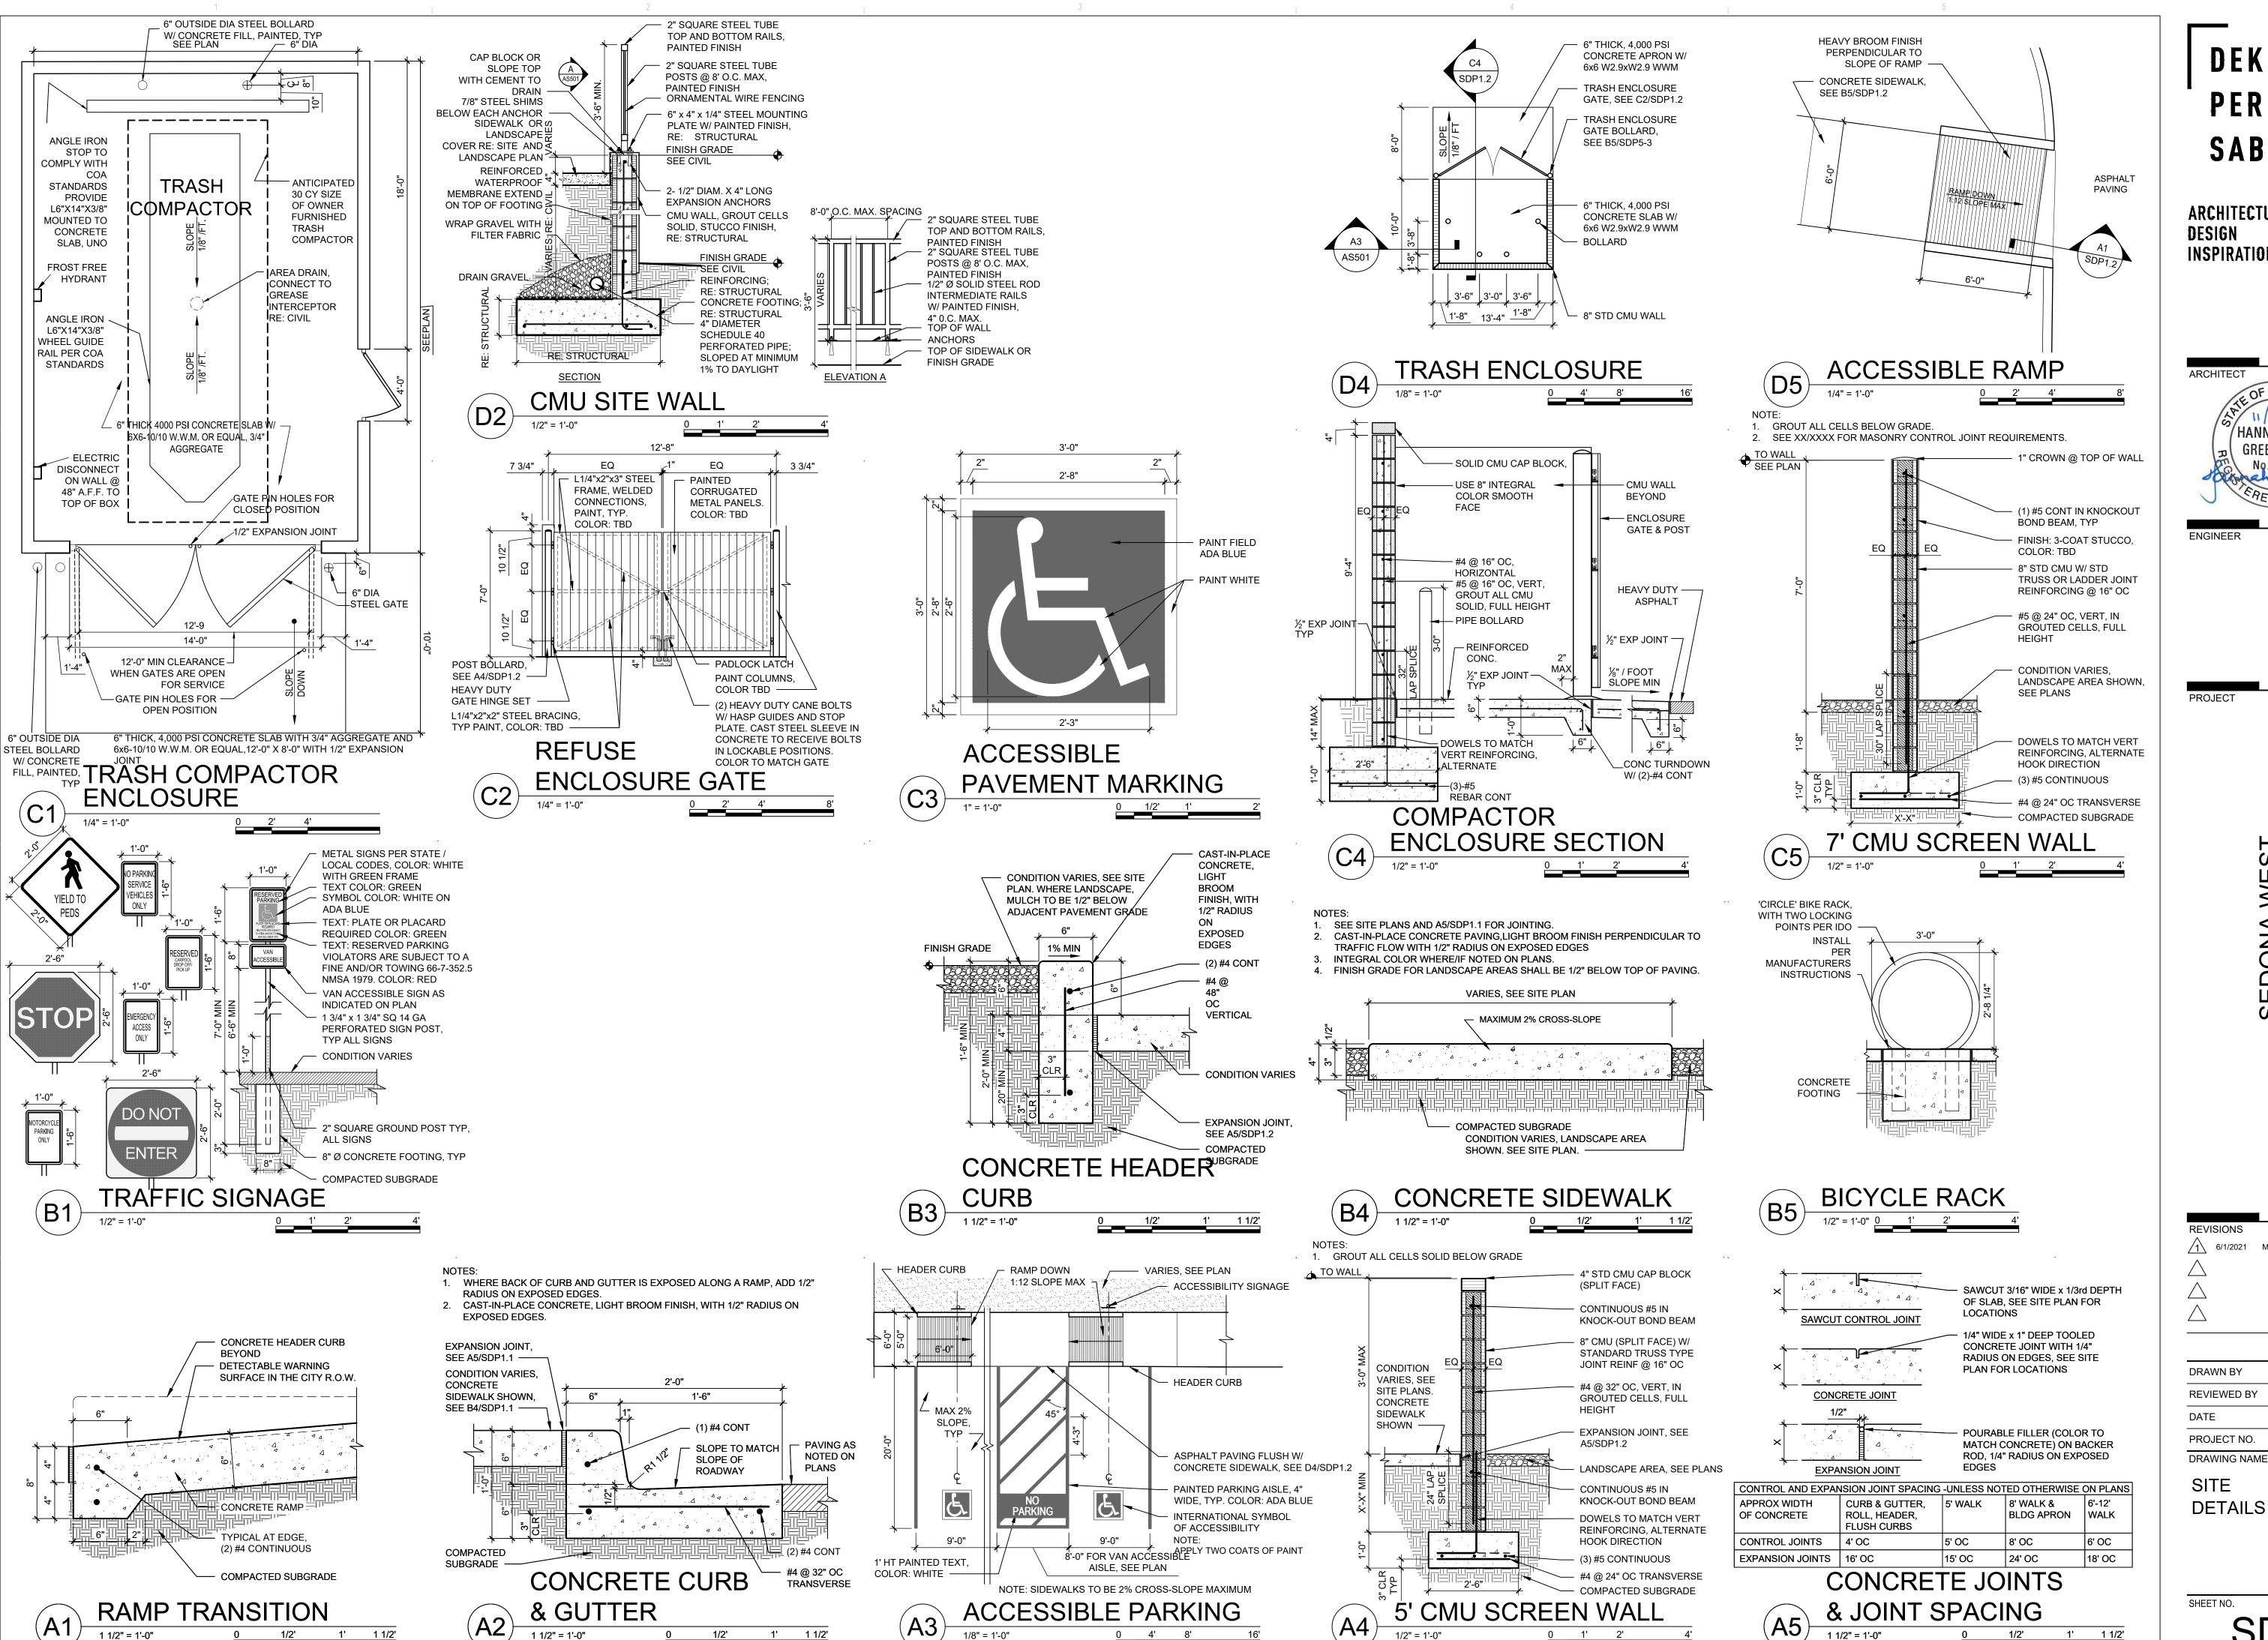

DEKKER PERICH SABATINI

ARCHITECTURE DESIGN **INSPIRATION** 

ARCHITECT HANNAH FEI GREENHOOD

**ENGINEER** 

PROJECT


SEDONA V EAGLE RANCH ALBUQUERQUE,

REVISIONS 6/1/2021 MAJOR AMENDMENT

DRAWN BY D/P/S D/P/S REVIEWED BY 10/29/2021 PROJECT NO. 20-0286

SITE **DETAILS** 

SHEET NO.

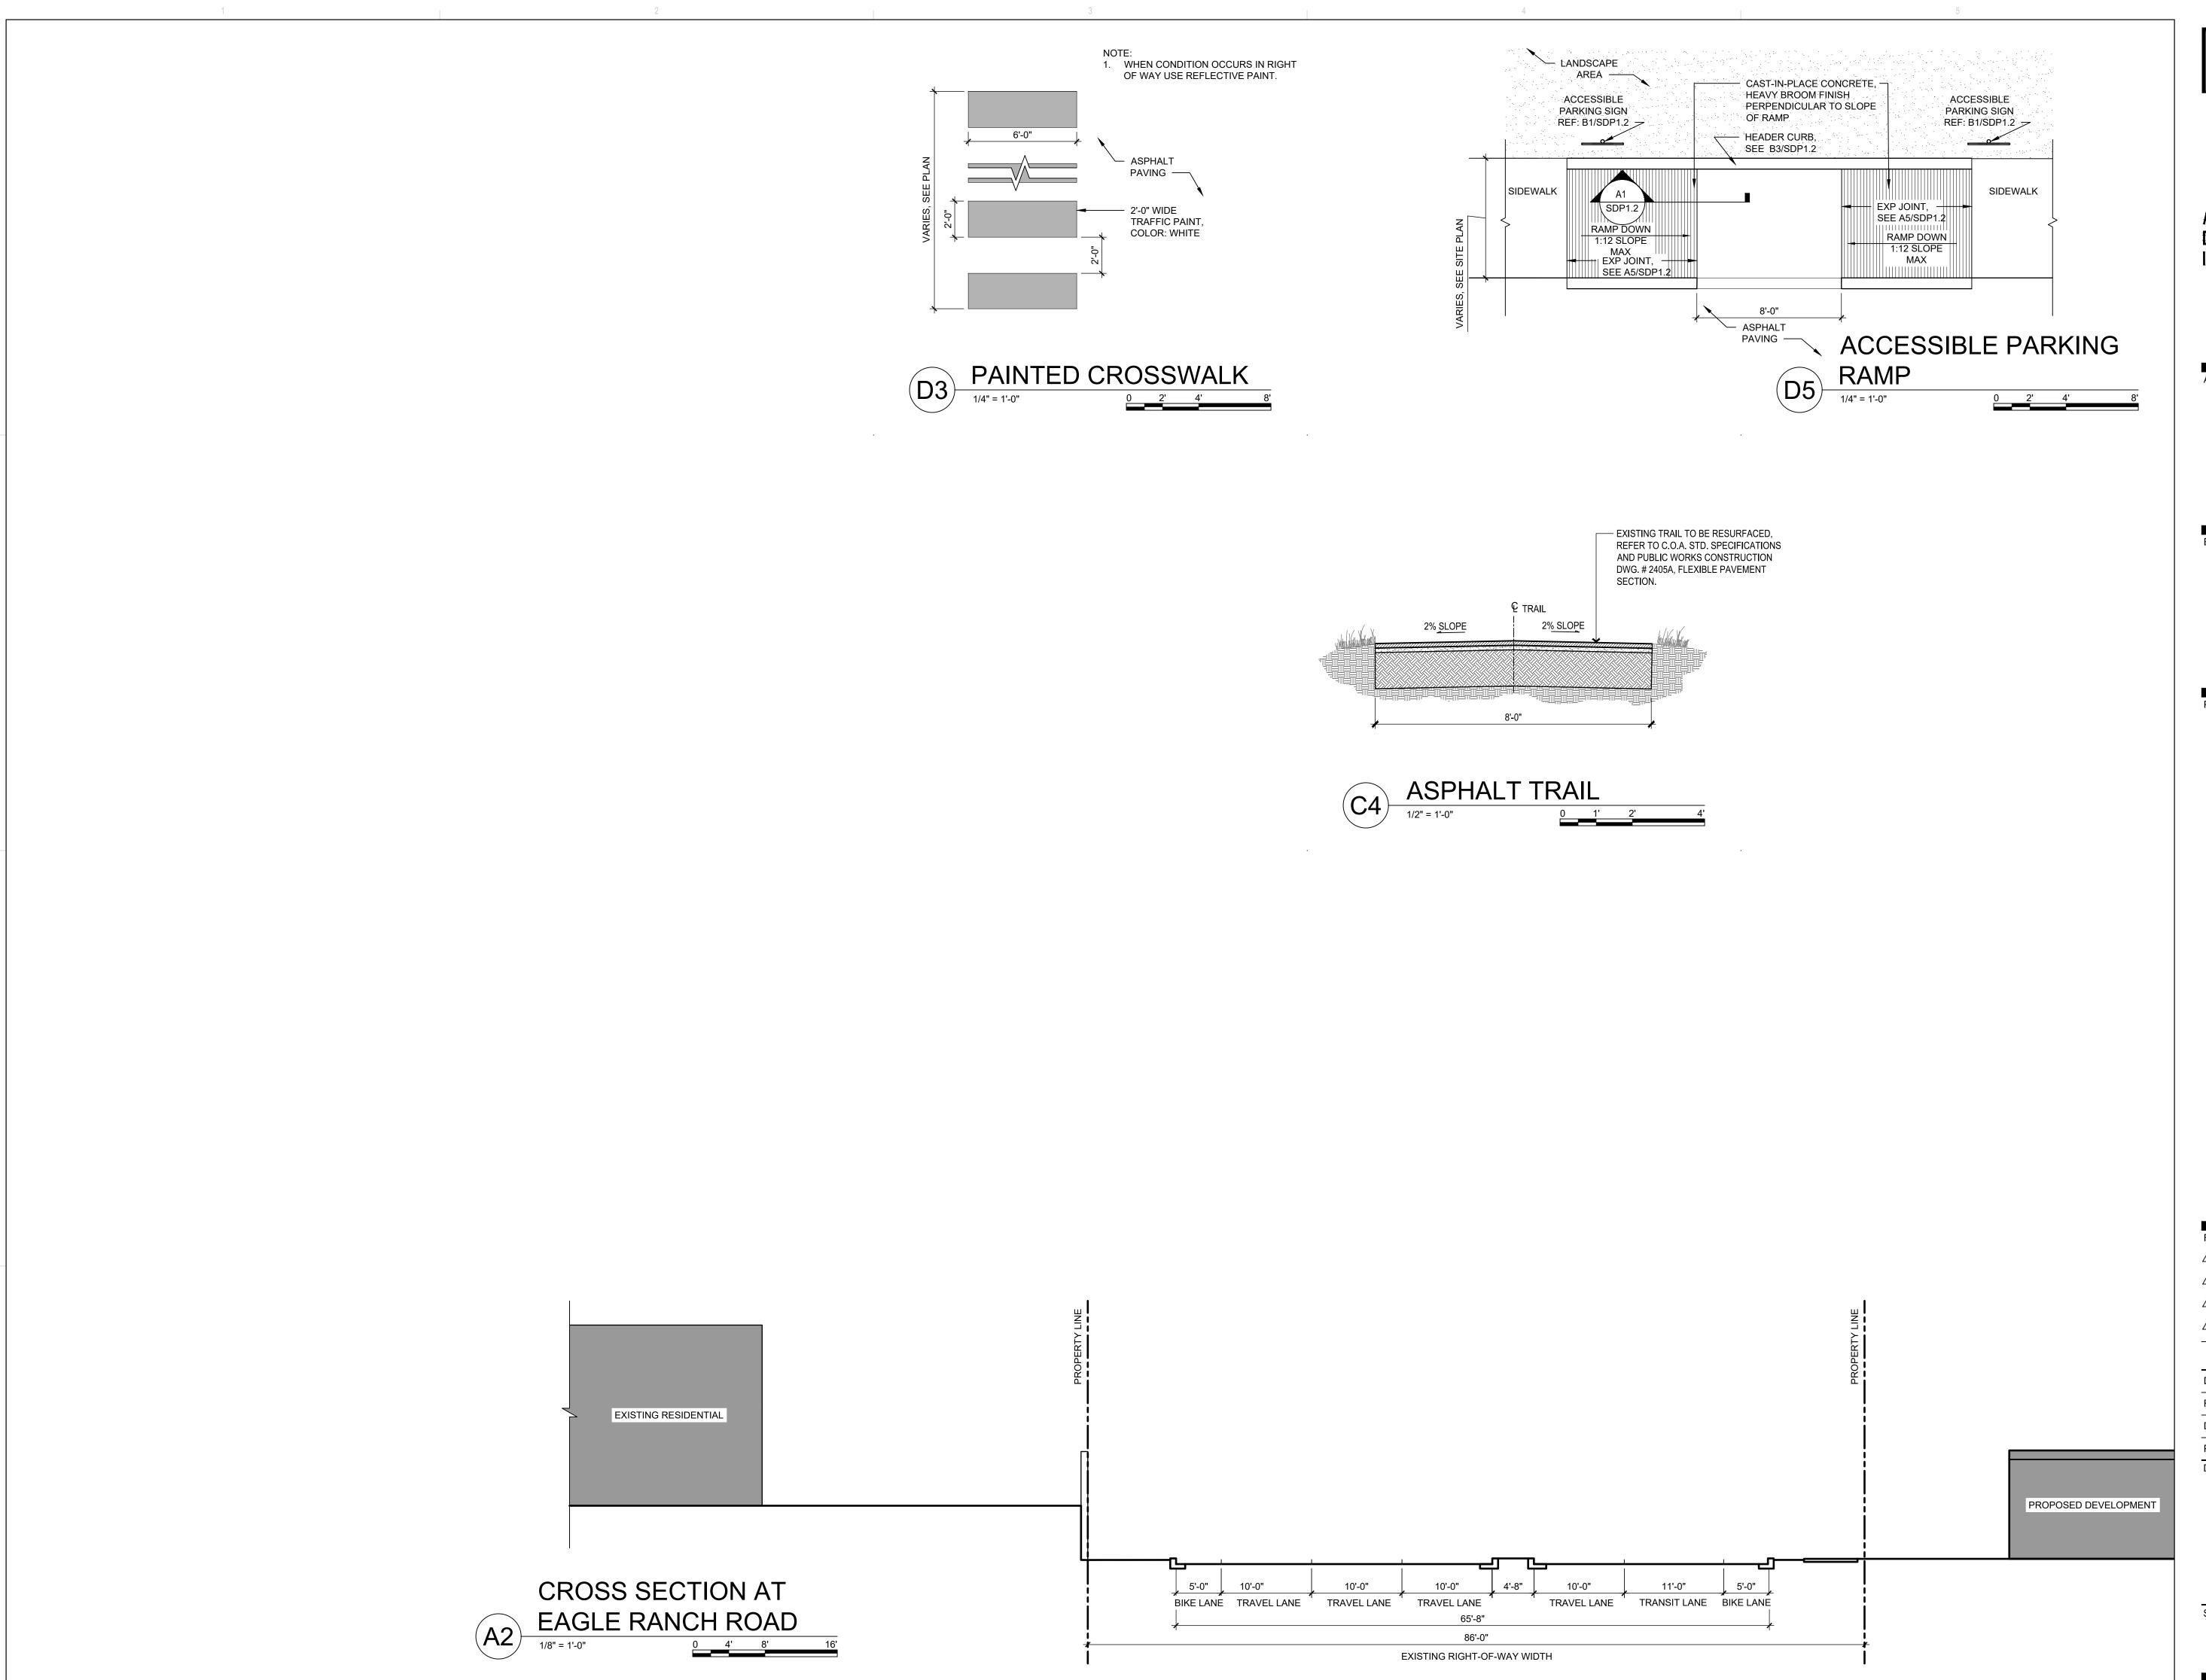

# DEKKER PERICH SABATINI

ARCHITECTURE DESIGN INSPIRATION

ARCHITECT

OF NEW MET

HANNAH FEIL

GREENHOOD

No. 5594

ENGINEER

PROJECT

SEDONA WEST EAGLE RANCH ROAD ALBUQUERQUE, NM 87114

REVISIONS

1 6/1/2021 MAJOR AMENDMENT

...

| PRAWN BY    | D/P/S      |
|-------------|------------|
| REVIEWED BY | D/P/S      |
| DATE        | 10/29/2021 |
| PROJECT NO. | 20-0286    |
| RAWING NAME | _          |
| SITE        |            |

SITE DETAILS

SHEET NO. SDP1.3

#### PROJECT BENCHMARK

AN 3 1/4" AGRS ALUMINUM DISK STAMPED "11\_C13", SET FLUSH IN THE NORTHEAST CONCRETE BRIDGE ABUTMENT OF PASEO DEL NORTE OVER COORS BOULEVARD NW. ELEVATION = 5031.88 FEET (NAVD 1988)

#### TEMPORARY BENCHMARK #201 (T.B.M.)

A 60d NAIL, SET IN CONCRETE JOINT NEAR THE NORTHWEST CORNER OF THE PROJECT SITE APPROXIMATELY 22.8' SOUTHWEST OF THE NORTHWEST PROPERTY CORNER, AS SHOWN ON THIS SHEET. ELEVATION = 5072.42 FEET (NAVD 1988)

#### TEMPORARY BENCHMARK #202 (T.B.M.)

A 60d NAIL, SET IN CONCRETE JOINT NEAR THE SOUTHWEST CORNER OF THE PROJECT SITE APPROXIMATELY 21.3' NORTHEAST OF THE TOP OF A WHEEL CHAIR RAMP, AS SHOWN ON THIS SHEET.

ELEVATION = 5076.20 FEET (NAVD 1988)

#### TEMPORARY BENCHMARK #203 (T.B.M.)

A MAG NAIL W/WASHER. SET IN ASPHALT PAVEMENT NEAR THE CENTER OF THE PROJECT SITE APPROXIMATELY 1.1' EAST OF THE EAST ASPHALT CURB, AS SHOWN ON THIS

ELEVATION = 5056.78 FEET (NAVD 1988)

#### TEMPORARY BENCHMARK #204 (T.B.M.)

A MAG NAIL W/WASHER, SET IN ASPHALT PAVEMENT NEAR THE NORTHEAST CORNER OF THE PROJECT SITE APPROXIMATELY 26.6' SOUTH OF THE SOUTHEAST CORNER OF A CONCRETE PAD, AS SHOWN ON THIS SHEET.

#### TEMPORARY BENCHMARK #205 (T.B.M.)

A MAG NAIL W/WASHER, SET IN ASPHALT PAVEMENT NEAR THE SOUTHEAST CORNER OF THE PROJECT SITE APPROXIMATELY 1.4' SOUTHWEST OF THE END OF A CONCRETE CURB LIP, AS SHOWN ON THIS SHEET. ELEVATION = 5049.36 FEET (NAVD 1988)

#### **GRADING AND DRAINAGE:**

THE PROJECT SITE CURRENTLY SLOPES FROM NORTHEAST TO SOUTHWEST. THE STORMWATER RUNOFF FROM THE WEST HALF OF THE SITE IS INTERCEPTED BY AN EXISTING PAVED, CURBED ACCESS ROAD THAT DRAINS TO TWO (2) EXISTING STORM DRAIN INLETS. THESE INLETS DISCHARGE TO AN EXISTING 24" PUBLIC SUBSURFACE STORM DRAIN SYSTEM THAT EXTENDS THROUGH THE SITE FROM NORTH TO SOUTH, ENLARGING TO A 36" RCP STORM DRAIN ALONG THE SOUTH PERIMETER OF THE PROPERTY. THIS PUBLIC STORM DRAIN SYSTEM CONTINUES SOUTHWEST PROJECT SITE AND ULTIMATELY DISCHARGES TO A PUBLIC STORMWATER DETENTION BASIN AT THE "PLAZA AT PASEO DEL NORTE UPPER DETENTION POND", LOCATED NEAR THE SOUTHEAST TERMINATION OF PARADISE BLVD NW, AND IMMEDIATELY SOUTH OF THE EAGLE RANCH APARTMENTS COMPLEX. THE EXISTING PUBLIC STORM DRAIN SYSTEM AND STORMWATER DETENTION POND FACILITY WAS DEVELOPED PER THE 1989 MARKET CENTER WEST (PLAZA AT PASEO DEL NORTE) MASTER PLAN (UPDATED 2007) AND CONSTRUCTED AS PART OF THE PHASE 1 DEVELOPMENT FOR THIS SITE IN 1990. THE STORMWATER DETENTION POND IS SIŽED TO ACCEPT THE FULLY DEVELOPED STORMWATER RUNOFF GENERATED BY THIS SITE (DENOTED AS PORTIONS OF BASIN A IN THE MASTER PLAN DRAINAGE REPORT). IN THE MASTER PLAN, BASINS A-1, A-2 AND A-3 WERE CALCULATED TO GENERATE 24.6 CFS, 16.6 CFS, AND 4.5 CFS RESPECTIVELY (QTOTAL = 45.7 CFS) IN THE FULLY DEVELOPED CONDITION THAT IS FREE DISCHARGED TO THE EXISTING PUBLIC STORM DRAIN IMPROVEMENTS. THIS PROPOSED 2021 SEDONA WEST DEVELOPMENT SITE IS 7.1 AC. 65% OF THE BASIN A 11 AC SITE. THEREFORE, THE ALLOWABLE DISCHARGE FOR THIS SITE IS 65% OF THE 45.7 CFS ALLOWABLE FREE DISCHARGE RATE, EQUAL TO 29.7 CFS.

EASEMENTS

PAGE 12.

PAGE 151.

PAGE 151.

905847.

DOC. # 8849100.

PAGE 7909, DOC. #91019534.

DETERMINED BASED UPON EASEMENT ANNOTATION.

BY PLATS OF RECORD REFERENCED HEREON.

(1) 10' PNM AND US WEST EASEMENT GRANTED BY PLAT FILED JULY 25, 1988, BOOK C37,

2. 10' PNM AND US WEST EASEMENT GRANTED BY PLAT FILED JUNE 28, 1990, BOOK 90C,

3. 10' EASEMENT GRANTED TO N.M. UTILITIES BY PLAT FILED JUNE 28, 1990, BOOK 90C,

4. 20' EASEMENT GRANTED TO N.M. UTILITIES BY PLAT FILED JUNE 28, 1990, BOOK 90C,

5. 30' EASEMENT GRANTED TO N.M. UTILITIES BY PLAT FILED JUNE 28, 1990, BOOK 90C,

6. APPROXIMATE LOCATION OF 100' PNM POWER LINE EASEMENT FILED MAY 06, 1957, BOOK

N.M. UTILITY CO., FILED JANUARY 23, 1990, BOOK 90-2, PAGES 1325-1327, DOC. #

7. 15' UTILITY EASEMENT GRANTED HORIZION-ALBUQUERQUE PROPERTIES AND PNM DATED

8. 8' BIKE LANE AND ASSOCIATED 12' EASEMENT, REFERENCED BY PREVIOUS PLATTING

PNM, FILED FEBRUARY 10, 2005, BOOK A-92, PAGE 31, DOC. #2005020108.

9. 10' GAS COMPANY OF NEW MEXICO EASEMENT, FILED MARCH 21, 1991, BOOK A91-4,

(11) POSSIBLE LOCATION OF 50' ROADWAY EASEMENT RESERVED BY WARRANTY DEED FILED

10. APPROXIMATE LOCATION PUBLIC SIDEWALK EASEMENT GRANTED BY PLAT FILED DECEMBER

18, 2007, BOOK 2007C, PAGE 347, DOC. #2007169358. EXACT LOCATION CANNOT BE

NOVEMBER 19, 1959, BOOK D-513, PAGE 189. EASEMENT NOT DEPICTED OR REFERENCED

D385. PAGE 3031. SUBJECT TO EASEMENT ENCROACHMENT AGREEMENT BETWEEN PNM AND

MARCH 27, 1961, RECORDED FEBRUARY 10, 1992, BOOK 92-3, PAGE 4164, N.M. UTILITIES

ACTIONS, AND SITE DEVELOPMENT PLAN DATED 06-19-2007, FILE NO. 2-83-93-1, ALSO

REFERENCED BY ENCROACHMENT AGREEMENT BETWEEN THE CITY OF ALBUQUERQUE AND

DISCLAIMS ALL INTEREST TO ABOVE REFERENCED EASEMENT RECORDED JUNE 01, 1988,

THE PROPOSED SITE DEVELOPMENT WILL MAINTAIN THE GENERAL DRAINAGE PATTERNS FOR THE SITE WITH OVERALL SITE GRADE SLOPING FROM NORTHEAST TO SOUTH WEST. ROOF DRAINAGE AND LOCALIZED PAVEMENT AREAS WILL BE SERVED BY NEW PRIVATE SUBSURFACE PIPED STORM DRAIN SYSTEMS THAT WILL OUTFALL TO THE EXISTING PUBLIC STORM DRAIN SYSTEM. THE PROJECT WILL RESULT IN AN INCREASE IN DEVELOPED STORMWATER RUNOFF GENERATED DUE TO THE NEW IMPERVIOUS AREAS. CALCULATIONS BASED ON THE CURRENT DPM PROCEDURE FOR A 40 ACRE OR SMALLER SITE SHOWN BELOW DEMONSTRATE THAT THE PROPOSED PEAK DISCHARGE FOR A 100 YEAR, 6 HOUR STORM EVENT GENERATED BY THE FULLY DEVELOPED SITE WILL BE 26.9 CFS. WHICH IS LESS THAN THE ALLOWABLE MASTER PLAN FREE DISCHARGE RATE OF 29.7 CFS NOTED ABOVE.

DUE TO THE GENERAL SLOPE OF THE SITE FROM WEST TO EAST, AND COORDINATION COMPROMISES TO THE SITE DEVELOPMENT WITH THE NEIGHBORING PROPERTY OWNERS. THIS SITE AS FULLY DEVELOPED WILL NOT BE ABLE TO INCLUDE PONDING IMPROVEMENTS NECESSARY TO COMPLY WITH THE CITY OF ALBUQUERQUE DPM AND CURRENT STORMWATER QUALITY ORDNANCE REQUIREMENTS TO CAPTURE AND TREAT THE FIRST FLUSH STORM EVENT GENERATED BY THE SITE. CALCULATIONS INCLUDED BELOW DEMONSTRATE THE REQUIRED STORMWATER QUALITY VOLUME GENERATED BY THE DEVELOPED SITE TO BE 8,510 CF. AS SUCH, THIS PROJECT ANTICIPATES UTILIZING THE ALTERNATIVE 'PAYMENT-IN-LIEU' OPTION NOTED IN THE COA DPM SECTION 6-12(C)(1), TO BE COORDINATED WITH THE CITY HYDROLOGY ENGINEER.

#### **CALCULATIONS:**

I. SITE CHARACTERISTICS

| Α.    | PRECIPITATION ZONE -                   | <u>1</u>       |   |                |              |
|-------|--|----------------|---|----------------|--------------|
| В.    | $P_{100.6HR} = P_{360} =$              | 2.17 IN        |   |                |              |
| C.    | TOTAL PROJECT AREA (A <sub>T</sub> ) = | 310,241 SF     |   |                |              |
|       | TO THE PROBLET AREA (AT) -             | 7.12 AC        |   |                |              |
| D. LA | ND TREATMENTS                          |                |   |                |              |
| 1.    | EXISTING                               | LAND TREATMENT |   | DEVELOPED      | LAND TREATME |
|       | PROJECT SITE                           | 310,241 SF     |   | PROJECT SITE   | 310,241      |
|       | PROJECT SITE                           | 7.12 AC        |   | PROJECT SITE   | 7.12         |
|       | LAND TREATMENT                         | AREA (SF/AC)   | % | LAND TREATMENT | AREA (SF//   |
|       | Δ                                      |                |   | Δ              |              |
|       |  |                |   |                |              |

263,079 SF 85% 6.04 AC 0.77 AC 33,620 SF 0.77 AC 47,162 SF 243,000 SF 5.58 AC 1.08 AC

#### **HYDROLOGY**

#### A. EXISTING CONDITION 100 YEAR STORM

1. PROJECT SITE a. VOLUME 100-YR, 6-HR

 $WT_F = (E_A \cdot A_A + E_B \cdot A_B + E_C \cdot A_C + E_D \cdot A_D)/A_T$  $\Rightarrow$  (0.55 · 0.00) + (0.73 · 6.04) + (0.95 · 0.00) + (2.24 · 1.08)/7.12 =  $\Rightarrow$  (0.96/12) • 7.12 = **0.5698 AC-FT =** 24,820 CF  $V_{100.6 \text{ HR}} = (E_W/12) \cdot A_T$ b. PEAK DISCHARGE 100-YR

 $Q_{100} = Q_A \cdot A_A + Q_B \cdot A_B + Q_C \cdot A_C + Q_D \cdot A_D$  $\Rightarrow$  (1.54 • 0.00) + (2.16 • 6.04) + (2.87 • 0.00) + (4.12 • 1.08) =

#### B. <u>DEVELOPED CONDITION 100 YEAR STORM</u>

1. PROJECT SITE a. VOLUME 100-YR, 6-HR

> $WT_E = (E_A \cdot A_A + E_B \cdot A_B + E_C \cdot A_C + E_D \cdot A_D)/A_T$  $\Rightarrow$  (0.55 • 0.00) + (0.73 • 0.77) + (0.95 • 0.77) + (2.24 • 5.58)/7.12 =  $\Rightarrow$  (1.94/12) • 7.12 = 1.1514 AC-FT = 50,160 CF  $V_{100.6 \text{ HR}} = (E_W/12) \cdot A_T$

b. STORM WATER QUALITY VOLUME (FIRST FLUSH) GENERATED  $V_{SWQV} = ((P_{SWQV})/12) \cdot A_D$  $\Rightarrow$  ((0.42)/12) • (5.58) = 0.1952 AC-FT =

c. STORM WATER QUALITY - PAYMENT IN LIEU VARIANCE REQUEST ⇒ \$8.00 PER CF FIRST FLUSH GENERATE x 8510 CF =

 $Q_{100} = Q_A \cdot A_A + Q_B \cdot A_B + Q_C \cdot A_C + Q_D \cdot A_D$  $\Rightarrow$  (1.54 • 0.00) + (2.16 • 0.77) + (2.87 • 0.77) + (4.12 • 5.58) =

d. PEAK DISCHARGE 100-YR

C. COMPARISON 100 YEAR STORM 1. PROJECT SITE

> a. VOLUME 100-YR, 6-HR b. PEAK DISCHARGE 100-YR  $\Delta Q_{100} = 26.9 - 17.5 =$

(INCREASE)

\*29.7 CFS FREE DISCHARGE ALLOWED PER PLAZA AT PASEO DEL NORTE MASTER PLAN > DEVELOPED 26.9 CFS GENERATE

THIS IS NOT A BOUNDARY SURVEY OR A RIGHT-OF-WAY SURVEY, APPARENT PROPERTY CORNERS. RIGHT-OF-WAY LINES. OR PROPERTY LINES AS SHOWN ARE DERIVED FROM RECORD SURVEY PLATS. RIGHT-OF-WAY MAPS, OR DEEDS REFERENCED HEREON AND ARE NOT GUARANTEED OR TO BE RELIED ON FOR THE ESTABLISHMENT OF PROPERTY LINES. THE BOUNDARY INFORMATION DEPICTED BY THIS PLAN IS BASED UPON A BOUNDARY SURVEY PREPARED BY HIGH MESA CONSULTING GROUP, NMPS 11184, DATED 03/24/2021 (2021.012.1). THE TOPOGRAPHIC INFORMATION DEPICTED HEREON IS BASED UPON THE TOPOGRAPHIC AND UTILITY SURVEY PREPARED BY

HIGH MESA CONSULTING GROUP, NMPS NO. 11184, DATED 03/24/2021 (2021.012.1).

2021.012.2

HIGH MESA Consulting Group

17.5 CFS

8,510 CF

\$68,080.00

26.9 CFS

6010-B Midway Park Blvd. NE • Albuquerque, New Mexico 87109 Phone: 505.345.4250 • Fax: 505.345.4254 • www.highmesacg.com

**DEKKER** PERICH SABATINI

ARCHITECTURE **DESIGN** INSPIRATION

ARCHITECT

**ENGINEER** 

\*THIS PLAN SUPERCEDES 06-04-2021 PLAN PROJECT

SITE DEVELOPMENT **PLAN** 

REVISIONS

DRAWN BY J.Y.R. **REVIEWED BY** G.M. 08/06/2021 PROJECT NO. 19-0058

CONCEPTUAL **GRADING PLAN** 

DRAWING NAME

SHEET NO.

CG-101

#### **EASEMENTS**

- W FRD ----- W FRD -----

- SAS — — — SAS — — — -

-SD----SD----

- (1) 10' PNM AND US WEST EASEMENT GRANTED BY PLAT FILED JULY 25, 1988, BOOK C37,
- 2. 10' PNM AND US WEST EASEMENT GRANTED BY PLAT FILED JUNE 28, 1990, BOOK 90C, PAGE 151.
- 3. 10' EASEMENT GRANTED TO N.M. UTILITIES BY PLAT FILED JUNE 28, 1990, BOOK 90C,
- 4. 20' EASEMENT GRANTED TO N.M. UTILITIES BY PLAT FILED JUNE 28, 1990, BOOK 90C,
- 5. 30' EASEMENT GRANTED TO N.M. UTILITIES BY PLAT FILED JUNE 28, 1990, BOOK 90C,
- PAGE 151. 6. APPROXIMATE LOCATION OF 100' PNM POWER LINE EASEMENT FILED MAY 06, 1957, BOOK D385, PAGE 3031. SUBJECT TO EASEMENT ENCROACHMENT AGREEMENT BETWEEN PNM AND N.M. UTILITY CO., FILED JANUARY 23, 1990, BOOK 90-2, PAGES 1325-1327, DOC. #
- 7. 15' UTILITY EASEMENT GRANTED HORIZION-ALBUQUERQUE PROPERTIES AND PNM DATED MARCH 27, 1961, RECORDED FEBRUARY 10, 1992, BOOK 92-3, PAGE 4164. N.M. UTILITIES DISCLAIMS ALL INTEREST TO ABOVE REFERENCED EASEMENT RECORDED JUNE 01, 1988,
- DOC. # 8849100. 8. 8' BIKE LANE AND ASSOCIATED 12' EASEMENT, REFERENCED BY PREVIOUS PLATTING ACTIONS, AND SITE DEVELOPMENT PLAN DATED 06-19-2007, FILE NO. 2-83-93-1, ALSO REFERENCED BY ENCROACHMENT AGREEMENT BETWEEN THE CITY OF ALBUQUERQUE AND
- PNM, FILED FEBRUARY 10, 2005, BOOK A-92, PAGE 31, DOC. #2005020108. 9. 10' GAS COMPANY OF NEW MEXICO EASEMENT, FILED MARCH 21, 1991, BOOK A91-4, PAGE 7909, DOC. #91019534.
- 10. APPROXIMATE LOCATION PUBLIC SIDEWALK EASEMENT GRANTED BY PLAT FILED DECEMBER 18, 2007, BOOK 2007C, PAGE 347, DOC. #2007169358. EXACT LOCATION CANNOT BE DETERMINED BASED UPON EASEMENT ANNOTATION.
- (11) POSSIBLE LOCATION OF 50' ROADWAY EASEMENT RESERVED BY WARRANTY DEED FILED NOVEMBER 19, 1959, BOOK D-513, PAGE 189. EASEMENT NOT DEPICTED OR REFERENCED BY PLATS OF RECORD REFERENCED HEREON.

#### PROJECT BENCHMARK

AN 3 1/4" AGRS ALUMINUM DISK STAMPED "11\_C13". SET FLUSH IN THE NORTHEAST CONCRETE BRIDGE ABUTMENT OF PASEO DEL NORTE OVER COORS BOULEVARD NW. ELEVATION = 5031.88 FEET (NAVD 1988)

#### TEMPORARY BENCHMARK #201 (T.B.M.)

A 60d NAIL, SET IN CONCRETE JOINT NEAR THE NORTHWEST CORNER OF THE PROJECT SITE APPROXIMATELY 22.8' SOUTHWEST OF THE NORTHWEST PROPERTY CORNER, AS SHOWN ON THIS SHEET.

ELEVATION = 5072.42 FEET (NAVD 1988)

#### TEMPORARY BENCHMARK #202 (T.B.M.)

A 60d NAIL, SET IN CONCRETE JOINT NEAR THE SOUTHWEST CORNER OF THE PROJECT SITE APPROXIMATELY 21.3' NORTHEAST OF THE TOP OF A WHEEL CHAIR RAMP, AS SHOWN ON THIS SHEET. ELEVATION = 5076.20 FEET (NAVD 1988)

#### TEMPORARY BENCHMARK #203 (T.B.M.)

A MAG NAIL W/WASHER, SET IN ASPHALT PAVEMENT NEAR THE CENTER OF THE PROJECT SITE APPROXIMATELY 1.1' EAST OF THE EAST ASPHALT CURB, AS SHOWN ON THIS

ELEVATION = 5056.78 FEET (NAVD 1988)

#### TEMPORARY BENCHMARK #204 (T.B.M.)

A MAG NAIL W/WASHER, SET IN ASPHALT PAVEMENT NEAR THE NORTHEAST CORNER OF THE PROJECT SITE APPROXIMATELY 26.6' SOUTH OF THE SOUTHEAST CORNER OF A CONCRETE PAD, AS SHOWN ON THIS SHEET. ELEVATION = 5052.58 FEET (NAVD 1988)

#### TEMPORARY BENCHMARK #205 (T.B.M.)

A MAG NAIL W/WASHER, SET IN ASPHALT PAVEMENT NEAR THE SOUTHEAST CORNER OF THE PROJECT SITE APPROXIMATELY 1.4' SOUTHWEST OF THE END OF A CONCRETE CURB LIP, AS SHOWN ON THIS SHEET.

ELEVATION = 5049.36 FEET (NAVD 1988)


#### **KEYED NOTES:**

- NEW METERED DOMESTIC WATER SERVICE CONNECTION TO EXISTING 12" PUBLIC WATER MAIN
- NEW DOMESTIC WATER SERVICE WITH LARGE METER VAULT NEW DOMESTIC WATER SERVICE BACKFLOW PREVENTER IN HEATED
- NEW UNMETERED FIRE PROTECTION SERVICE CONNECTION TO EXISTING 12" PUBLIC WATER MAIN
- NEW FIRE PROTECTION LINE BACKFLOW PREVENTER IN HEATED ENCLOSURE

PROPOSED FIRE HYDRANT PROPOSED FIRE LINE

- NEW FIRE HYDRANT NEW SANITARY SEWER SERVICE CONNECTION TO EXISTING 8" PUBLIC
- SANITARY SEWER MAIN NEW SANITARY SEWER MANHOLE
- (9) RELOCATE EXISTING PUBLIC FIRE HYDRANT

#### LEGEND:

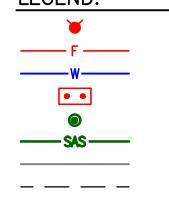

PROPOSED WATER LINE NEW BACKFLOW PREVENTER PROPOSED SANITARY SEWER MANHOLE PROPOSED SANITARY SEWER PROPOSED STORM DRAIN EXISTING EASEMENT LINE PROPOSED EASEMENT LINE EXISTING PROPERTY LINE PROPOSED PROPERTY LINE EXISTING STORM DRAIN MANHOLE EXISTING SANITARY MANHOLE

THIS IS NOT A BOUNDARY SURVEY OR A RIGHT-OF-WAY SURVEY. APPARENT PROPERTY CORNERS, RIGHT-OF-WAY LINES, OR PROPERTY LINES AS SHOWN ARE DERIVED FROM RECORD SURVEY PLATS, RIGHT-OF-WAY MAPS, OR DEEDS REFERENCED HEREON AND ARE NOT GUARANTEED OR TO BE RELIED ON FOR THE ESTABLISHMENT OF PROPERTY LINES.

THE BOUNDARY INFORMATION DEPICTED BY THIS PLAN IS BASED UPON A BOUNDARY SURVEY PREPARED BY HIGH MESA CONSULTING GROUP, NMPS 11184, DATED 03/24/2021 (2021.012.1). THE TOPOGRAPHIC INFORMATION DEPICTED HEREON IS BASED UPON THE TOPOGRAPHIC AND UTILITY SURVEY PREPARED BY HIGH MESA CONSULTING GROUP, NMPS NO. 11184, DATED 03/24/2021 (2021.012.1).

2021.012.2



6010-B Midway Park Blvd. NE • Albuquerque, New Mexico 87109 Phone: 505.345.4250 • Fax: 505.345.4254 • www.highmesacg.com DEKKER PERICH SABATINI

ARCHITECTURE DESIGN INSPIRATION

ARCHITECT

**ENGINEER** 



SEDONA V LE RANCH ALBUQ ALBUQUERQUE, I

SITE DEVELOPMENT PLAN

REVISIONS

DRB COMMENT UPDATE


DRAWN BY J.Y.R. **REVIEWED BY** G.M. DATE 08/06/2021 PROJECT NO. 19-0058

CONCEPTUAL WATER AND SANITARY **SEWER PLAN** 

DRAWING NAME

SHEET NO.

CU-101

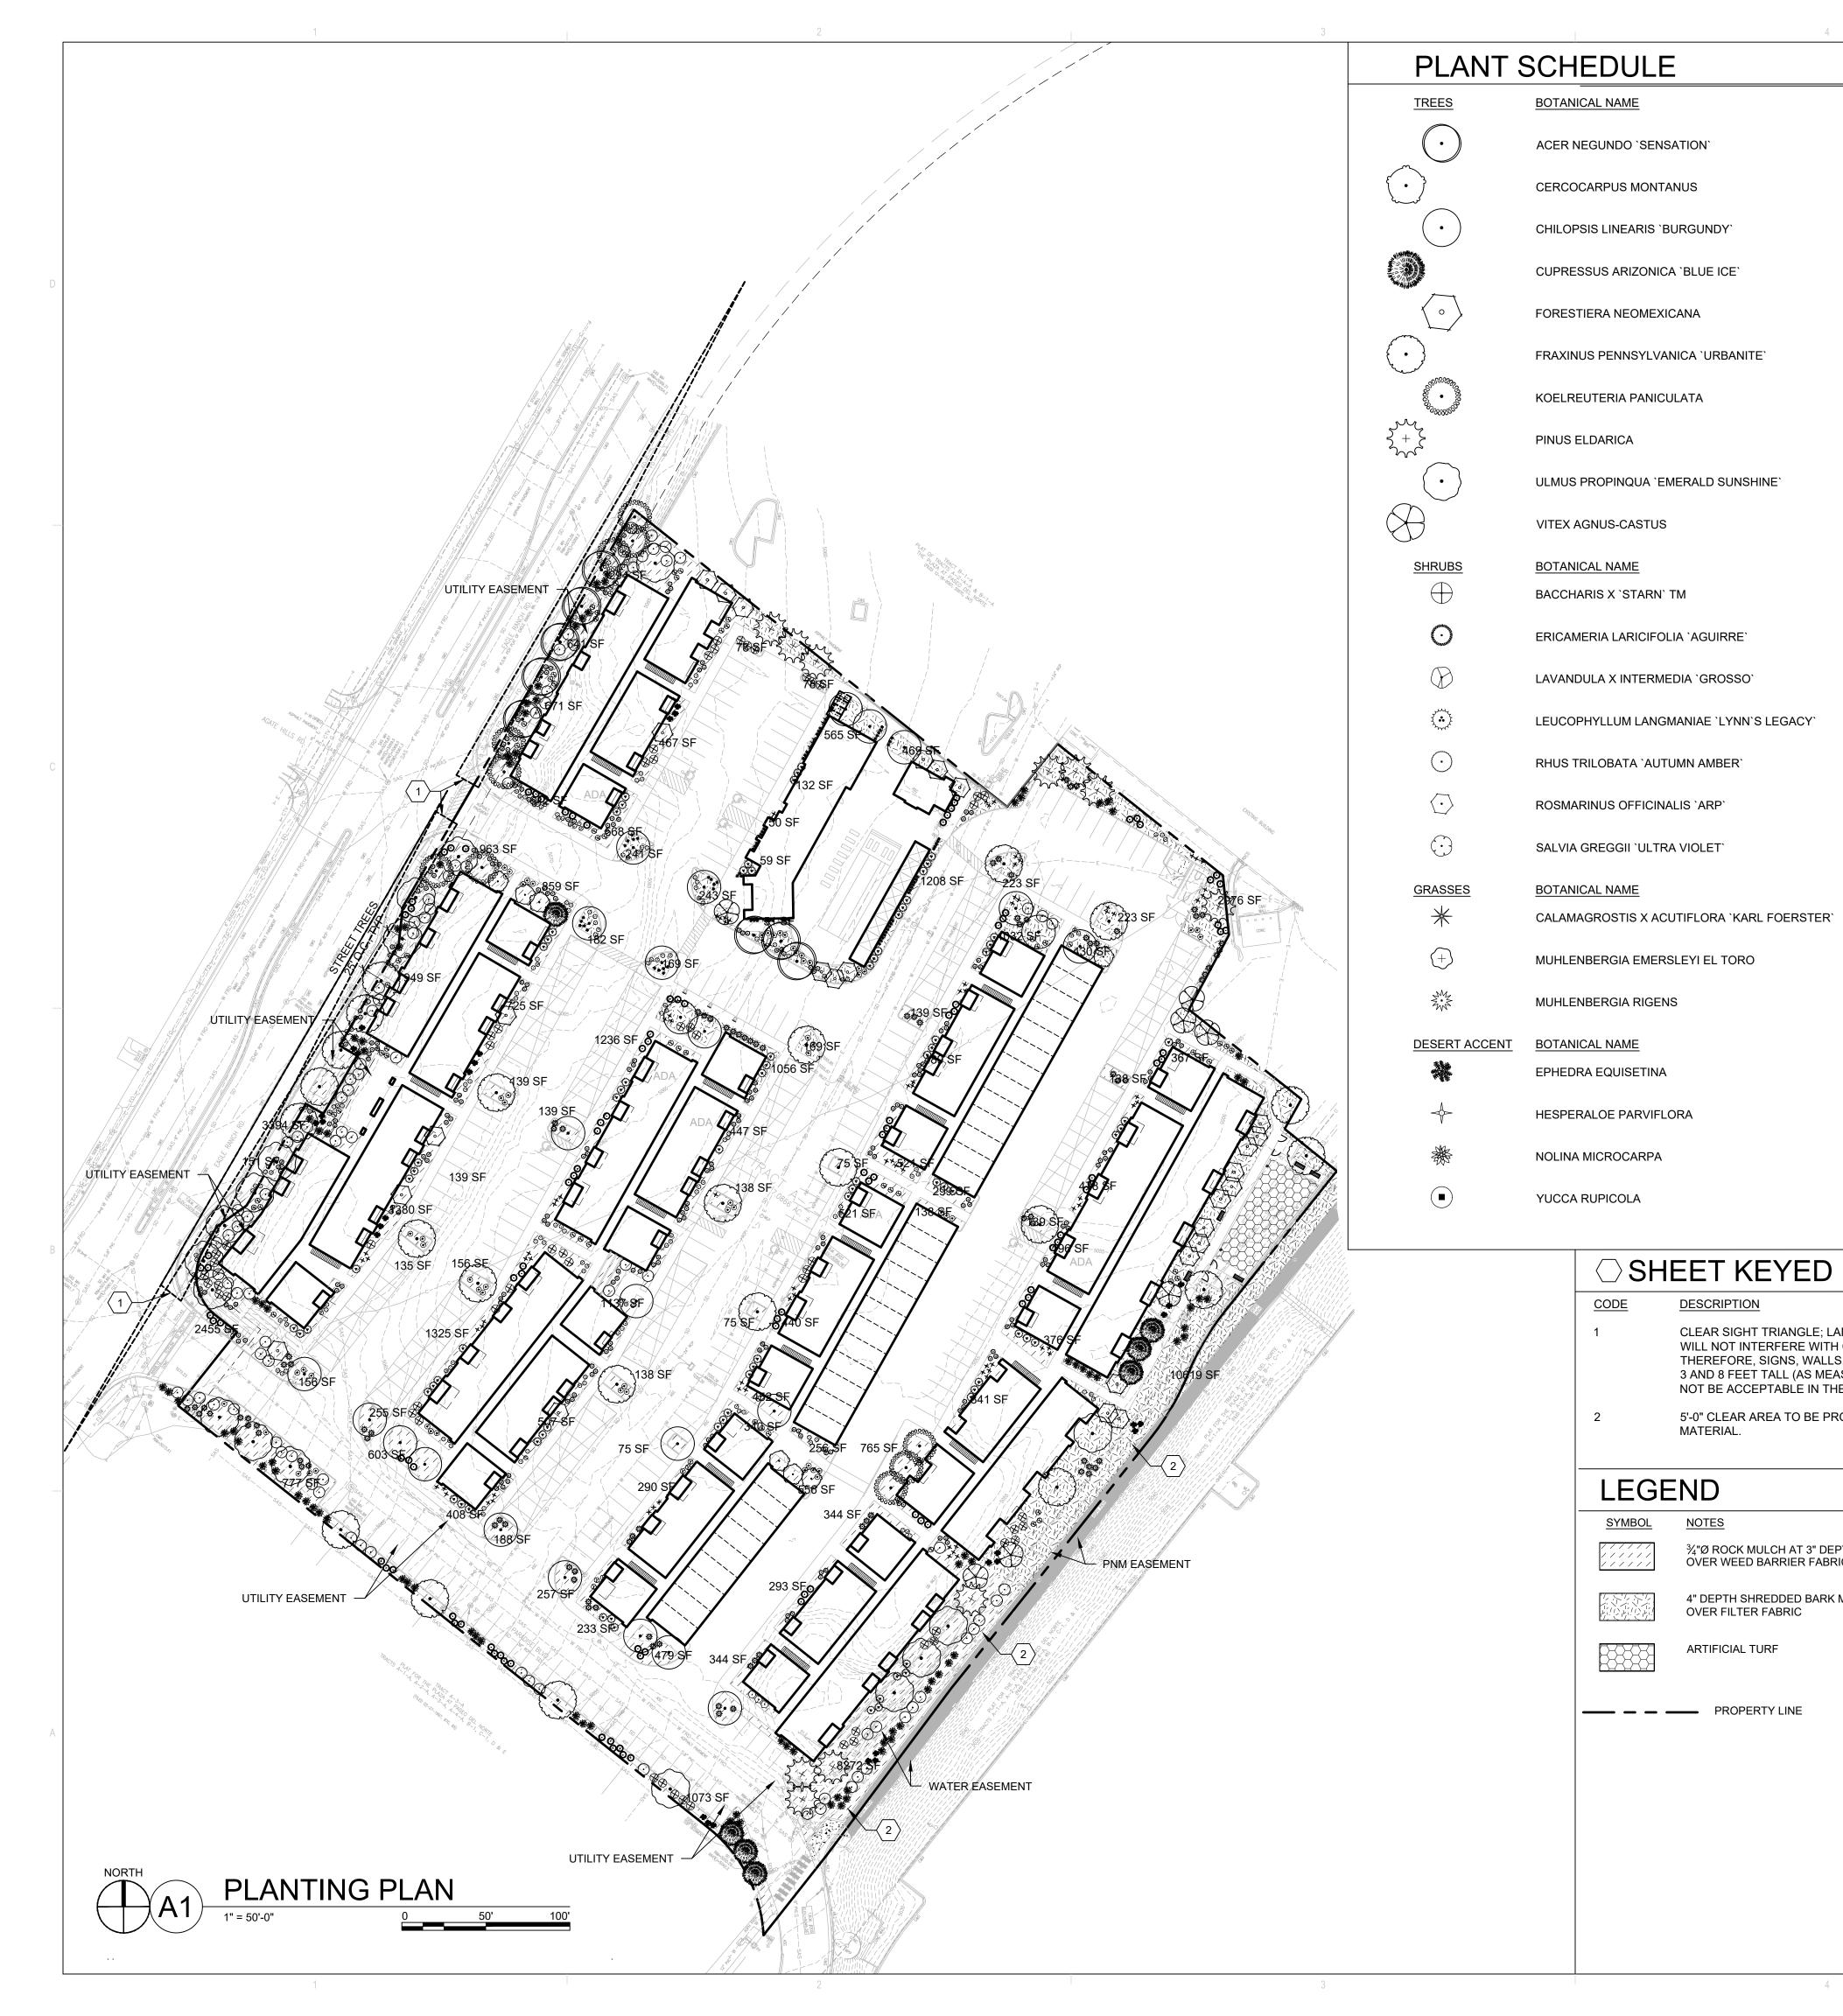

**COMMON NAME** 

SENSATION BOX ELDER

**MOUNTAIN MAHOGANY** 

BLUE ICE ARIZONA CYPRESS

DESERT WILLOW

**NEW MEXICO OLIVE** 

**GOLDEN RAIN TREE** 

EMERALD SUNSHINE ELM

STARN THOMPSON COYOTE BRUSH

URBANITE ASH

**AFGHAN PINE** 

CHASTE TREE

**COMMON NAME** 

**TURPENTINE BUSH** 

GROSSO LAVENDER

PROSTRATE SUMAC

ARP ROSEMARY

**COMMON NAME** 

DEER GRASS

**COMMON NAME** 

RED YUCCA

**BEARGRASS** 

CLEAR SIGHT TRIANGLE; LANDSCAPING, FENCING AND SIGNING

5'-0" CLEAR AREA TO BE PROVIDED BETWEEN TRAIL AND PLANT

WILL NOT INTERFERE WITH CLEAR SIGHT REQUIREMENTS. THEREFORE, SIGNS, WALLS, TREES, AND SHRUBBERY BETWEEN 3 AND 8 FEET TALL (AS MEASURED FROM THE GUTTER PAN) WILL

NOT BE ACCEPTABLE IN THE CLEAR SIGHT TRIANGLE.

⇒ SHEET KEYED NOTES

¾"Ø ROCK MULCH AT 3" DEPTH

4" DEPTH SHREDDED BARK MULCH 20,479 SF

**OVER WEED BARRIER FABRIC** 

OVER FILTER FABRIC

ARTIFICIAL TURF

DESCRIPTION

MATERIAL.

<u>NOTES</u>

PROPERTY LINE

**LEGEND** 

<u>SYMBOL</u>

CODE

**BLUESTEM EPHEDRA** 

TWISTED LEAF YUCCA

EST QTY

43,736 SF

1,835 SF

LYNN'S LEGACY TEXAS SAGE

ULTRA VIOLET AUTUMN SAGE

`KARL FOERSTER` GRASS

EL TORO MUHLY GRASS

A. RESPONSIBILITY FOR MAINTENANCE: THE CONTRACTOR WILL BE RESPONSIBLE FOR MAINTENANCE OF THE LANDSCAPE DURING CONSTRUCTION AND DURING A 90 DAY-MAINTENANCE PERIOD FOLLOWING SUBSTANTIAL COMPLETION. THE OWNER WILL BE RESPONSIBLE FOR MAINTENANCE FOLLOWING THE 90-DAY MAINTENANCE PERIOD.

B. STATEMENT OF COMPLIANCE WITH CITY OF ALBUQUERQUE: THE LANDSCAPE DESIGN WILL COMPLY WITH THE CITY OF ALBUQUERQUE'S LANDSCAPING, BUFFERING, AND SCREENING REGULATIONS (14-16-5-6), WATER CONSERVATION

ORDINANCE AND POLLEN ORDINANCE. C. TIMING OF LANDSCAPE INSTALLATION: INSTALLATION OF THE LANDSCAPING

SHALL BE COMPLETE WITHIN 60 DAYS OF THE RELATED BUILDING'S OCCUPANCY. D. SURFACE TREATMENT: ALL LANDSCAPE AREAS SHALL BE COVERED WITH VEGETATION AND/OR MULCH. ORGANIC MULCH IS REQUIRED AT EACH TREE ROOTBALL AREA/DRIPLINE.

E. LANDSCAPE AND SIGNAGE WILL NOT INTERFERE WITH CLEAR SIGHT REQUIREMENTS. THEREFORE SIGNS, WALLS, TREES AND SHRUBS BETWEEN 3 AND 8 FEET TALL (AS MEASURED FROM THE GUTTER PAN) WILL NOT BE PERMITTED IN THE CLEAR SIGHT TRIANGLE.

F. MINIMUM PLANT SIZES ARE AS PER CITY OF ALBUQUERQUE STANDARDS PER TABLE 5-6-1 OF THE IDO.

G. AREAS DISTURBED DURING CONSTRUCTION, INCLUDING AREAS NOT WITHIN THE PROPERTY LINE, WILL BE STABILIZED. H. VEGETATIVE SCREENING SURROUNDING GROUND-MOUNTED TRANSFORMERS

AND UTILITY PADS SHALL ALLOW 10' OF CLEARANCE MINIMUM IN FRONT OF THE

EQUIPMENT DOOR AND 5' OF CLEARANCE MINIMUM ON THE REMAINING SIDES FOR SAFE OPERATION AND MAINTENANCE. NO EXISTING PLANT MATERIAL IS TO BE PRESERVED ON THE PROPERTY. ALL PLANT MATERIALS ILLUSTRATED ARE NEW.

# **IRRIGATION NOTES**

- A. PLANTS SHALL BE IRRIGATED BY AN AUTOMATED IRRIGATION SYSTEM, WITH PROGRAMMABLE SETTINGS, AUTOMATED IRRIGATION CONTROLLER, AND MOISTURE SENSOR TO AVOID OVERWATERING.
- B. THE IRRIGATION SYSTEM SHALL BE DESIGNED TO MINIMIZE THE USE OF WATER. C. THE IRRIGATION SYSTEM SHALL NOT IRRIGATE IMPERVIOUS SURFACES,
- INCLUDING SIDEWALKS, DRIVEWAYS, STREETS, PARKING, AND LOADING AREAS. D. IRRIGATION POINT OF CONNECTION TO THE CITY WATER WILL BE LOCATED WITHIN PROPERTY LIMITS AND SHALL COMPLY WITH THE CITY OF ALBUQUERQUE REDUCED PRESSURE BACKFLOW PREVENTER STANDARDS AND SPECIFICATIONS.
- E. RUN TIMES AND IRRIGATION ZONES SHALL BE BASED UPON PLANT SPECIES AND THEIR ESTABLISHMENT. RUN TIMES SHALL BE REGULARLY ADJUSTED BY THE OWNER ACCORDING TO PLANT MATURITY, SEASON, LOCATION AND PERFORMANCE.

#### LANDSCAPE CALCULATIONS

TOTAL SITE AREA = 7.12 AC = 310,147 SF AREA OF LOT COVERED BY BUILDINGS = 91,826 SF NET LOT AREA = 218,321 SF

REQUIRED LANDSCAPE AREA (15% OF NET LOT AREA) = 32,749 SF

PROVIDED LANDSCAPE AREA = 64,215 SF = 29%

TOTAL NUMBER OF PARKING SPACES = 304 SPACES REQUIRED PARKING LOT TREES (1 TREE PER 10 SPACES) = 31 TREES PROVIDED NUMBER OF PARKING LOT TREES = 34 TREES NO PARKING SPACE MAY BE MORE THAN 100 FEET AWAY FROM A TREE TRUNK

REQUIRED STREET TREES = 21 placed at 25' on center (535' of street frontage) PROVIDED STREET TREES = 23

REQUIRED TREES FOR MULTI-FAMILY RESIDENTIAL DEVELOPMENTS = 135 TREES 1 TREE PER GROUND FLOOR DWELLING UNIT (57) AND 1 TREE PER SECOND-STORY PROVIDED TREES FOR MULTI-FAMILY RESIDENTIAL DEVELOPMENTS = 137 TREES

REQUIRED VEGETATIVE COVERAGE

REQUIRED GROUND COVERAGE = 47,535 SF = 75% OF PROVIDED LANDSCAPE AREA A MINIMUM 25% OF REQUIRED VEGETATIVE COVERAGE BY GROUND PLANTS PROVIDED TOTAL GROUND COVERAGE = 76,966 SF TREE CANOPY COVERAGE = 57,648 SF


GROUND PLANT COVERAGE = 13,207 SF = 27% OF REQUIRED VEGETATIVE COVERAGE

PARKING LOT AREA = 194,500 SF PARKING LOT LANDSCAPING PROVIDED = 29,175 SF = 15% MIN. 15% OF PARKING LOT AREA TO BE LANDSCAPED

TOTAL ROCK MULCH GROUND COVER = 43,736 SF = 68% TOTAL ORGANIC MULCH GROUND COVER = 20,479 SF = 32% A MAXIMUM OF 75% OF GRAVEL OR CRUSHER FINES IS PERMITTED 14-16-5-6(C)(5)(d

# TREE PLANTING DETAIL

PRIOR TO BACKFILLING, MATERIAL SUCH AS CONTAINERS, WIRE, BURLAP AND ROPE SHALL BE COMPLETELY REMOVED.

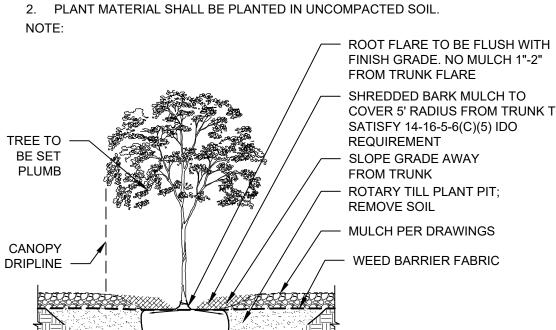

3 TIMES ROOTBALL DIAMETER

SHREDDED BARK MULCH TO COVER 5' RADIUS FROM TRUNK TO SATISFY 14-16-5-6(C)(5) IDO - ROTARY TILL PLANT PIT; MULCH PER DRAWINGS

> ROUGH-UP SIDES OF PLANTING PIT ROOTBALL ON

UNDISTURBED SOIL

PLANTING PLAN

**SDP2.1** 

DEKKER PERICH SABATINI

ARCHITECTURE DESIGN **INSPIRATION** 

**ENGINEER** 

**PROJECT** 

REVISIONS

DRAWN BY **REVIEWED BY** 


DATE 10/29/2021 PROJECT NO.


20-0286 DRAWING NAME



- A. ALL ROOF MOUNTED MECHANICAL EQUIPMENT SHALL BE SCREENED BY PARAPET WALL AND NOT BE VISIBLE WHEN VIEWED FROM 5' ABOVE GRADE AT ANY PROPERTY LINE.
- B. ALL DIMENSIONS SHOWN ARE TO OUTSIDE FACE OF FINISH UNLESS OTHERWISE NOTED.
- C. BUILDING IDENTIFICATION SIGNAGE TO BE A MINIMUM OF 18" HIGH CHARACTERS WITH A MINIMUM OF 3" BRUSH STROKE WITH CONTRASTING ALUMINUM COLORS LIT FROM DUSK UNTIL DAWN AS WELL AS DAYLIGHT HOURS, PER
- 2009 IFC. MOUNT AT 15'-20' ABOVE FINISH FLOOR. D. ALL IDO REQUIREMENTS WILL BE MET PER SECTION
- 5-11(E)(2); REF: BUILDING FLOOR PLAN SHEETS FOR
- ADDITIONAL INFORMATION. E. ROOF DRAINAGE BY WAY OF EXTERNAL DOWNSPOUTS.

- SHEET KEYNOTES (X)
- 1. FIELD COLOR NEUTRAL WARM WHITE STUCCO FINISH MATERIAL
- 2. ACCENT COLOR/MATERIAL #1 DARK MASONRY VENEER 3. ACCENT COLOR/MATERIAL #2 - DARK GRAY - ACCENT PANELIZED FIBER CEMENT BOARD
- 4. ACCENT COLOR #3 LIGHT GRAY ACCENT STUCCO FINISH
- 5. ACCENT COLOR #4 RUST TONE ACCENT STUCCO FINISH 6. ACCENT COLOR #5- BLUE TONE - ACCENT STUCCO FINISH
- 7. NOT USED 8. ACCENT COLOR #7 - YELLOW TONE - ACCENT STUCCO FINISH
- 9. FIBER CEMENT BOARD FACIA TO MATCH MASONRY VENEER 10. PREFINISHED METAL COPING - COLOR TO MATCH ADJACENT MATERIAL OR STANDARD NEUTRAL COLOR
- 11. GUARDRAIL METAL CUSTOM FABRICATED
- 12. BUILDING IDENTIFICATION SIGNAGE FOR WAYFINDING 13. RESIDENTIAL WINDOWS (OPERABLE, LOW-E GLASS) - FRAME
- COLOR: BLACK 14. WINDOW AWNING - METAL CUSTOM FABRICATED
- 15. PATIO WALL CMU
- 16. GARAGE OVERHEAD DOOR
- 17. METAL UNIT ENTRY DOOR 18. METAL PATIO GATE
- 19. STEEL COLUMN PAINTED
- 21. EXTERIOR STEEL STAIR
- 22. PATIO DOOR WITH LIGHT 23. ALUMINUM STOREFRONT
- 20. STEEL DOWNSPOUT

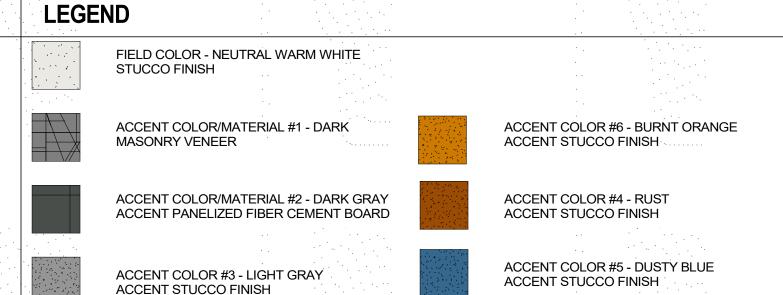

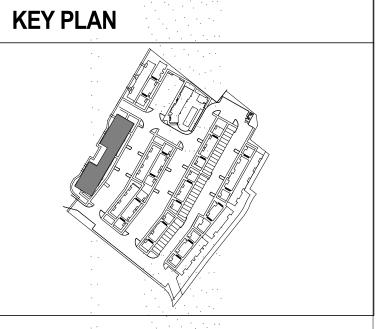

11'-2 1/2" 28'-0 1/2" 10  $\langle 14 \rangle \langle 13 \rangle$ T.O. PARAPET AT ACCENT BLDGS A&B 123'-3 3/4" T.O. PARAPET BLDGS A&B 122'-3 3/4" ROOF BEARING BLUGS A&B 119'-8 3/4" T.O. DECK - LEVEL 2 110'-7 3/4" T.O. SLAB 100'-0"

T.O. PARAPET AT ACCENT BLDGS A&B T.O. PARAPET BLDGS A&B-122'-3 3/4" KUUF BEARING BLDGS A&B 119'-8 3/4" T.O. DECK - LEVEL 2 110'-7 3/4" T.O. SLAB 100'-0"


**BUILDING A - SOUTH ELEVATION** 

COMPLIANCE WITH SECTION 5-7(D): CMU WALLS 3'-0" IN HEIGHT 5-7(D)(1)

COMPLIANCE WITH SECTION 5-11(D): PRIMARY BUILDING ENTRANCE COMPLIES WITH 5-11(D)(1) RECESSED WINDOWS 2" WITH 2" CASING 5-11(D)(3)

COMPLIANCE WITH SECTION 5-11(E)(2): PROVIDE WINDOWS ON UPPER FLOORS 5-11(E)(2)(a&b)2&3 PROVIDE AWNINGS OVER WINDOWS 5-11(E)(2)(a&b)2&3 CHANGE IN COLOR EVERY 50 FT 5-11(E)(2)(a)3 RECESSED WINDOWS 2" AT UPPER FLOORS 5-11(E)(2)(b)1

GROUND FLOOR STREET-FACING FACADE CONTAINS MINIMUM OF 30 PERCENT TRANSPARENT WINDOWS/DOORS 5-11(E)(2)(b) 2 CHANGE IN COLOR EVERY 25 FT 5-11(E)(2)(b)4 CHANGE IN PARAPET HEIGHT 5-11(E)(2)(b)4

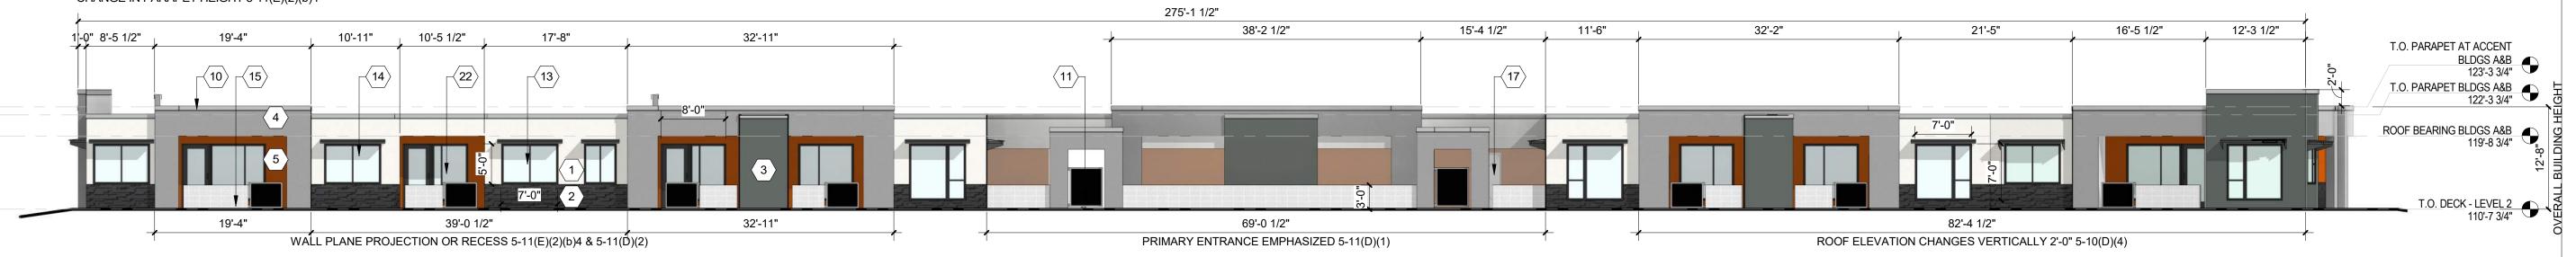


BUILDING A - WEST ELEVATION(STREET-FACING FACADE)





PERICH SABATINI

ARCHITECTURE DESIGN INSPIRATION

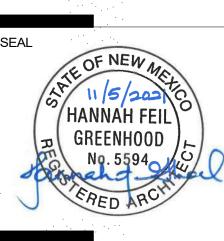

PROJECT

EAGLE RANG ALBUQUERQUE

**DESIGN REVIEW** BOARD (DRB) MINOR SITE PLAN **AMENDMENT** 

| REVISIONS   |          |
|-------------|----------|
|             |          |
|             |          |
| RAWN BY     | VM, A    |
| REVIEWED BY | HF       |
| DATE        | 10/12/20 |
| ROJECT NO:  | 20-02    |
|             |          |
|             |          |

DRAWING NAME

EXTERIOR **ELEVATIONS -BUILDING A** 

SHEET NO

**SDP5.1** 

- A. ALL ROOF MOUNTED MECHANICAL EQUIPMENT SHALL BE SCREENED BY PARAPET WALL AND NOT BE VISIBLE WHEN VIEWED FROM 5' ABOVE GRADE AT ANY PROPERTY LINE.
- B. ALL DIMENSIONS SHOWN ARE TO OUTSIDE FACE OF FINISH UNLESS OTHERWISE NOTED.
- C. BUILDING IDENTIFICATION SIGNAGE TO BE A MINIMUM OF 18" HIGH CHARACTERS WITH A MINIMUM OF 3" BRUSH STROKE WITH CONTRASTING ALUMINUM COLORS LIT FROM DUSK UNTIL DAWN AS WELL AS DAYLIGHT HOURS, PER
- 2009 IFC. MOUNT AT 15'-20' ABOVE FINISH FLOOR. D. ALL IDO REQUIREMENTS WILL BE MET PER SECTION
- 5-11(E)(2); REF: BUILDING FLOOR PLAN SHEETS FOR
- ADDITIONAL INFORMATION. E. ROOF DRAINAGE BY WAY OF EXTERNAL DOWNSPOUTS.

#### SHEET KEYNOTES (X)

- 1. FIELD COLOR NEUTRAL WARM WHITE STUCCO FINISH MATERIAL
- 2. ACCENT COLOR/MATERIAL #1 DARK MASONRY VENEER 3. ACCENT COLOR/MATERIAL #2 - DARK GRAY - ACCENT PANELIZED FIBER CEMENT BOARD
- 4. ACCENT COLOR #3 LIGHT GRAY ACCENT STUCCO FINISH 5. ACCENT COLOR #4 - RUST TONE - ACCENT STUCCO FINISH
- 6. ACCENT COLOR #5- BLUE TONE ACCENT STUCCO FINISH 7. NOT USED
- 8. ACCENT COLOR #7 YELLOW TONE ACCENT STUCCO FINISH 9. FIBER CEMENT BOARD FACIA - TO MATCH MASONRY VENEER
- 10. PREFINISHED METAL COPING COLOR TO MATCH ADJACENT MATERIAL OR STANDARD NEUTRAL COLOR
- 16. GARAGE OVERHEAD DOOR
- 15. PATIO WALL CMU

11. GUARDRAIL - METAL CUSTOM FABRICATED

12. BUILDING IDENTIFICATION SIGNAGE FOR WAYFINDING

14. WINDOW AWNING - METAL CUSTOM FABRICATED

13. RESIDENTIAL WINDOWS (OPERABLE, LOW-E GLASS) - FRAME

- 17. METAL UNIT ENTRY DOOR
- 18. METAL PATIO GATE 19. STEEL COLUMN PAINTED
- 20. STEEL DOWNSPOUT 21. EXTERIOR STEEL STAIR

COLOR: BLACK


22. PATIO DOOR WITH LIGHT 23. ALUMINUM STOREFRONT

#### **LEGEND** FIELD COLOR - NEUTRAL WARM WHITE STUCCO FINISH ACCENT COLOR #6 - BURNT ORANGE ACCENT COLOR/MATERIAL #1 - DARK ACCENT STUCCO FINISH MASONRY VENEER ACCENT COLOR/MATERIAL #2 - DARK GRAY ACCENT COLOR #4 - RUST ACCENT PANELIZED FIBER CEMENT BOARD ACCENT STUCCO FINISH ACCENT COLOR #5 - DUSTY BLUE ACCENT COLOR #3 - LIGHT GRAY ACCENT STUCCO FINISH ACCENT STUCCO FINISH

64'-2 1/2"



INSPIRATION

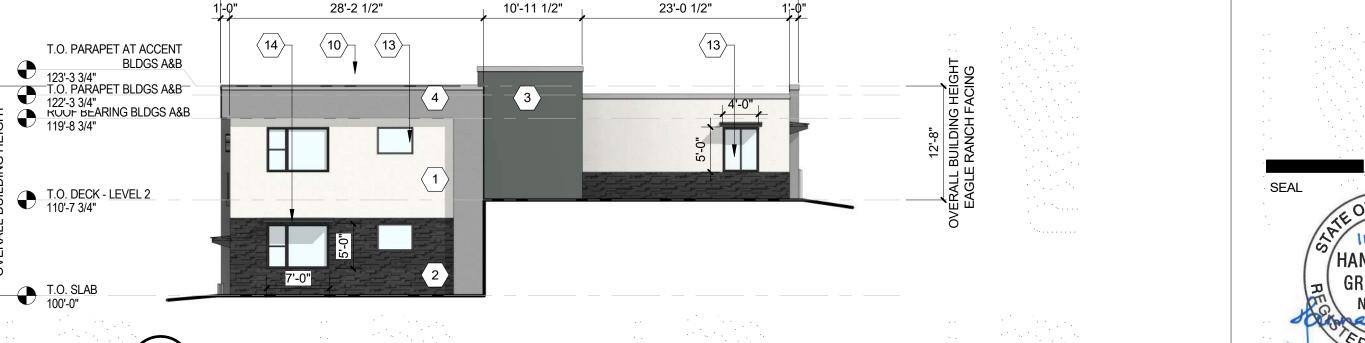

**KEY PLAN** 

**BUILDING B - NORTH ELEVATION** 

T.O. DECK - <u>LEVEL 2</u> 110'-7 3/4"

64'-2 1/2" 28'-2 1/2" 5'-9 1/2" 28'-2 1/2" T.O. PARAPET AT ACCENT BLDGS A&B 123'-3 3/4"

T.O. PARAPET BLUGS A&B
122'-3 3/4"

ROOF BEARING BLUGS A&B 119'-8 3/4" T.O. DECK - LEVEL 2 T.O. SLAB 100'-0"

**BUILDING B - SOUTH ELEVATION** 


COMPLIANCE WITH SECTION 5-7(D): CMU WALLS 3'-0" IN HEIGHT 5-7(D)(1) COMPLIANCE WITH SECTION 5-11(D): PRIMARY BUILDING ENTRANCES COMPLY WITH 5-11(D)(1) RECESSED WINDOWS 2" WITH 2" CASING 5-11(D)(3)

CHANGE IN PARAPET HEIGHT 5-11(E)(2)(b)4


COMPLIANCE WITH SECTION 5-11(E)(2): PROVIDE WINDOWS ON UPPER FLOORS 5-11(E)(2)(a&b)2&3 PROVIDE AWNINGS OVER WINDOWS 5-11(E)(2)(a&b)2&3 CHANGE IN COLOR EVERY 50 FT 5-11(E)(2)(a)3 RECESSED WINDOWS 2" AT UPPER FLOORS 5-11(E)(2)(b)1 GROUND FLOOR STREET-FACING FACADE CONTAINS MINIMUM OF 30 PERCENT TRANSPARENT WINDOWS/DOORS 5-11(E)(2)(b) 2 CHANGE IN COLOR EVERY 25 FT 5-11(E)(2)(b)4

108'-6 1/2" ROOF ELEVATION CHANGES VERTICALLY 2'-0" 5-10(D)(4) 157'-2" 22'-2 1/2" 5'-11 1/2" 11'-8 1/2" 14'-10 1/2" 29'-10 1/2" 11'-9 1/2" T.O. PARAPET AT ACCENT
BLDGS A&B
123'-3 3/4" -T.O. PARAPET BLDGS A&B 122'-3 3/4" 7'-0" 22'-2 1/2" WALL PLANE PROJECTION OR RECESS 5-11(E)(2)(b)4 & 5-11(D)(2)

BUILDING B - WEST ELEVATION (STREET-FACING FACADE)

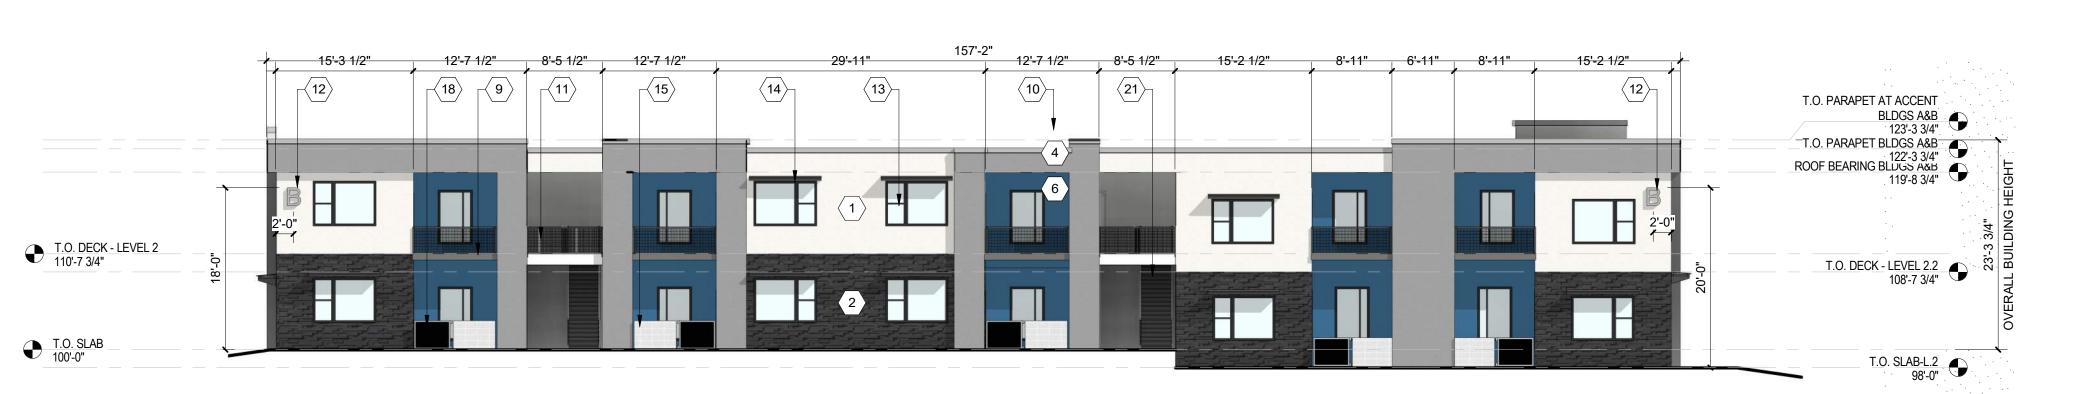



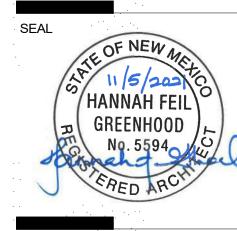

PROJECT

EAGLE RAN

**DESIGN REVIEW** BOARD (DRB) MINOR SITE PLAN **AMENDMENT** 

REVISIONS DRAWN BY **REVIEWED BY** DATE 10/12/2021 PROJECT NO:

EXTERIOR **ELEVATIONS -BUILDING B** 

DRAWING NAME

SHEET NO

VM, AG

20-0286

HFG

- A. ALL ROOF MOUNTED MECHANICAL EQUIPMENT SHALL BE SCREENED BY PARAPET WALL AND NOT BE VISIBLE WHEN VIEWED FROM 5' ABOVE GRADE AT ANY PROPERTY LINE.
- B. ALL DIMENSIONS SHOWN ARE TO OUTSIDE FACE OF FINISH UNLESS OTHERWISE NOTED.
- C. BUILDING IDENTIFICATION SIGNAGE TO BE A MINIMUM OF 18" HIGH CHARACTERS WITH A MINIMUM OF 3" BRUSH STROKE WITH CONTRASTING ALUMINUM COLORS LIT FROM DUSK UNTIL DAWN AS WELL AS DAYLIGHT HOURS, PER
- 2009 IFC. MOUNT AT 15'-20' ABOVE FINISH FLOOR. D. ALL IDO REQUIREMENTS WILL BE MET PER SECTION
- 5-11(E)(2); REF: BUILDING FLOOR PLAN SHEETS FOR
- ADDITIONAL INFORMATION. E. ROOF DRAINAGE BY WAY OF EXTERNAL DOWNSPOUTS.

#### SHEET KEYNOTES (X)


- 1. FIELD COLOR NEUTRAL WARM WHITE STUCCO FINISH MATERIAL
- 2. ACCENT COLOR/MATERIAL #1 DARK MASONRY VENEER 3. ACCENT COLOR/MATERIAL #2 - DARK GRAY - ACCENT PANELIZED
- FIBER CEMENT BOARD 4. ACCENT COLOR #3 - LIGHT GRAY - ACCENT STUCCO FINISH
- 5. ACCENT COLOR #4 RUST TONE ACCENT STUCCO FINISH 6. ACCENT COLOR #5- BLUE TONE - ACCENT STUCCO FINISH 7. NOT USED
- 8. ACCENT COLOR #7 YELLOW TONE ACCENT STUCCO FINISH
- 10. PREFINISHED METAL COPING COLOR TO MATCH ADJACENT MATERIAL OR STANDARD NEUTRAL COLOR
- 9. FIBER CEMENT BOARD FACIA TO MATCH MASONRY VENEER
- 11. GUARDRAIL METAL CUSTOM FABRICATED
- 12. BUILDING IDENTIFICATION SIGNAGE FOR WAYFINDING 13. RESIDENTIAL WINDOWS (OPERABLE, LOW-E GLASS) - FRAME
- COLOR: BLACK 14. WINDOW AWNING - METAL CUSTOM FABRICATED
- 15. PATIO WALL CMU 16. GARAGE OVERHEAD DOOR
- 17. METAL UNIT ENTRY DOOR
- 18. METAL PATIO GATE
- 19. STEEL COLUMN PAINTED 20. STEEL DOWNSPOUT
- 21. EXTERIOR STEEL STAIR 22. PATIO DOOR WITH LIGHT 23. ALUMINUM STOREFRONT


#### FIELD COLOR - NEUTRAL WARM WHITE STUCCO FINISH ACCENT COLOR/MATERIAL #1 - DARK MASONRY VENEER ACCENT STUCCO FINISH ACCENT COLOR/MATERIAL #2 - DARK GRAY ACCENT COLOR #4 - RUST ACCENT PANELIZED FIBER CEMENT BOARD ACCENT STUCCO FINISH


ACCENT COLOR #3 - LIGHT GRAY

ACCENT STUCCO FINISH


**LEGEND** 

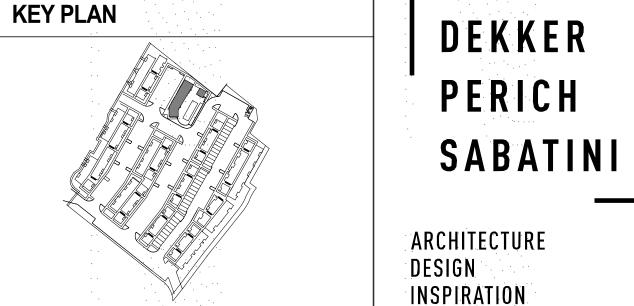

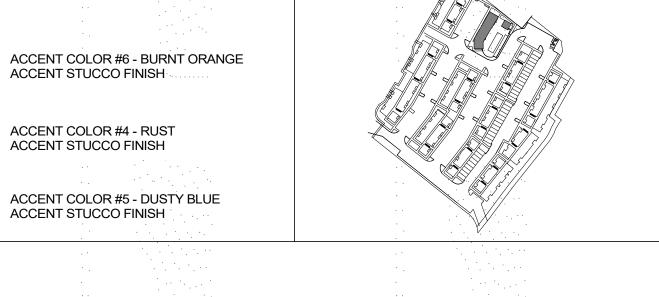

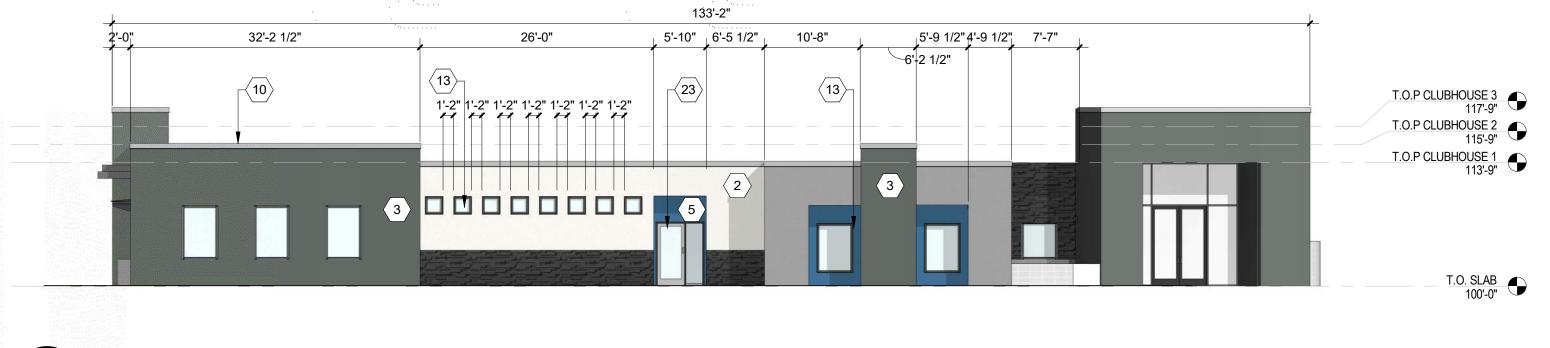


CLUBHOUSE - NORTH ELEVATION

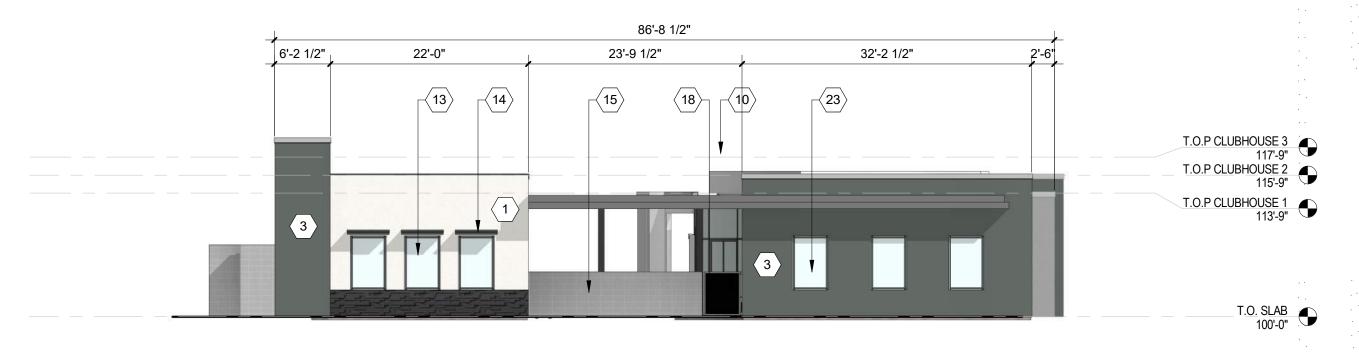


C4) CLUBHOUSE - EAST ELEVATION

3/32" = 1'-0"

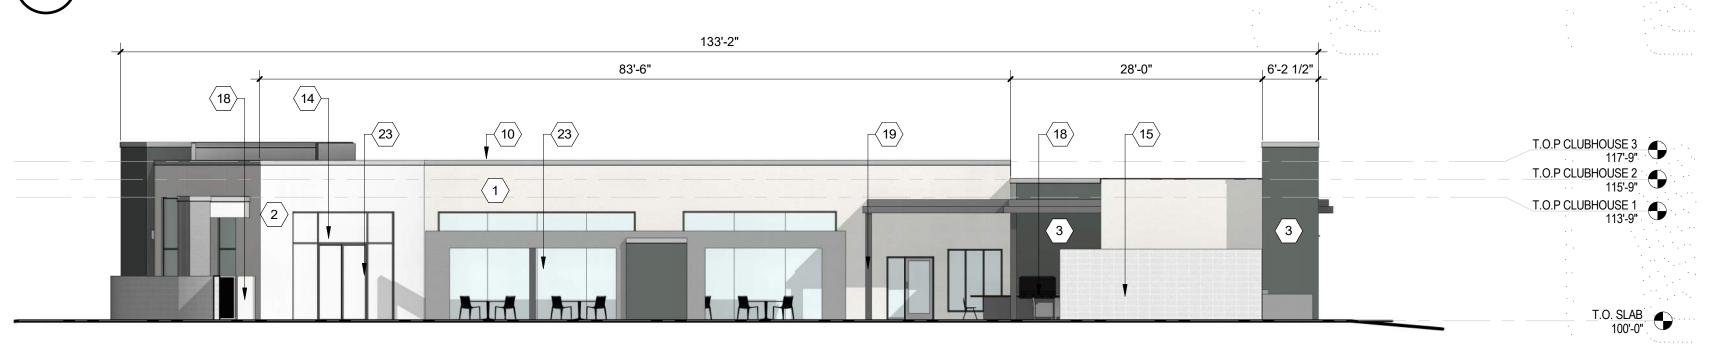

(A2) CLUBHOUSE - WEST ELEVATION

3/32" = 1'-0"

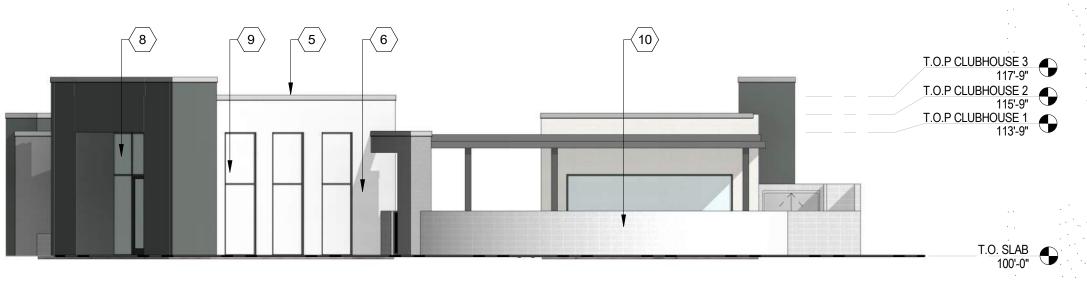

BLDG C WEST ELEVATION-DRB



PROJECT

EAGLE RANC ALBUQUERQUE SEDON/

**DESIGN REVIEW** BOARD (DRB) MINOR SITE PLAN **AMENDMENT** 

REVISIONS DRAWN BY Author **REVIEWED BY** Approver DATE 10/12/2021 PROJECT NO: 20-0286

DRAWING NAME

EXTERIOR **ELEVATIONS -**CLUBHOUSE

SHEET NO

**SDP5.3** 



DEKKER
PERICH
SABATINI

ARCHITECTURE DESIGN INSPIRATION

HANNAH FEIL GREENHOOD No. 5594

PROJECT

SEDONA WEST
EAGLE RANCH ROAD
ALBUQUERQUE, NM 87112

DESIGN REVIEW BOARD (DRB) MINOR SITE PLAN AMENDMENT

DRAWN BY VM, AG
REVIEWED BY HFG
DATE 10/12/2021
PROJECT NO: 20-0286

DRAWING NAME

EXTERIOR
ELEVATIONS BUILDING D

SDP5.4

- A. ALL ROOF MOUNTED MECHANICAL EQUIPMENT SHALL BE SCREENED BY PARAPET WALL AND NOT BE VISIBLE WHEN VIEWED FROM 5' ABOVE GRADE AT ANY PROPERTY LINE.
- B. ALL DIMENSIONS SHOWN ARE TO OUTSIDE FACE OF FINISH UNLESS OTHERWISE NOTED.
- C. BUILDING IDENTIFICATION SIGNAGE TO BE A MINIMUM OF 18" HIGH CHARACTERS WITH A MINIMUM OF 3" BRUSH STROKE WITH CONTRASTING ALUMINUM COLORS LIT FROM DUSK UNTIL DAWN AS WELL AS DAYLIGHT HOURS, PER 2009 IFC. MOUNT AT 15'-20' ABOVE FINISH FLOOR.
- D. ALL IDO REQUIREMENTS WILL BE MET PER SECTION 5-11(E)(2); REF: BUILDING FLOOR PLAN SHEETS FOR
- ADDITIONAL INFORMATION. E. ROOF DRAINAGE BY WAY OF EXTERNAL DOWNSPOUTS.

#### SHEET KEYNOTES (X)


- 1. FIELD COLOR NEUTRAL WARM WHITE STUCCO FINISH MATERIAL
- 2. ACCENT COLOR/MATERIAL #1 DARK MASONRY VENEER 3. ACCENT COLOR/MATERIAL #2 - DARK GRAY - ACCENT PANELIZED FIBER CEMENT BOARD
- 4. ACCENT COLOR #3 LIGHT GRAY ACCENT STUCCO FINISH
- 5. ACCENT COLOR #4 RUST TONE ACCENT STUCCO FINISH 6. ACCENT COLOR #5- BLUE TONE - ACCENT STUCCO FINISH 7. NOT USED
- 8. ACCENT COLOR #7 YELLOW TONE ACCENT STUCCO FINISH 9. FIBER CEMENT BOARD FACIA - TO MATCH MASONRY VENEER
- 10. PREFINISHED METAL COPING COLOR TO MATCH ADJACENT MATERIAL OR STANDARD NEUTRAL COLOR
- 11. GUARDRAIL METAL CUSTOM FABRICATED
- 12. BUILDING IDENTIFICATION SIGNAGE FOR WAYFINDING
- 13. RESIDENTIAL WINDOWS (OPERABLE, LOW-E GLASS) FRAME COLOR: BLACK
- 14. WINDOW AWNING METAL CUSTOM FABRICATED
- 15. PATIO WALL CMU
- 16. GARAGE OVERHEAD DOOR
- 17. METAL UNIT ENTRY DOOR
- 18. METAL PATIO GATE
- 19. STEEL COLUMN PAINTED
- 20. STEEL DOWNSPOUT
- 22. PATIO DOOR WITH LIGHT
- 21. EXTERIOR STEEL STAIR 23. ALUMINUM STOREFRONT

#### **LEGEND** FIELD COLOR - NEUTRAL WARM WHITE STUCCO FINISH ACCENT COLOR/MATERIAL #1 - DARK







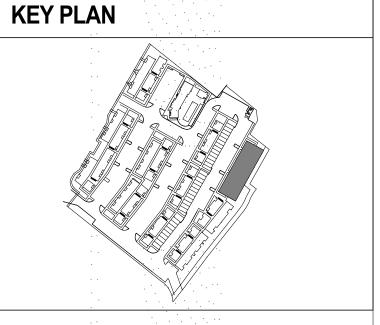

64'-2 1/2" 28'-2 1/2" 5'-9 1/2" 29'-2 1/2" **13** T.O. PARAPET AT ACCENT 138'-0" T.O. PARAPET ROOF BEARING 130'-4 1/2" T.O. DECK - LEVEL 3 121'-3 1/2"  $\langle 1 \rangle$ T.O. DECK - LEVEL 2 T.O. SLAB

64'-2 1/2" 28'-2 1/2" 28'-2 1/2" 5'-9 1/2" 14  $\langle 10 \rangle_{\Box}$ T.O. PARAPET AT ACCENT 138'-0" ROOF BEARING 130'-4 1/2" T.O. DECK - LEVEL 3 121'-3 1/2" T.O. DECK - LEVEL 2


**BUILDING E - SOUTH ELEVATION** 

**BUILDING E - NORTH ELEVATION** 



B2) BUILDING E - WEST ELEVATION

3/32" = 1'-0"

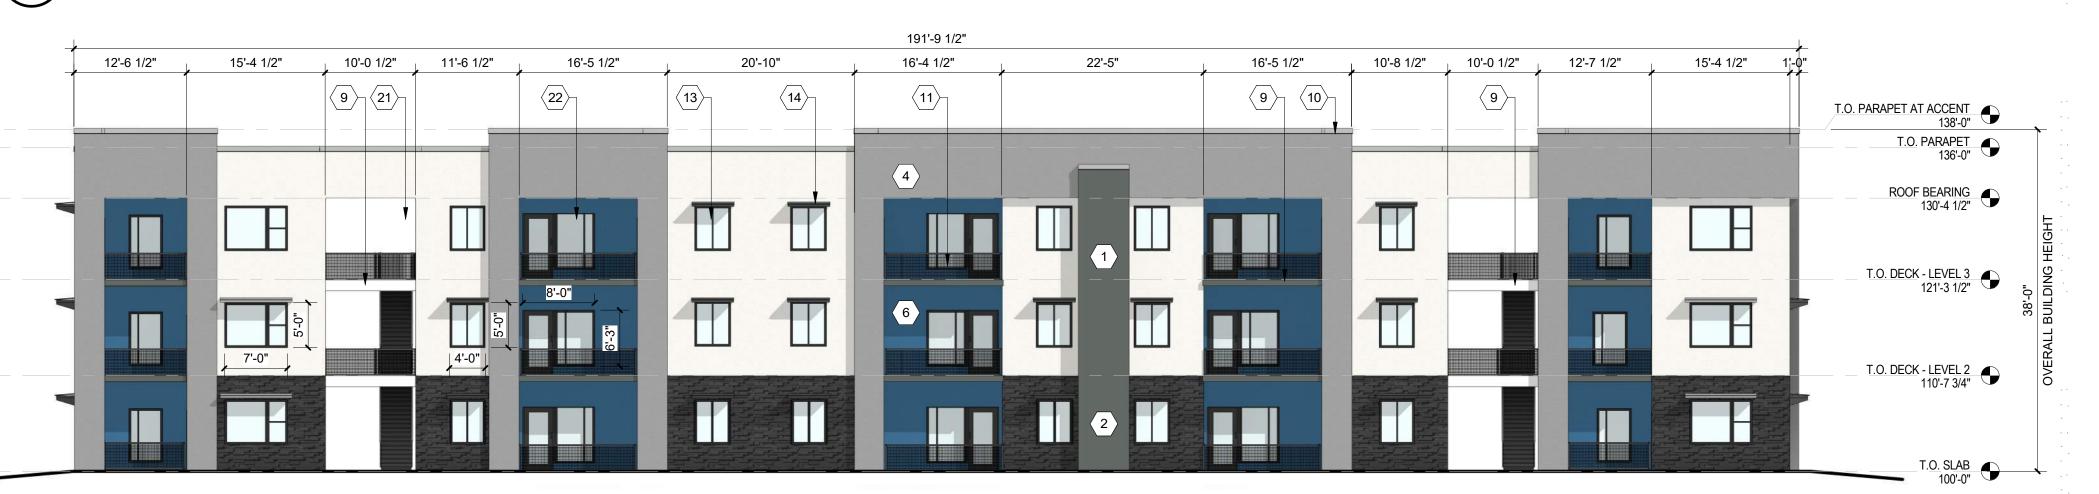

BUILDING E - EAST ELEVATION

3/32" = 1'-0"

PERICH SABATINI

ARCHITECTURE DESIGN INSPIRATION



PROJECT

EAGLE RANC ALBUQUERQUE SEDON

**DESIGN REVIEW** BOARD (DRB) MINOR SITE PLAN **AMENDMENT** 

| REVIS       | SIONS   |            |
|-------------|---------|------------|
| $\triangle$ |         |            |
|             |         |            |
| $\triangle$ |         |            |
| DRAV        | VN BY   | VM         |
| REVIE       | EWED BY | HFG        |
| DATE        |         | 10/12/2021 |
|             |         |            |

DRAWING NAME

PROJECT NO:

EXTERIOR **ELEVATIONS -BUILDING E** 

SHEET NO

SDP5.5

HFG

20-0286

- A. ALL ROOF MOUNTED MECHANICAL EQUIPMENT SHALL BE SCREENED BY PARAPET WALL AND NOT BE VISIBLE WHEN VIEWED FROM 5' ABOVE GRADE AT ANY PROPERTY LINE.
- B. ALL DIMENSIONS SHOWN ARE TO OUTSIDE FACE OF FINISH UNLESS OTHERWISE NOTED.
- C. BUILDING IDENTIFICATION SIGNAGE TO BE A MINIMUM OF 18" HIGH CHARACTERS WITH A MINIMUM OF 3" BRUSH STROKE WITH CONTRASTING ALUMINUM COLORS LIT FROM DUSK UNTIL DAWN AS WELL AS DAYLIGHT HOURS, PER 2009 IFC. MOUNT AT 15'-20' ABOVE FINISH FLOOR.
- D. ALL IDO REQUIREMENTS WILL BE MET PER SECTION 5-11(E)(2); REF: BUILDING FLOOR PLAN SHEETS FOR
- ADDITIONAL INFORMATION. E. ROOF DRAINAGE BY WAY OF EXTERNAL DOWNSPOUTS.

#### SHEET KEYNOTES (X)

- 1. FIELD COLOR NEUTRAL WARM WHITE STUCCO FINISH MATERIAL
- 2. ACCENT COLOR/MATERIAL #1 DARK MASONRY VENEER 3. ACCENT COLOR/MATERIAL #2 - DARK GRAY - ACCENT PANELIZED FIBER CEMENT BOARD
- 4. ACCENT COLOR #3 LIGHT GRAY ACCENT STUCCO FINISH 5. ACCENT COLOR #4 - RUST TONE - ACCENT STUCCO FINISH
- 6. ACCENT COLOR #5- BLUE TONE ACCENT STUCCO FINISH 7. NOT USED
- 8. ACCENT COLOR #7 YELLOW TONE ACCENT STUCCO FINISH 9. FIBER CEMENT BOARD FACIA - TO MATCH MASONRY VENEER
- 10. PREFINISHED METAL COPING COLOR TO MATCH ADJACENT MATERIAL OR STANDARD NEUTRAL COLOR
- 11. GUARDRAIL METAL CUSTOM FABRICATED
- 12. BUILDING IDENTIFICATION SIGNAGE FOR WAYFINDING
- 13. RESIDENTIAL WINDOWS (OPERABLE, LOW-E GLASS) FRAME COLOR: BLACK
- 14. WINDOW AWNING METAL CUSTOM FABRICATED
- 15. PATIO WALL CMU
- 16. GARAGE OVERHEAD DOOR
- 17. METAL UNIT ENTRY DOOR 18. METAL PATIO GATE
- 19. STEEL COLUMN PAINTED
- 20. STEEL DOWNSPOUT 21. EXTERIOR STEEL STAIR
- 22. PATIO DOOR WITH LIGHT 23. ALUMINUM STOREFRONT

STUCCO FINISH ACCENT COLOR/MATERIAL #1 - DARK ACCENT COLOR #6 - BURNT ORANGE MASONRY VENEER ACCENT STUCCO FINISH ACCENT COLOR/MATERIAL #2 - DARK GRAY ACCENT COLOR #4 - RUST ACCENT PANELIZED FIBER CEMENT BOARD ACCENT STUCCO FINISH ACCENT COLOR #5 - DUSTY BLUE ACCENT COLOR #3 - LIGHT GRAY

ACCENT STUCCO FINISH

FIELD COLOR - NEUTRAL WARM WHITE


ACCENT STUCCO FINISH

**LEGEND** 




DESIGN INSPIRATION

**KEY PLAN** 

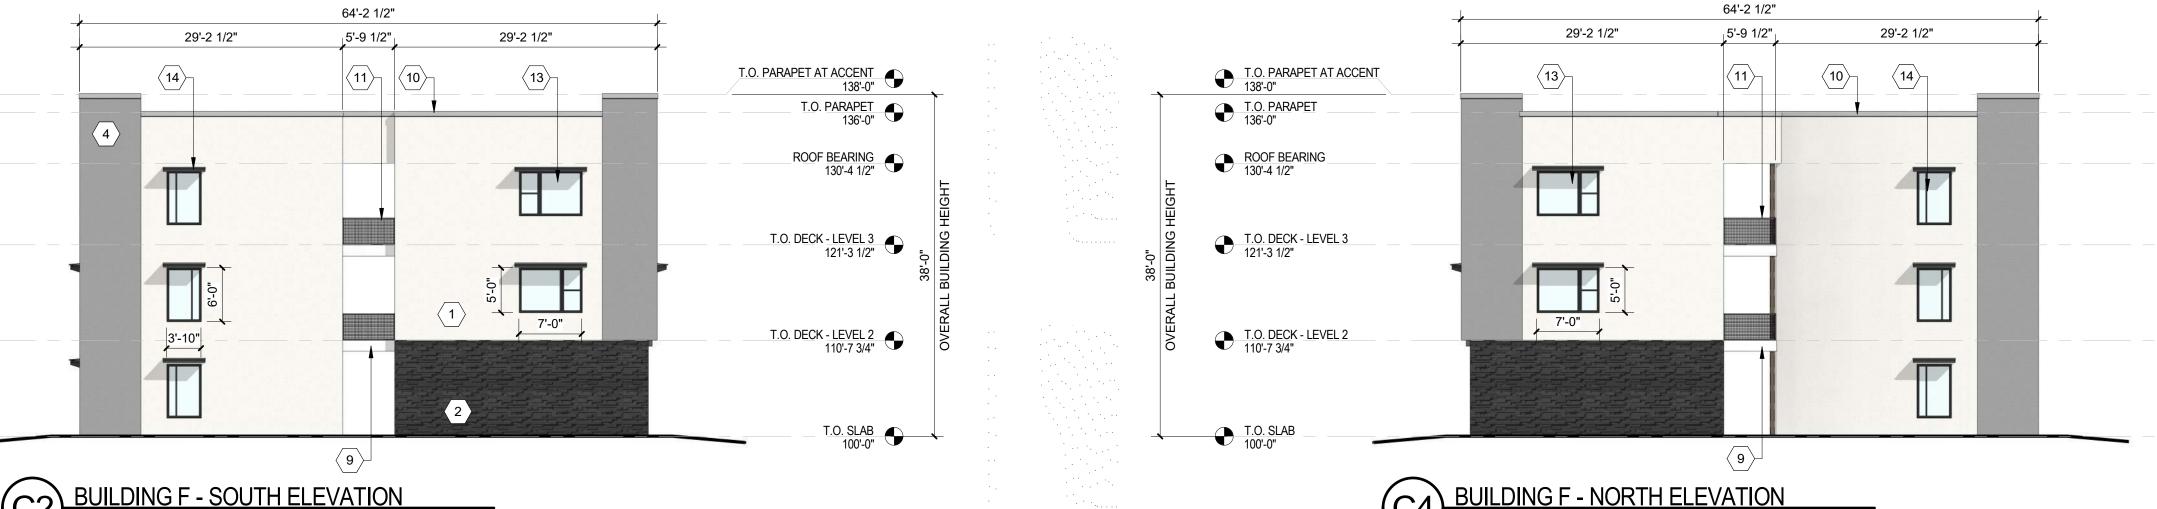

156'-2" 10'-3" 12'-7 1/2" 15'-4" 8'-5 1/2" 34'-9 1/2" 23'-2" 15'-2 1/2" 8'-5 1/2" 15'-2 1/2" 12'-8 1/2" (9)  $\langle 21 \rangle$  $\langle 13 \rangle \langle 12 \rangle$  $\langle 17 \rangle_{\Box}$  $\lceil \sqrt{12} \rangle$  $\langle 11 \rangle_{\Box}$ T.O. PARAPET AT ACCENT T.O. PARAPET 136'-0" ROOF BEARING 130'-4 1/2" T.O. DECK - LEVEL 3 121'-3 1/2" T.O. DECK - LEVEL 2 110'-7 3/4" T.O. SLAB 100'-0"

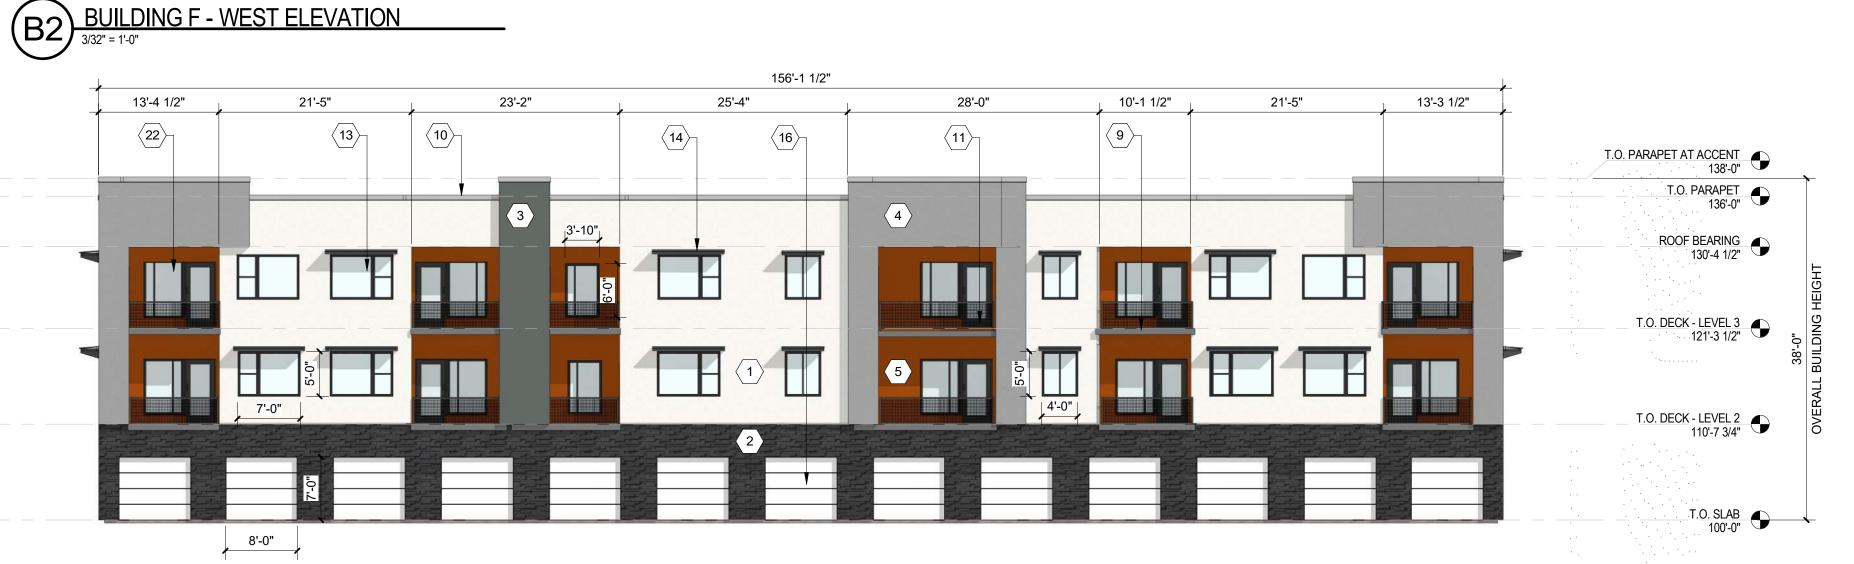



PROJECT

EAGLE RANC ALBUQUERQUE SEDON/

**DESIGN REVIEW** BOARD (DRB) MINOR SITE PLAN **AMENDMENT** 

REVISIONS DRAWN BY **REVIEWED BY** 

VM

HFG

10/12/2021

20-0286

DRAWING NAME

PROJECT NO:


EXTERIOR **ELEVATIONS -BUILDING F** 

SHEET NO SDP5.6


- A. ALL ROOF MOUNTED MECHANICAL EQUIPMENT SHALL BE SCREENED BY PARAPET WALL AND NOT BE VISIBLE WHEN VIEWED FROM 5' ABOVE GRADE AT ANY PROPERTY LINE.
- B. ALL DIMENSIONS SHOWN ARE TO OUTSIDE FACE OF FINISH UNLESS OTHERWISE NOTED.
- C. BUILDING IDENTIFICATION SIGNAGE TO BE A MINIMUM OF 18" HIGH CHARACTERS WITH A MINIMUM OF 3" BRUSH STROKE WITH CONTRASTING ALUMINUM COLORS LIT FROM DUSK UNTIL DAWN AS WELL AS DAYLIGHT HOURS, PER 2009 IFC. MOUNT AT 15'-20' ABOVE FINISH FLOOR.
- D. ALL IDO REQUIREMENTS WILL BE MET PER SECTION 5-11(E)(2); REF: BUILDING FLOOR PLAN SHEETS FOR
- ADDITIONAL INFORMATION. E. ROOF DRAINAGE BY WAY OF EXTERNAL DOWNSPOUTS.


#### SHEET KEYNOTES (X)

- 1. FIELD COLOR NEUTRAL WARM WHITE STUCCO FINISH MATERIAL
- 2. ACCENT COLOR/MATERIAL #1 DARK MASONRY VENEER 3. ACCENT COLOR/MATERIAL #2 - DARK GRAY - ACCENT PANELIZED FIBER CEMENT BOARD
- 4. ACCENT COLOR #3 LIGHT GRAY ACCENT STUCCO FINISH 5. ACCENT COLOR #4 - RUST TONE - ACCENT STUCCO FINISH 6. ACCENT COLOR #5- BLUE TONE - ACCENT STUCCO FINISH
- 7. NOT USED 8. ACCENT COLOR #7 - YELLOW TONE - ACCENT STUCCO FINISH
- 9. FIBER CEMENT BOARD FACIA TO MATCH MASONRY VENEER 10. PREFINISHED METAL COPING - COLOR TO MATCH ADJACENT MATERIAL OR STANDARD NEUTRAL COLOR
- 11. GUARDRAIL METAL CUSTOM FABRICATED
- 12. BUILDING IDENTIFICATION SIGNAGE FOR WAYFINDING 13. RESIDENTIAL WINDOWS (OPERABLE, LOW-E GLASS) - FRAME
- COLOR: BLACK 14. WINDOW AWNING - METAL CUSTOM FABRICATED
- 15. PATIO WALL CMU
- 16. GARAGE OVERHEAD DOOR 17. METAL UNIT ENTRY DOOR
- 18. METAL PATIO GATE
- 19. STEEL COLUMN PAINTED
- 21. EXTERIOR STEEL STAIR
- 22. PATIO DOOR WITH LIGHT 23. ALUMINUM STOREFRONT
- 20. STEEL DOWNSPOUT

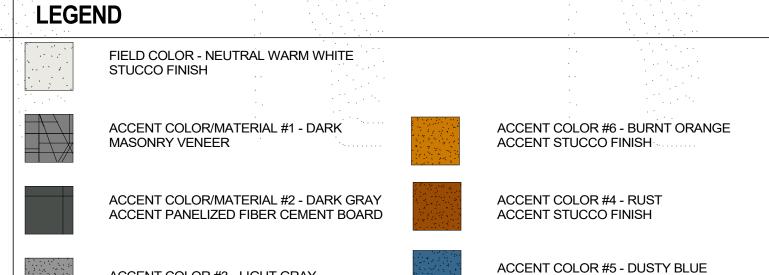


ACCENT STUCCO FINISH

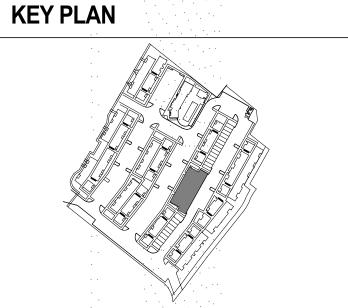

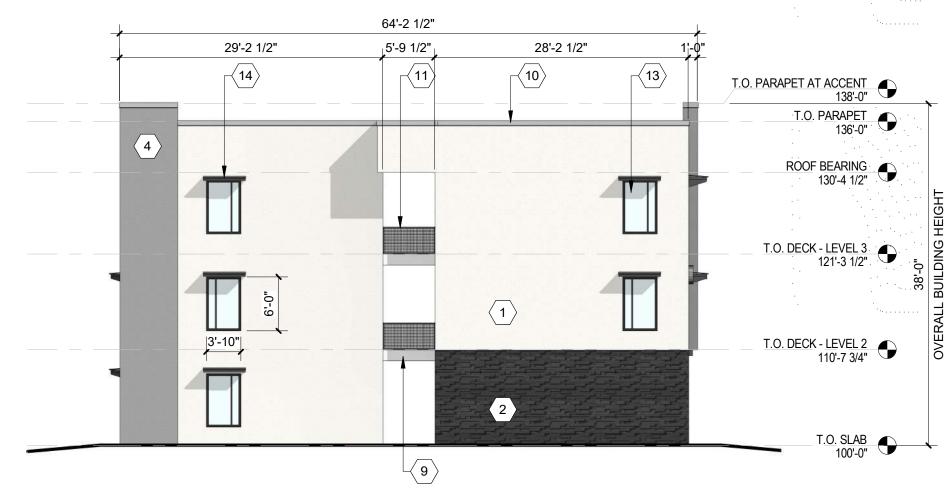

BUILDING G - SOUTH ELEVATION

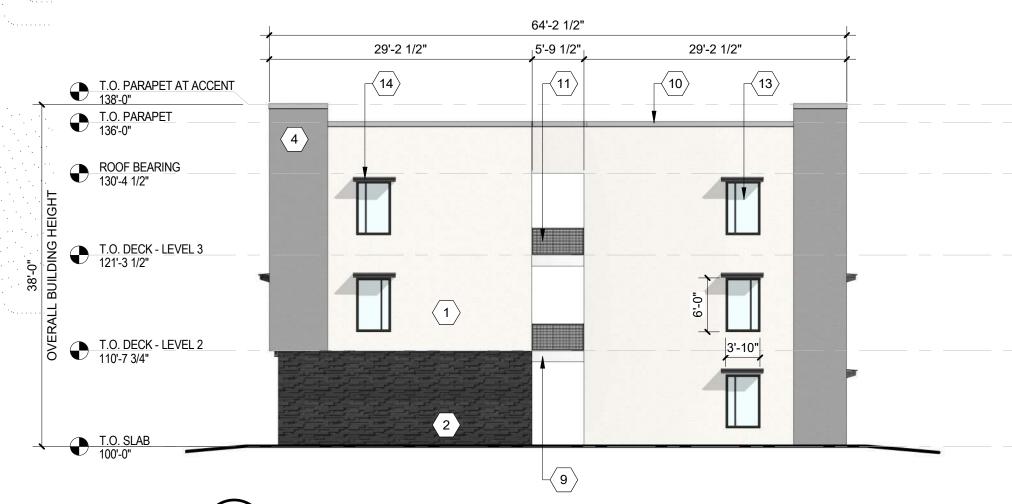

ACCENT COLOR #3 - LIGHT GRAY

ACCENT STUCCO FINISH

**BUILDING G - NORTH ELEVATION** 







PERICH SABATINI

ARCHITECTURE DESIGN INSPIRATION



PROJECT

EAGLE RANC ALBUQUERQUE

**DESIGN REVIEW** BOARD (DRB) MINOR SITE PLAN **AMENDMENT** 

REVISIONS DRAWN BY **REVIEWED BY** 10/12/2021 20-0286 PROJECT NO:

DRAWING NAME

EXTERIOR **ELEVATIONS -BUILDING G** 


SHEET NO


VM


- A. ALL ROOF MOUNTED MECHANICAL EQUIPMENT SHALL BE SCREENED BY PARAPET WALL AND NOT BE VISIBLE WHEN VIEWED FROM 5' ABOVE GRADE AT ANY PROPERTY LINE.
- B. ALL DIMENSIONS SHOWN ARE TO OUTSIDE FACE OF FINISH UNLESS OTHERWISE NOTED.
- C. BUILDING IDENTIFICATION SIGNAGE TO BE A MINIMUM OF 18" HIGH CHARACTERS WITH A MINIMUM OF 3" BRUSH STROKE WITH CONTRASTING ALUMINUM COLORS LIT FROM DUSK UNTIL DAWN AS WELL AS DAYLIGHT HOURS, PER 2009 IFC. MOUNT AT 15'-20' ABOVE FINISH FLOOR.
- D. ALL IDO REQUIREMENTS WILL BE MET PER SECTION 5-11(E)(2); REF: BUILDING FLOOR PLAN SHEETS FOR
- ADDITIONAL INFORMATION. E. ROOF DRAINAGE BY WAY OF EXTERNAL DOWNSPOUTS.

#### SHEET KEYNOTES (X)


- 1. FIELD COLOR NEUTRAL WARM WHITE STUCCO FINISH MATERIAL
- 2. ACCENT COLOR/MATERIAL #1 DARK MASONRY VENEER 3. ACCENT COLOR/MATERIAL #2 - DARK GRAY - ACCENT PANELIZED FIBER CEMENT BOARD
- 4. ACCENT COLOR #3 LIGHT GRAY ACCENT STUCCO FINISH 5. ACCENT COLOR #4 - RUST TONE - ACCENT STUCCO FINISH
- 6. ACCENT COLOR #5- BLUE TONE ACCENT STUCCO FINISH 7. NOT USED
- 8. ACCENT COLOR #7 YELLOW TONE ACCENT STUCCO FINISH 9. FIBER CEMENT BOARD FACIA - TO MATCH MASONRY VENEER
- 10. PREFINISHED METAL COPING COLOR TO MATCH ADJACENT MATERIAL OR STANDARD NEUTRAL COLOR
- 11. GUARDRAIL METAL CUSTOM FABRICATED
- 12. BUILDING IDENTIFICATION SIGNAGE FOR WAYFINDING
- 13. RESIDENTIAL WINDOWS (OPERABLE, LOW-E GLASS) FRAME COLOR: BLACK
- 14. WINDOW AWNING METAL CUSTOM FABRICATED
- 15. PATIO WALL CMU
- 16. GARAGE OVERHEAD DOOR
- 17. METAL UNIT ENTRY DOOR
- 18. METAL PATIO GATE 19. STEEL COLUMN PAINTED
- 20. STEEL DOWNSPOUT
- 21. EXTERIOR STEEL STAIR
- 22. PATIO DOOR WITH LIGHT 23. ALUMINUM STOREFRONT

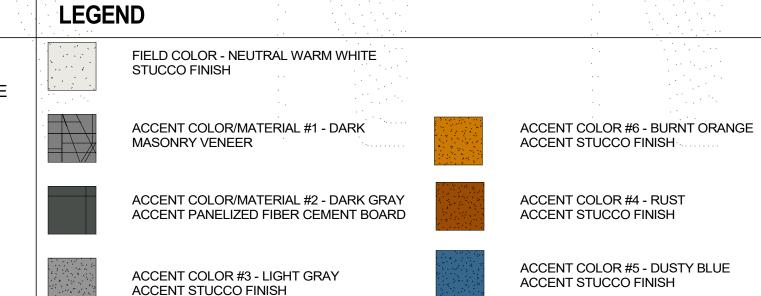

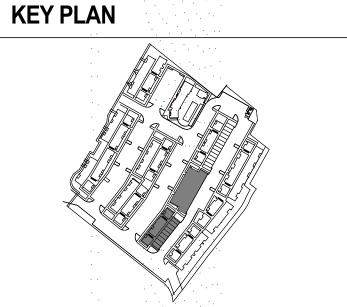


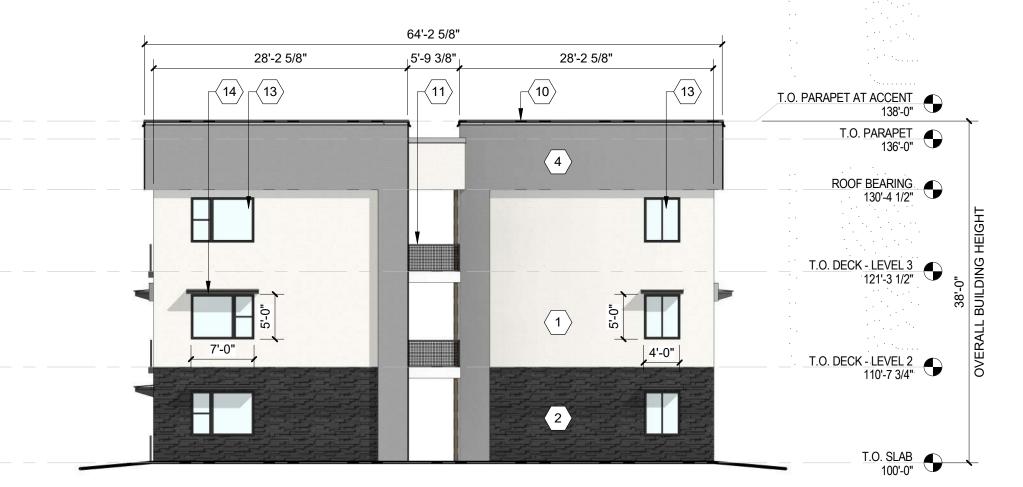

BUILDING H - SOUTH ELEVATION

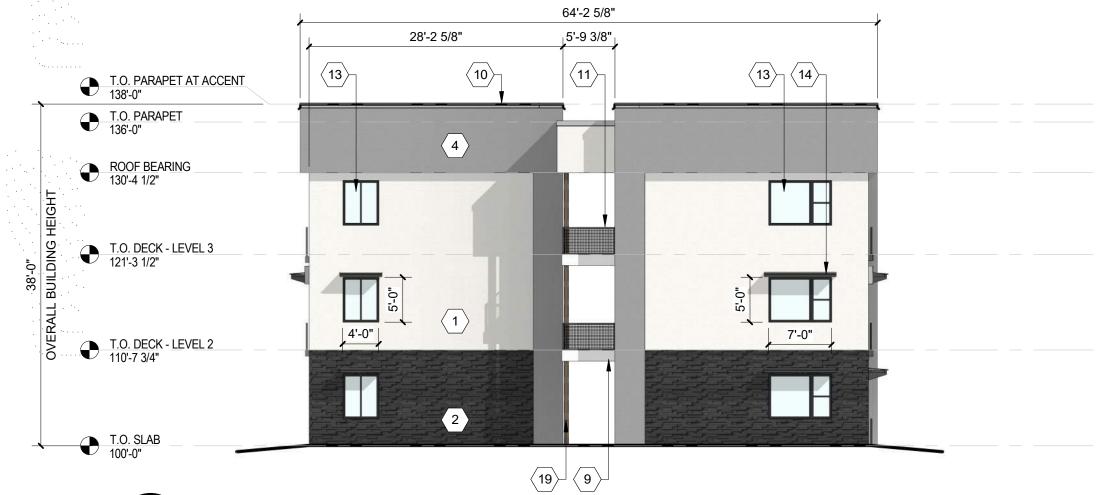

**BUILDING H - NORTH ELEVATION** 

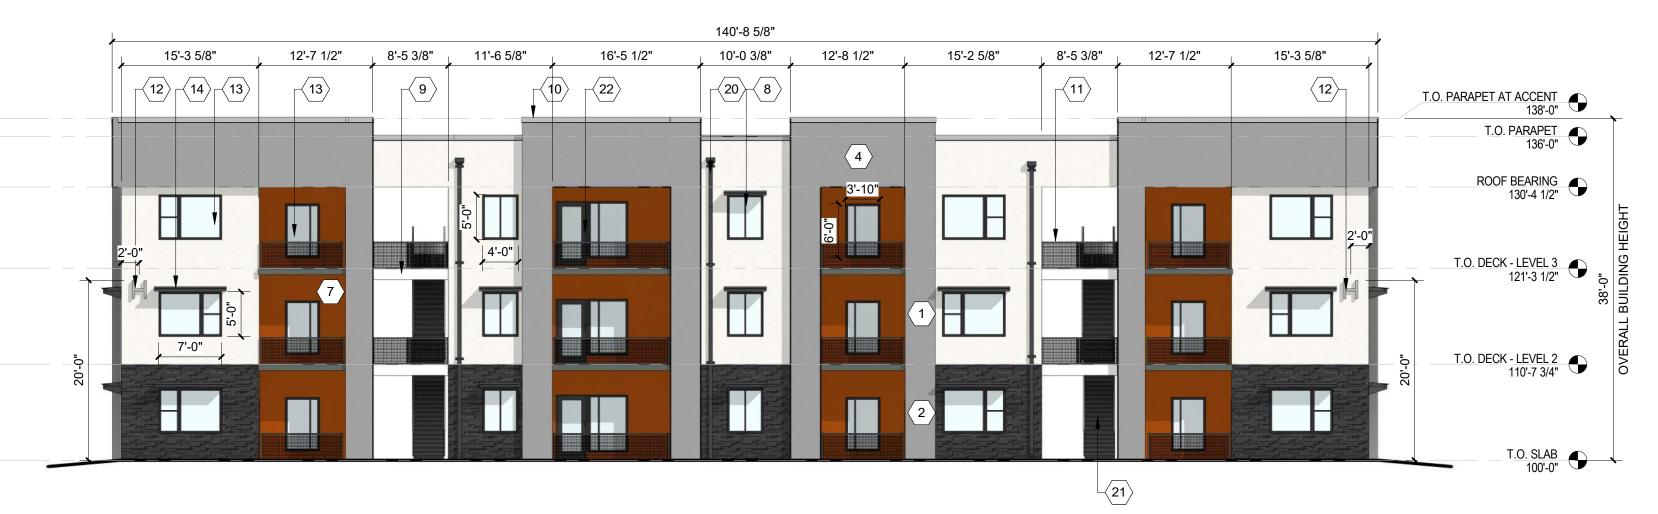


B2) BUILDING H WEST ELEVATION
3/32" = 1'-0"





PERICH SABATINI

ARCHITECTURE DESIGN INSPIRATION

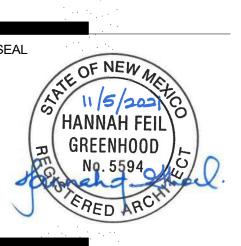

PROJECT

EAGLE RANG ALBUQUERQUI SEDON/

**DESIGN REVIEW** BOARD (DRB)
MINOR SITE PLAN **AMENDMENT** 

REVISIONS DRAWN BY Author **REVIEWED BY** Approver 10/12/2021 PROJECT NO: 20-0286

EXTERIOR **ELEVATIONS -BUILDING H** 


DRAWING NAME


SHEET NO SDP5.8


- A. ALL ROOF MOUNTED MECHANICAL EQUIPMENT SHALL BE SCREENED BY PARAPET WALL AND NOT BE VISIBLE WHEN VIEWED FROM 5' ABOVE GRADE AT ANY PROPERTY LINE.
- B. ALL DIMENSIONS SHOWN ARE TO OUTSIDE FACE OF FINISH UNLESS OTHERWISE NOTED.
- C. BUILDING IDENTIFICATION SIGNAGE TO BE A MINIMUM OF 18" HIGH CHARACTERS WITH A MINIMUM OF 3" BRUSH STROKE WITH CONTRASTING ALUMINUM COLORS LIT FROM DUSK UNTIL DAWN AS WELL AS DAYLIGHT HOURS, PER
- 2009 IFC. MOUNT AT 15'-20' ABOVE FINISH FLOOR. D. ALL IDO REQUIREMENTS WILL BE MET PER SECTION 5-11(E)(2); REF: BUILDING FLOOR PLAN SHEETS FOR
- ADDITIONAL INFORMATION. E. ROOF DRAINAGE BY WAY OF EXTERNAL DOWNSPOUTS.

#### SHEET KEYNOTES (X)

- 1. FIELD COLOR NEUTRAL WARM WHITE STUCCO FINISH MATERIAL
- 2. ACCENT COLOR/MATERIAL #1 DARK MASONRY VENEER 3. ACCENT COLOR/MATERIAL #2 - DARK GRAY - ACCENT PANELIZED FIBER CEMENT BOARD
- 4. ACCENT COLOR #3 LIGHT GRAY ACCENT STUCCO FINISH 5. ACCENT COLOR #4 - RUST TONE - ACCENT STUCCO FINISH
- 6. ACCENT COLOR #5- BLUE TONE ACCENT STUCCO FINISH 7. NOT USED
- 8. ACCENT COLOR #7 YELLOW TONE ACCENT STUCCO FINISH 9. FIBER CEMENT BOARD FACIA - TO MATCH MASONRY VENEER
- 10. PREFINISHED METAL COPING COLOR TO MATCH ADJACENT MATERIAL OR STANDARD NEUTRAL COLOR
- 11. GUARDRAIL METAL CUSTOM FABRICATED
- 12. BUILDING IDENTIFICATION SIGNAGE FOR WAYFINDING
- 13. RESIDENTIAL WINDOWS (OPERABLE, LOW-E GLASS) FRAME COLOR: BLACK
- 14. WINDOW AWNING METAL CUSTOM FABRICATED
- 15. PATIO WALL CMU
- 16. GARAGE OVERHEAD DOOR
- 17. METAL UNIT ENTRY DOOR
- 18. METAL PATIO GATE 19. STEEL COLUMN PAINTED
- 20. STEEL DOWNSPOUT
- 21. EXTERIOR STEEL STAIR
- 22. PATIO DOOR WITH LIGHT 23. ALUMINUM STOREFRONT

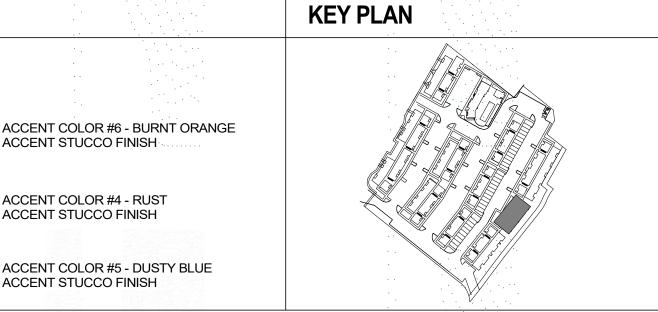

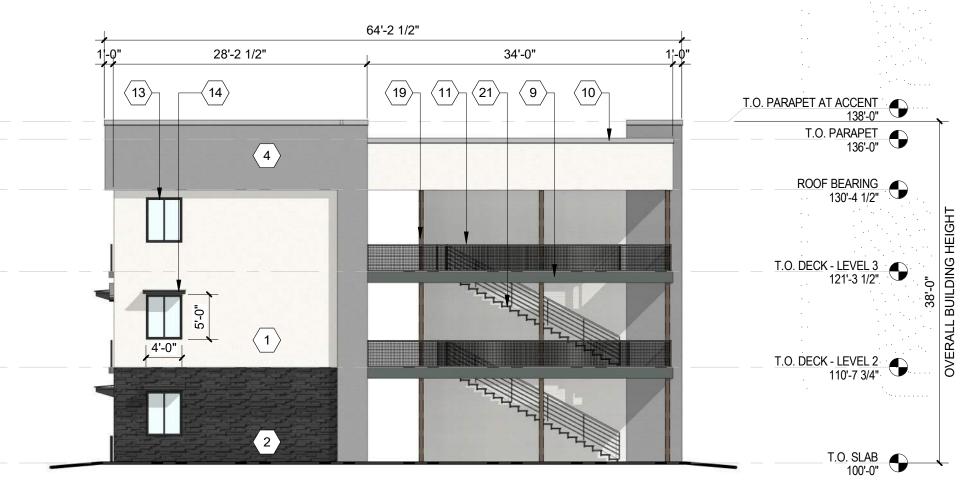

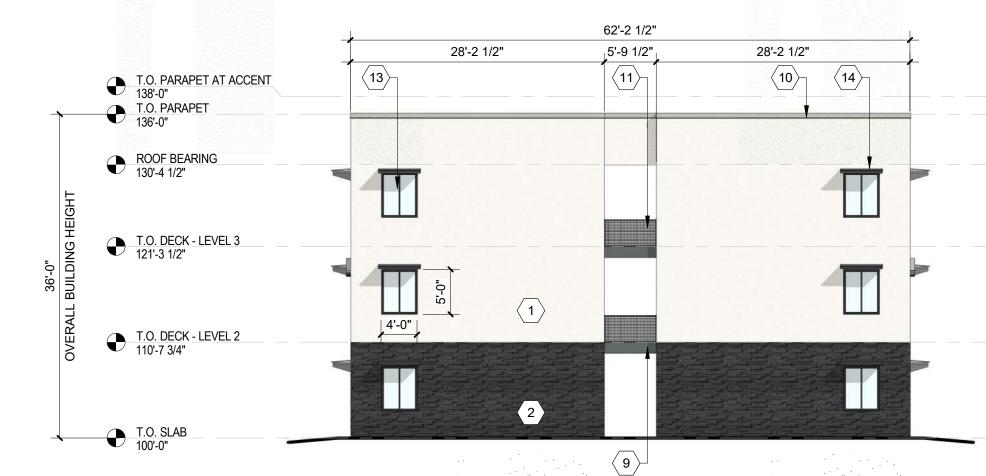

**LEGEND** 

FIELD COLOR - NEUTRAL WARM WHITE

ACCENT COLOR/MATERIAL #1 - DARK

ACCENT COLOR #3 - LIGHT GRAY


ACCENT STUCCO FINISH


ACCENT COLOR/MATERIAL #2 - DARK GRAY


ACCENT PANELIZED FIBER CEMENT BOARD

STUCCO FINISH

MASONRY VENEER

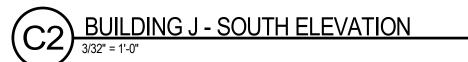

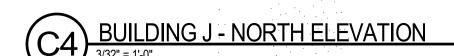

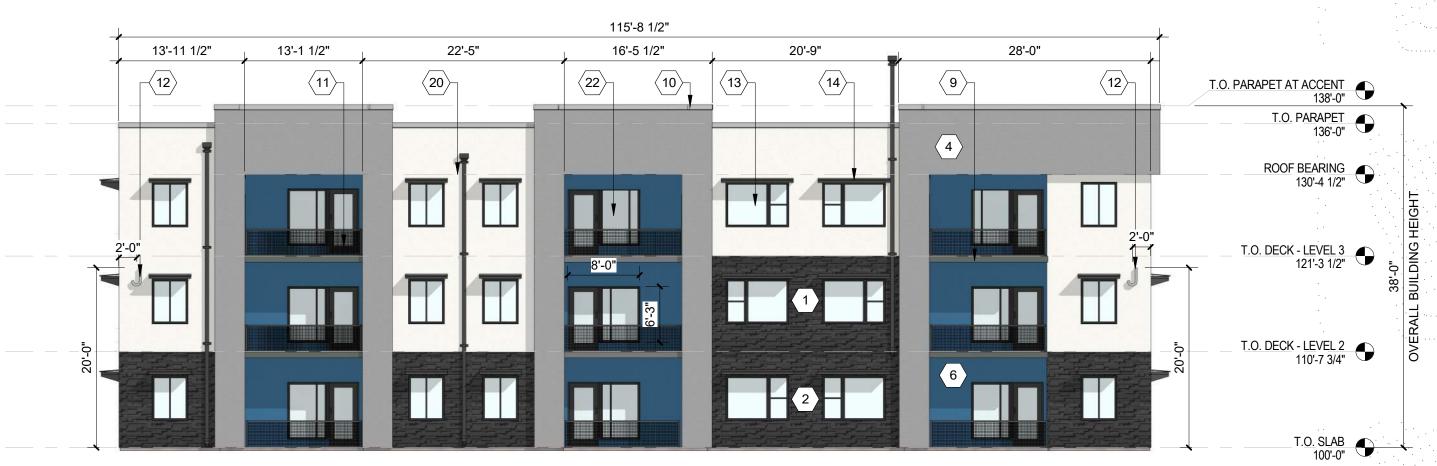

B2 BUILDING J - WEST ELEVATION

3/32" = 1'-0"



BUILDING J - EAST ELEVATION

3/32" = 1'-0"

PERICH SABATINI

ARCHITECTURE DESIGN INSPIRATION



PROJECT

EAGLE RANG ALBUQUERQUI SEDON/

**DESIGN REVIEW** BOARD (DRB) MINOR SITE PLAN **AMENDMENT** 

REVISIONS DRAWN BY **REVIEWED BY** 10/12/2021 PROJECT NO:

DRAWING NAME

EXTERIOR **ELEVATIONS -BUILDING J** 

SHEET NO

**SDP5.9** 


VM, JF


20-0286

- A. ALL ROOF MOUNTED MECHANICAL EQUIPMENT SHALL BE SCREENED BY PARAPET WALL AND NOT BE VISIBLE WHEN VIEWED FROM 5' ABOVE GRADE AT ANY PROPERTY LINE.
- B. ALL DIMENSIONS SHOWN ARE TO OUTSIDE FACE OF FINISH UNLESS OTHERWISE NOTED.
- C. BUILDING IDENTIFICATION SIGNAGE TO BE A MINIMUM OF 18" HIGH CHARACTERS WITH A MINIMUM OF 3" BRUSH STROKE WITH CONTRASTING ALUMINUM COLORS LIT FROM DUSK UNTIL DAWN AS WELL AS DAYLIGHT HOURS, PER
- 2009 IFC. MOUNT AT 15'-20' ABOVE FINISH FLOOR. D. ALL IDO REQUIREMENTS WILL BE MET PER SECTION
- 5-11(E)(2); REF: BUILDING FLOOR PLAN SHEETS FOR
- ADDITIONAL INFORMATION. E. ROOF DRAINAGE BY WAY OF EXTERNAL DOWNSPOUTS.

#### SHEET KEYNOTES (X)

- 1. FIELD COLOR NEUTRAL WARM WHITE STUCCO FINISH MATERIAL
- 2. ACCENT COLOR/MATERIAL #1 DARK MASONRY VENEER 3. ACCENT COLOR/MATERIAL #2 - DARK GRAY - ACCENT PANELIZED
- FIBER CEMENT BOARD 4. ACCENT COLOR #3 - LIGHT GRAY - ACCENT STUCCO FINISH
- 5. ACCENT COLOR #4 RUST TONE ACCENT STUCCO FINISH 6. ACCENT COLOR #5- BLUE TONE - ACCENT STUCCO FINISH
- 7. NOT USED 8. ACCENT COLOR #7 - YELLOW TONE - ACCENT STUCCO FINISH
- 10. PREFINISHED METAL COPING COLOR TO MATCH ADJACENT MATERIAL OR STANDARD NEUTRAL COLOR
- 9. FIBER CEMENT BOARD FACIA TO MATCH MASONRY VENEER 20. STEEL DOWNSPOUT
- 11. GUARDRAIL METAL CUSTOM FABRICATED
- 12. BUILDING IDENTIFICATION SIGNAGE FOR WAYFINDING 13. RESIDENTIAL WINDOWS (OPERABLE, LOW-E GLASS) - FRAME
- COLOR: BLACK 14. WINDOW AWNING - METAL CUSTOM FABRICATED
- 15. PATIO WALL CMU
- 16. GARAGE OVERHEAD DOOR 17. METAL UNIT ENTRY DOOR
- 18. METAL PATIO GATE
- 19. STEEL COLUMN PAINTED
  - 22. PATIO DOOR WITH LIGHT
  - 21. EXTERIOR STEEL STAIR 23. ALUMINUM STOREFRONT

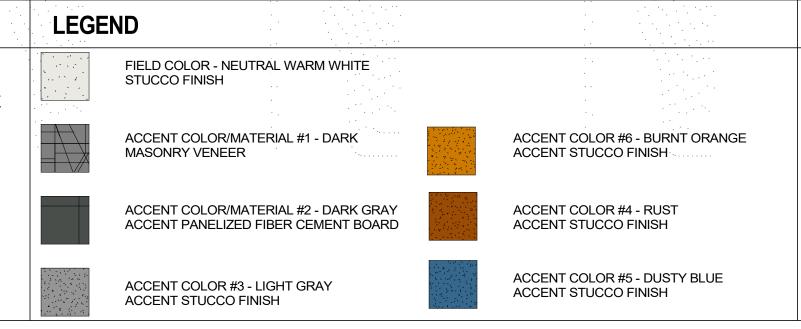

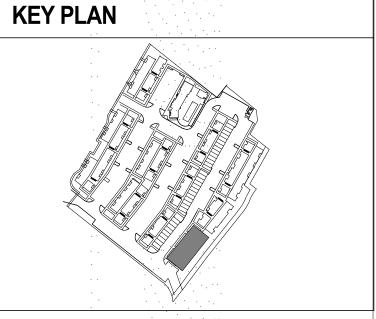

64'-2 1/2" 28'-2 1/2" 5'-9 1/2" 28'-2 1/2"  $\langle 11 \rangle$ T.O. PARAPET AT ACCENT 138'-0" T.O. PARAPET 136'-0" ROOF BEARING 130'-4 1/2" T.O. DECK - LEVEL 3 121'-3 1/2" T.O. DECK - LEVEL 2 T.O. SLAB 100'-0"

64'-2 1/2" 28'-2 1/2" <sub>1</sub>5'-9 1/2"<sub>1</sub> 28'-2 1/2" **10** T.O. PARAPET AT ACCENT 138'-0" T.O. PARAPET 136'-0" ROOF BEARING 130'-4 1/2" T.O. DECK - LEVEL 3 121'-3 1/2" 4'-0" T.O. DECK - LEVEL 2 110'-7 3/4" 9

BUILDING K - NORTH ELEVATION





**BUILDING K - WEST ELEVATION** 




BUILDING K - EAST ELEVATION

3/32" = 1'-0"

PERICH SABATINI

ARCHITECTURE DESIGN INSPIRATION

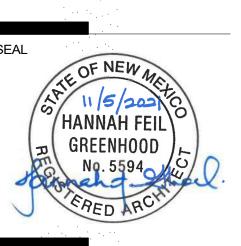

PROJECT

EAGLE RAN SEDON/

**DESIGN REVIEW** BOARD (DRB) MINOR SITE PLAN **AMENDMENT** 

REVISIONS DRAWN BY **REVIEWED BY** 10/12/2021

VM


20-0286

DRAWING NAME EXTERIOR **ELEVATIONS -**

PROJECT NO:

SHEET NO SDP5.10


**BUILDING K** 

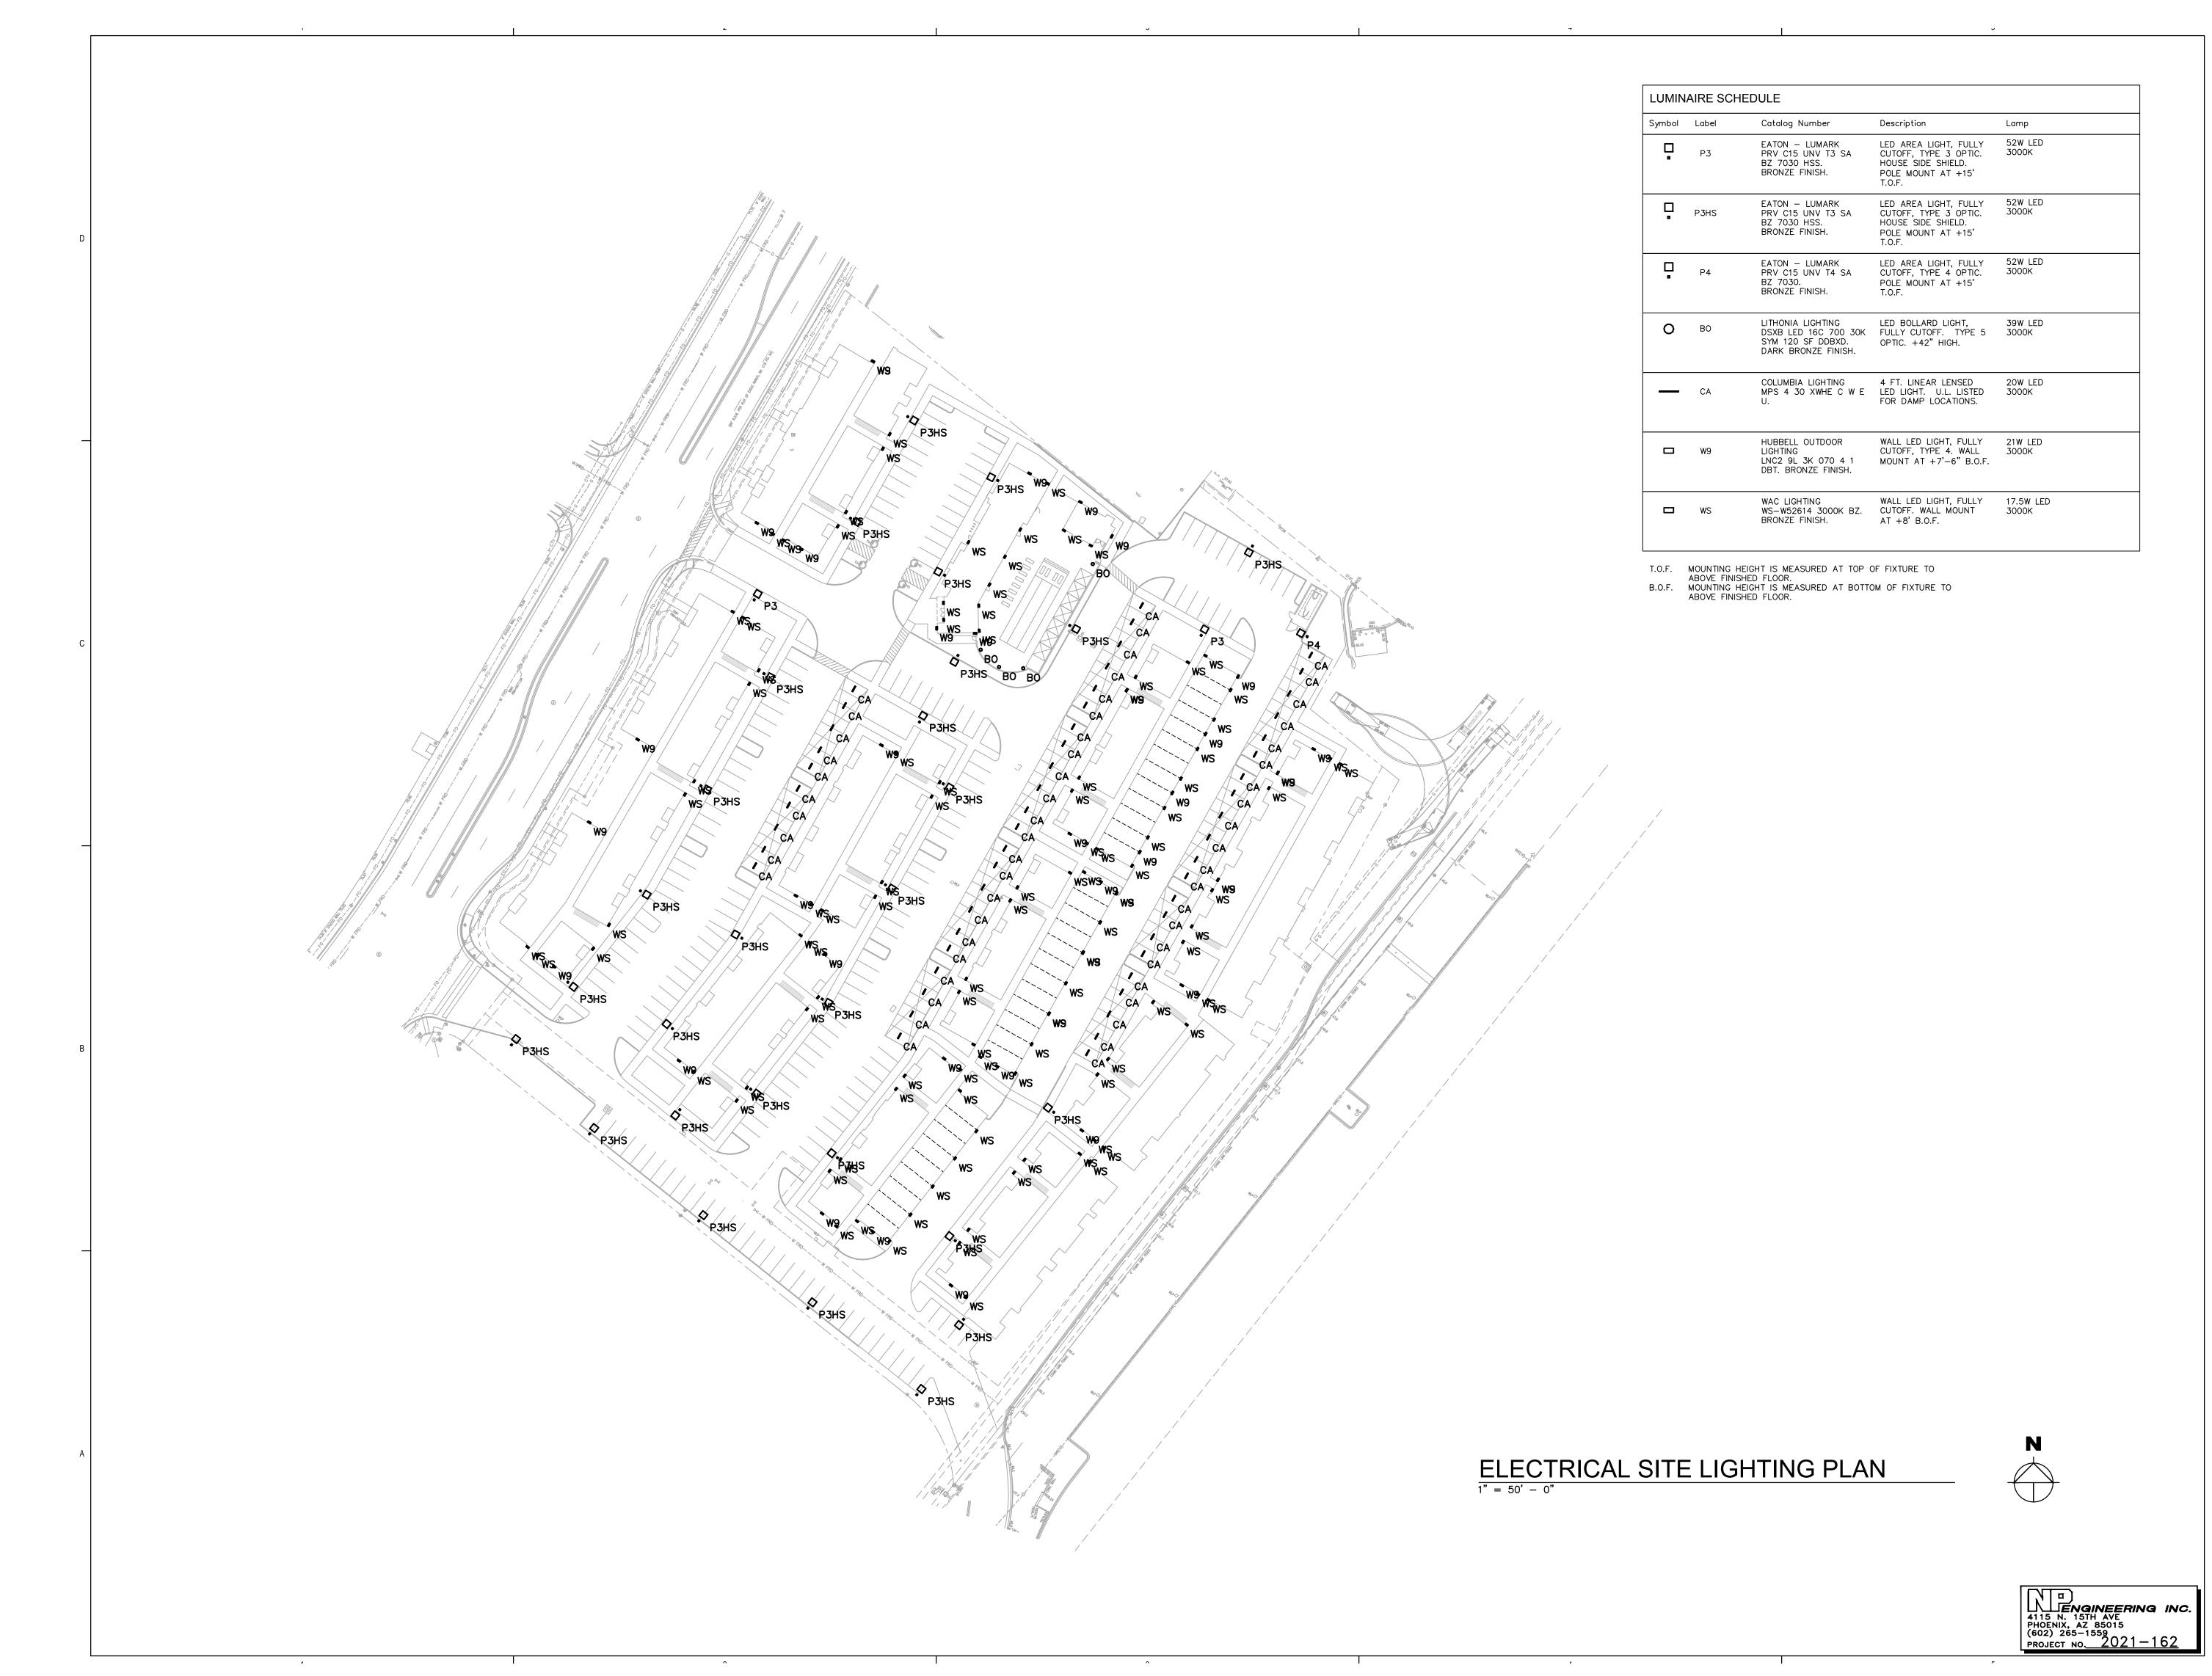

# DEKKER PERICH SABATINI

ARCHITECTURE DESIGN INSPIRATION

ARCHITECT

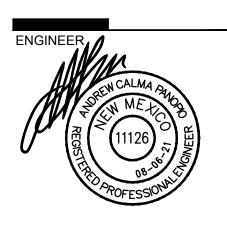

PROJECT

SEDONA WES I EAGLE RANCH ROAD LBUQUERQUE, NM 87114

#### SITE DEVELOPMENT PLAN

DRAWN BY
REVIEWED BY

DATE 04/16/2021
PROJECT NO 10.0050

PROJECT NO.

DRAWING NAME

ELECTRICAL SITE LIGHTING PLAN

SHEET NO.

E

|    |  | Symbol Label Qty Catalog Number Description  |
|----|--|--|
|    |  | P3 2 PRV C15 UNV T3 SA CUTOFF, TYPE 3 OPTIC<br>BZ 7030 HSS. HOUSE SIDE SHIELD.<br>BRONZE FINISH. POLE MOUNT AT +15'<br>T.O.F.  |
| D  |  | P3HS 28 PRV C15 UNV T3 SA CUTOFF, TYPE 3 OPTION BZ 7030 HSS. HOUSE SIDE SHIELD. BRONZE FINISH. POLE MOUNT AT +15' T.O.F.   |
|    |  | P4 1 PRV C15 UNV T4 SA CUTOFF, TYPE 4 OPTIC<br>BZ 7030. POLE MOUNT AT +15'<br>BRONZE FINISH. T.O.F.  |
|    | 76,06.1 0.2 0.0 0.0 0.0 0.2 0.3 0.0 0.0 0.0 0.0 0.0 0.0 0.0 0.0 0.0  | O BO 4 LITHONIA LIGHTING LED BOLLARD LIGHT, DSXB LED 16C 700 30K FULLY CUTOFF. TYPE SYM 120 SF DDBXD. OPTIC. +42" HIGH. DARK BRONZE FINISH.  |
|    | \$\begin{align*} \begin{align*} \begi  | COLUMBIA LIGHTING 4 FT. LINEAR LENSED  CA 53 MPS 4 30 XWHE C W E LED LIGHT. U.L. LISTE  U. FOR DAMP LOCATIONS  |
| -  | $\begin{array}{c ccccccccccccccccccccccccccccccccccc$  | HUBBELL OUTDOOR WALL LED LIGHT, FULL CUTOFF, TYPE 4. WALL CUTOFF, TYPE 4. |
|    | 0.00.0<br>0.00.1<br>0.00.4<br>0.00.4<br>0.00.0<br>0.00.0<br>0.00.0<br>0.00.0<br>0.00.0<br>0.00.0<br>0.00.0<br>0.00.0<br>0.00.0<br>0.00.0<br>0.00.0<br>0.00.0<br>0.00.0<br>0.00.0<br>0.00.0<br>0.00.0<br>0.00.0<br>0.00.0<br>0.00.0<br>0.00.0<br>0.00.0<br>0.00.0<br>0.00.0<br>0.00.0<br>0.00.0<br>0.00.0<br>0.00.0<br>0.00.0<br>0.00.0<br>0.00.0<br>0.00.0<br>0.00.0<br>0.00.0<br>0.00.0<br>0.00.0<br>0.00.0<br>0.00.0<br>0.00.0<br>0.00.0<br>0.00.0<br>0.00.0<br>0.00.0<br>0.00.0<br>0.00.0<br>0.00.0<br>0.00.0<br>0.00.0<br>0.00.0<br>0.00.0<br>0.00.0<br>0.00.0<br>0.00.0<br>0.00.0<br>0.00.0<br>0.00.0<br>0.00.0<br>0.00.0<br>0.00.0<br>0.00.0<br>0.00.0<br>0.00.0<br>0.00.0<br>0.00.0<br>0.00.0<br>0.00.0<br>0.00.0<br>0.00.0<br>0.00.0<br>0.00.0<br>0.00.0<br>0.00.0<br>0.00.0<br>0.00.0<br>0.00.0<br>0.00.0<br>0.00.0<br>0.00.0<br>0.00.0<br>0.00.0<br>0.00.0<br>0.00.0<br>0.00.0<br>0.00.0<br>0.00.0<br>0.00.0<br>0.00.0<br>0.00.0<br>0.00.0<br>0.00.0<br>0.00.0<br>0.00.0<br>0.00.0<br>0.00.0<br>0.00.0<br>0.00.0<br>0.00.0<br>0.00.0<br>0.00.0<br>0.00.0<br>0.00.0<br>0.00.0<br>0.00.0<br>0.00.0<br>0.00.0<br>0.00.0<br>0.00.0<br>0.00.0<br>0.00.0<br>0.00.0<br>0.00.0<br>0.00.0<br>0.00.0<br>0.00.0<br>0.00.0<br>0.00.0<br>0.00.0<br>0.00.0<br>0.00.0<br>0.00.0<br>0.00.0<br>0.00.0<br>0.00.0<br>0.00.0<br>0.00.0<br>0.00.0<br>0.00.0<br>0.00.0<br>0.00.0<br>0.00.0<br>0.00.0<br>0.00.0<br>0.00.0<br>0.00.0<br>0.00.0<br>0.00.0<br>0.00.0<br>0.00.0<br>0.00.0<br>0.00.0<br>0.00.0<br>0.00.0<br>0.00.0<br>0.00.0<br>0.00.0<br>0.00.0<br>0.00.0<br>0.00.0<br>0.00.0<br>0.00.0<br>0.00.0<br>0.00.0<br>0.00.0<br>0.00.0<br>0.00.0<br>0.00.0<br>0.00.0<br>0.00.0<br>0.00.0<br>0.00.0<br>0.00.0<br>0.00.0<br>0.00.0<br>0.00.0<br>0.00.0<br>0.00.0<br>0.00.0<br>0.00.0<br>0.00.0<br>0.00.0<br>0.00.0<br>0.00.0<br>0.00.0<br>0.00.0<br>0.00.0<br>0.00.0<br>0.00.0<br>0.00.0<br>0.00.0<br>0.00.0<br>0.00.0<br>0.00.0<br>0.00.0<br>0.00.0<br>0.00.0<br>0.00.0<br>0.00.0<br>0.00.0<br>0.00.0<br>0.00.0<br>0.00.0<br>0.00.0<br>0.00.0<br>0.00.0<br>0.00.0<br>0.00.0<br>0.00.0<br>0.00.0<br>0.00.0<br>0.00.0<br>0.00.0<br>0.00.0<br>0.00.0<br>0.00.0<br>0.00.0<br>0.00.0<br>0.00.0<br>0.00.0<br>0.00.0<br>0.00.0<br>0.00.0<br>0.00.0<br>0.00.0<br>0.00.0<br>0.00.0<br>0.00.0<br>0.00.0<br>0.00.0<br>0.00.0<br>0.00.0<br>0.00.0<br>0.00.0<br>0.00.0<br>0.00.0<br>0.00.0<br>0.00.0<br>0.00.0<br>0.00.0<br>0.00.0<br>0.00.0<br>0.00.0<br>0.00.0<br>0.00.0<br>0.00.0<br>0.00.0<br>0.00.0<br>0.00.0<br>0.00.0<br>0.00.0<br>0.00.0<br>0.00.0<br>0.00.0<br>0.00.0<br>0.00.0<br>0.00.0<br>0.00.0<br>0.00.0<br>0.00.0<br>0.00.0<br>0.00.0<br>0.00.0<br>0.00.0<br>0.00.0 | WAC LIGHTING WALL LED LIGHT, FULL  WS 108 WS-W52614 3000K BZ. CUTOFF. WALL MOUNT BRONZE FINISH. AT +8' B.O.F.  |
|    | 10 10 10 10 10 10 10 10 10 10 10 10 10 1   | T.O.F. MOUNTING HEIGHT IS MEASURED AT TOP OF FIXTURE TO ABOVE FINISHED FLOOR.  B.O.F. MOUNTING HEIGHT IS MEASURED AT BOTTOM OF FIXTURE TO ABOVE FINISHED FLOOR.  |
| С  | \$\\ \begin{array}{cccccccccccccccccccccccccccccccccccc  | STATISTICS   |
|    | 3.2 \\ \frac{1.1}{5.5} \\ \frac{1.5}{5.5} \\  | Description Symbol Avg Max M SITE CALCS + 2.0 fc 37.6 fc 0.  |
|    | 7.5 4.8 4.6 b.7 b.3 b.4 2.7 6.8 b.5 b.4 b.4 b.5 b.4 b.4 b.8 2.1 b.6 b.5 b.4 b.8 2.1 b.8 b.5 b.8 b.5 b.4 b.8 2.1 b.8 b.5 b.8 b.5 b.4 b.8 2.1 b.8 b.5 b.8 b.8 b.5 b.8 b.8 b.5 b.8  | SPILL LIGHT AT +6 FT. ABOVE PROPERTY LINE  ** 2.5 fc   |
|    | 70 00 27 W9 0.8 7.1 1.0 0.6 0.3 0.4 2.6 0.5 0.1 W9 1.1 1.0 0.6 0.3 0.4 2.6 0.5 0.1 W9 1.1 1.0 0.6 0.3 0.4 2.5 0.6 0.1 WS 1.1 1.0 0.6 0.3 0.4 2.5 0.6 0.7 1.2 W9 2.4 1.7 1.7 1.7 1.0 0.5 0.5 0.3 0.7 1.8 0.5 0.7 1.1 1.1 1.8 2.5 0.5 0.7 1.2 W9 2.4 1.1 1.1 1.1 1.1 1.1 1.1 1.1 1.1 1.1 1   | /  |
|    | \$\( \) \\ \\ \\ \\ \\ \\ \\ \\ \\ \\ \\ \\  |  |
|    | 15 1.3 1.5 1.3 1.5 1.3 1.5 1.5 1.3 1.5 1.5 1.5 1.5 1.5 1.5 1.5 1.5 1.5 1.5   |  |
|    | 0.8 1.4 1.5 0.7 0.4 0.5 2.6 0.3 0.5 3.5 0.6 0.3 0.5 3.5 0.6 0.3 0.5 3.5 0.6 0.3 0.5 0.0 0.0 0.0 0.0 0.0 0.0 0.0 0.0 0.0  |  |
|    | \$5 P3H3   |  |
|    | 10.00 0.1 0.2 1.8 WS 1.8 1.3 1.7 0.5 0.5 0.7 1.5 2.6 32 WS 1.8 1.3 1.5 0.6 0.3 0.4 2.8 0.6 0.1 1.7 1.5 0.6 0.3 0.8 0.8 0.8 0.1 1.7 1.5 0.6 0.3 0.8 0.8 0.8 0.8 0.8 0.8 0.8 0.8 0.8 0.8   |  |
|    | ## 122 120 10 10 10 10 10 10 10 10 10 10 10 10 10  |  |
| D. | 1.2 1.5 1.8 2.2 2.6 1.0 0.7 0.5 0.8 1.8 2.2 1.9 1.4 0.6 0.5 0.7 1.6 3.0 2.2 0.9 0.0 0.0 0.0 0.0 0.0 0.0 0.0 0.0 0.0  |  |
| В  | $\begin{array}{cccccccccccccccccccccccccccccccccccc$   |  |
|    | ## 1 1 1 2 1 2 1 2 1 2 1 3 1 3 2 0 3 1 1 1 1 1 2 9 0 0 5 1 1 1 1 2 1 2 1 2 1 3 1 3 2 0 3 1 1 1 1 1 1 2 9 0 0 5 1 1 1 1 1 2 9 0 0 5 1 1 1 1 1 2 9 0 0 5 1 1 1 1 1 1 2 9 0 0 5 1 1 1 1 1 1 1 1 1 1 1 1 1 1 1 1 1   |  |
|    | 0.5, 2.31, 1.5 1.4 2.4 2.5 3.1 1.7 1.9 1.5 0.5 0.5 0.5 0.5 0.5 0.5 0.5 0.5 0.5 0   |  |
|    | 0.2 b.1 b.8 b.8 b.1 b.5  |  |
|    | 5.2 3.0 5.1 5.3 5.8 5.8 5.8 5.8 5.8 5.8 5.8 5.8 5.8 5.8  |  |
|    | 7.2 to 8 to 8 to 9 to 9 to 8 to 8 to 9 to 9  |  |
|    | **************************************   |  |
|    | 0.5  |  |
|    |  |  |
|    | $\begin{array}{c} 0.1 & 2.7 & 1.4 & 0.8 & 0.5 & 0.3 & 1.4 \\ 0.0 & 0.7 & 0.4 & 0.4 & 0.1 \\ 0.0 & 0.4 & 0.2 & 0.6 \end{array}$   |  |
| A  | ELECTRIC 1" = 50' - 0"   | AL SITE PHOTOMETRIC PLAN   |
|    |  |  |
|    |  |  |
|    |  |  |


| Symbol | Label | Qty | Catalog Number  | Description  | Lamp               | Lumens   | LLF  |
|--------|-------|-----|---|--|--------------------|----------|------|
|        | Р3    | 2   | EATON — LUMARK<br>PRV C15 UNV T3 SA<br>BZ 7030 HSS.<br>BRONZE FINISH.                 | LED AREA LIGHT, FULLY CUTOFF, TYPE 3 OPTIC. HOUSE SIDE SHIELD. POLE MOUNT AT +15' T.O.F. | 52W LED<br>3000K   | Absolute | 0.88 |
|        | P3HS  | 28  | EATON — LUMARK<br>PRV C15 UNV T3 SA<br>BZ 7030 HSS.<br>BRONZE FINISH.                 | LED AREA LIGHT, FULLY CUTOFF, TYPE 3 OPTIC. HOUSE SIDE SHIELD. POLE MOUNT AT +15' T.O.F. | 52W LED<br>3000K   | Absolute | 0.88 |
|        | P4    | 1   | EATON — LUMARK<br>PRV C15 UNV T4 SA<br>BZ 7030.<br>BRONZE FINISH.                     | LED AREA LIGHT, FULLY CUTOFF, TYPE 4 OPTIC. POLE MOUNT AT +15' T.O.F.                    | 52W LED<br>3000K   | Absolute | 0.88 |
| 0      | ВО    | 4   | LITHONIA LIGHTING<br>DSXB LED 16C 700 30K<br>SYM 120 SF DDBXD.<br>DARK BRONZE FINISH. | LED BOLLARD LIGHT,<br>FULLY CUTOFF. TYPE 5<br>OPTIC. +42" HIGH.                          | 39W LED<br>3000K   | Absolute | 0.95 |
| _      | CA    | 53  | COLUMBIA LIGHTING<br>MPS 4 30 XWHE C W E<br>U.  | 4 FT. LINEAR LENSED<br>LED LIGHT. U.L. LISTED<br>FOR DAMP LOCATIONS.                     | 20W LED<br>3000K   | Absolute | 0.90 |
|        | W9    | 35  | HUBBELL OUTDOOR<br>LIGHTING<br>LNC2 9L 3K 070 4 1<br>DBT. BRONZE FINISH.              | WALL LED LIGHT, FULLY<br>CUTOFF, TYPE 4. WALL<br>MOUNT AT +7'-6" B.O.F.                  | 21W LED<br>3000K   | Absolute | 0.90 |
|        | WS    | 108 | WAC LIGHTING<br>WS-W52614 3000K BZ.<br>BRONZE FINISH.                                 | WALL LED LIGHT, FULLY CUTOFF. WALL MOUNT AT +8' B.O.F.                                   | 17.5W LED<br>3000K | 1255     | 0.95 |

| STATISTICS                                   |        |        |         |        |         |         |
|--|--------|--------|---------|--------|---------|---------|
| Description                                  | Symbol | Avg    | Max     | Min    | Max/Min | Avg/Min |
| SITE CALCS                                   | +      | 2.0 fc | 37.6 fc | 0.0 fc | N/A     | N/A     |
| SPILL LIGHT AT +6 FT.<br>ABOVE PROPERTY LINE | *      | 0.1 fc | 0.7 fc  | 0.0 fc | N/A     | N/A     |

PERICH SABATINI ARCHITECTURE

DEKKER

DESIGN INSPIRATION

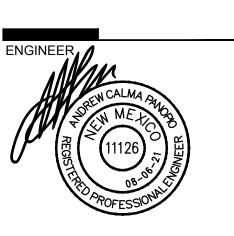

PROJECT

SITE DEVELOPMENT PLAN

REVISIONS

DRAWN BY REVIEWED BY DATE

04/16/2021 PROJECT NO. DRAWING NAME


ELECTRICAL SITE PHOTOMETRIC PLAN


SHEET NO.

19-0058

ENGINEERING INC.
4115 N. 15TH AVE
PHOENIX, AZ 85015
(602) 265-1559
PROJECT NO. 2021-162



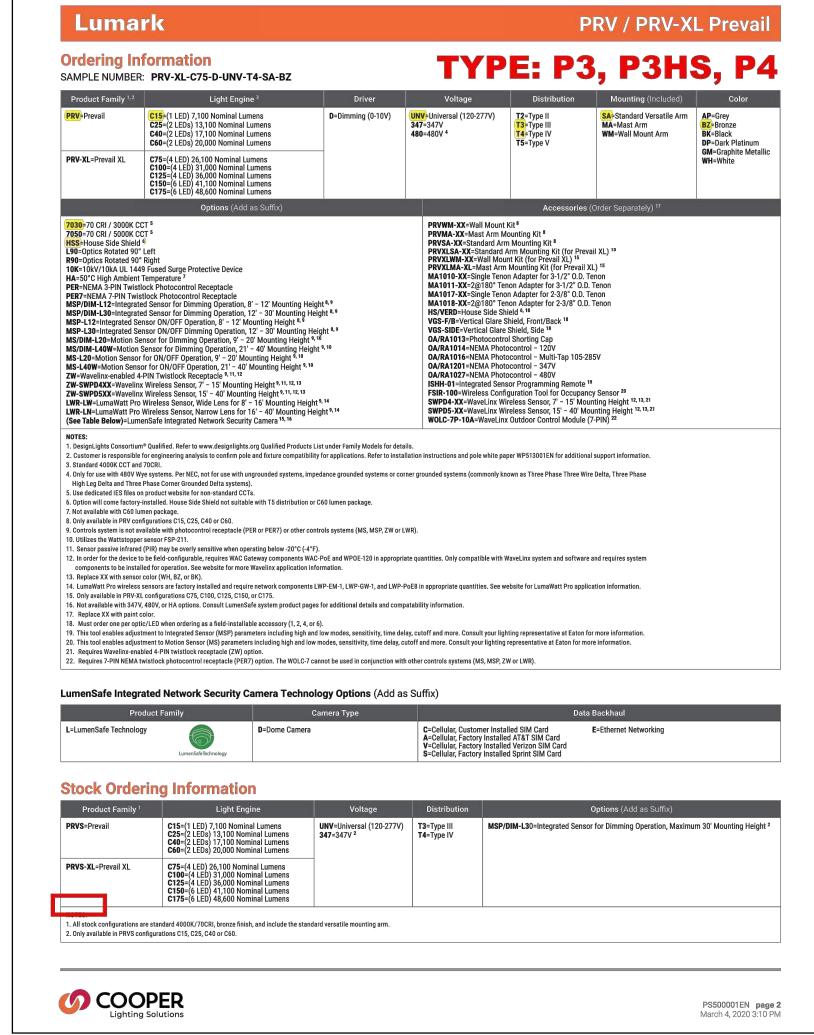


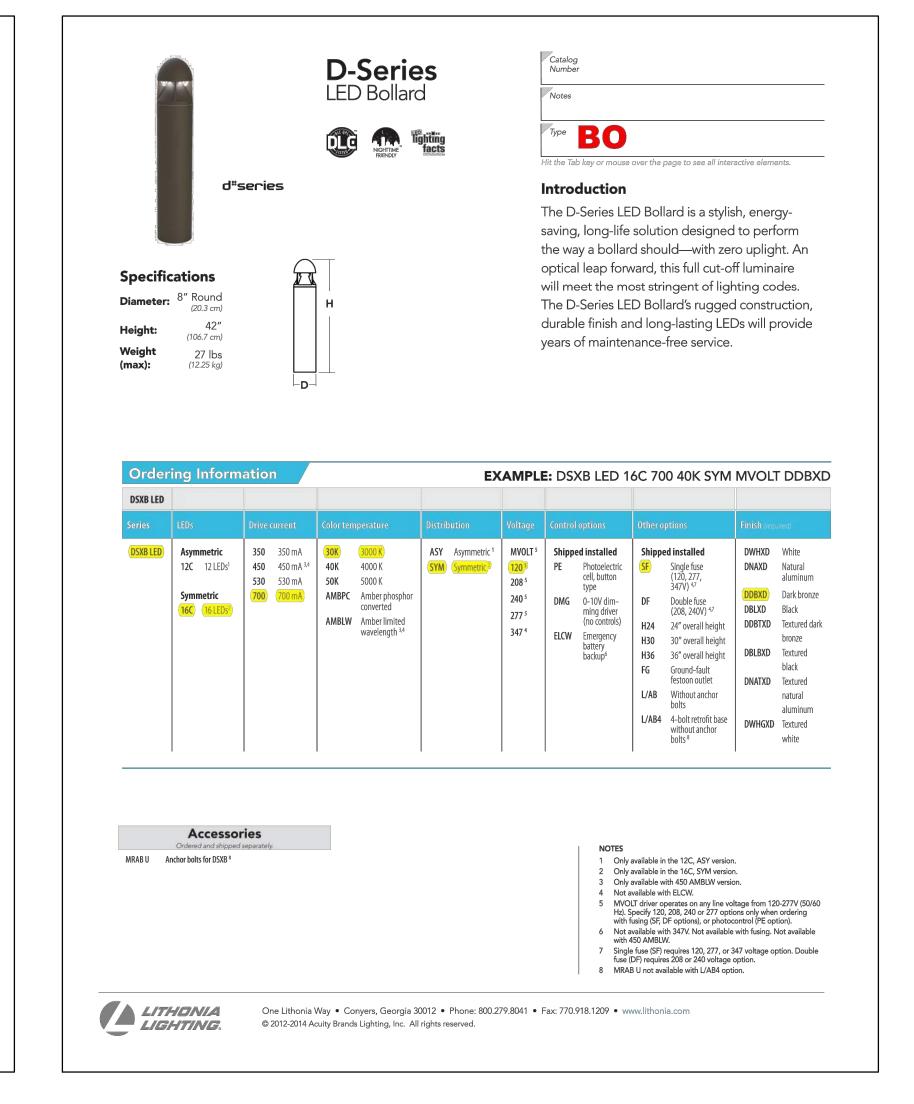



ARCHITECTURE DESIGN INSPIRATION

ARCHITECT

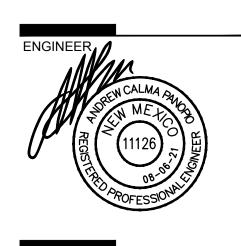

PROJECT

DONA WEST SLE RANCH ROAD QUERQUE, NM 87114

#### SITE DEVELOPMENT PLAN

DRAWN BY

REVIEWED BY

DATE 04/16/2021

PROJECT NO. 19-0058

DRAWING NAME

ELECTRICAL SITE LIGHTING CUT SHEETS


\_\_\_\_


SHEET NO.

ENGINEERING INC.
4115 N. 15TH AVE
PHOENIX, AZ 85015
(602) 265-1559
PROJECT NO. 2021-162

E3



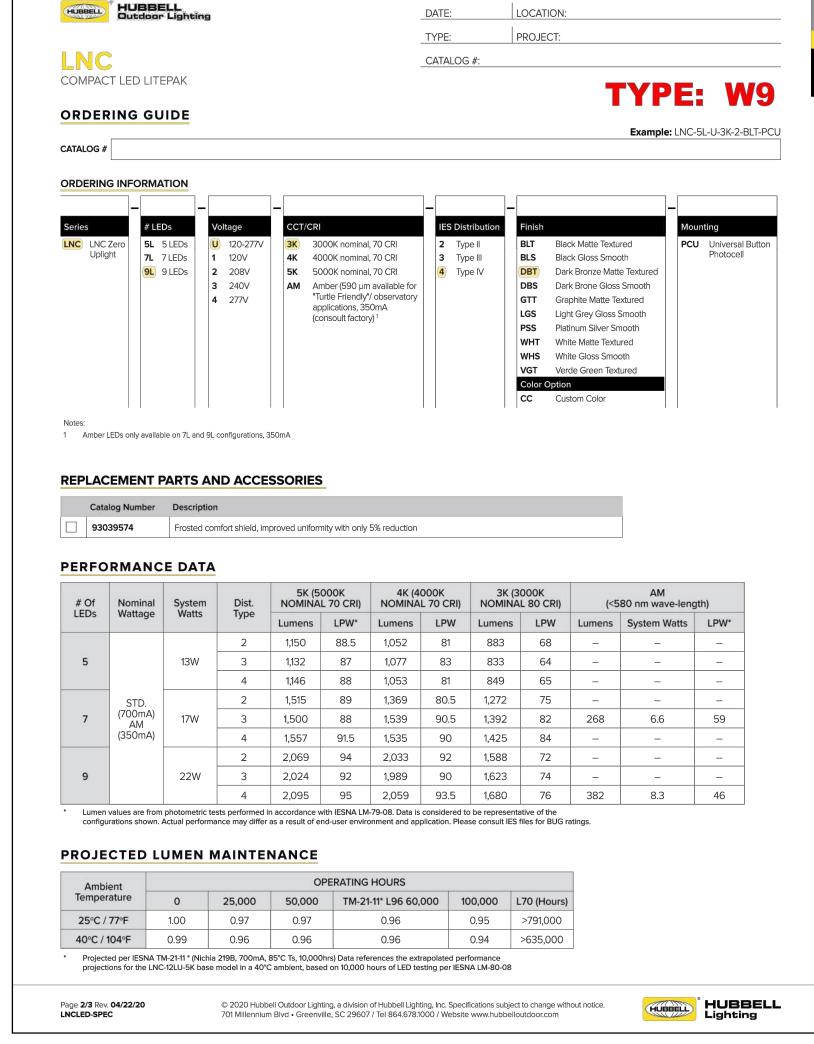


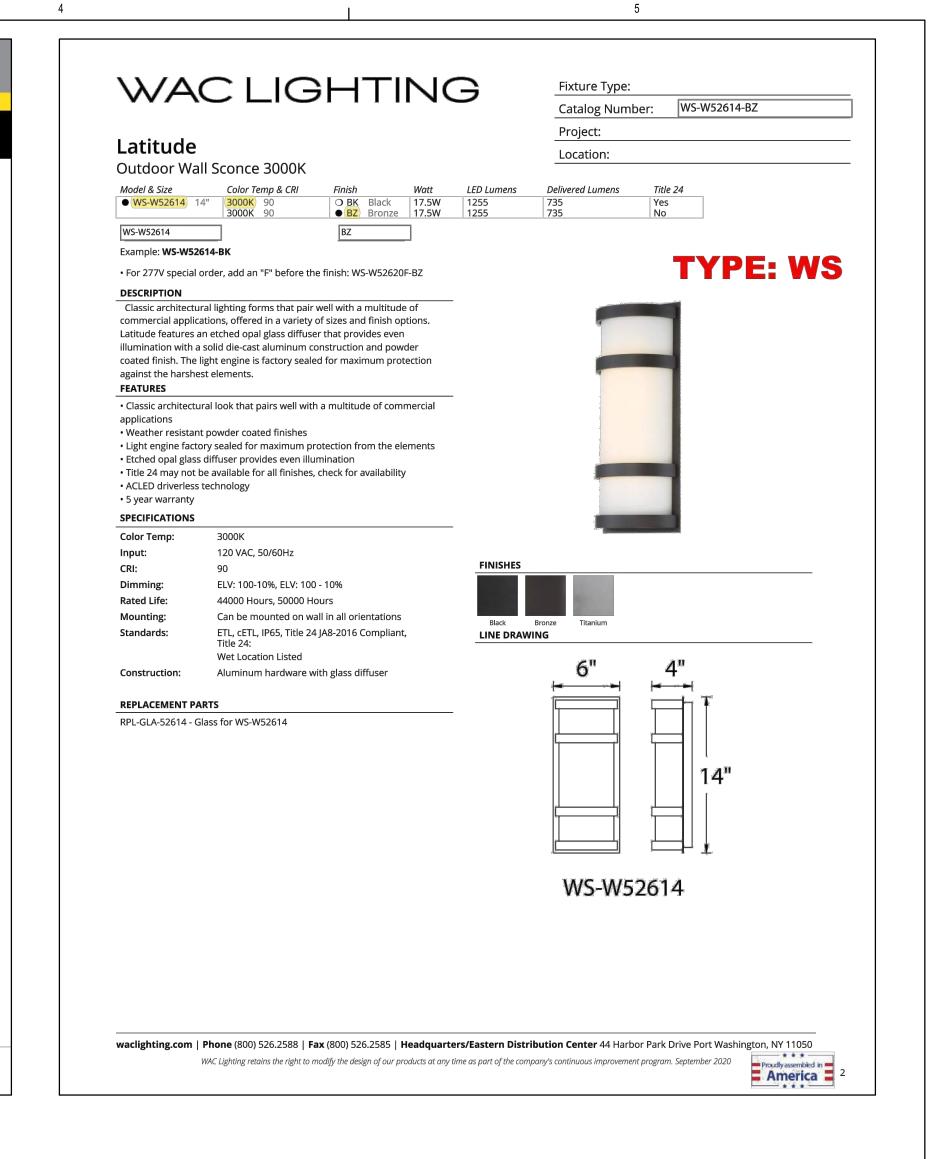



ARCHITECTURE DESIGN INSPIRATION

ARCHITECT

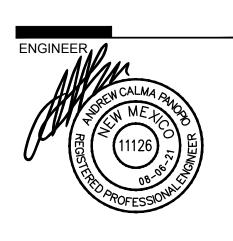

PROJECT

SEDONA WEST EAGLE RANCH ROAD ALBUQUERQUE, NM 87114

SITE DEVELOPMENT PLAN

| DE1/(010110    |  |
|----------------|--|
| REVISIONS<br>∧ |  |
| $\Delta$       |  |
| $\triangle$    |  |
| $\triangle$    |  |
| $\triangle$    |  |

DRAWN BY

REVIEWED BY

DATE 04/16/2021

PROJECT NO. 19-0058

DRAWING NAME

ELECTRICAL SITE LIGHTING CUT SHEETS

SHEET NO.

EZ OF

