


SITE DEVELOPMENT FLAN AFFROVAL.	
Einest armijo	Jul 21, 2
Traffic Engineering, Transportation Division	Date
Blaine Carter Blaine Carter (Jul 21, 2022 08:06 MDT)	Jul 21,
ABCWUA	Date
Chery Spinerfeldt (Jul 20, 2022 17:53 MDT)	Jul 20, 2
Parks and Recreation Department	Date
Shahab Biazar	Jul 21, 1
City Engineer/Hydrology	Date
Jeff Palan	Jul 21, 2
Jeff Palmer Jul 21, 2022 08:24 MDT) Code Enforcement	Date
* Environmental Health Department (conditional)	Date
SEE SHEET 19	
Solid Waste Management	Date
Mr and I	Jul 26, 2
DRB Chairperson, Planning Department	Date

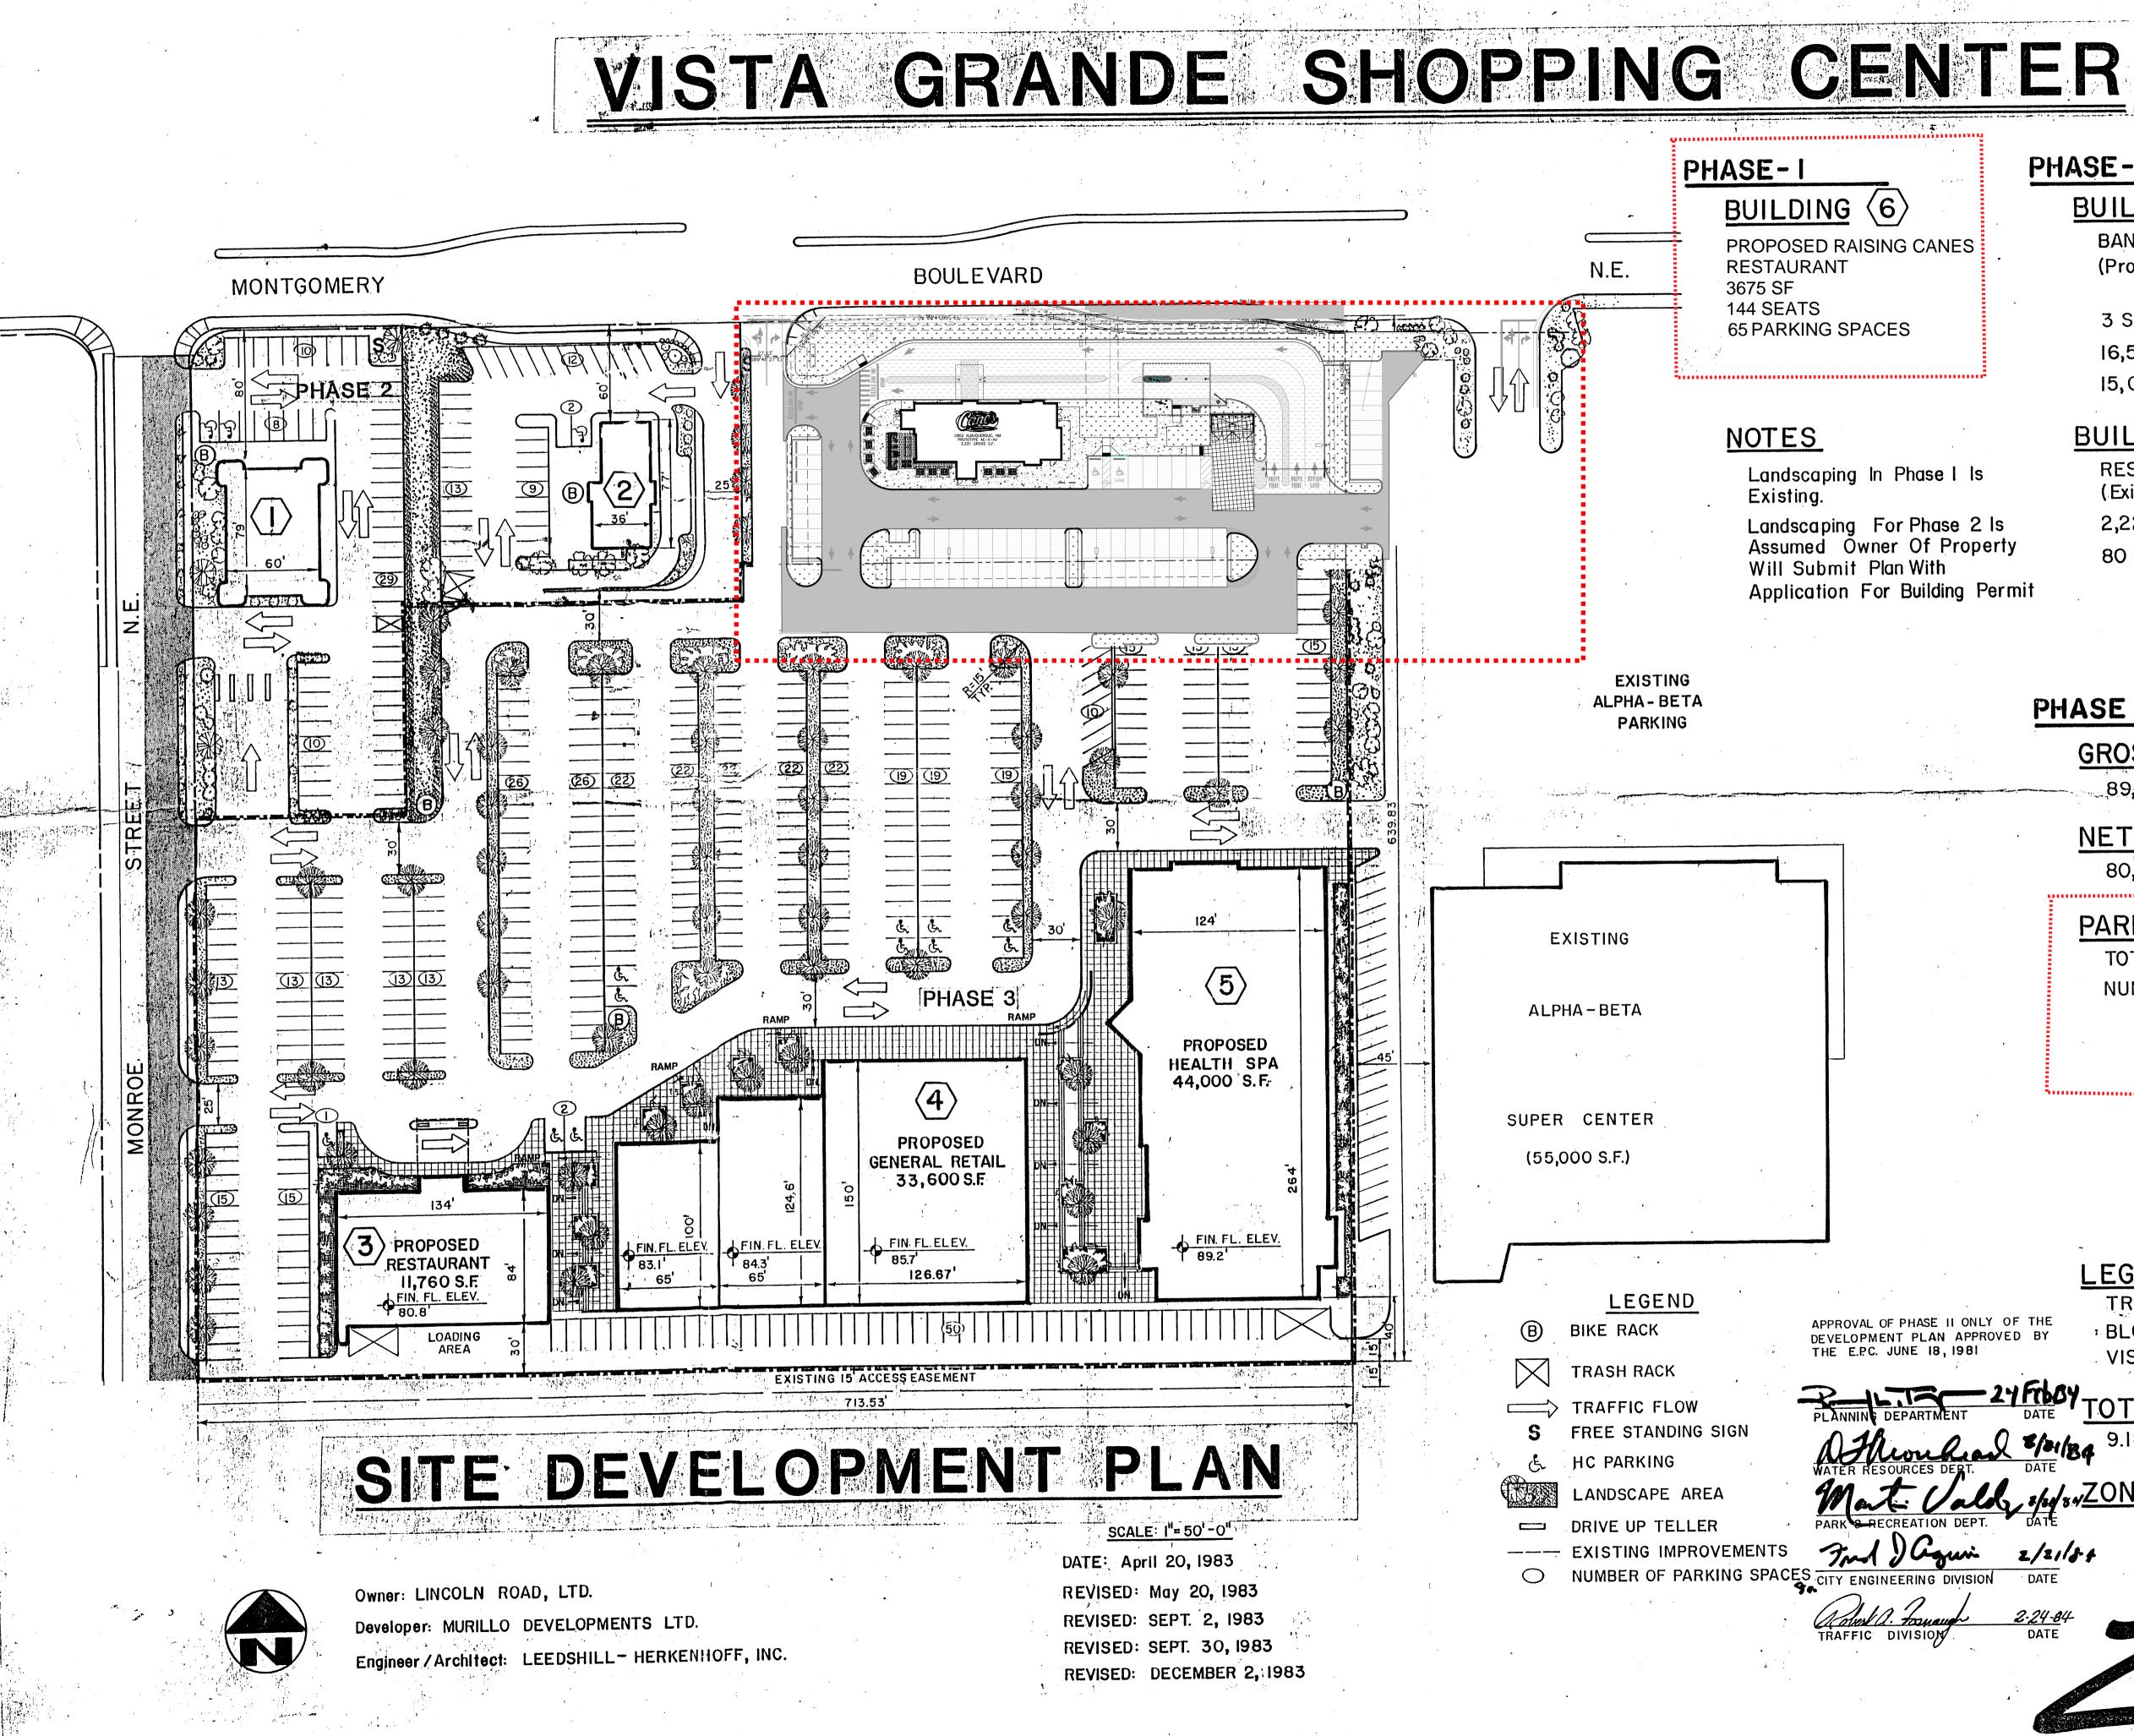


SITE PLAN EPC MAJOR AMENDMENT **TRACT B-1, APRIL 2022**

PROJECT DESCRIPTION


ALL EXISTING IMPROVEMENTS ONSITE, INCLUDING ROCK & BREWS BUILDING, ASPHALT DRIVE AISLES AND PARKING STALLS, CURBING, AND UTILITIES SERVING THE EXISTING BUILDING WILL BE DEMOLISHED. A NEW BUILDING WITH ASSOCIATED ASPHALT DRIVE AISLES AND PARKING STALLS, CURBING, AND UTILITY SERVICES WILL BE CONSTRUCTED IN ACCORDANCE WITH THE INTEGRATED DEVELOPMENT ORDINANCE (IDO) RULES AND REGULATIONS, AS DETAILED IN THIS EPC MAJOR AMENDMENT SUBMITTAL.




PHASE-3 PHASE-2 BUILDING (3) BUILDING (1) RESTAURANT BANK (Proposed-SUN COUNTRY 11,760 S.F. SAVINGS AND LOAN) 300 SEATS **3** STORIES <u>BUILDING</u> $\langle 4 \rangle$ 16,500 S.F. GROSS 15,000 S.F. NET RETAIL 33,600 S.F. GROSS <u>BUILDING</u> $\langle 2 \rangle$ 30,240 S.F. NET RESTAURANT (Existing - BURGER KING) <u>BUILDING</u> $\langle 5 \rangle$ 2,220 S.F. HEALTH SPA 80 SEATS 32,000 S.F. GROUND FLOOR 12,000 S.F. SECOND FLOOR 44,000 S.F. GROSS 39,600 S.F. NET PHASE - 3 GROSS BUILDING AREA OTHER REQUIRED DEVELOPMENTS The following improvements will-be-completed before a Certificate of Occupancy is requested 89,380 S.F. for buildings 1, 3, 4, or 5. I.Monroe Street: 4' wide sidewalks, curb and NET BUILDING AREA gutter, residential paving of the east half to centerline, and 4 wide temporary paving west 80,424 S.F. of the centerline. PARKING SPACES 2. Access Easement along the south property line: a minimum of 24' wide paving from Monroe TOTAL PROVIDED: ---St. east to east property line. NUMBER REQUIRED:- 307 Handicapped — 9 Small Car 88 PR-2021-005467 Standard----- 338 Application Number: SI-2022-00861 This plan is consistent with the specific Site Development Plan approved by the Environmental Planning Commission (EPC), dated _______ # Findings and Conditions in the Official Notification of Decision are satisfied. Is an Infrastructure List required? () Yes () No If yes, then a set of approved DRC plans with a work order is required for any construction within Public Right-of-Way or for construction of public improvements. RB SITE DEVELOPMENT PLAN APPROVAL rafic Engineering, Transcortation D _EGAL DESCRIPTION TRACT B-5 ABCMUM ¹ BLOCK A arks and Recreation VISTA GRANDE ADDITION UNIT I -24 Frboy DATE TOTAL LAND AREA City Engineer/Hydro 5/01/84 9.1897 ACRES Code Enforcement invironmental Health Department (cc Mart: Valde, s/20NED: C-2 Solid Waste Manager 2/21/84 DATE 2.24-84 DATE

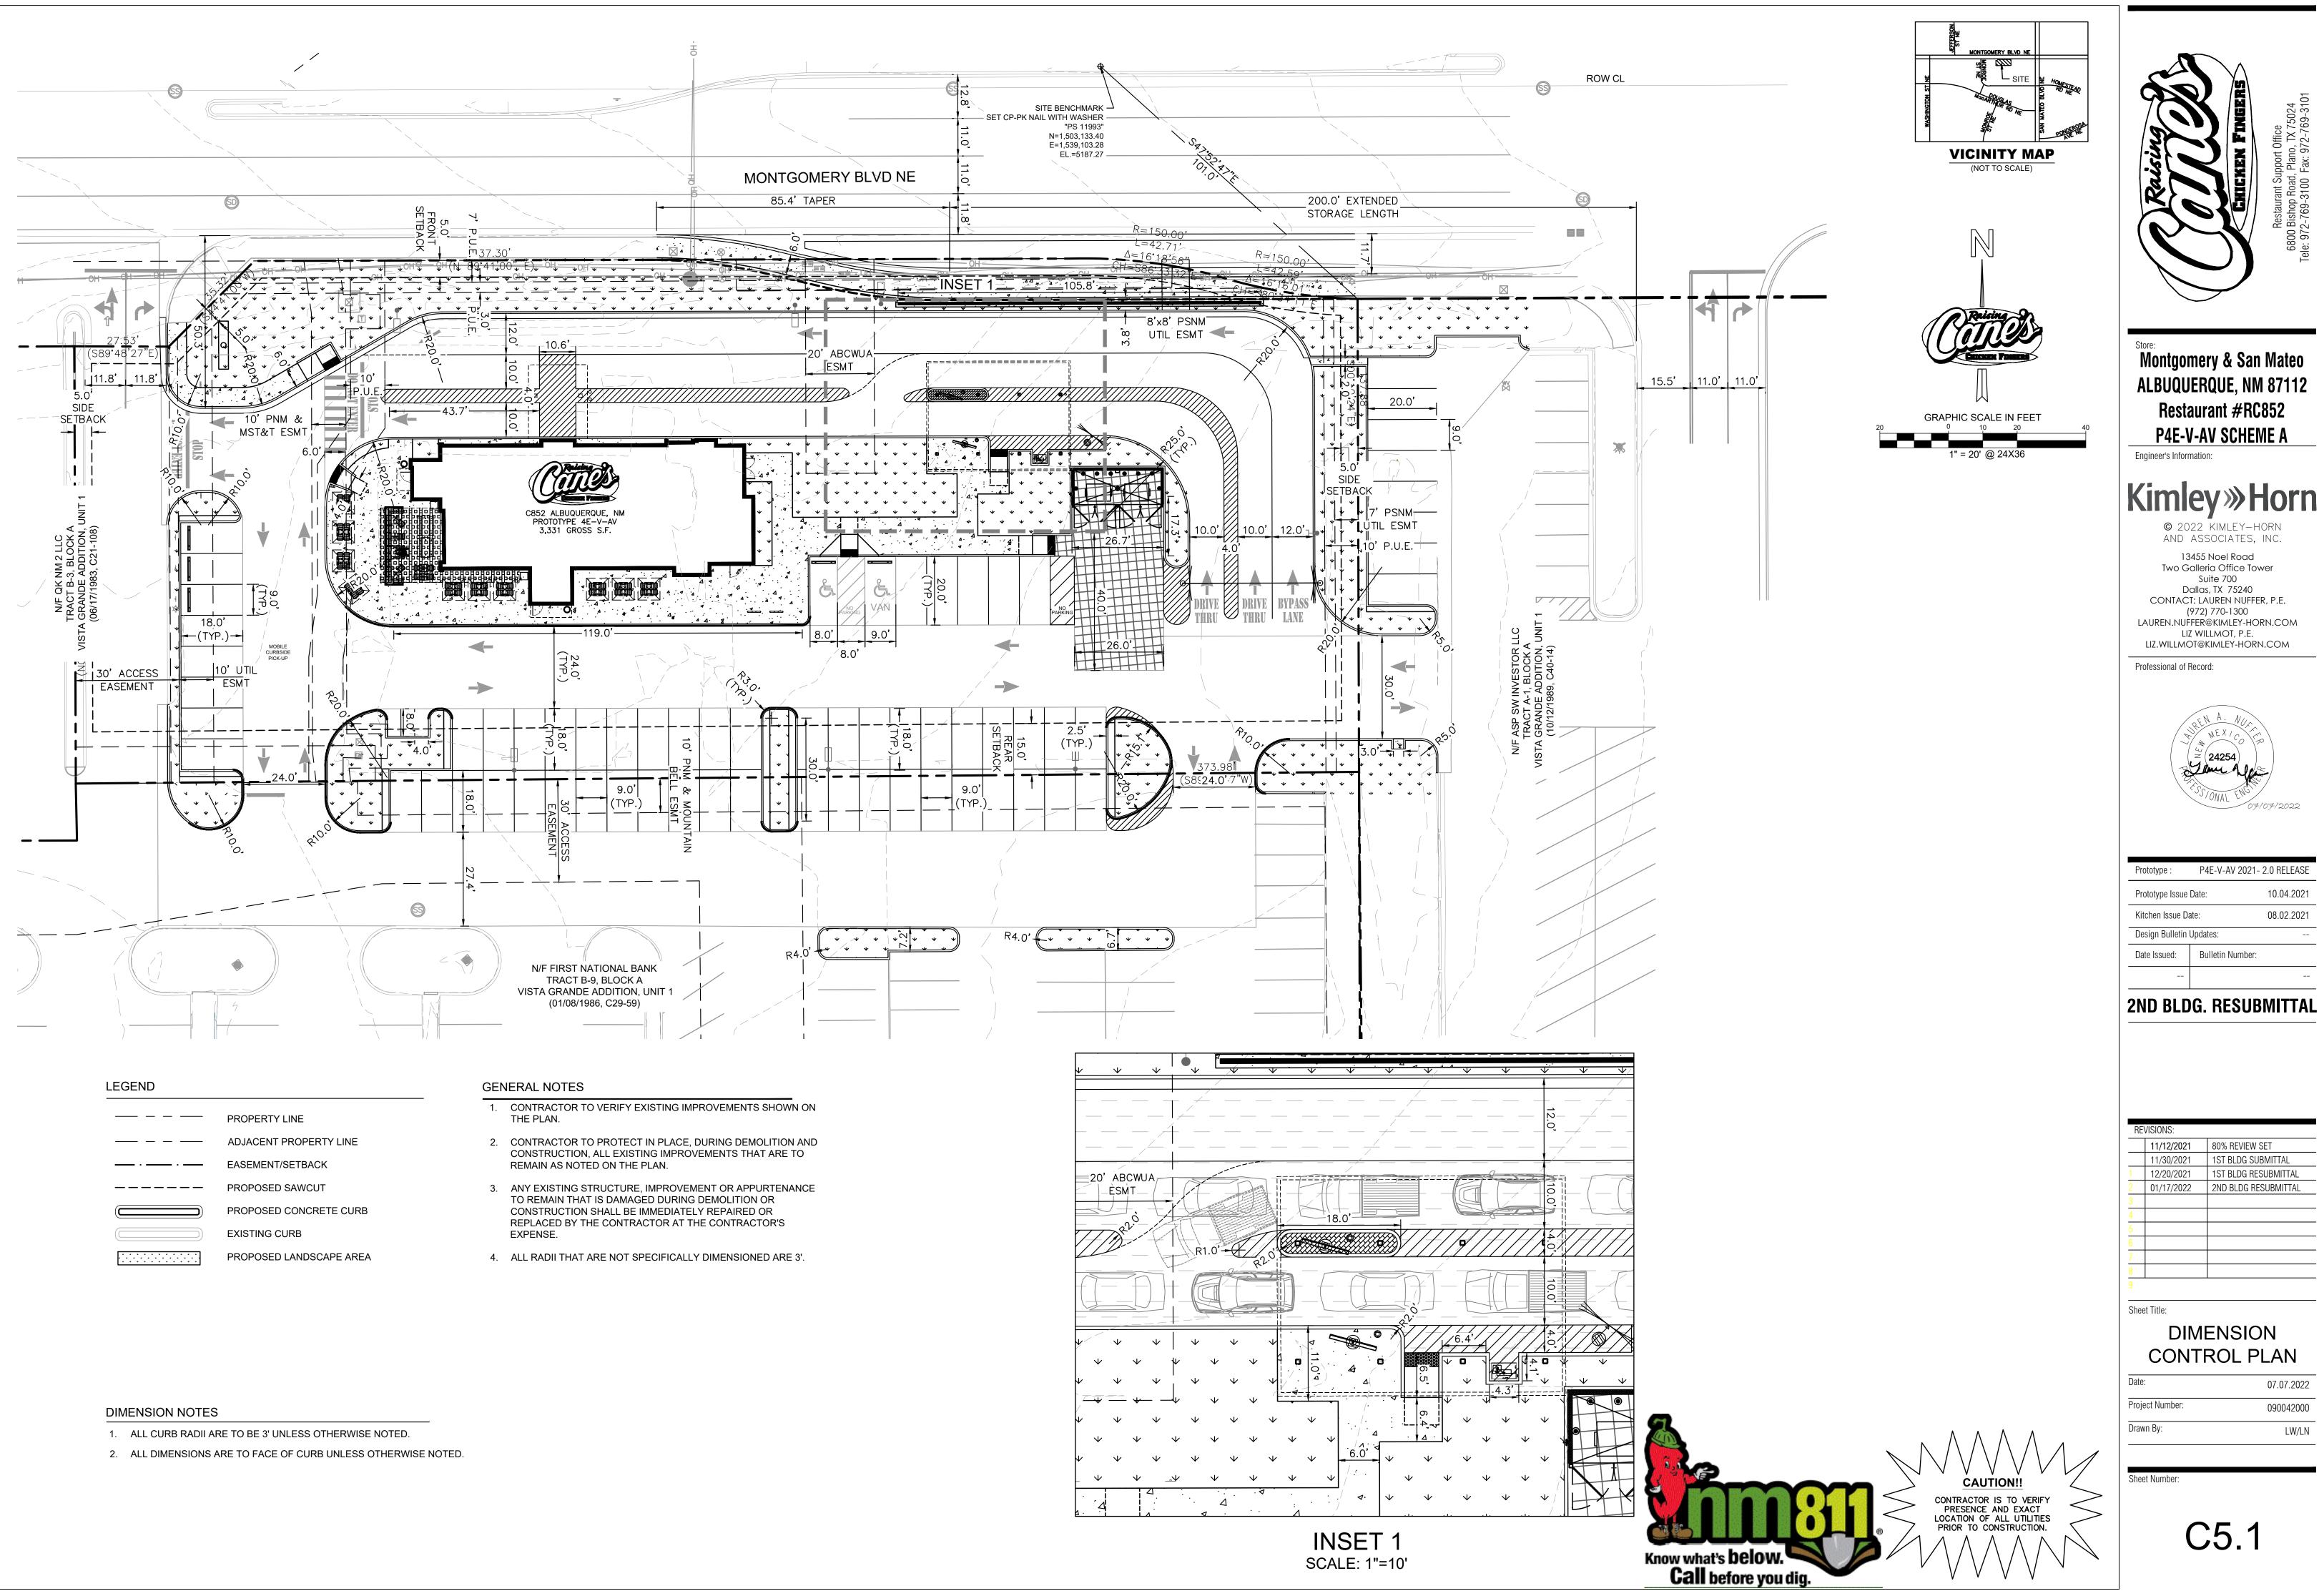


	PROPERTY LINE
	ADJACENT PROPERTY LINE
	EASEMENT/SETBACK
	PROPOSED SAWCUT
	PROPOSED CONCRETE CURB
	EXISTING CURB
· · · · · · · · · · · · · · · · · · ·	PROPOSED LANDSCAPE AREA

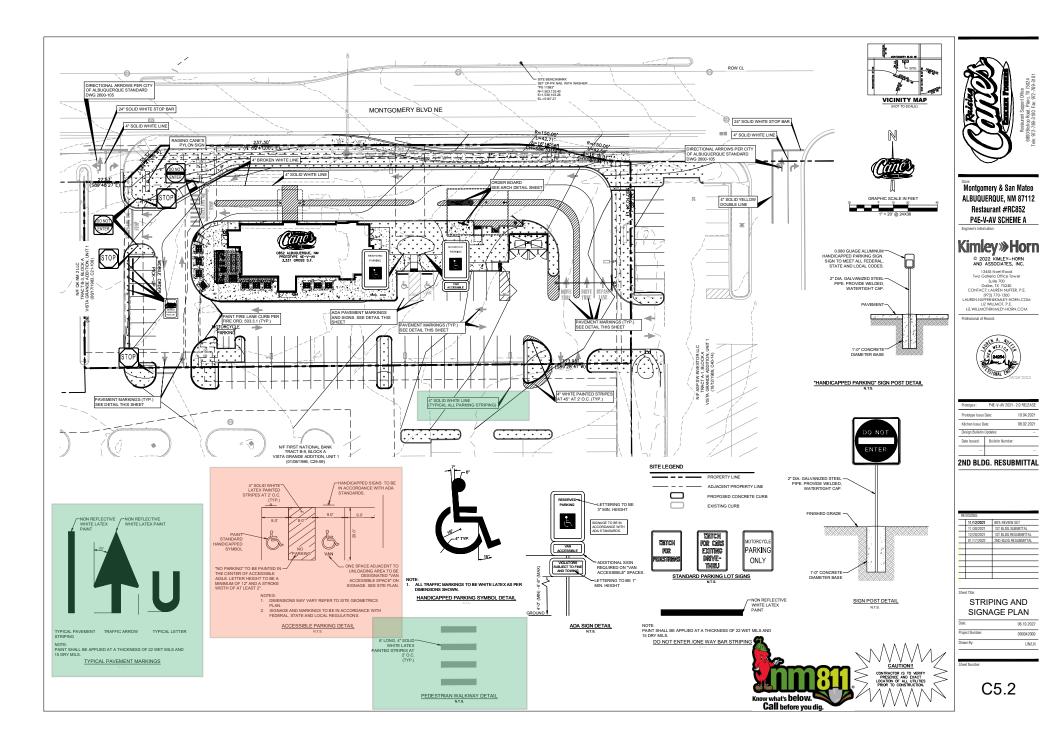

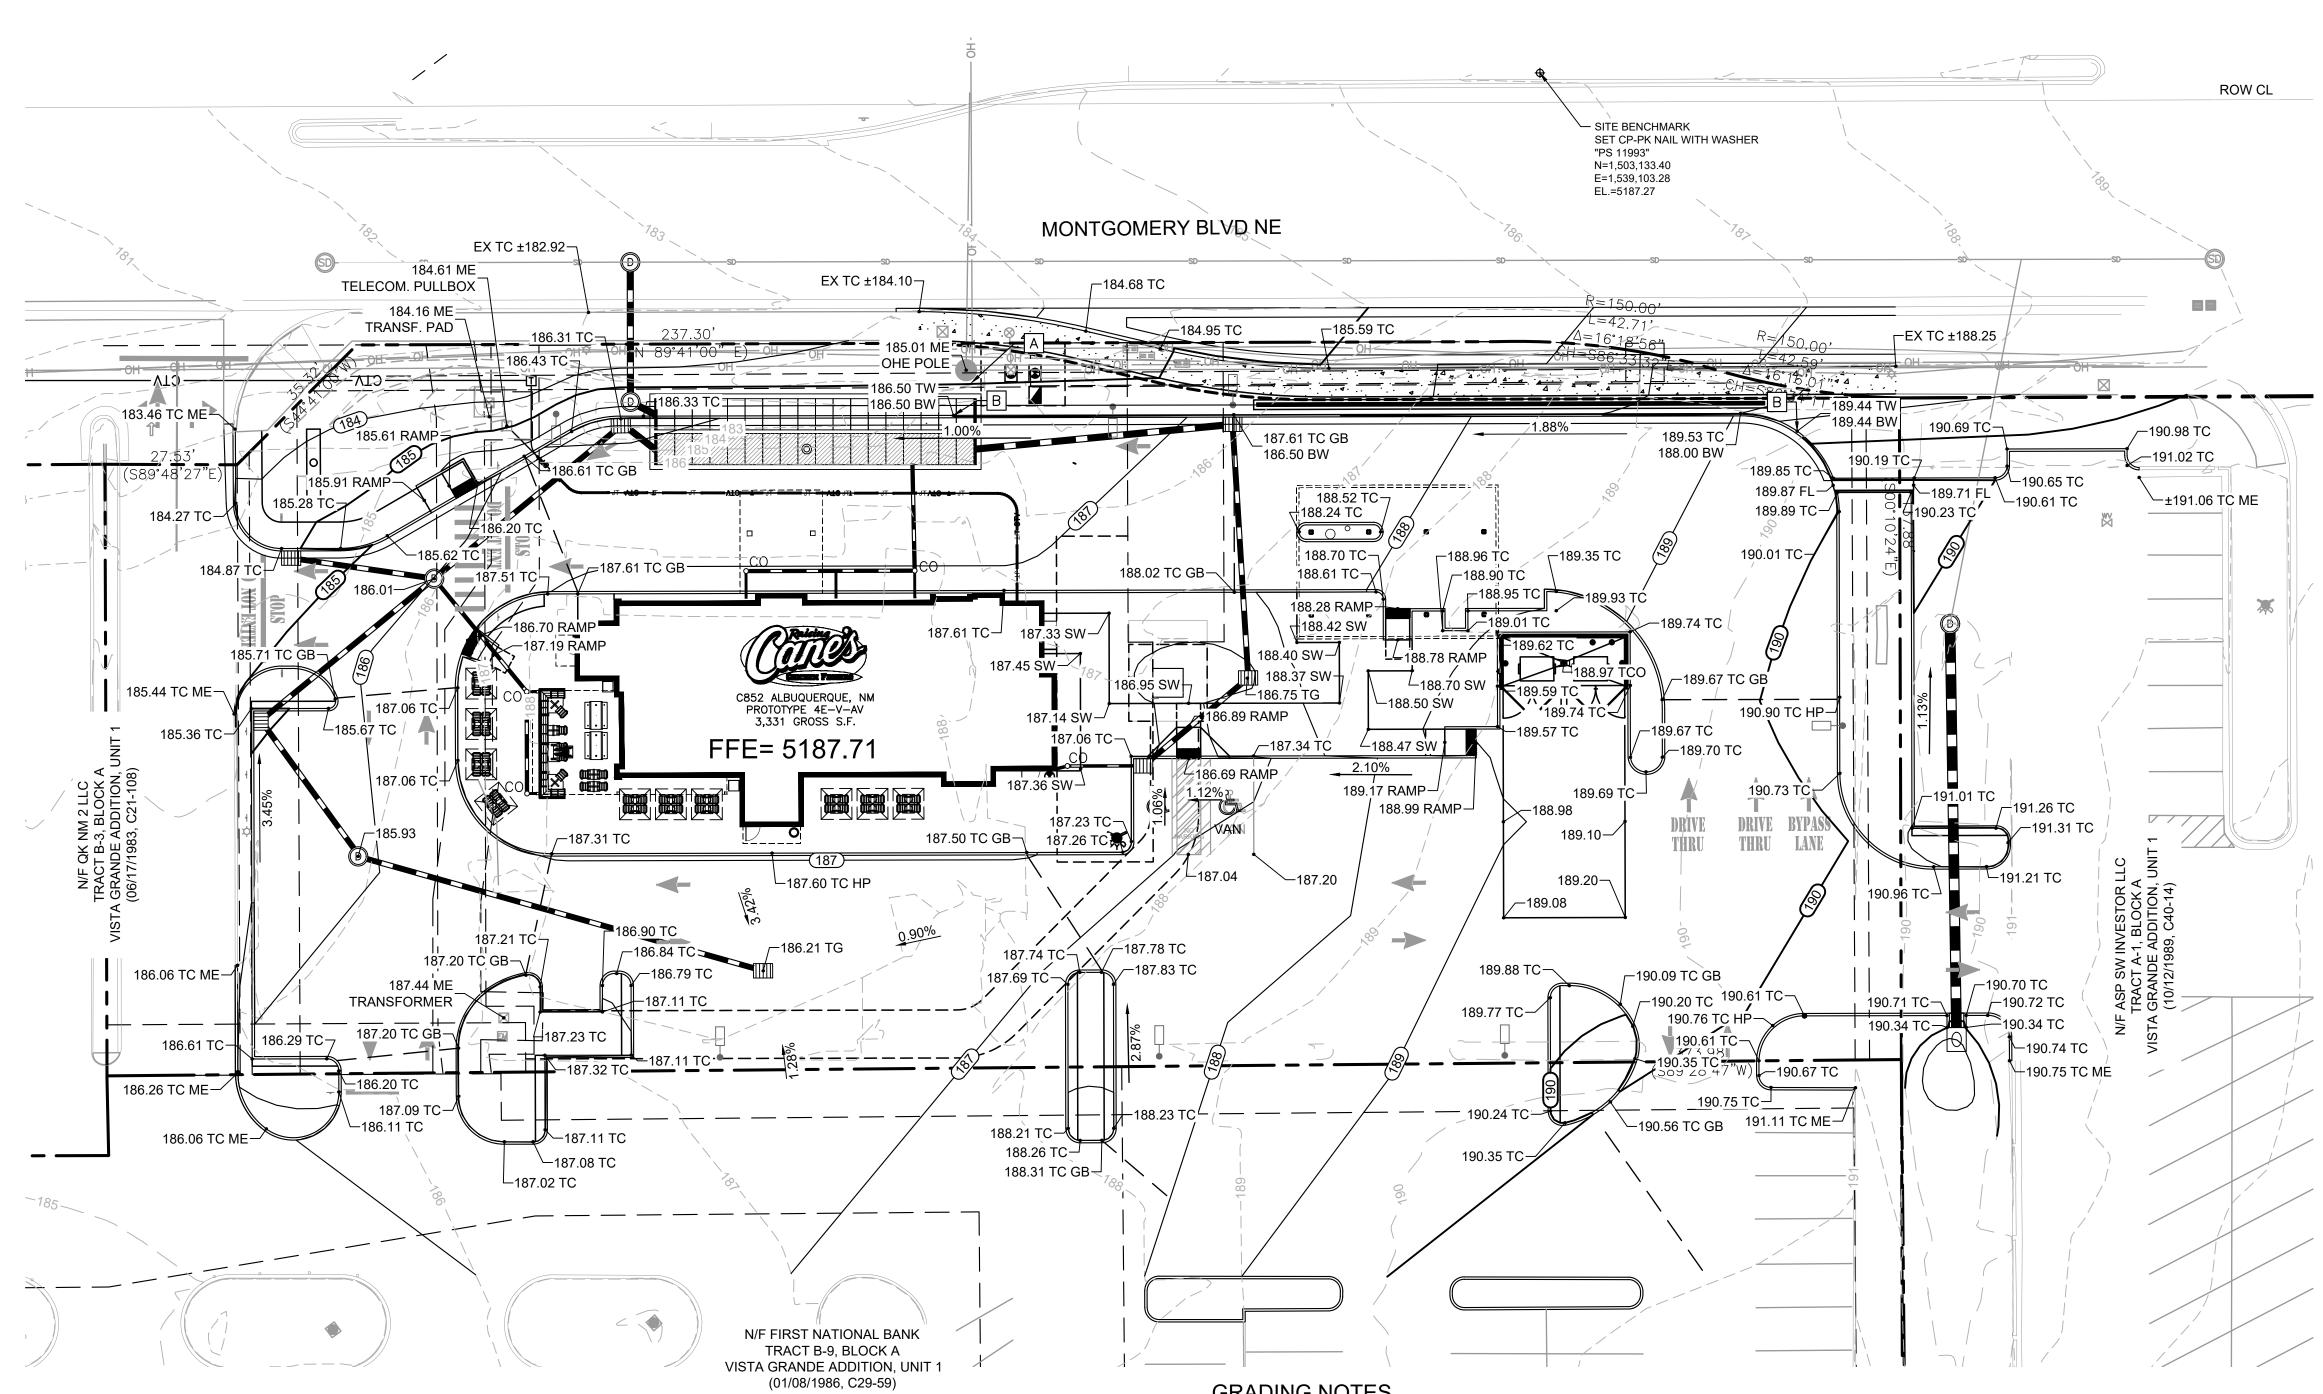

GRADING NOTES

- 1. ADD 5000' TO ALL SPOT ELEVATIONS & CONTOUR LABELS.
- 2. ALL CONSTRUCTION TO BE IN ACCORDANCE WITH THESE PLANS AND THE CITY/AHJ STANDARDS AND SPECIFICATIONS.
- 3. PRIOR TO STARTING CONSTRUCTION, THE CONTRACTOR SHALL MAKE CERTAIN THAT ALL REQUIRED PERMITS AND APPROVALS HAVE BEEN OBTAINED. NO CONSTRUCTION OR FABRICATION SHALL BEGIN UNTIL THE CONTRACTOR HAS RECEIVED AND THOROUGHLY REVIEWED ALL PLANS AND OTHER DOCUMENTS APPROVED BY ALL OF THE PERMITTING AUTHORITIES.
- 4. THE GENERAL CONTRACTOR AND ALL SUB-CONTRACTORS SHALL VERIFY THE SUITABILITY OF ALL EXISTING AND PROPOSED SITE CONDITIONS INCLUDING GRADES AND DIMENSIONS BEFORE COMMENCEMENT OF ANY CONSTRUCTION. THE ENGINEER SHALL BE NOTIFIED IMMEDIATELY OF ANY DISCREPANCIES. MINOR ADJUSTMENTS TO FINISH GRADE TO ACCOMPLISH SPOT DRAINAGE ARE ACCEPTABLE, IF NECESSARY, UPON PRIOR APPROVAL OF ENGINEER. PAVING INSTALLED SHALL "FLUSH OUT" AT ANY JUNCTURE WITH EXISTING PAVING.
- 5. THE CONTRACTOR IS SPECIFICALLY CAUTIONED THAT THE LOCATION AND/OR ELEVATION OF EXISTING UTILITIES AS SHOWN ON THESE PLANS IS BASED ON RECORDS OF THE VARIOUS UTILITY COMPANIES, AND WHERE POSSIBLE, MEASUREMENTS TAKEN IN THE FIELD. THE INFORMATION IS NOT TO BE RELIED ON AS BEING EXACT OR COMPLETE. THE CONTRACTOR MUST CALL THE APPROPRIATE UTILITY COMPANIES AT LEAST 72 HOURS BEFORE ANY EXCAVATION TO REQUEST EXACT FIELD LOCATION OF UTILITIES. IT SHALL BE THE RESPONSIBILITY OF THE CONTRACTOR TO RELOCATE ALL EXISTING UTILITIES WHICH CONFLICT WITH THE PROPOSED IMPROVEMENTS SHOWN ON THE PLANS.
- 6. ALL CUT OR FILL SLOPES SHALL BE 4:1 OR FLATTER UNLESS OTHERWISE NOTED.
- 7. CONTRACTOR SHALL ADJUST AND/OR CUT EXISTING PAVEMENT AS NECESSARY TO ASSURE A SMOOTH FIT AND CONTINUOUS GRADE.
- 8. CONTRACTOR SHALL ASSURE POSITIVE DRAINAGE AWAY FROM BUILDINGS FOR ALL NATURAL AND PAVED AREAS.
- 9. TOPOGRAPHIC INFORMATION IS TAKEN FROM A TOPOGRAPHIC SURVEY BY LAND SURVEYORS. IF THE CONTRACTOR DOES NOT ACCEPT EXISTING TOPOGRAPHY AS SHOWN ON THE PLANS, WITHOUT EXCEPTION, THEN THE CONTRACTOR SHALL SUPPLY, AT THEIR EXPENSE, A TOPOGRAPHIC SURVEY BY A REGISTERED LAND SURVEYOR TO THE OWNER FOR REVIEW.
- 10. CONTRACTOR SHALL REFER TO ARCHITECTURAL PLANS FOR EXACT BUILDING FOOTPRINT DIMENSIONS.
- 11. CONTRACTOR SHALL REFER TO FINAL GEOTECH REPORT FOR BUILDING SUBGRADE AND SITE PREPARATION REQUIREMENTS.
- 12. CONTRACTOR SHALL ADJUST EXISTING VALVES, MANHOLE RIMS, ETC. AS NECESSARY TO MATCH FINISHED GRADE.
- 13. ALL ELEVATIONS ARE TOP OF PAVEMENT UNLESS NOTED OTHERWISE. TO GET TOP OF CURB ELEVATIONS ADD 6" TO THE ELEVATION SHOWN.
- 14. GRADING FOR ALL SIDEWALKS AND ACCESSIBLE ROUTES INCLUDING CROSSING DRIVEWAYS SHALL CONFORM TO ADA STANDARDS. SLOPES SHALL NOT EXCEED 5% LONGITUDINAL SLOPE OR 2% CROSS SLOPE. SIDEWALK ACCESS TO EXTERNAL BUILDING DOORS SHALL BE ADA COMPLIANT. CONTRACTOR SHALL NOTIFY ENGINEER IMMEDIATELY IF ADA CRITERIA CANNOT BE MET AT ANY LOCATION.
- 15. ANY PROPOSED CONTOURS SHOWN ARE APPROXIMATE. PROPOSED SPOT ELEVATIONS AND DESIGNATED GRADIENT ARE TO BE USED IN THE EVENT OF ANY DISCREPANCIES.
- 16. REFER TO EROSION CONTROL PLAN FOR EROSION CONTROL DEVICES TO BE INSTALLED PRIOR TO COMMENCING GRADING OPERATIONS.
- 17. ALL FILL TO BE PLACED SHALL BE IN ACCORDANCE WITH THE CURRENT APPLICABLE GEOTECHNICAL REPORT RECOMMENDATIONS.

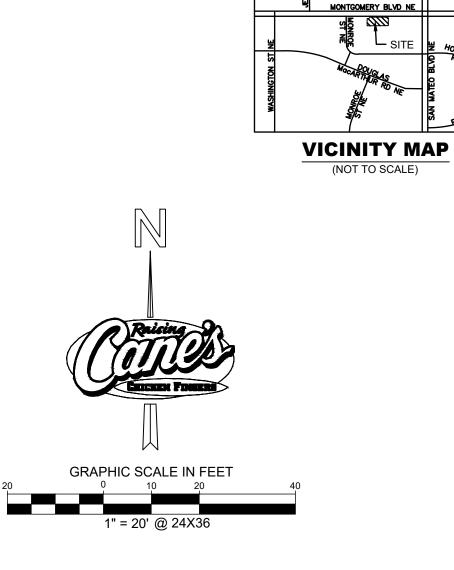


LEGEND

	PROPOSED PROPERTY LINE
	ADJACENT PROPERTY LINE
15	EXISTING CONTOUR
15	PROPOSED CONTOUR
1.00%	PROPOSED FLOW ARROW WITH SLOPE
14.50	PROPOSED SPOT ELEVATION
	EXISTING STORM INLET
GB	GRADE BREAK
HP	HIGH POINT
Р	TOP OF PAVEMENT
SW	TOP OF SIDEWALK
ME	MATCH EXISTING ELEVATION
TG	TOP OF GRATE
FL	FLOW LINE
тсо	TOP OF CLEANOUT
TW	TOP OF WALL
BW	BOTTOM OF WALL
	PROPOSED RIDGE

GRADING CONSTRUCTION NOTES

3:1 CUT SLOPE BETWEEN EDGE OF EXISTING OVERHEAD ELECTRIC POLE AND TOP OF PROPOSED CURB, REFERENCE GRADING NOTE 5 THIS SHEET CONSTRUCT CUT-OFF WALL IN PLACE OF CURB PER CITY OF ALBUQUERQUE STANDARD DWG 2415C. TOP OF WALL = TOP OF CURB, ELEVATION PER DRAWING BOTTOM OF WALL = BOTTOM OF EXPOSED WALL, BURY WALL A MINIMUM OF 18" BELOW FINISHED GRADE. MIN HEIGHT = 0", MAX HEIGHT = 18"



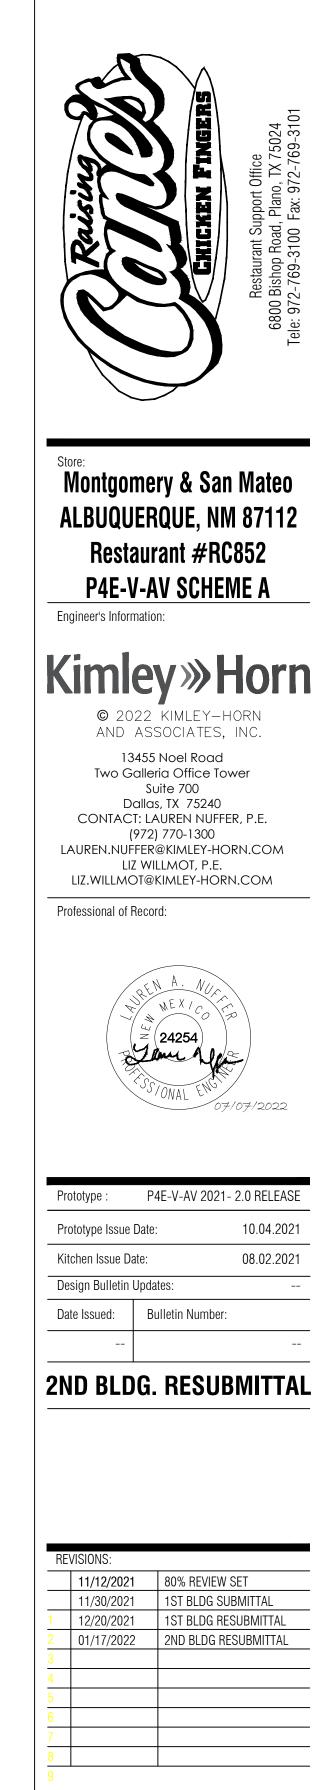


Sheet Title:

GRADING PLAN

Date:	07.07.2022
Project Number:	090042000
Drawn By:	LW/LN

Sheet Number:

C6.0

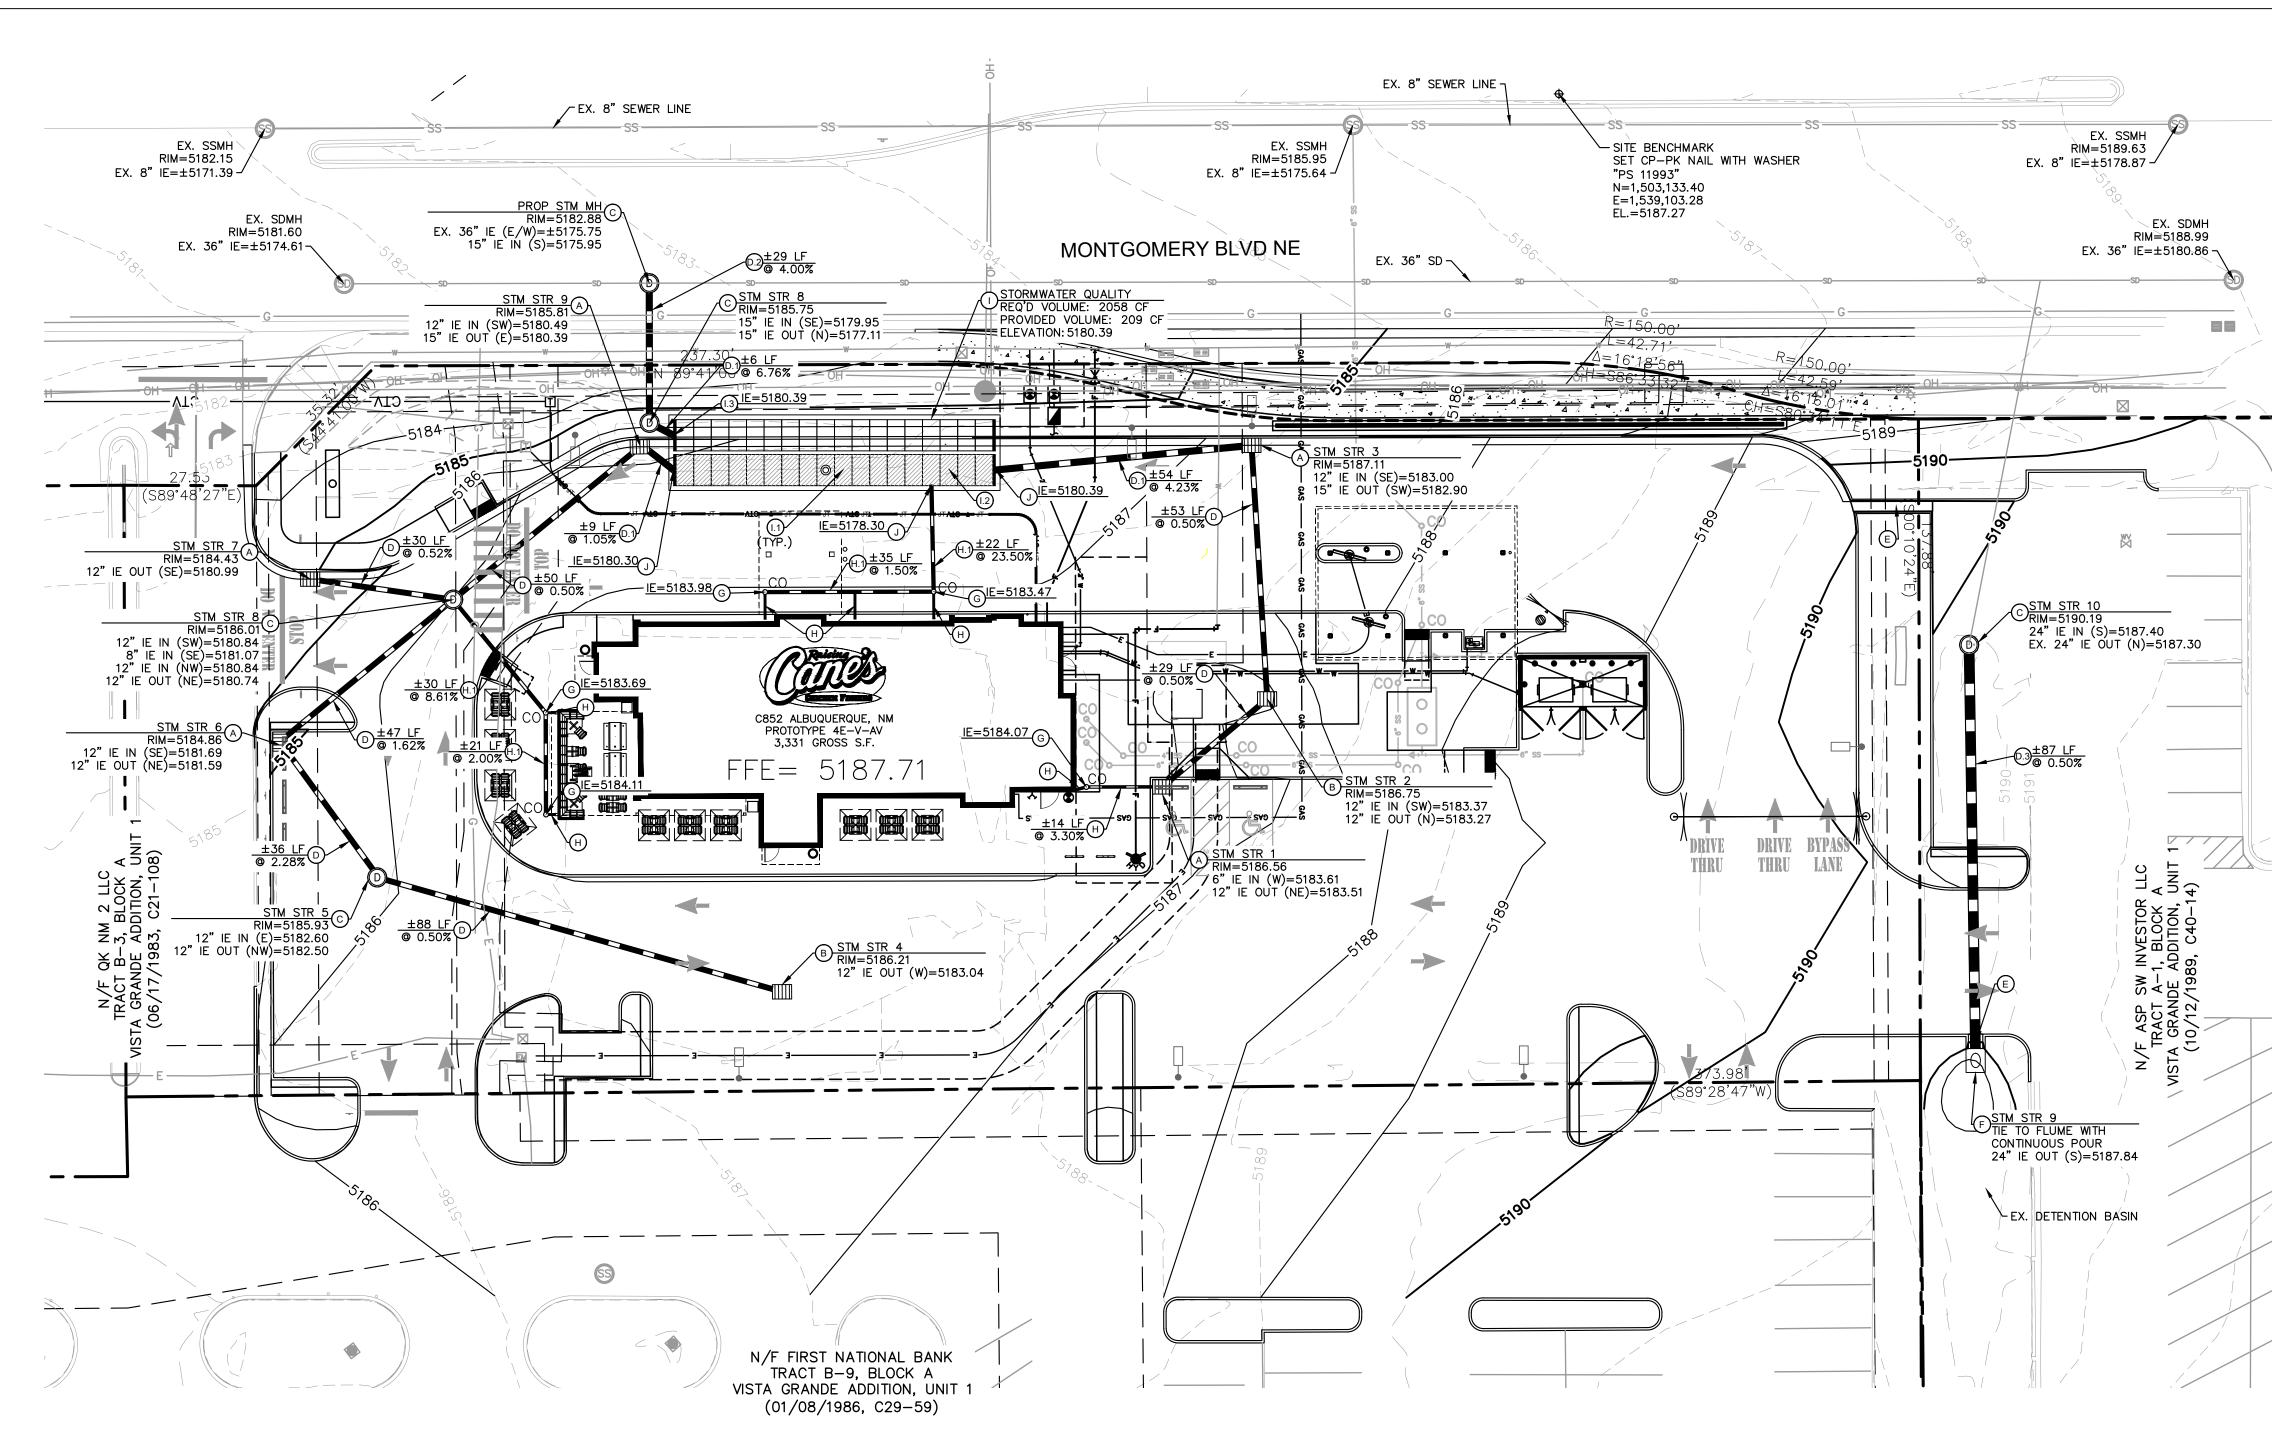


STORM NOTES


- REFER TO CITY STANDARD AND DETAILS FOR TRENCHING, BEDDING, BACKFILL, AND TRENCH COMPACTION REQUIREMENTS.
 GUTTER TRANSITION ADJACENT TO TYPE "A" INLETS TO FOLLOW CITY OF ALBUQUERQUE STANDARD DETAILS, DWG NO. 2207.
- 3. CONTRACTOR IS RESPONSIBLE FOR COMPLYING TO THE SPECIFICATIONS OF THE CITY WITH REGARDS TO MATERIALS, INSTALLATION, AND UTILITY CROSSINGS.
- 4. THE CONTRACTOR IS SPECIFICALLY CAUTIONED THAT THE LOCATION AND/OR ELEVATION OF EXISTING UTILITIES AS SHOWN ON THESE PLANS IS BASED ON RECORDS OF THE VARIOUS UTILITY COMPANIES, AND WHERE POSSIBLE, MEASUREMENTS TAKEN IN THE FIELD. THE INFORMATION IS NOT TO BE RELIED ON AS BEING EXACT OR COMPLETE. THE CONTRACTOR MUST CALL THE APPROPRIATE UTILITY COMPANIES AT LEAST 72 HOURS BEFORE ANY EXCAVATION TO REQUEST EXACT FIELD LOCATION AND ELEVATIONS OF UTILITIES. IT SHALL BE THE RESPONSIBILITY OF THE CONTRACTOR TO RELOCATE ALL EXISTING UTILITIES WHICH CONFLICT WITH THE PROPOSED IMPROVEMENTS SHOWN ON THE PLANS.
- CONTRACTOR IS RESPONSIBLE FOR ALL NECESSARY PERMITS, INSPECTIONS AND/OR CERTIFICATIONS REQUIRED BY CITY CODES AND/OR UTILITY SERVICE COMPANIES.
- CONTRACTOR IS RESPONSIBLE FOR PAVEMENT REPLACEMENT REQUIRED FOR ALL UTILITY INSTALLATIONS PER CITY STANDARDS.
 THE AREA OF LAND TREATMENT D WITHIN THE PROJECT AREA IS 58,667 SF OR 1.35 AC.


PAVEMENT SECTION-SEE CONSTRUCTION DETAILS


RECHARGER 902HD CHAMBERS SEE CULTEC DETAILS

> STONE FILL SEE CULTEC DETAILS

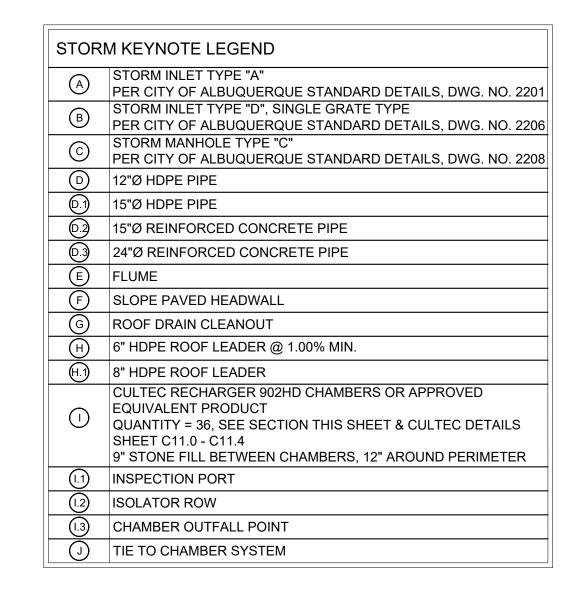

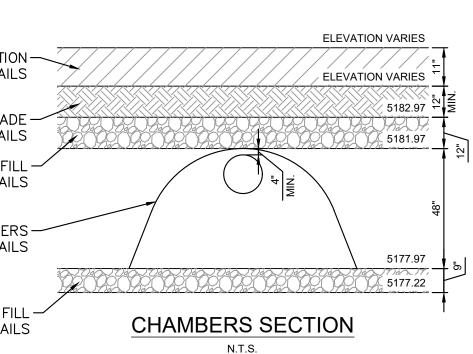


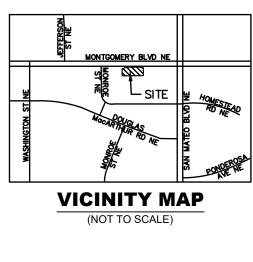

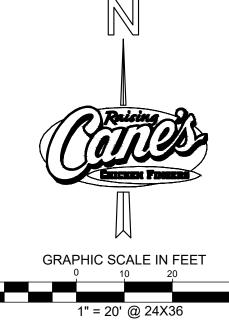

UTILITY LEGEND

	PROPERTY LINE
	EXISTING EASEMENT
	PROPOSED EASEMENT
	EXISTING FIRE LANE
s	PROPOSED SANITARY SEWER LINE
w	PROPOSED WATER LINE
——— F ———	PROPOSED FIRE WATER LINE
— GAS —— GAS —	PROPOSED UNDERGROUND GAS LINE
	PROPOSED UNDERGROUND ELECTRIC LINE
UGT	PROPOSED UNDERGROUND TELEPHONE LINE
	PROPOSED STORM DRAINAGE LINE
	EXISTING STORM DRAINAGE LINE
89 89	EXISTING OVERHEAD POWER LINE
GAS GAS	EXISTING GAS LINE
W	EXISTING WATER LINE
SS	EXISTING SANITARY SEWER LINE
¢	PROPOSED FIRE HYDRANT
Θ	PROPOSED WATER METER
o	PROPOSED SEWER CLEANOUT
\bowtie	PROPOSED WATER VALVE
Ъ	PROPOSED TEE
<u>~</u> 1 Г	PROPOSED BEND
°co	PROPOSED SEWER CLEAN OUT
Ø	EXISTING POWER POLE
¢	EXISTING FIRE HYDRANT
S	EXISTING SANITARY SEWER MANHOLE
	EXISTING SIGN
4	THRUST BLOCK

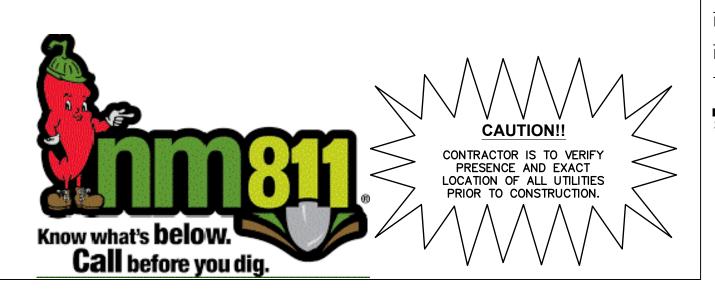





STORM DRAINAGE PLAN

Date:	07.07.2022
Project Number:	090042000
Drawn By:	LW/LN

Sheet Number:

C7.0

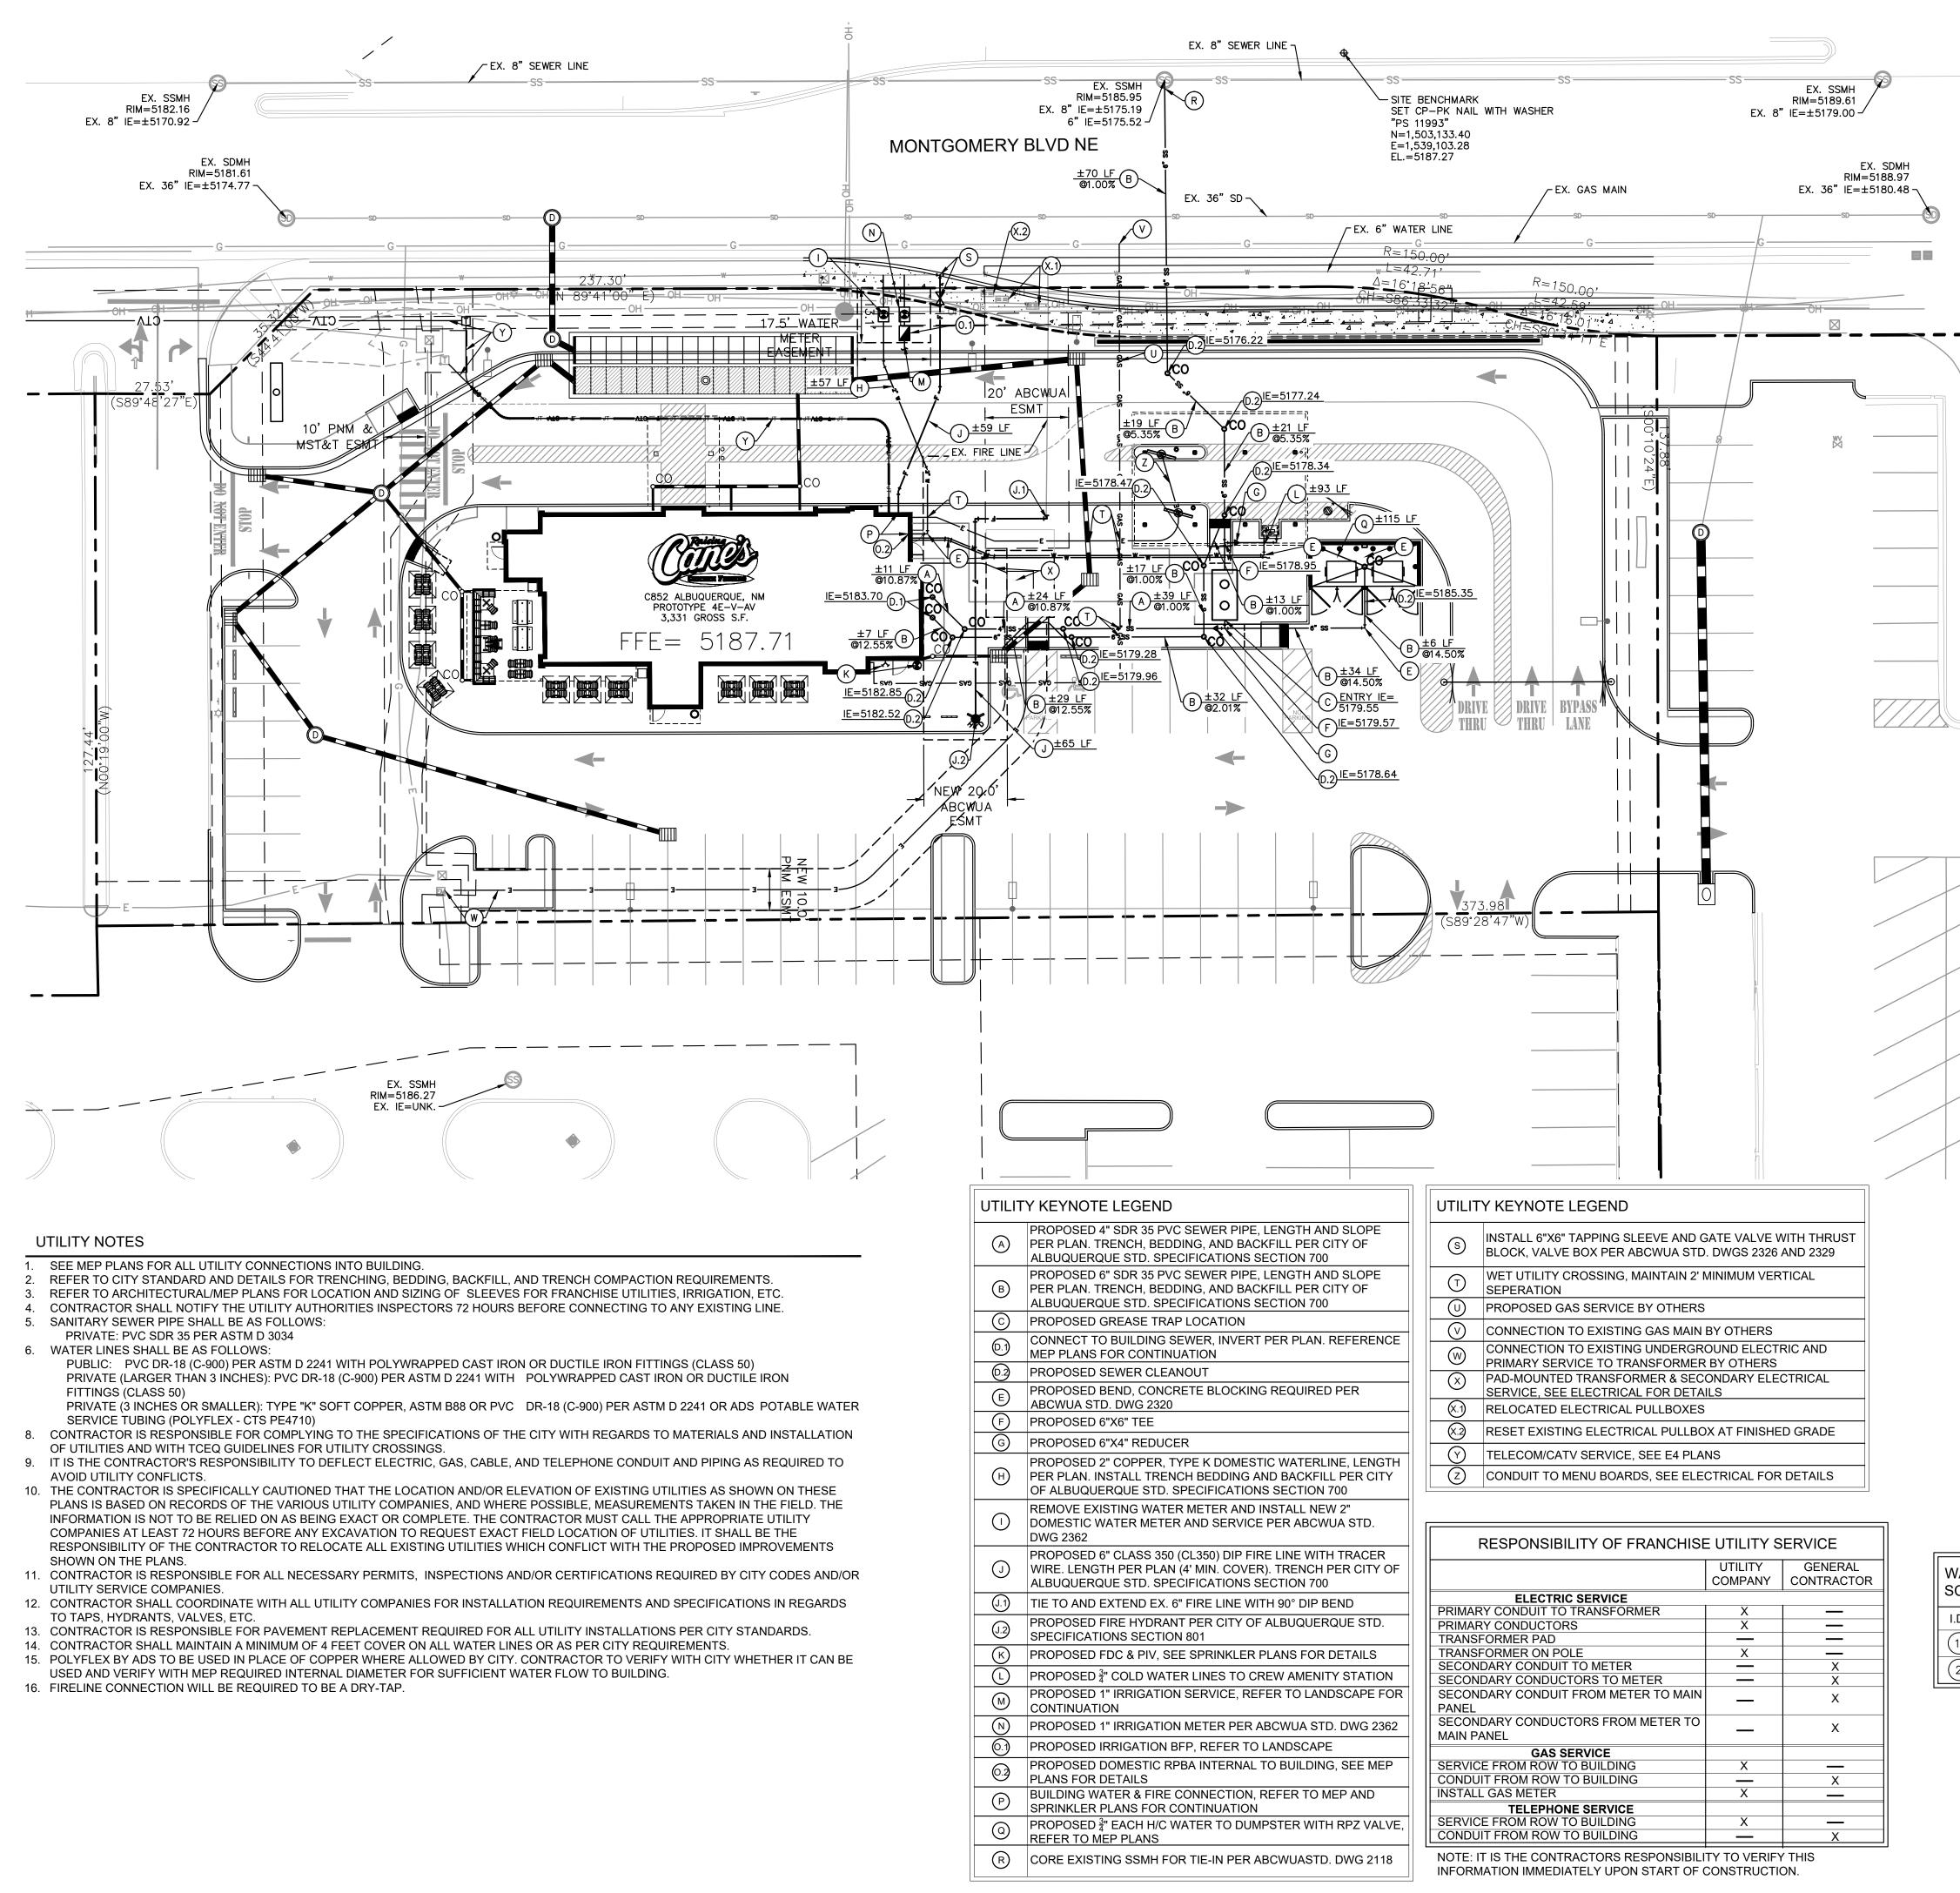

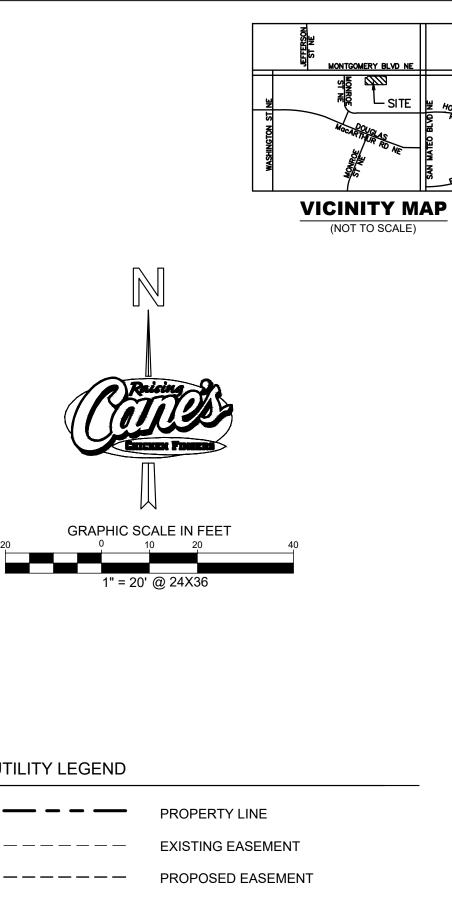


UTILITY	LEGEND	

	PROPERTY LINE
	EXISTING EASEMENT
	PROPOSED EASEMENT
	EXISTING FIRE LANE
S	PROPOSED SANITARY SEWER LINE
— w ——	PROPOSED WATER LINE
—— F ———	PROPOSED FIRE WATER LINE
GAS ——— GAS ——	PROPOSED UNDERGROUND GAS LINE
—— E ———	PROPOSED UNDERGROUND ELECTRIC LINE
T	PROPOSED UNDERGROUND TELEPHONE LINE
CATV	PROPOSED UNDERGROUND CABLE LINE
JT	PROPOSED JOINT TRENCH
	PROPOSED STORM DRAINAGE LINE
	EXISTING STORM DRAINAGE LINE
	EXISTING OVERHEAD POWER LINE
— GAS ——— GAS ———	EXISTING GAS LINE
W	EXISTING WATER LINE
SS	EXISTING SANITARY SEWER LINE
¢	PROPOSED FIRE HYDRANT
θ	PROPOSED WATER METER
o	PROPOSED SEWER CLEANOUT
\bowtie	PROPOSED WATER VALVE
Η	PROPOSED TEE
<u>~</u> Т	PROPOSED BEND
°CO	PROPOSED SEWER CLEAN OUT
Ø	EXISTING POWER POLE
¢	EXISTING FIRE HYDRANT
S	EXISTING SANITARY SEWER MANHOLE
	EXISTING SIGN

	ER METER (EDULE	& SEV	VER	
D.	TYPE	SIZE	NO.	SEWER
1)	DOMESTIC	1.5"	1	6"
2)	IRRIGATION	1"	1	



NOTE: ALL IMPROVEMENTS PROPOSED IN THE RIGHT-OF-WAY SHALL BE CONSTRUCTED PER CITY OF ALBUQUERQUE DRC PROJECT 642183 DRAWINGS.

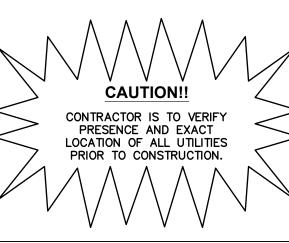





UTILITY PLAN

Date:	07.07.2022
Project Number:	090042000
Drawn By:	LW/LN

Sheet Number:

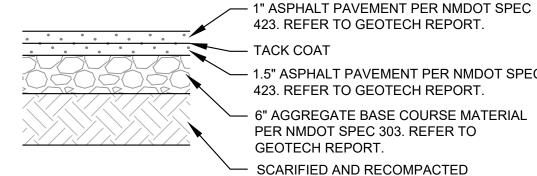


423. REFER TO GEOTECH REPORT. - TACK COAT 1.5" ASPHALT PAVEMENT PER NMDOT SPEC 423. REFER TO GEOTECH REPORT. 6" AGGREGATE BASE COURSE MATERIAL PER NMDOT SPEC 303. REFER TO GEOTECH REPORT. SCARIFIED AND RECOMPACTED SOIL PER GEOTECH REPORT

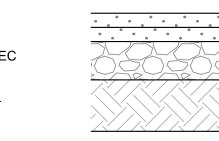

- 1.5" ASPHALT PAVEMENT PER NMDOT SPEC 423. REFER TO GEOTECH REPORT. - TACK COAT 2" ASPHALT PAVEMENT PER NMDOT SPEC 423. REFER TO GEOTECH REPORT. 6" AGGREGATE BASE COURSE MATERIAL PER NMDOT SPEC 303. REFER TO GEOTECH REPORT. SCARIFIED AND RECOMPACTED SOIL PER GEOTECH REPORT

LIGHT DUTY ASPHALT PAVEMENT SECTION

MEDIUM DUTY ASPHALT PAVEMENT SECTION

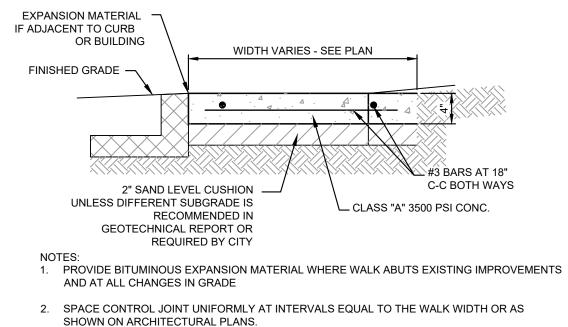

- 3. PLACE PREMOLDED EXPANSION JOINT MATERIAL AROUND ALL STRUCTURES IN NEW WALK ALONGSIDE ALL ADJACENT BUILDINGS AND ABUTTING STRUCTURES TO THE NEW CONCRETE SIDEWALK
- 4. SEAL EXPANSION & CONTRACTION JOINTS WITH AN APPROVED TYPE SEALANT.
- 5. SIDEWALK PAVEMENT WHERE PATIO FURNITURE IS TO BE PLACED MUST BE 4000 PSI.

NOTE REFER TO GEOTECH REPORT FOR FURTHER INFORMATION.




MANUFACTURER: BELGARD PHONE: 877-235-4273 WEB: WWW.BELGARD.COM

PATTERN: HERRINGBONE


PRODUCT: HOLLAND STONE LEGACY


NOTES: 1. PAVER JOINTS TO BE BUTT TIGHT


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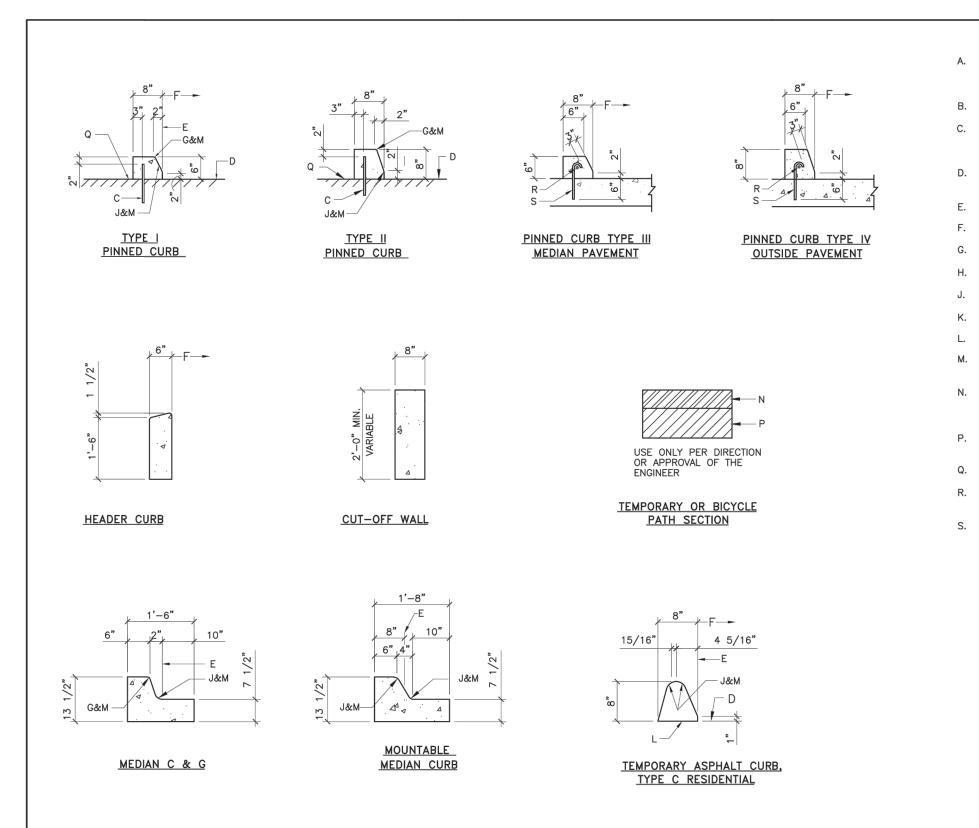


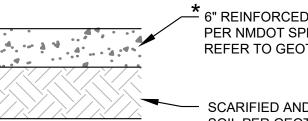
INTEGRAL COLORED STANDARD DUTY CONCRETE PAVEMENT SECTION



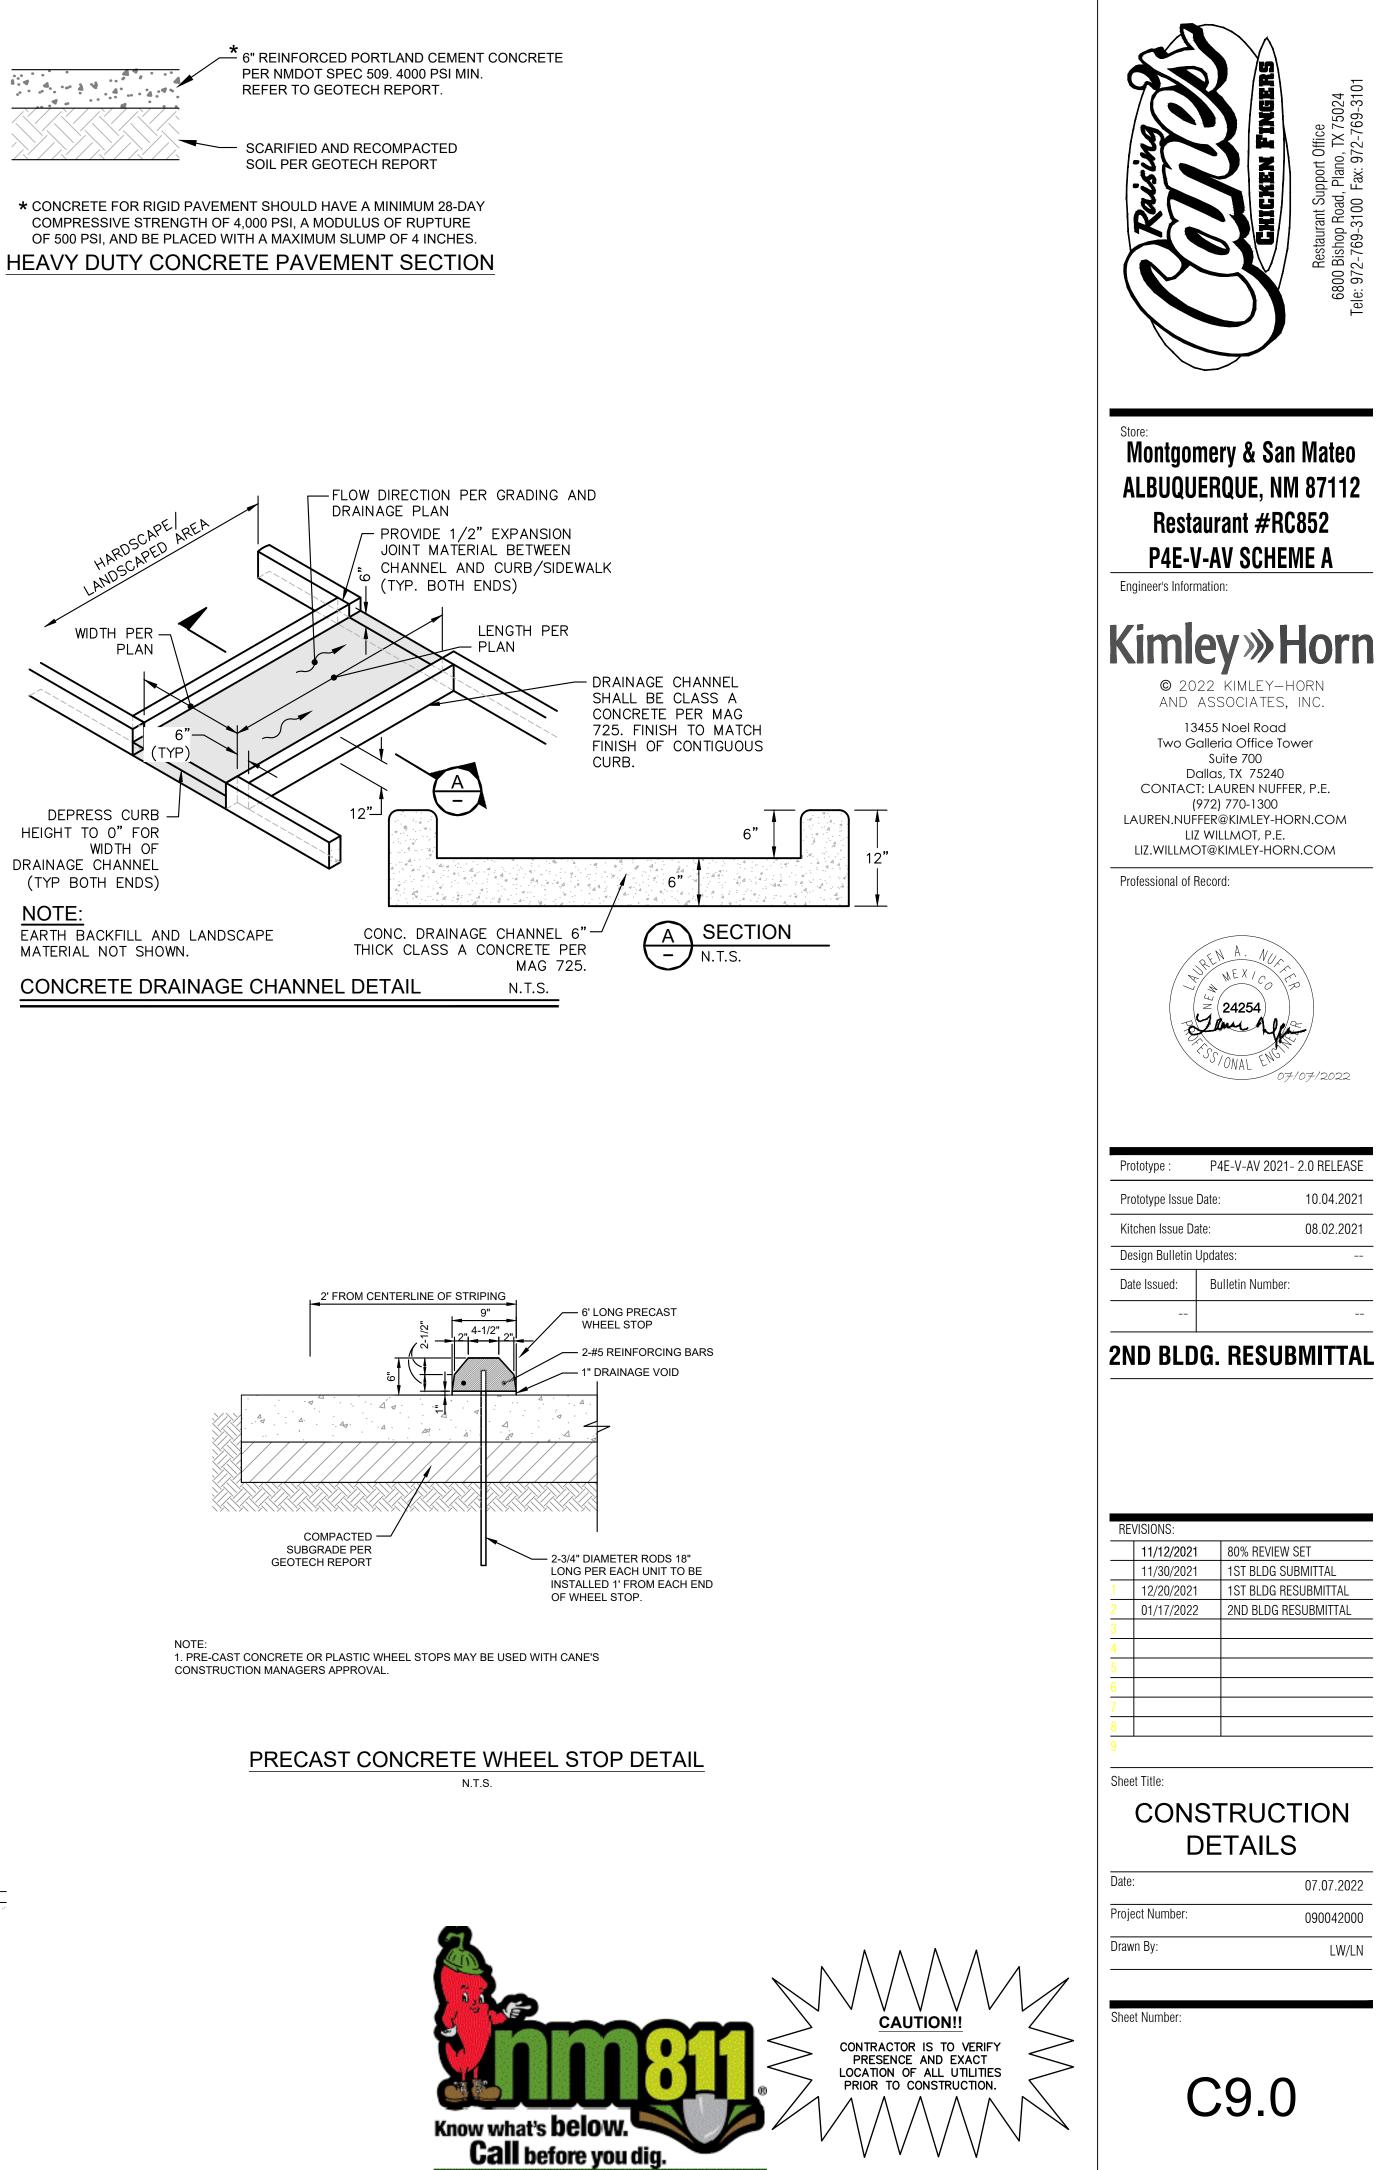


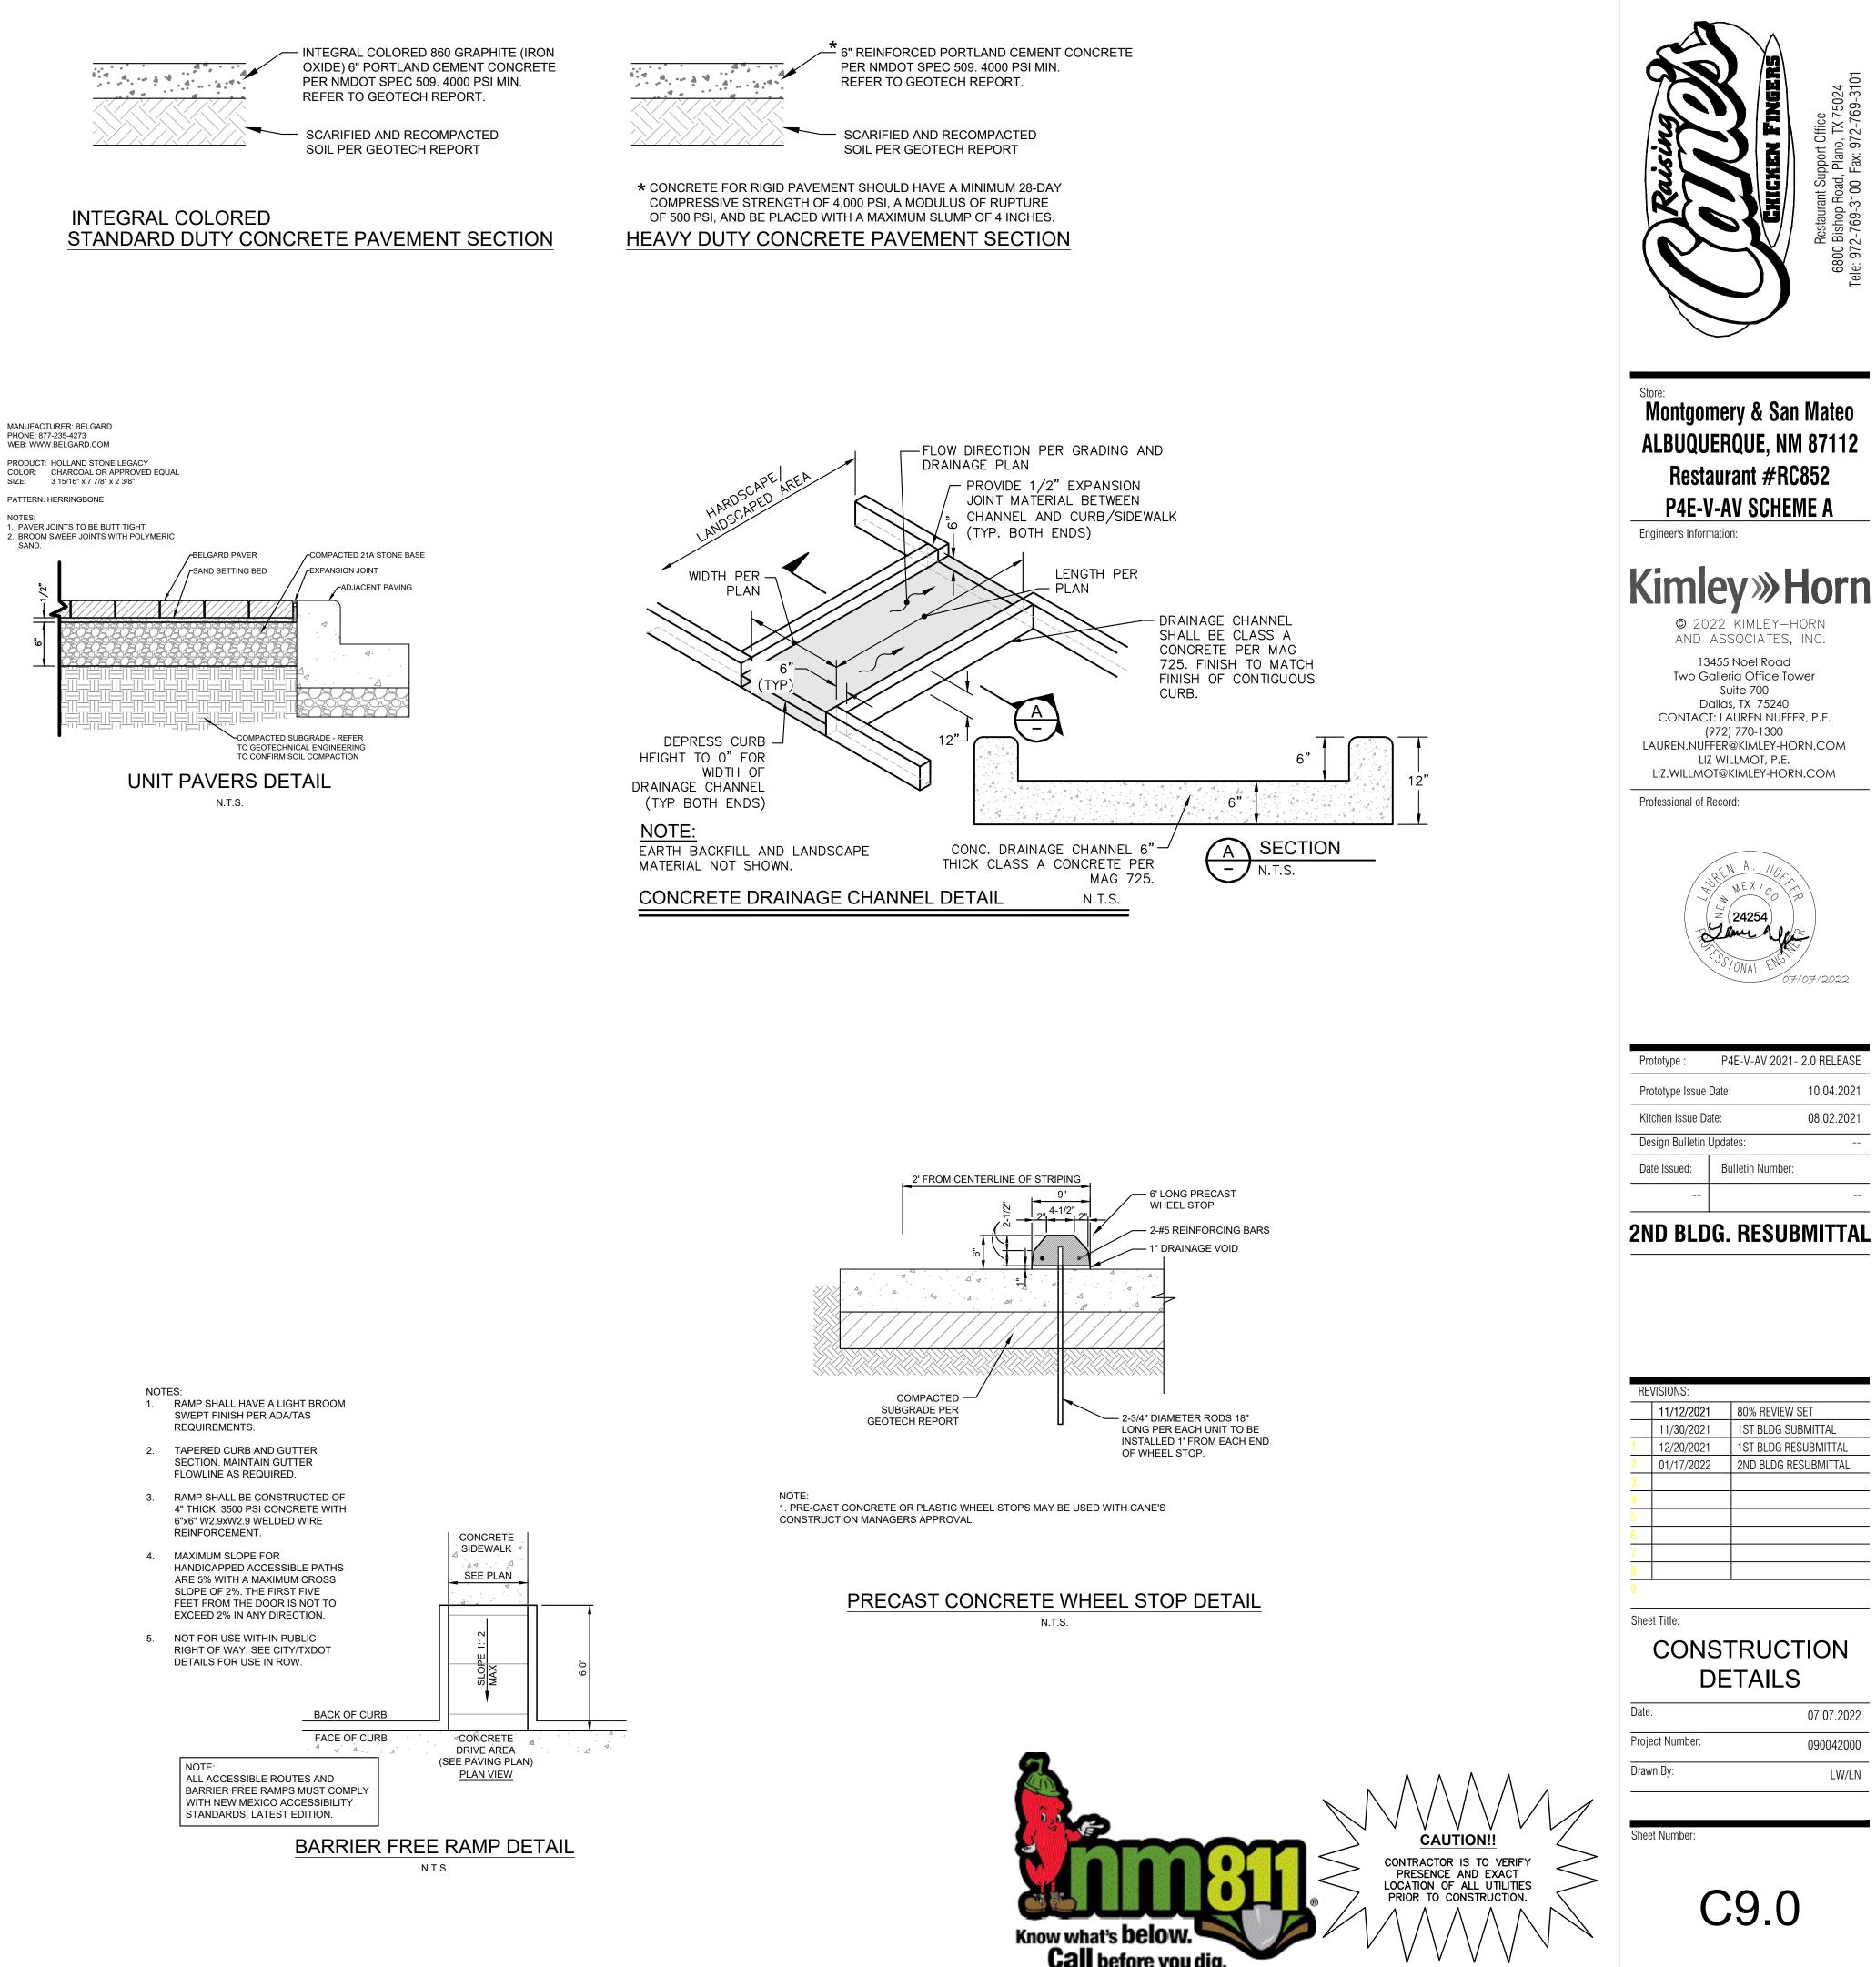


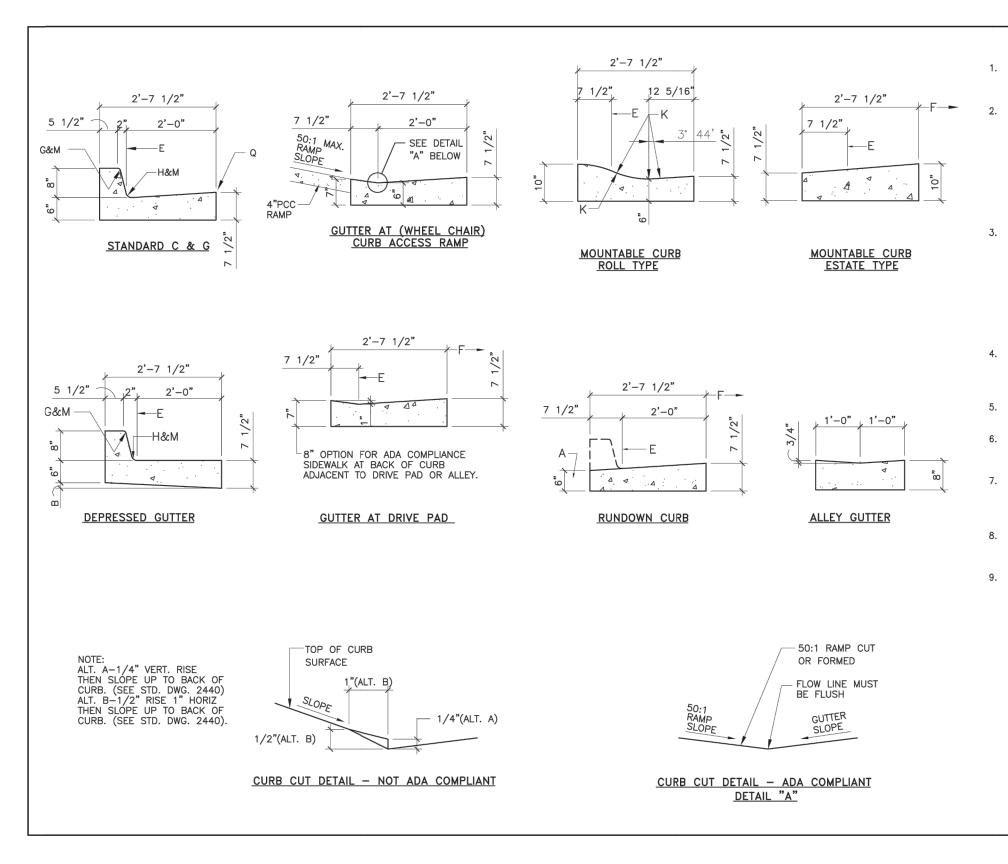


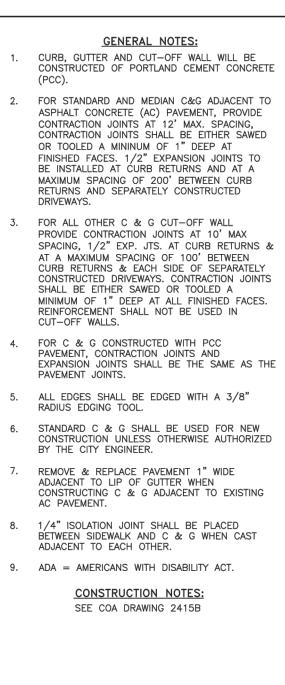

REVISIONS	CIT	Y OF	ALBUQUERQUE
9/91			PAVING
11/14/91 12/15/92 3/30/94			AND GUTTER & B CUT DETAILS
	DWG.	2415A	JANUARY 2003

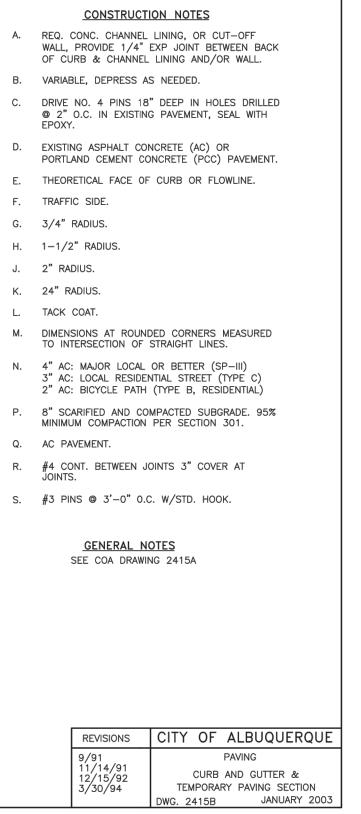

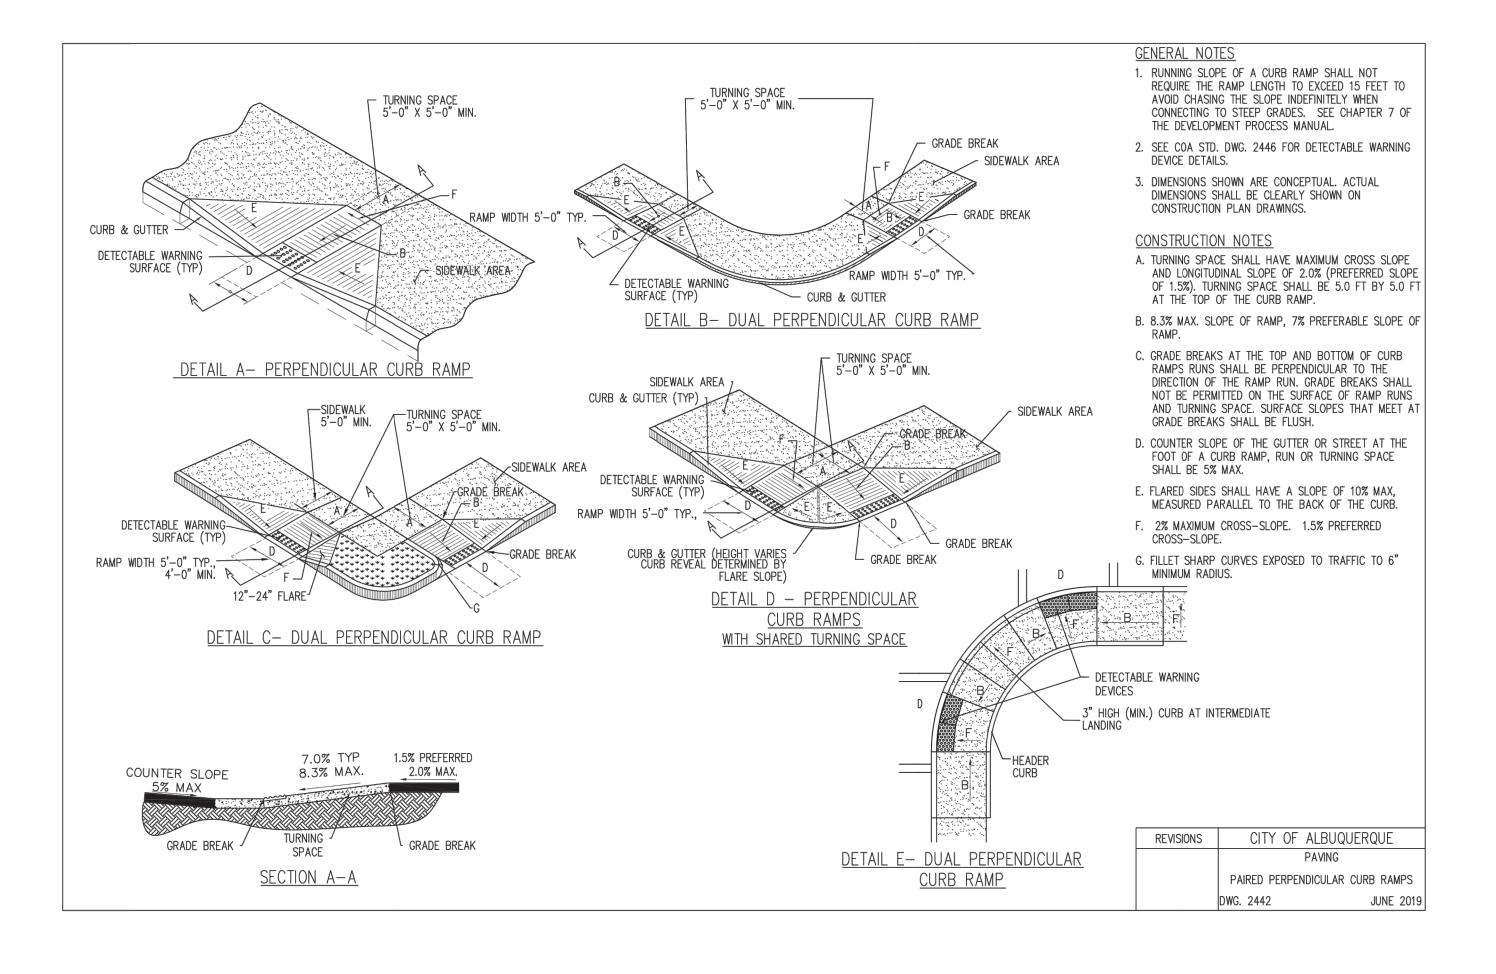

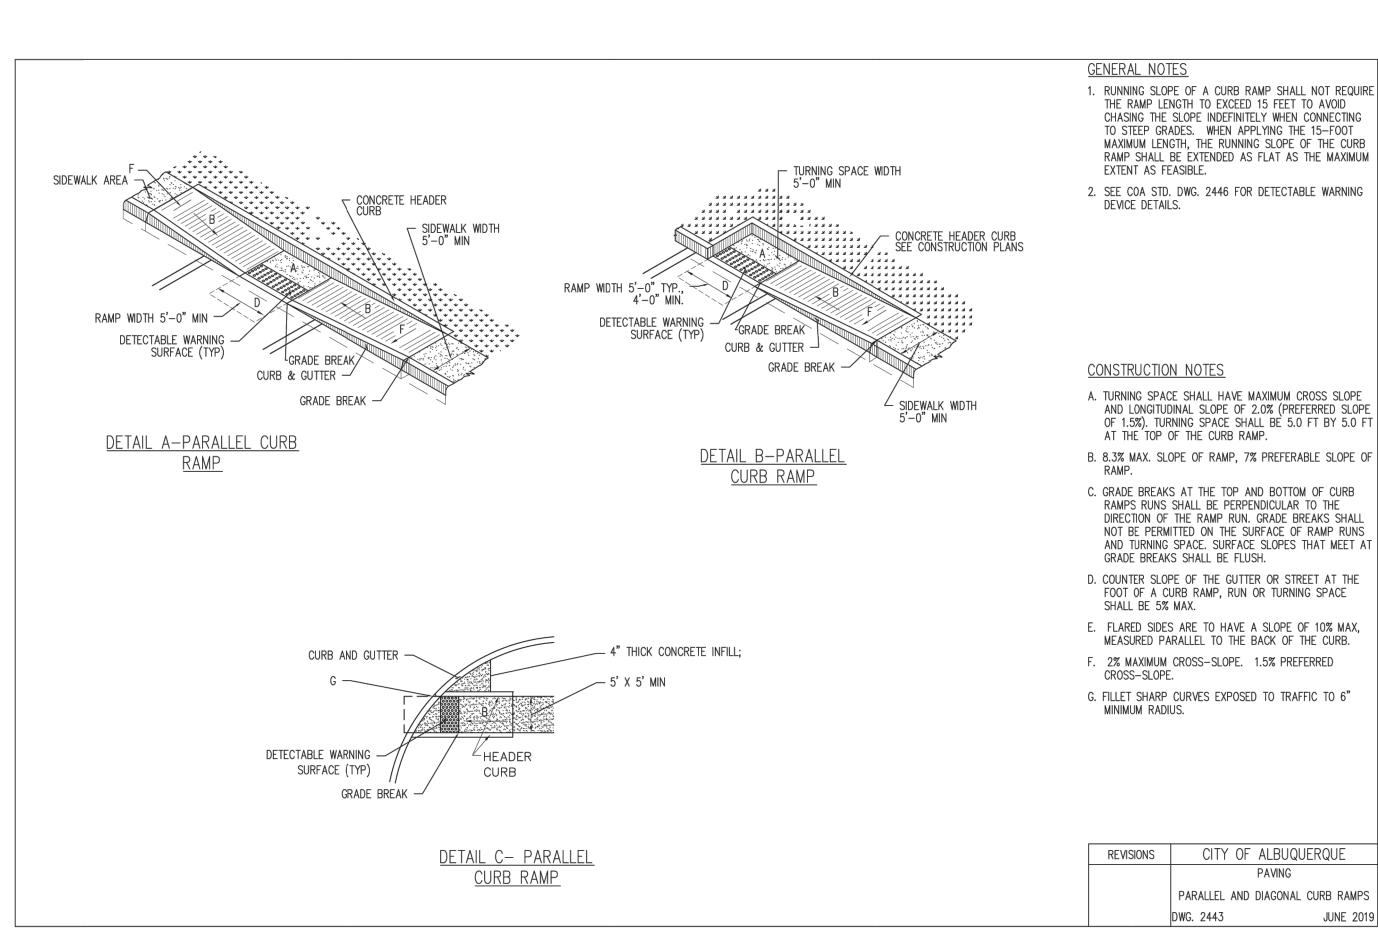






Raising	CKICKEN FINGERS Restaurant Support Office 6800 Bishop Road, Plano, TX 75024 Tele: 972-769-3100 Fax: 972-769-3101
ALBUQUER Restaur	ry & San Mateo QUE, NM 87112 rant #RC852 V SCHEME A
© 2022 AND ASS Two Galler Su Dallas CONTACT: LA (972) LAUREN.NUFFER LIZ WI	KIMLEY-HORN SOCIATES, INC. Noel Road ria Office Tower uite 700 s, TX 75240 AUREN NUFFER, P.E.) 770-1300 @KIMLEY-HORN.COM LLMOT, P.E. KIMLEY-HORN.COM
Professional of Record	rd: A. NUME 24254 VONAL ENG 07/07/2022
Prototype : P4	4E-V-AV 2021- 2.0 RELEASE
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C10.0

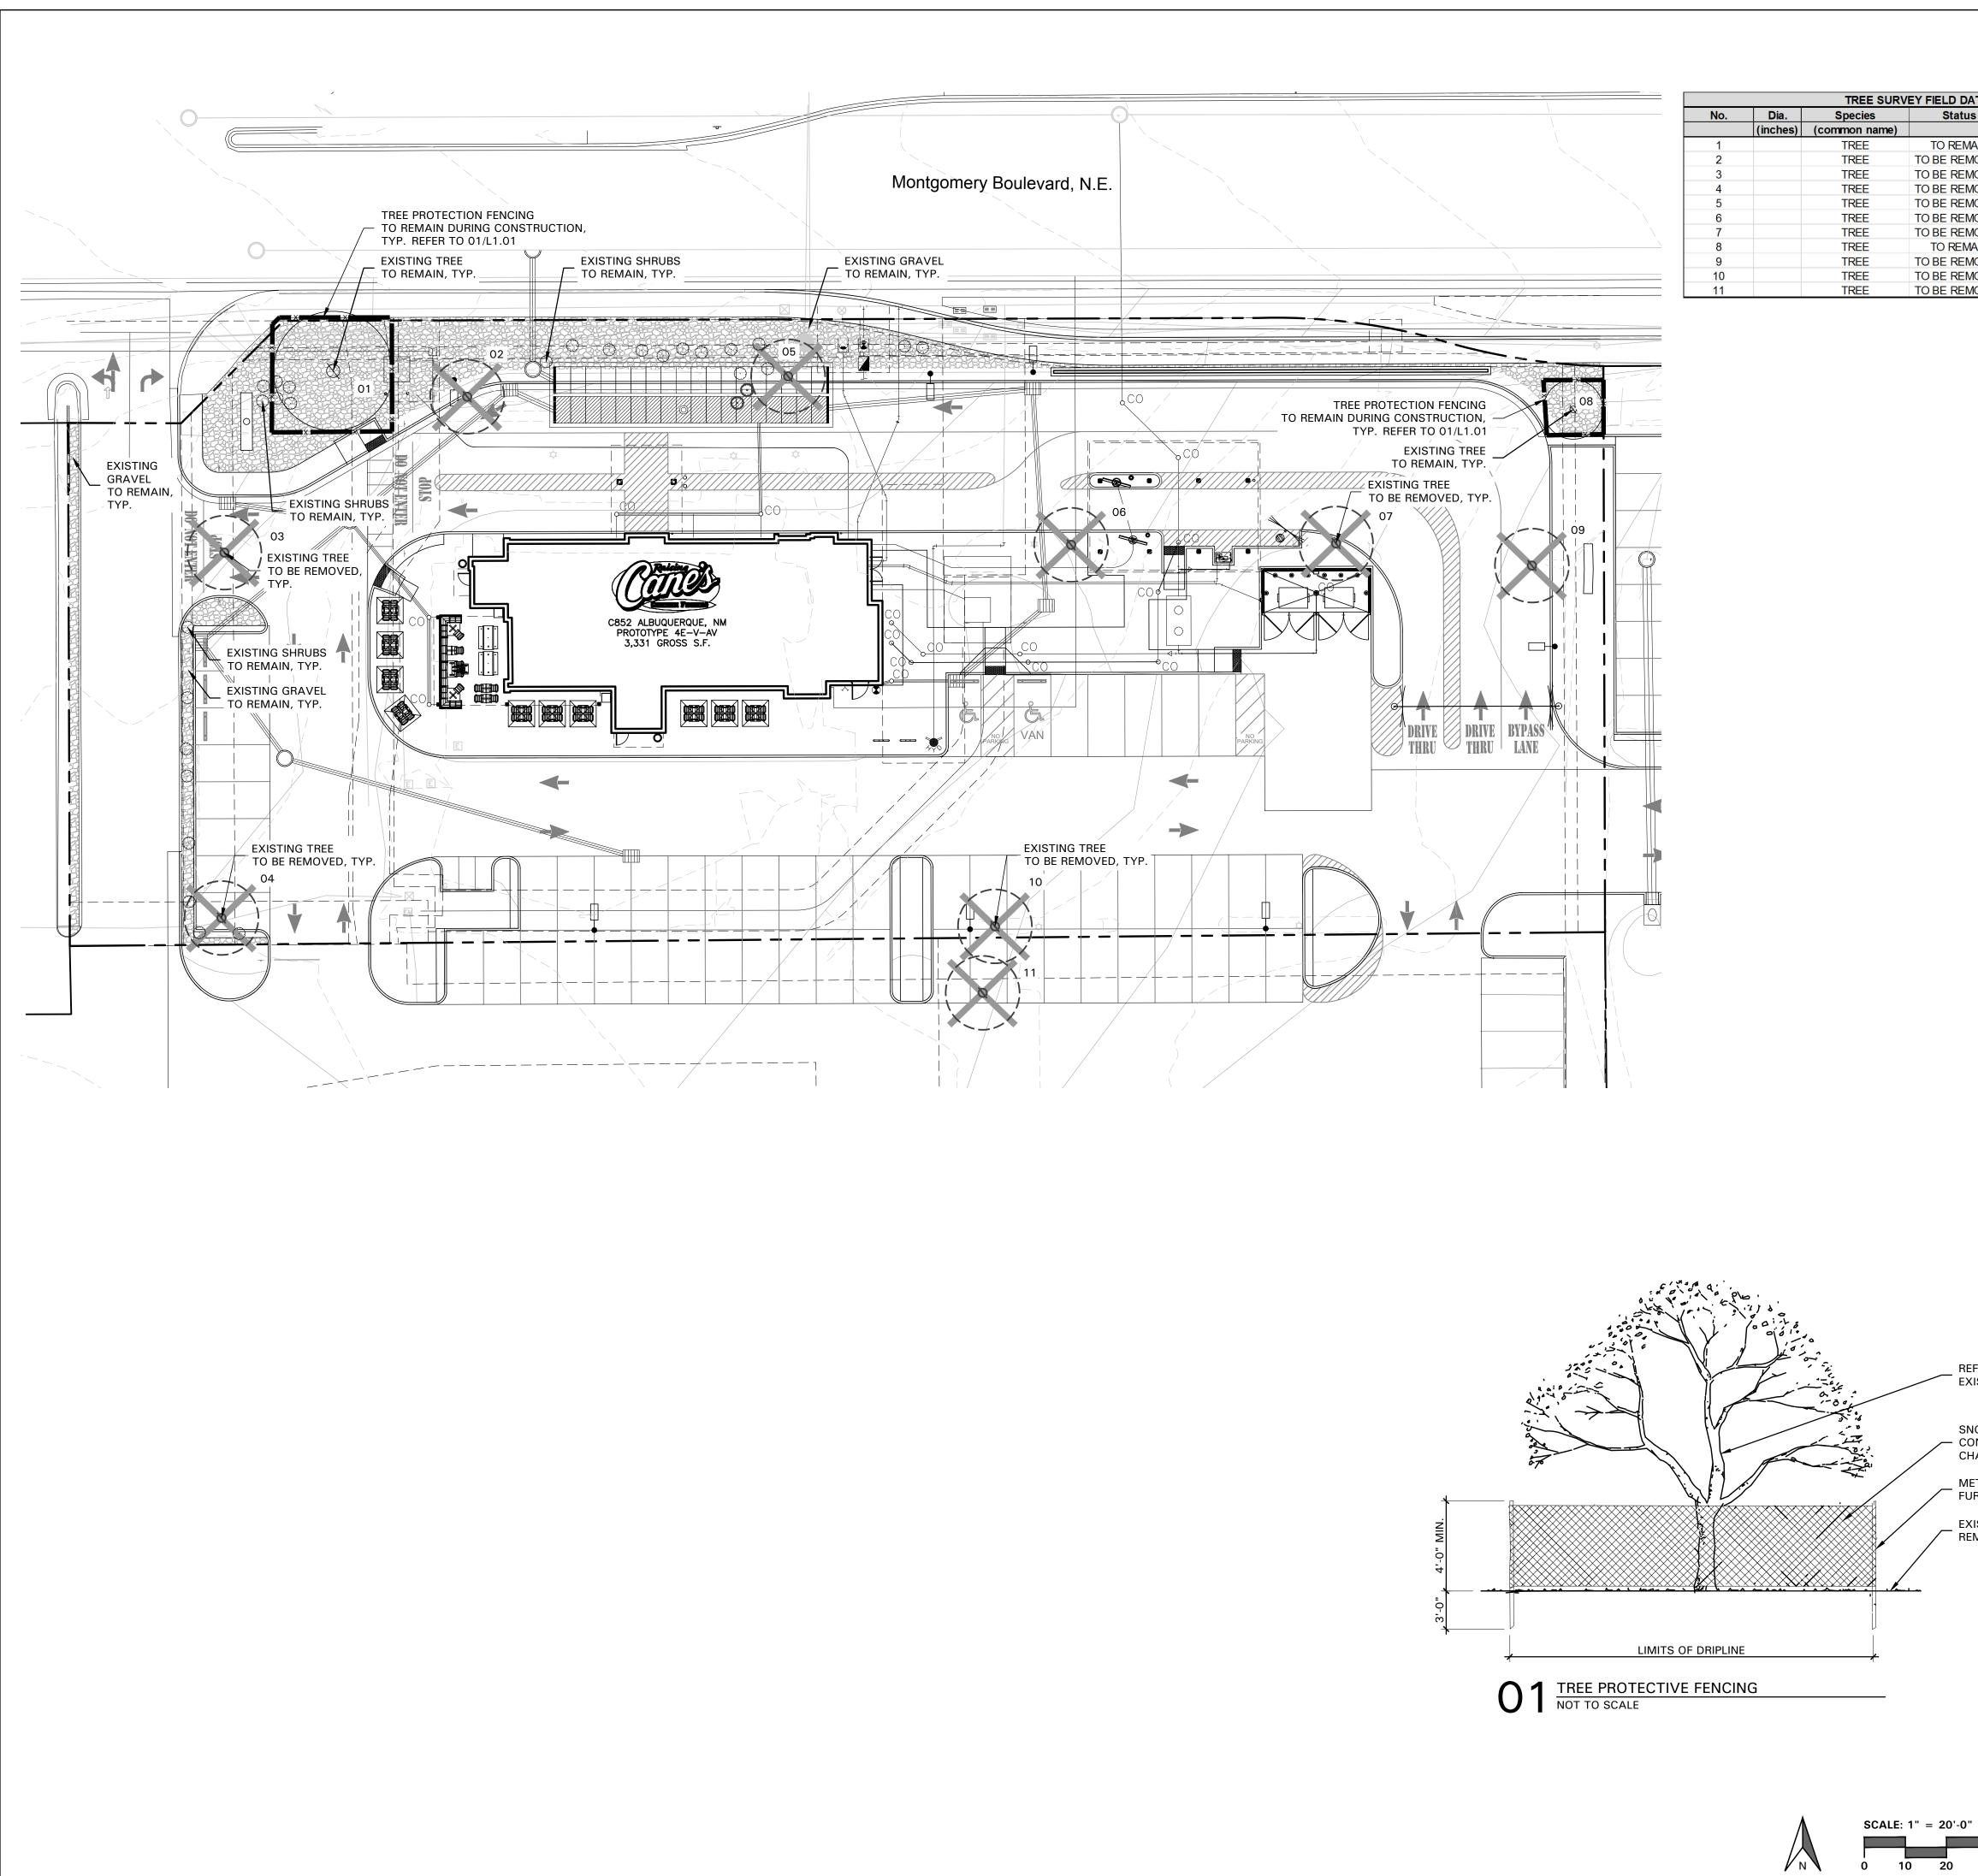

TREE SURVEY FIELD DATA				
No.	Dia.	Species	Status	Remarks
	(inches)	(common name)		
1		TREE	TO REMAIN	
2		TREE	TO BE REMOVED	
3		TREE	TO BE REMOVED	
4		TREE	TO BE REMOVED	
5		TREE	TO BE REMOVED	
6		TREE	TO BE REMOVED	
7		TREE	TO BE REMOVED	
8		TREE	TO REMAIN	
9		TREE	TO BE REMOVED	
10		TREE	TO BE REMOVED	
11		TREE	TO BE REMOVED	


TREE PRESERVATION NOTES

- 1. EXISTING TREES TO REMAIN SHALL BE PROTECTED DURING CONSTRUCTION FROM TREE STRUCTURE DAMAGE AND COMPACTION OF SOIL UNDER AND AROUND DRIP LINE (CANOPY) OF TREE.
- 2. IF ANY ROOT STRUCTURE IS DAMAGED DURING ADJACENT EXCAVATION / CONSTRUCTION, NOTIFY OWNER'S AUTHORIZED REPRESENTATIVE IMMEDIATELY. IT IS RECOMMENDED THAT A LICENSED ARBORIST BE SECURED FOR THE TREATMENT OF ANY POSSIBLE TREE WOUNDS.
- 3. NO DISTURBANCE OF THE SOIL GREATER THAN 4" SHALL BE LOCATED CLOSER TO THE TREE TRUNK THAN 1/2 THE DISTANCE OF THE DRIP LINE TO THE TREE TRUNK. A MINIMUM OF 75% OF THE DRIP LINE AND ROOT ZONE SHALL BE PRESERVED AT NATURAL GRADE.
- 4. ANY FINE GRADING DONE WITHIN THE CRITICAL ROOT ZONES OF THE PROTECTED TREES MUST BE DONE WITH LIGHT MACHINERY SUCH AS A BOBCAT OR LIGHT TRACTOR. NO EARTH MOVING EQUIPMENT WITH TRACKS IS ALLOWED WITHIN THE CRITICAL ROOT ZONE OF THE TREES.
- 5. NO MATERIALS INTENDED FOR USE IN CONSTRUCTION OR WASTE MATERIALS ACCUMULATED DUE TO EXCAVATION OR DEMOLITION SHALL BE PLACED WITHIN THE LIMITS OF THE DRIP LINE OF ANY TREE.
- 6. NO EQUIPMENT MAY BE CLEANED OR TOXIC SOLUTIONS, OR OTHER LIQUID CHEMICALS, SHALL BE DEPOSITED WITHIN THE LIMITS OF THE DRIP LINE OF A TREE, INCLUDING BUT NOT LIMITED TO: PAINT, OIL, SOLVENTS, ASPHALT, CONCRETE, MORTAR, PRIMERS, ETC.
- 7. NO SIGNS, WIRES OR OTHER ATTACHMENTS, OTHER THAN THOSE OF A PROTECTIVE NATURE, SHALL BE ATTACHED TO ANY TREE.
- 8. NO VEHICULAR / CONSTRUCTION EQUIPMENT TRAFFIC OR PARKING IS ALLOWED WITHIN THE LIMITS OF THE DRIP LINE OF TREES.
- 9. BORING OF UTILITIES MAY BE PERMITTED UNDER PROTECTED TREES IN CERTAIN CIRCUMSTANCES. THE MINIMUM LENGTH OF THE BORE SHALL BE THE WIDTH OF THE TREE'S CANOPY AND SHALL BE A MINIMUM DEPTH OF FORTY-EIGHT (48") INCHES.
- 10. IRRIGATION TRENCHING WHICH MUST BE DONE WITHIN THE CRITICAL ROOT ZONE OF A TREE SHALL BE DUG BY HAND AND ENTER THE AREA IN A RADIAL MANNER.
- 11. ALL TREES TO BE REMOVED FROM THE SITE SHALL BE FLAGGED BY THE CONTRACTOR WITH BRIGHT RED VINYL TAPE (3" WIDTH) WRAPPED AROUND THE MAIN TRUNK AT A HEIGHT OF FOUR (4') FEET ABOVE GRADE. FLAGGING SHALL BE APPROVED BY OWNER'S AUTHORIZED REPRESENTATIVE PRIOR TO ANY TREE REMOVAL. CONTRACTOR SHALL CONTACT OWNER'S AUTHORIZED REPRESENTATIVE WITH 72 HOURS NOTICE TO SCHEDULE ON-SITE MEETING.
- 12. ALL TREES TO REMAIN, AS NOTED ON DRAWINGS, SHALL HAVE PROTECTIVE FENCING LOCATED AT THE TREE'S DRIP LINE. THE PROTECTIVE FENCING MAY BE COMPRISED OF SNOW FENCING, ORANGE VINYL CONSTRUCTION FENCING, CHAIN LINK FENCE OR OTHER SIMILAR FENCING WITH A FOUR (4') FOOT APPROXIMATE HEIGHT. THE PROTECTIVE FENCING SHALL BE LOCATED AS INDICATED ON THE TREE PROTECTION DETAIL.
- 13. WHEN A LOW HANGING LIMB IS BROKEN DURING THE COURSE OF CONSTRUCTION, THE CONTRACTOR SHALL NOTIFY THE OWNER'S AUTHORIZED REPRESENTATIVE IMMEDIATELY. UNDER NO CIRCUMSTANCE SHALL THE CONTRACTOR PRUNE ANY PORTION OF THE DAMAGED TREE WITHOUT THE PRIOR APPROVAL BY THE OWNER'S AUTHORIZED REPRESENTATIVE.

EXISTING TREE LEGEND



EXISTING TREE TO REMAIN

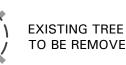


EXISTING SHRUBS

TO BE REMOVED

TREE PROTECTION FENCING TO REMAIN DURING CONSTRUCTION REFER TO 01/L1.01

Lund TO REMAIN $\sim\sim\sim$

EXISTING SHRUBS TO BE REMOVED TO 12" BELOW GRADE, TYP.

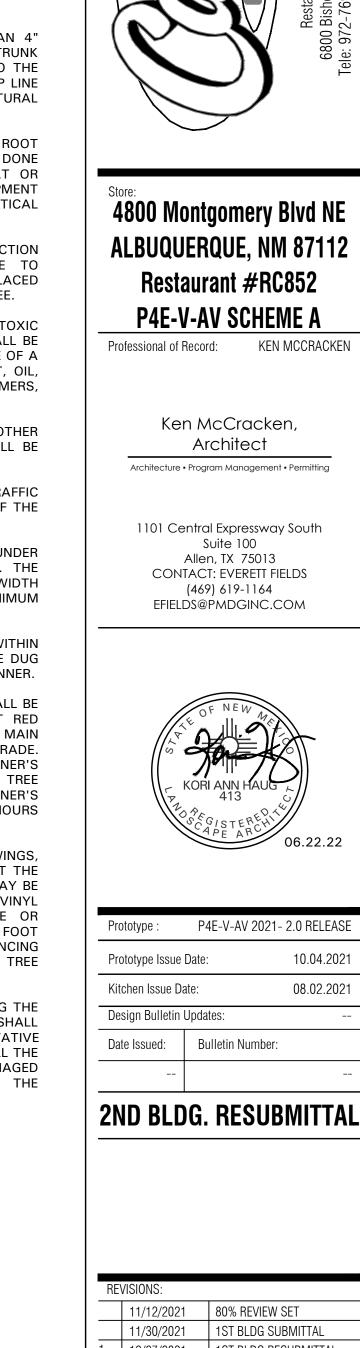

	11/12/2021	80% REVIEW SET
	11/30/2021	1ST BLDG SUBMITTAL
1	12/27/2021	1ST BLDG RESUBMITTAL
2	01/17/2022	2ND BLDG RESUBMITTAL
3	06/07/2022	CITY COMMENTS
4	06/22/2022	CITY COMMENTS
5		
6		
7		
8		
9		
· _ ·		
Sheet Title:		

TREE PRESERVATION PLAN

Date:	06.22.2022
Project Number:	RAC21059.0
Drawn By:	TM/KH

Sheet Number:



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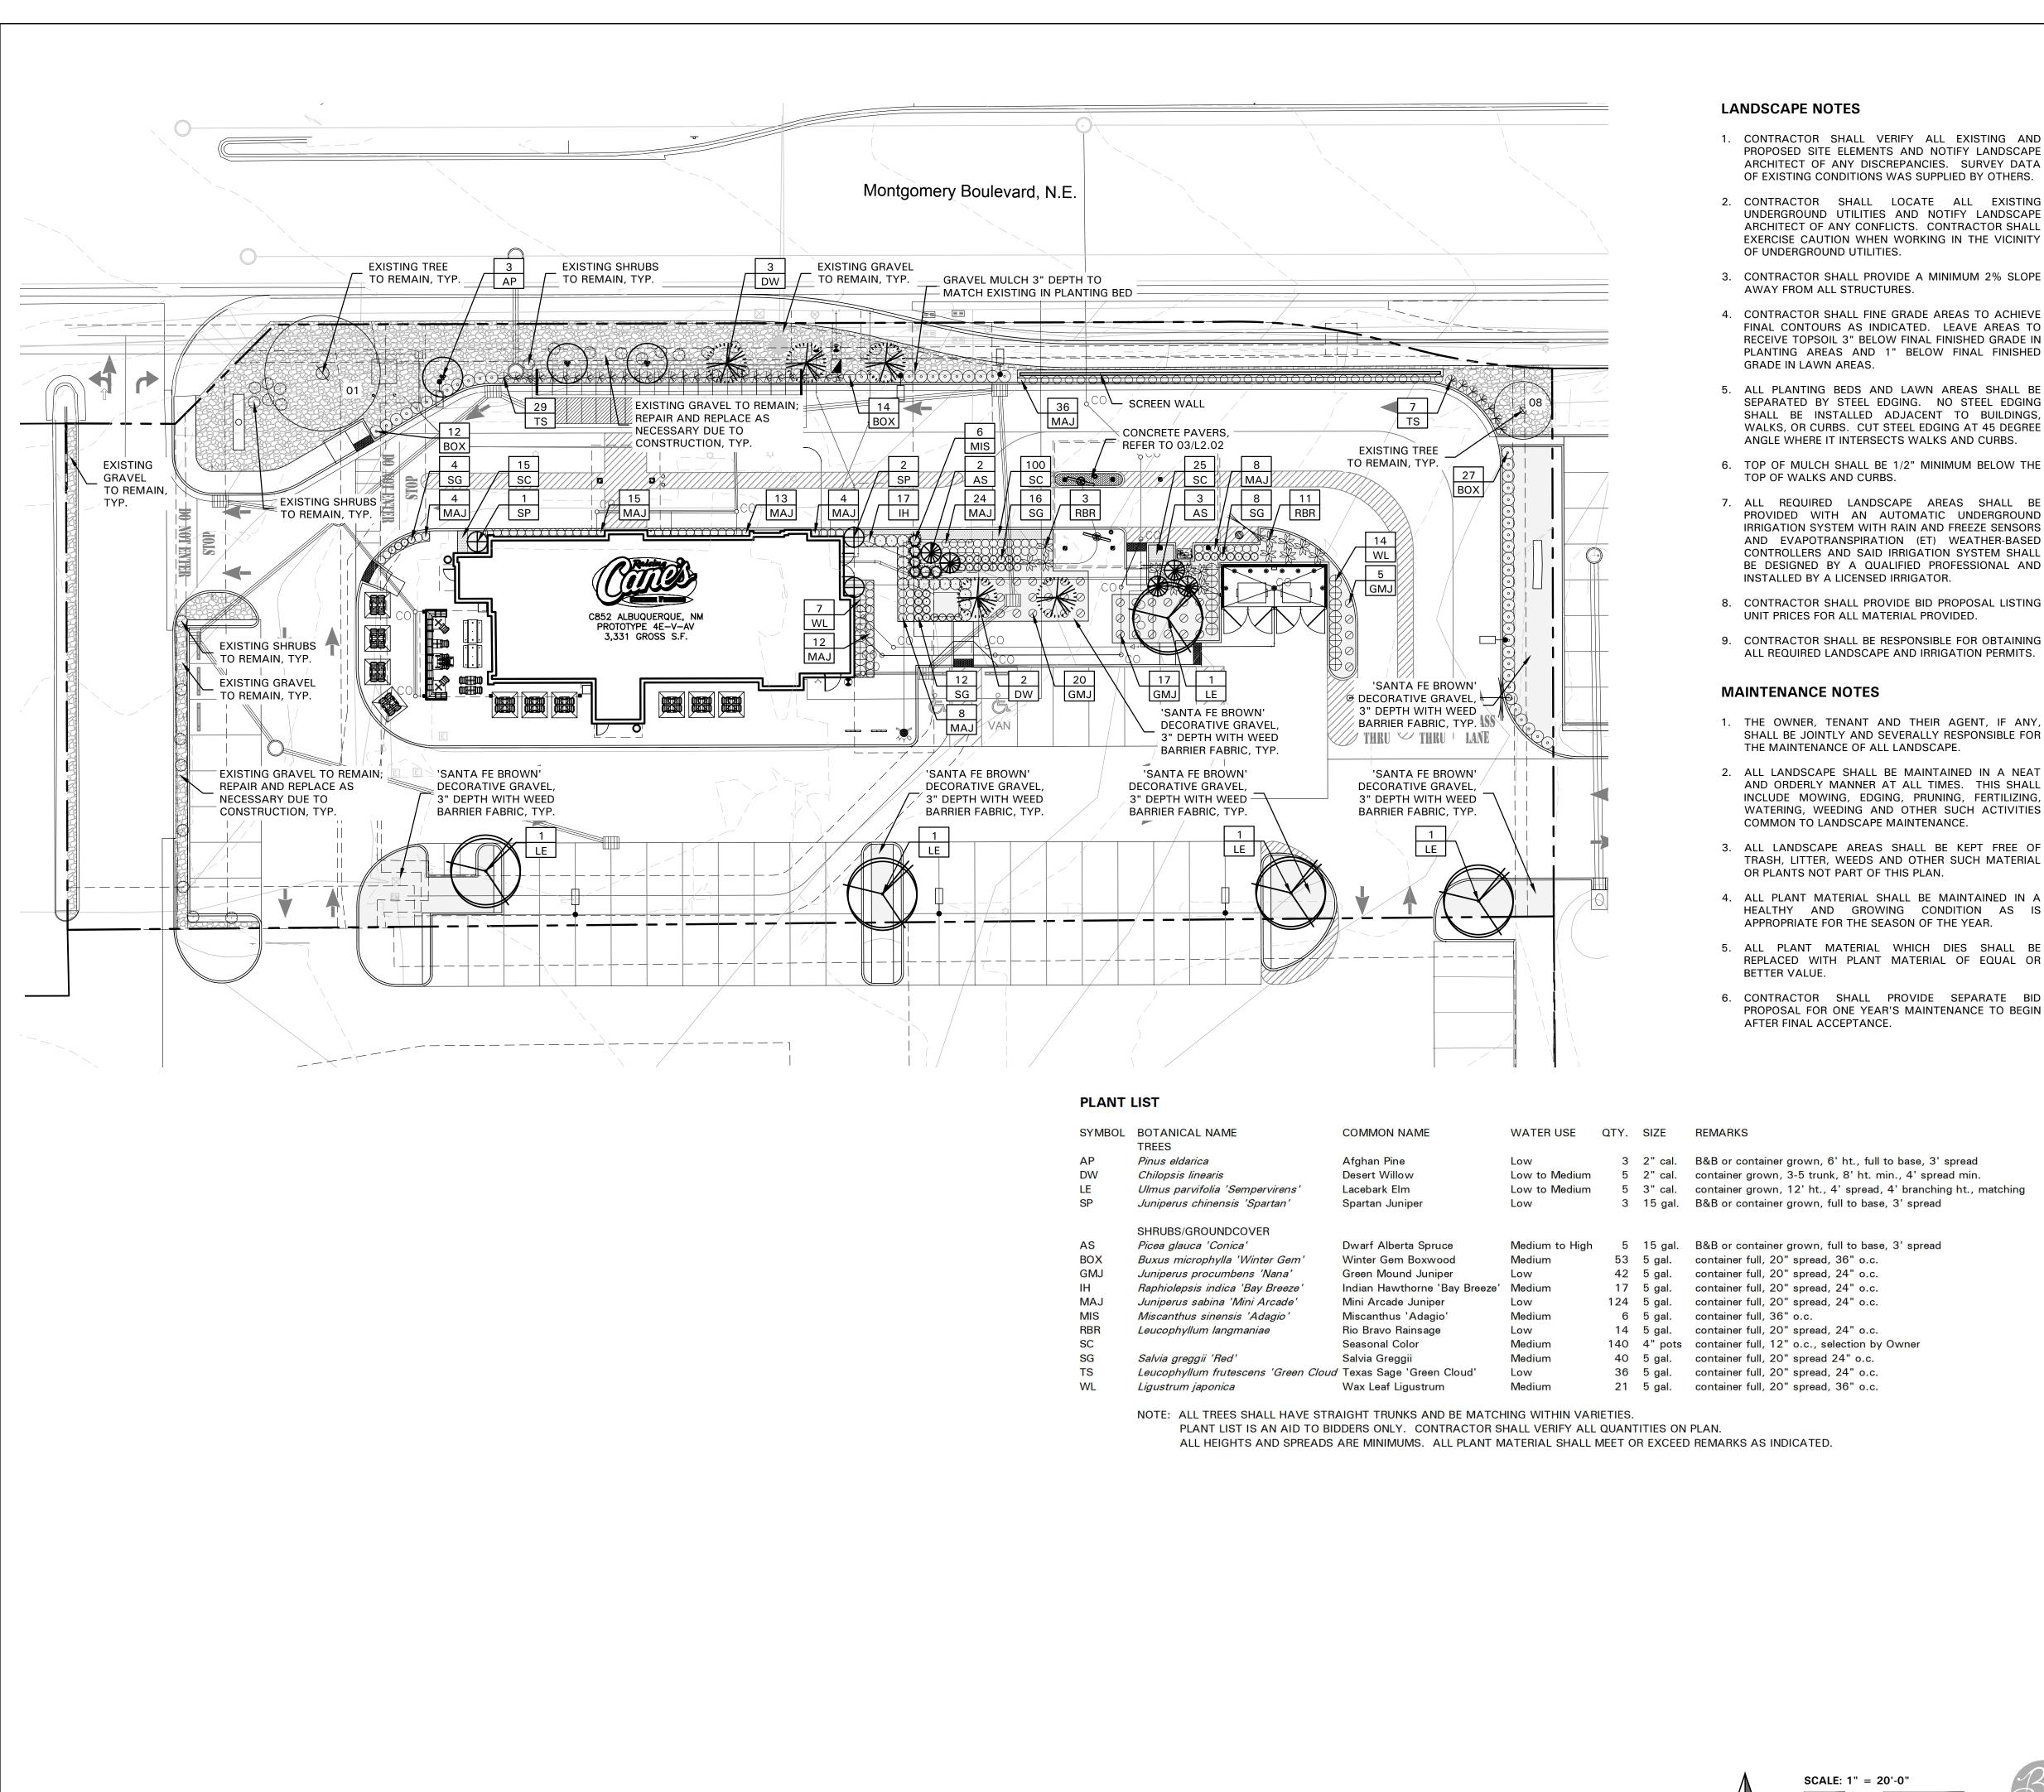
L1.01

REFER TO PLAN FOR EXISTING TREE TO REMAIN

SNOW FENCE, ORANGE VINYL - CONSTRUCTION FENCE, OR CHAINLINK FENCE METAL T-POST PLACED NO FURTHER THAN 8' APART

EXISTING GRADE TO REMAIN UNDISTURBED





3 2" cal. B&B or container grown, 6' ht., full to base, 3' spread 5 2" cal. container grown, 3-5 trunk, 8' ht. min., 4' spread min. 5 3" cal. container grown, 12' ht., 4' spread, 4' branching ht., matching 3 15 gal. B&B or container grown, full to base, 3' spread 5 15 gal. B&B or container grown, full to base, 3' spread 53 5 gal. container full, 20" spread, 36" o.c. 42 5 gal. container full, 20" spread, 24" o.c. 17 5 gal. container full, 20" spread, 24" o.c. 124 5 gal. container full, 20" spread, 24" o.c. 14 5 gal. container full, 20" spread, 24" o.c. 140 4" pots container full, 12" o.c., selection by Owner 40 5 gal. container full, 20" spread 24" o.c. 36 5 gal. container full, 20" spread, 24" o.c. 21 5 gal. container full, 20" spread, 36" o.c.


LANDSCAPE NOTES

- OF UNDERGROUND UTILITIES.
- AWAY FROM ALL STRUCTURES.
- GRADE IN LAWN AREAS.
- TOP OF WALKS AND CURBS.
- INSTALLED BY A LICENSED IRRIGATOR.
- UNIT PRICES FOR ALL MATERIAL PROVIDED.

MAINTENANCE NOTES

- THE MAINTENANCE OF ALL LANDSCAPE.
- COMMON TO LANDSCAPE MAINTENANCE.
- OR PLANTS NOT PART OF THIS PLAN.
- APPROPRIATE FOR THE SEASON OF THE YEAR.
- BETTER VALUE.
- AFTER FINAL ACCEPTANCE.



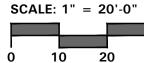

1. CONTRACTOR SHALL VERIFY ALL EXISTING AND PROPOSED SITE ELEMENTS AND NOTIFY LANDSCAPE ARCHITECT OF ANY DISCREPANCIES. SURVEY DATA OF EXISTING CONDITIONS WAS SUPPLIED BY OTHERS.

UNDERGROUND UTILITIES AND NOTIFY LANDSCAPE ARCHITECT OF ANY CONFLICTS. CONTRACTOR SHALL EXERCISE CAUTION WHEN WORKING IN THE VICINITY

3. CONTRACTOR SHALL PROVIDE A MINIMUM 2% SLOPE

4. CONTRACTOR SHALL FINE GRADE AREAS TO ACHIEVE FINAL CONTOURS AS INDICATED. LEAVE AREAS TO RECEIVE TOPSOIL 3" BELOW FINAL FINISHED GRADE IN PLANTING AREAS AND 1" BELOW FINAL FINISHED

5. ALL PLANTING BEDS AND LAWN AREAS SHALL BE SEPARATED BY STEEL EDGING. NO STEEL EDGING SHALL BE INSTALLED ADJACENT TO BUILDINGS, WALKS, OR CURBS. CUT STEEL EDGING AT 45 DEGREE ANGLE WHERE IT INTERSECTS WALKS AND CURBS.

6. TOP OF MULCH SHALL BE 1/2" MINIMUM BELOW THE

7. ALL REQUIRED LANDSCAPE AREAS SHALL BE PROVIDED WITH AN AUTOMATIC UNDERGROUND IRRIGATION SYSTEM WITH RAIN AND FREEZE SENSORS AND EVAPOTRANSPIRATION (ET) WEATHER-BASED CONTROLLERS AND SAID IRRIGATION SYSTEM SHALL BE DESIGNED BY A QUALIFIED PROFESSIONAL AND

8. CONTRACTOR SHALL PROVIDE BID PROPOSAL LISTING

9. CONTRACTOR SHALL BE RESPONSIBLE FOR OBTAINING ALL REQUIRED LANDSCAPE AND IRRIGATION PERMITS.

1. THE OWNER, TENANT AND THEIR AGENT, IF ANY, SHALL BE JOINTLY AND SEVERALLY RESPONSIBLE FOR

2. ALL LANDSCAPE SHALL BE MAINTAINED IN A NEAT AND ORDERLY MANNER AT ALL TIMES. THIS SHALL INCLUDE MOWING, EDGING, PRUNING, FERTILIZING, WATERING, WEEDING AND OTHER SUCH ACTIVITIES

3. ALL LANDSCAPE AREAS SHALL BE KEPT FREE OF TRASH, LITTER, WEEDS AND OTHER SUCH MATERIAL

4. ALL PLANT MATERIAL SHALL BE MAINTAINED IN A HEALTHY AND GROWING CONDITION AS IS

5. ALL PLANT MATERIAL WHICH DIES SHALL BE REPLACED WITH PLANT MATERIAL OF EQUAL OR

6. CONTRACTOR SHALL PROVIDE SEPARATE BID PROPOSAL FOR ONE YEAR'S MAINTENANCE TO BEGIN

CONCRETE PAVER NOTES

1. CONTRACTOR SHALL ADHERE TO THE MANUFACTURER'S INSTALLATION GUIDELINES, SPECIFICATIONS, AND ANY OTHER REQUIREMENTS OUTLINED BY THE MANUFACTURER FOR ALL PAVER INSTALLATION.

- 2. IT SHALL BE THE RESPONSIBILITY OF THE CONTRACTOR TO OBTAIN A COPY OF THE MANUFACTURER'S SPECIFICATIONS PRIOR TO COMMENCING ANY WORK.
- 3. CONCRETE PAVERS SHALL BE:
 - BELGARD[®] LEGACY SERIES
 - MODEL: HOLLAND STONE • PATTERN: HERRINGBONE
 - COLOR: CHARCOAL
- 4. CONTRACTOR SHALL SUBMIT A STANDARD COLOR SAMPLE BOARD TO THE OWNER'S AUTHORIZED REPRESENTATIVE FOR FINAL COLOR SELECTION PRIOR TO PLACING ORDER.
- 5. THE FINAL COLOR SELECTION SHALL BE MADE BY THE OWNER'S AUTHORIZED REPRESENTATIVE ON-SITE.
- 6. CONCRETE PAVERS AVAILABLE FROM:
- WWW.BELGARD.COM
- 7. THE CONTRACTOR SHALL CONSTRUCT A SAMPLE PANEL 4'-0" BY 4'-0" ON-SITE, AT NO EXPENSE TO THE OWNER, FOR APPROVAL BY THE OWNER'S AUTHORIZED REPRESENTATIVE PRIOR TO COMMENCING WORK
- 8. THE OWNER'S AUTHORIZED REPRESENTATIVE RESERVES THE RIGHT TO REJECT ANY AND ALL WORK EXECUTED BY THE CONTRACTOR WHICH DOES NOT MEET HIS/HER EXPECTATIONS AND THE MANUFACTURER'S SPECIFICATIONS.
- 9. THE CONTRACTOR SHALL MAKE ANY MODIFICATIONS REQUIRED BY THE OWNER'S AUTHORIZED REPRESENTATIVE AT NO EXPENSE TO THE OWNER.

LANDSCAPE TABULATIONS THE CITY OF ALBUQUERQUE, NEW MEXICO

SITE LANDSCAPE REQUIREMENTS

- 1. The total landscaped area required for each development shall equal not less than 15% of the net lot area.
- 2. Tree canopies and ground-level plants shall cover a minimum of 75% of the total landscape area.
- 3. Of the required vegetative coverage, a minimum of 25% shall be provided as ground-level plants.

Total Site: 54,989 s.f. Building Pad: 3,331 s.f. Net Lot Area: 51,658 s.f.

Required	Provided
7,749 s.f. (15%)	9,282 s.f. (17%)
Total Landscape Area: Required: 8,091 s.f. (75%)	10,788 s.f. Provided: 8,383 s.f. (77%) 2,183 s.f. planting 6,200 s.f. trees

7%) anting ees (2) small existing trees @ 300 s.f. = 600 s.f.(5) trees @700 s.f. = 3,500 s.f.(7) small trees @ 300 s.f. = 2,100 s.f.2,022 s.f. (25% of 8,091) 2,604 s.f. (32% of 8,091)

(14) trees, 2" cal.

STREET TREES

1. One (1) tree every 25 feet on center along street frontage.

MONTGOMERY BOULEVARD: 356 l.f. Required Provided

(14) trees, 2" cal.

- PARKING LOT INTERIOR 1. One (1) tree is required per 10 parking spaces. 2. No parking space may be more than 100 feet in any
- direction from a tree trunk. 3. At least 75% of the required parking area trees shall be
- deciduous canopy-type shade trees, capable of achieving a mature canopy diameter of at least 25 feet.

Parking Spaces: 36	
Required:	
(3) trees	
75% deciduous	

75% deciduous DRIVE THROUGH SCREENING 1. Drive-through lanes adjacent to public rights-of-way shall be screened by a landscape buffer area at least 6

Provided:

(3) trees


feet wide containing a vegetative screen or wall constructed of a material similar in texture, appearance, and color to the street facing facade of the primary building.

Required: 36" vegetative screen Screen wall

Provided: 36" vegetative screen Screen wall



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Sheet Title:

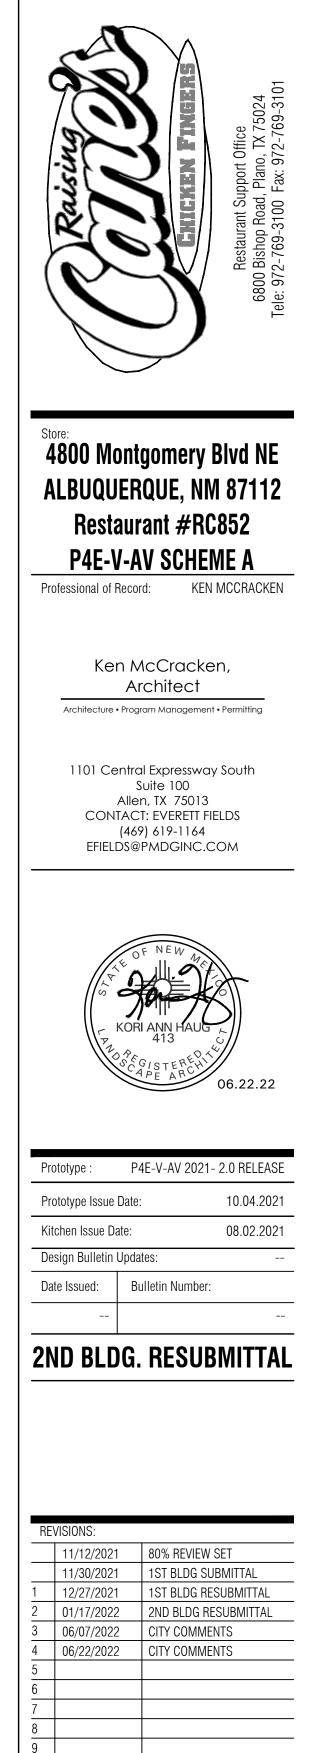LANDSCAPE PLAN

Date:	06.22.2022
Project Number:	RAC21059.0
Drawn By:	TM/KH

2

Sheet Number:

SECTION 32 9300 - LANDSCAPE

PART 1 - GENERAL

1.1 REFERENCED DOCUMENTS

A. Refer to Landscape Plans, notes, details, bidding requirements, special provisions, and schedules for additional requirements.


1.2 DESCRIPTION OF WORK

- A. Work included: Furnish all supervision, labor, materials, services, equipment and appliances required to complete the work covered in conjunction with the landscaping covered in these specifications and landscaping plans, including:
- 1. Planting (trees, shrubs and grasses)
- 2. Bed preparation and fertilization
- 3. Notification of sources
- 4. Water and maintenance until final acceptance
- 5. Guarantee
- 1.3 REFERENCE STANDARDS
- A. American Standard for Nursery Stock published by American Association of Nurserymen: April 14, 2014 Edition; by American National Standards Institute, Inc. (Z60.1) – plant material
- B. American Joint Committee on Horticultural Nomenclature: 1942 Edition of Standardized Plant Names.
- C. New Mexico Association of Nurserymen, Grades and Standards
- D. Hortis Third, 1976 Cornell University
- 1.4 NOTIFICATION OF SOURCES AND SUBMITTALS
- A. Samples: Provide representative quantities of sandy loam soil, mulch, bed mix material, gravel, crushed stone, steel edging and tree stakes. Samples shall be approved by Owner's Authorized Representative before use on the project.
- 1.5 JOB CONDITIONS
- A. General Contractor to complete the following punch list: Prior to Landscape Contractor initiating any portion of landscape 1.7 QUALITY ASSURANCE installation, General Contractor shall leave planting bed areas three (3") inches below final finish grade of sidewalks, drives and curbs as shown on the drawings. All lawn areas to receive solid sod shall be left one (1") inch below the final finish grade of sidewalks, drives and curbs. All construction debris shall be removed prior to Landscape Contractor beginning any work.
- B. Storage of materials and equipment at the job site will be at the risk of the Landscape Contractor. The Owner cannot be held responsible for theft or damage.
- 1.6 MAINTENANCE AND GUARANTEE
- A. Maintenance:
- 1. The Landscape Contractor shall be held responsible for the maintenance of all work from the time of planting until final acceptance by the Owner. No trees, shrubs, groundcover or grass will be accepted unless they show healthy growth and satisfactory foliage conditions.
- 2. Maintenance shall include watering of trees and plants, cultivation, weeding spraying, edging, pruning of trees, mowing of grass, cleaning up and all other work necessary of maintenance.
- 3. A written notice requesting final inspection and acceptance should be submitted to the Owner at least seven (7) days prior to completion. An on-site inspection by the Owner's Authorized Representative will be completed prior to written acceptance.
- B. Guarantee:

- Trees, shrubs and groundcover shall be guaranteed for a twelve (12) month period after final acceptance. The Contractor shall replace all dead materials as soon as weather permits and upon notification of the Owner. Plants, including trees, which have partially died so that shape, size, or symmetry have been damaged, shall be considered subject to replacement. In such cases, the opinion of the Owner shall be final.
- a. Plants used for replacement shall be of the same size and kind as those originally planted and shall be planted as originally specified. All work, including materials, labor and equipment used in replacements, shall carry a twelve (12) month guarantee. Any damage, including ruts in lawn or bed areas, incurred as a result of making replacements shall be immediately repaired.
- b. At the direction of the Owner, plants may be replaced at the start of the next year's planting season. In such cases, dead plants shall be removed from the premises 1.8 PRODUCT DELIVERY, STORAGE AND HANDLING immediately.
- c. When plant replacements are made, plants, soil mix, fertilizer and mulch are to be utilized as originally specified and re-inspected for full compliance with the contract requirements. All replacements are to be included under "Work" of this section.
- 2. The Owner agrees that for the guarantee to be effective, he will water plants at least twice a week during dry periods and cultivate beds once a month after final acceptance.
- 3. The above guarantee shall not apply where plants die after acceptance because of injury from storms, hail, freeze, insects, diseases, injury by humans, machines or theft.
- 4. Acceptance for all landscape work shall be given after final inspection by the Owner provided the job is in a complete, undamaged condition and there is a stand of grass in all lawn areas. At that time, the Owner will assume maintenance on the accepted work.
- C. Repairs: Any necessary repairs under the Guarantee must be made within ten (10) days after receiving notice, weather permitting. In the event the Landscape Contractor does not make repairs accordingly, the Owner, without further notice to Contractor, may provide materials and men to make such repairs at the expense to the Landscape Contractor.

С.

- A. General: Comply with applicable federal, state, county and local regulations governing landscape materials and work
- B. Personnel: Employ only experienced personnel who are familiar with the required work. Provide full time supervision by a qualified foreman acceptable to Landscape Architect.
- Selection of Plant Material: Make contact with suppliers immediately upon obtaining notice of contract acceptance to select and book materials. Develop a program of maintenance (pruning and fertilization) which will ensure the purchased materials will meet and / or exceed project specifications.
- 2. Substitutions: Do not make plant material substitutions. If the specified landscape material is not obtainable, submit proof of non-availability to Landscape Architect, together with proposal for use of equivalent material. At the time bids are submitted, the Contractor is assumed to have located the materials necessary to complete the job as specified.
- Landscape Architect will provide a key identifying each tree location on site Written verification will be required to document material selection, source and delivery schedules to site.
- Measurements: Measure trees with branches and trunks or canes in their normal position. Do not prune to obtain required sizes. Take caliper measurements six inches above ground for trees up to and including 4" caliper size, and twelve inches above ground for larger sizes. Measure main body of all plant material of height and spread dimensions,

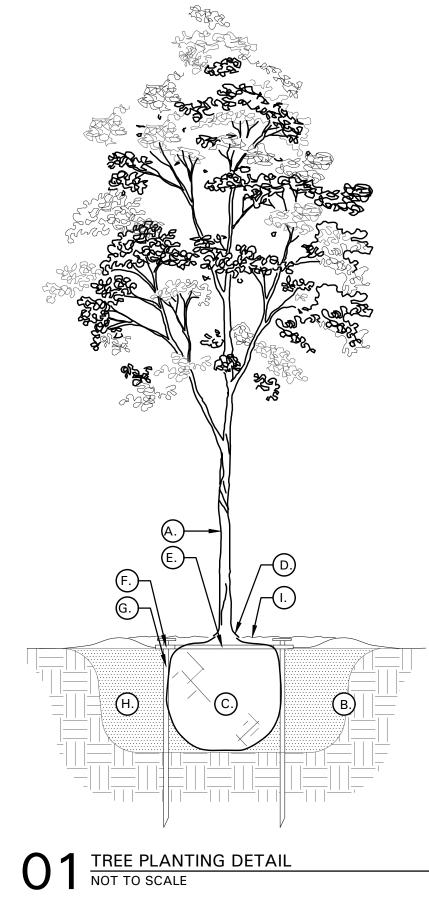

TREE PLANTING DETAIL LEGEND AND NOTES

- A. TREE: TREES SHALL CONFORM WITH LATEST AMERICAN STANDARD FOR NURSERY STOCK. www.anla.org
- BALL CENTER TREE IN HOLE & REST ROOT BALL ON UNDISTURBED NATIVE SOIL.
- C. ROOT BALL: REMOVE TOP $\frac{1}{3}$ BURLAP CONTAINER GROWN STOCK TO BE INSPECTED FOR GIRDLING ROOTS.
- D. ROOT FLARE: ENSURE THAT ROOT ROOT FLARE IS NOT APPARENT.
- E. ROOTBALL ANCHOR RING: REFER TO SHOULD BE IN THE CENTER OF THE RING.
- F. ROOT ANCHOR BY TREE STAKE SOLUTIONS.
- G. NAIL STAKE: REFER MANUFACTURER'S GUIDELINES FOR SIZING. INSTALL NAIL STAKES WITH HAMMER OR MALLET FIRMLY INTO UNDISTURBED GROUND. DRIVE NAIL STAKES FLUSH WITH "U" BRACKET ADJACENT TO ROOTBALL (DO NOT DISTURB ROOTBALL).

do not measure from branch or root tip-to-tip.

- 5. Owner's Authorized Representative shall inspect all plant material with requirements for genus, species, cultivar / variety size and quality.
- 6. Owner's Authorized Representative retains the right to further inspect all plant material upon arrival to the site and during installation for size and condition of root balls and root systems, limbs, branching habit, insects, injuries and latent defects.
- 7. Owner's Authorized Representative may reject unsatisfactory or defective material at any time during the process work. Remove rejected materials immediately from the site and replace with acceptable material at no additional cost to the Owner. Plants damaged in transit or at job site shall be rejected.

- A. Preparation:
- 1. Balled and Burlapped (B&B) Plants: Dig and prepare shipment in a manner that will not damage roots, branches, shape and future development.
- 2. Container Grown Plants: Deliver plants in rigid container to hold ball shape and protect root mass.
- B. Delivery:
- 1. Deliver packaged materials in sealed containers showing weight, analysis and name of manufacturer. Protect materials from deterioration during delivery and while stored on site.
- 2. Deliver only plant materials that can be planted in one day unless adequate storage and watering facilities are available on iob site.
- 3. Protect root balls by heeling in with sawdust or other approved moisture retaining material if not planted within 24 hours of delivery.
- 4. Protect plants during delivery to prevent damage to root balls or desiccation of leaves. Keep plants moist at all times. Cover all materials during transport.
- 5. Notify Owner's Authorized Representative of delivery schedule 72 hours in advance job site.
- 6. Remove rejected plant material immediately from job site.
- 7. To avoid damage or stress, do not lift, move, adjust to plumb, or otherwise manipulate plants by trunk or stems.
- PART 2 PRODUCTS

2.1 PLANTS

- A. General: Well-formed No. 1 grade or better nursery grown stock. Listed plant heights are from tops of root balls to nominal tops of 2.3 MISCELLANEOUS MATERIALS plants. Plant spread refers to nominal outer width of the plant, not to the outer leaf tips. Plants will be individually approved by the Owner's Authorized Representative and his decision as to their acceptability shall be final.
- Quantities: The drawings and specifications are complementary. Anything called for on one and not the other is as binding as if shown and called for on both. The plant schedule is an aid to bidders only. Confirm all quantities on plan.
- C. Quality and size: Plant materials shall conform to the size given on the plan, and shall be healthy, symmetrical, well-shaped, full branched and well rooted. The plants shall be free from injurious insects, diseases, injuries to the bark or roots, broken branches, objectionable disfigurements, insect eggs and larvae, and are to be of specimen quality.
- D. Approval: All plants which are found unsuitable in growth, or are in any unhealthy, badly shaped or undersized condition will be rejected by the Owner's Authorized Representative either before or after planting and shall be removed at the expense of the Landscape Contractor and replaced with acceptable plant as

specified at no additional cost to the Owner.

- Trees shall be healthy, full-branched, well-shaped, and shall meet 3.1 BED PREPARATION & FERTILIZATION the minimum trunk and diameter requirements of the plant schedule. Balls shall be firm, neat, slightly tapered and well wrapped in burlap. Any tree loose in the ball or with a broken root ball at time of planting will be rejected. Balls shall be ten (10") inches in diameter for each one (1") inch of trunk diameter. measured six (6") inches above ball. (Nomenclature confirms to the customary nursery usage. For clarification, the term "multi-trunk" defines a plant having three (3) or more trunks of nearly equal diameter.)
- Pruning: All pruning of trees and shrubs, as directed by the Landscape Architect prior to final acceptance, shall be executed by the Landscape Contractor at no additional cost to the Owner.
- 2.2 SOIL PREPARATION MATERIALS
- A. Sandy Loam:
- 1. Friable, fertile, dark, loamy soil, free of clay lumps, subsoil, stones and other extraneous material and reasonably free of weeds and foreign grasses. Loam containing Dallasgrass or Nutgrass shall be rejected.
- 2. Physical properties as follows:
- a. Clay between 7-27 percent b. Silt – between 15-25 percent
- c. Sand less than 52 percent
- 3. Organic matter shall be 3%-10% of total dry weight.
- 4. If requested, Landscape Contractor shall provide a certified soil analysis conducted by an approved soil testing 3.2 INSTALLATION laboratory verifying that sandy loam meets the above requirements.
- Organic Material: Compost with a mixture of 80% vegetative Β. matter and 20% animal waste. Ingredients should be a mix of course and fine textured material.
- С Sharp Sand: Sharp sand must be free of seeds, soil particles and weeds.
- Mulch: Double Shredded Hardwood Mulch, partially decomposed, dark brown unless otherwise specified on plans.
- Organic Fertilizer: Fertilaid, Sustane, or Green Sense or equal as recommended for required applications. Fertilizer shall be delivered to the site in original unopened containers, each bearing the manufacturer's guaranteed statement of analysis.
- Commercial Fertilizer: 10-20-10 or similar analysis. Nitrogen source to be a minimum 50% slow release organic Nitrogen (SCU or UF) with a minimum 8% sulfur and 4% iron, plus micronutrients
- G. Peat: Commercial sphagnum peat moss or partially decomposed shredded pine bark or other approved organic material.
- Steel Edging: All steel edging shall be 3/16" thick x 4" deep x 16' long with 6 stakes per section, painted black at the factory as manufactured by The J.D. Russell Company and under its trade name DURAEDGE Heavy Duty Steel.
- B. Staking Material for Shade Trees: refer to details.
- C. Gravel: Washed native pea gravel, graded 1 inch to 1-1/2 inch.
- D. Filter Fabric: 'Mirafi Mirascape' by Mirafi Construction Products or approved equal.
- E. River Rock: 'Colorado' or native river rock, 2" 4" dia.
- Decomposed Granite: Base material shall consist of a natural material mix of granite aggregate not to exceed 1/8" diameter in size and shall be composed of various stages of decomposed earth base

PART 3 - EXECUTION

- A. Landscape Contractor to inspect all existing conditions and report any deficiencies to the Owner.
- B. All planting areas shall be conditioned as follows:
- 1. Prepare new planting beds by scraping away existing grass and weeds as necessary. Till existing soil to a depth of six (6") inches prior to placing compost and fertilizer. Apply fertilizer as per Manufacturer's recommendations. Add six (6") inches of compost and till into a depth of six (6") inches of the topsoil. Apply organic fertilizer such as Sustane or Green Sense at the rate of twenty (20) pounds per one thousand (1,000) square feet.
- 2. All planting areas shall receive a three (3") inch layer of specified mulch.
- 3. Backfill for tree pits shall be as follows: Use existing top soil on site (use imported topsoil as needed) free from large clumps, rocks, debris, caliche, subsoils, etc., placed in nine (9") inch layers and watered in thoroughly.
- C. Grass Areas:
- 1. Blocks of sod should be laid joint to joint (staggered joints) after fertilizing the ground first. Roll grass areas to achieve a smooth, even surface. The joints between the blocks of sod should be filled with topsoil where they are evidently gaped open, then watered thoroughly.

- A. Maintenance of plant materials shall begin immediately after each plant is delivered to the site and shall continue until all construction has been satisfactorily accomplished.
- B. Plant materials shall be delivered to the site only after the beds are prepared and areas are ready for planting. All shipments of nursery materials shall be thoroughly protected from the drying winds during transit. All plants which cannot be planted at once, after delivery to the site, shall be well protected against the possibility of drying by wind and Balls of earth of B & B plants shall be kept covered with soil or other acceptable material. All plants remain the property of the Contractor until final acceptance.
- C. Position the trees and shrubs in their intended location as per
- D. Notify the Owner's Authorized Representative for inspection and approval of all positioning of plant materials.
- E. Excavate pits with vertical sides and horizontal bottom. Tree pits shall be large enough to permit handling and planting without injury to balls of earth or roots and shall be of such depth that, when planted and settled, the crown of the plant shall bear the same relationship to the finish grade as it did to soil surface in original place of growth.
- Shrub and tree pits shall be no less than twenty-four (24") inches wider than the lateral dimension of the earth ball and six (6") inches deeper than it's vertical dimension. Remove and haul from site all rocks and stones over three-quarter $(\frac{3}{4})$ inch in diameter. Plants should be thoroughly moist before removing 3.3 CLEANUP AND ACCEPTANCE containers
- G. Dig a wide, rough sided hole exactly the same depth as the height of the ball, especially at the surface of the ground. The sides of the hole should be rough and jagged, never slick or glazed
- H. Percolation Test: Fill the hole with water. If the water level does not percolate within 24 hours, the tree needs to move to another END OF SECTION location or have drainage added. Install a PVC stand pipe per tree planting detail as approved by the Landscape Architect if the percolation test fails.
- Backfill only with 5 parts existing soil or sandy loam and 1 part bed preparation. When the hole is dug in solid rock, topsoil from

CONCRETE PAVER $3 \frac{1}{8}$ " MIN. THICKNESS, REFER TO CONCRETE PAVER NOTES L2.01 BEDDING SAND, 1" - 1 ½" DEPTH CONCRETE CURB AND GUTTER, REFER TO CIVIL PLANS COMPACTED AGGREGATE BASE **4" MINIMUM THICKNESS** NOTE: PROVIDE DRAINAGE GEOTEXTILE TURNED FOR BEDDING SAND UP AT SIDES COMPACTED SUBGRADE PER GEOTECHNICAL REPORT 03 CONCRETE PAVERS DETAIL SHRUBS / GROUNDCOVER REFER TO LANDSCAPE PLAN **TOPDRESS MULCH PER** SPECIFICATIONS; 3" MINIMUM-SETTLED THICKNESS TOP OF MULCH 1/2" jeff@treestakesolutions.com MINIMUM BELOW TOP OF-CONCRETE WALK / CURB -W000 SCARIFY SIDES 142 CONCRETE WALK - Wyon K. IT SHALL BE THE RESPONSIBILITY OF MANUFACTURER'S PRIOR NO STEEL EDGING SHALL BE INSTALLED ALONG SIDEWALKS OR CURBS

- B. TREE PIT: WIDTH TO BE AT LEAST TWO (2) TIMES THE DIAMETER OF THE ROOT
- AND ANY OTHER FOREIGN OBJECT;
- FLARE IS EXPOSED, FREE FROM MULCH, AND AT LEAST TWO INCHES ABOVE GRADE. TREES SHALL BE REJECTED WHEN GIRDLING ROOTS ARE PRESENT &
- MANUFACTURER'S GUIDELINES FOR SIZING. PLACE ROOTBALL ANCHOR RING ON BASE OF ROOTBALL, TRUNK

H. BACKFILL: USE EXISTING NATIVE SOIL (no amendments) WATER THOROUGHLY TO ELIMINATE AIR POCKETS.

MULCH: DOUBLE SHREDDED HARDWOOD MULCH 3 INCH SETTLED THICKNESS, WITH 2" HT. WATERING RING; ENSURE THAT ROOT FLARE IS EXPOSED. BELOW GROUND STAKE SHOULD NOT BE VISIBLE.

- TREE STAKES: TREE STAKE SOLUTIONS 'SAFETY
- STAKE' BELOW GROUND MODEL AVAILABLE FROM: **Tree Stake Solutions**
- ATTN: Jeff Tuley (903) 676-6143
 - www.treestakesolutions.com

OR APPROVED EQUAL. TREES SHALL BE STAKED BELOW GROUND WHERE NECESSARY; ABOVE GROUND STAKING IS EXPRESSLY PROHIBITED.

THE CONTRACTOR TO OBTAIN A COPY OF THE SPECIFICATIONS INSTALLATION OF TREE STAKES. CONTRACTOR SHALL ADHERE TO MANUFACTURER'S INSTALLATION GUIDELINES, SPECIFICATIONS, AND OTHER REQUIREMENTS FOR TREE STAKE INSTALLATION.

02 SHRUB / GROUNDCOVER DETAIL NOT TO SCALE

- the same area should not be used. Carefully settle by watering to prevent air pockets. Remove the burlap from the top $\frac{1}{3}$ of the ball, as well as all nylon, plastic string and wire. Container trees will usually be root bound, if so follow standard nursery practice of 'root scoring'.
 - J. Do not wrap trees.
 - K. Do not over prune.
 - Mulch the top of the ball. Do not plant grass all the way to the trunk of the tree. Leave the area above the top of the ball and mulch with at least three (3") inches of specified mulch.
 - M. All plant beds and trees to be mulched with a minimum settled thickness of three (3") inches over the entire bed or pit.
 - N. Obstruction below ground: In the event that rock, or underground construction work or obstructions are encountered in any plant pit excavation work to be done under this section, alternate locations may be selected by the Owner. Where locations cannot be changed, the obstructions shall be removed to a depth of not less than three (3') feet below grade and no less than six (6") inches below the bottom of ball when plant is properly set at the required grade. The work of this section shall include the removal from the site of such rock or underground obstructions encountered at the cost of the Landscape Contractor.
 - O. Trees and large shrubs shall be staked as site conditions require. Position stakes to secure trees against seasonal prevailing winds.
 - P. Pruning and Mulching: Pruning shall be directed by the Landscape Architect and shall be pruned in accordance with standard horticultural practice following Fine Pruning, Class I pruning standards provided by the National Arborist Association.
 - 1. Dead wood, suckers, broken and badly bruised branches shall be removed. General tipping of the branches is not permitted. Do not cut terminal branches.
 - 2. Pruning shall be done with clean, sharp tools.
 - 3. Immediately after planting operations are completed, all tree pits shall be covered with a layer of organic material two (2") inches in depth. This limit of the organic material for trees shall be the diameter of the plant pit.
 - Q. Steel Curbing Installation:
 - 1. Curbing shall be aligned as indicated on plans. Stake out limits of steel curbing and obtain Owners approval prior to installation.
 - 2. All steel curbing shall be free of kinks and abrupt bends.
 - 3. Top of curbing shall be $\frac{1}{2}$ " maximum height above final finished grade.
 - 4. Stakes are to be installed on the planting bed side of the curbing, as opposed to the grass side.
 - 5. Do not install steel edging along sidewalks or curbs.
 - 6. Cut steel edging at 45 degree angle where edging meets sidewalks or curbs.

 - A. Cleanup: During the work, the premises shall be kept neat and orderly at all times. Storage areas for all materials shall be so organized so that they, too, are neat and orderly. All trash and debris shall be removed from the site as work progresses. Keep paved areas clean by sweeping or hosing them at end of each work day.

POCKET PLANTING NOT ALLOWED PREPARED SOIL MIX PER

SPECIFICATIONS; TILL 6" MINIMUM OF PREPARED SOIL MIX INTO 6" DEPTH OF EXISTING SOIL

3/16" X 4" BLACK EDGING,

BE 1/2" MAXIMUM HEIGHT

ABOVE FINISH GRADE

STAKES ON INSIDE; EDGING SHALL

-LAWN / FINISH GRADE

-NATIVE SOIL ROOTBALL


DO NOT DISTURB

REFER TO LANDSCAPE PLAN

FOR SPACING



4245 North Central Expy Suite 501 Dallas, Texas 75205 214.865.7192 office

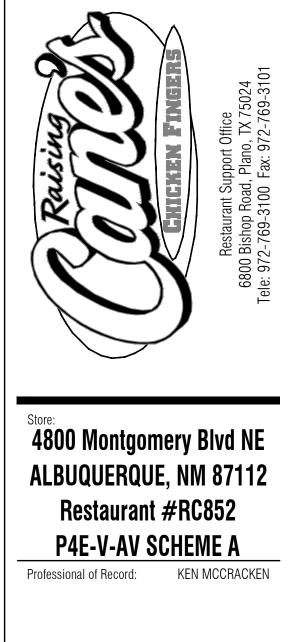

Ken McCracken, Architect

Architecture • Program Management • Permitting

1101 Central Expressway South Suite 100 Allen, TX 75013 CONTACT: EVERETT FIELDS (469) 619-1164 EFIELDS@PMDGINC.COM



Prototype :	P4E-V-AV 2021-	2.0 RELEASE
Prototype Issue	Date:	10.04.2021
Kitchen Issue Da	ate:	08.02.2021
Design Bulletin	Updates:	
Date Issued:	Bulletin Number:	

2ND BLDG. RESUBMITTAL


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Sheet Title: LANDSCAPE

SPECIFICATIONS Date: 06.22.2022 Project Number RAC21059.0 Drawn By: TM/KH

Sheet Number:



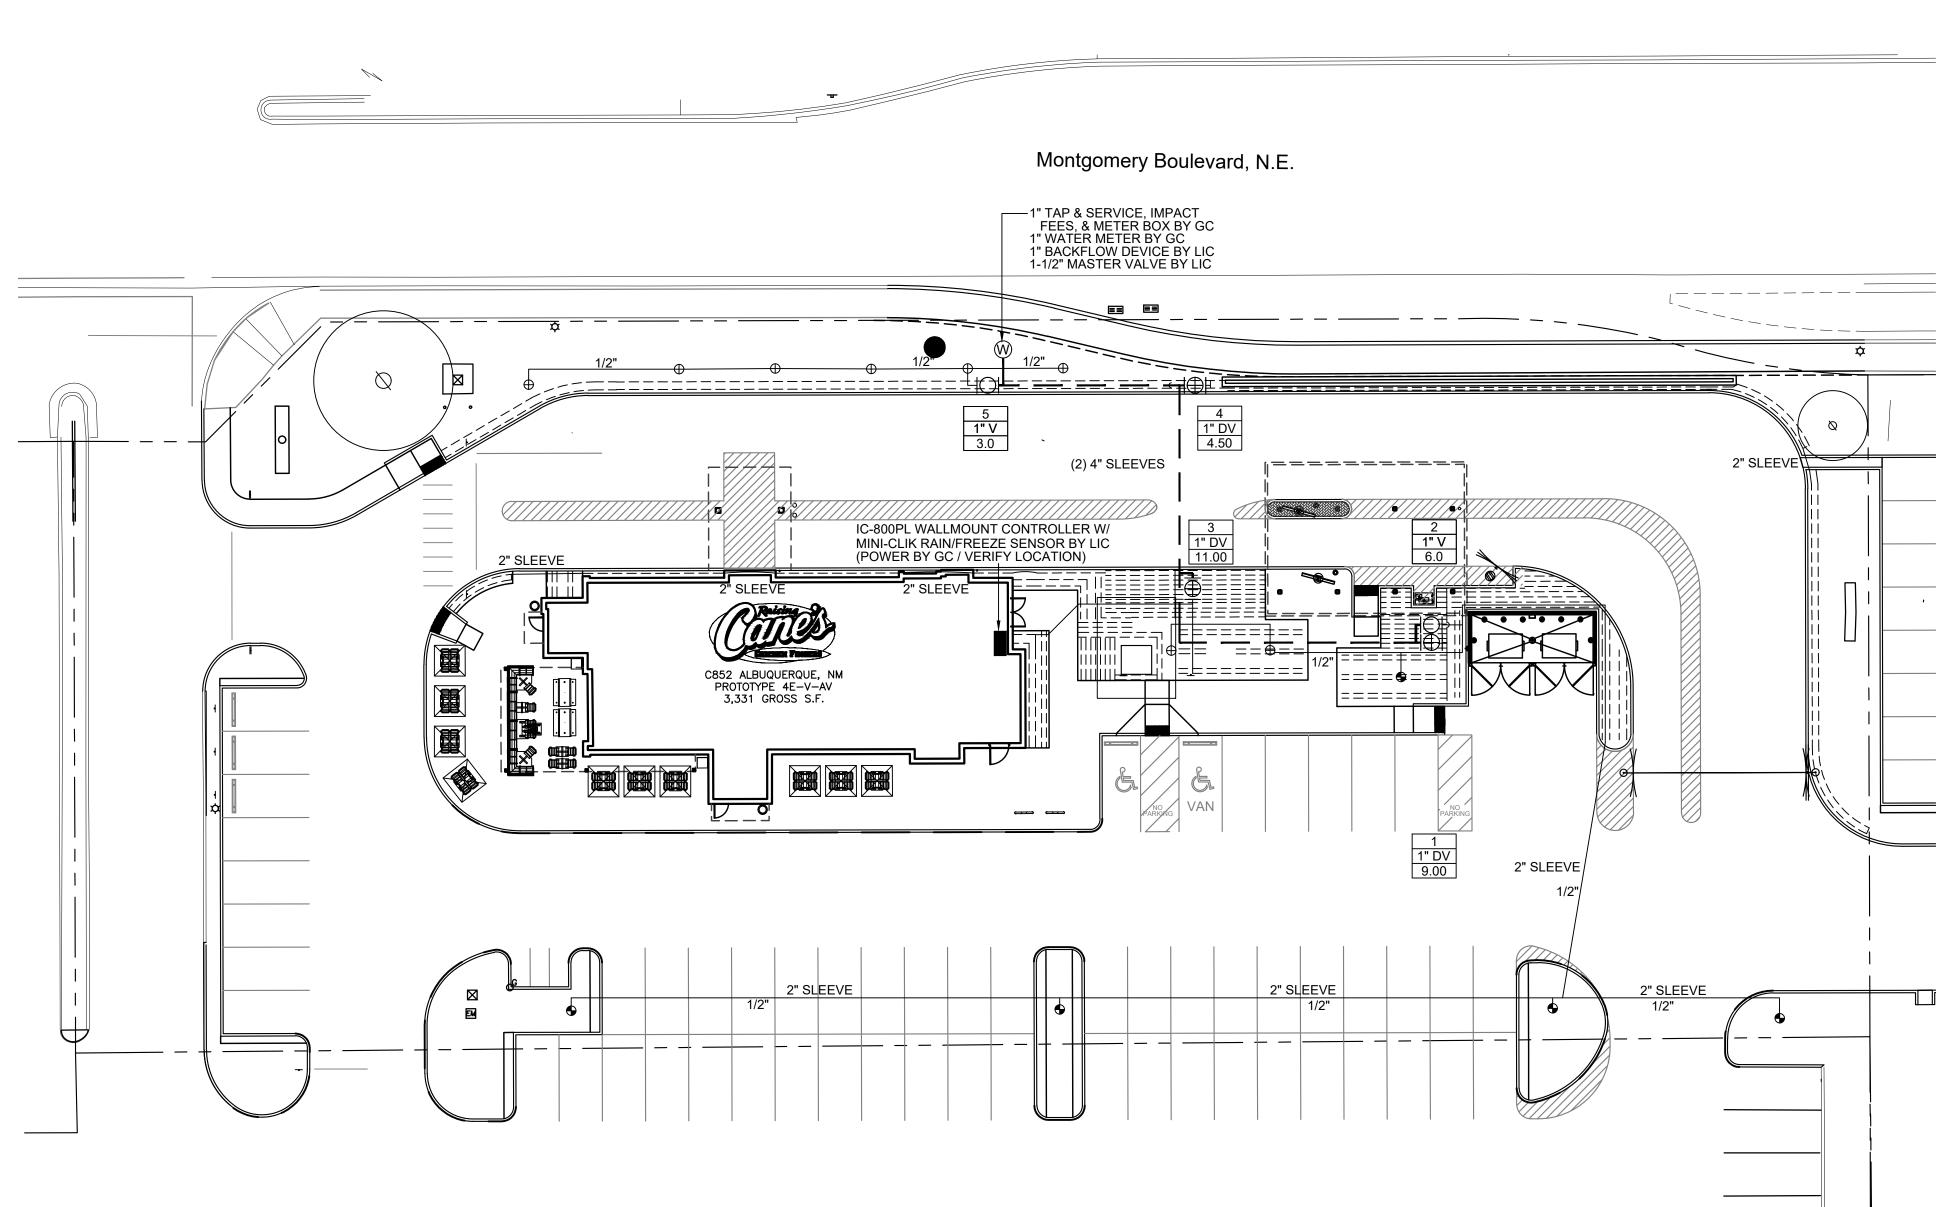

IRRIGATION LEGEND:			
SYMBOL	DESCRIPTION	MANUFACTURER	
\oplus	BUBBLER HEAD	HUNTER (30 PSI)	
•	BUBBLER HEAD	HUNTER (30 PSI)	
	REMOTE CONTROL VALVE	HUNTER	
	CONTROLLER	HUNTER	
	MAINLINE PIPING	REFER TO SPEC.	
	LATERAL PIPING	REFER TO SPEC.	
	REMOTE CONTROL DRIP VALVE	HUNTER	
	DRIP HEADER PIPING	REFER TO SPEC.	
	PLANTING BED DRIPLINE TUBING	HUNTER	
W	WATER METER	REFER TO SPEC.	
NN	PVB BACKFLOW PREVENTER	FEBCO	
M	MASTER VALVE	HUNTER	
	STATION NUMBER VALVE SIZE GPM (APPROX.)		

MODEL NO,

PCB-50 PLASTIC BUBBLER NOZZLE ON HUNTER SJ SWING JOINT

PCB-10 PLASTIC BUBBLER NOZZLE ON

HUNTER SJ SWING JOINT

PGV SERIES WITH ACCU-SYNC PRESSURE REGULATOR, REFER TO PLANS FOR SIZE

I-CORE WALLMOUNT WITH MINI-CLIK WIRELESS RAIN AND FREEZE SENSOR

1-1/2" CLASS 200 PVC

3/4" & LARGER - CLASS 200 PVC 1/2" - CLASS 315 PVC

PCZ-100 CONTROL ZONE KIT, REFER TO PLAN FOR SIZE

CLASS 200 PVC UNLESS OTHERWISE NOTED

PLD-CV-06-18 AT 18" O.C. WITH PLD INSERT FITTINGS, 12 GA. GALVANIZED STAKES AND DRIP INDICATOR HEAD

PER LOCAL BUILDING CODE

#765, REFER TO PLAN FOR SIZE

ICV, REFER TO PLAN FOR SIZE

PIPE SIZE CHART

PIPE SIZE:
1/2"
3/4"
1"
1-1/4"
1-1/2"
2"



SCALE: 1" = 20'-0" 0 10 20

40



Store: 4800 Montgomery Blvd NE ALBUQUERQUE, NM 87112 Restaurant #RC852 P4E-V-AV SCHEME A Professional of Record: KEN MCCRACKEN, Architecture - Program Management - Permitting Allen, TX 75013 CONTACT: EVERETT FIELDS (469) 619-1164 EFIELDS@PMDGINC.COM FORT ALB 140 CONTACT: EVERETT FIELDS (469) 619-1164 EFIELDS@PMDGINC.COM	ENGRIN FINGERS	Restaurant Support Office 6800 Bishop Road, Plano, TX 75024 Tele: 972-769-3100 Fax: 972-769-3101
Architecture - Program Monogement - Permitting IIOI Central Expressival South Suite 100 Allen, TX 75013 CONTACT: EVERETT FIELDS (469) 619-1164 EFIELDS@PMDGINC.COM IVORT ALL ALL ALL ALL ALL ALL ALL ALL ALL AL	4800 Montgomery ALBUQUERQUE, NM Restaurant #RO P4E-V-AV SCHE	A 87112 C852 Me A
Suite 100 Allen, TX 75013 CONTACT: EVERETT FIELDS (469) 619-1164 EFIELDS@PMDGINC.COM Image: Gright Erection Margin Balletin Model Prototype : P4E-V-AV 2021- 2.0 RELEASE Prototype Issue Date: 10.04.2021 Date Issued: Bulletin Number: Date Issued: Bulletin Number: CONTACT: Stotal Ballogs. RESUBMITTAL 11/12/2021 80% REVIEW SET 11/30/2021 15T BLDG SUBMITTAL 1 12/27/2021 15T BLDG RESUBMITTAL 2 06/07/2022 CITY COMMENTS 4 06/22/2022 CITY COMMENTS 4 9 Mark	Architect	
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Date:	06.22.2022
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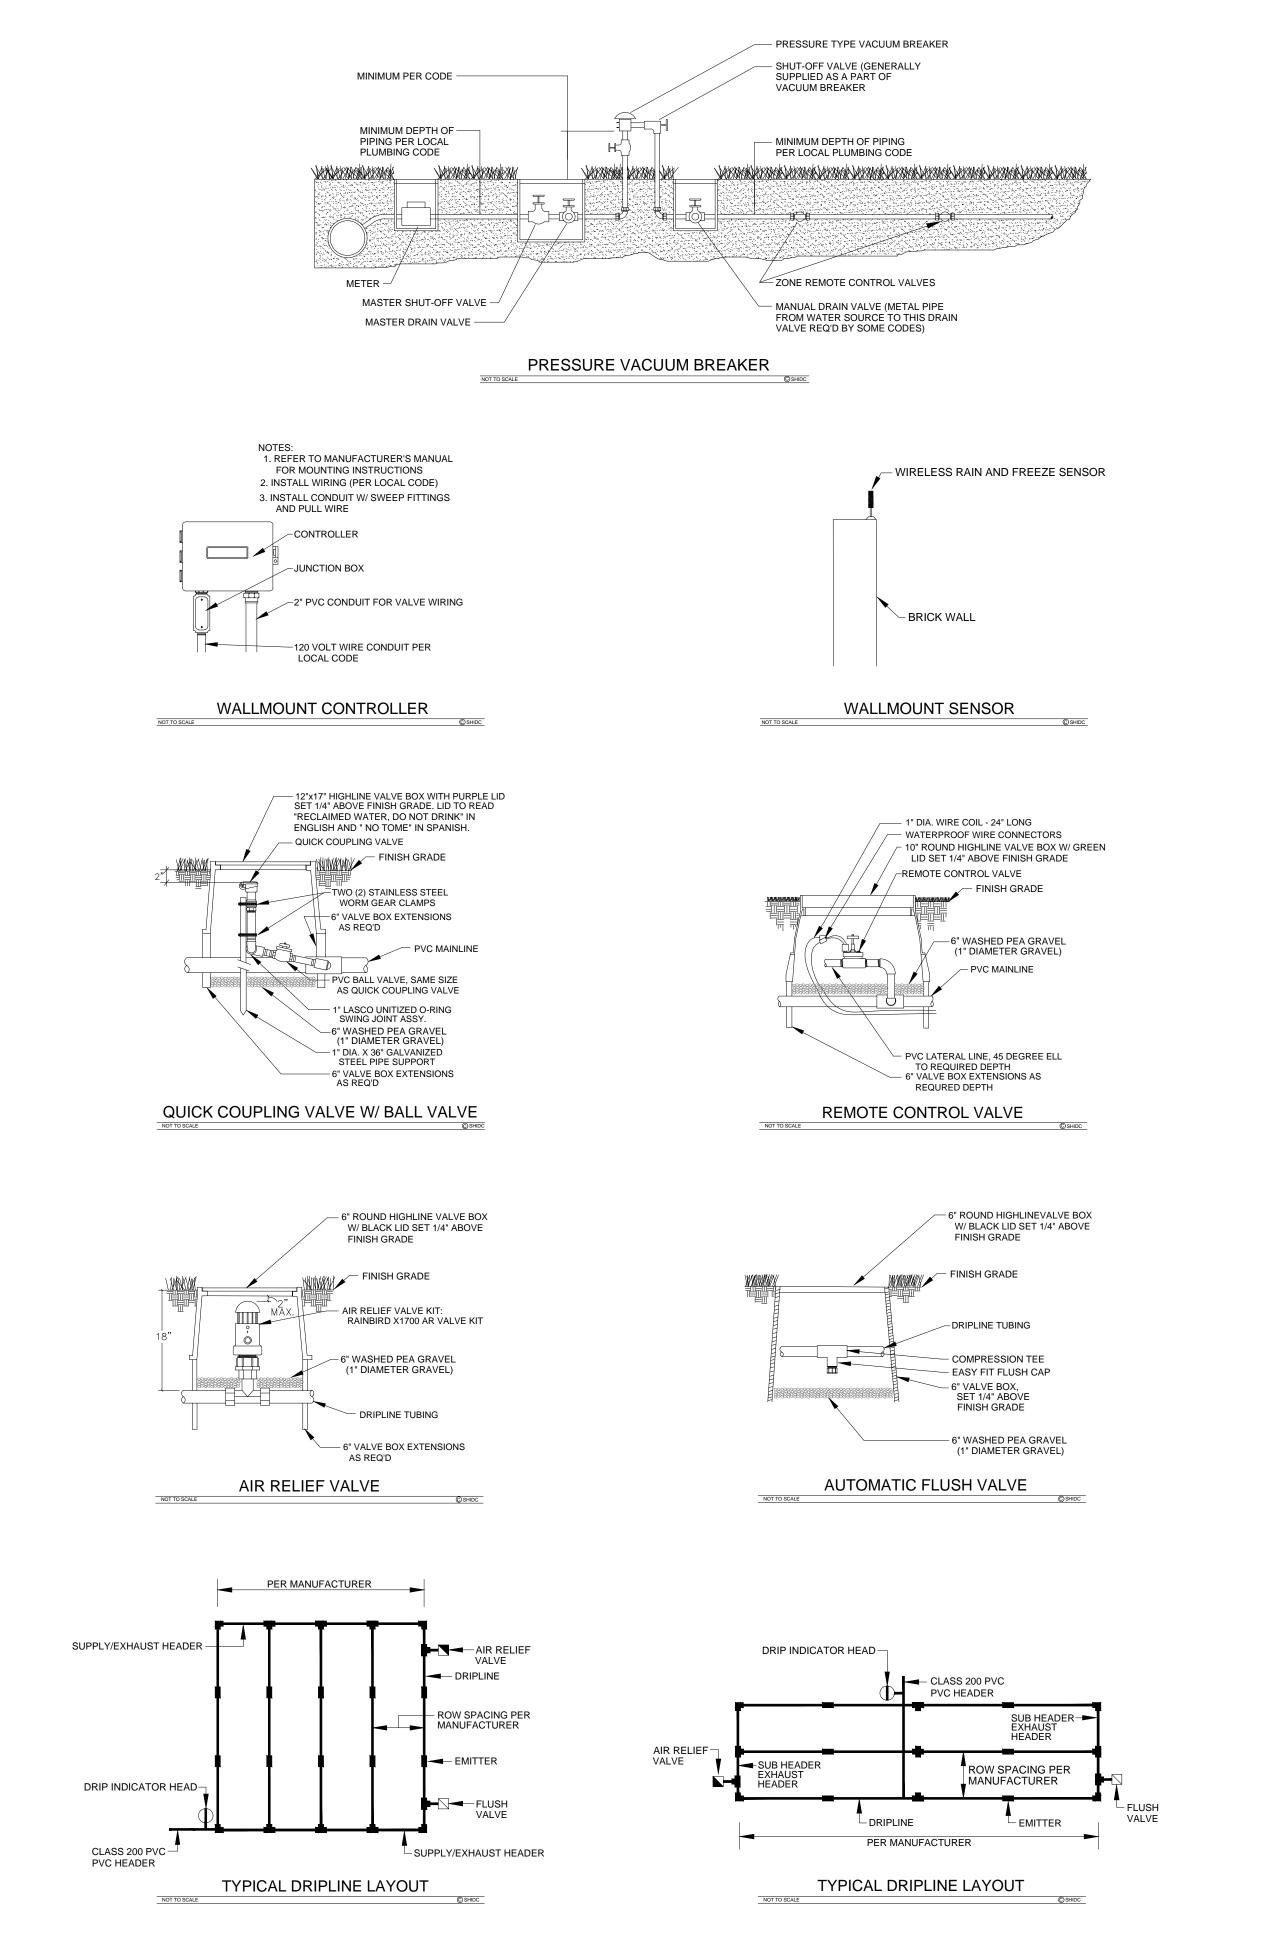
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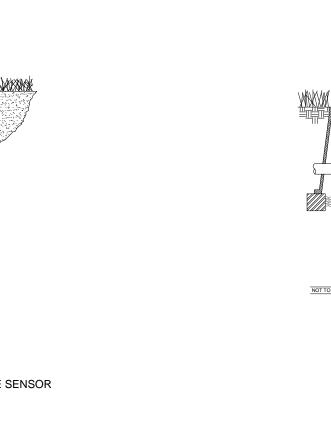



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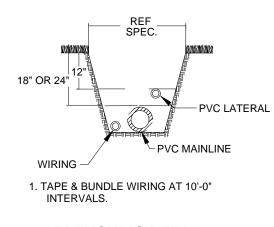
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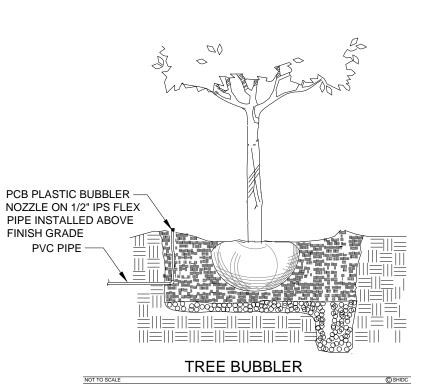



MAINLINE, LATERAL, AND WIRING






NOT TO SCALE

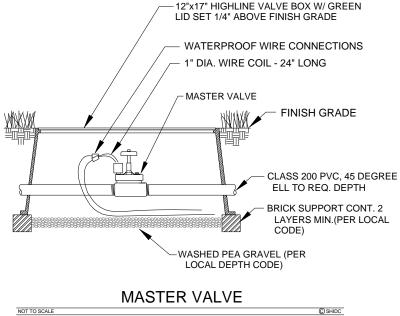

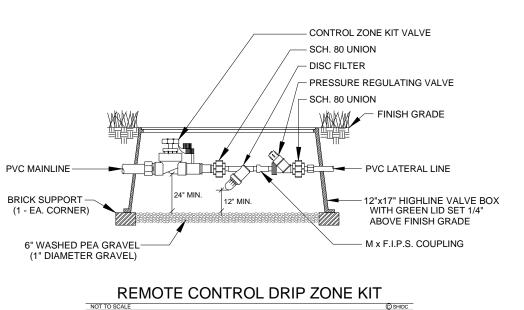

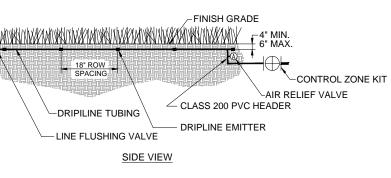

TYPICAL SUBSURFACE DRIPLINE LAYOUT

NOTES:

- 3M-DBY PERMANENT AND WATERPROOF PER THE SPECIFICATIONS.
- SPECIFICATIONS.
- AREA
- AND #P-68 PRIMER FOR PVC CONNECTIONS PER THE SPECIFICATIONS.
- REFERENCE PIPE SIZE CHART.
- JOINT.
- 7. MAINLINE.
- GENERAL CONTRACTOR.
- IRRIGATION CONTRACTOR.
- WORK UNTIL NOTIFIED TO PROCEED.
- BETWEEN ANY VALVES THAT ARE INSTALLED SIDE BY SIDE.
- BOXES.
- MANUFACTURER'S RECOMMENDATIONS OF 5'-0" PS IN DRIPLINE.
- INDICATOR HEAD TO BE A HUNTER ECO INDICATOR HEAD.
- HIGHLINE VALVE BOX WITH 6" OF GRAVEL SUMP.
- OF TUBING AND A MINIMUM OF 24" FROM ANY FITTINGS.
- EACH DRIP ZONE KIT.
- INSTALLED OUTSIDE RIGHT-OF-WAY.



ALL 24 VOLT LEAD AND COMMON VALVE WIRING SHALL BE A MINIMUM OF UF-14 GA. SINGLE CONDUCTOR. REFER TO MANUFACTURER'S RECOMMENDATIONS FOR PROPER WIRE SIZE. WIRE SPLICES SHALL BE

2. COORDINATE INSTALLATION OF IRRIGATION SYSTEM WITH LANDSCAPE CONTRACTOR TO ENSURE ALL PLANT MATERIAL WILL BE WATERED IN ACCORDANCE WITH THE INTENT OF THE PLANS AND

3. PIPING AND VALVES IN PAVING SHOWN FOR CLARITY, INSTALL IN ADJACENT PLANTING BED OR LAWN

4. LATERAL PIPING SHALL HAVE A MINIMUM OF 12" OF COVER. MAINLINE AND PIPING UNDER PAVING SHALL HAVE A MINIMUM OF 18" OF COVER. ALL FITTINGS TO BE SCHEDULE 40 PVC. USE WELD-ON #705 SOLVENT

5. SIZE ALL LATERAL PIPING PER MANUFACTURER'S RECOMMENDATIONS OF NOT EXCEEDING 5 FPS.

6. CONNECT TREE BUBBLER AND DRIP INDICATOR HEADS TO LATERAL PIPING WITH HUNTER 1/2" SJ SWING

INSTALL QUICK COUPLING VALVES IN TWELVE BY SEVENTEEN (12"x17") INCH HIGHLINE VALVE BOX. CONNECT QUICK COUPLING VALVES TO MAINLINE PIPE WITH HUNTER HSJ SWING JOINT. SUPPLY OWNER WITH ONE (1) COUPLER KEY WITH SWIVEL HOSE BIBB EACH. VALVES TO BE INSTALLED SO THAT TOP OF QUICK COUPLER IS 2" BELOW BOTTOM OF VALVE BOX TOP. PURPLE LID READS "NON-POTABLE, NOT SAFE FOR DRINKING" IN ENGLISH AND SPANISH. INSTALL EVERY 150'-0" ON CENTER ALONG ENTIRE LENGTH OF

PERFORM ELECTRICAL WORK IN ACCORDANCE WITH LOCAL BUILDING CODE. POWER (120V) SHALL BE LOCATED IN A JUNCTION BOX AND HARDWIRED WITHIN FIVE (5') FEET OF CONTROLLER LOCATION BY

9. INSTALL REMOTE CONTROL VALVES AND WIRE SPLICES IN TEN (10") INCH HIGHLINE VALVE BOXES.

10. INSTALL SLEEVES UNDER ALL HARDSCAPE SURFACES SUCH AS ROADS, DRIVES, WALKS, ETC. WHETHER SHOWN OR NOT. SLEEVES SHALL BE CLASS 200 PVC, SIZED AS NOTED ON PLANS AND INSTALLED BY

11. ADJUST NOZZLES FOR SITUATIONS THAT REQUIRE LESS THAN 90 DEGREE RADIUS SPRAY. THIS MAY REQUIRE ADJUSTABLE NOZZLES. NO OVERSPRAY ALLOWED ON ANY HARDSCAPE SURFACES

12. DESIGN PRESSURE IS 56.0 PSI. STATIC PRESSURE IS 65 PSI. TEN DAYS PRIOR TO START OF CONSTRUCTION, VERIFY STATIC PRESSURE. IF STATIC PRESSURE IS LESS THAN STATED DO NOT START

13. MINIMUM DISTANCE BETWEEN MAIN LINE AND LATERAL LINE FITTINGS (EXCEPT FOR REDUCER BUSHINGS) TO BE EIGHTEEN (18") INCHES AND MINIMUM HORIZONTAL DISTANCE OF TWENTY-FOUR (24") INCHES

14. INSTALL REMOTE CONTROL DRIP ZONE KITS IN TWELVE BY SEVENTEEN (12"x17") INCH HIGHLINE VALVE

15. INSTALL DRIPLINE MINIMUM OF 2" AND A MAXIMUM OF 4" FROM HARDSCAPE SURFACES. STAKE DRIPLINE AND RECEIVE APPROVAL FROM OWNER'S REPRESENTATIVE BEFORE INSTALLATION. DO NOT EXCEED

16. PROVIDE AND INSTALL DISTRIBUTION TUBING, STAKES, EMITTERS, TRANSFER FITTINGS, DIFFUSER BUG CAP. CONTROL ZONE KITS, ETC. NECESSARY FOR PROPER INSTALLATION OF THE BEDS. ALL PVC HEADER PIPING TO BE CLASS 200 PVC SOLVENT WELD PIPE. INSERT ALL HUNTER PLD BARBED FITTINGS PER MANUFACTURER'S RECOMMENDATIONS. INSTALL ONE DRIP INDICATOR HEAD FOR EACH DRIP ZONE

17. AIR/VACUUM RELIEF VALVE TO BE HUNTER PLD-ARV INSTALLED IN A SIX-INCH (6") HIGHLINE VALVE BOX WITH 6" OF GRAVEL SUMP. AUTOMATIC FLUSH VALVE TO BE HUNTER AFV INSTALLED IN A SIX-INCH (6")

18. ALL HUNTER PLD-CV DRIPLINE AND DISTRIBUTION TUBING TO BE INSTALLED BELOW FINISH GRADE APPROXIMATELY 4" TO 6" PER MANUFACTURER'S RECOMMENDATIONS. ALL DRIPLINE TO BE INSTALLED MINIMUM OF 1'-0" AND MAXIMUM OF 1'-2" ROW SPACING UNLESS INSTRUCTED OTHERWISE. VERIFY THE EXACT EMITTER FLOW, EMITTER SPACING, AND ROW SPACING WITH MANUFACTURER PRIOR TO INSTALLING TO PROVIDE PROPER PRECIPITATION RATE BASED ON PLANT MATERIAL AND SOIL TYPE. TUBING TO BE STAKED WITH 12 GA. GALVANIZED TIE DOWNS. INSTALL STAKES EVERY 3'-0" ALONG LENGTH

19. INCLUDE THE FOLLOWING ALLOWANCES FOR PROVIDING AND INSTALLING AIR RELIEF VALVES AND FLUSH VALVES FOR THE DRIP SYSTEM. EXACT QUANTITY AND LOCATION OF THESE DEVICES WILL BE DETERMINED AT THE TIME OF INSTALLATION. IN GENERAL, ALL AIR RELIEF VALVES WILL BE INSTALLED AT THE HIGH POINTS AND FLUSH VALVES WILL BE INSTALLED AT THE LOW POINTS OF EXHAUST HEADER. ALLOW FOR APPROXIMATELY ONE (1) AIR RELIEF VALVE AND APPROXIMATELY ONE (1) FLUSH VALVE FOR

20. WHERE POSSIBLE LOCATE ALL MAINLINES, VALVES, OR CONTROL WIRES SHALL BE LOCATED AND

21. ALL STATE OF NEW MEXICO LAWS/RULES AND ALL LOCAL CODES/ORDINANCES ARE MADE PART OF THESE PLANS AND SPECIFICATIONS WHETHER SHOWN OR NOT. THESE LAWS AND ORDINANCES WILL SUPERCEDE THE PLANS, DETAILS, AND/OR SPECIFICATIONS FOR THIS PROJECT. CONTRACTOR IS CAUTIONED THAT THEY ARE TO INCLUDE ANY AND ALL COST NECESSARY TO MEET OR EXCEED THE LAWS OF THE STATE OF NEW MEXICO OR LOCAL CODES CONCERNING LANDSCAPE IRRIGATION.

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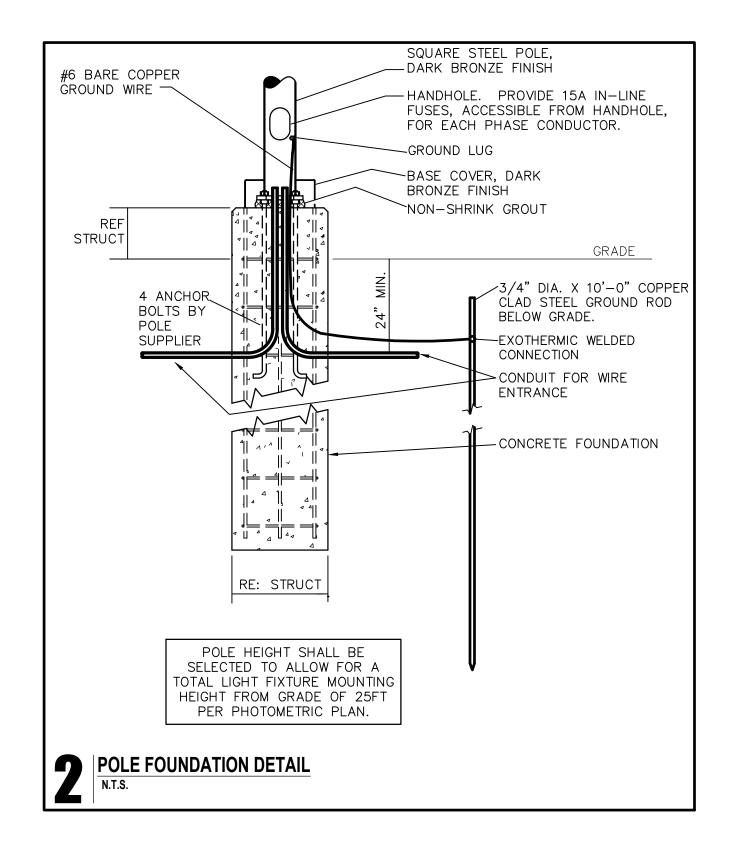
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2	01/17/2022	2ND BLDG RESUBMITTAL	
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4	06/22/2022	CITY COMMENTS	
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IRRIGATION **SPECIFICATIONS**

Date:	06.22.2022
Project Number:	RAC21059.0
Drawn By:	SAH

Sheet Number:


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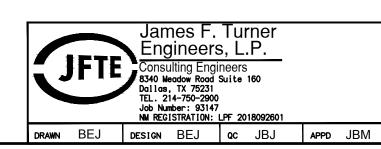


POLE LUMINAIRE LOCATIONS										
No.	Label	Х	Y	Z	MH	Orientation	Tilt	Х	Y	Z
1	Y1	1538842	1502974	25	25	90	0	1538842	1502974	0
1	Y2	1539096	1502935	25	25	0	0	1539096	1502935	0
2	Y2	1539024	1502935	25	25	0	0	1539024	1502935	0
3	Y2	1539016	1503060	25	25	180	0	1539016	1503060	0
1	Y3	1539161	1502997	25	25	270	0	1539161	1502997	0
2	Y3	1538898	1503058	25	25	180	0	1538898	1503058	0
3	Y3	1538933	1502935	25	25	0	0	1538933	1502935	0

POLE	POLE LUMINAIRE SCHEDULE									
TYPE	TYPE MANUFACTURER CATALOG NUMBER LAMP TYPE WATTS VOLTS COMMENTS									
Y1	LITHONIA	DSX1 LED P3 40K BLC MVOLT	LED	102	120-277	MOUNT FIXTURE AT TOP OF POLE 25' FROM GRADE				
Y2	LITHONIA	DSX1 LED P3 40K TFTM MVOLT HS	LED	102	120-277	MOUNT FIXTURE AT TOP OF POLE 25' FROM GRADE				
Y3	Y3 LITHONIA DSX1 LED P6 40K BLC MVOLT LED 163 120-277 MOUNT FIXTURE AT TOP OF POLE 25' FROM GRADE									
CONFIRM A	CONFIRM ALL FINISHES WITH OWNER AND ARCHITECT.									

REFER TO 'LIGHTING FIXTURE SCHEDULE (EXTERIOR)' ON SHEET E1.1b FOR ALL OTHER EXTERIOR LIGHT FIXTURE INFORMATION.



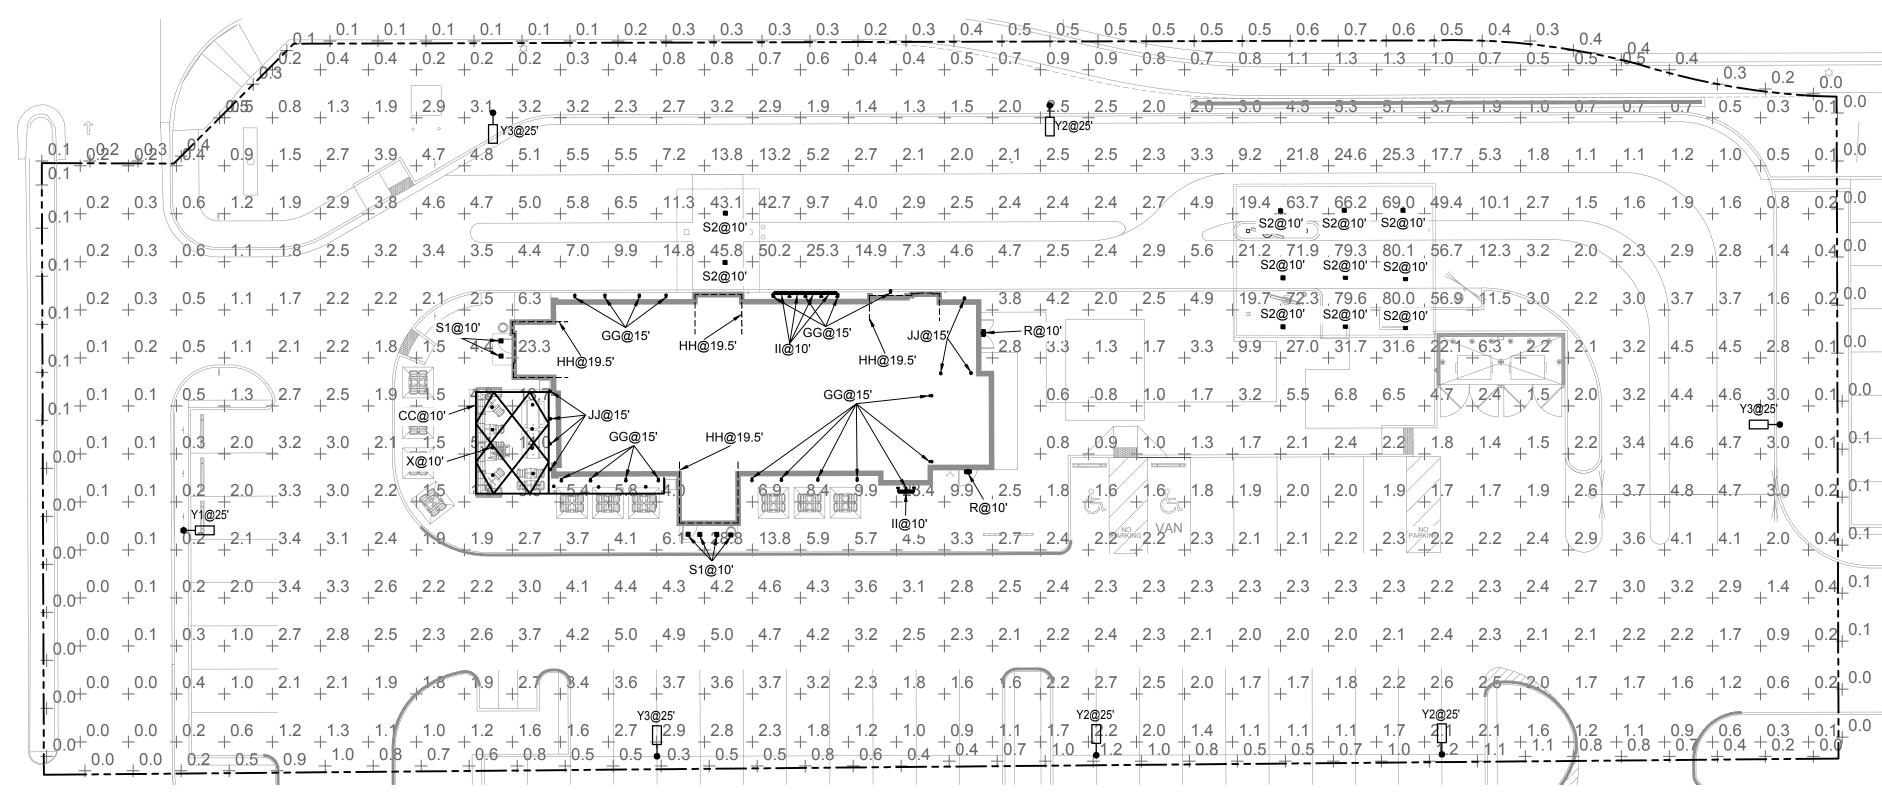

PHOTOMETRIC SITE PLAN 1" = 20'-0"

$\begin{array}{cccccccccccccccccccccccccccccccccccc$	
+ $+$ $+$ $+$ $+$ $+$ $+$ $+$ $+$ $+$	0.0
4.9 19.4 63.7 66.2 69 0 49.4 10.1 2.7 1.5 1.6 1.9 1.6 0.8 0.2	
$\begin{array}{c} + & + & + & + & + & + & + & + & + & + $	
$+ \begin{array}{cccccccccccccccccccccccccccccccccccc$	0.0
+3.3 $+9.9$ $+27.0$ 31.7 $+31.6$ $+22.1$ $+6.3$ 2.2 $+2.1$ $+3.2$ $+4.5$ $+4.5$ $+2.8$ $+0.1$	0.0
-1.7 3.2 +5.5 +6.8 +6.5 +4.7 +2.4 +1.5 +2.0 +3.2 +4.4 +4.6 3.0 +0.1 +3.2 +4.4 +4.6 3.0 +0.1 +3.2 +4.4 +4.6 -3.0 +0.1 +3.2 +4.4 +4.6 -3.0 +0.1 +3.2 +4.4 +4.6 -3.0 +0.1 +3.2 +4.4 +4.6 -3.0 +0.1 +3.2 +4.4 +4.6 -3.0 +0.1 +3.2 +4.4 +4.6 -3.0 +0.1 +3.2 +4.4 +4.6 -3.0 +0.1 +3.2 +4.4 +4.6 -3.0 +0.1 +3.2 +4.4 +4.6 -3.0 +0.1 +3.2 +4.4 +4.6 -3.0 +0.1 +3.2 +4.4 +4.6 -3.0 +0.1 +3.2 +4.4 +4.6 -3.0 +0.1 +3.2 +4.4 +4.6 -3.0 +0.1 +3.2 +4.4 +4.6 -3.0 +0.1 +3.2 +4.4 +4.6 -3.0 +0.1 +3.2 +4.4 +4.6 -3.0 +0.1 +3.2 +4.4 +4.6 -3.0 +0.1 +3.2 +4.4 +4.6 -3.0 +0.1 +3.2 +4.4 +4.6 -3.0 +0.1 +3.2 +4.4 +3.6 -3.0 +0.1 +3.2 +3.	0.0
$\begin{array}{c ccccccccccccccccccccccccccccccccccc$	0.1—
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$ \begin{array}{c ccccccccccccccccccccccccccccccccccc$	0.1
$+^{2.3}+^{2.3}+^{2.3}+^{2.3}+^{2.3}+^{2.3}+^{2.2}+^{2.3}+^{2.4}+^{2.7}+^{3.0}+^{3.2}+^{2.9}+^{1.4}+^{0.4}$	0.1
+ $+$ $+$ $+$ $+$ $+$ $+$ $+$ $+$ $+$	0.1
+2.0 $+1.7$ $+1.7$ $+1.8$ $+2.2$ $+2.6$ $+2.5$ $+2.0$ $+1.7$ $+1.7$ $+1.6$ $+1.2$ $+0.6$ $+0.2$	0.0
$\begin{array}{c ccccccccccccccccccccccccccccccccccc$	0.0

STATISTICS						
	Avg	Max	Min	Max/Min	Avg/Min	
	5.2 fc	80.1 fc	0.0 fc	N/A	N/A	
	0.4 fc	1.2 fc	0.0 fc	N/A	N/A	

LIGHTING

Landscaping/Parking


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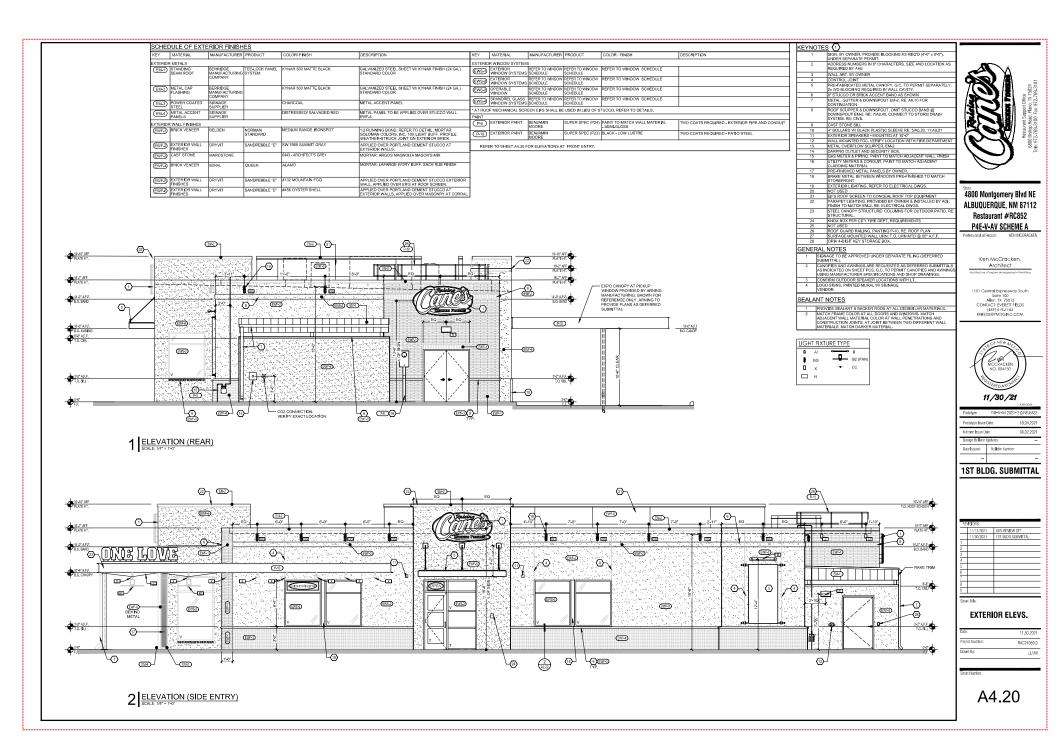
Property Line


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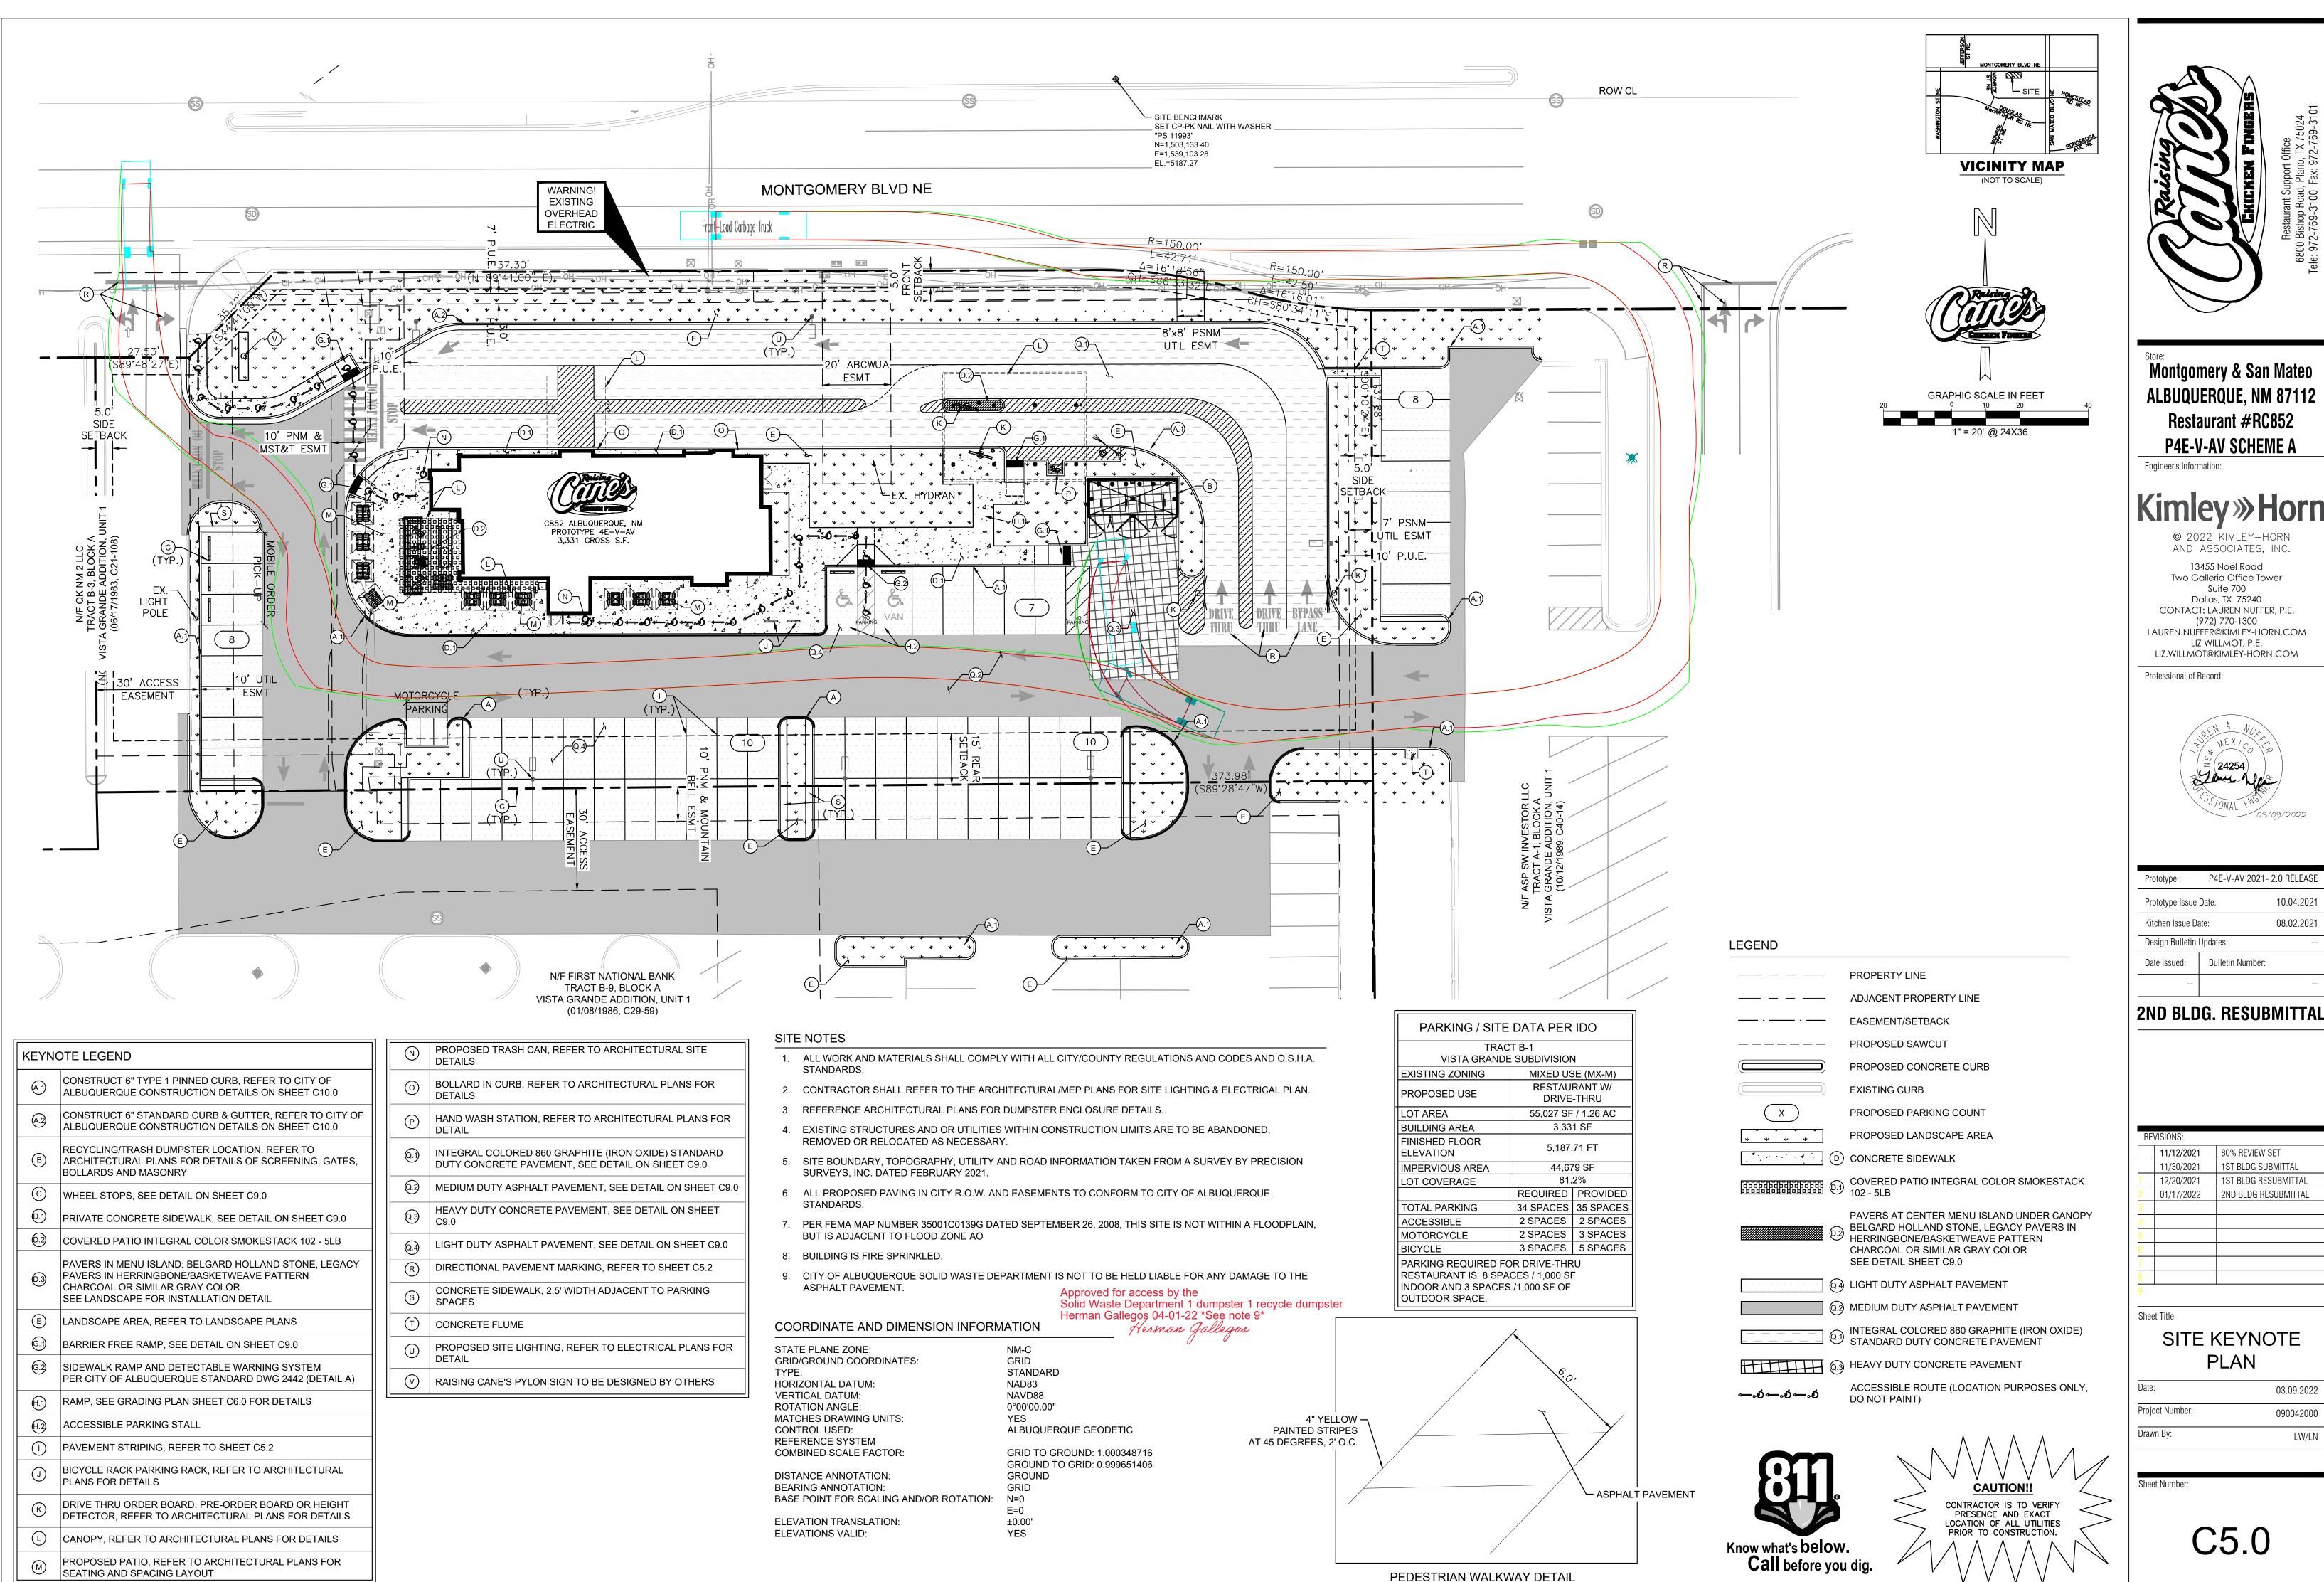
Raising	CHICKEN FINGERS Restaurant Support Office 6800 Bishop Road, Plano, TX 75024 Fele: 972-769-3100 Fax: 972-769-3101
ALBUQUEF Restau	tgomery Blvd NE RQUE, NM 87112 rant #RC852
Professional of Reco Ken N A Architecture • Prog 1101 Centra Alle	AV SCHEME A ord: KEN MCCRACKEN MCCracken, Architect gram Management • Permitting al Expressway South Suite 100 en, TX 75013 CT: EVERETT FIELDS
IN PROFILE	BARBATTO 4 EN ME + CO 26186 S/ONAL ENGINE
Prototype Issue Date:	08.02.2021
	lates: Bulletin Number: SUBMITTAL
REVISIONS: 11/12/2021 11/30/2021 1 12/27/2021 2 01/17/2022 05/03/2022 3 4 5 6	80% REVIEW SET 1ST BLDG SUBMITTAL 1ST BLDG RESUBMITTAL 2ND BLDG RESUBMITTAL DRB SUBMITTAL
7 8 9	
	TOMETRIC TE PLAN
Date: Project Number: Drawn By:	07.12.2022 RAC21059.0 LL/JN
Sheet Number:	


E1.1a





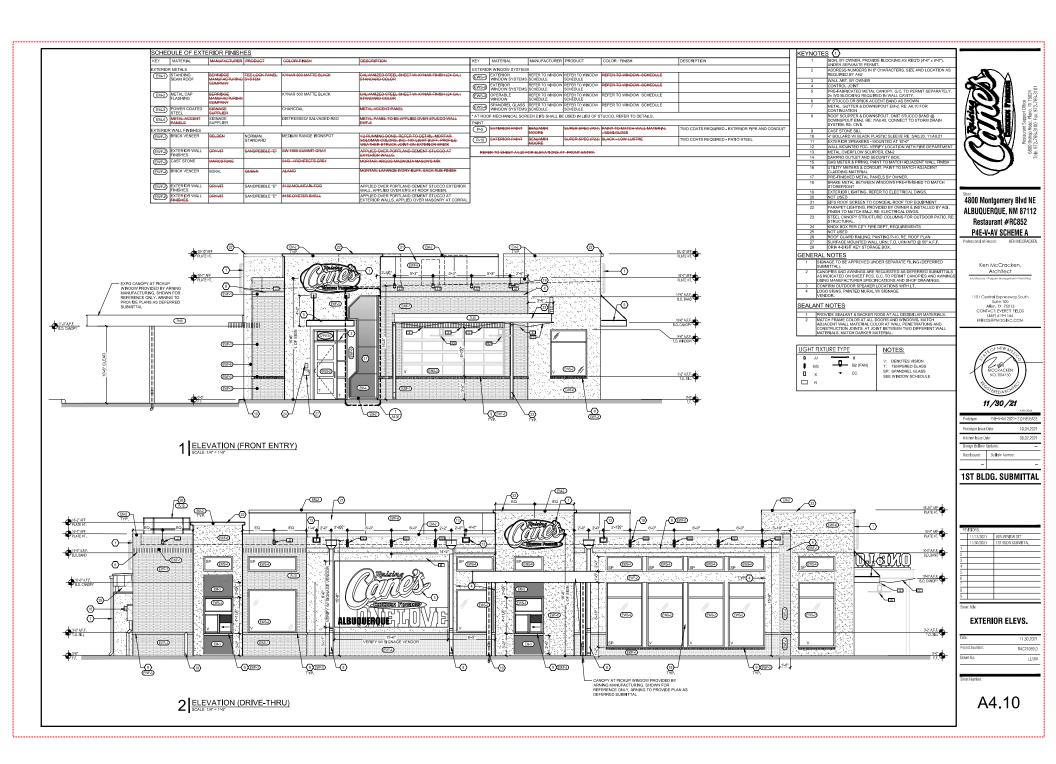

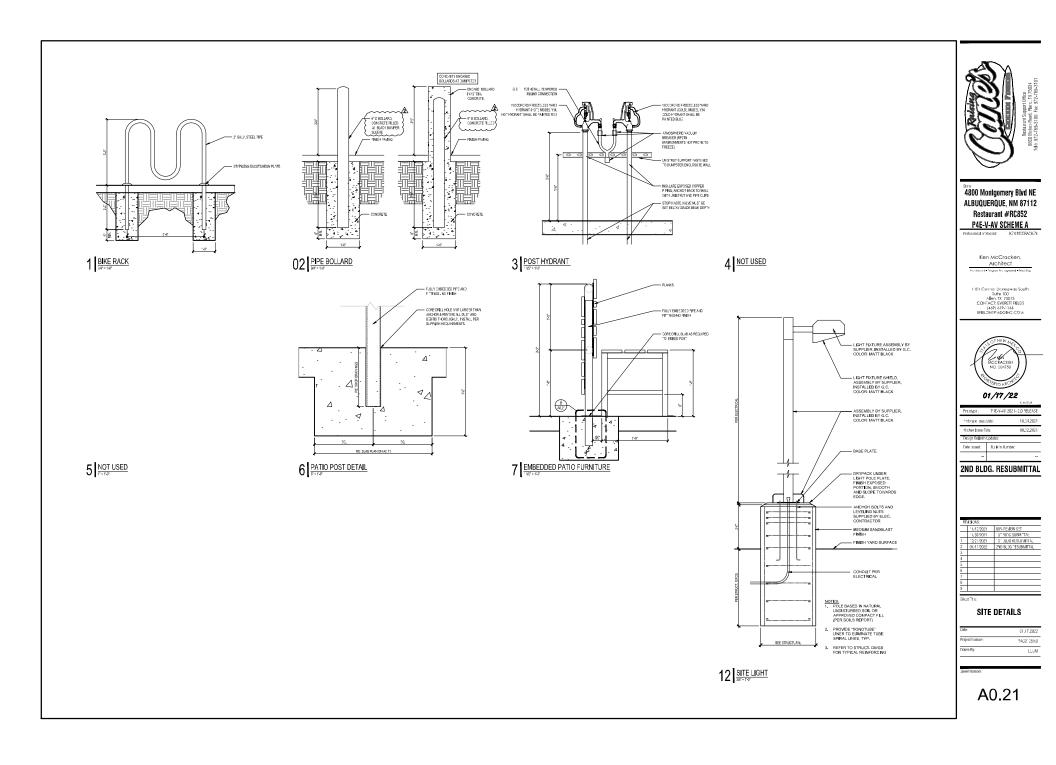

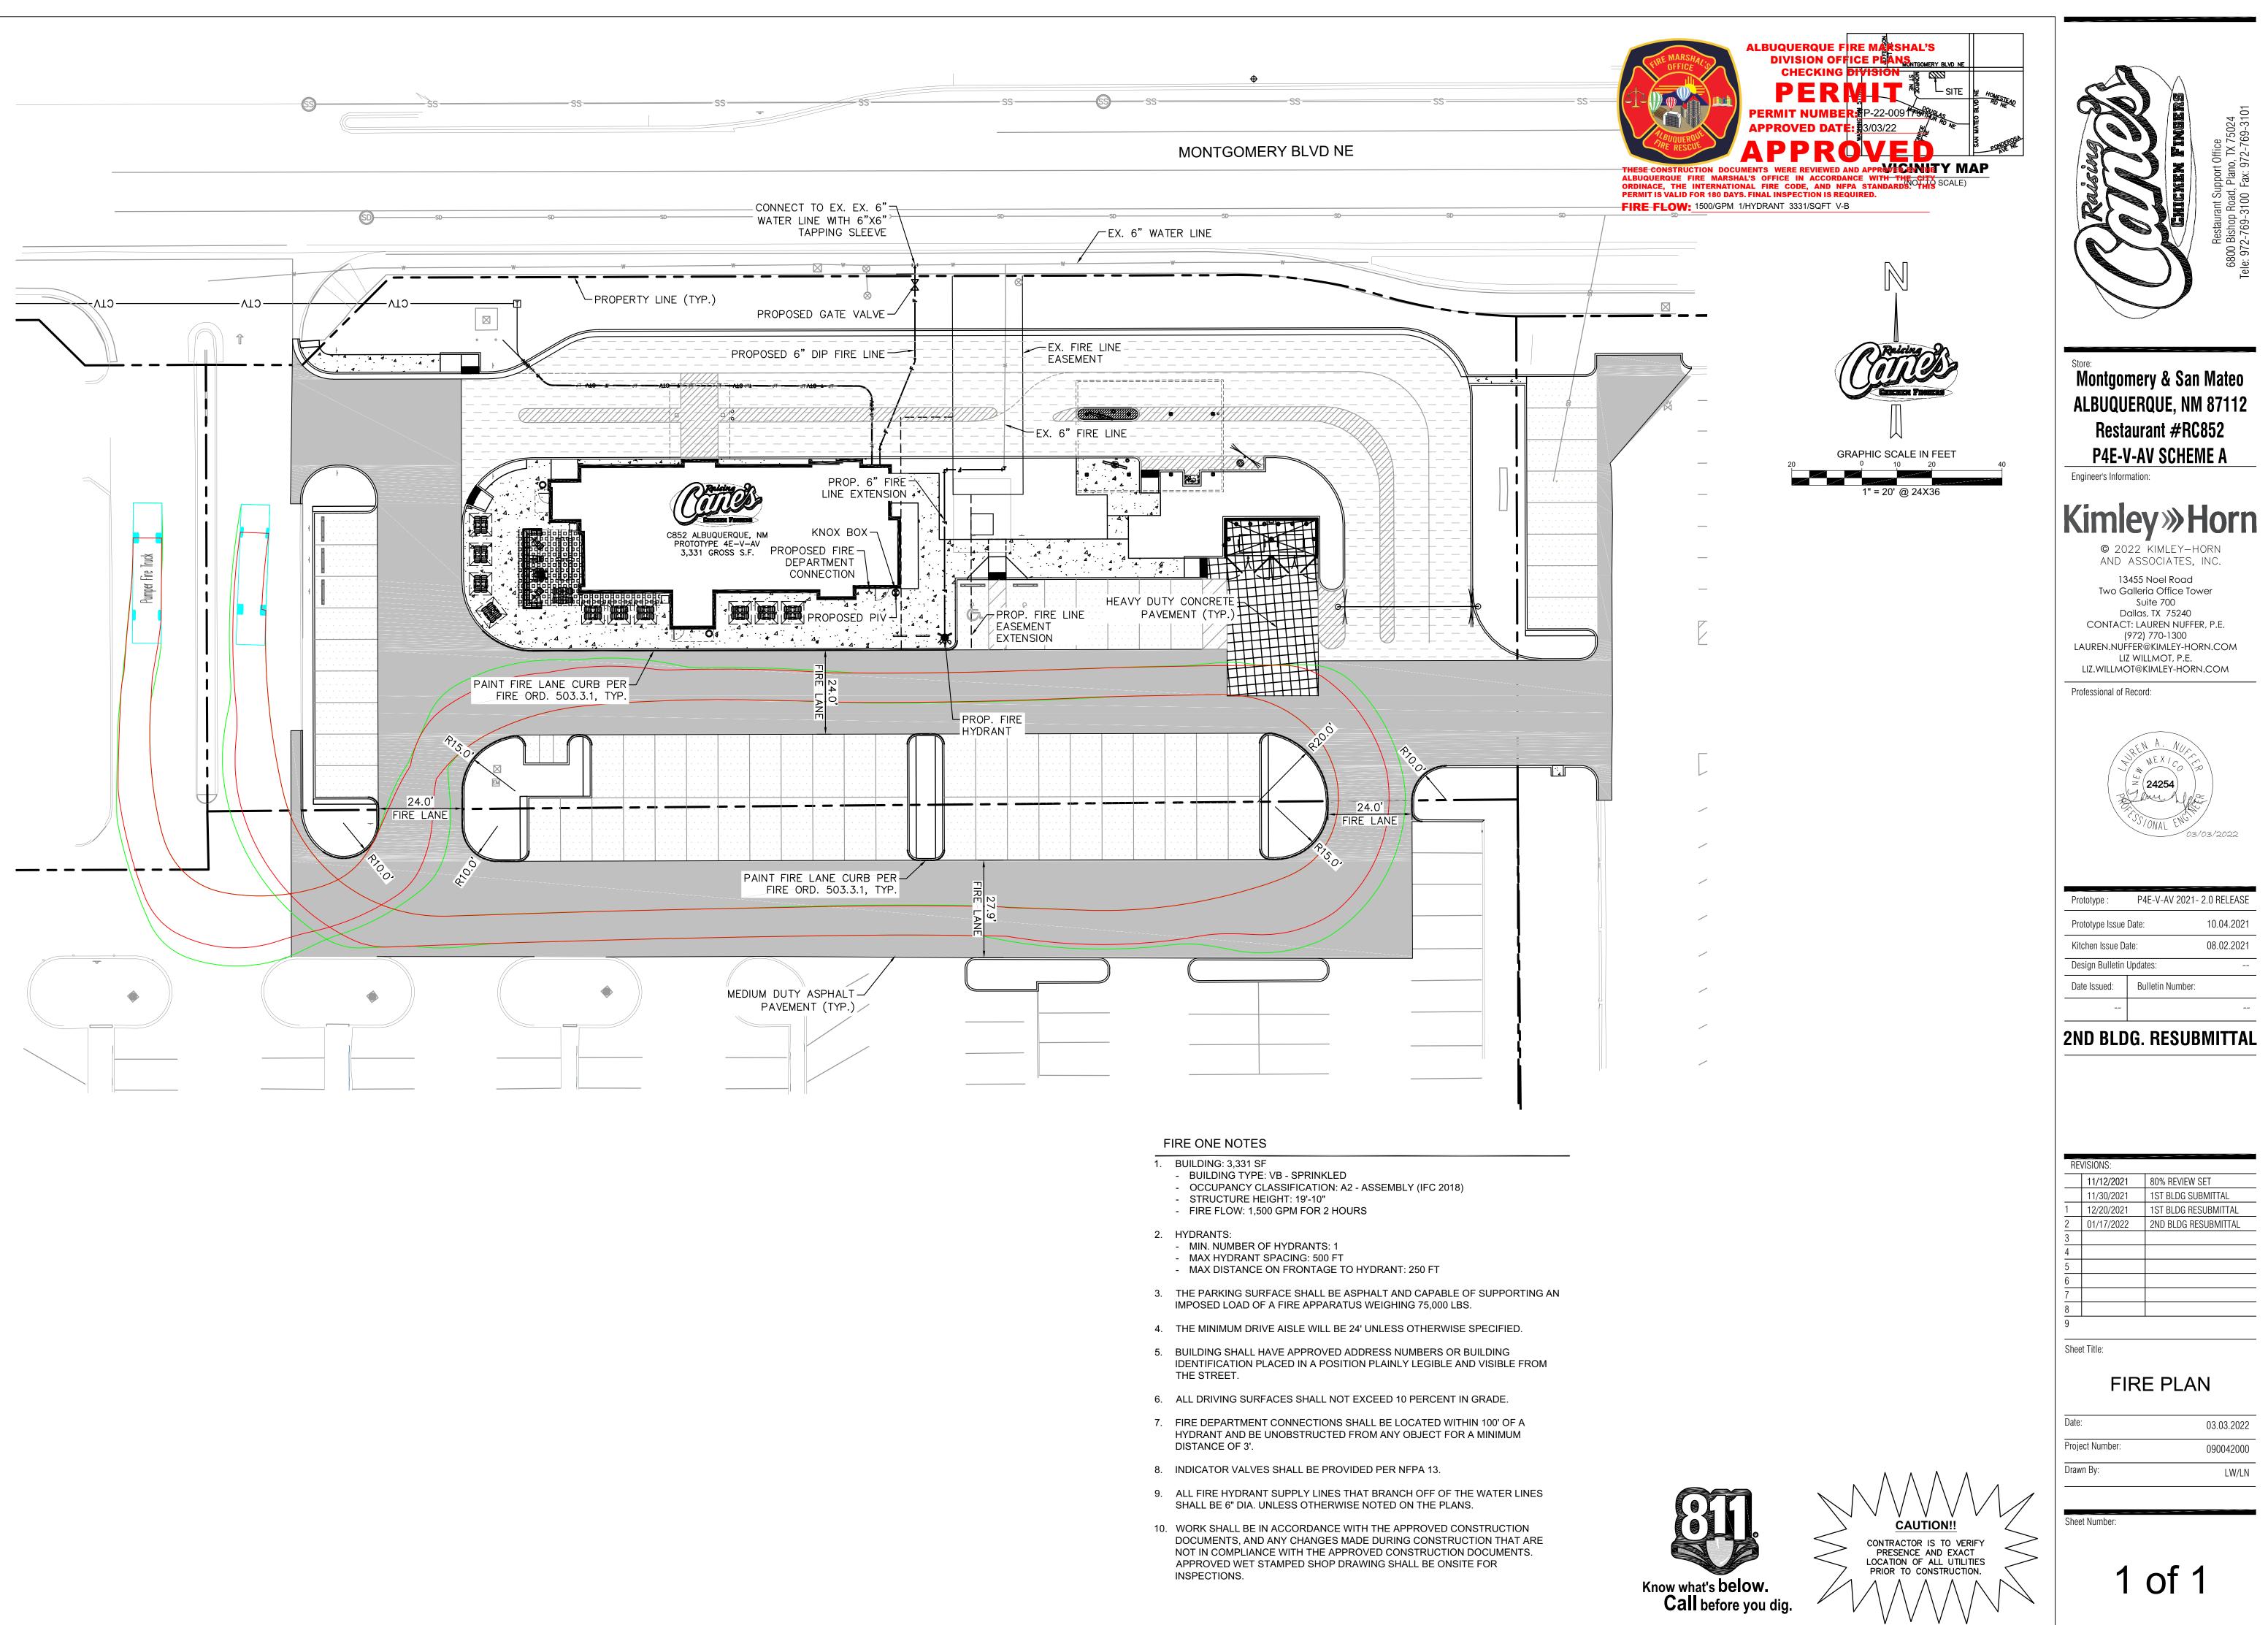



30% GLAZING REQUIREMENT ALONG DRIVE THRU AT MONTGOMERY BLVD.





POWDER COATED STEEL MATTE **BLACK FINISH**

EM-4



RECLAIMED METAL PANEL: VINTAGE CAR HOOD OCCURS AT FACE OF THE "1" ELEMENT ONLY

EWF-1



BELDEN NORMAN BRICK MASONRY MEDIUM RANGE, SMOOTH, IRON SPOT. MORTAR TO MATCH SOLOMON PRODUCTS IO H, WEATHERED HORIZONTAL STRIKE. VERTICAL JOINTS ARE FLUSH

MATERIAL FINISHES



"SW 7669 SUMMIT GRAY" PORTLAND CEMENT STUCCO

EWF-4



EWF-5



"132 MOUNTAIN FOG" PORTLAND CEMENT STUCCO

PRODUCTS IO H, LIGHT BUFF

SACK RUB FINISH.







"456 OYSTER SHELL" CEMENT STUCCO

EWS-2



ALUMINUM STOREFRONT SYSTEM FINISH: ANODIZED BLACK

EXTERIOR ELEVATIONS C852 – Montgomery and San Mateo – Albuquerque, NM | August 20, 2021










4800 Montgomery Blvd NE/RC0852 Alburquerque, NM 87109 5/4/2022

DRAWIN	DRAWING REVISIONS							
DATE	PM	CHANGE						
11/24/21	SH	Updated elevations & changed to flame, added speaker post & lemonade sign						
12/21/21	SH	Updated siteplan & elevations, changed to mural						
3/12/22	SH	Updated siteplan & added pylon sign						
4/5/22	SH	Updated elevations & changed to OL channel letters						

SITEMAP

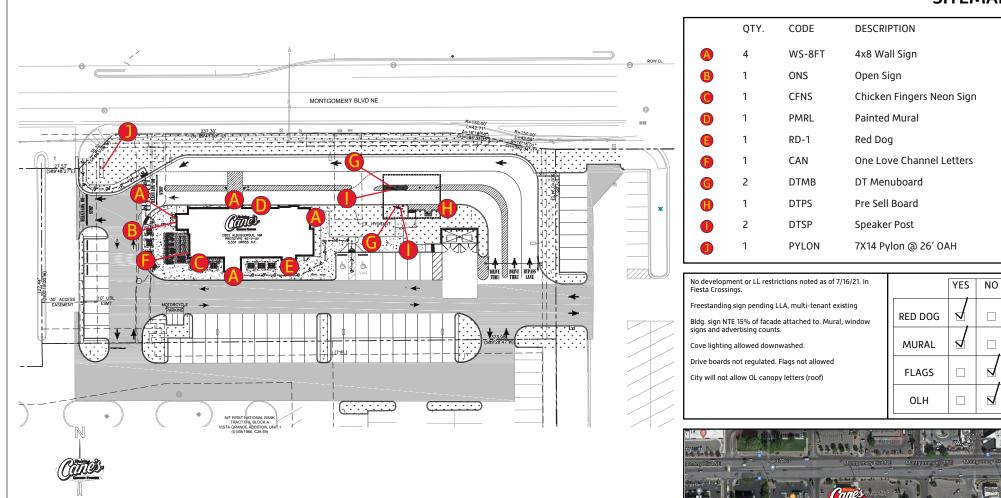






Location: Albuquerque, NM	AGI Rep: S. Holmes
Site ID: RC0852	AGI PM: Katie Norman
Date: 07/20/2021	Drawn by: M. Folden

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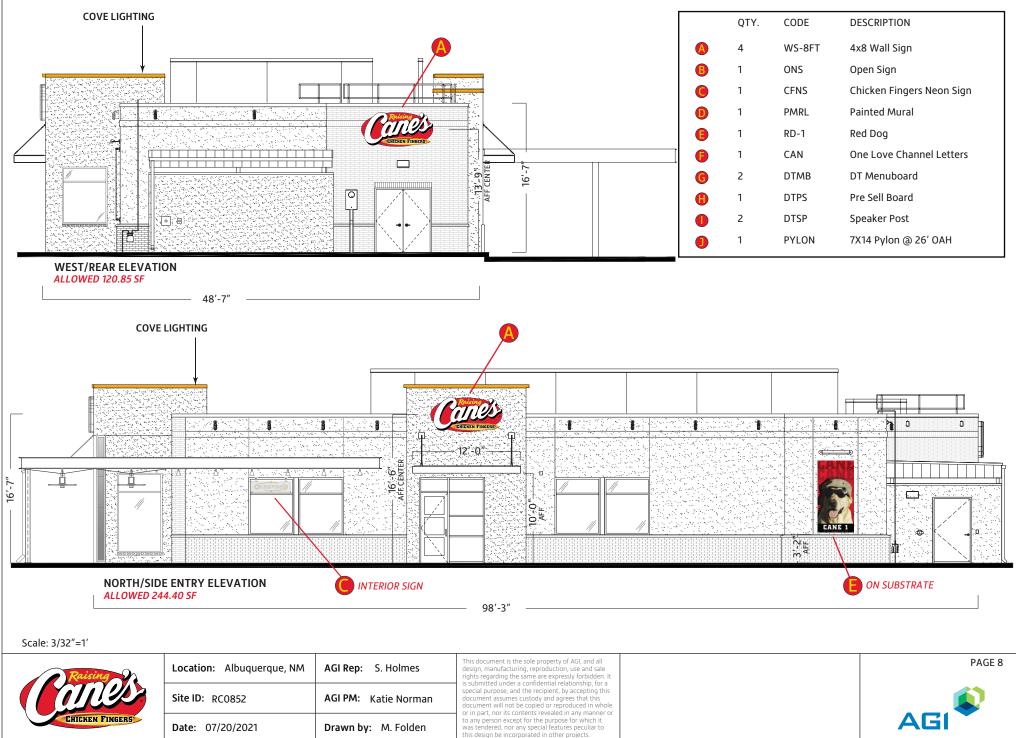


PAGE 2

ELEVATIONS

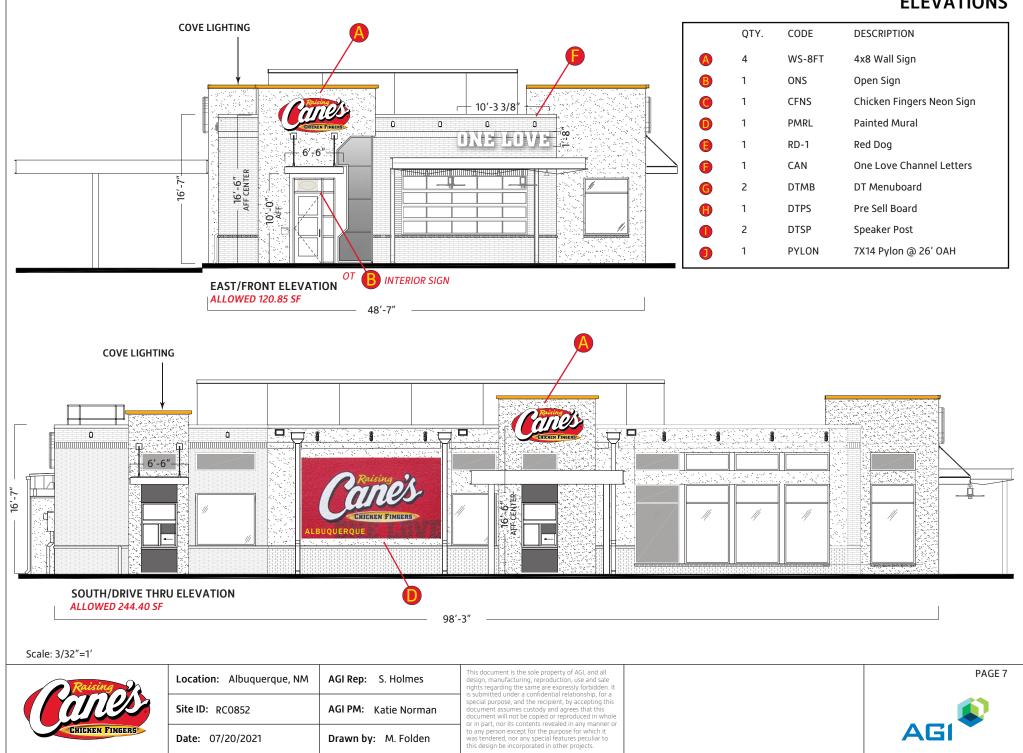

ELEVATIONS






Scale: 3/16"=1'



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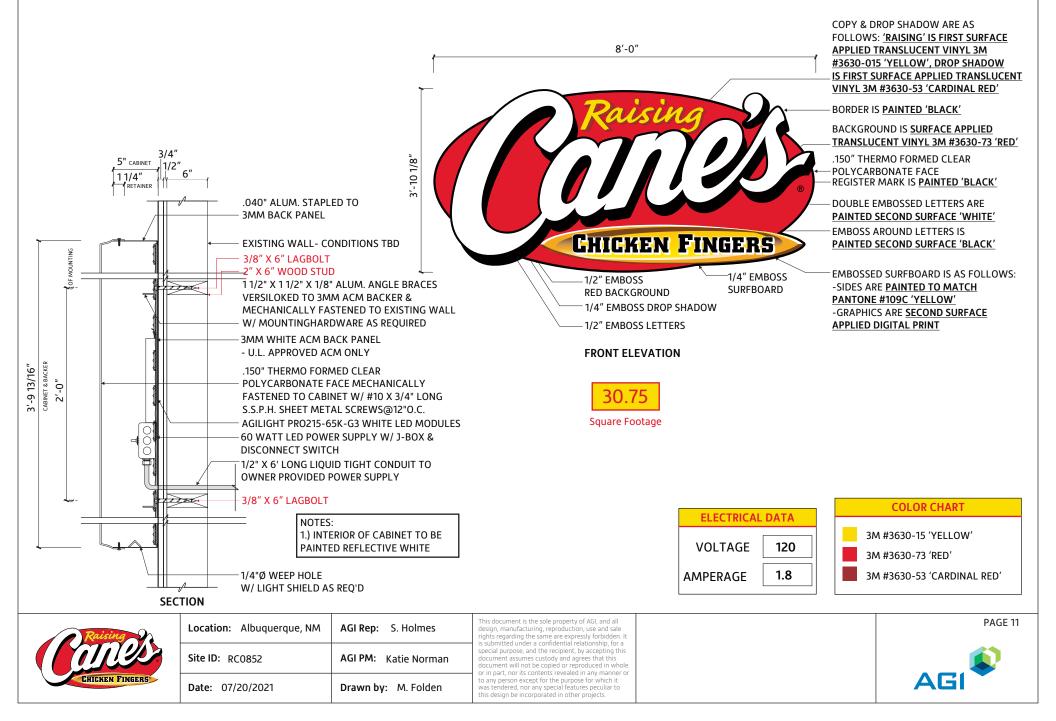
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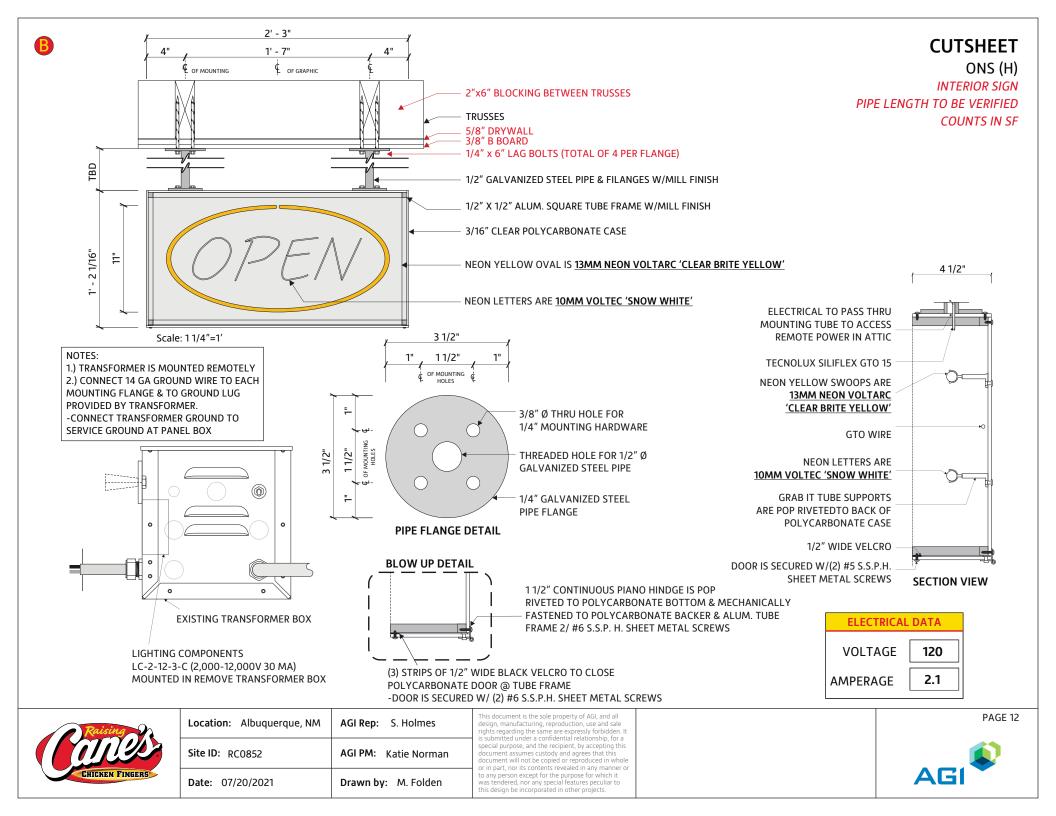
CUTSHEET PH-0714 PENDING SITE SURVEY AND LL APPROVAL




this design be incorporated in other projects.

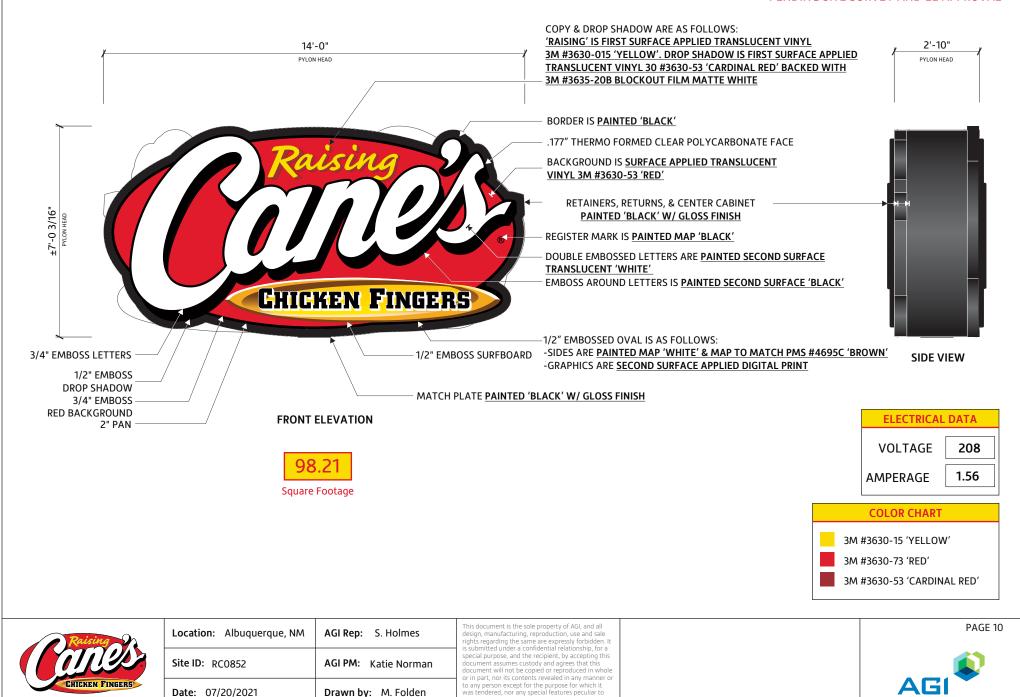CUTSHEET WS-8FT ALLOWED 15% OF FACADE ATTACHED TO





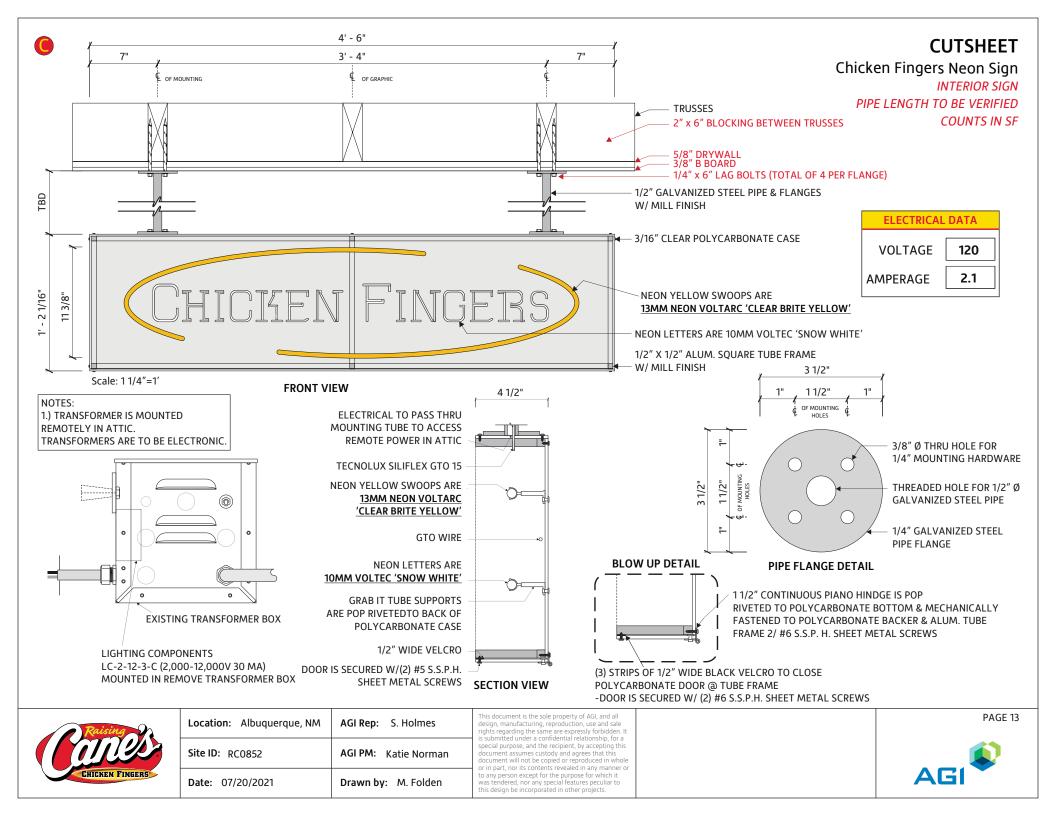






FOR ARTIST RENDERING USE ONLY MURAL PROVIDED BY OTHER VENDOR





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PAGE 14





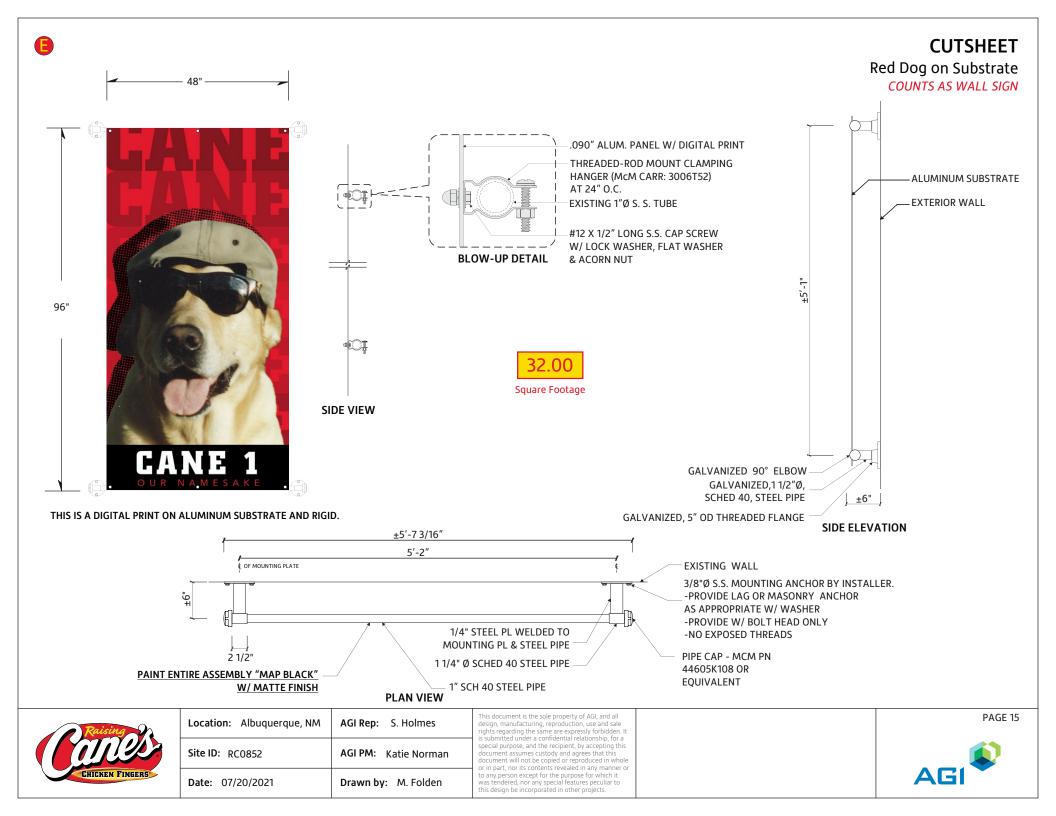


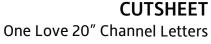
SIDE SECTION

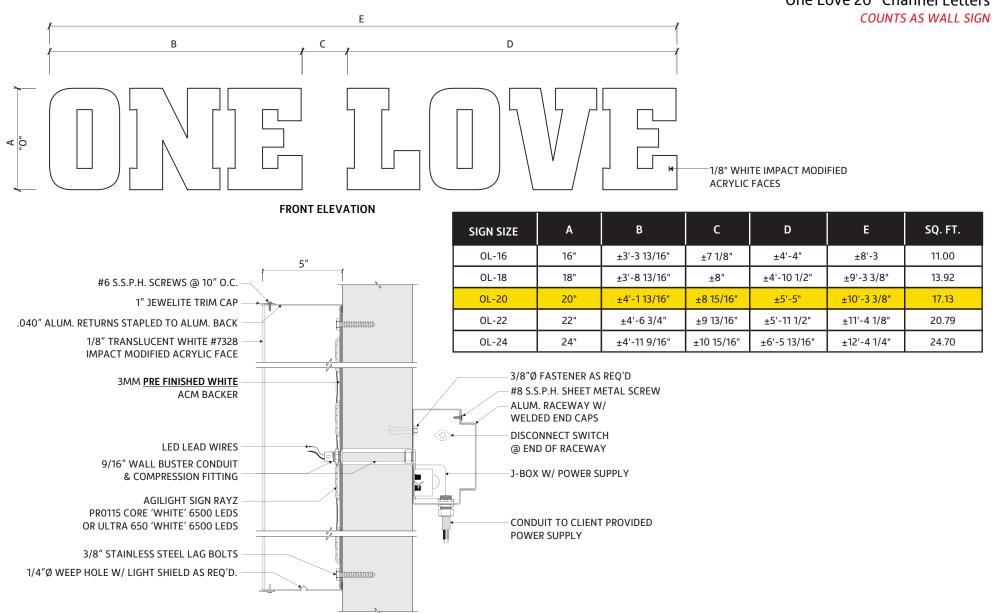

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CUTSHEET Cove Lighting ILT



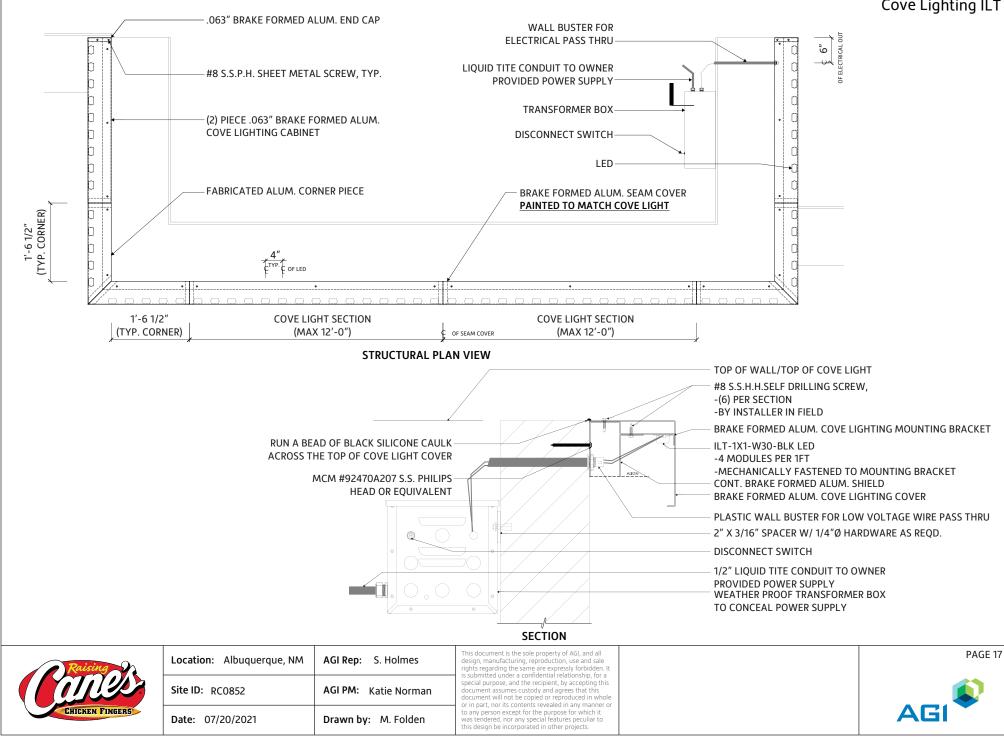

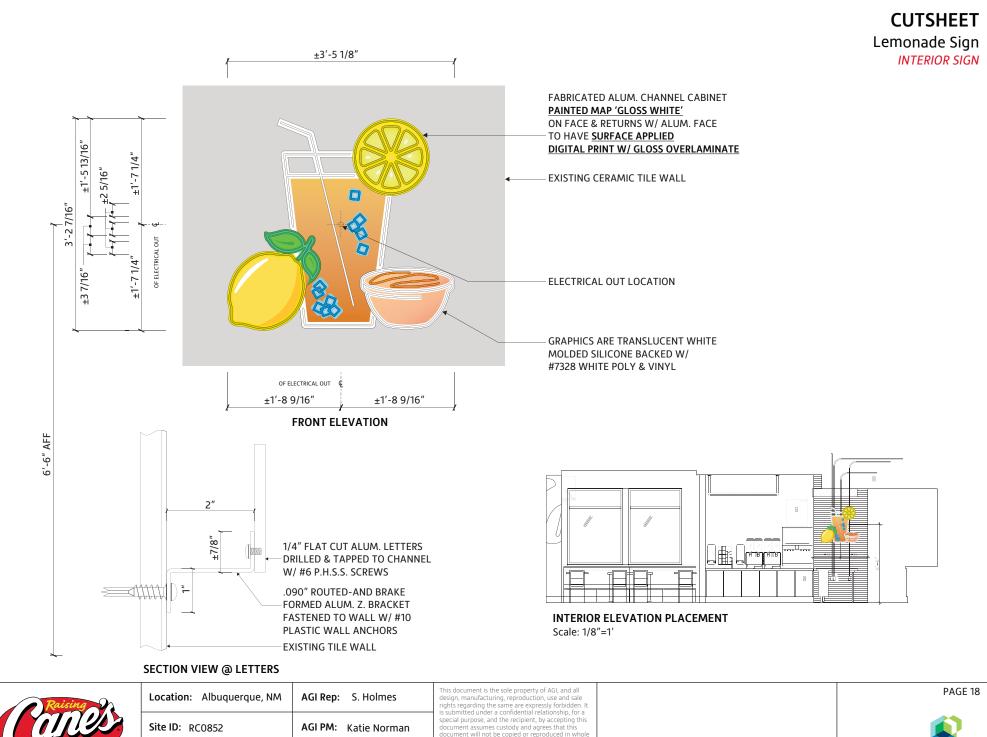CHICKEN FINGERS Date: 07/20/2021

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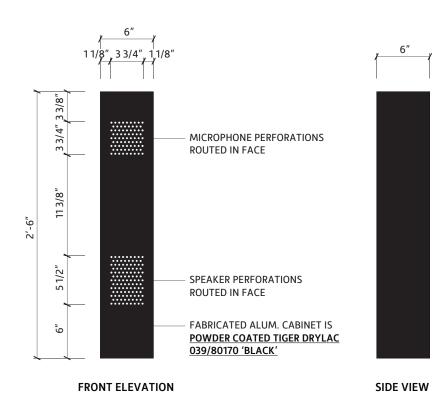
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	Site ID: RC0852	AGI PM: Katie Norman			
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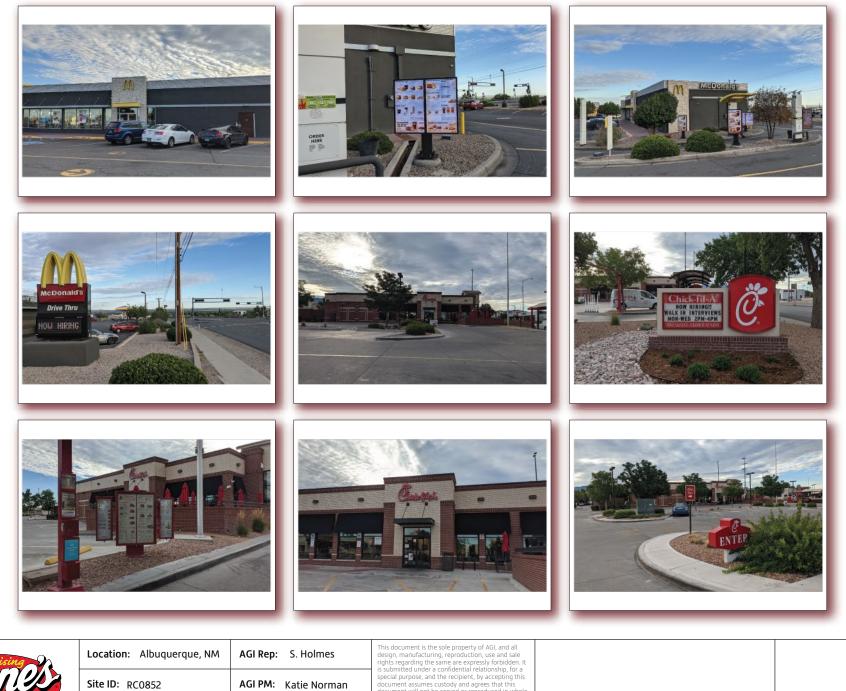
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(alles	Site ID: RC0852	AGI PM: Katie Norman			
CHICKEN FINGERS	Date: 07/20/2021 Drawn by	Drawn by: M. Folden			

SURROUNDING SITE PHOTOS



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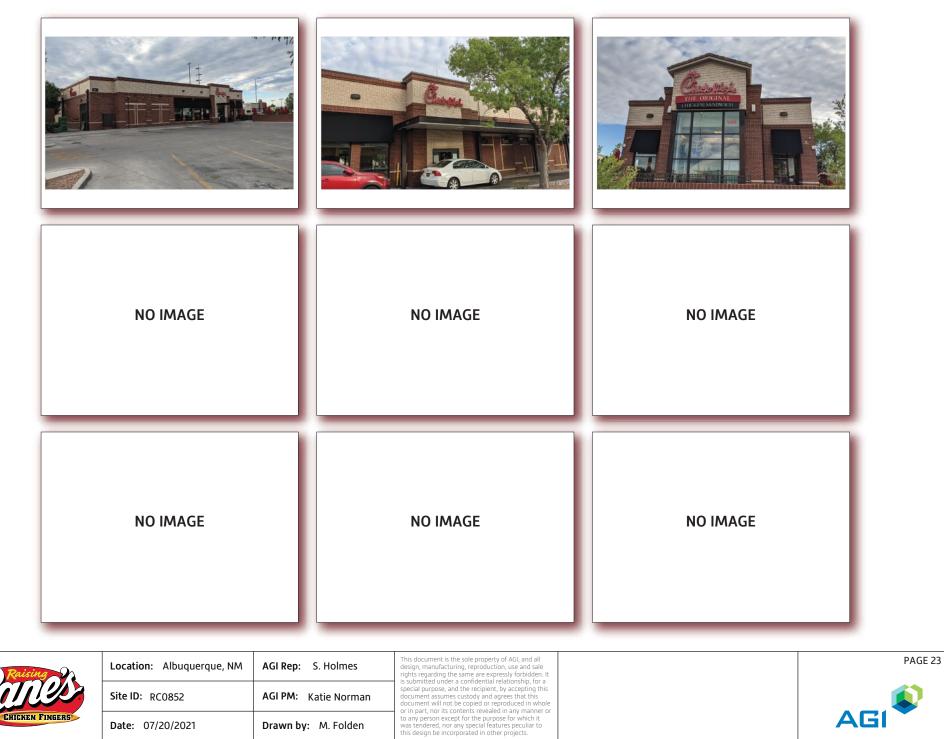
CHICKEN FINGERS

Date: 07/20/2021




PAGE 22

SURROUNDING SITE PHOTOS



PROJECT DESCRIPTION ALL EXISTING IMPROVEMENTS ONSITE, INCLUDING ROCK & BREWS BUILDING, ASPHALT DRIVE AISLES AND PARKING STALLS, CURBING, AND UTILITIES SERVING THE EXISTING BUILDING WILL BE DEMOLISHED. A NEW BUILDING WITH ASSOCIATED ASPHALT DRIVE AISLES AND PARKING STALLS, CURBING, AND UTILITY SERVICES WILL BE CONSTRUCTED IN ACCORDANCE WITH THE INTEGRATED DEVELOPMENT ORDINANCE (IDO) RULES AND REGULATIONS, AS DETAILED IN THIS EPC MAJOR AMENDMENT SUBMITTAL

DRB MAJOR AMENDMENT, MAY 2022

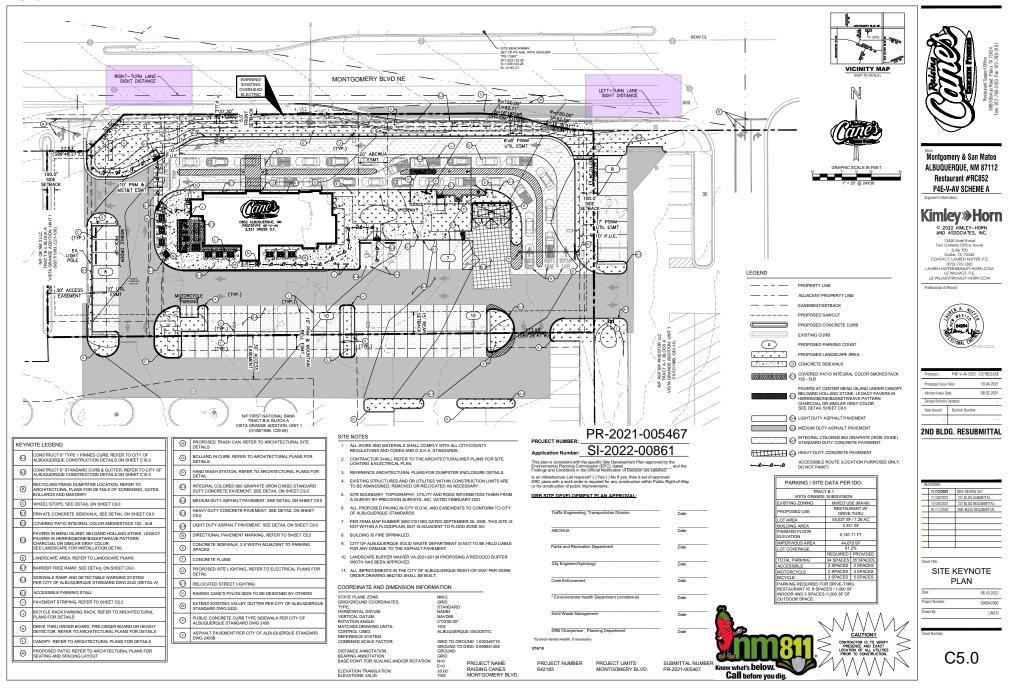

PR-2021-005467_SI-2022-00861_Site_Plan_Ap proved_7-20-22_Sheet_1

Final Audit Report

2022-07-26

Created:	2022-07-20
Ву:	Jay Rodenbeck (jrodenbeck@cabq.gov)
Status:	Signed
Transaction ID:	CBJCHBCAABAABTIXhNnOi2ZjSVUBqmTH4tGJhxVWKTi7

"PR-2021-005467_SI-2022-00861_Site_Plan_Approved_7-20-22 _Sheet_1" History

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