

DEVELOPMENT REVIEW BOARD SUPPLEMENTAL SUBMITTAL

(Deadline is Friday at noon unless noted on DRB calendar – late submittals will not be accepted unless approved by the DRB)

PROJECT NO. PR-2021-005467 Application No. SI-2022-00861
TO: X Planning Department/Chair Hydrology Transportation Development ABCWUA Code Enforcement Parks & Rec *(Please attach this sheet with each collated set for each board member)
NOTE: ELECTRONIC VERSION (ie disk, thumbdrive) is Required. Submittal will not be accepted without.
DRB SCHEDULED HEARING DATE: HEARING DATE OF DEFERRAL: May 18, 2022
SUBMITTAL DESCRIPTION: This submittal address all comments received from the DRB to include:
Updated Plans, Colored Elevations, Sign Package and updated Infrastructure List.
CONTACT NAME: Regina Okoye 505.338.1499 (Ext. 1003) TELEPHONE:EMAIL: rokoye@modulusarchitects.com



May 11, 2022

To: Jay Rodenbeck

One Albuquerque Planning jrodenbeck@cabq.gov
505,924,3994

Re: Raising Cane's (4800 Montgomery Blvd NE) PR-2021-005467

Dear Mr. Rodenbeck:

Please find the following responses addressing comments received in a letter dated May 4,2022 from the One Albuquerque Planning:

Department/Reviewer (Development Review Board)

Comment 1: Signature blocks for DRB members and Solid Waste must be added to the Site

Response 1: Comment addressed, see sheet C5.0 – Site Keynote Plan.

Comment 2: The project and application numbers must be added to the Site Plan

Response 2: Comment addressed in C5.0 Keynote Plan.

Comment 3: Future development must meet all applicable standards and provisions of the

IDO and the DPM.

Response 3: Comment Noted.

Comment 4: There is an Infrastructure List included with the application submittal. Therefore,

a recorded Infrastructure Improvements Agreement (IIA) must be submitted prior to final sign off from Planning if/once the EPC Final Site Plan Sign Off is

approved by the DRB.

Response 4: Comment Noted.

Comment 5: The Infrastructure List must be signed and dated.

Response 5: Resubmitted Infrastructure List has been signed and dated.



Comment 6: Confirmation must be provided that the Building Design requirements of 5-11(E)

of the IDO are being met in a comment response letter and/or on the elevations. Staff could not discern that the requirements are being met per the EPC Staff Report, EPC Site Plan Amendment submittal, and the EPC Final Site Plan Sign

Off submittal.

Response 6: Refer to the provided compliance letter meeting the Building

Design requirement of 5-11(E).

Comment 7: To confirm the requirements of the 5-11 (E) of the IDO are being met, staff

request color elevations.

Response 7: Refer to the provided rendered elevations with material finish

sheet.

Comment 8: 5-5(I)(2)(a) of the IDO requires a landscape buffer at least 6-feet in width to

screen drive-through lanes adjacent to public rights-of-way. The applicant asserts that a portion of the buffer on the northeastern portion of the site adjacent to Montgomery Boulevard cannot meet the 6-foot width requirement, and the buffer is as narrow as 3.6 feet in width. The applicant has applied for a Waiver from this requirement which is scheduled to be heard at the May 18 DRB meeting. The EPC Final Site Plan Sign Off cannot be approved

until/unless the Waiver is approved.

Response 8: Comment noted.

Department/Reviewer (Water Utility Authority)

Comment 1: Please provide a copy of your project's topographic survey. The proposed sanitary

sewer manhole connection is not within our mapping yet appears in the street view

image. We would like to add this manhole to our database.

Response 1: Topographic survey has been included in this submittal package.



Comment 2: Revise the irrigation meter to connect directly to the six-inch public water main. We do not allow multiple meters from a single tap.

Response 2: The irrigation meter has been revised as noted.

Comment 3: Note that the fireline connection will be required to be a dry-tap. We do not allow wettaps for 6-inch services onto 6-inch mains.

Response 3: Comment addressed in the Note 16 in C8.0 Utility Plan.

Comment 4: Infrastructure List:

- a) No objections
- The Water Authority improvements may be constructed via a mini-work order or included in the DRC Work Order.

Response 4: Comment Noted.

Comment 5: Exclusive public water and sanitary sewer easements are required for all public lines

that are to be constructed outside of any dedicated rights-of-way. Easements for standard sized water meters need to be 5'x5' and include the length of the water

service if located on private property.

Response 5: Comment addressed in C8.0 Utility Plan.

Comment 6: Information Only

- a) Availability Statement #220303 has been issued and provides the conditions for service. Routine connections are available
- b) This project is within the adopted service area
- c) Pro rata is not owed for this property.

Response 5: Comment Noted.

Department/Reviewer (Parks & Recreation)

No Comments.



Department/Reviewer (Code Enforcement)

Comment 1: As noted on Amended Site Plan, development must follow the approved EPC Plan;

where silent, relevant IDO sections will apply.

Response 1: Comment Noted.

Comment 2: Follow IDO section 5-8 Outdoor and Site Lighting (not specified on plan)

Response 2: Comment noted, the proposed lighting submittal is included for

reference.

Comment 3: Follow IDO section 5-12 for Signs, both Freestanding and Wall signs, even if painted

on building, must meet percent of façade requirements (15% for MX-M zone).

Response 3: Refer to the provided compliance letter meeting the Building Design

requirement of 5-12.

Comment 4: Freestanding Pylon Sign must be located at least 3 feet from property line (not

indicated on site plan), as per IDO section 5-1(G), Table 5-1-4.

Response 4: Comment addressed in sheet C5.1 - Dimensional Control

Plan.

Department/Reviewer (Transportation Development)

Comment 1: Platting action shall be approved prior to site plan approval. Establish shared access

as part of plating action

Response 1: Comment noted. Easements will be finalized during the platting

process.

Comment 2: On the infrastructure list, "Montgomery" is misspelled. Also, call out width and length

of lane extensions and additions per the Traffic Impact Study

Response 2: The street name has been corrected and width and length of right-

turn lane extension has been added. Refer to the Infrastructure List.



Comment 3: On separate sheet, show queue for the drive-thru at 20-foot lengths.

Response 3: Comment noted, see sheet C5.0 – Site Keynote Plan.

Comment 4: Use exact detail for graphics of ramps on site plan. Specify header curb, minimum

landing area, etc.

Response 4: Comment noted. All ramps have been called out with City of

Albuquerque ramp details.

Comment 5: At least one 8-foot-wide van accessible aisle is needed for the handicapped spaces.

Response 5: Comment addressed. Updates can be found in sheet C5.1

Dimensional Control Plan

Comment 6: Include motorcycle parking sign as part of the detail sheet. The curb pick-up sign is

illegible.

Response 6: Motorcycle Parking Only sign has been added and the Mobile

Curbside Pick-Up sign has been altered, see sheet C5.2 – Striping

and Signage Plan.

Comment 7: Detail on-site parking striping. Specify color, spacing of diagonal striping, etc.

Response 7: Comment addressed on sheet 5.2 – Striping and Signage Plan

Comment 8: Show clear sight triangles along with the standard note on landscape height

restrictions. Use intersection clear sight distance along Montgomery Blvd. Specify on

both site plan and landscaping plan

Response 8: Comment noted, see sheet C5.0 – Site Keynote Plan.



Zoning Data

Flood Map

Flood Note

Notes Corresponding to Schedule B-II

- (1) EASEMENT(S) RESERVED ACROSS THE WISHRED LAND, AS SHOWN ON THE RECORDED PLAT, FILED WI THE OFFICE OF THE COUNTY CLERK OF BERNAULLO COUNTY, NEW MEMOCO, ON NOVEMBER 23, 1881, IN PLAT BOOK CIS, FOLIO 27, AFFECTS PARCEL I. AS PLOTTED

- RECORDS OF REMANLUL COUNTY, NEW MEXICO. AFFOLTS PARCEL I. AS PLOTTED

 (I) MICREMORIUM CALENDER MAINTED TO PUBLIC SERVICE COMPANY OF NEW MEXICO AND MOUNTAIN

 STATES TELEPHORY AND ITELEORIPM COMPANY, FILED TERROURS (II. 1882 , RECORDED IN BOOK

 AFFOLTS PROMPE AND TELEPHORY MORE—515, RECORDED OF REMANLUL COUNTY, REW MEXICO.

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 SERVILLAD CONTY, NEW MEXICO. APETES PAREL 1, AS FORTED
- ABRICALLE COURT, NEW WOOD, APPLICES PARKET, LASE POUTED AND VITES FRANCE FRANCE
- [21] RATINGATION OF SHARED PARKING AGREEMENT FILED DECEMBER 17, 2003, RECORDED IN BOOK A70, PAGE 2876 AS DOCUMENT NO. 2003223353, RECORDS OF BERNAULLO COUNTY, NEW MEXICO, AFFECTS PAGELS I AND A MYD NOT PLOTTABLE
- 22) UNDERFORMING EASIERTY GRANTED TO PUBLIC SETRICE COMPANY OF NEW MEXICO, FILED NOVEMBER 5, 2004, RECORDED IN BOOK ABS, PACE 5607 AS DOCUMENT NO. 2004156038, RECORDS OF BERMAULIO COUNTY, NEW MEXICO, AFFECTS PARCEL, I. A SPLOTTED
- (2) PERMANENT EASEMENT FILED AUGUST 27, 2014 AS DOCUMENT NO. 2014067544, RECORDS OF BERNALILLO COUNTY, NEW MEXICO. AFFECTS PARCEL I, AS PLOTTED
- [26] NOTICE OF NON-EXERCISE OF FIRST RIGHT OF REFUSAL AS SET FORTH ON DOCUMENT RECORDED DECEMBER 8, 2011112852, RECORDS OF BERNAULLO COUNTY, NEW MEXICO. AFFECTS PARCEL I AND
- NOT PLOTHABLE

 27) UNRECORDED LEASE BETWEEN USRP FUNDING 2001-A, L.P., A DELAWARE LIMITED PARTNERSHP,
 AS LESSOR AND GRALOC INVESTMENTS, LLC, A NEW MEXICO LIMITED LIABILITY COMPANY, AS
 LESSER DATED JUNE 20 2004 AS MEMBER

Key Note Legend

AFFECTS SUBJECT PROPERTY: AS SHOWN AFFECTS SUBJECT PROPERTY: NON-SURVEY MATTER

A DOES NOT AFFECT SUBJECT PROPERTY

Notes

- 1. THE MATERIANDO UTULES SYMM HAVE BED LECATED FROM THEIL BURKEY REFINANCIA OF MADER BROWN APPRITAMENCES AND DESTRING DAMANCES. THE SURFECT HAVES NO GLARANITES THAT THE UIDERSTROUM UTULES SHOWN COMPRISE ALL THE UTULES IN THE AREA, ETHER IN SPRINCE OF MANAGED. THE SURFICE PRUMER DOES OF THE MADERATION OF MANAGED THE CONTROL OF MANAGED THE CONTROL OF MANAGED THE CONTROL OF THE MADERATION OF THE MADERIA OF THE
- NO OBSERVABLE EVIDENCE OF EARTH MOVING WORK, BUILDING CONSTRUCTION OR BUILDING ADDITIONS WITHIN RECENT MONTHS.
- 3. NO CHANGES IN STREET RIGHT OF WAY LINES EITHER COMPLETED OR PROPOSED, AND AVAILABLE FROM THE CONTROLLING JURISDICTION, NO OBSERVABLE EVIDENCE OF RECENT STREET OR SIDEMAK CONSTRUCTION OR REPAIRS.
- 4. NO OBSERVABLE EVIDENCE OF SITE USE AS A SOLID WASTE DUMP, SUMP OR SANITARY LANDFILL.
- 5. EASEMENT BEARINGS AND DISTANCES SHOWN HEREON ARE RECORD AND EASEMENTS HAVE BEEN ROTATED TO MATCH BASIS OF BEARINGS AND BOUNDARY UNLESS OTHERWISE INDICATED
- ELEVATION DATUM IS BASED ON NAVD 1988 FROM AGRS MONUMENT "F_18", PUBLISHED ELEVATION (FEET) = 5212-228
- THIS MAP HAS BEEN PRODUCED ACCORDING TO PROCEDURES THAT HAVE BEEN DEMONSTRATED TO PRODUCE DATA THAT MEETS OR EXCEEDS THE MINIMUM STANDARDS FOR A TOPOGRAPHIC MAP COMPLED AT A SCALE OF 1°20' WITH A CONTOUR HITERVAL OF ONE FOOT.

Statement of Encroachments

(A) APPARENT ENCROACHMENT OF COMMERCIAL BUILDING ONTO PNM & MST&T EASEMENT

COORDINATE AND DIMENSION INFORMATION STATE PLANE ZONE GRID ARROUND COORDINATES: PLSS INFORMATION PROPERTY INFORMATION GRID PROPERTY OWNER TRADECOR 4800 MONTGOMERY LLC 0° 00' 00.00" YES SUBDIVISION NAME VISTA GRANDE, UNIT 1 RANGE 03 EAST TOWNSHIP 10 NORTH COUNTY STATE BERNALILLO NIM 101706044751711603 ADDRESS 4800 MONTGOMERY BLVD, N.E. ALBUQUERQUE

ALTA/NSPS Land Title Survey

Tract B-1, Block 1,

Vista Grande Addition, Unit 1

Albuquerque, Bernalillo County, New Mexico January 2022

Legal Description Per Field Survey

BEGONNING AT THE NORTHWEST CORNER OF DESCRIBED TRACT LYING ON THE SOUTH RIGHT OF MAY LINE OF MONTGOMERY BOULEVARD, N.E., MARKED BY A FOLIND NO. 5 REBAR MITH "LICLOP PLASTIC OF TERRIHOFFE LY 247" FROM MERCE A TE TO A.G.A.S. MONIMENT "9_PIS" BEARS N 3913"52" E, A DISTANCE OF 1687.08 FEET.

THENCE CONTINUING ALONG SAID SOUTH RIGHT OF WAY LINE, N 45'00'17" E. A. DISTANCE OF 35.32 FEET TO AN ANGLE POINT, MARKED BY A FOUND NO. 4 REBAR;

THEMCE CONTINUING ALONG SAID SOUTH RIGHT OF WAY LINE, ALONG A CURVE TO THE RIGHT, HAWING AN ARC LENGTH OF 42.71 FEET, A RADIUS OF 150.00 FEET, A DELTA ANGLE OF 151855", A HOROR BEARING OF S 2023.32", A NO A CHORD LENGTH OF 42.57 FEET TO A POINT OF REVEYS: CURVATURE, MARKED BY A SET NO. 5 REBAR WITH PINE PLASTIC CAP "PS 1933".

THENCE CONTINUING ALONG SAD SOUTH RIGHT OF WAY LINE, ALONG A REVERSE CURVE TO THE LEFT, HAWING AN ARC LENGTH OF 42.59 FEET, A READUS OF THE FEET ADELT ANALES OF THEORY A. CHORD LENGTH OF 52.44 FEET TO THE NORTHEAST CORNER OF BESCRIED TRACT, MARKED BY A FOUND NO. 3. BEBLAY:

THENCE LEAVING SAID SOUTH RIGHT OF WAY LINE, S 00"10"24" E. A DISTANCE OF 137-88 FEET TO THE SOUTHEAST CORNER OF DESCRIBED TRACT, MARKED BY A

THENCE S 89"28"47" W, A DISTANCE OF 373.98 FEET TO THE SOUTHWEST CORNER OF DESCRIBED TRACT, MARKED BY A FOUND PK NAIL WITH WASHER (ILLEGIBLE); THENCE N 00"1"51" W, A DISTANCE OF 127.44 FEET TO THE POINT OF BEGINNING, CONTAINING 1,2632 ACRES (55,027 SQUARE FEET), MORE OR LESS,

TOGETHER WITH VIEW-TIGGETHER EIGHT OF TASKINGT LONGER AND IN ACCORD WITH THE CRETAMATION OF RESTRICTIONS AND WART OF TASKINGT RECORD INFORMATION TO A STANISH THE THE ASSOCIATION OF A STANISH THE ASSOCIATION ASSOCIATI

Legal Description Per Title Commitment

A TRACT OF LANG BEING A PORTION OF TRACT B-1 OF THE AMENIES THAT OF TRACTS B-1 & B-2, BLOCK A, MSTA GRANDER ADDITION, UNT ONE, ABBIQUEROUE, NEW MERCIOL, AS THE SENIE IS SHOWN AND DESIGNATED ON THE FLAT THEREOF, FLEED IN THE OFFICE OF THE COUNTY CLERK OF BERNALLED COUNTY ON NOVEMBER 23, 1981 IN VOLUME CTS, FLOW 27, AND BEING MORE PARTICULARLY DESCREED AS FOLLOWS:

THENCE S 89" 41:00 W. 374.00 FEET: THENCE N 00' 19'00' W, 125.00 FEET;

THENCE N A9" 41'00'F. 27.50 FEET:

THENCE N 44' 41'00'E. 35.36 FEET TO A POINT ON THE SOUTH RIGHT-OF-WAY LINE OF MONTGOMERY BLVD. N.E.:

THENCE ALONG SAID RIGHT-OF-WAY LINE N 89" 41:00 E. 237.50 FEET:

THURCE 4.5.7 FET ALONG A CUPIE TO THE ROUT. MIGOE PAILUE IS 15.0.0 FET AND MYGIS LONG CHORD BEARS. SETH'S E-8.44 FET THROUGH A CONTRAL MIGOE OF 15.5.7.7 INDEXE 4.5.7 FET ALONG A CAST TO THE LET HYGIS RADUS IS 150.00 FET AND WIGSE LONG CHORD BEARS. S 82" IN 12" E, 42.43 FET THROUGH A CENTRAL MARIE OF 16" 15.3" OT THE NORTHEAST AND BEGINNIUS CONTRIC.

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Property Information Per County Assessor

UPC # 101706044751711603 OWNER: TRADECOR 4800 MONTGOMERY LLC PROPERTY ADDRESS 4800 MONTGOMERY BLVD. N.F.

Access Note

INGRESS AND EGRESS TO THE PREMISES IS PROVIDED BY MONTGOMERY BOULEVARD, N.E., THE SAME BRING A PAYED AND DEDICATED RIGHT OF WAY MAINTAINED BY THE CITY OF ALBUQUERQUE.

Surveyor's Certificate

TO RAISING CANE'S RESTAURANTS, LL.C., A LOUISIANA LIMITED LIABILITY COMPANY, OLD REPUBLIC NATIONAL TITLE INSURANCE COMPANY AND TRADECOR 4800 MONTGOMERY LLC, AN ARIZONA LIMITED LIABILITY COMPANY AS FOLIONS:

THE S TO CENTEY THAT THE MAP OF PLAT AND THE SUPPLY ON MINCH IT IS BASED METE MADE IN ACCORDANCE MAY THE 2011 MINIMAL STANDARD CETAL REQUIREMENTS FOR ALTA, ACCORDANCE THAT ESWRENTS, SUMMY ESTABLISHED AND ADOPTED BY ALT A

I FURTHER CERTIFY THAT THIS SURVEY MEETS THE MINIMUM STANDARD REQUIREMENTS FOR BOUNDARY SURVEYS AS ADOPTED BY THE NEW MEXICO BOARD OF LICENSURE FOR ENGINEERS AND

Reason: I attest to the accuracy and integrity of this document Date: 2022.01.06 10:45:55-07'00'




PRECISION

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	PROJECT INFORMATION	
tateo Boulevard, NE	CREW/TECH: MT	01/03/2022
10. ISM 87113	DRAWN BY: JK	CHECKED BY:
100 PAK	PSI JOB NO.	SHEET NUMBER




SITE PLAN EPC MAJOR AMENDMENT TRACT B-1, APRIL 2022

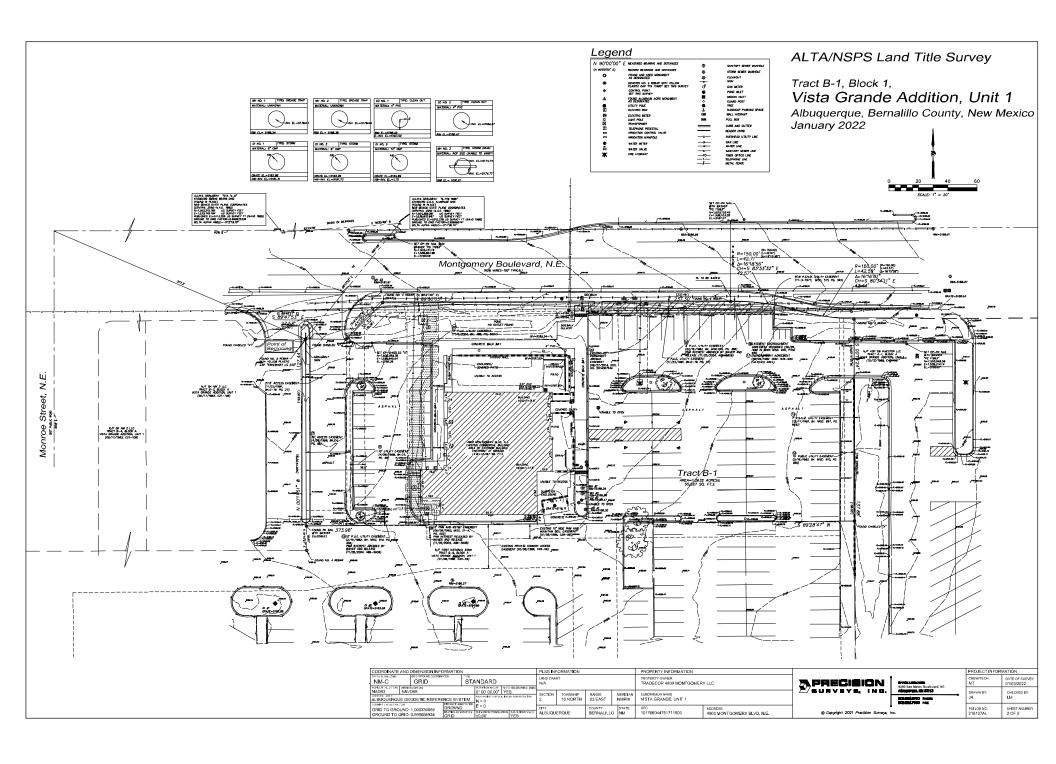
VISTA GRANDE SHOPPING CENTER

PROJECT DESCRIPTION

ALL EXISTING IMPROVEMENTS ONSITE, INCLUDING ROCK & BREWS BUILDING, ASPHALT DRIVE AISLES AND PARKING STALLS, CURBING, AND UTILITIES SERVING THE EXISTING BUILDING WILL BE DEMOLISHED. A NEW BUILDING WITH ASSOCIATED ASPHALT DRIVE AISLES AND PARKING STALLS, CURBING, AND UTILITY SERVICES WILL BE CONSTRUCTED IN ACCORDANCE WITH THE INTEGRATED DEVELOPMENT ORDINANCE (IDO) RULES AND REGULATIONS, AS DETAILED IN THIS EPC MAJOR AMENDMENT SUBMITTAL.

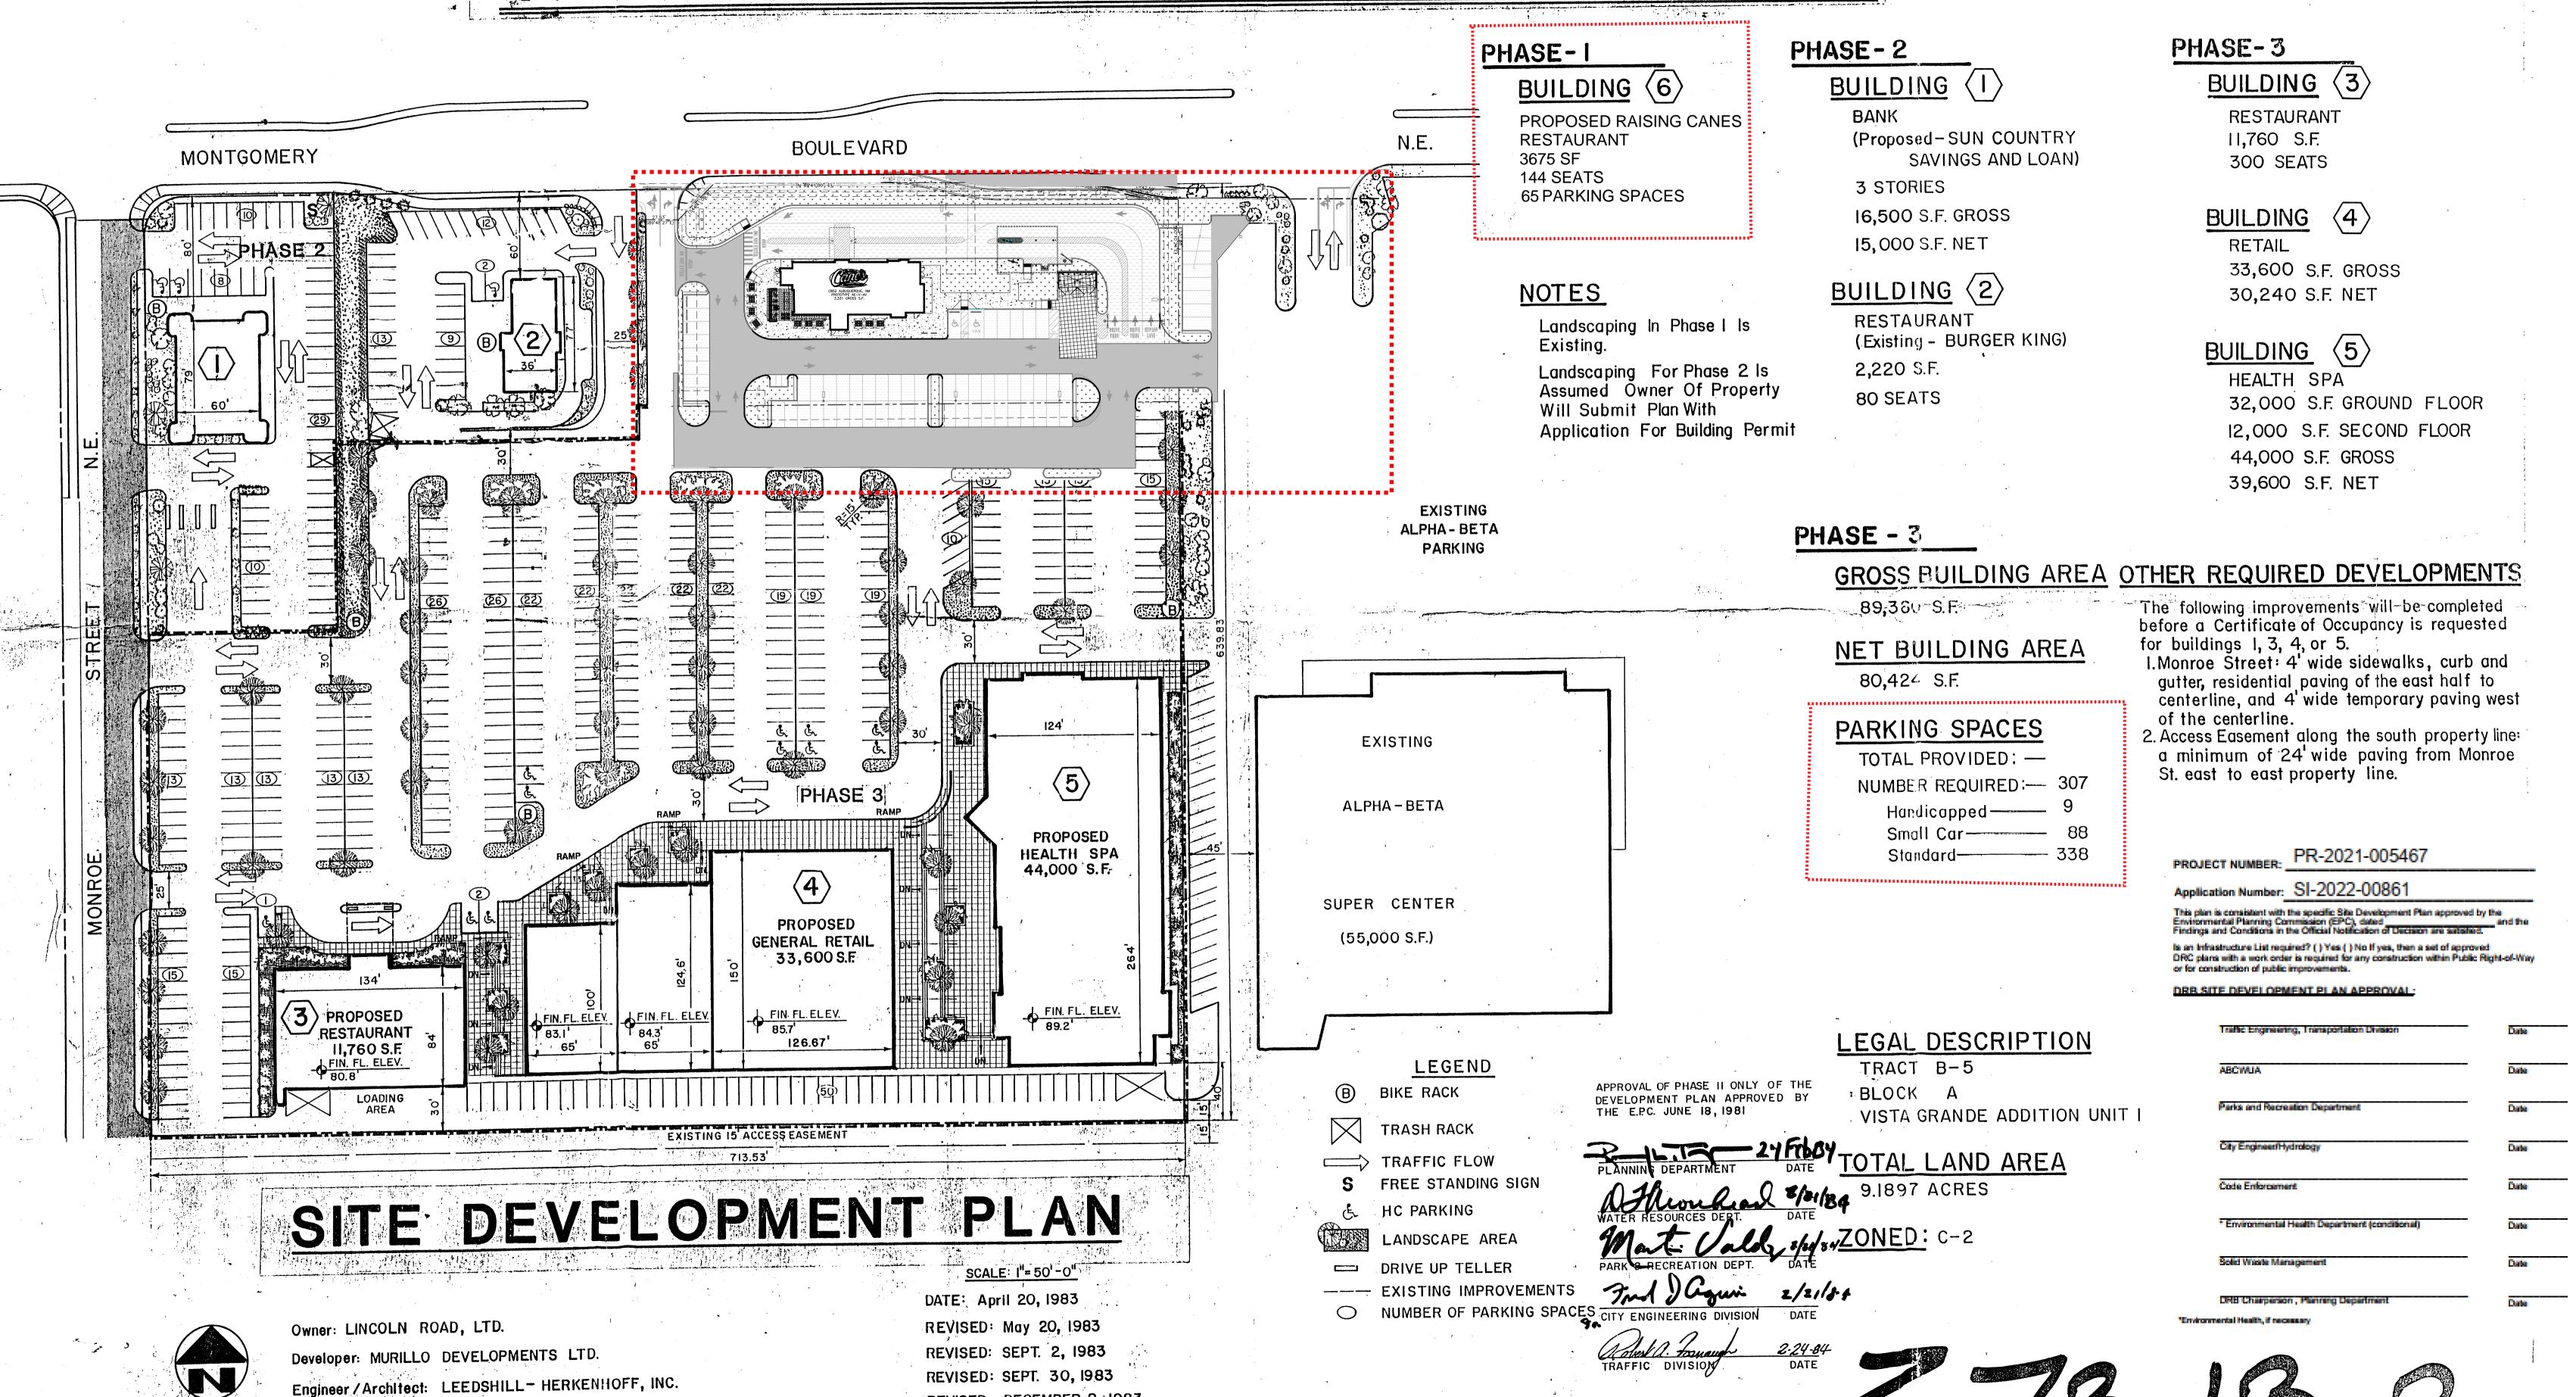

REVISED: DECEMBER 2, 1983

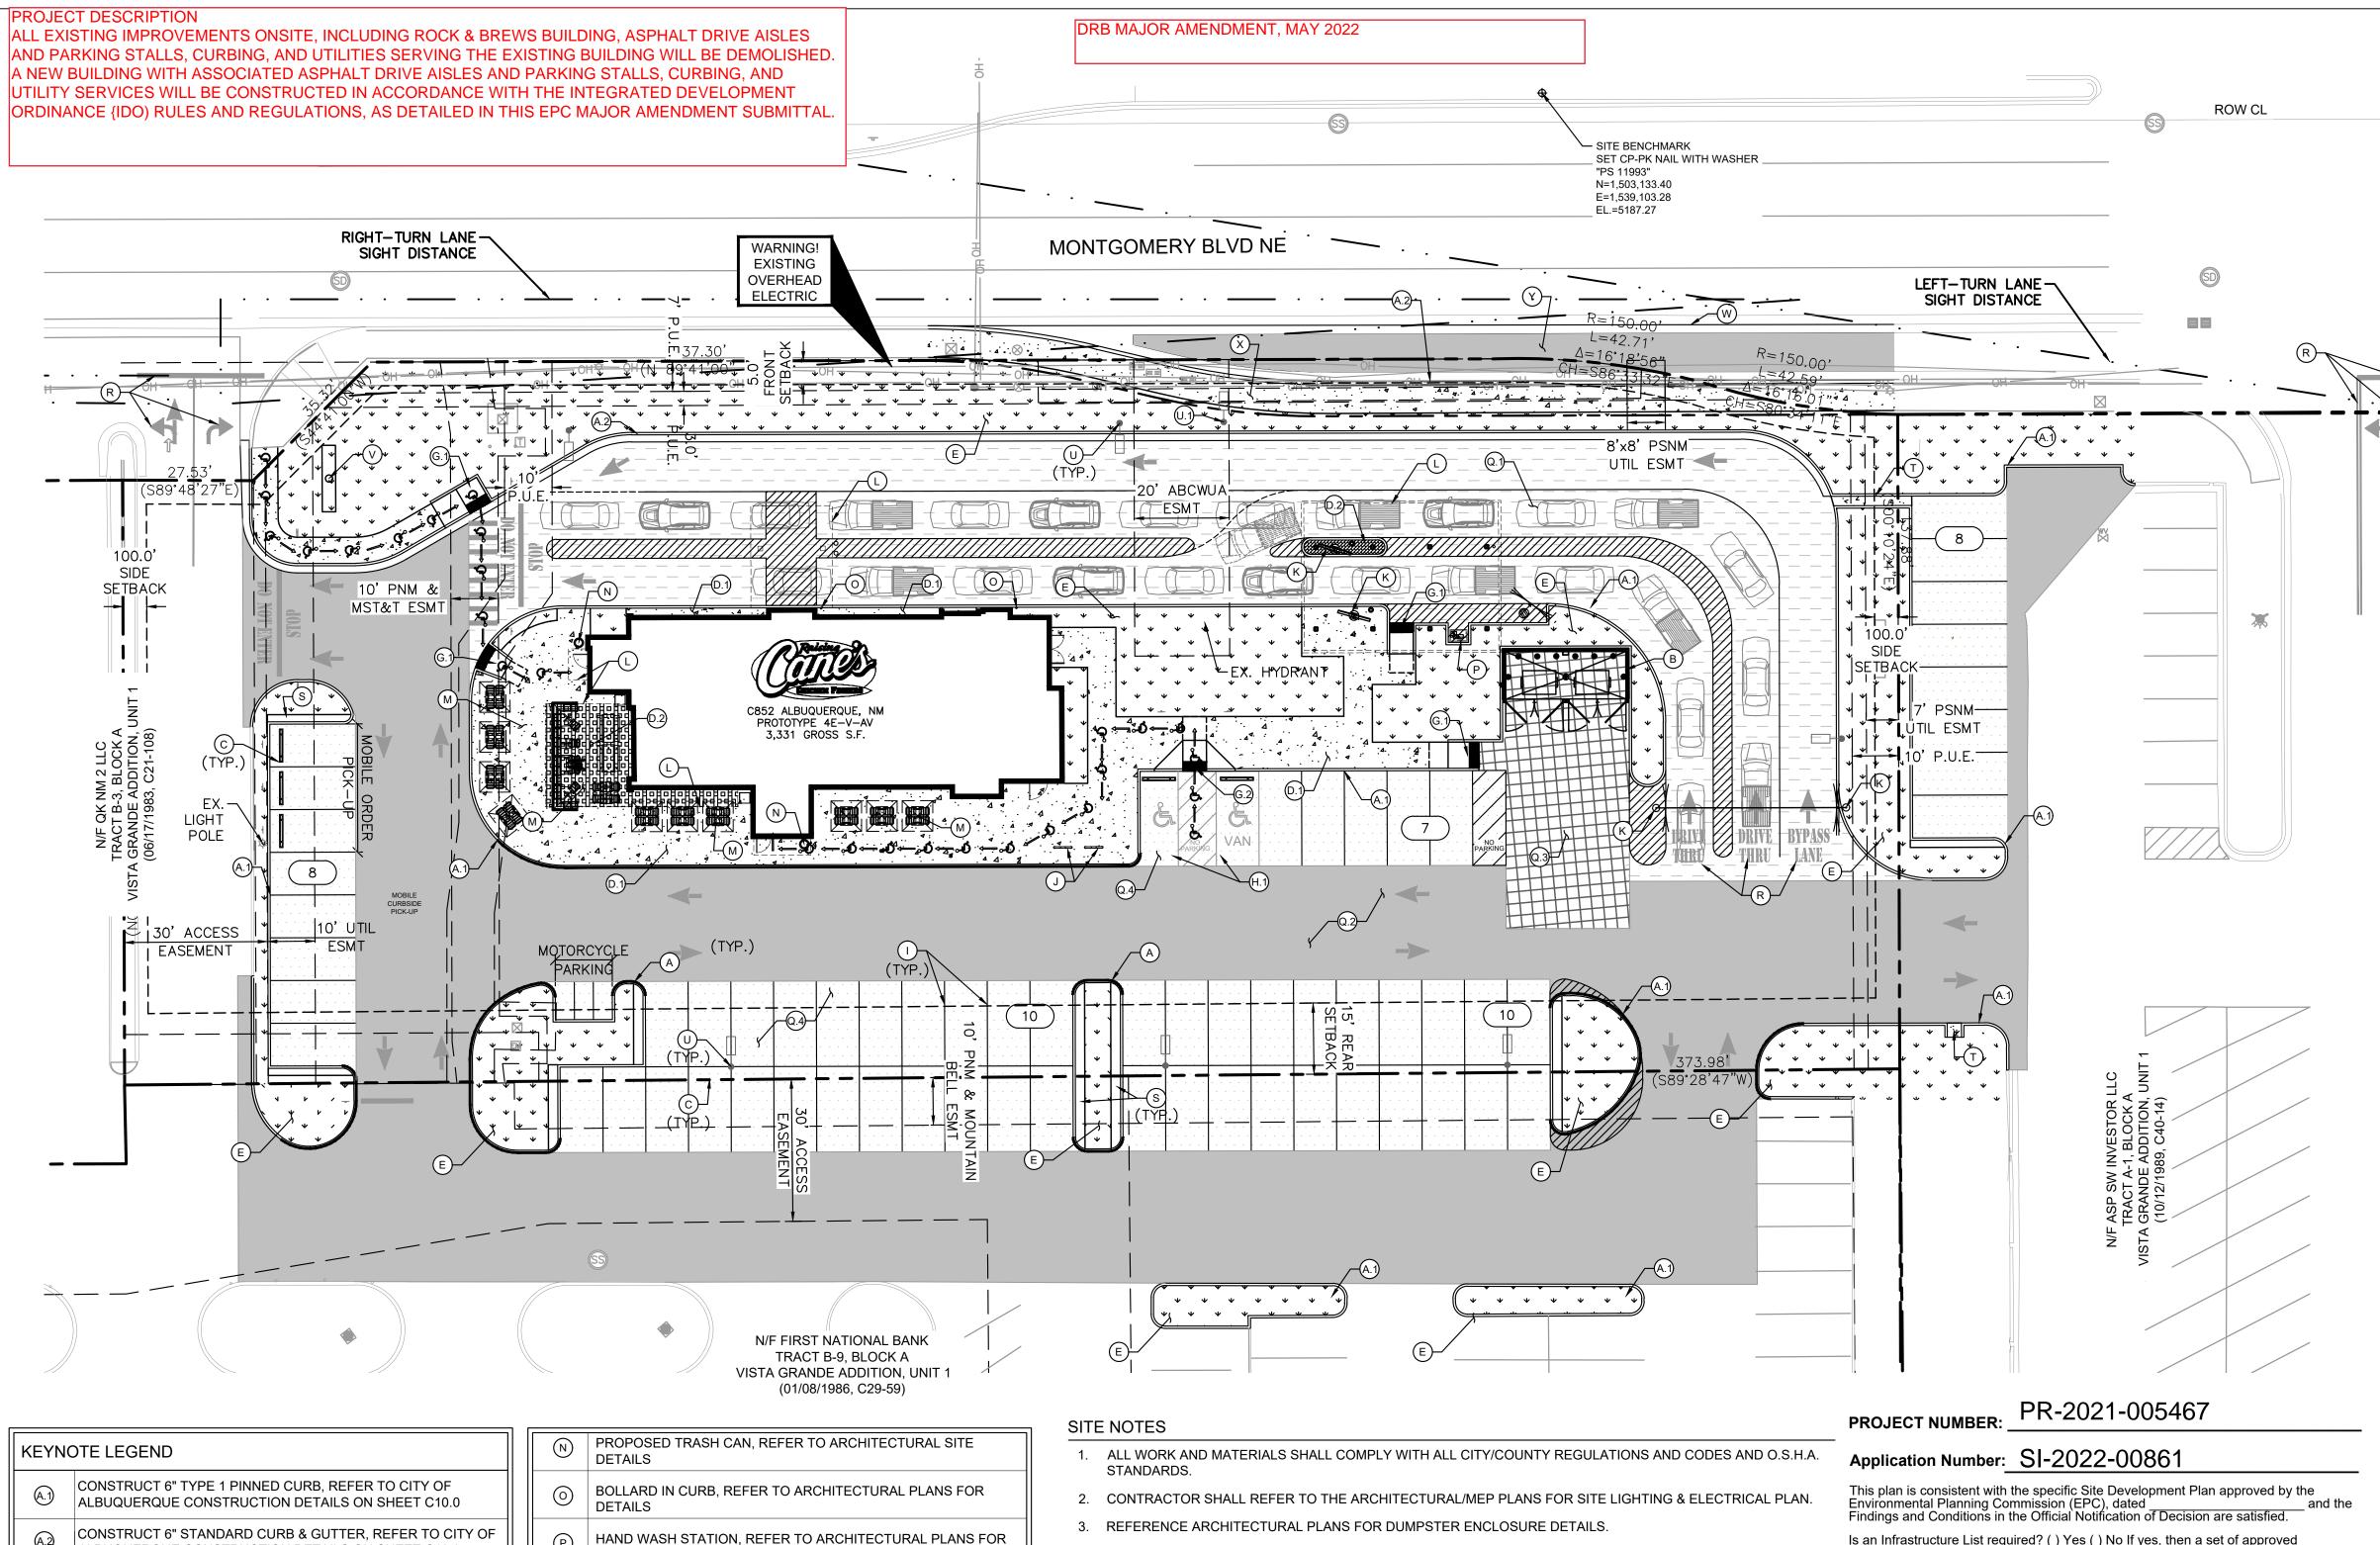

(EYN(OTE LEGEND		DETAILS
(A.1)	CONSTRUCT 6" TYPE 1 PINNED CURB, REFER TO CITY OF ALBUQUERQUE CONSTRUCTION DETAILS ON SHEET C10.0	0	BOLLARD IN CURB, REFER TO ARCHITECTURAL PLANS FOR DETAILS
(A.2)	CONSTRUCT 6" STANDARD CURB & GUTTER, REFER TO CITY OF ALBUQUERQUE CONSTRUCTION DETAILS ON SHEET C10.0	P	HAND WASH STATION, REFER TO ARCHITECTURAL PLANS FOR DETAIL
B	RECYCLING/TRASH DUMPSTER LOCATION. REFER TO ARCHITECTURAL PLANS FOR DETAILS OF SCREENING, GATES, BOLLARDS AND MASONRY	Q.1)	INTEGRAL COLORED 860 GRAPHITE (IRON OXIDE) STANDARD DUTY CONCRETE PAVEMENT, SEE DETAIL ON SHEET C9.0
©	WHEEL STOPS, SEE DETAIL ON SHEET C9.0	Q.2	MEDIUM DUTY ASPHALT PAVEMENT, SEE DETAIL ON SHEET C9.0
(D.1)	PRIVATE CONCRETE SIDEWALK, SEE DETAIL ON SHEET C9.0	@.3	HEAVY DUTY CONCRETE PAVEMENT, SEE DETAIL ON SHEET C9.0
(D.2)	COVERED PATIO INTEGRAL COLOR SMOKESTACK 102 - 5LB	Q.4)	LIGHT DUTY ASPHALT PAVEMENT, SEE DETAIL ON SHEET C9.0
D .3	PAVERS IN MENU ISLAND: BELGARD HOLLAND STONE, LEGACY PAVERS IN HERRINGBONE/BASKETWEAVE PATTERN	R	DIRECTIONAL PAVEMENT MARKING, REFER TO SHEET C5.2
	CHARCOAL OR SIMILAR GRAY COLOR SEE LANDSCAPE FOR INSTALLATION DETAIL	S	CONCRETE SIDEWALK, 2.5' WIDTH ADJACENT TO PARKING SPACES
E	LANDSCAPE AREA, REFER TO LANDSCAPE PLANS	T	CONCRETE FLUME
G.1	BARRIER FREE RAMP, SEE DETAIL ON SHEET C9.0	U	PROPOSED SITE LIGHTING, REFER TO ELECTRICAL PLANS FOR DETAIL
G.2	SIDEWALK RAMP AND DETECTABLE WARNING SYSTEM PER CITY OF ALBUQUERQUE STANDARD DWG 2442 (DETAIL A)	(J.1)	RELOCATED STREET LIGHTING
(H.1)	ACCESSIBLE PARKING STALL	V	RAISING CANE'S PYLON SIGN TO BE DESIGNED BY OTHERS
	PAVEMENT STRIPING, REFER TO SHEET C5.2	W	EXTEND EXISTING VALLEY GUTTER PER CITY OF ALBUQUERQUE
J	BICYCLE RACK PARKING RACK, REFER TO ARCHITECTURAL PLANS FOR DETAILS		STANDARD DWG 2420
		\otimes	PUBLIC CONCRETE CURB TYPE SIDEWALK PER CITY OF ALBUQUERQUE STANDARD DWG 2430
K	DRIVE THRU ORDER BOARD, PRE-ORDER BOARD OR HEIGHT DETECTOR, REFER TO ARCHITECTURAL PLANS FOR DETAILS	Y	ASPHALT PAVEMENT PER CITY OF ALBUQUERQUE STANDARD
L	CANOPY, REFER TO ARCHITECTURAL PLANS FOR DETAILS		DWG 2405B

PROPOSED PATIO, REFER TO ARCHITECTURAL PLANS FOR

SEATING AND SPACING LAYOUT

- 4. EXISTING STRUCTURES AND OR UTILITIES WITHIN CONSTRUCTION LIMITS ARE TO BE ABANDONED, REMOVED OR RELOCATED AS NECESSARY.
- 5. SITE BOUNDARY, TOPOGRAPHY, UTILITY AND ROAD INFORMATION TAKEN FROM A SURVEY BY PRECISION SURVEYS, INC. DATED FEBRUARY 2021.
- 6. ALL PROPOSED PAVING IN CITY R.O.W. AND EASEMENTS TO CONFORM TO CITY OF ALBUQUERQUE
- 7. PER FEMA MAP NUMBER 35001C0139G DATED SEPTEMBER 26, 2008, THIS SITE IS NOT WITHIN A FLOODPLAIN,
- BUT IS ADJACENT TO FLOOD ZONE AO 8. BUILDING IS FIRE SPRINKLED.
- 9. CITY OF ALBUQUERQUE SOLID WASTE DEPARTMENT IS NOT TO BE HELD LIABLE FOR ANY DAMAGE TO THE ASPHALT PAVEMENT.

COORDINATE AND DIMENSION INFORMATION STATE PLANE ZONE: GRID/GROUND COORDINATES: GRID STANDARD HORIZONTAL DATUM: NAD83 VERTICAL DATUM: NAVD88 **ROTATION ANGLE:** 0°00'00.00" MATCHES DRAWING UNITS: CONTROL USED: ALBUQUERQUE GEODETIC REFERENCE SYSTEM COMBINED SCALE FACTOR:

DISTANCE ANNOTATION: BEARING ANNOTATION: BASE POINT FOR SCALING AND/OR ROTATION: **ELEVATION TRANSLATION:** ELEVATIONS VALID:

GRID TO GROUND: 1.000348716 GROUND TO GRID: 0.999651406 GROUND GRID E=0 ±0.00' YES

PROJECT NAME

RAISING CANES

MONTGOMERY BLVD.

PROJECT NUMBER PROJECT LIMITS 642183

2/16/18

SUBMITTAL NUMBER MONTGOMERY BLVD. PR-2021-005467

Is an Infrastructure List required? () Yes () No If yes, then a set of approved DRC plans with a work order is required for any construction within Public Right-of-Way or for construction of public improvements.

DRB SITE DEVELOPMENT PLAN APPROVAL:

Traffic Engineering, Transportation Division	Date
ABCWUA	Date
Parks and Recreation Department	Date
City Engineer/Hydrology	Date
Code Enforcement	Date
* Environmental Health Department (conditional)	Date
Solid Waste Management	Date
DRB Chairperson , Planning Department	Date
rironmental Health, if necessary	

Know what's below. Call before you dig

LEGEND

PROPERTY LINE

EASEMENT/SETBACK

PROPOSED SAWCUT

EXISTING CURB

D CONCRETE SIDEWALK

ADJACENT PROPERTY LINE

PROPOSED CONCRETE CURB

PROPOSED PARKING COUNT

PROPOSED LANDSCAPE AREA

COVERED PATIO INTEGRAL COLOR SMOKESTACK 102 - 5LB

SEE DETAIL SHEET C9.0

(3) HEAVY DUTY CONCRETE PAVEMENT

DO NOT PAINT)

EXISTING ZONING

PROPOSED USE

BUILDING AREA

FINISHED FLOOR

IMPERVIOUS AREA

LOT COVERAGE

TOTAL PARKING

OUTDOOR SPACE.

ACCESSIBLE

MOTORCYCLE

LOT AREA

ELEVATION

PARKING / SITE DATA PER IDO

TRACT B-1

VISTA GRANDE SUBDIVISION

PARKING REQUIRED FOR DRIVE-THRU

RESTAURANT IS 8 SPACES / 1,000 SF

INDOOR AND 3 SPACES /1,000 SF OF

(a) LIGHT DUTY ASPHALT PAVEMENT

(a.2) MEDIUM DUTY ASPHALT PAVEMENT

STANDARD DUTY CONCRETE PAVEMENT

PAVERS AT CENTER MENU ISLAND UNDER CANOPY BELGARD HOLLAND STONE, LEGACY PAVERS IN

INTEGRAL COLORED 860 GRAPHITE (IRON OXIDE)

ACCESSIBLE ROUTE (LOCATION PURPOSES ONLY,

MIXED USE (MX-M)

RESTAURANT W/

55,027 SF / 1.26 AC

DRIVE-THRU

3,331 SF

5,187.71 FT

44,679 SF

81.2%

REQUIRED PROVIDED

34 SPACES 35 SPACES

2 SPACES | 2 SPACES

2 SPACES | 3 SPACES

3 SPACES 5 SPACES

HERRINGBONE/BASKETWEAVE PATTERN CHARCOAL OR SIMILAR GRAY COLOR



└─ SITE

VICINITY MAP (NOT TO SCALE)

> **Montgomery & San Mateo** ALBUQUERQUE, NM 87112 Restaurant #RC852 P4E-V-AV SCHEME A

Engineer's Information:

© 2022 KIMLEY-HORN

AND ASSOCIATES, INC. 13455 Noel Road Two Galleria Office Tower Suite 700 Dallas, TX 75240 CONTACT: LAUREN NUFFER, P.E

(972) 770-1300 LAUREN.NUFFER@KIMLEY-HORN.COM LIZ WILLMOT, P.E. LIZ.WILLMOT@KIMLEY-HORN.COM

Professional of Record:



Prototype:	P4E-V-AV 2021-	2.0 RELEASE
Prototype Issue	Date:	10.04.2021
Kitchen Issue Date:		08.02.2021
Design Bulletin Updates:		
Date Issued:	Bulletin Number:	

2ND BLDG. RESUBMITTAL


RE	EVISIONS:	
	11/12/2021	80% REVIEW SET
	11/30/2021	1ST BLDG SUBMITTAL
1	12/20/2021	1ST BLDG RESUBMITTAL
2	01/17/2022	2ND BLDG RESUBMITTAL
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SITE KEYNOTE PLAN

05.12.2022 Project Number: 090042000 Drawn By: LW/LN

Sheet Number:

CAUTION!! CONTRACTOR IS TO VERIFY PRESENCE AND EXACT LOCATION OF ALL UTILITIES PRIOR TO CONSTRUCTION.

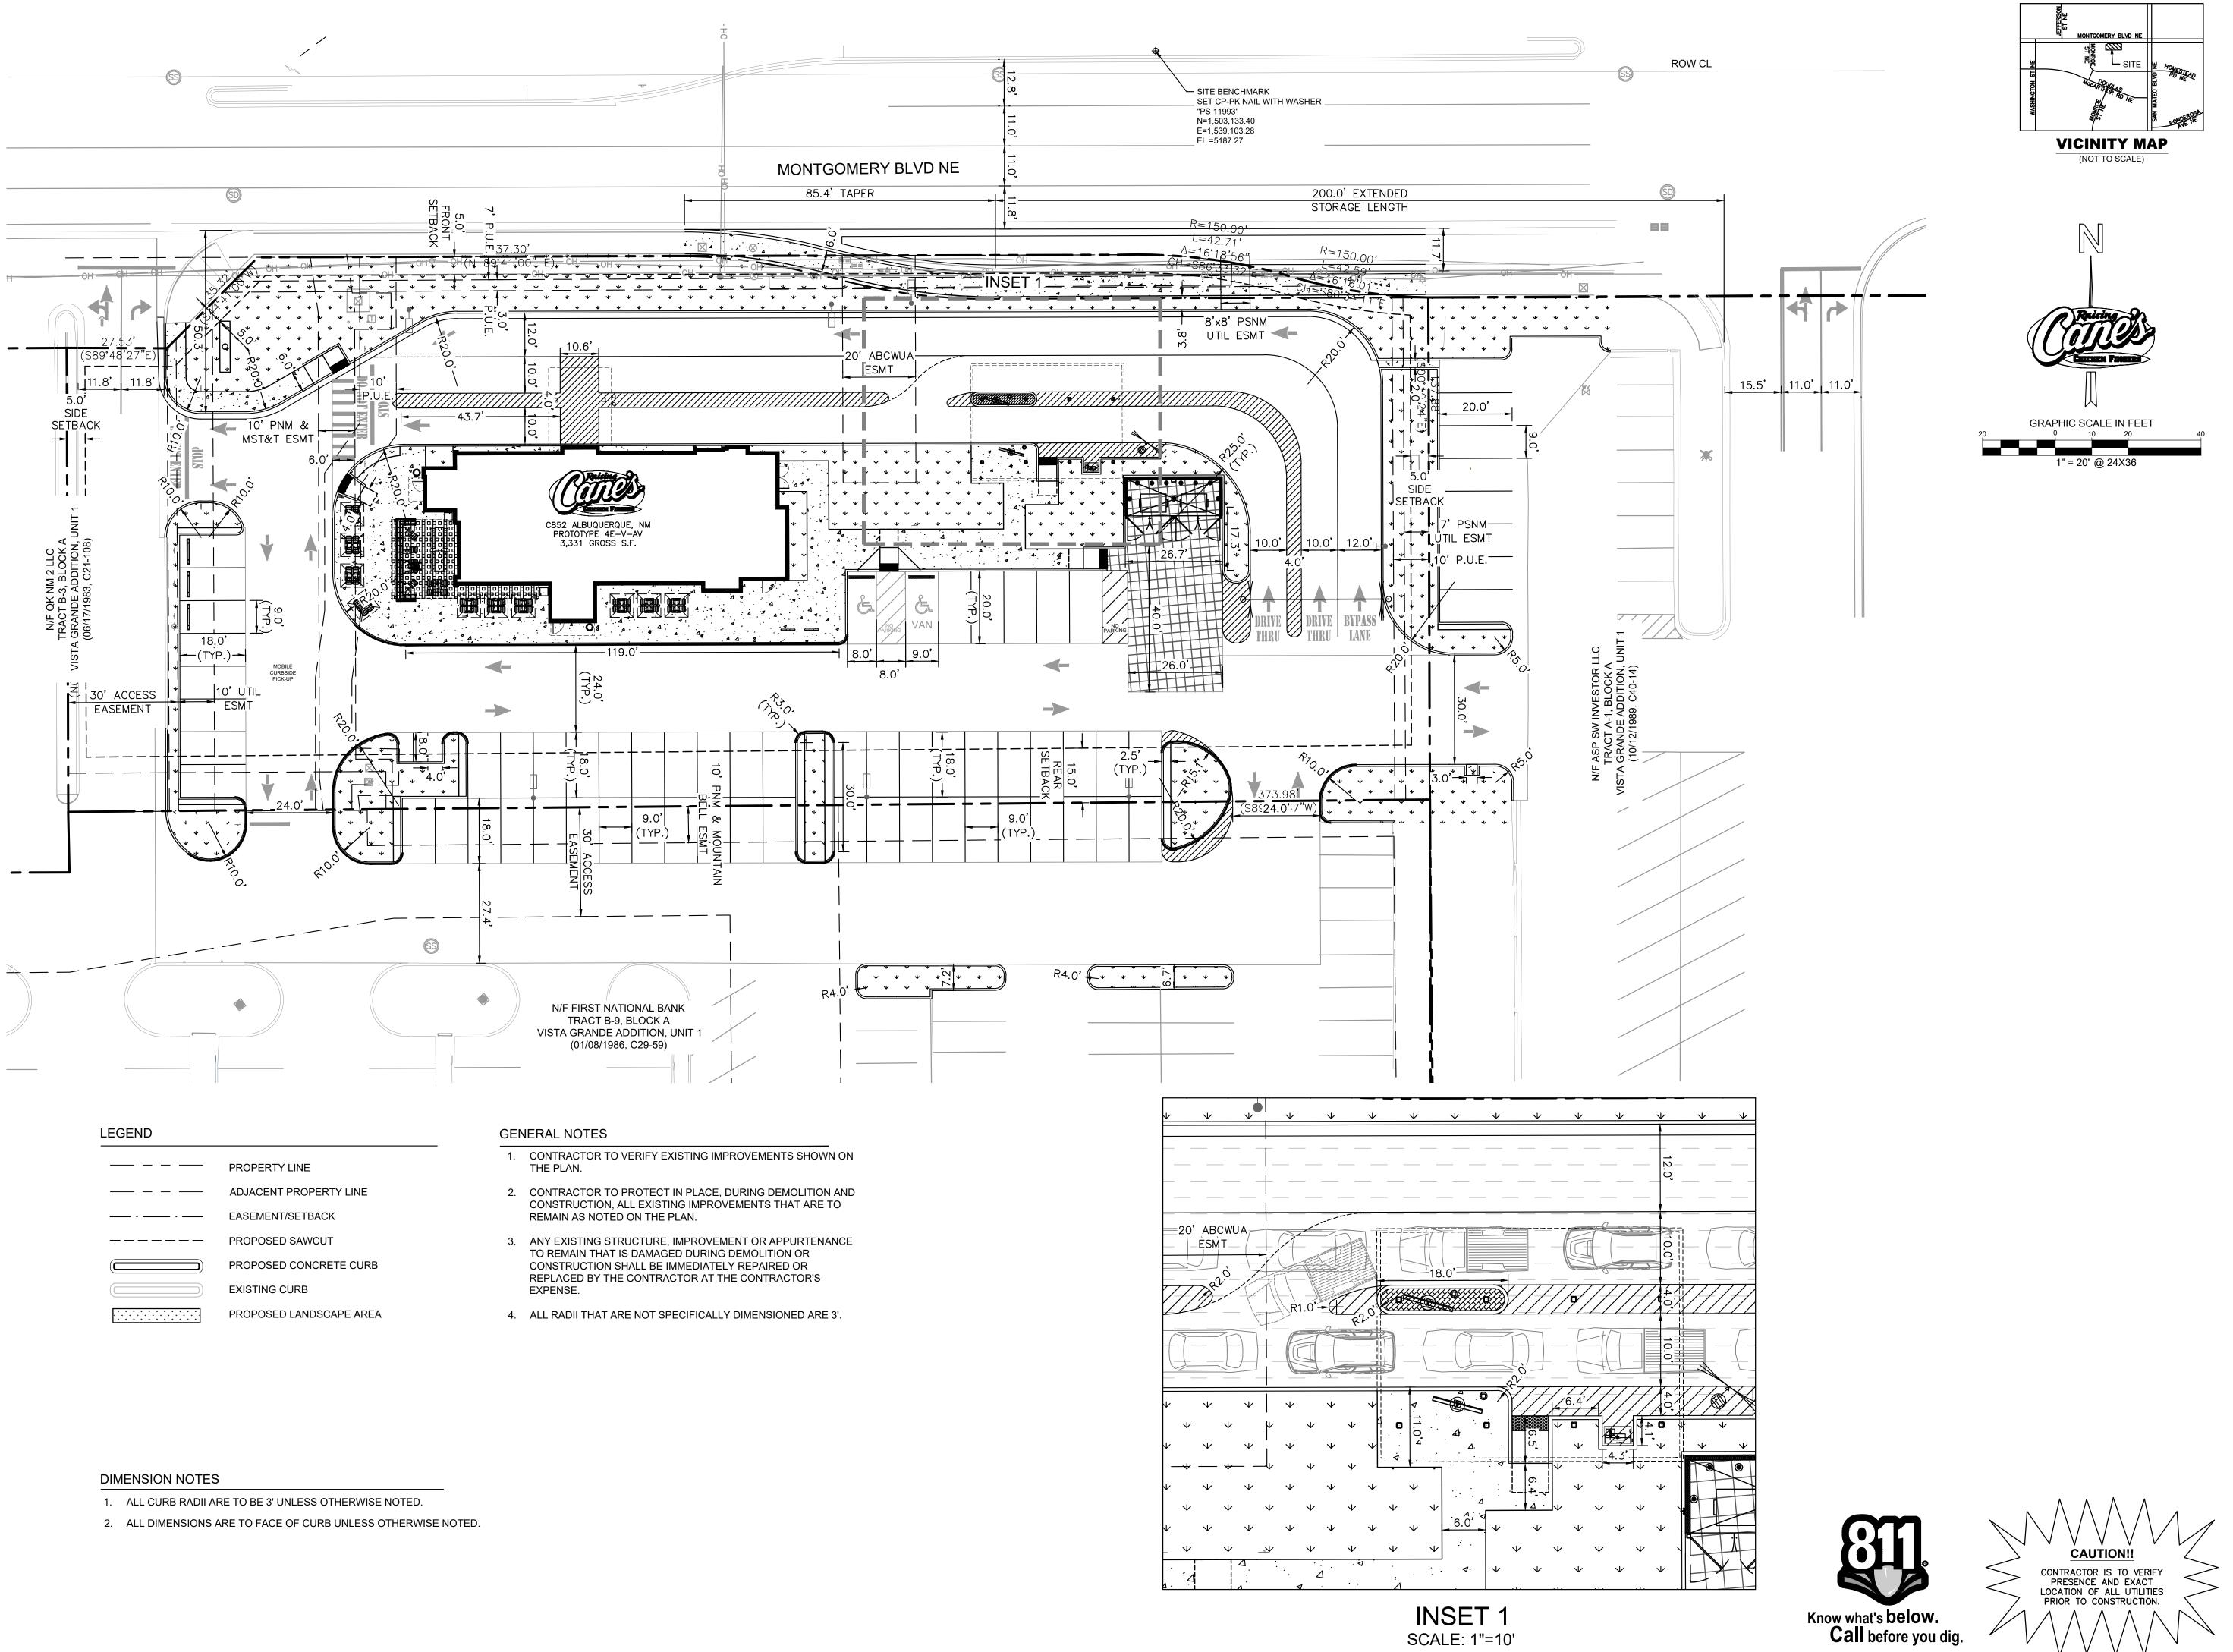

SCALE: 1"=10'

Montgomery & San Mateo **ALBUQUERQUE, NM 87112** Restaurant #RC852 P4E-V-AV SCHEME A

© 2022 KIMLEY—HORN AND ASSOCIATES, INC. 13455 Noel Road Two Galleria Office Tower Suite 700 Dallas, TX 75240 CONTACT: LAUREN NUFFER, P.E (972) 770-1300 LAUREN.NUFFER@KIMLEY-HORN.COM LIZ WILLMOT, P.E. LIZ.WILLMOT@KIMLEY-HORN.COM

Professional of Record:

Engineer's Information:



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Design Bulletin	Updates:	
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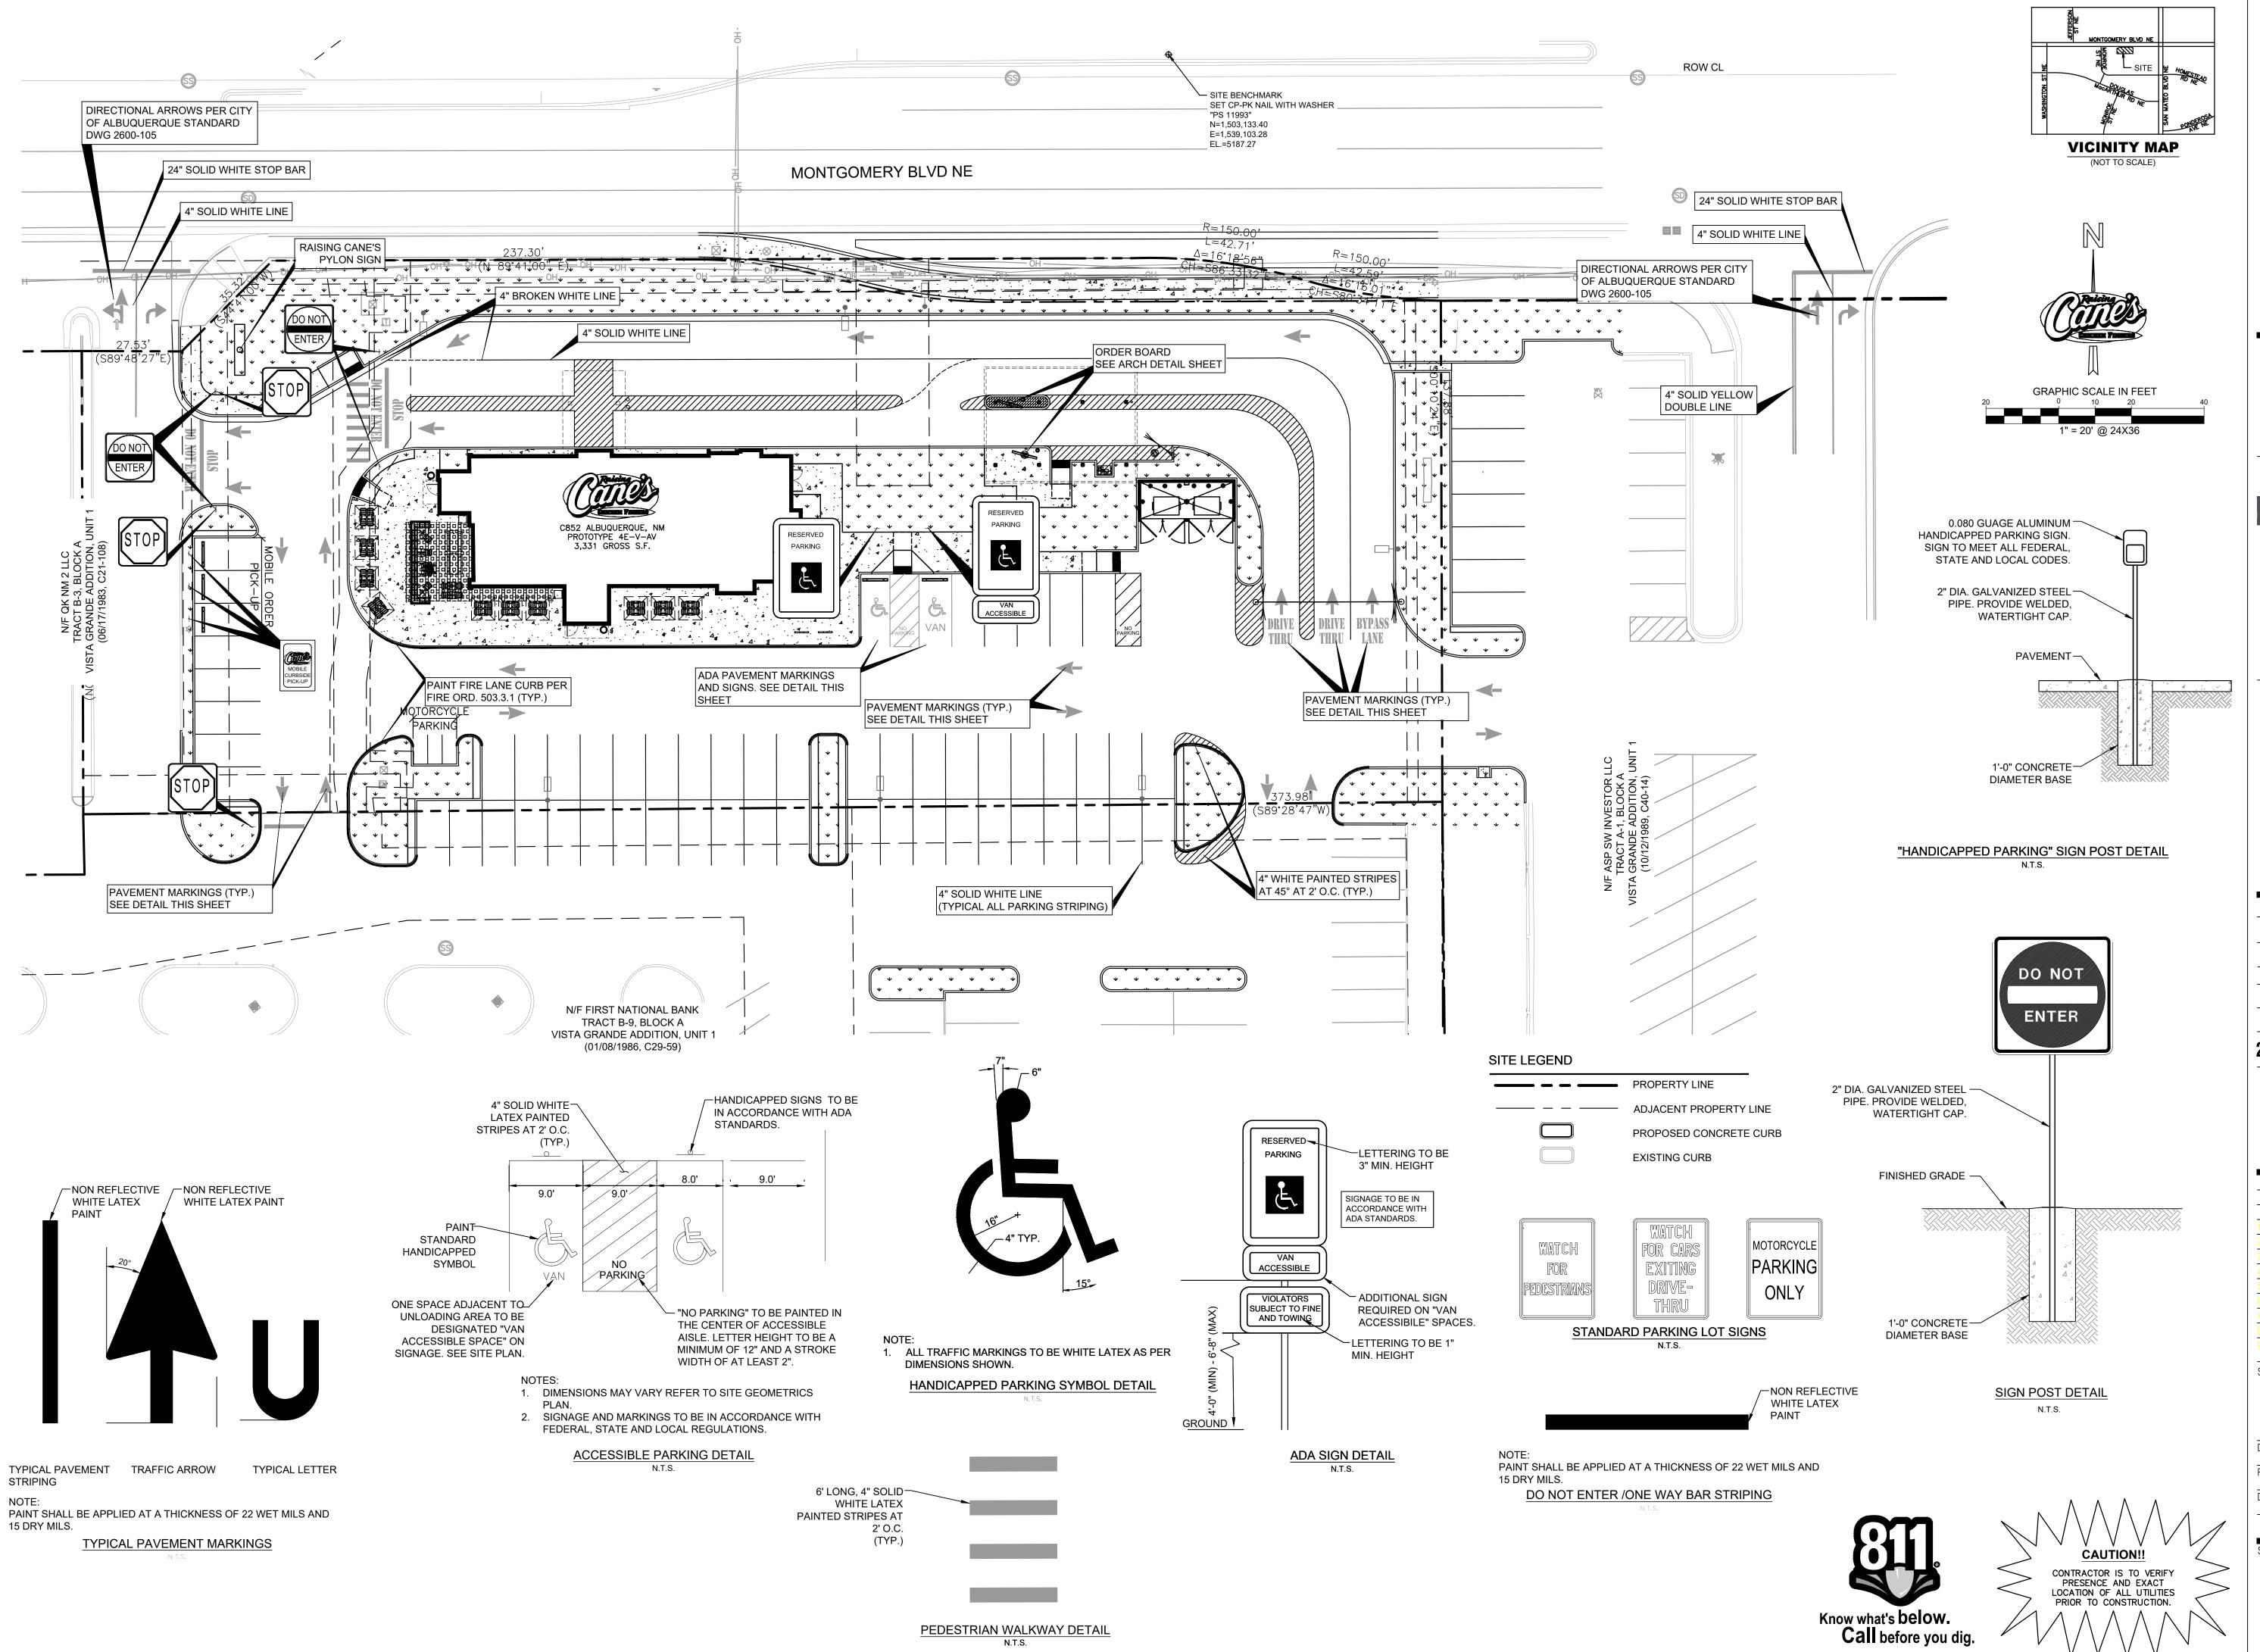
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Sheet Title:

DIMENSION **CONTROL PLAN**

Date:	05.12.2022
Project Number:	090042000
Drawn By:	LW/LN





Montgomery & San Mateo
ALBUQUERQUE, NM 87112
Restaurant #RC852
P4E-V-AV SCHEME A

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Professional of Record:

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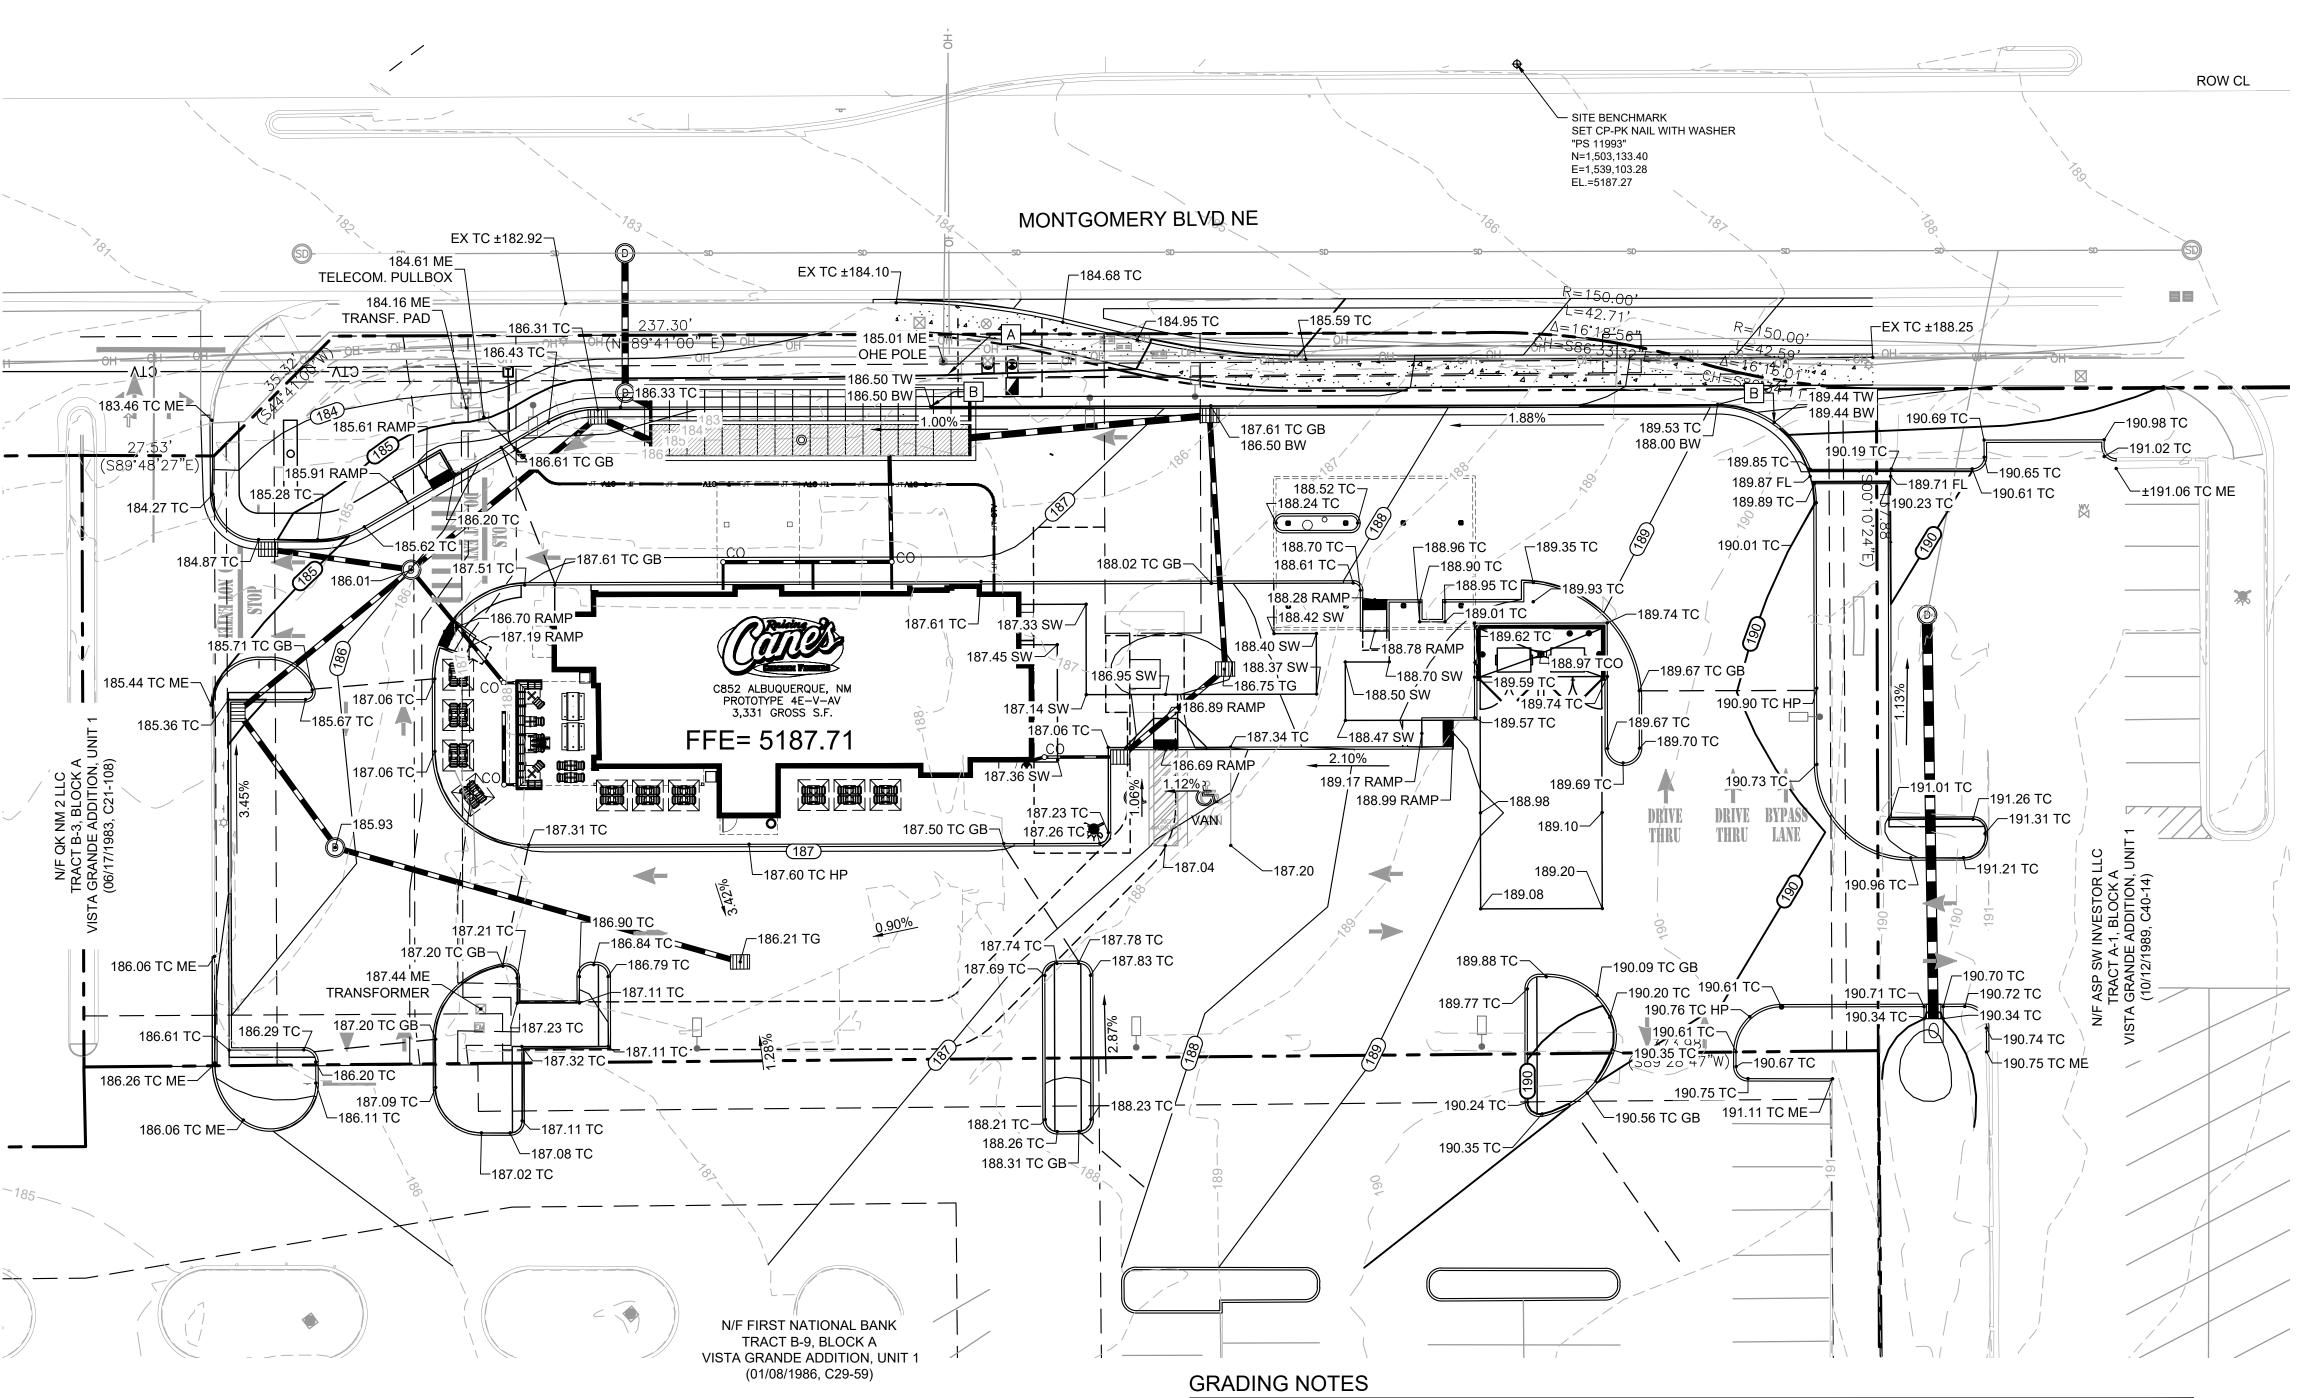
Sheet Title:

STRIPING AND SIGNAGE PLAN

Date:	05.12.2022
Project Number:	090042000
Drawn By:	LW/LN

Sheet Number:

C5.2



1. ADD 5000' TO ALL SPOT ELEVATIONS & CONTOUR LABELS.

DOCUMENTS APPROVED BY ALL OF THE PERMITTING AUTHORITIES.

2. ALL CONSTRUCTION TO BE IN ACCORDANCE WITH THESE PLANS AND THE CITY/AHJ STANDARDS AND SPECIFICATIONS.

OF ENGINEER. PAVING INSTALLED SHALL "FLUSH OUT" AT ANY JUNCTURE WITH EXISTING PAVING.

UTILITIES WHICH CONFLICT WITH THE PROPOSED IMPROVEMENTS SHOWN ON THE PLANS.

6. ALL CUT OR FILL SLOPES SHALL BE 4:1 OR FLATTER UNLESS OTHERWISE NOTED.

BY A REGISTERED LAND SURVEYOR TO THE OWNER FOR REVIEW.

ANY DISCREPANCIES.

3. PRIOR TO STARTING CONSTRUCTION, THE CONTRACTOR SHALL MAKE CERTAIN THAT ALL REQUIRED PERMITS AND APPROVALS HAVE BEEN OBTAINED.

NO CONSTRUCTION OR FABRICATION SHALL BEGIN UNTIL THE CONTRACTOR HAS RECEIVED AND THOROUGHLY REVIEWED ALL PLANS AND OTHER

INCLUDING GRADES AND DIMENSIONS BEFORE COMMENCEMENT OF ANY CONSTRUCTION. THE ENGINEER SHALL BE NOTIFIED IMMEDIATELY OF ANY DISCREPANCIES. MINOR ADJUSTMENTS TO FINISH GRADE TO ACCOMPLISH SPOT DRAINAGE ARE ACCEPTABLE, IF NECESSARY, UPON PRIOR APPROVAL

5. THE CONTRACTOR IS SPECIFICALLY CAUTIONED THAT THE LOCATION AND/OR ELEVATION OF EXISTING UTILITIES AS SHOWN ON THESE PLANS IS BASED ON RECORDS OF THE VARIOUS UTILITY COMPANIES, AND WHERE POSSIBLE, MEASUREMENTS TAKEN IN THE FIELD. THE INFORMATION IS NOT TO BE RELIED ON AS BEING EXACT OR COMPLETE. THE CONTRACTOR MUST CALL THE APPROPRIATE UTILITY COMPANIES AT LEAST 72 HOURS BEFORE ANY EXCAVATION TO REQUEST EXACT FIELD LOCATION OF UTILITIES. IT SHALL BE THE RESPONSIBILITY OF THE CONTRACTOR TO RELOCATE ALL EXISTING

4. THE GENERAL CONTRACTOR AND ALL SUB-CONTRACTORS SHALL VERIFY THE SUITABILITY OF ALL EXISTING AND PROPOSED SITE CONDITIONS

7. CONTRACTOR SHALL ADJUST AND/OR CUT EXISTING PAVEMENT AS NECESSARY TO ASSURE A SMOOTH FIT AND CONTINUOUS GRADE.

11. CONTRACTOR SHALL REFER TO FINAL GEOTECH REPORT FOR BUILDING SUBGRADE AND SITE PREPARATION REQUIREMENTS.

9. TOPOGRAPHIC INFORMATION IS TAKEN FROM A TOPOGRAPHIC SURVEY BY LAND SURVEYORS. IF THE CONTRACTOR DOES NOT ACCEPT EXISTING

13. ALL ELEVATIONS ARE TOP OF PAVEMENT UNLESS NOTED OTHERWISE. TO GET TOP OF CURB ELEVATIONS ADD 6" TO THE ELEVATION SHOWN.

16. REFER TO EROSION CONTROL PLAN FOR EROSION CONTROL DEVICES TO BE INSTALLED PRIOR TO COMMENCING GRADING OPERATIONS.

17. ALL FILL TO BE PLACED SHALL BE IN ACCORDANCE WITH THE CURRENT APPLICABLE GEOTECHNICAL REPORT RECOMMENDATIONS.

14. GRADING FOR ALL SIDEWALKS AND ACCESSIBLE ROUTES INCLUDING CROSSING DRIVEWAYS SHALL CONFORM TO ADA STANDARDS. SLOPES SHALL NOT EXCEED 5% LONGITUDINAL SLOPE OR 2% CROSS SLOPE. SIDEWALK ACCESS TO EXTERNAL BUILDING DOORS SHALL BE ADA COMPLIANT.

15. ANY PROPOSED CONTOURS SHOWN ARE APPROXIMATE. PROPOSED SPOT ELEVATIONS AND DESIGNATED GRADIENT ARE TO BE USED IN THE EVENT OF


TOPOGRAPHY AS SHOWN ON THE PLANS, WITHOUT EXCEPTION, THEN THE CONTRACTOR SHALL SUPPLY, AT THEIR EXPENSE, A TOPOGRAPHIC SURVEY


8. CONTRACTOR SHALL ASSURE POSITIVE DRAINAGE AWAY FROM BUILDINGS FOR ALL NATURAL AND PAVED AREAS.

12. CONTRACTOR SHALL ADJUST EXISTING VALVES, MANHOLE RIMS, ETC. AS NECESSARY TO MATCH FINISHED GRADE.

CONTRACTOR SHALL NOTIFY ENGINEER IMMEDIATELY IF ADA CRITERIA CANNOT BE MET AT ANY LOCATION.

10. CONTRACTOR SHALL REFER TO ARCHITECTURAL PLANS FOR EXACT BUILDING FOOTPRINT DIMENSIONS.

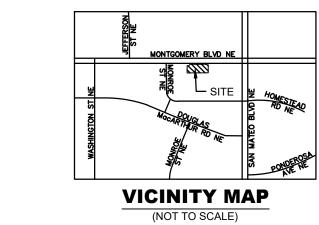

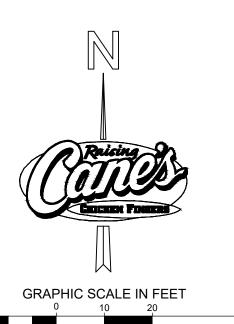

1" = 20' @ 24X36

LEGEND

PROPOSED PROPERTY LINE ADJACENT PROPERTY LINE **EXISTING CONTOUR**

PROPOSED FLOW ARROW WITH SLOPE

PROPOSED CONTOUR

PROPOSED SPOT ELEVATION EXISTING STORM INLET

GRADE BREAK HIGH POINT

TOP OF PAVEMENT

MATCH EXISTING ELEVATION

TOP OF SIDEWALK

TOP OF GRATE FLOW LINE

TOP OF CLEANOUT TOP OF WALL

BOTTOM OF WALL — — — PROPOSED RIDGE

- CONSTRUCT CUT-OFF WALL IN PLACE OF CURB PER CITY OF ALBUQUERQUE STANDARD
- DWG 2415C. TOP OF WALL = TOP OF CURB, ELEVATION PER DRAWING BOTTOM OF WALL = BOTTOM OF EXPOSED WALL, BURY WALL A MINIMUM OF 18" BELOW FINISHED GRADE. MIN HEIGHT = 0", MAX HEIGHT = 18"

GRADING CONSTRUCTION NOTES

3:1 CUT SLOPE BETWEEN EDGE OF EXISTING OVERHEAD ELECTRIC POLE AND TOP OF PROPOSED CURB, REFERENCE GRADING NOTE 5 THIS SHEET







Montgomery & San Mateo ALBUQUERQUE, NM 87112 Restaurant #RC852 P4E-V-AV SCHEME A

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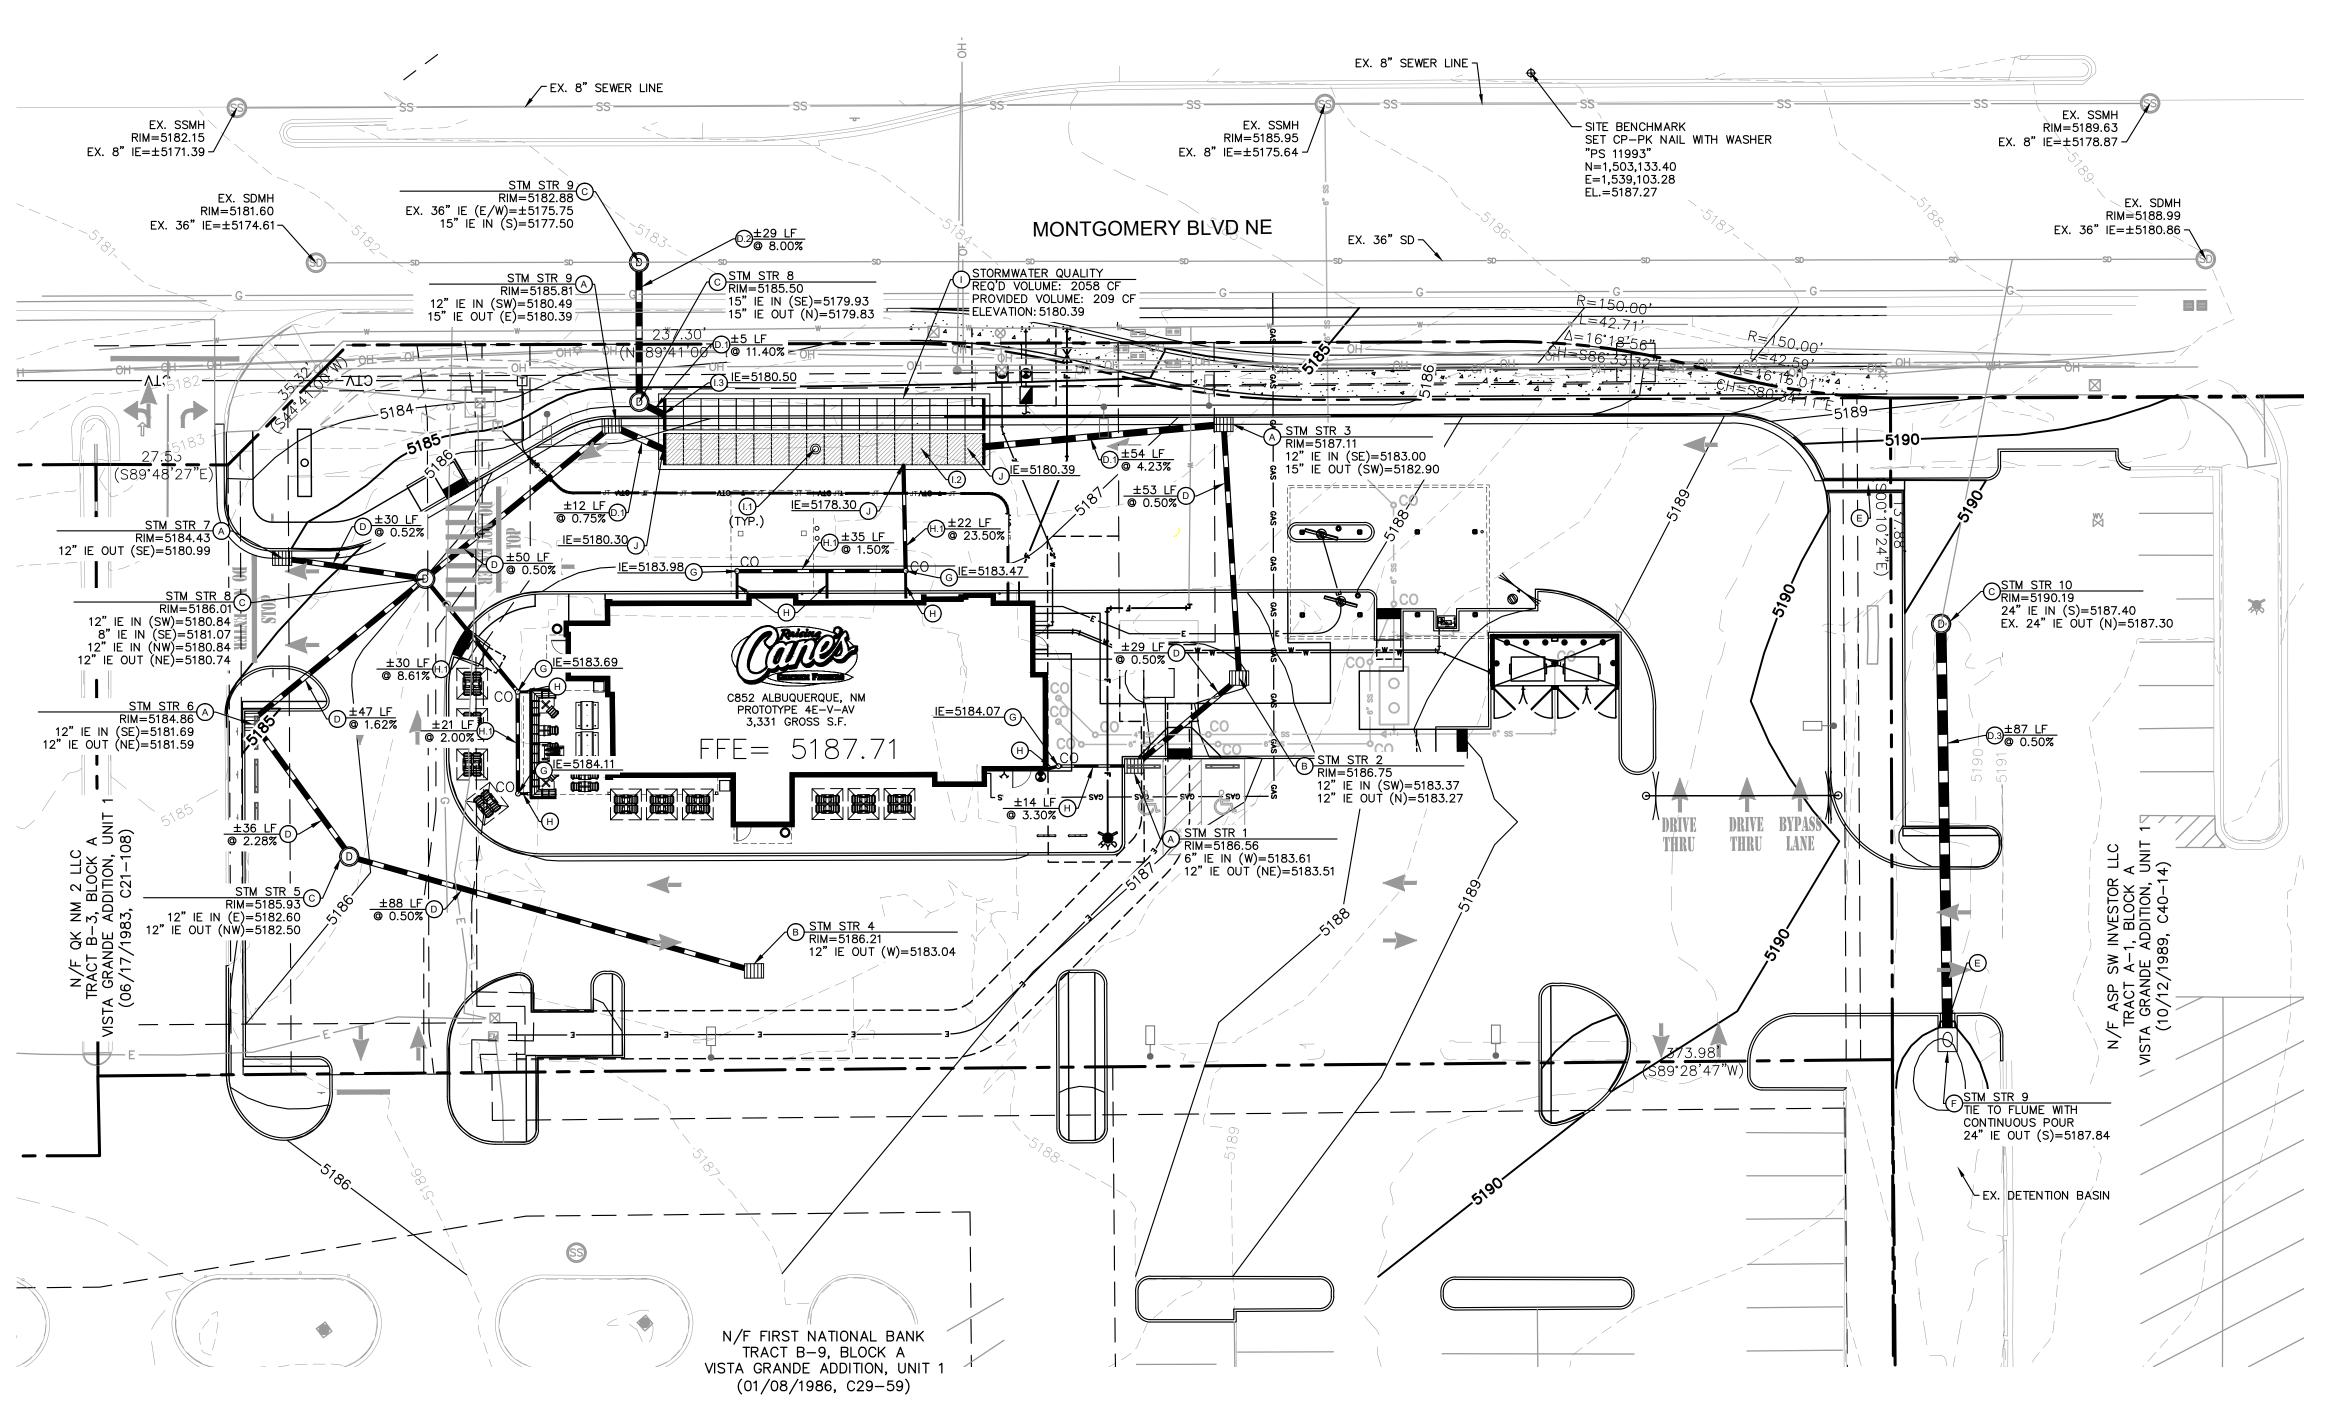
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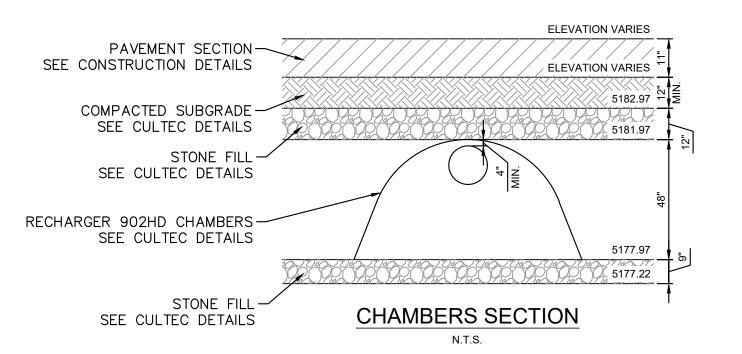
GRADING PLAN









- . REFER TO CITY STANDARD AND DETAILS FOR TRENCHING, BEDDING, BACKFILL, AND TRENCH COMPACTION REQUIREMENTS. GUTTER TRANSITION ADJACENT TO TYPE "A" INLETS TO FOLLOW CITY OF ALBUQUERQUE STANDARD DETAILS, DWG NO. 2207.
- 3. CONTRACTOR IS RESPONSIBLE FOR COMPLYING TO THE SPECIFICATIONS OF THE CITY WITH REGARDS TO MATERIALS, INSTALLATION, AND UTILITY CROSSINGS.
- 4. THE CONTRACTOR IS SPECIFICALLY CAUTIONED THAT THE LOCATION AND/OR ELEVATION OF EXISTING UTILITIES AS SHOWN ON THESE PLANS IS BASED ON RECORDS OF THE VARIOUS UTILITY COMPANIES, AND WHERE POSSIBLE, MEASUREMENTS TAKEN IN THE FIELD. THE INFORMATION IS NOT TO BE RELIED ON AS BEING EXACT OR COMPLETE. THE CONTRACTOR MUST CALL THE APPROPRIATE UTILITY COMPANIES AT LEAST 72 HOURS BEFORE ANY EXCAVATION TO REQUEST EXACT FIELD LOCATION AND ELEVATIONS OF UTILITIES. IT SHALL BE THE RESPONSIBILITY OF THE CONTRACTOR TO RELOCATE ALL EXISTING UTILITIES WHICH CONFLICT WITH THE PROPOSED IMPROVEMENTS SHOWN ON THE PLANS.
- 5. CONTRACTOR IS RESPONSIBLE FOR ALL NECESSARY PERMITS, INSPECTIONS AND/OR CERTIFICATIONS REQUIRED BY CITY CODES AND/OR UTILITY SERVICE COMPANIES.
- 6. CONTRACTOR IS RESPONSIBLE FOR PAVEMENT REPLACEMENT REQUIRED FOR ALL UTILITY INSTALLATIONS PER CITY STANDARDS.
- 7. THE AREA OF LAND TREATMENT D WITHIN THE PROJECT AREA IS 58,667 SF OR 1.35 AC.



STORM KEYNOTE LEGEND		
A	STORM INLET TYPE "A" PER CITY OF ALBUQUERQUE STANDARD DETAILS, DWG. NO. 2201	
В	STORM INLET TYPE "D", SINGLE GRATE TYPE PER CITY OF ALBUQUERQUE STANDARD DETAILS, DWG. NO. 2206	
©	STORM MANHOLE TYPE "C" PER CITY OF ALBUQUERQUE STANDARD DETAILS, DWG. NO. 2208	
D	12"Ø HDPE PIPE	
0.1	15"Ø HDPE PIPE	
0.2	15"Ø REINFORCED CONCRETE PIPE	
0.3	24"Ø REINFORCED CONCRETE PIPE	
E	FLUME	
F	SLOPE PAVED HEADWALL	
G	ROOF DRAIN CLEANOUT	
H	6" HDPE ROOF LEADER @ 1.00% MIN.	
(H.1)	8" HDPE ROOF LEADER	
0	CULTEC RECHARGER 902HD CHAMBERS OR APPROVED EQUIVALENT PRODUCT QUANTITY = 36, SEE SECTION THIS SHEET & CULTEC DETAILS SHEET C11.0 - C11.4 9" STONE FILL BETWEEN CHAMBERS, 12" AROUND PERIMETER	
(1.1)	INSPECTION PORT	
(1.2)	ISOLATOR ROW	
(1.3)	CHAMBER OUTFALL POINT	
J	TIE TO CHAMBER SYSTEM	

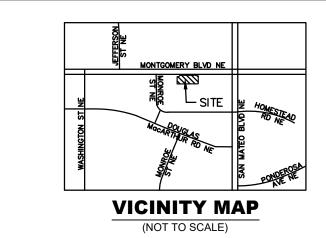


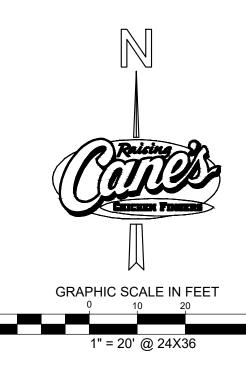

UTILITY LEGEND

	PROPERTY LINE
	EXISTING EASEMENT
	PROPOSED EASEMENT
	EXISTING FIRE LANE
s	PROPOSED SANITARY SEWER LINE
—— w ——	PROPOSED WATER LINE
——— F ———	PROPOSED FIRE WATER LINE
— GAS —— GAS —	PROPOSED UNDERGROUND GAS LINE
	PROPOSED UNDERGROUND ELECTRIC LINE
ист	PROPOSED UNDERGROUND TELEPHONE LI
	PROPOSED STORM DRAINAGE LINE
	EXISTING STORM DRAINAGE LINE
80- 80	EXISTING OVERHEAD POWER LINE
——— GAS ———	EXISTING GAS LINE
w	EXISTING WATER LINE
ss	EXISTING SANITARY SEWER LINE
\$	PROPOSED FIRE HYDRANT
•	PROPOSED WATER METER
o	PROPOSED SEWER CLEANOUT
\bowtie	PROPOSED WATER VALVE
ŀ	PROPOSED TEE
✓1 ⊏	PROPOSED BEND
°co	PROPOSED SEWER CLEAN OUT
Ø	EXISTING POWER POLE
	EXISTING FIRE HYDRANT
(\$)	EXISTING SANITARY SEWER MANHOLE
	EXISTING SIGN
⊲	THRUST BLOCK



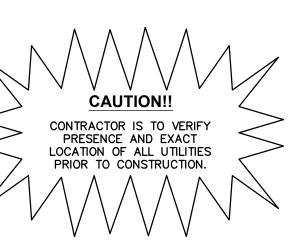



Montgomery & San Mateo **ALBUQUERQUE, NM 87112** Restaurant #RC852 P4E-V-AV SCHEME A

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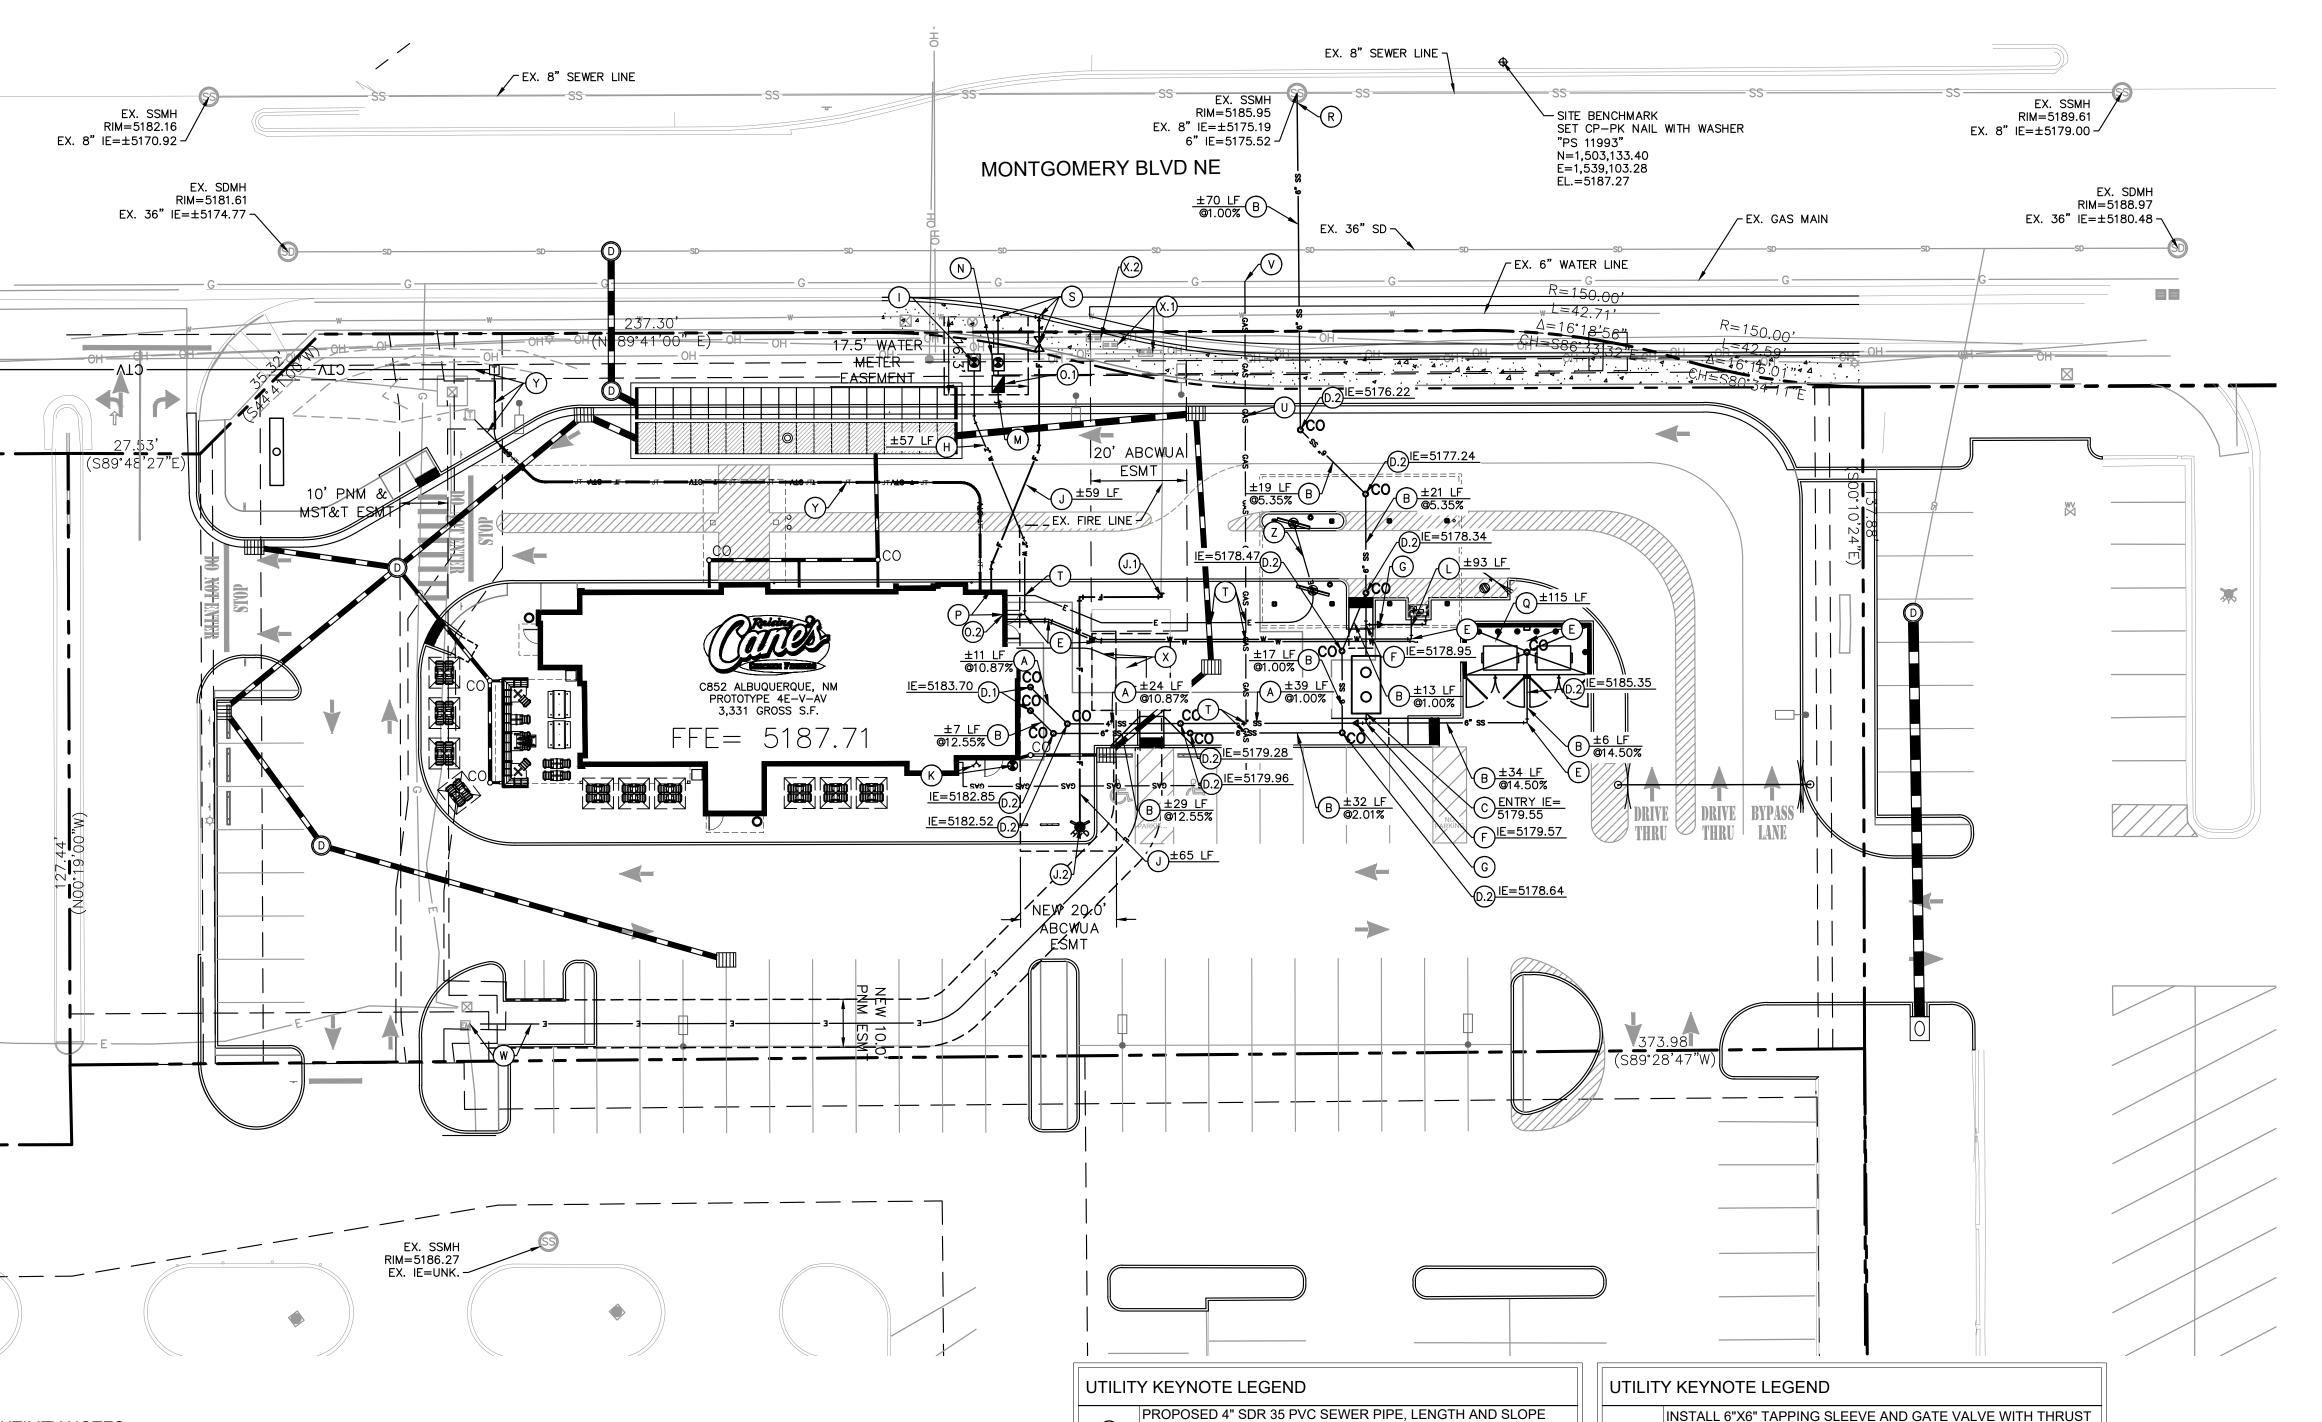
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STORM DRAINAGE PLAN

Date:	05.12.202
Project Number:	09004200
Drawn By:	LW/L



UTILITY NOTES

- 1. SEE MEP PLANS FOR ALL UTILITY CONNECTIONS INTO BUILDING.
- 2. REFER TO CITY STANDARD AND DETAILS FOR TRENCHING, BEDDING, BACKFILL, AND TRENCH COMPACTION REQUIREMENTS.
- 3. REFER TO ARCHITECTURAL/MEP PLANS FOR LOCATION AND SIZING OF SLEEVES FOR FRANCHISE UTILITIES, IRRIGATION, ETC. 4. CONTRACTOR SHALL NOTIFY THE UTILITY AUTHORITIES INSPECTORS 72 HOURS BEFORE CONNECTING TO ANY EXISTING LINE.
- 5. SANITARY SEWER PIPE SHALL BE AS FOLLOWS:
- PRIVATE: PVC SDR 35 PER ASTM D 3034 6. WATER LINES SHALL BE AS FOLLOWS:
- PUBLIC: PVC DR-18 (C-900) PER ASTM D 2241 WITH POLYWRAPPED CAST IRON OR DUCTILE IRON FITTINGS (CLASS 50) PRIVATE (LARGER THAN 3 INCHES): PVC DR-18 (C-900) PER ASTM D 2241 WITH POLYWRAPPED CAST IRON OR DUCTILE IRON
- PRIVATE (3 INCHES OR SMALLER): TYPE "K" SOFT COPPER, ASTM B88 OR PVC DR-18 (C-900) PER ASTM D 2241 OR ADS POTABLE WATER SERVICE TUBING (POLYFLEX - CTS PE4710)
- 8. CONTRACTOR IS RESPONSIBLE FOR COMPLYING TO THE SPECIFICATIONS OF THE CITY WITH REGARDS TO MATERIALS AND INSTALLATION
- OF UTILITIES AND WITH TCEQ GUIDELINES FOR UTILITY CROSSINGS.
- 9. IT IS THE CONTRACTOR'S RESPONSIBILITY TO DEFLECT ELECTRIC, GAS, CABLE, AND TELEPHONE CONDUIT AND PIPING AS REQUIRED TO
- 10. THE CONTRACTOR IS SPECIFICALLY CAUTIONED THAT THE LOCATION AND/OR ELEVATION OF EXISTING UTILITIES AS SHOWN ON THESE PLANS IS BASED ON RECORDS OF THE VARIOUS UTILITY COMPANIES, AND WHERE POSSIBLE, MEASUREMENTS TAKEN IN THE FIELD. THE INFORMATION IS NOT TO BE RELIED ON AS BEING EXACT OR COMPLETE. THE CONTRACTOR MUST CALL THE APPROPRIATE UTILITY COMPANIES AT LEAST 72 HOURS BEFORE ANY EXCAVATION TO REQUEST EXACT FIELD LOCATION OF UTILITIES. IT SHALL BE THE RESPONSIBILITY OF THE CONTRACTOR TO RELOCATE ALL EXISTING UTILITIES WHICH CONFLICT WITH THE PROPOSED IMPROVEMENTS
- SHOWN ON THE PLANS. 11. CONTRACTOR IS RESPONSIBLE FOR ALL NECESSARY PERMITS, INSPECTIONS AND/OR CERTIFICATIONS REQUIRED BY CITY CODES AND/OR
- UTILITY SERVICE COMPANIES. 12. CONTRACTOR SHALL COORDINATE WITH ALL UTILITY COMPANIES FOR INSTALLATION REQUIREMENTS AND SPECIFICATIONS IN REGARDS TO TAPS, HYDRANTS, VALVES, ETC.
- 13. CONTRACTOR IS RESPONSIBLE FOR PAVEMENT REPLACEMENT REQUIRED FOR ALL UTILITY INSTALLATIONS PER CITY STANDARDS.
- 14. CONTRACTOR SHALL MAINTAIN A MINIMUM OF 4 FEET COVER ON ALL WATER LINES OR AS PER CITY REQUIREMENTS.
- 15. POLYFLEX BY ADS TO BE USED IN PLACE OF COPPER WHERE ALLOWED BY CITY. CONTRACTOR TO VERIFY WITH CITY WHETHER IT CAN BE
- USED AND VERIFY WITH MEP REQUIRED INTERNAL DIAMETER FOR SUFFICIENT WATER FLOW TO BUILDING. 16. FIRELINE CONNECTION WILL BE REQUIRED TO BE A DRY-TAP.

- PER PLAN. TRENCH, BEDDING, AND BACKFILL PER CITY OF ALBUQUERQUE STD. SPECIFICATIONS SECTION 700
- PROPOSED 6" SDR 35 PVC SEWER PIPE, LENGTH AND SLOPE PER PLAN. TRENCH, BEDDING, AND BACKFILL PER CITY OF
- ALBUQUERQUE STD. SPECIFICATIONS SECTION 700
- (c) PROPOSED GREASE TRAP LOCATION CONNECT TO BUILDING SEWER, INVERT PER PLAN. REFERENCE
- MEP PLANS FOR CONTINUATION
- (D.2) PROPOSED SEWER CLEANOUT
- PROPOSED BEND, CONCRETE BLOCKING REQUIRED PER CITY OF ALBUQUERQUE STD. DWG 2320
- PROPOSED 6"X6" TEE
- PROPOSED 6"X4" REDUCER
- PROPOSED 2" COPPER, TYPE K DOMESTIC WATERLINE, LENGTH PER PLAN. INSTALL TRENCH BEDDING AND BACKFILL PER CITY
- OF ALBUQUERQUE STD. SPECIFICATIONS SECTION 700 REMOVE EXISTING WATER METER AND INSTALL NEW 1.5" DOMESTIC WATER METER PER CITY OF ALBUQUERQUE STD. DWG 2363 & 2367
- PROPOSED 6" CLASS 350 (CL350) DIP FIRE LINE WITH TRACER WIRE. LENGTH PER PLAN (4' MIN. COVER). TRENCH PER CITY OF
- ALBUQUERQUE STD. SPECIFICATIONS SECTION 700 (J.1) | TIE TO AND EXTEND EX. 6" FIRE LINE WITH 90° DIP BEND
- PROPOSED FIRE HYDRANT PER CITY OF ALBUQUERQUE STD.
- SPECIFICATIONS SECTION 801 PROPOSED FDC & PIV, SEE SPRINKLER PLANS FOR DETAILS PROPOSED 3" COLD WATER LINES TO CREW AMENITY STATION
- CONTINUATION (N) PROPOSED 1" IRRIGATION METER, REFER TO LANDSCAPE

PROPOSED 1" IRRIGATION SERVICE, REFER TO LANDSCAPE FOR

- PROPOSED IRRIGATION BFP, REFER TO LANDSCAPE
- PROPOSED DOMESTIC RPBA INTERNAL TO BUILDING, SEE MEP PLANS FOR DETAILS
- BUILDING WATER & FIRE CONNECTION, REFER TO MEP AND SPRINKLER PLANS FOR CONTINUATION
- PROPOSED $\frac{3}{4}$ " EACH H/C WATER TO DUMPSTER WITH RPZ VALVE,
- REFER TO MEP PLANS
- CORE EXISTING SSMH FOR TIE-IN PER CITY OF ALBUQUERQUE STD. DWG 2118

- BLOCK, VALVE BOX PER CITY OF ALBUQUERQUE STD. DWGS
- 2326 AND 2329
- (U) PROPOSED GAS SERVICE BY OTHERS

- PRIMARY SERVICE TO TRANSFORMER BY OTHERS
- SERVICE, SEE ELECTRICAL FOR DETAILS
- (x.2) RESET EXISTING ELECTRICAL PULLBOX AT FINISHED GRADE
- TELECOM/CATV SERVICE, SEE E4 PLANS
- CONDUIT TO MENU BOARDS, SEE ELECTRICAL FOR DETAILS

RESPONSIBILITY OF FRANCHISE UTILITY SERVICE

ELECTRIC SERVICE		
PRIMARY CONDUIT TO TRANSFORMER	Х	_
PRIMARY CONDUCTORS	X	_
TRANSFORMER PAD		_
TRANSFORMER ON POLE	X	_
SECONDARY CONDUIT TO METER	_	X
SECONDARY CONDUCTORS TO METER	_	X
SECONDARY CONDUIT FROM METER TO MAIN		X
PANEL		, ,
SECONDARY CONDUCTORS FROM METER TO		X
MAIN PANEL	_	^
GAS SERVICE		
SERVICE FROM ROW TO BUILDING	X	
CONDUIT FROM ROW TO BUILDING		X
INSTALL GAS METER	Х	_
TELEPHONE SERVICE		
SERVICE FROM ROW TO BUILDING	Х	

GENERAL

COMPANY | CONTRACTOR

NOTE: IT IS THE CONTRACTORS RESPONSIBILITY TO VERIFY THIS INFORMATION IMMEDIATELY UPON START OF CONSTRUCTION.

CONDUIT FROM ROW TO BUILDING

INSTALL 6"X6" TAPPING SLEEVE AND GATE VALVE WITH THRUST

- WET UTILITY CROSSING, MAINTAIN 2' MINIMUM VERTICAL
- SEPERATION
- (V) CONNECTION TO EXISTING GAS MAIN BY OTHERS
- CONNECTION TO EXISTING UNDERGROUND ELECTRIC AND
- PAD-MOUNTED TRANSFORMER & SECONDARY ELECTRICAL
- RELOCATED ELECTRICAL PULLBOXES

WATER METER & SEWER SCHEDULE

I.D.	TYPE	SIZE	NO.	SEWER
1	DOMESTIC	1.5"	1	6"
2	IRRIGATION	1"	1	_



UTILITY LEGEND

PROPERTY LINE

EXISTING EASEMENT

PROPOSED EASEMENT

EXISTING FIRE LANE

PROPOSED WATER LINE

PROPOSED FIRE WATER LINE

PROPOSED JOINT TRENCH

PROPOSED STORM DRAINAGE LINE

EXISTING GAS LINE

EXISTING WATER LINE

PROPOSED SANITARY SEWER LINE

PROPOSED UNDERGROUND GAS LINE

PROPOSED UNDERGROUND CABLE LINE

EXISTING OVERHEAD POWER LINE

EXISTING SANITARY SEWER LINE

PROPOSED FIRE HYDRANT

PROPOSED WATER METER

PROPOSED WATER VALVE

PROPOSED TEE

PROPOSED BEND

EXISTING SIGN

EXISTING POWER POLE

EXISTING FIRE HYDRANT


PROPOSED SEWER CLEANOUT

PROPOSED SEWER CLEAN OUT

EXISTING SANITARY SEWER MANHOLE

PROPOSED UNDERGROUND ELECTRIC LINE

PROPOSED UNDERGROUND TELEPHONE LINE

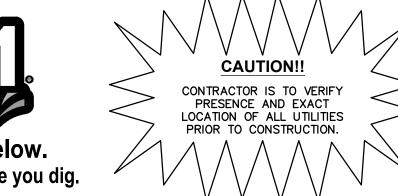



MONTGOMERY BLVD NE

VICINITY MAP

(NOT TO SCALE)

L SITE

Montgomery & San Mateo ALBUQUERQUE, NM 87112 Restaurant #RC852 P4E-V-AV SCHEME A

Engineer's Information:

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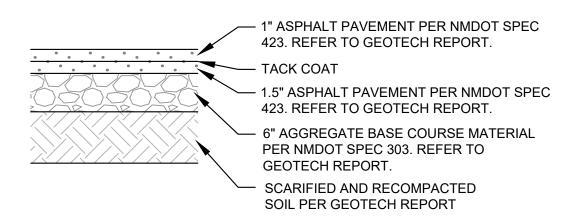


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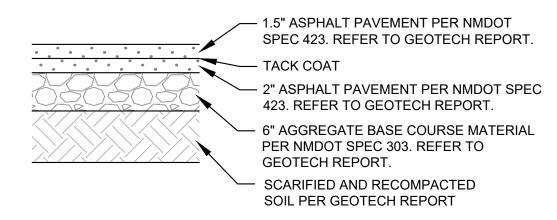
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1	12/20/2021	1ST BLDG RESUBMITTAL
2	01/17/2022	2ND BLDG RESUBMITTAL
3		


Date:	05.12.2022
Project Number:	090042000
Drawn By:	LW/LN




LIGHT DUTY ASPHALT PAVEMENT SECTION



MEDIUM DUTY ASPHALT PAVEMENT SECTION

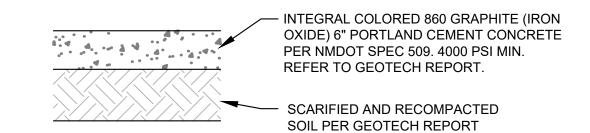

INTEGRAL COLORED
STANDARD DUTY CONCRETE PAVEMENT SECTION

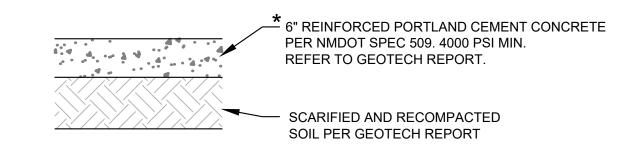

* CONCRETE FOR RIGID PAVEMENT SHOULD HAVE A MINIMUM 28-DAY COMPRESSIVE STRENGTH OF 4,000 PSI, A MODULUS OF RUPTURE OF 500 PSI, AND BE PLACED WITH A MAXIMUM SLUMP OF 4 INCHES.

HEAVY DUTY CONCRETE PAVEMENT SECTION

MANUFACTURER: BELGARD
PHONE: 877-235-4273
WEB: WWW.BELGARD.COM

PRODUCT: HOLLAND STONE LEGACY
COLOR: CHARCOAL OR APPROVED EQUAL.
SIZE: 3 15/16" x 7 7/8" x 2 3/8"

PATTERN: HERRINGBONE

NOTES:

1. PAVER JOINTS TO BE BUTT TIGHT
2. BROOM SWEEP JOINTS WITH POLYMERIC SAND.

BELGARD PAVER

COMPACTED 21A STONE BASE


EXPANSION JOINT


ADJACENT PAVING

COMPACTED SUBGRADE - REFER
TO GEOTECHNICAL ENGINEERING
TO CONFIRM SOIL COMPACTION

UNIT PAVERS DETAIL

N.T.S.

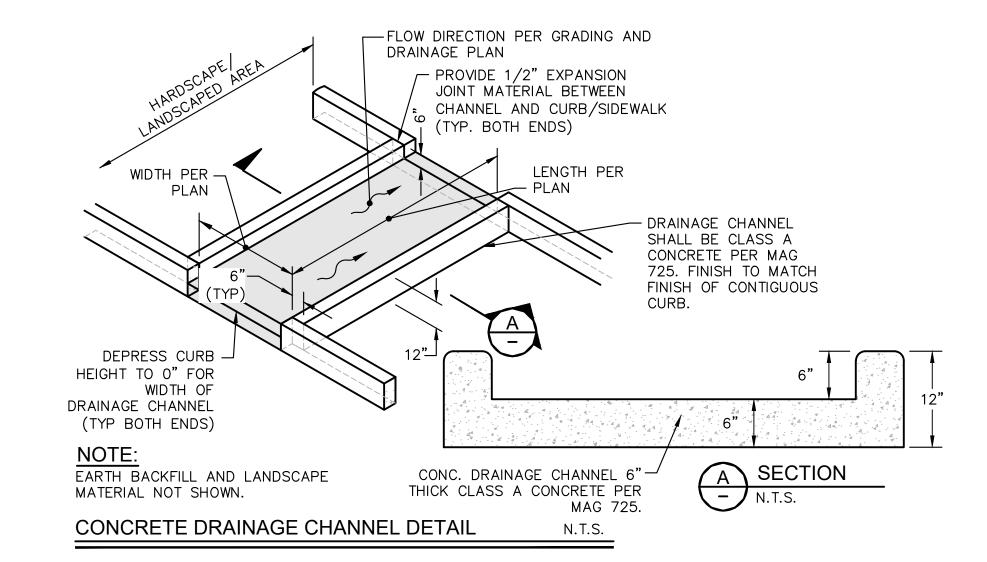

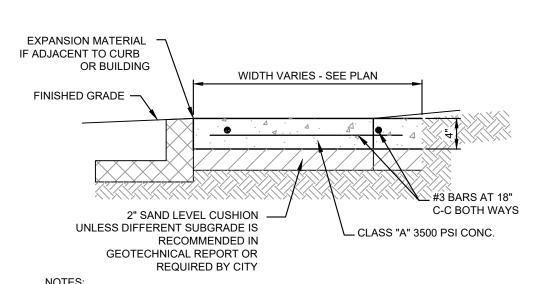

PROVIDE BITUMINOUS EXPANSION MATERIAL WHERE WALK ABUTS EXISTING IMPROVEMENTS AND AT ALL CHANGES IN GRADE


SPACE CONTROL JOINT UNIFORMLY AT INTERVALS EQUAL TO THE WALK WIDTH OR AS SHOWN ON ARCHITECTURAL PLANS.

3. PLACE PREMOLDED EXPANSION JOINT MATERIAL AROUND ALL STRUCTURES IN NEW WALK ALONGSIDE ALL ADJACENT BUILDINGS AND ABUTTING STRUCTURES TO THE NEW CONCRETE SIDEWALK

4. SEAL EXPANSION & CONTRACTION JOINTS WITH AN APPROVED TYPE SEALANT.

5. SIDEWALK PAVEMENT WHERE PATIO FURNITURE IS TO BE PLACED MUST BE 4000 PSI.

NOTE:
REFER TO GEOTECH REPORT FOR
FURTHER INFORMATION.

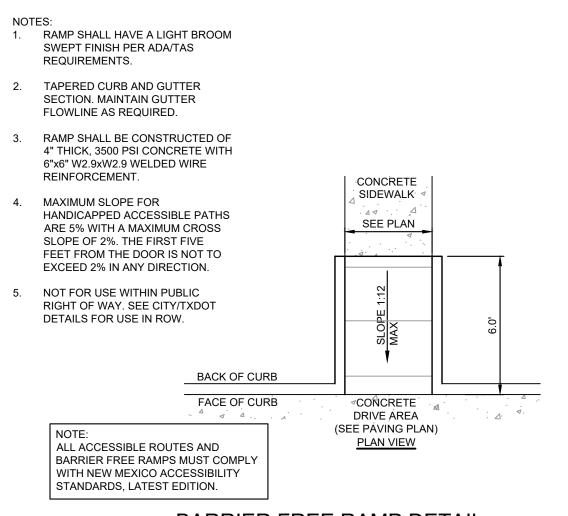

BARRIER FREE RAMP DETAIL

COMPACTED SUBGRADE PER GEOTECH REPORT

2' FROM CENTERLINE OF STRIPING

9"

4-1/2"

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4-1

NOTE:

1. PRE-CAST CONCRETE OR PLASTIC WHEEL STOPS MAY BE USED WITH CANE'S CONSTRUCTION MANAGERS APPROVAL.

PRECAST CONCRETE WHEEL STOP DETAIL







Montgomery & San Mateo
ALBUQUERQUE, NM 87112
Restaurant #RC852
P4E-V-AV SCHEME A

Engineer's Information:

Kimley » Horn

© 2022 KIMLEY—HORN
AND ASSOCIATES, INC.

13455 Noel Road
Two Galleria Office Tower
Suite 700
Dallas, TX 75240
CONTACT: LAUREN NUFFER, P.E.
(972) 770-1300
LAUREN.NUFFER@KIMLEY-HORN.COM
LIZ WILLMOT, P.E.
LIZ.WILLMOT@KIMLEY-HORN.COM

Professional of Record:



Prototype:	P4E-V-AV 2021-	2.0 RELEASE
Prototype Issue	10.04.2021	
Kitchen Issue D	08.02.2021	
Design Bulletin		
Date Issued:	Bulletin Number:	

2ND BLDG. RESUBMITTAL

RE	EVISIONS:	
	11/12/2021	80% REVIEW SET
	11/30/2021	1ST BLDG SUBMITTAL
1	12/20/2021	1ST BLDG RESUBMITTAL
2	01/17/2022	2ND BLDG RESUBMITTAL
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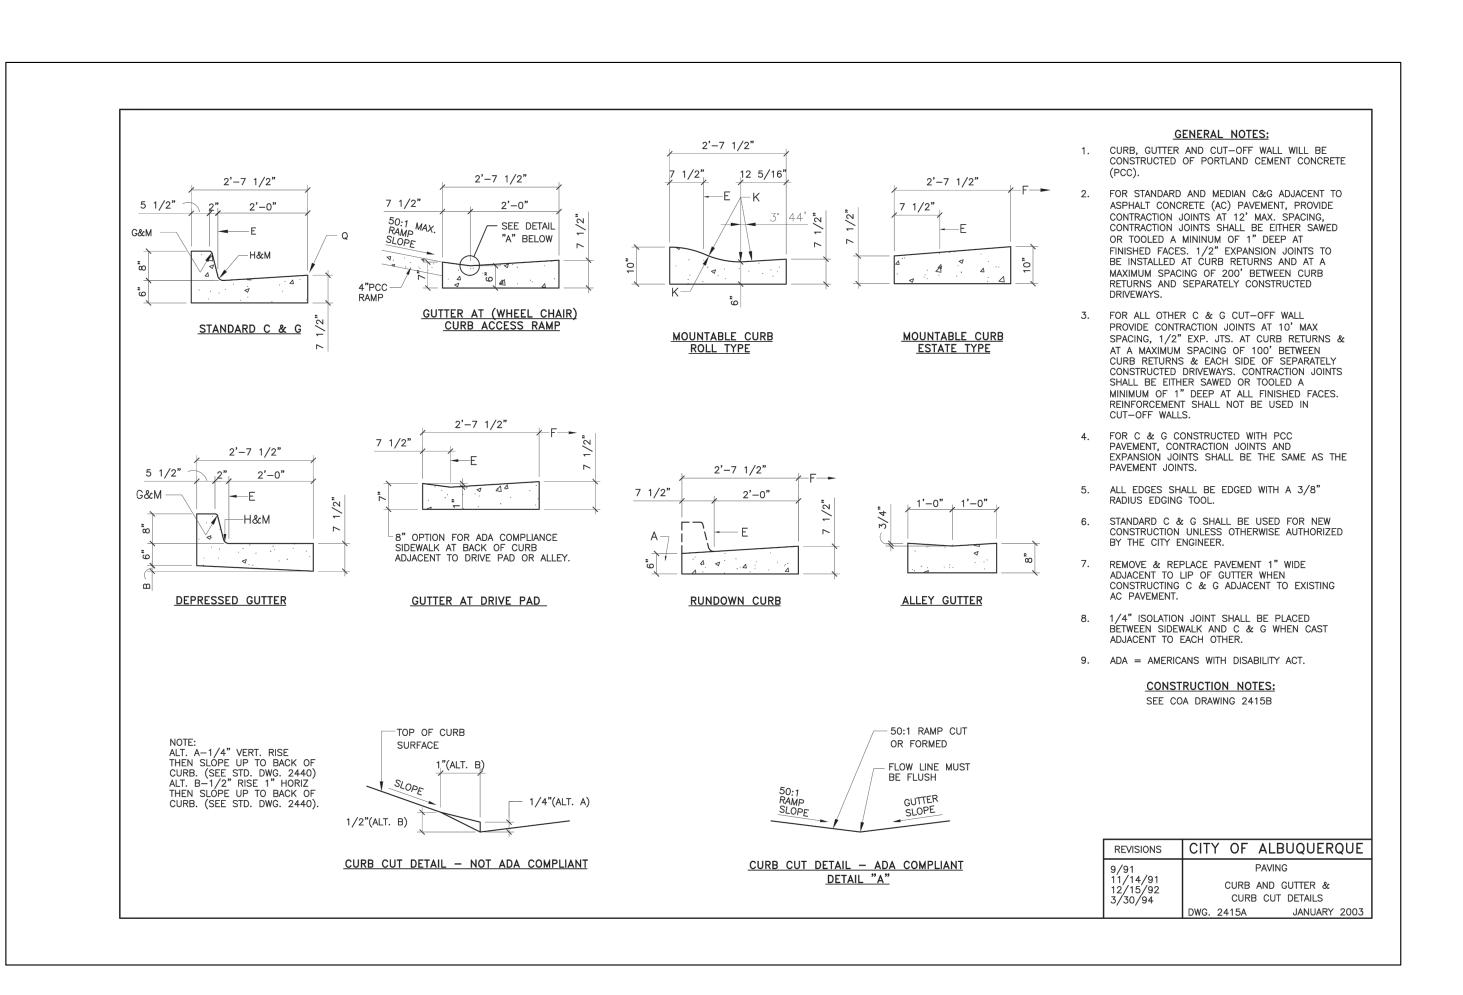
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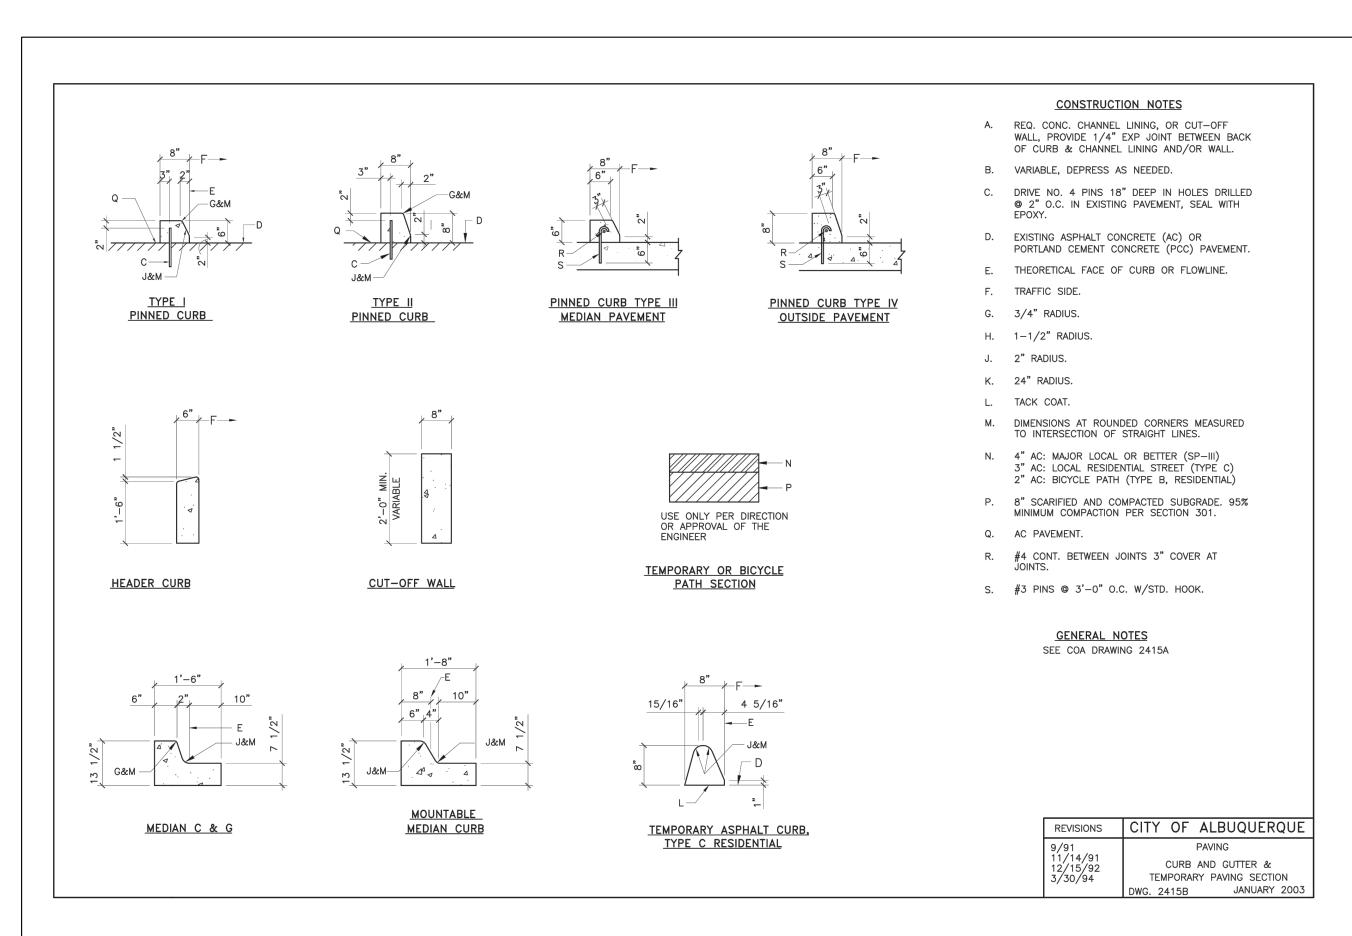
CONSTRUCTION DETAILS


Date:	05.12.2022
Project Number:	090042000
Drawn By:	LW/LN


Sheet Number:

C9.0





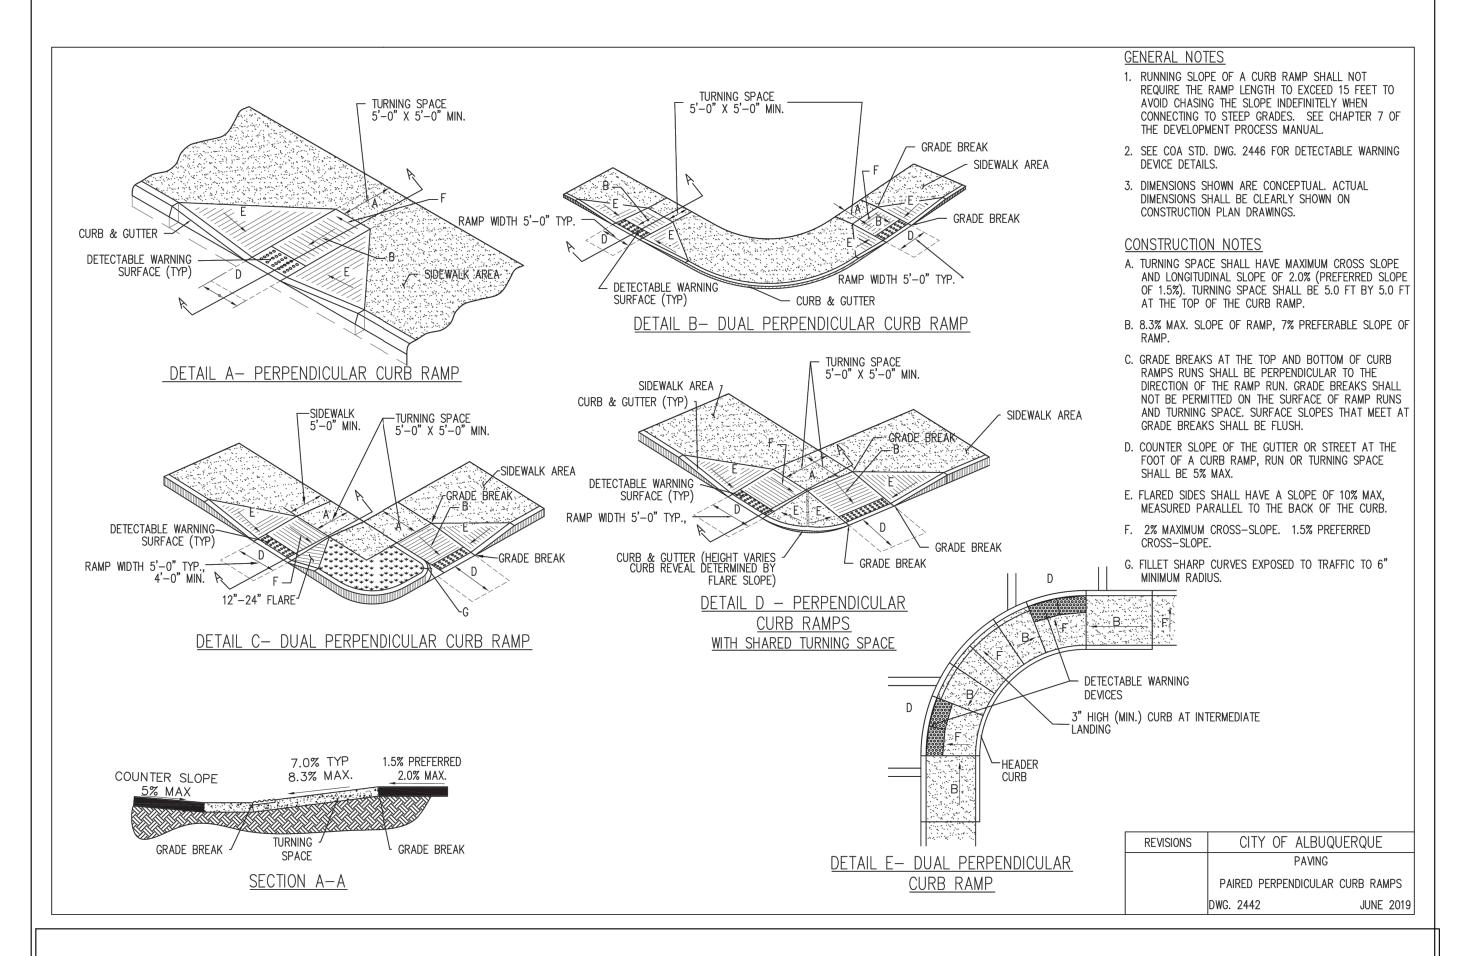

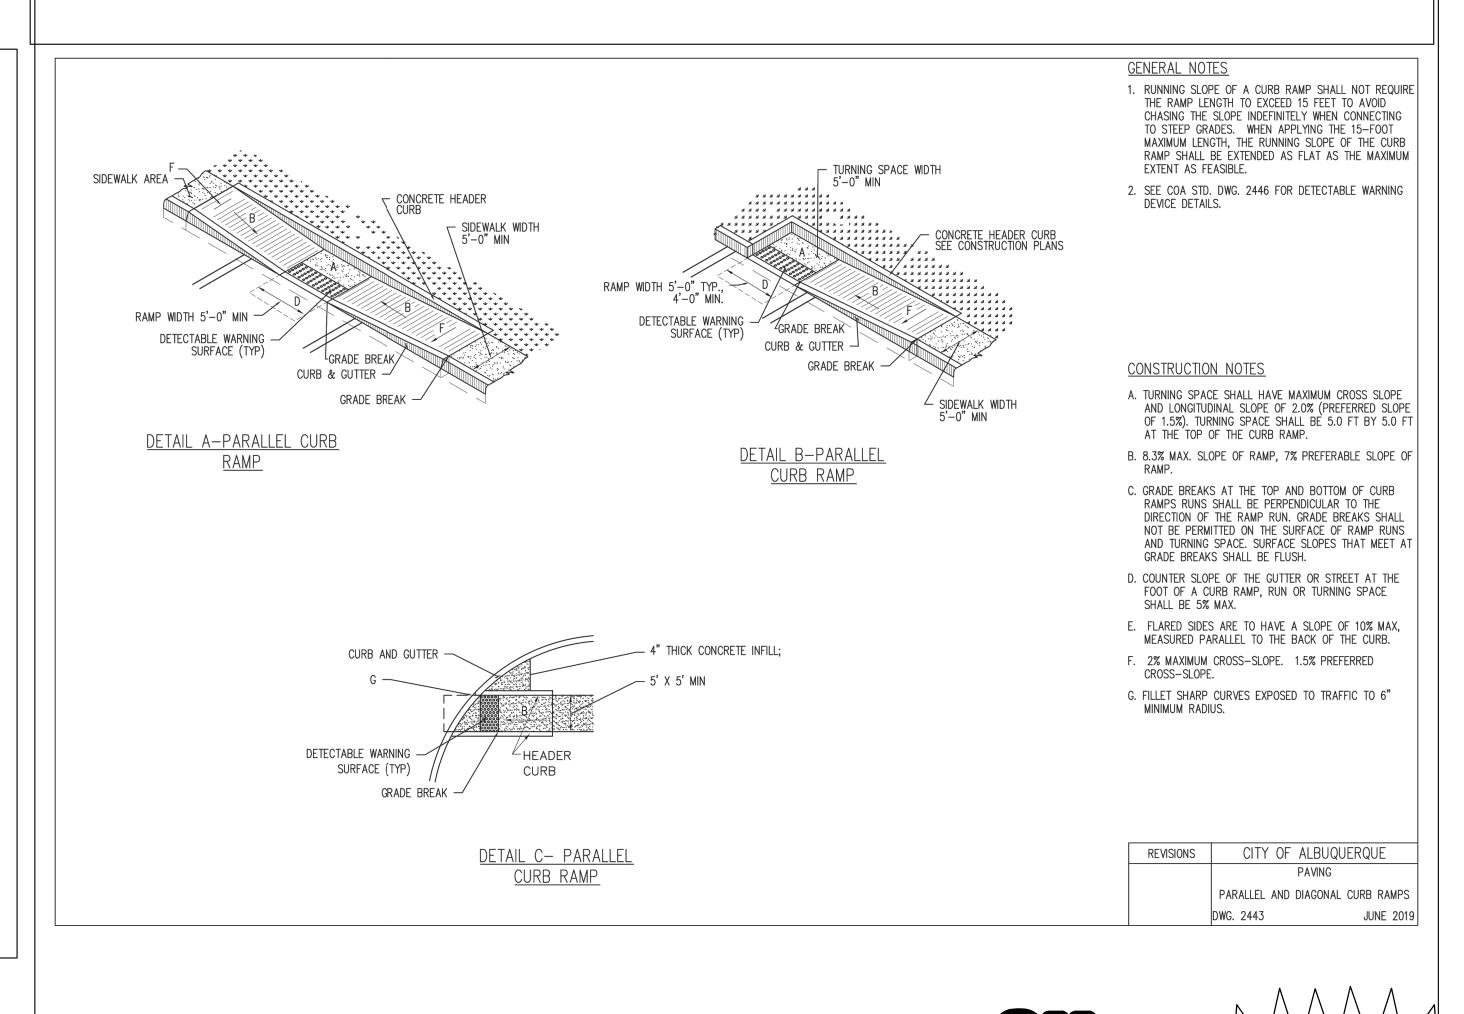



CAUTION!!

CONTRACTOR IS TO VERIFY
PRESENCE AND EXACT
LOCATION OF ALL UTILITIES
PRIOR TO CONSTRUCTION.



Montgomery & San Mateo
ALBUQUERQUE, NM 87112
Restaurant #RC852
P4E-V-AV SCHEME A

Engineer's Information:


Kimley» Horn © 2022 KIMLEY-HORN

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Prototype Issue	10.04.2021		
Kitchen Issue D	ate:	08.02.2021	
Design Bulletin	Design Bulletin Updates:		
Date Issued:	Bulletin Number:		

2ND BLDG. RESUBMITTAL

RE	EVISIONS:	
	11/12/2021	80% REVIEW SET
	11/30/2021	1ST BLDG SUBMITTAL
1	12/20/2021	1ST BLDG RESUBMITTAL
2	01/17/2022	2ND BLDG RESUBMITTAL
3		
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7		

CITY
CONSTRUCTION
DETAILS

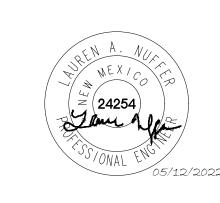 Date:
 05.12.2022

 Project Number:
 090042000

 Drawn By:
 LW/LN

Sheet Number:

C10.0

Current DRC	
Project Number:	

FIGURE 12

Date Submitted:
Date Site Plan Approved:
Date Preliminary Plat Approved:
Date Preliminary Plat Expires:
DRB Project No.:

DRB Application No.:____

INFRASTRUCTURE LIST (Rev. 2-16-18)

EXHIBIT "A"

TO SUBDIVISION IMPROVEMENTS AGREEMENT DEVELOPMENT REVIEW BOARD (D.R.B.) REQUIRED INFRASTRUCTURE LIST

Restaurant # RC852

PROPOSED NAME OF PLAT AND/OR SITE DEVELOPMENT PLAN

Tract B-1 of Vista Grande Addition Plat

EXISTING LEGAL DESCRIPTION PRIOR TO PLATTING ACTION

Following is a summary of PUBLIC/PRIVATE Infrastructure required to be constructed or financially guaranteed for the above development. This Listing is not necessarily a complete listing. During the SIA process and/or in the review of the construction drawings, if the DRC Chair determines that appurtenant items and/or unforeseen litems have not been included in the infrastructure listing, the DRC Chair may include those items in the listing and related financial guarantee. Likewise, if the DRC Chair determines that appurtenant or non-essential items can be deleted from the listing, those items may be deleted as well as the related portions of the financial guarantees. All such revisions require approval by the DRC Chair, the User Department and agent/owner. If such approvals are obtained, these revisions to the listing will be incorporated administratively. In addition, any unforeseen items which arise during construction which are necessary to complete the project and which normally are the Subdivider's responsibility will be required as a condition of project acceptance and close out by the City.

Financially	Constructed	Size	Type of Improvement	Location	From	То	Priva	ate	rtification City Cnst
Guaranteed DRC #	Under DRC #	205'	Concrete Curb & Gutter	East side of Montgomery Blvd NE	East Property Line	204' West of East Property Line	Inspector /	P.E. /	Enginee /
		203'	Concrete Valley Gutter	East side of Montgomery Blvd NE	East Property Line	204' West of East Property Line		/	/
		1,192 SF 190 LF 12 LF	Asphalt Pavement Montgomery Right-Lane Length Montgomery Right-Lane Width	East side of Montgomery Blvd NE	East Property Line	160' West of East Property Line			
		1,214 SF	Concrete Sidewalk	East side of Montgomery Blvd NE	East Property Line	204' West of East Property Line		/	/
		62'	6" Sanitary Sewer Pipe	East side of Montgomery Blvd NE	North Property Line	62' North of North Property Line		/	/
		17'	15" RCP Storm Drain Pipe	East side of Montgomery Blvd NE	North Property Line	17' North of North Property Line		/	/
		22'	Gas Pipe	East side of Montgomery Blvd NE	North Property Line	22' North of North Property Line		/	
		1	Relocation of Light Pole	East side of Montgomery Blvd NE	Behind Existing Property Line	Behind Future Property Line	/	/	
		2	Relocation of Electric Pullbox	East side of Montgomery Blvd NE	Existing Sidewalk	Future Sidewalk	/	1	/

Financially	Constructed	1					Const	ruction Cer	rtification
Guaranteed	Under	Size	Type of Improvement	Location	From	То	Priv	ate	City Cnst
DRC#	DRC#						Inspector	P.E.	Engineer
		76'	Removal of Valley Gutter	East side of Montgomery Blvd NE	East Property Line	204' West of East Property Line		1	
		205'	Removal of Curb & Gutter	East side of Montgomery Blvd NE	East Property Line	204' West of East Property Line	/		
		244 SF	Removal of Asphalt Pavement	East side of Montgomery Blvd NE	East Property Line	40' West of East Property Line	/	1	
		1,215 SF	Removal of Concrete Sidewalk	East side of Montgomery Blvd NE	East Property Line	204' West of East Property Line			
		178 SF	Removal and Replacement of Asphalt Pavement for Utility Trenching	East side of Montgomery Blvd NE	19' North of North Property Line	64' North of North Property Line		/	
		101 SF	Removal and Replacement of Asphalt Pavement for Utility Trenching	East side of Montgomery Blvd NE	North Property Line	19' North of North Property Line		/	
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PAGE ____ OF ____

			roved for Impact Fee credits. Signature e standard SIA requirements.	es from the Impact Fee Adn	ninistrator and the Cit	y User Department is requ	ired prior to	DRB approv	al of this
Financially	Constructed	1					Cons	struction Cer	tification
Guaranteed	Under	Size	Type of Improvement	Location	From	То	Pri	vate	City Cnst
DRC#	DRC#						Inspector	P.E.	Engineer
				- <u> </u>			1		
							/	1	1
					Approval of Cred	itable Items:	Approval o	f Creditable	Items:
					Impact Fee Admis	strator Signature Date	City User	Dept. Signat	ure Date
		"		NOTES					
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2 _									
=									
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_									
	AGENT / OWNER			DEVELOPMENT RI	EVIEW BOARD MEME	BER APPROVALS			
Liz	Willmot, F	P.E			_				
	NAME (print)		DRB CH	IAIR - date		PARKS & RECREATION -	date		
Ki	mley-Hor	<u>n</u>							
1. 11	FIRM		TRANSPORTATION	DEVELOPMENT - date		AMAFCA - date			
mu	ellento (05/12/2022						_	
0	SIGNATURE - date		UTILITY DEVE	LOPMENT - date		CODE ENFORCEMENT - 0	date		
			CITY ENG	INEER - date		date		_	
			DESIGN	REVIEW COMMITTEE REV	ISIONS				
			BESIGN	NEVIEW COMMITTEE NEV	1010110				
	REVISION	DATE	DRC CHAIR	USER DEP	ARTMENT	AGEN	IT /OWNER		
									_
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PAGE ____ OF ____ (Rev. 2-16-18)