

LEGEND

 EXISTING CURB PROPOSED CURB

PARKING COUNT


- PROPOSED SIDEWALK

PROPOSED SAWCUT

PROPOSED PAVEMENT

- PROPOSED LANDSCAPE AREA

ⅎ PROPOSED LIGHT POLE

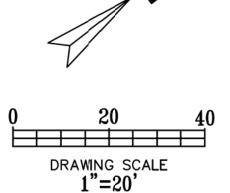

22 G.G.

NW MEXIC

VARD NEW

COORS ALBUQUE ERNALILI

26 OF

PLOT DATE

07/27/21

DRAWING SCALE

1" = 20'

PROJECT NUMBER

CDC20021

SHEET NUMBER

C1.01

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SITI

VICINITY MAP
ZONE ATLAS MAP C-13 NTS

GENERAL NOTES

1. DEVIATIONS FROM THESE STANDARDS SHALL BE SUBMITTED TO THE CITY ENGINEER AND/OR CITY TRAFFIC ENGINEER FOR APPROVAL PRIOR TO CONSTRUCTION.

2. SUBGRADE UNDER SIDEWALKS AND DRIVEPADS SHALL BE COMPACTED IN ACCORDANCE WITH

3. FOR SIDEWALKS LESS THAN 60' WIDE ON ACCESSIBLE ROUTE, PASSING SPACE AT LEAST 60' X 60' SHALL BE PROVIDED AT LEAST EVERY 200 FT.

4. GRATINGS LOCATED IN WALKING SURFACE SHALL HAVE SPACES NO GREATER THAN 1/2 WIDE IN DIRECTION OF TRAVEL. IF OPENINGS ARE ELONGATED, LONG DIMENSION SHALL BE PLACED PERPENDICULAR TO DIRECTION OF TRAVEL.

ALONG THE ACCESSIBLE ROUTE, CHANGES IN LEVEL BETWEEN 14" AND 12" SHALL BE BEVELED WITH A SLOPE NO GREATER THAN 2H: 1V. CHANGES IN LEVEL GREATER THAN 1/2" REQUIRE

6. PROVIDE A MINIMUM SIDEWALK WIDTH OF 4' AROUND OBSTACLES FOR ADA ACCESS.

'. SEE COA STD DWG 2425A AND 2425B FOR DRIVEPAD DETAILS.

CONSTRUCTION NOTES

A. SLOPE 2% MAX. 1.5% PREFERRED SLOPE.

B. 5' MIN. SIDEWALK WIDTH. SIDEWALK WIDTH SHALL BE IN ACCORDANCE WITH CHAPTER 23 OF DEVELOPMENT PROCESS MANUAL

C. SETBACK TO BE DETERMINED BY AVAILABLE RIGHT-OF-WAY. SEE CHAPTER 7 OF DEVELOPMENT PROCESS MANUAL. ALSO SEE COA STD. DWG. 2414 FOR LANDSCAPE BUFFER.

E. WALKWAY VARIABLE (6' MINIMUM).

. PROPERTY LINE.

G. 1/2' EXPANSION JOINTS WHERE SIDEWALK OR DRIVEPAD ABUTS BUILDINGS, FENCES, WALLS OR OTHER IMMOVABLE OBJECTS.

H. HEADER CURB OR INTEGRAL CURB AS REQUIRED TO MEET GRADE AT BACK OF SIDEWALK. SEE STD. DWG. 2415.

. CONTRACTION JOINTS.

J. FOR CURB ACCESS RAMPS, SEE DWGS. 2440 THROUGH 2445.

K CHECK DIMENSION FROM BOTH PROPERTY LINE AND FLOW LINE. USE IN AREAS WHERE DRIVEPAD IS FARTHEST FROM INTERSECTION. L. RAMP AS REQUIRED TO MEET DRIVEPAD GRADE.

M. ADA ACCESSIBLE PATHWAY. 2% MAX. CROSS-SLOPE. 1.5% PREFERABLE CROSS-SLOPE.

SITE PLAN				
EXISTING ZONING: MX-M/MODERATE INTENSITY				
LAND USE:	FINANCIAL INSTITUTION			
LEASE ACREAGE:	1.334 ACRES (54,740 SF) 1.257 ACRES			
BUILDING FOOT PRINT (TOTAL):	±3,291 SQUARE FEET			
OPEN SPACE REQUIRED (25% OF LOT ACREAGE):	±13,685 SQUARE FEET			
OPEN SPACE PROVIDED:	±16,348 SQUARE FEET (29.9%)			
BUILDING COVERAGE:	3,291/54,740: 6.01%			
APPROX EX. IMPERVIOUS AREA:	±41,767 SQUARE FEET (76.3%)			
APPROX PROPOSED IMPERVIOUS AREA::	±38,392 SQUARE FEET (70.1%)			
PARKING REQUIRED (3 PER 1000 SF OF PROPOSED BUILDING):	10 SPACES			
PARKING PROVIDED:	60 SPACES			
ACCESSIBLE PARKING REQUIRED (1 ACCESSIBLE SPACE/25 STANDARD SPACE):	3 SPACES			
PARKING PROVIDED (ACCESSIBLE):	3 SPACES			
REQUIRED STACKING SPACES:	4 SPACES PER ATM			
PROVIDED STACKING SPACES:	4 SPACES PER ATM			
BICYCLE SPACE: REQUIRED/PROVIDED	3/4 SPACES			
MOTORCYCLE SPACES: REQUIRED/PROVIDED	1/2 SPACES			

PR-2021-005508 **PROJECT NUMBER:** SI-2021-00809 **Application Number:** This plan is consistent with the specific Site Development Plan approved by the Environmental Planning Commission (EPC), dated N/A Findings and Conditions in the Official Notification of Decision are satisfied. Is an Infrastructure List required? () Yes (X) No If yes, then a set of approved DRC plans with a work order is required for any construction within Public Right-of-Way or for construction of public improvements. DRB SITE DEVELOPMENT PLAN APPROVAL: Jeanne Wolfenbarger Aug 26, 2021 Traffic Engineering, Transportation Division Date Blaine Carter Aug 31, 2021 Date Aug 26, 2021 Date Parks and Recreation Department Einest Urmijo Aug 26, 2021 City Engineer/Hydrology Date Vimit World Aug 26, 2021 Code Enforcement Date * Environmental Health Department (conditional) Date 07-28-21 Herman Gallegos Herman Gallegos Solid Waste Management Date Sep 1, 2021 Date DRB Chairperson, Planning Department

*Environmental Health, if necessary

THE BENCHMARKS ARE PROVIDED BASED ON THE ELEVATIONS

ALBUQUERQUE CONTROL SURVEY MONUMENT "DOUGLAS" NEW MEXICO STATE PLANE COORDINATES CENTRAL ZONE, NAD 83 AS PUBLISHED: N=1505417.495 E=1520286.421 GROUND TO GRID FACTOR=0.999682452, DELTA ALPHA = $-00^{\circ}13'52.53''$ ELEVATION=4975.078 NAVD88

ALBUQUERQUE CONTROL SURVEY MONUMENT "13_C15" NEW MEXICO STATE PLANE COORDINATES, CENTRAL ZONE, NAD 83 AS PUBLISHED: N=1520736.123 E=1527665.310 GROUND TO GRID FACTOR=0.999678880, DELTA ALPHA = - 00°13'02.61" ELEVATION=5008.218 NAVD88

CONSTRUCTION. ENGINEER NOT RESPONSIBLE FOR PROVIDING BENCHMARKS AND BEARINGS.

CALL NM ONE-CALL SYSTEM SEVEN (7) DAYS

PRIOR TO ANY EXCAVATION

PROVIDED BY SURVTEK CONSULTING SURVEYORS

CONTRACTOR SHALL COORDINATE WITH SURVEYOR FOR BENCHMARKS AND ELEVATIONS PRIOR TO

AND MAINTAIN ALL UTILITIES FROM DAMAGE DURING CONSTRUCTION. ANY DAMAGE BY THE CONTRACTOR TO UTILITIES SHALL BE REPAIRED OR REPLACED BY THE CONTRACTOR AT THEIR OWN EXPENSE.

!!! CAUTION !!!

UNDERGROUND UTILITIES

RESPONSIBILITY OF THE CONTRACTOR(S) TO VERIFY THE HORIZONTALLY AND VERTICALLY

EXISTING UTILITIES AND UNDERGROUND FACILITIES INDICATED ON THESE PLANS HAVE BEEN

LOCATED FROM REFERENCE INFORMATION SUPPLIED BY VARIOUS PARTIES. THE ENGINEER DOES

LOCATION OF ALL UTILITIES AND UNDÈRGROUND FACILITIES PRIOR TO CONSTRUCTION, TO TAKE

OF ALL CONFLICTS OF THE WORK WITH EXISTING FACILITIES. THE CONTRACTOR SHALL PROTECT

PRECAUTIONS IN ORDER TO PROTECT ALL FACILITIES ENCOUNTERED AND NOTIFY THE ENGINEER

NOT ASSUME THE RESPONSIBILITY FOR THE UTILITY LOCATIONS SHOWN. IT SHALL BE THE SOLE

PLANT MATERIAL LIST

		TREES		SQ. FT.	TOTAL S.F.
KEY	QUANTITY	<u>DESCRIPTION</u>	SIZE	<u>COVERAGE</u>	COVERAG
60	2	QUERCUS MUELENBURGII	3" CAL., MIN. 3'		
CO		CHINKAPIN OAK	SPREAD, MIN. 10 FT. HT.	1,600	3200
		ORNAMENTAL TREES			
<u>KEY</u>	QUANTITY	DESCRIPTION	SIZE		
DW	1	CHILOPSIS LINEARIS 'BUBBA'	30 GAL., 8' HT.,		
DVV		DESERT WILLOW	3' SPREAD	25	25
DD	3	CERCIS CANADENSIS 'OKLAHOMA'	30 GAL., 8' HT.,		
RB		REDBUD	3' SPREAD	15	45
V/AC	2	VITEX AGNUS-CASTUS 'SHOAL CREEK'	30 GAL., 8' HT.,		
VAC		SHOAL CREEK VITEX	3' SPREAD	20	40
		SHRUBS			
<u>KEY</u>	QUANTITY	<u>DESCRIPTION</u>	SIZE		
DS	2	DASYLIRION TEXANUM			
DS	3	GREEN DESERT SPOON	5 GAL., MIN. 15" HT.	4	12
66	10	COTONEASTER BUXIFOLIUS			
GC		GRAY COTONEASTER	5 GAL., MIN. 15" HT.	9	90
NIDC	3	ILEX X 'NELLIE R. STEVENS'	30 GAL., 5' HT.,		
NRS		NELLIE R. STEVENS HOLLY	3' SPREAD	10	30
TC	6	LEUCOPHYLLUM LANGMANIAE			
TS		TEXAS SAGE 'LYNN'S LEGACY'	5 GAL., MIN. 15" HT.	4	24
DV	7	HESPERALOE PARVIFOLIA			
RY		RED YUCCA	3 GAL., MIN. 10" HT.	3	21
CLIV	13	SALVIA X 'ULTRA VIOLET'			
SUV		ULTRA VIOLET SAGE	5 GAL., MIN. 15" HT.	8	104
VDD	1	CAESALPINIA GILLIESII			
YBP		YELLOW BIRD OF PARADISE	10 GAL., MIN. 36" HT.	10	10
\	1	AGAVE OVATIFOLIA			
WT		WHALE'S TONGUE	10 GAL., MIN. 36" HT.	4	4
YF	6	YUCCA FILAMENTOSA 'COLOR GUARD'			
		COLOR GUARD YUCCA	5 GAL., MIN. 8" HT.	2	12
		ORNAMENTAL GRASSES			
<u>KEY</u>	QUANTITY	DESCRIPTION	<u>SIZE</u>		
FRG	12	CALAMAGROSTIS ARUNDINACEA 'KARL	3 GAL., FULL PLANT		
רוט		FOESTER' FEATHER REED GRASS	SP. AS SHOWN	2	24
ABM	27	MUHLENBERGIA CAPILLARIS 'REGAL MIST'	3 GAL., FULL PLANT		
		AUTUMN BLUSH MUHLY	SP. AS SHOWN	3	81
NACC	35	NASSELLA TENUISSIMA	1 GAL., FULL PLANT		
MFG	25	MEXICAN FEATHER GRASS	SP. AS SHOWN	2	<u>50</u>
					3772

SHEET NOTES:

THE LANDSCAPE SECTION DETAILS ARE ON SHEET LAND003.

THE DRAWINGS AND SPECIFICATIONS ARE
COMPLIMENTARY. ANYTHING CALLED FOR ON ONE AND
NOT THE OTHER IS AS BINDING AS IF SHOWN AND
CALLED FOR ON BOTH. THE PLANT SCHEDULE IS AN AID
TO BIDDERS ONLY.

GRAVEL TO BE 2" DEEP WHERE PLANT MATERIAL IS TO BE
INSTALLED.

GRAVEL KEY

~ ~ ~	DESERT BRONZE GRAVEL 2"-4"
	SMOKE FINES
* * * * * * *	MOUNTAINAIR BROWN GRAVEL 2"-4"
	PUEBLO ROSE GRAVEL 7/8"
++++	COYOTE MIST GRAVEL 2"-4"
	GREY CRUSHED GRAVEL 3/4"



CHASE RETAIL BANKING CE
COORS BLVD & PASEO DEL NORTE
ALBUQUERQUE, NEW MEXICO 87110

1445 ROSS AVENUE SUITE 5700 DALLAS, TEXAS 75202 214.997.6029




REVISIONS

DATE ISSUED: FEBRUARY 08, 2020
JOB #: 2020049
SHEET NAME:

LANDSCAPE PLAN

LAND002

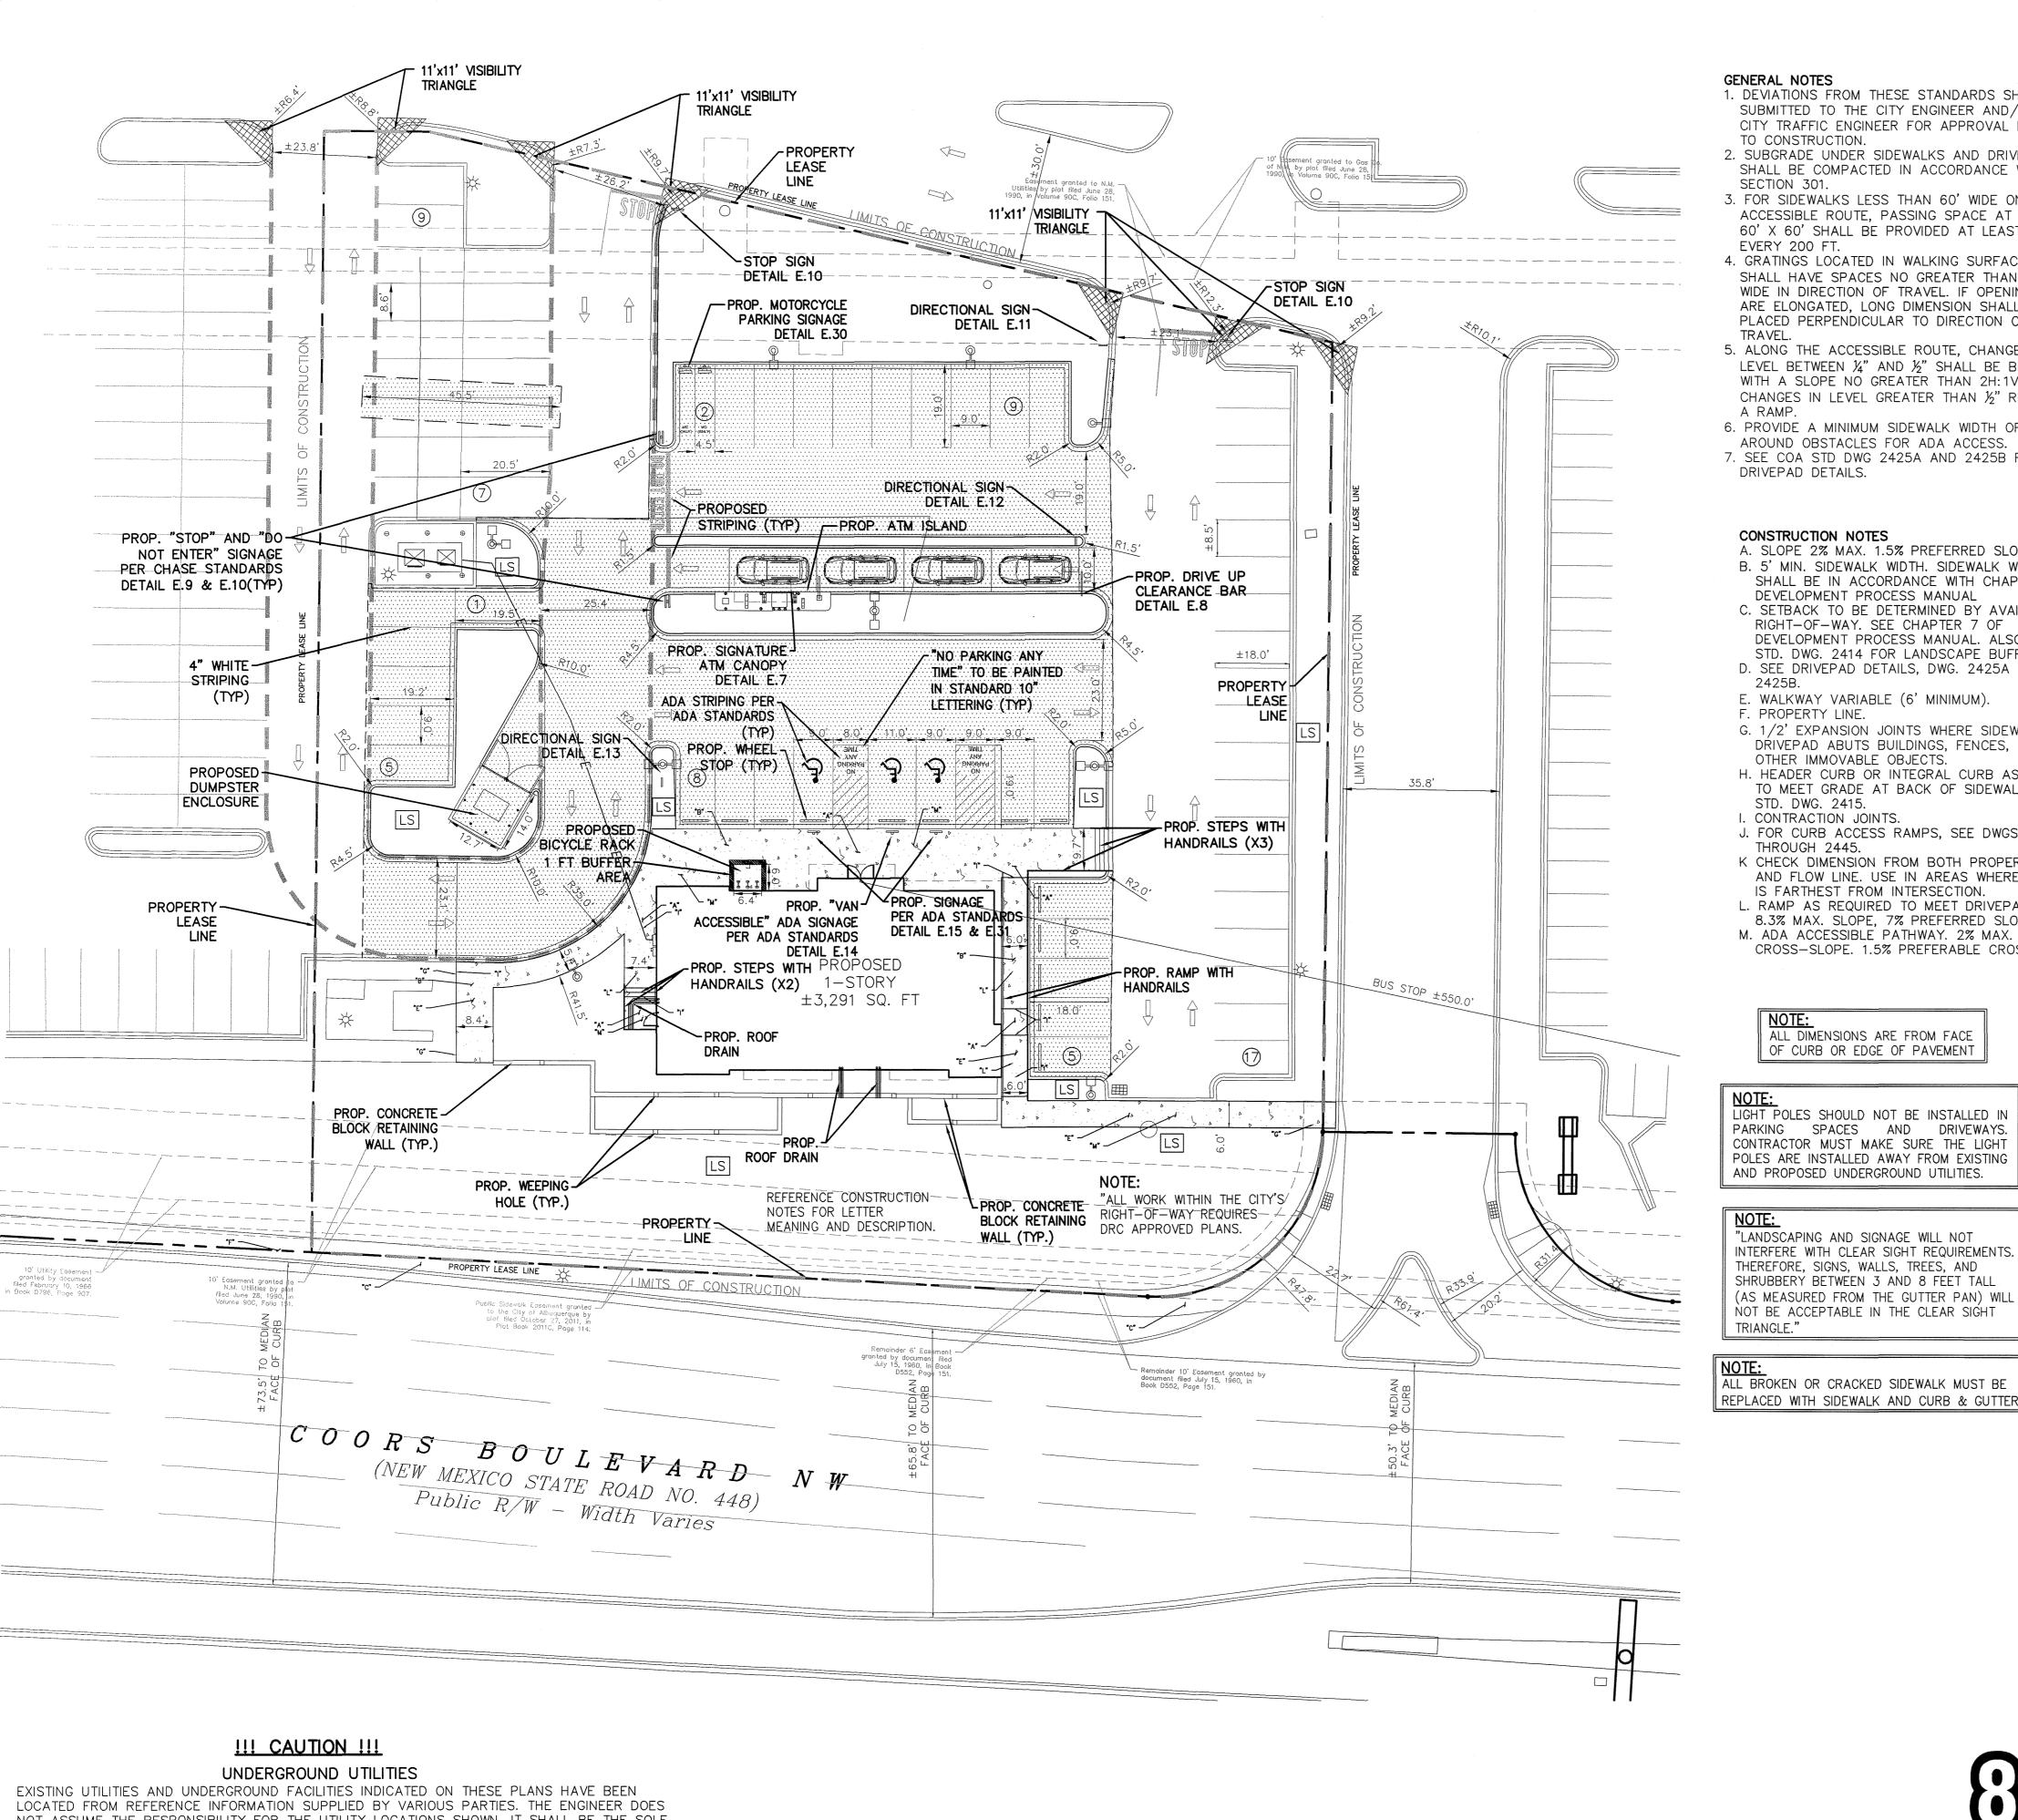

GENERAL NOTES

1. DEVIATIONS FROM THESE STANDARDS SHALL BE SUBMITTED TO THE CITY ENGINEER AND/OR CITY TRAFFIC ENGINEER FOR APPROVAL PRIOR TO CONSTRUCTION.

2. SUBGRADE UNDER SIDEWALKS AND DRIVEPADS SHALL BE COMPACTED IN ACCORDANCE WITH SECTION 301.

3. FOR SIDEWALKS LESS THAN 60' WIDE ON ACCESSIBLE ROUTE, PASSING SPACE AT LEAST 60' X 60' SHALL BE PROVIDED AT LEAST

EVERY 200 FT. 4. GRATINGS LOCATED IN WALKING SURFACE SHALL HAVE SPACES NO GREATER THAN 1/2" WIDE IN DIRECTION OF TRAVEL. IF OPENINGS ARE ELONGATED, LONG DIMENSION SHALL BE PLACED PERPENDICULAR TO DIRECTION OF TRAVEL.

5. ALONG THE ACCESSIBLE ROUTE, CHANGES IN LEVEL BETWEEN 1/4" AND 1/2" SHALL BE BEVELED WITH A SLOPE NO GREATER THAN 2H: 1V. CHANGES IN LEVEL GREATER THAN 1/2" REQUIRE A RAMP.

6. PROVIDE A MINIMUM SIDEWALK WIDTH OF 4' AROUND OBSTACLES FOR ADA ACCESS.

7. SEE COA STD DWG 2425A AND 2425B FOR DRIVEPAD DETAILS.

CONSTRUCTION NOTES

A. SLOPE 2% MAX. 1.5% PREFERRED SLOPE.

B. 5' MIN. SIDEWALK WIDTH. SIDEWALK WIDTH SHALL BE IN ACCORDANCE WITH CHAPTER 23 OF DEVELOPMENT PROCESS MANUAL

C. SETBACK TO BE DETERMINED BY AVAILABLE RIGHT-OF-WAY. SEE CHAPTER 7 OF DEVELOPMENT PROCESS MANUAL. ALSO SEE COA STD. DWG. 2414 FOR LANDSCAPE BUFFER.

D. SEE DRIVEPAD DETAILS, DWG. 2425A AND

E. WALKWAY VARIABLE (6' MINIMUM). F. PROPERTY LINE.

G. 1/2' EXPANSION JOINTS WHERE SIDEWALK OR DRIVEPAD ABUTS BUILDINGS, FENCES, WALLS OR OTHER IMMOVABLE OBJECTS

H. HEADER CURB OR INTEGRAL CURB AS REQUIRED TO MEET GRADE AT BACK OF SIDEWALK. SEE STD. DWG. 2415.

I. CONTRACTION JOINTS.

J. FOR CURB ACCESS RAMPS, SEE DWGS. 2440 THROUGH 2445.

K CHECK DIMENSION FROM BOTH PROPERTY LINE AND FLOW LINE, USE IN AREAS WHERE DRIVEPAD IS FARTHEST FROM INTERSECTION. L. RAMP AS REQUIRED TO MEET DRIVEPAD GRADE.

8.3% MAX. SLOPE. 7% PREFERRED SLOPE. M. ADA ACCESSIBLE PATHWAY. 2% MAX. CROSS-SLOPE. 1.5% PREFERABLE CROSS-SLOPE.

ALL DIMENSIONS ARE FROM FACE OF CURB OR EDGE OF PAVEMENT


LIGHT POLES SHOULD NOT BE INSTALLED IN PARKING SPACES AND DRIVEWAYS. CONTRACTOR MUST MAKE SURE THE LIGHT POLES ARE INSTALLED AWAY FROM EXISTING

"LANDSCAPING AND SIGNAGE WILL NOT INTERFERE WITH CLEAR SIGHT REQUIREMENTS. THEREFORE, SIGNS, WALLS, TREES, AND SHRUBBERY BETWEEN 3 AND 8 FEET TALL

ALL BROKEN OR CRACKED SIDEWALK MUST BE REPLACED WITH SIDEWALK AND CURB & GUTTER.



 EXISTING CURB - PROPOSED CURB

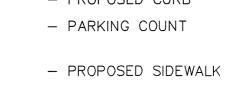




- PROPOSED SAWCUT

- PROPOSED LANDSCAPE AREA

- PROPOSED LIGHT POLE

LIMITS OF CONSTRUCTION

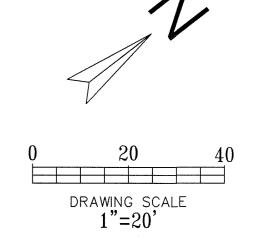

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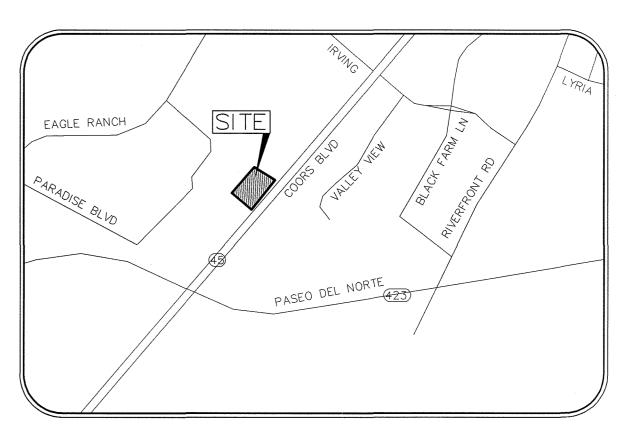
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SITE PLAN					
EXISTING ZONING: MX-M/MODERATE INTENSITY					
LAND USE:	FINANCIAL INSTITUTION				
LEASE ACREAGE:	1.334 ACRES (54,740 SF) 1.257 ACRES				
BUILDING FOOT PRINT (TOTAL):	±3,291 SQUARE FEET				
OPEN SPACE REQUIRED (25% OF LOT ACREAGE):	±13,685 SQUARE FEET				
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APPROX EX. IMPERVIOUS AREA:	±41,767 SQUARE FEET (76.3%)				
APPROX PROPOSED IMPERVIOUS AREA::	±38,388 SQUARE FEET (70.1%)				
PARKING REQUIRED (3 PER 1000 SF OF PROPOSED BUILDING):	10 SPACES				
PARKING PROVIDED:	61 SPACES				
ACCESSIBLE PARKING REQUIRED (1 ACCESSIBLE SPACE/25 STANDARD SPACE):	3 SPACES				
PARKING PROVIDED (ACCESSIBLE):	3 SPACES				
REQUIRED STACKING SPACES:	4 SPACES PER ATM				
PROVIDED STACKING SPACES:	4 SPACES PER ATM				
BICYCLE SPACE: REQUIRED/PROVIDED	4/5 SPACES				
MOTORCYCLE SPACES: REQUIRED/PROVIDED	1/2 SPACES				



VICINITY MAP
ZONE ATLAS MAP C-13 NTS

TRAFFIC CIRCULATION LAYOUT APPROVED MP----P.E. 3/18/2021

THE BENCHMARKS ARE PROVIDED BASED ON THE ELEVATIONS PROVIDED BY SURVTEK CONSULTING SURVEYORS

CALL NM ONE-CALL

SYSTEM SEVEN (7) DAYS

PRIOR TO ANY EXCAVATION

ALBUQUERQUE CONTROL SURVEY MONUMENT "DOUGLAS" NEW MEXICO STATE PLANE COORDINATES CENTRAL ZONE, NAD 83 AS PUBLISHED: N=1505417.495 E=1520286.421 GROUND TO GRID FACTOR=0.999682452, DELTA ALPHA = $-00^{\circ}13'52.53''$ ELEVATION=4975.078 NAVD88

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PLOT DATE 03/17/21

DRAWING SCALE 1" = 20'


PROJECT NUMBER CDC20021


SHEET NUMBER

NOT ASSUME THE RESPONSIBILITY FOR THE UTILITY LOCATIONS SHOWN, IT SHALL BE THE SOLE RESPONSIBILITY OF THE CONTRACTOR(S) TO VERIFY THE HORIZONTALLY AND VERTICALLY LOCATION OF ALL UTILITIES AND UNDERGROUND FACILITIES PRIOR TO CONSTRUCTION, TO TAKE PRECAUTIONS IN ORDER TO PROTECT ALL FACILITIES ENCOUNTERED AND NOTIFY THE ENGINEER OF ALL CONFLICTS OF THE WORK WITH EXISTING FACILITIES. THE CONTRACTOR SHALL PROTECT AND MAINTAIN ALL UTILITIES FROM DAMAGE DURING CONSTRUCTION. ANY DAMAGE BY THE CONTRACTOR TO UTILITIES SHALL BE REPAIRED OR REPLACED BY THE CONTRACTOR AT THEIR

OWN EXPENSE. CALL: NEW MEXICO ONE CALL @ NM 811 AT LEAST 7 DAYS PRIOR TO CONSTRUCTION.

\\SERVER-PC\SERVER\2020 CDC PROJECTS\CDC20021 - COORS BLVD AND PASEO\PLANS\TRAFFIC CIRCULATION PLAN CDC20021.DWG

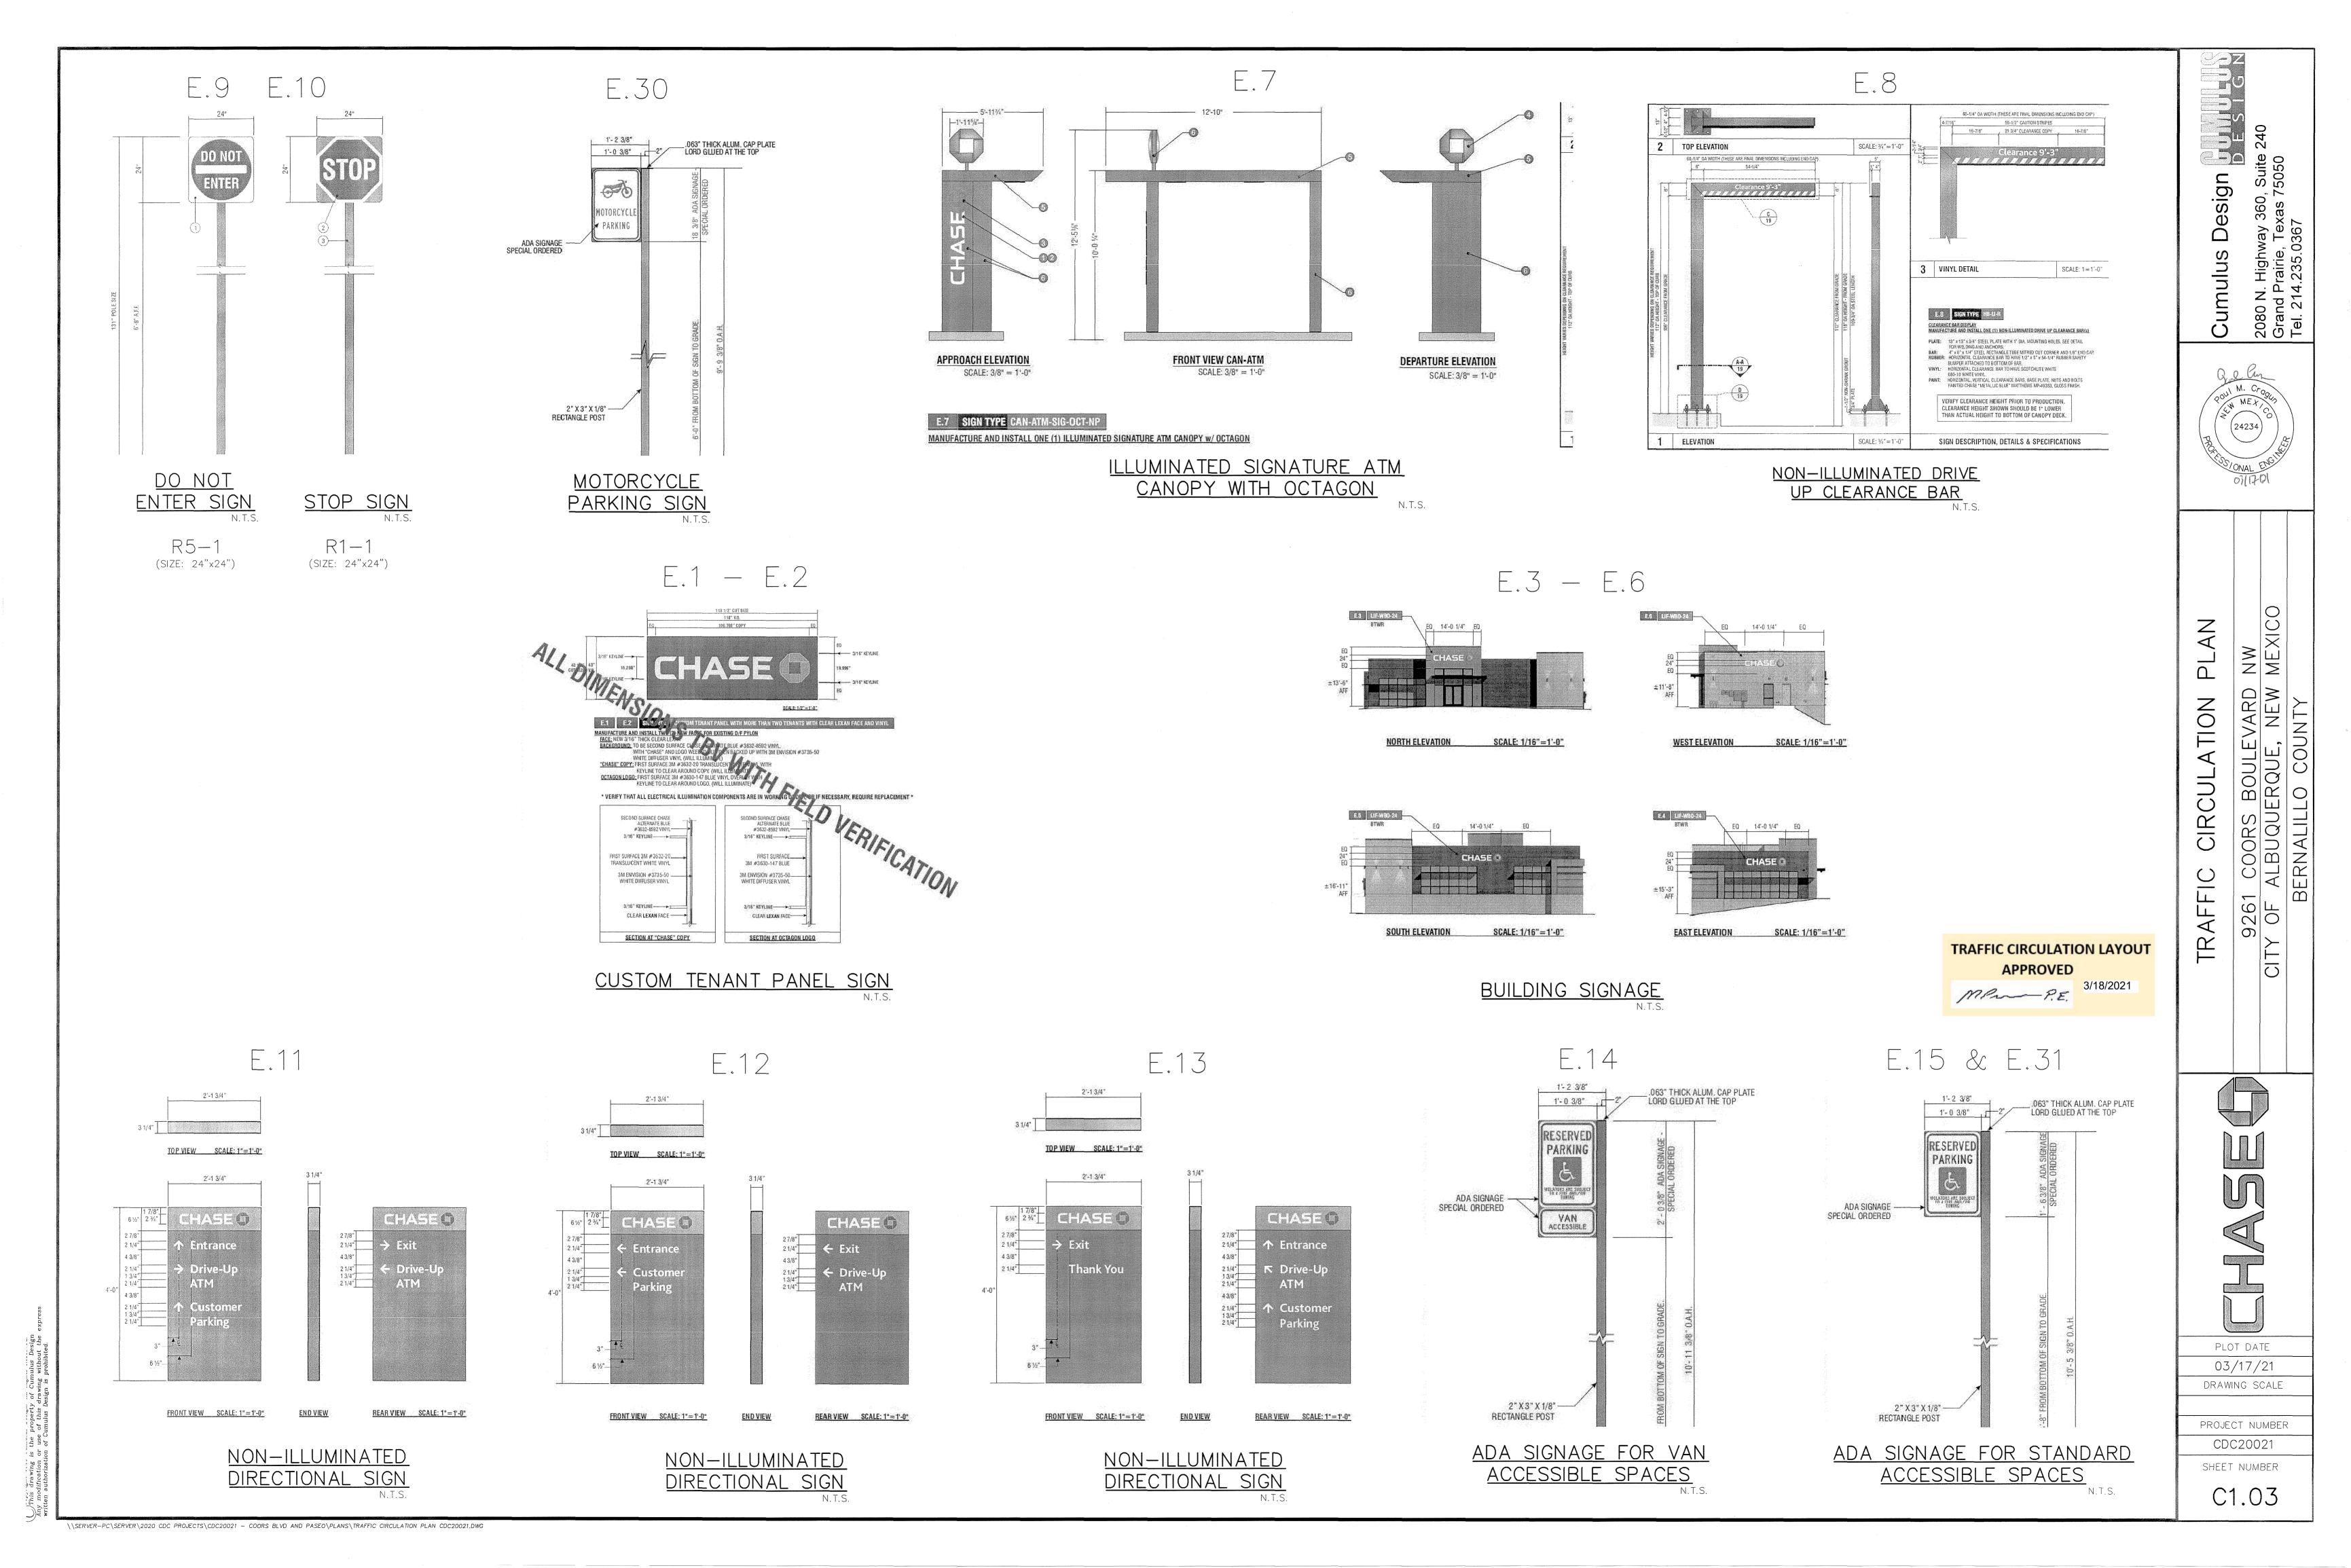

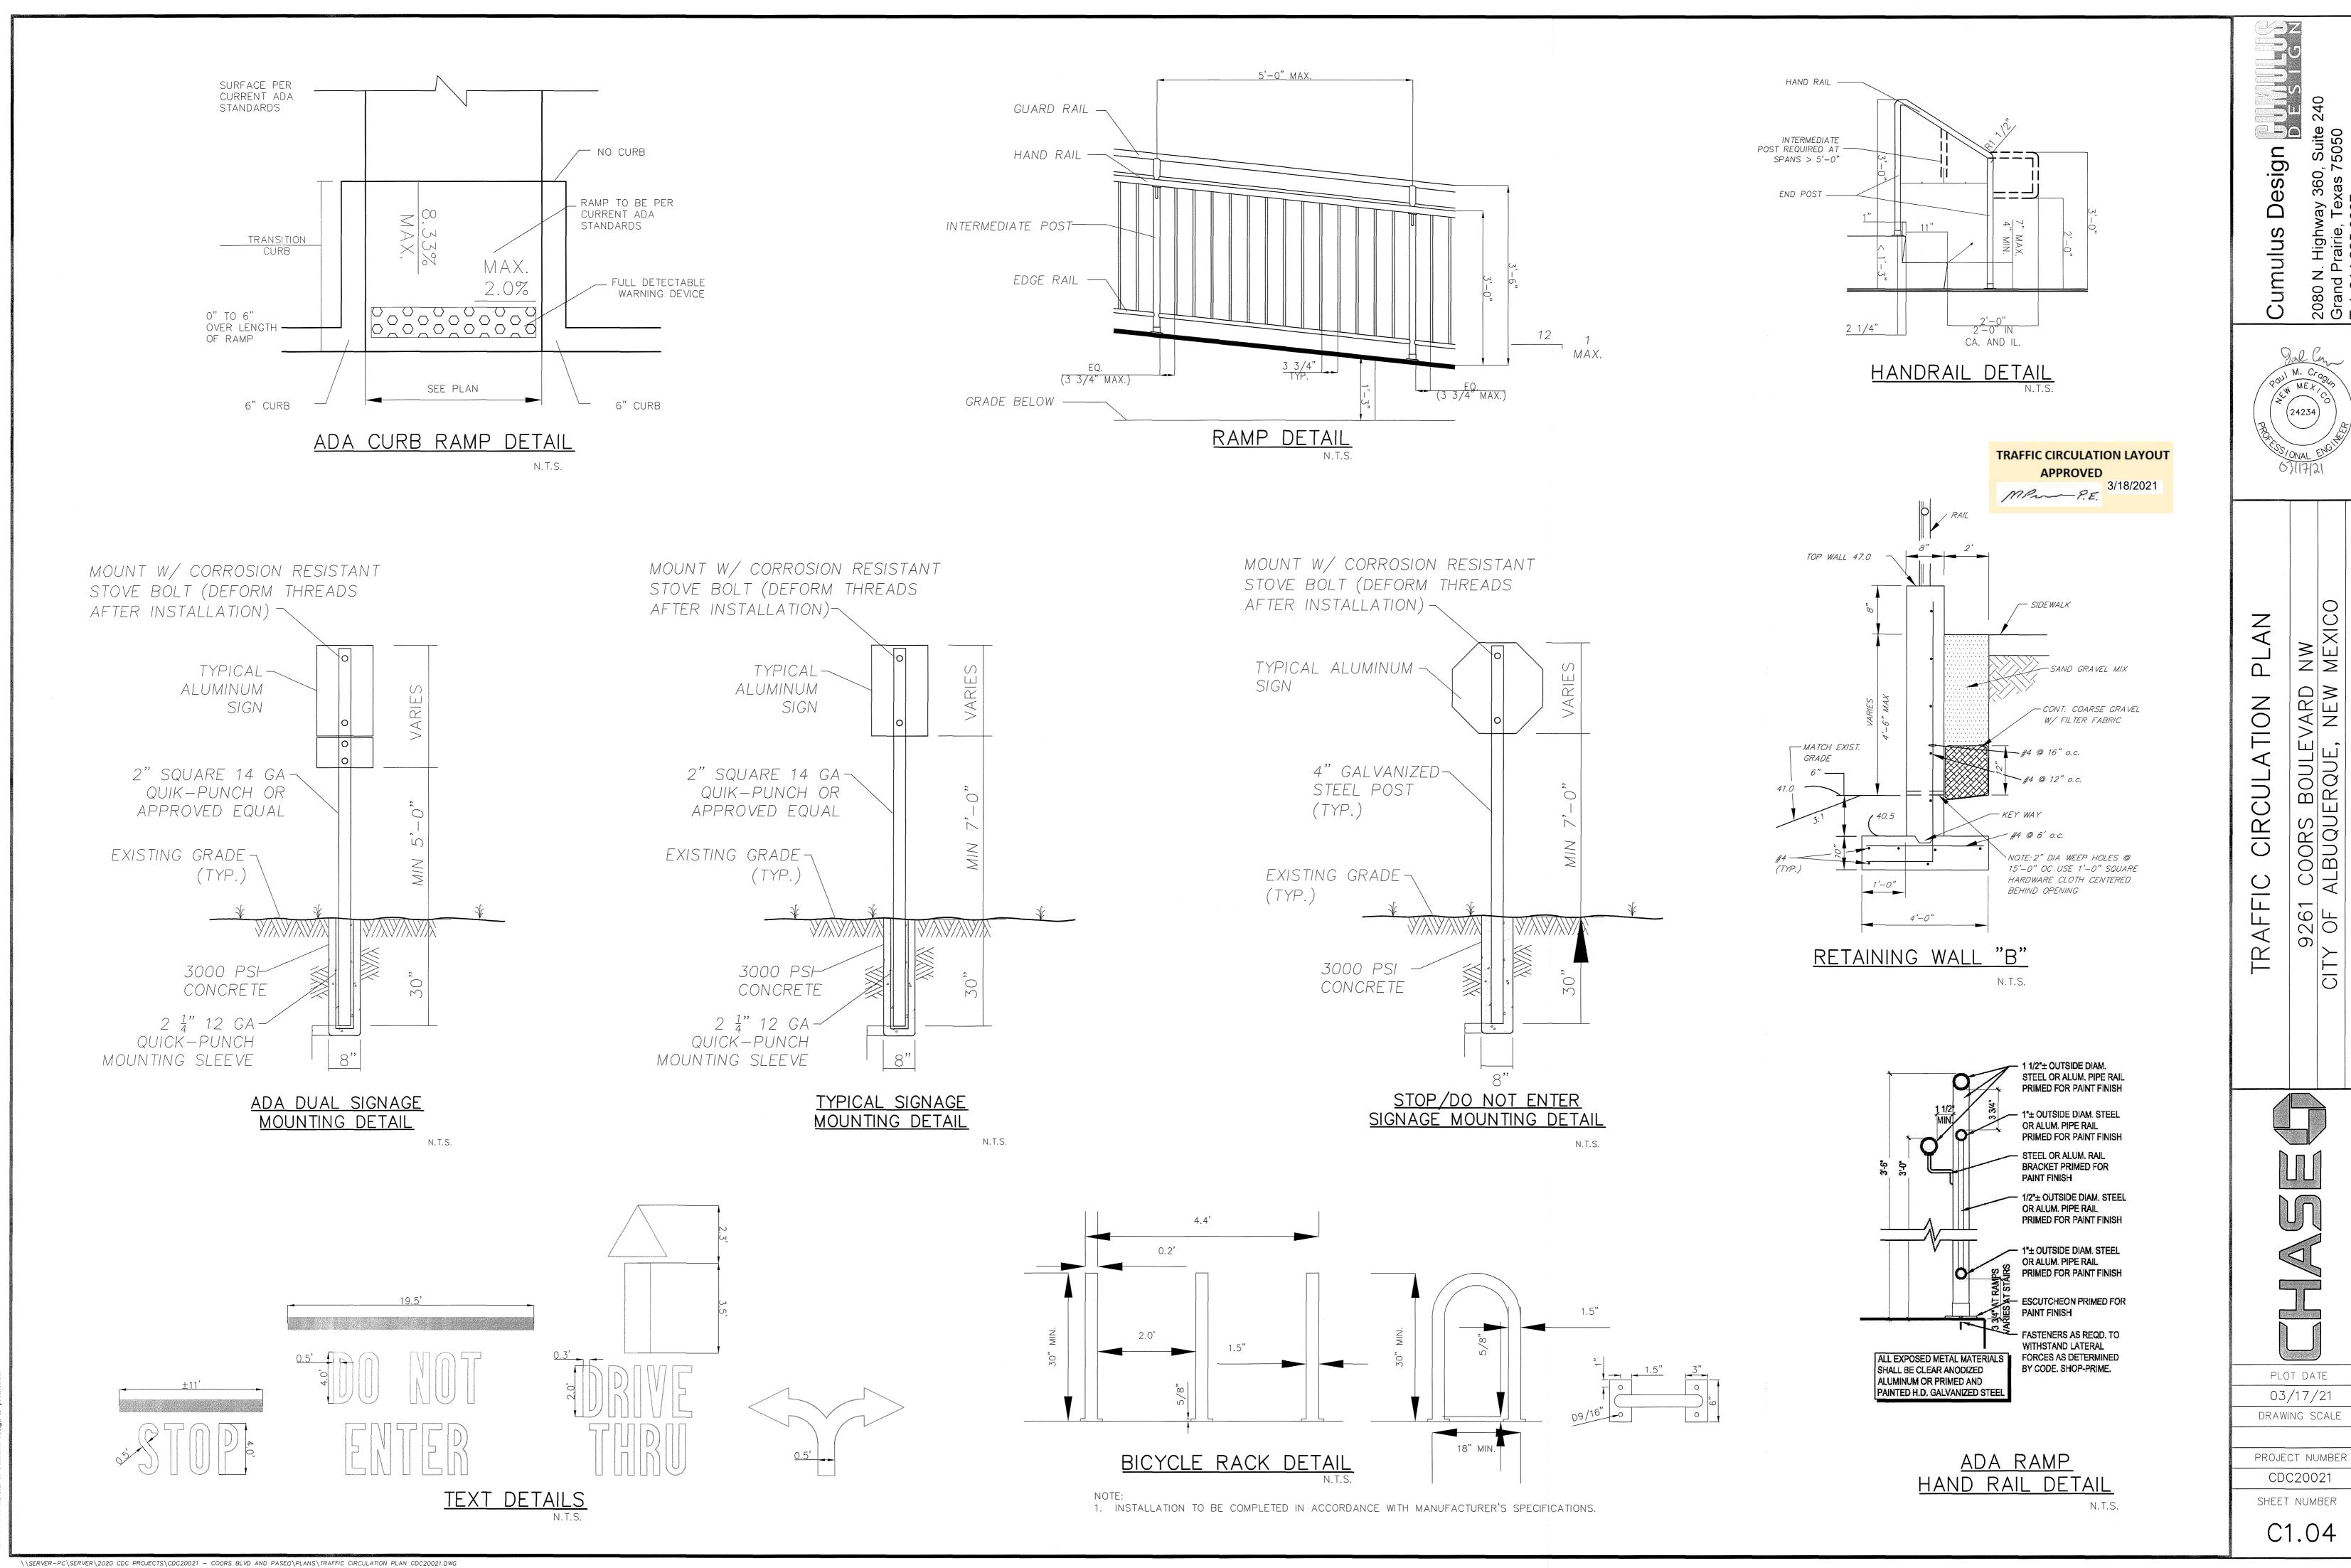


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NW MEXICO

COORS BOULEVARD ALBUQUERQUE, NEW ERNALILLO COUNTY

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<u>LEGEND</u>

EXISTING CURB

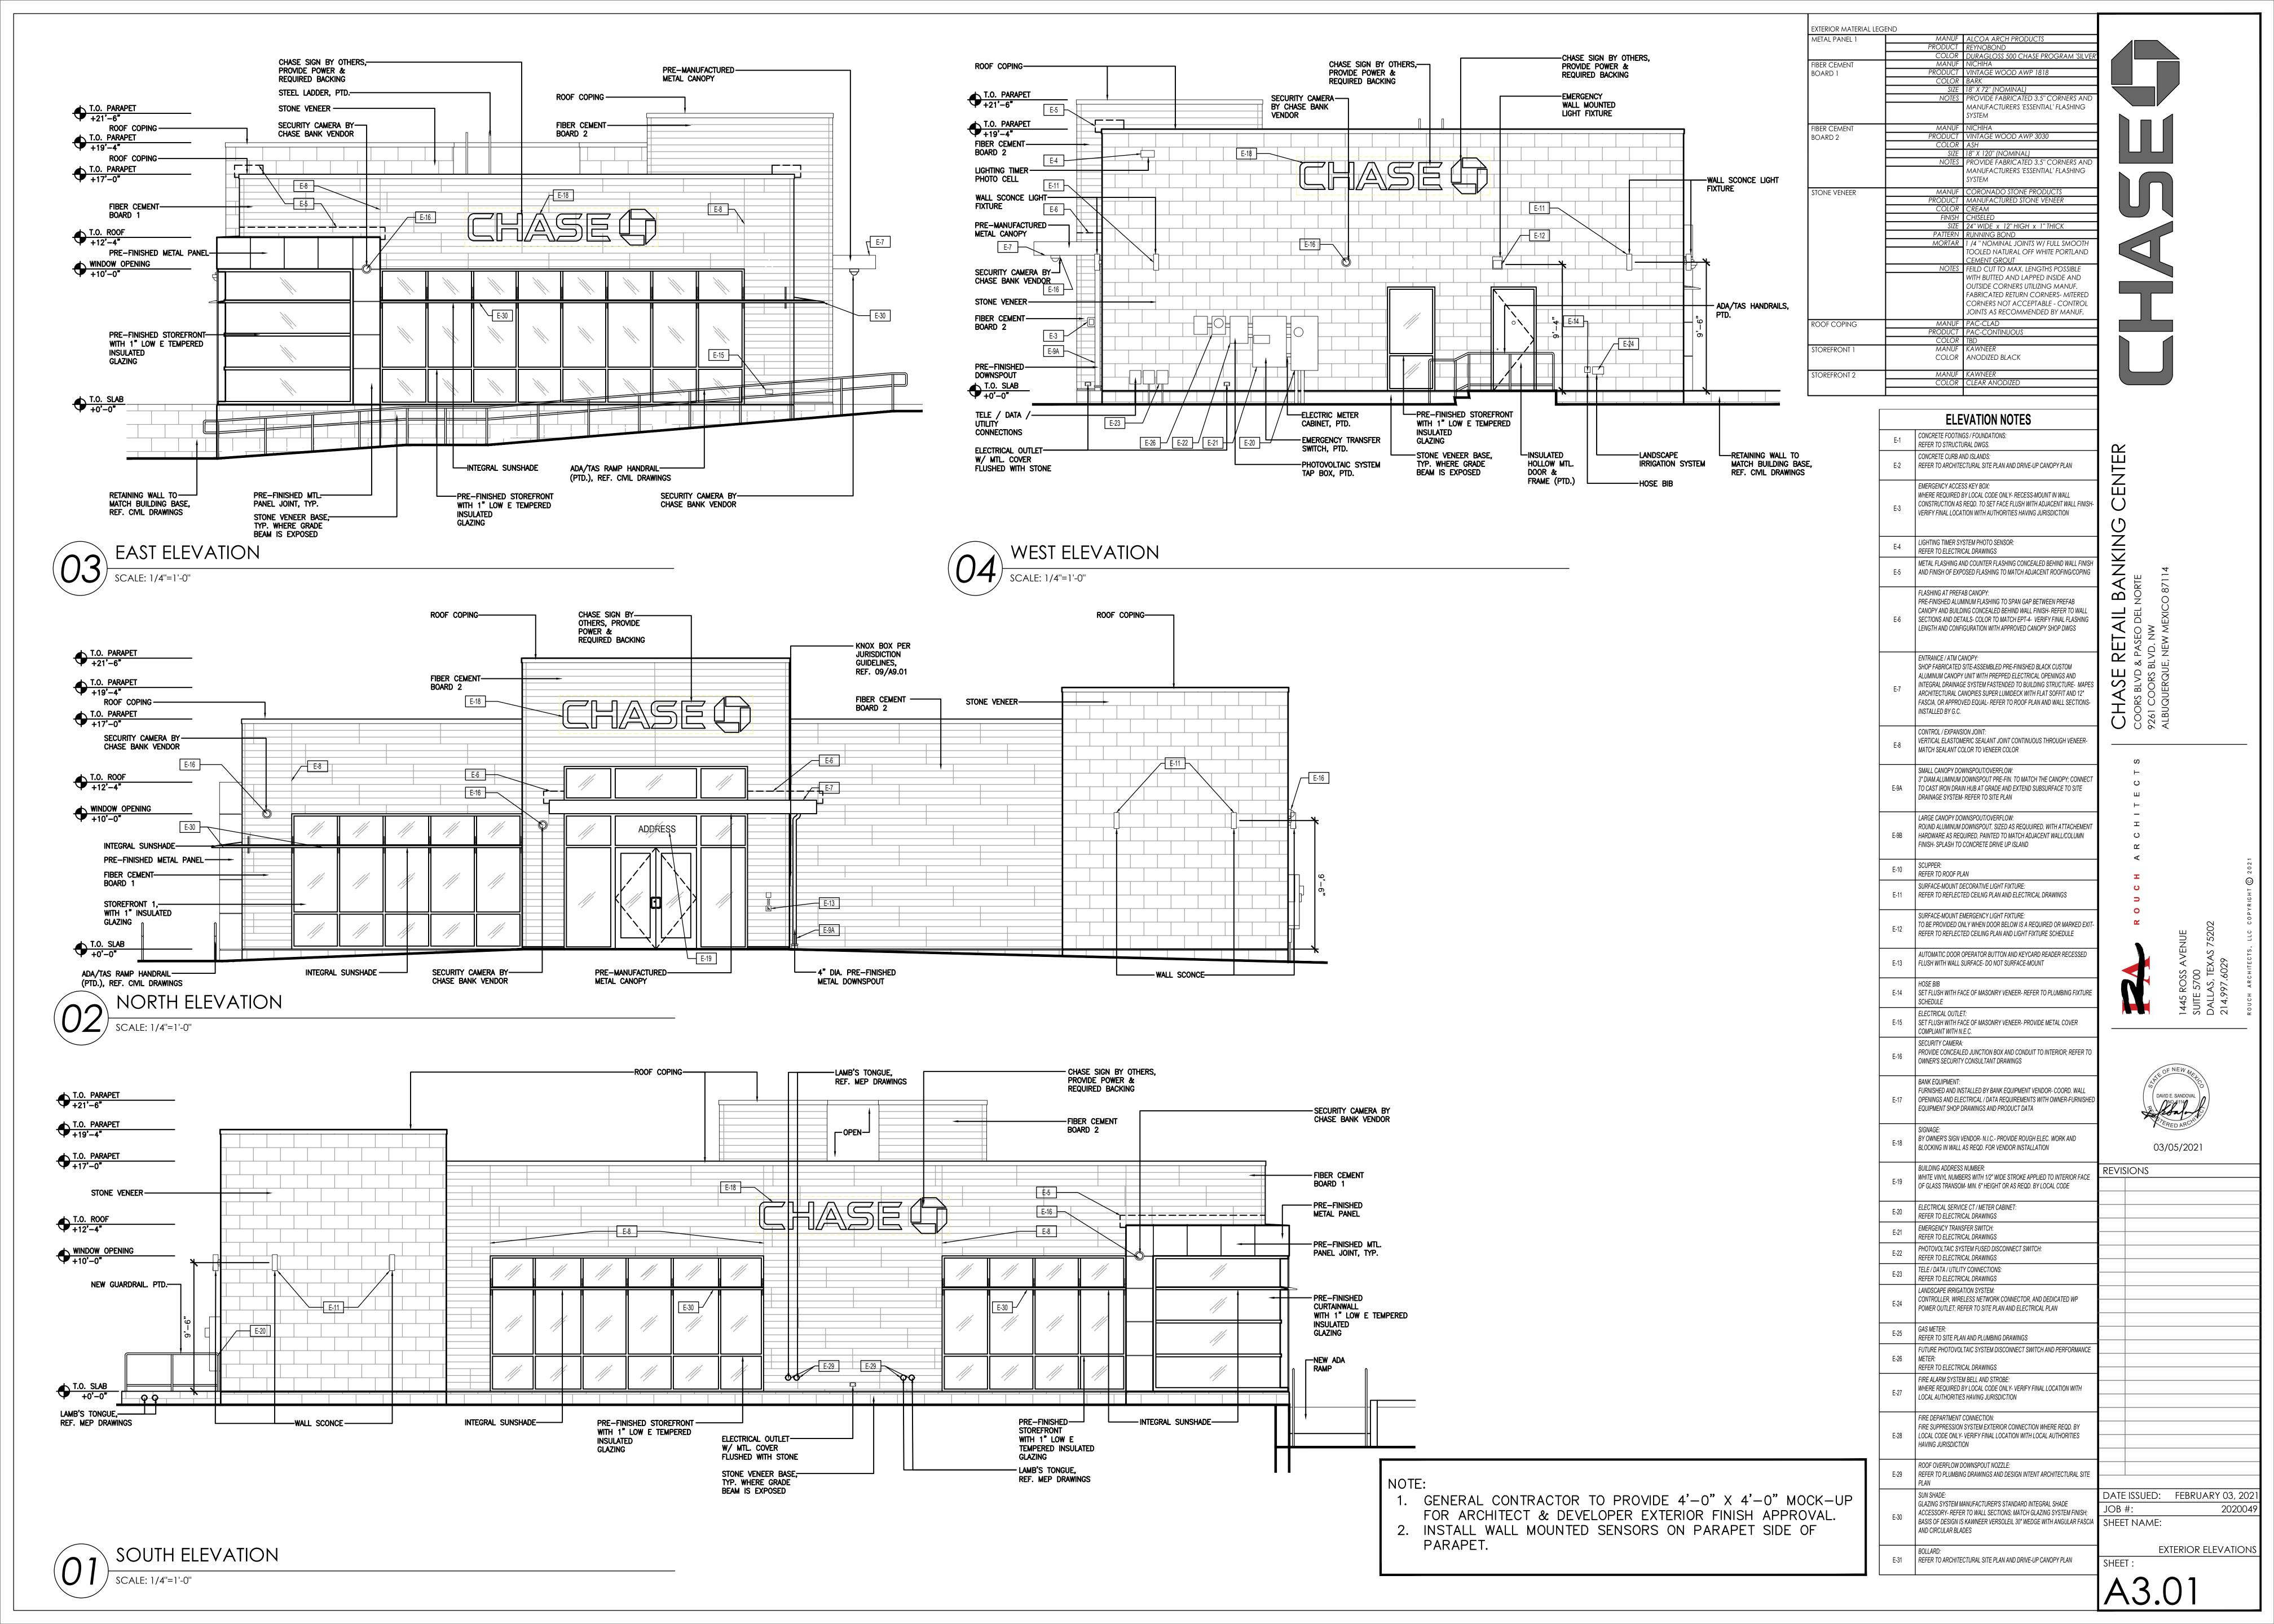 EXISTING CONTOUR - PROPOSED CONTOUR

- EXISTING SPOT ELEVATION

- PROPOSED SPOT ELEVATION

- DIRECTIONAL FLOW ARROW PROPOSED VALLEY

— R— — PROPOSED RIDGE



DRAWING SCALE 1"=20'

±4.3% SLOPE DOWN TOWARDS COORS BOULEVARD NW. AT APPROXIMATELY 40 FEET FROM COORS BOULEVARD RIGHT-OF-WAY THE SLOPE INCREASES TO ±26%. THE SOUTHWESTERN PORTION OF THE EXISTING DEVELOPMENT THE PAVEMENT SLOPES TOWARDS THE SOUTH-WEST TOWARDS AN

TOPOGRAPHY. THE PARKING LOT LOCATED IN THE NORTHERN PORTION OF THE PROPOSED BUILDING WILL RETAIN THE EXISTING SLOPE DOWN TO THE SOUTH-EAST. THE WESTERN PORTION WILL SLOPE TO THE SOUTH-WEST AND DRAIN TOWARDS THE EXISTING DETENTION POND LOCATED ±190 FT.

THE EXISTING SITE TOPOGRAPHY WITHIN THE PROPERTY HAS A EXISTING ±51,000 CU. FT. DETENTION POND.

THE PROPOSED DEVELOPMENT WILL UTILIZE THE EXISTING SITE

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THE BENCHMARKS ARE PROVIDED BASED ON THE ELEVATIONS PROVIDED BY SURVTEK CONSULTING SURVEYORS

City of Albuquerque Planning Department
Development Review Services

HYDROLOGY SECTION

APPROVED

03/18/21 C13D035

CENTRAL ZONE, NAD 83 AS PUBLISHED: N=1505417.495 E=1520286.421 GROUND TO GRID FACTOR=0.999682452, DELTA ALPHA = - 00°13'52.53" ELEVATION=4975.078 NAVD88

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!!! CAUTION !!!

UNDERGROUND UTILITIES

NOT ASSUME THE RESPONSIBILITY FOR THE UTILITY LOCATIONS SHOWN. IT SHALL BE THE SOLE RESPONSIBILITY OF THE CONTRACTOR(S) TO VERIFY THE HORIZONTALLY AND VERTICALLY LOCATION OF ALL UTILITIES AND UNDÈRGROUND FACILITIES PRIOR TO CONSTRUCTION, TO TAKE PRECAUTIONS IN ORDER TO PROTECT ALL FACILITIES ENCOUNTERED AND NOTIFY THE ENGINEER OF ALL CONFLICTS OF THE WORK WITH EXISTING FACILITIES. THE CONTRACTOR SHALL PROTECT AND MAINTAIN ALL UTILITIES FROM DAMAGE DURING CONSTRUCTION. ANY DAMAGE BY THE CONTRACTOR TO UTILITIES SHALL BE REPAIRED OR REPLACED BY THE CONTRACTOR AT THEIR

CALL: NEW MEXICO ONE CALL @ NM 811 AT LEAST 7 DAYS PRIOR TO CONSTRUCTION.

\\SERVER-PC\SERVER\2020 CDC PROJECTS\CDC20021 - COORS BLVD AND PASEO\PLANS\GRADING PLAN CDC20021.DWG

OWN EXPENSE.

PLOT DATE 02/23/21 DRAWING SCALE

1" = 20'

PROJECT NUMBER

CDC20021

SHEET NUMBER

C5.01

EXISTING UTILITIES AND UNDERGROUND FACILITIES INDICATED ON THESE PLANS HAVE BEEN LOCATED FROM REFERENCE INFORMATION SUPPLIED BY VARIOUS PARTIES. THE ENGINEER DOES

CALL NM ONE-CALL

SYSTEM SEVEN (7) DAYS

PRIOR TO ANY EXCAVATION

CONTRACTOR'S EXPENSE. 5. CONTRACTOR SHALL VERIFY ALL EXISTING INVERTS AND RIM ELEVATIONS PRIOR TO CONSTRUCTION. IF CONFLICTS EXIST, THE CONTRACTOR IS TO CONTACT ENGINEER.

SPECIFICATIONS.

GRADING NOTES:

PERMITTING AUTHORITIES.

6. BENCHMARKS HAVE BEEN PROVIDED AS A REFERENCE. IT IS THE CONTRACTOR'S RESPONSIBILITY TO LOCATE, VERIFY, AND/OR ESTABLISH A BENCHMARKS PRIOR TO CONSTRUCTION. IT IS THE CONTRACTOR'S

. ALL CONSTRUCTION TO BE IN ACCORDANCE WITH THESE PLANS, CITY

STANDARDS, SPECIFICATIONS FOR PUBLIC WORKS CONSTRUCTION.

2. PRIOR TO STARTING CONSTRUCTION, THE CONTRACTOR SHALL MAKE

NEW MEXICO DEPARTMENT OF TRANSPORTATION RULES AND

CERTAIN THAT ALL REQUIRED PERMITS AND APPROVALS HAVE BEEN OBTAINED. NO CONSTRUCTION OR FABRICATION SHALL BEGIN UNTIL THE CONTRACTOR HAS RECEIVED AND THOROUGHLY REVIEWED ALL PLANS AND OTHER DOCUMENTS APPROVED BY ALL RESPONSIBLE PARTIES OF THE

3. BARRICADING, TRAFFIC CONTROL, AND PROJECT SIGNS SHALL CONFORM TO

4. THE LOCATION OF ALL EXISTING UTILITIES SHOWN ARE BASED ON FIELD

UTILITY COMPANIES TO LOCATE THEIR UTILITIES PRIOR TO STARTING

SURVEYS AND LOCAL UTILITY COMPANY RECORDS. IT SHALL BE THE

CONTRACTOR'S FULL AND SOLE RESPONSIBILITY TO CONTACT THE VARIOUS

CONSTRUCTION. ANY DAMAGE TO EXISTING UTILITIES IS TO BE REPAIRED AT

RESPONSIBILITY TO PRESERVE SURVEY STAKES AND MARKERS FOR THE DURATION OF THE PROJECT. IF ANY CONSTRUCTION STAKES OR MARKERS ARE LOST OR DISTURBED AND ARE NEEDED TO BE REPLACED, SUCH REPLACEMENT SHALL BE BY THE SURVEYOR AT THE EXPENSE OF THE CONTRACTOR.

7. EROSION CONTROLS SHALL BE IN PLACE PRIOR TO THE DISTURBANCE OF ANY EXISTING SURFACE.

8. CONTRACTOR SHALL BE RESPONSIBLE FOR MAINTAINING TRENCH SAFETY REQUIREMENTS IN ACCORDANCE WITH CITY STANDARDS, NEW MEXICO STATE LAW, AND O.S.H.A. STANDARDS FOR ALL EXCAVATION.

9. ALL EARTHWORK OPERATIONS SHALL CONFORM TO THE RECOMMENDATIONS PER THE GEOTECHNICAL REPORT.

10. DRAINAGE SHOULD BE MAINTAINED AWAY FROM THE FOUNDATIONS, BOTH DURING AND AFTER CONSTRUCTION.

11. ALL SIDEWALKS AND ACCESSIBLE ROUTE (INCLUDING HATCHED AREA ACROSS DRIVES) SHALL MAINTAIN A 2% MAXIMUM CROSS SLOPE AND A MAXIMUM 5% IN THE DIRECTION OF PEDESTRIAN TRAVEL.

12. SLOPE IN HANDICAP PARKING AREAS SHALL NOT EXCEED 2% IN ANY DIRECTION.

13. PROVIDE "FLAT" LANDINGS AT TOP AND BOTTOM OF ALL RAMPS. THESE "FLAT" AREAS SHALL BE 5' LONG AND THE SLOPE SHALL NOT EXCEED 2% IN ANY DIRECTION.

14. IT IS THE RESPONSIBILITY OF THE CONTRACTOR TO PROVIDE POSITIVE DRAINAGE AWAY FROM BUILDING AND PARKING AT ALL TIMES.

15. SITE GRADING SHALL BE PERFORMED IN A MANNER TO DIRECT WATER AS INDICATED. SURFACE WATER SHALL NOT BE RELEASED ONTO ADJACENT PRIVATE PROPERTY.

PR-2021-005508_SI-2021-00809_Site_Plan_Ap proved_7-28-21

Final Audit Report 2021-09-01

Created: 2021-08-26

By: Jay Rodenbeck (jrodenbeck@cabq.gov)

Status: Signed

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