

EXISTING 5' PNM & M.S.T.&T. CO. EASEMENT

(50' R/W)

Summer Avenue, N.E.

EXISTING 10' PUBLIC UTILITY EASEMENT


438.98'


EXISTING PEDESTRIAN

CONNECTION

8200 Mountain Road NE Albuquerque, NM 87110

CONSENSUS PLANNING, INC.
Planning / Landscape Architecture 302 Eighth Street NW Albuquerque, NM 87102 (505) 764-9801 Fax 842-5495 e-mail: cp@consensusplanning.com

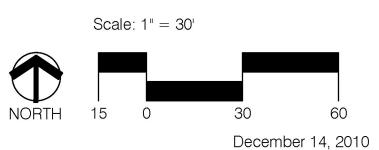

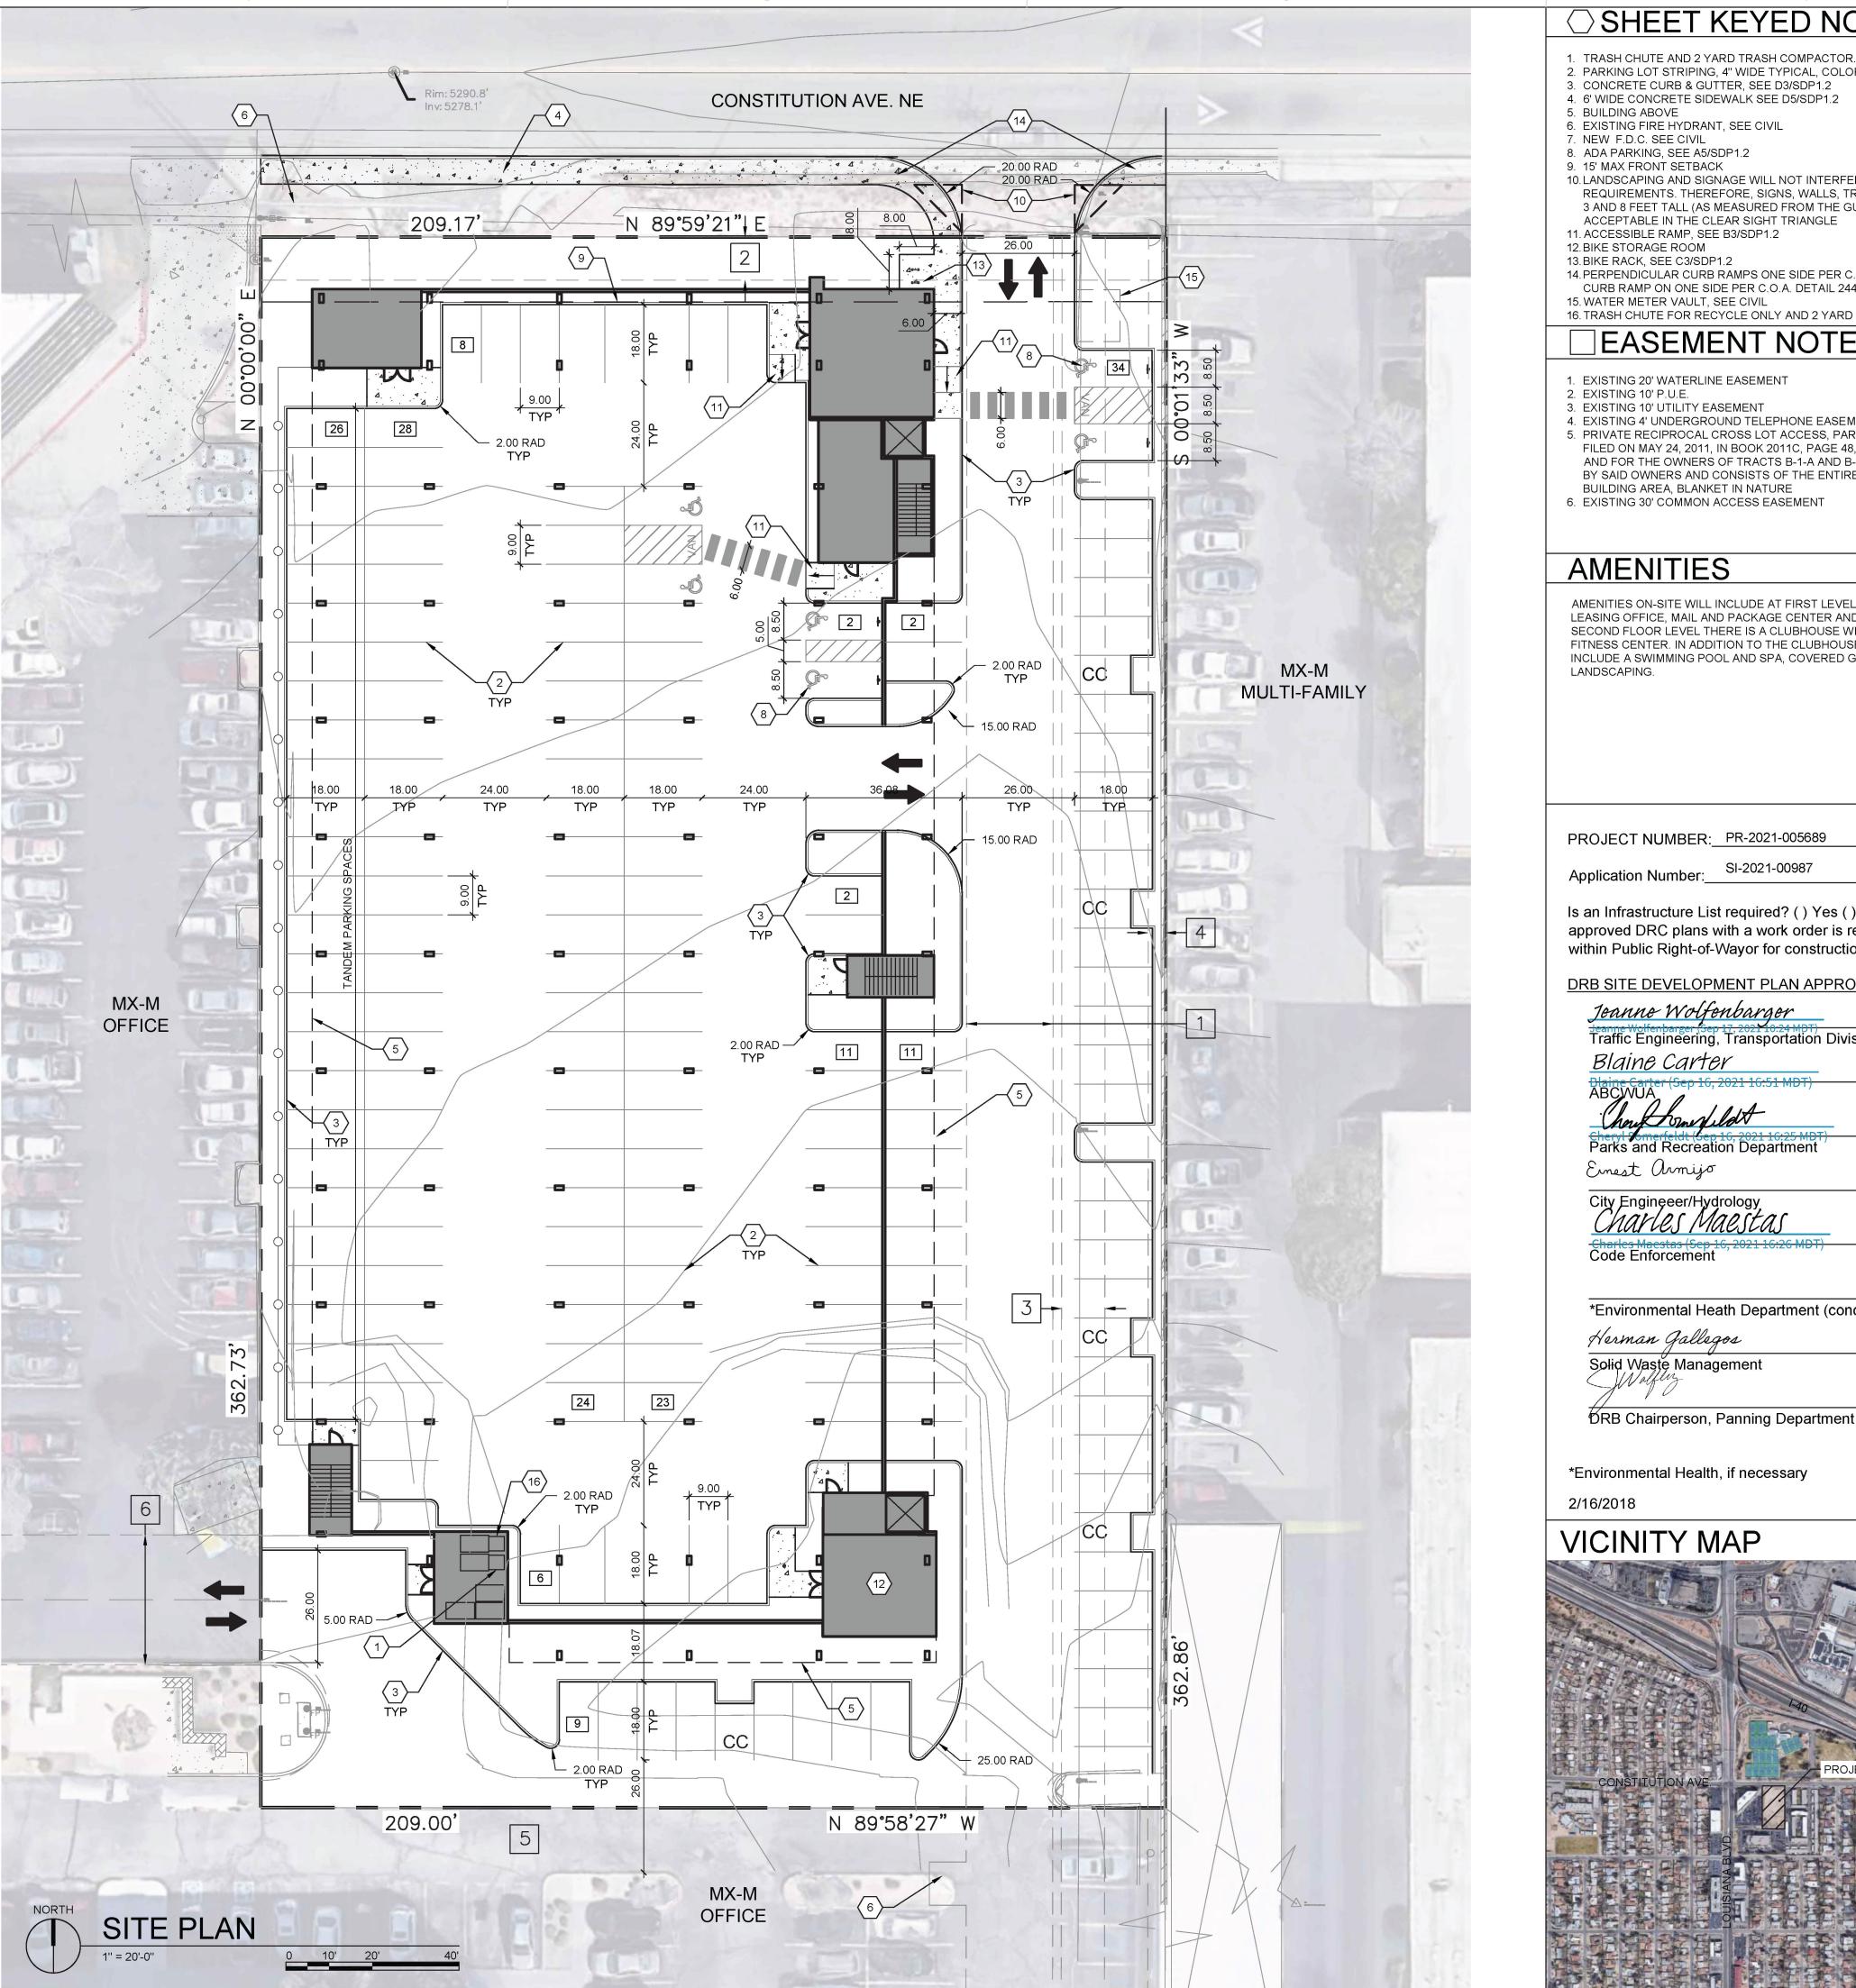

SHEET KEYED NOTES

- TRASH CHUTE AND 2 YARD TRASH COMPACTOR.
- 2. PARKING LOT STRIPING, 4" WIDE TYPICAL, COLOR: WHITE 3. CONCRETE CURB & GUTTER, SEE D3/SDP1.2
- 4. 6' WIDE CONCRETE SIDEWALK SEE D5/SDP1.2
- 5. BUILDING ABOVE
- 6. EXISTING FIRE HYDRANT, SEE CIVIL
- 7. NEW F.D.C. SEE CIVIL
- 3. ADA PARKING, SEE A5/SDP1.2
- 9. 15' MAX FRONT SETBACK 10. LANDSCAPING AND SIGNAGE WILL NOT INTERFERE WITH CLEAR SIGHT
- REQUIREMENTS. THEREFORE, SIGNS, WALLS, TREES, AND SHRUBBERY BETWEEN 3 AND 8 FEET TALL (AS MEASURED FROM THE GUTTER PAN) WILL NOT BE ACCEPTABLE IN THE CLEAR SIGHT TRIANGLE
- 11. ACCESSIBLE RAMP, SEE B3/SDP1.2 12. BIKE STORAGE ROOM
- 14. PERPENDICULAR CURB RAMPS ONE SIDE PER C.O.A. DETAIL 2441 AND PARALLEL CURB RAMP ON ONE SIDE PER C.O.A. DETAIL 2443.

15. WATER METER VAULT, SEE CIVIL 16. TRASH CHUTE FOR RECYCLE ONLY AND 2 YARD COMPACTOR.

EASEMENT NOTES

- 1. EXISTING 20' WATERLINE EASEMENT
- 2. EXISTING 10' P.U.E.
- 3. EXISTING 10' UTILITY EASEMENT 4. EXISTING 4' UNDERGROUND TELEPHONE EASEMENT
- 5. PRIVATE RECIPROCAL CROSS LOT ACCESS, PARKING, AND DRAINAGE EASEMENT FILED ON MAY 24, 2011, IN BOOK 2011C, PAGE 48, FOR THE BENEFIT AND USE BY AND FOR THE OWNERS OF TRACTS B-1-A AND B-1-B. AND IS TO BE MAINTAINED BY SAID OWNERS AND CONSISTS OF THE ENTIRE PARCEL EXCLUSIVE OF THE
- BUILDING AREA, BLANKET IN NATURE 6. EXISTING 30' COMMON ACCESS EASEMENT

AMENITIES

AMENITIES ON-SITE WILL INCLUDE AT FIRST LEVEL COVERED PARKING GARAGE, LEASING OFFICE, MAIL AND PACKAGE CENTER AND BIKE STORAGE ROOM. AT SECOND FLOOR LEVEL THERE IS A CLUBHOUSE WITH GATHERING SPACE AND FITNESS CENTER. IN ADDITION TO THE CLUBHOUSE, OUTDOOR AMENITIES INCLUDE A SWIMMING POOL AND SPA, COVERED GATHERING AREAS AND

PROJECT NUMBER: PR-2021-005689

SI-2021-00987 Application Number:

Is an Infrastructure List required? () Yes () No If yes, then a set of approved DRC plans with a work order is required for any construction within Public Right-of-Wayor for construction of public improvements.


DRB SITE DEVELOPMENT PLAN APPROVAL:

January Walfardson, Com 17, 202 MADT	
Jeanne Wolfenbarger (Sep 17, 2021/10:24 MDT) Traffic Engineering, Transportation Division	Date
Blaine Carter	Sep 16, 202
Blaine Carter (Sep 16, 2021 16:51 MDT) ABCWUA	Date
Charle transfeld	Sep 16, 202
Cheryl Somerfeldt (Sep 16, 2021 16:25 MDT) Parks and Recreation Department	Date
Einest Armijo	Sep 16, 202
City Engineeer/Hydrology	Date
Charles Maestas	Sep 16, 202
Charles Maestas (Sep. 16, 2021 16:26 MDT) Code Enforcement	Date
*Environmental Heath Department (conditional)	Date
Herman Gallegos	09-15-21

*Environmental Health, if necessary

2/16/2018

VICINITY MAP

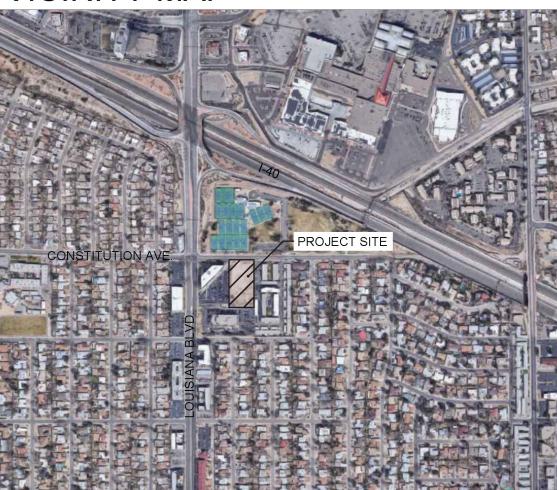

GENERAL NOTES

- A. DIMENSIONS ARE TO FACE OF CURB, OR WALL, OR EDGE OF PAVEMENT UNLESS OTHERWISE NOTED.
- D. SITE PLAN SHALL COMPLY WITH LOCAL, STATE AND FEDERAL ADA STANDARDS & GUIDELINES, INCLUDING THE INTERNATIONAL FIRE CODE (IFC) 2015. E. CURBS AND ACCESSIBLE RAMPS WILL BE DESIGNED AND BUILT ACCORDING TO THI
- CITY OF ALBUQUERQUE STANDARDS. ELIGHT FIXTURES AND DESIGN SHALL COMPLY WITH THE CITY OF ALBUQUERQUE
- INTEGRATED DEVELOPMENT ORDINANCE (IDO): SECTION 14-16-5-8 OUTDOOR
- G. STREETS, PARKING SPACES AND ASSOCIATED DRIVES TO BE ASPHALT UNLESS NOTED OTHERWISE.
- H. LANDSCAPE AND SIGNAGE WILL NOT INTERFERE WITH CLEAR SIGHT REQUIREMENTS. SIGNS, WALLS AND PLANTING BETWEEN 3 FEET AND 8 FEET TALL (AS MEASURED FROM THE GUTTER PAN) WILL NOT BE PERMITTED IN THE CLEAR
- ALL PUBLIC INFRASTRUCTURE LOCATED WITHIN CITY RIGHT-OF-WAY SHALL BE INCLUDED IN A PUBLIC WORK ORDER.

PROJECT DATA

IDO - MIXED USE - MODERATE INTENSITY ZONING DISTRICT (MX-M)

LANDUSE: MULTIFAMILY RESIDENTIAL **PLANNING CONTEXT:**

SITE IS WITHIN THE UPTOWN URBAN CENTER

PROJECT SITE IS WITHIN A MAJOR TRANSIT CORRIDOR (LOUISIANA BOULEVARD). BUS ROUTE 12 IS ALONG CONSTITUTION, WEST OF LOUISIANA BOULEVARD. BUS ROUTE 157 IS ALONG LOUISIANA. A BUS STOP IS LOCATED APPROXIMATELY 255 FEET FROM THE SUBJECT SITE AT THE LOUISIANA/CONSTITUTION INTERSECTION.

A BIKE ROUTE IS WITHIN CONSTITUTION AVENUE EAST OF LOUISIANA BOULEVARD AND BIKE LANES ARE WITHIN CONSTITUTION AVENUE WEST OF LOUISIANA BOULEVARD. THE PASEO DE LAS MONTANAS MULTI-USE TRAIL IS NORTH OF THE SUBJECT SITE, WHICH CROSSES OVER I-40 AND CONTINUES ALONG THE FRONTAGE ROAD AS THE I-40 TRAIL.

LEGAL DESCRIPTION: Tract B-1-A, Mesa Del Norte Addition, City of Albuquerque, Bernalillo County, New Mexico SITE AREA: 1.74 ACRES **2ONE ATLAS:** J-19-Z

SETBACKS: FRONT= 0' MIN / 15' MAX, SIDE = 0' MIN / N/A MAX REAR= 15'

MAXIMUM ALLOWED: 65'-0" UC-MS-PT + 12'-0" STRUCTURED PARKING BONUS: 77'-0" ACTUAL HEIGHT: 69'-1" SPRINKLERED: YES, NFPA 13

BUILDING OCCUPANCY: S-2 COVERED PARKING, R-2 MULTIFAMILY RESIDENTIAL CONSTRUCTION TYPE: 1 STORY COVERED PARKING (PODIUM) - TYPE IA 4 STORY RESIDENTIAL BUILDING - TYPE VA

FIRST LEVEL - COVERED PARKING (PODIUM) 44,987 GSF 34,015 GSF SECOND LEVEL THIRD LEVEL 34,350 GSF FOURTH LEVEL 34,350 GSF FIFTH LEVEL 34,350 GSF TOTAL 182,052 GSF

PARKING CALCULATION: (TABLE 5-5-1, UC-MS-PT) REQUIRED SPACES: 151 SPACES 1 SPACES / DWELLING UNITS: 151 X 1 = 151 SPACES PROVIDED PARKING = 187 TOTAL SPACES

ACCESSIBLE PARKING: (ADA 208.2.3) 2% OF UNITS = 151 X .02 = 3.02 = 4 SPACES REQUIRED 2 STANDARD SPACES + 4 VAN ACCESSIBLE SPACES = 6 SPACES PROVIDED

BICYCLE PARKING REQUIRED = 16 SPACES (10% OF REQUIRED OFF-STREET PARKING = 151 X 0.10 = 16 SPACES)
BICYCLE PARKING PROVIDED = 16 SPACES

UNIT DATA

Sep 17, 2021

UNIT TYPE	DESCRIPTION	GSF	#UNITS	TOTAL
STUDIO	STUDIO	513 SF	51	26,418 SF
1-1B	1 BEDROOM / 1 BATHROOM	698 SF	16	11,168 SF
1-1C	1 BEDROOM / 1 BATHROOM	696 SF	15	10,455 SF
1-1D	1 BEDROOM / 1 BATHROOM	639 SF	17	10,897 SF
1-1E	1 BEDROOM / 1 BATHROOM	626 SF	15	9,930 SF
1-1F	1 BEDROOM / 1 BATHROOM	764 SF	3	2,343 SF
1-1G	1 BEDROOM / 1 BATHROOM	753 SF	4	2,964 SF
1-1H	1 BEDROOM / 1 BATHROOM	700 SF	4	2,800 SF
1-1J	1 BEDROOM / 1 BATHROOM	667 SF	4	2,660 SF
<u>2-2C</u>	2 BEDROOM / 2 BATHROOM	1,014 SF	22	22,990 SF
		TOTAL:	151 UNITS	102,625 SF

OPEN SPACE CALCULATIONS

TABLE 2-4-5 / MX-M ZONING USABLE OPEN SPACE 1 BD: 225 SF PER UNIT 225 SF x 129 UNITS = 29,025 SF 285 SF x 22 UNITS = 6,270 SF = 35,295 SF 2 BD: 285 SF PER UNIT = 35,295 SF X 50% = 17,648 SF UC-MS-PT: 50% REDUCTION = 17,648 SF REQUIRED OPEN SPACE: PROVIDED OPEN SPACE:


= 10,138 SF

Date

Date

Sep 20, 2021

LEGEND

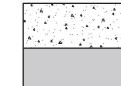

CONCRETE

HEAVY DUTY ASPHALT (RATED FOR UP TO 75,000 LBS)

FIRELANE STRIPING MARKING FIRE ACCESS LANE; REF: A4/SDP1.2 PROPERTY LINE

FIRE HYDRANT

POST INDICATOR VALVE (PIV), RE: CONCEPTUAL UTILITY PLAN FIRE DEPARTMENT CONNECTION (FDC) WALL-MOUNTED

BIKE RACK

SIDEWALK RAMP (ARROW POINTS DOWN) TRANSFORMER WITH SAFETY BOLLARDS & 6" THICK CONCRETE PAD PER PNM STANDARDS

6' TALL DECORATIVE METAL FENCE

ACCESSIBLE PARKING WITH ACCESSIBLE SIGNAGE AND STRIPING, REF: A3/SDP1.2, A4/SDP1.2 & B4/SDP1.2.

COMPACT PARKING; REF: D5/SDP1.3

6" BOLLARD WITH SIGN

6' WIDE PAINTED CROSSWALK, SEE A3/SDP1.2

PERICH SABATINI

ARCHITECTURE DESIGN INSPIRATION



PROJECT

LOUISIANA BLVD. ALBUQUERQUE, NM

SITE PLAN - DRB


REVISIONS

DRAWN BY REVIEWED BY 7/1/2021 PROJECT NO. 21-0020

DRAWING NAME

ARCHITECTURAL SITE PLAN

SHEET NO.

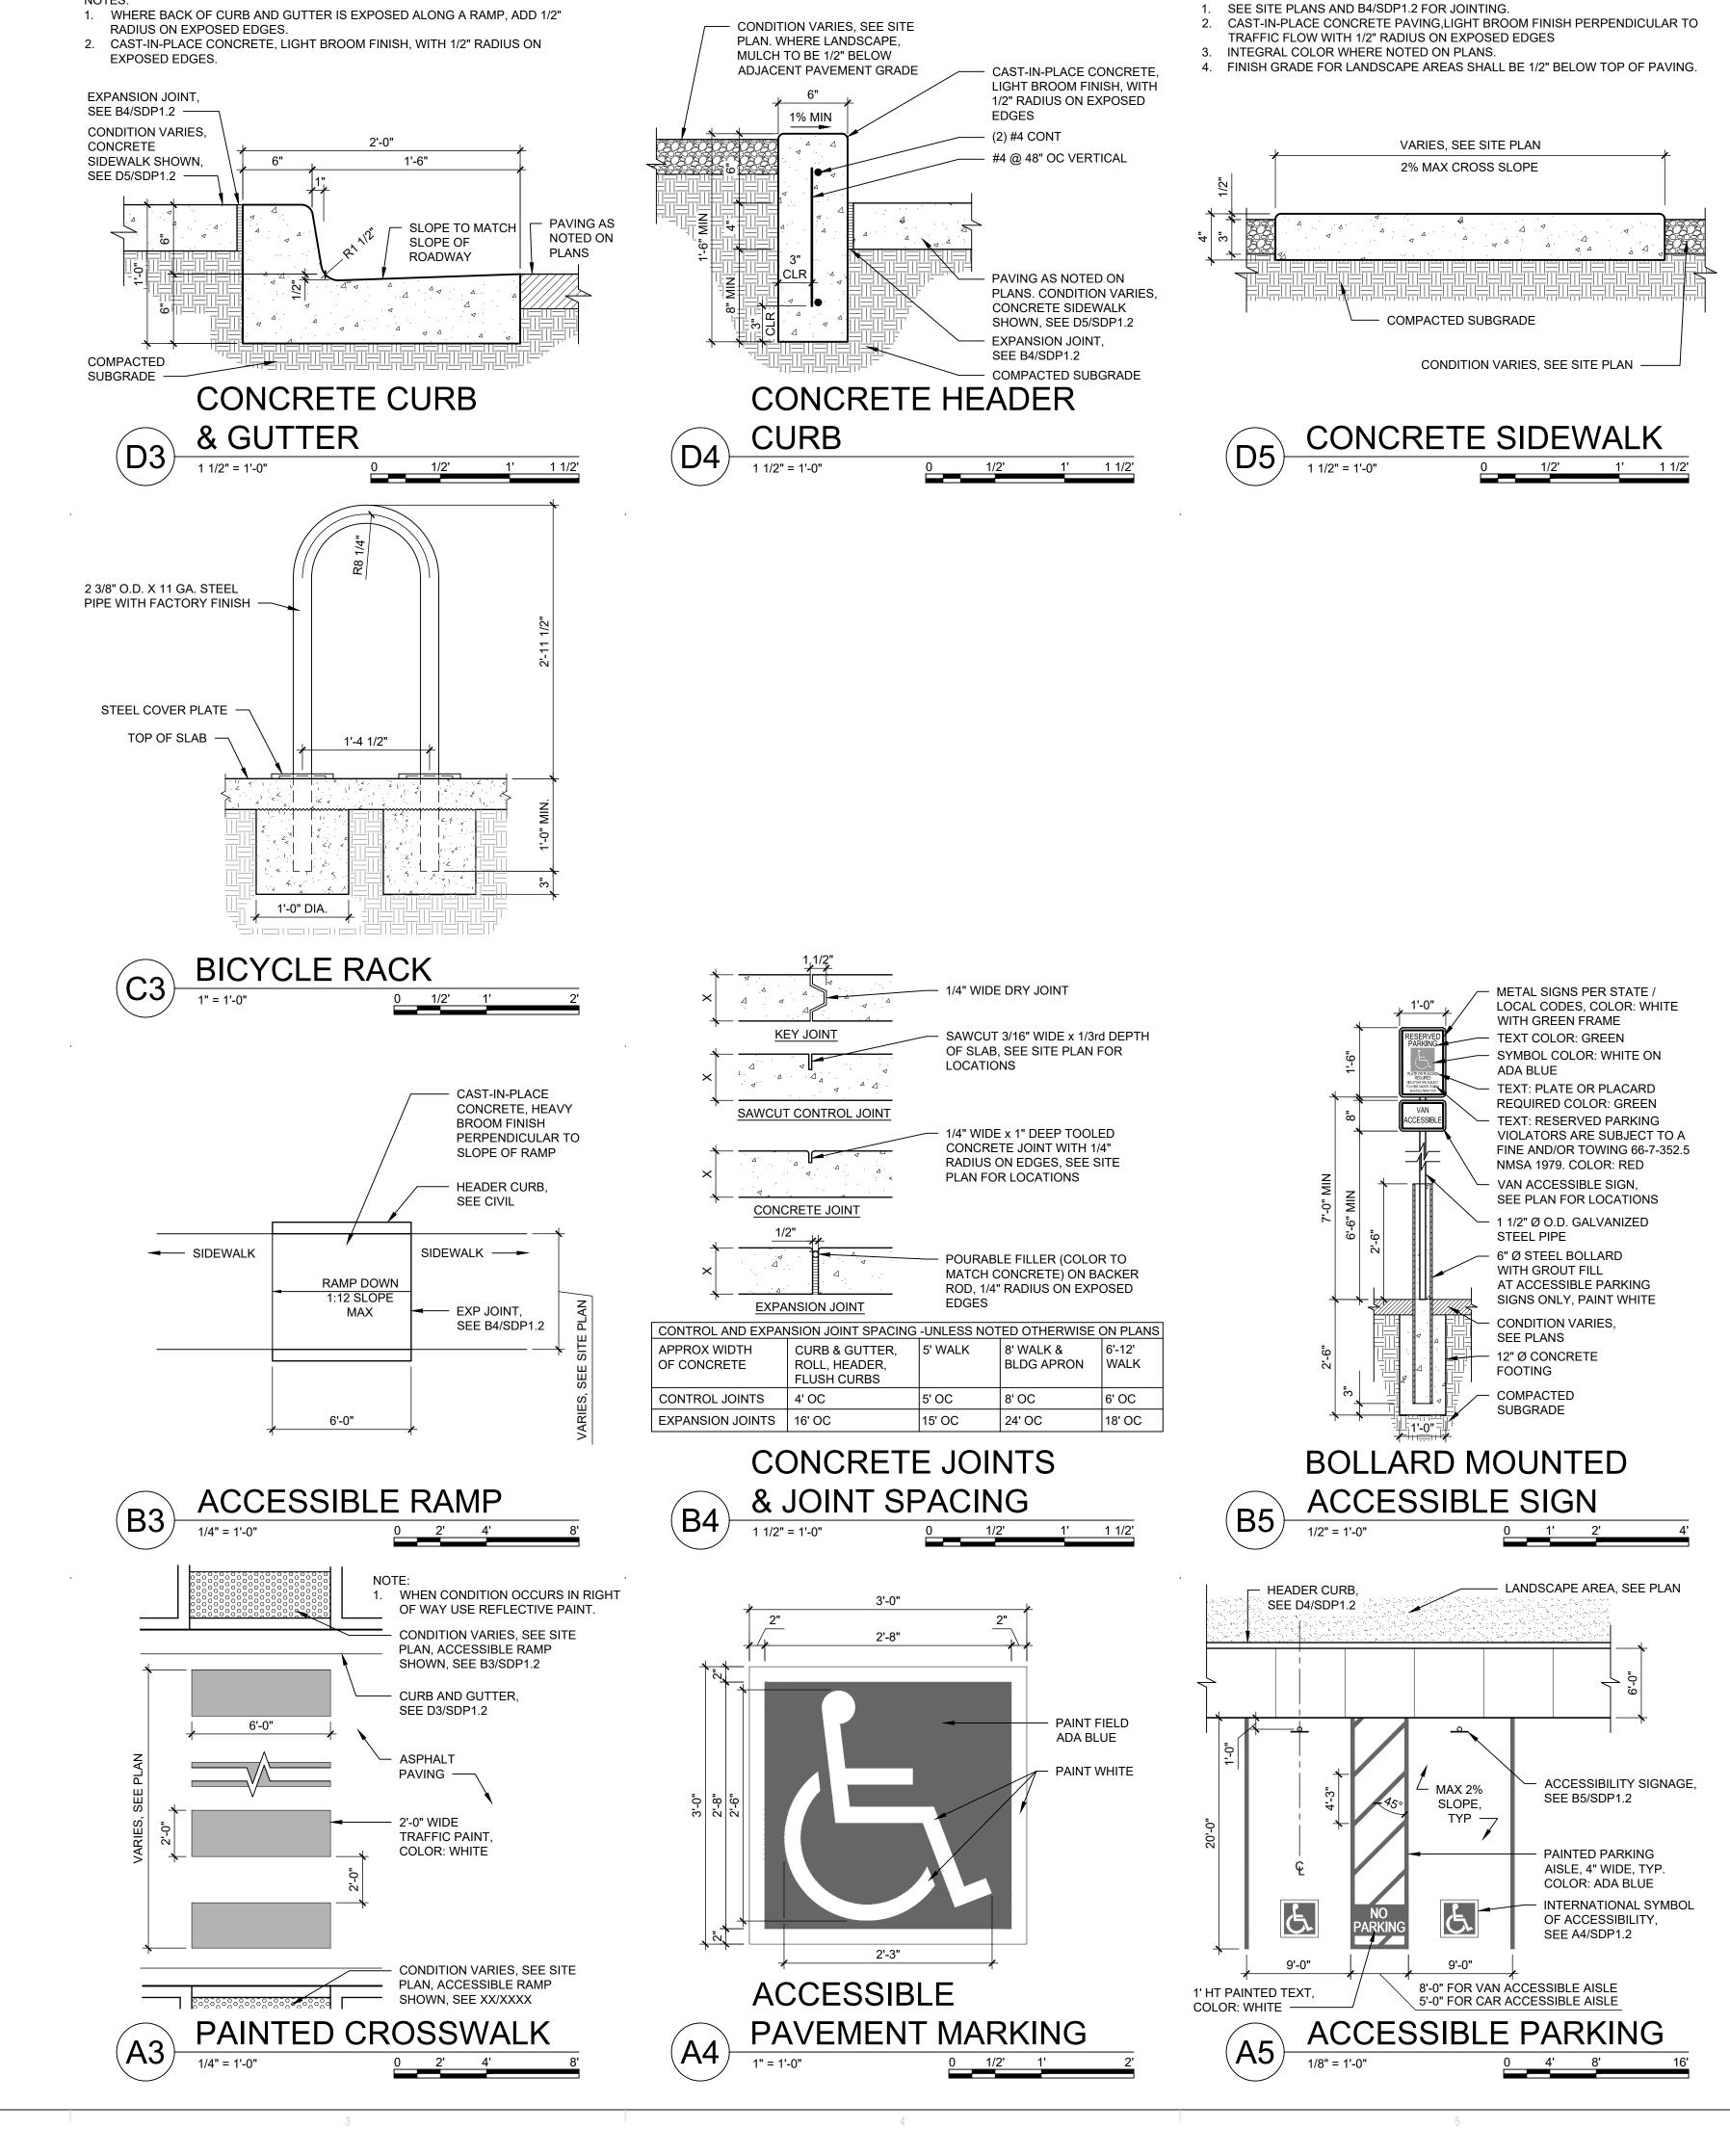

DEKKER
PERICH
SABATINI


ARCHITECTURE DESIGN INSPIRATION



PROJECT

MARKANA FLATS
LOUISIANA BLVD. NE
ALBUQUERQUE, NM 87110

SITE PLAN - DRB

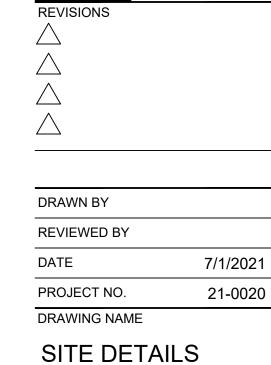

SHEET NO.
SDP1.2

ARCHITECTURE IN PROGRESS

DEKKER PERICH SABATINI



PROJECT

MARKANA FLATS LOUISIANA BLVD. NE ALBUQUERQUE, NM 87110

DRB SUBMITTAL


REVISIONS	
DRAWN BY	SP
REVIEWED BY	DM
DATE	6/30/2021
DDO IECT NO.	04.0000

PROJECT NO: 21-0020

DRAWING NAME

LEVEL 2 FLOOR PLAN

SDP4.1

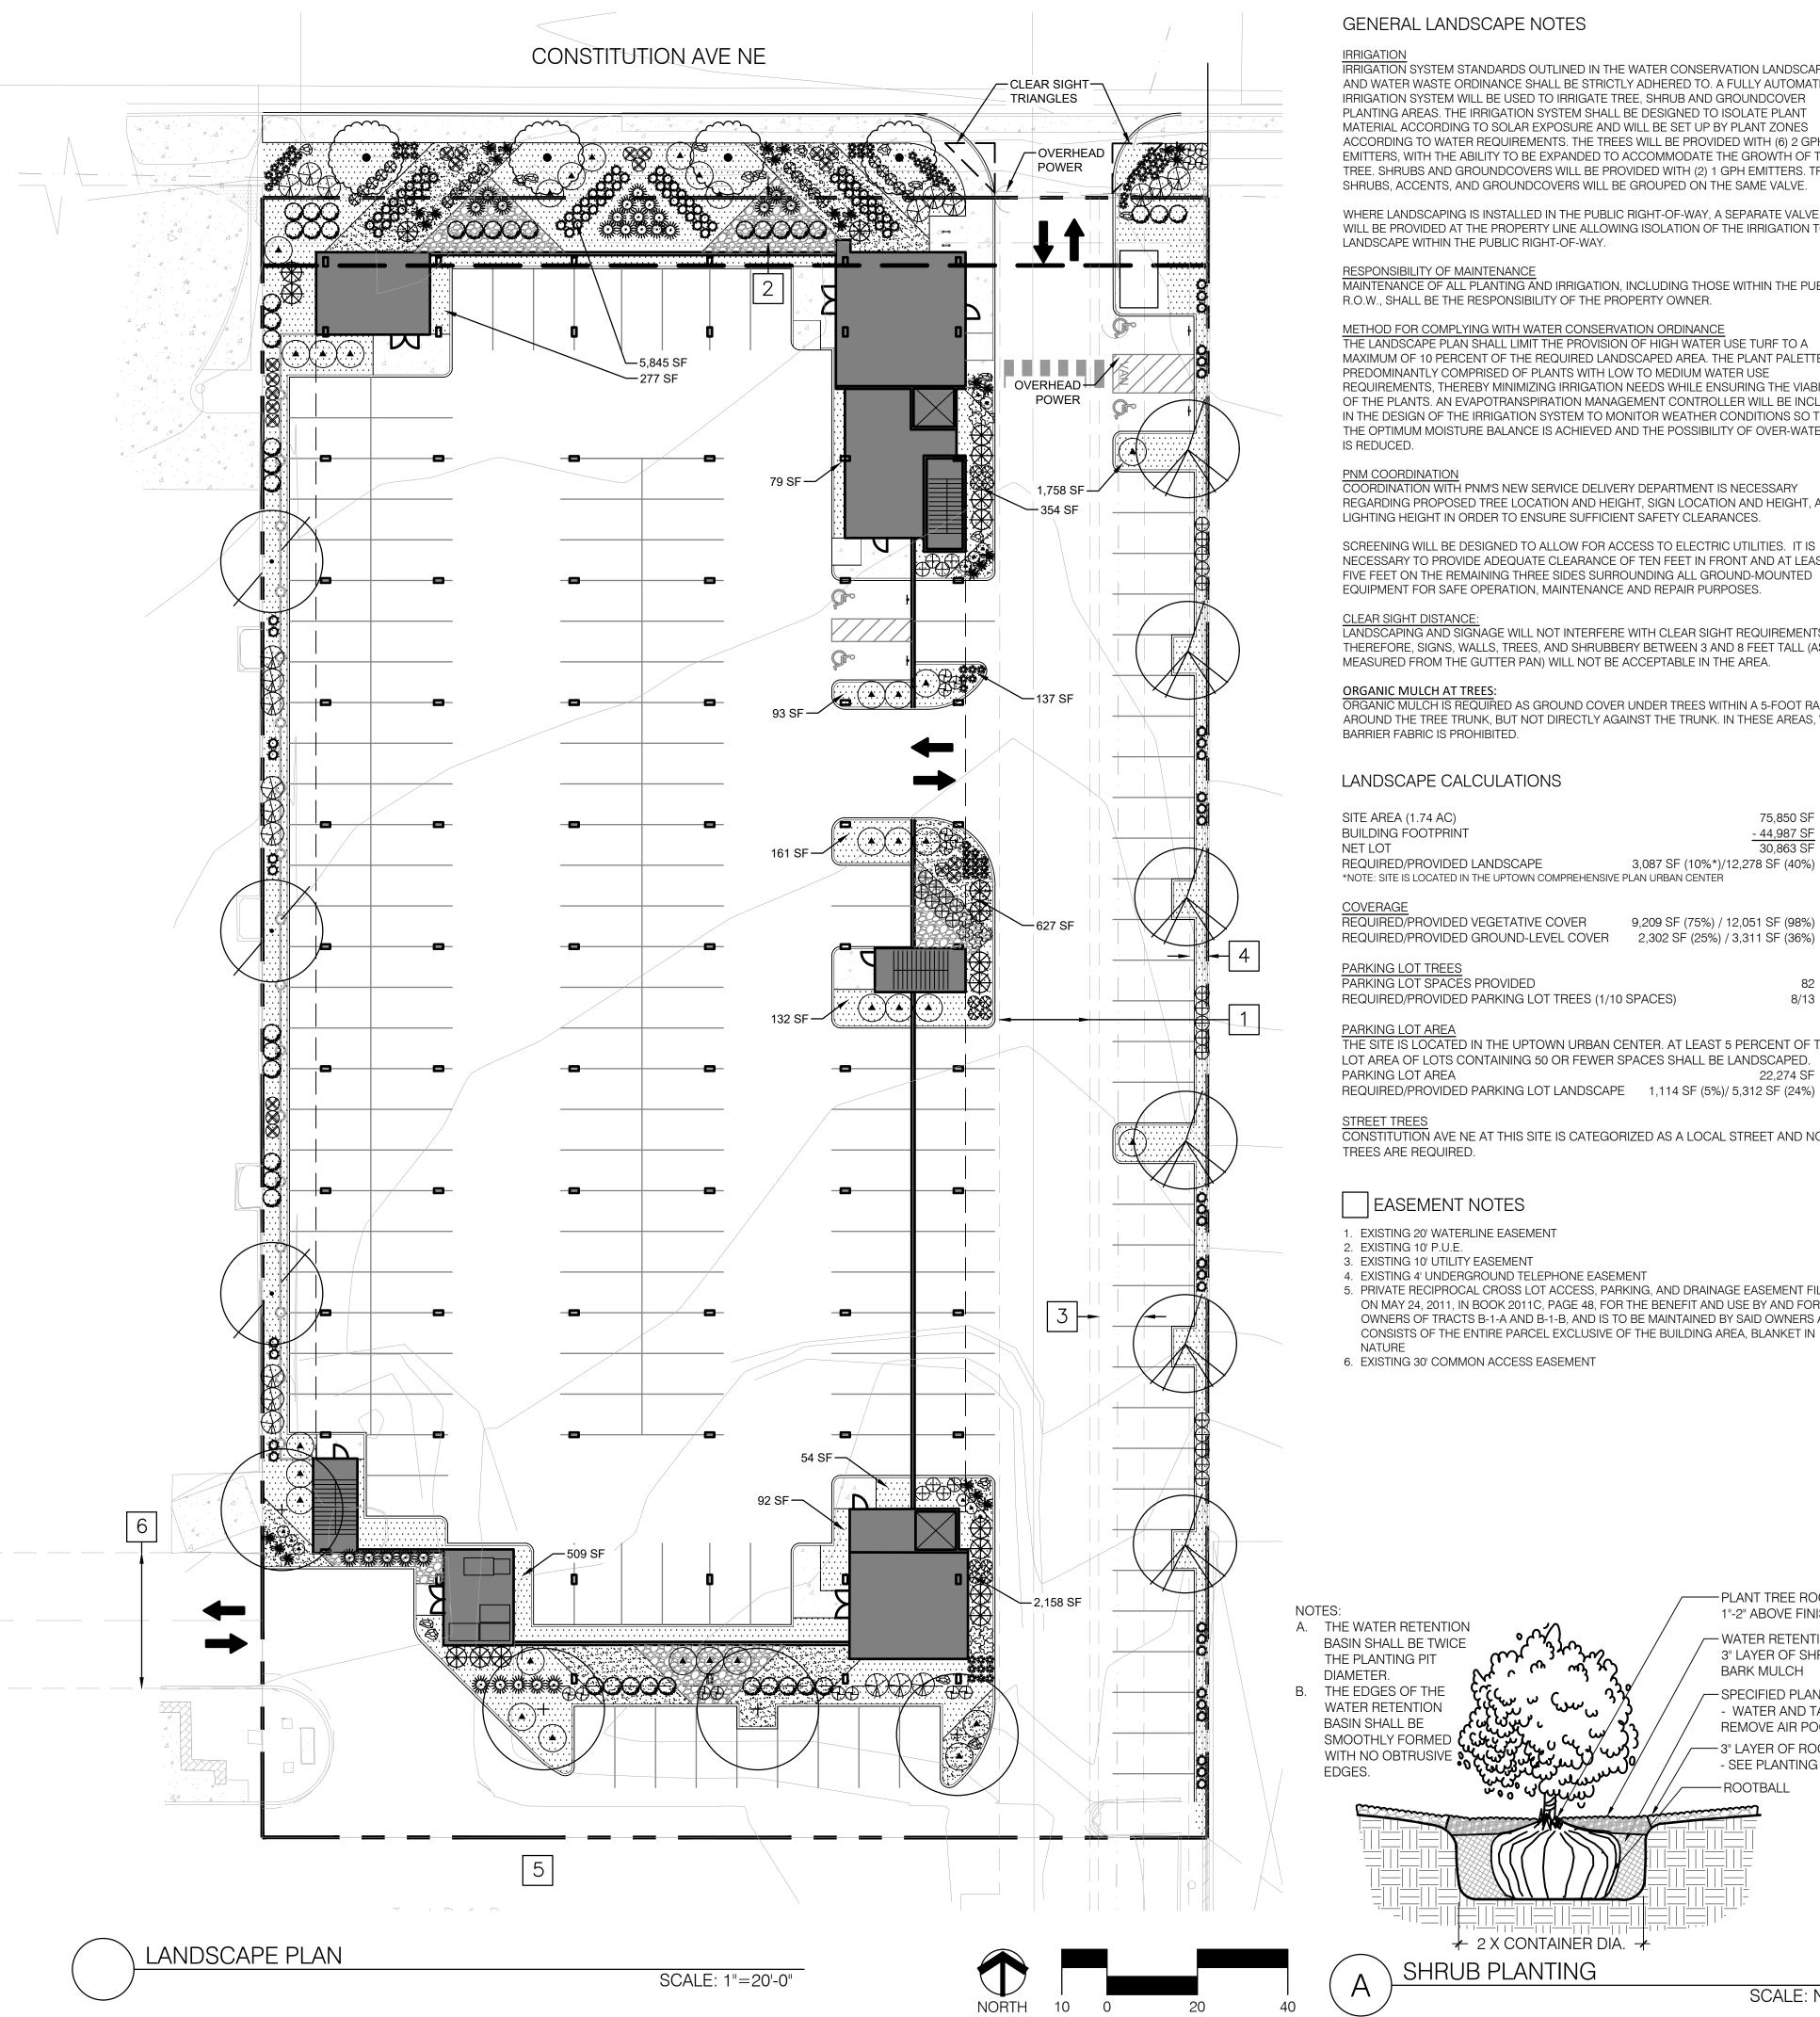

GENERAL LANDSCAPE NOTES

IRRIGATION SYSTEM STANDARDS OUTLINED IN THE WATER CONSERVATION LANDSCAPING AND WATER WASTE ORDINANCE SHALL BE STRICTLY ADHERED TO. A FULLY AUTOMATED IRRIGATION SYSTEM WILL BE USED TO IRRIGATE TREE, SHRUB AND GROUNDCOVER PLANTING AREAS. THE IRRIGATION SYSTEM SHALL BE DESIGNED TO ISOLATE PLANT MATERIAL ACCORDING TO SOLAR EXPOSURE AND WILL BE SET UP BY PLANT ZONES ACCORDING TO WATER REQUIREMENTS. THE TREES WILL BE PROVIDED WITH (6) 2 GPH EMITTERS, WITH THE ABILITY TO BE EXPANDED TO ACCOMMODATE THE GROWTH OF THE TREE. SHRUBS AND GROUNDCOVERS WILL BE PROVIDED WITH (2) 1 GPH EMITTERS. TREES, SHRUBS, ACCENTS, AND GROUNDCOVERS WILL BE GROUPED ON THE SAME VALVE.

WHERE LANDSCAPING IS INSTALLED IN THE PUBLIC RIGHT-OF-WAY, A SEPARATE VALVE(S) WILL BE PROVIDED AT THE PROPERTY LINE ALLOWING ISOLATION OF THE IRRIGATION TO THE LANDSCAPE WITHIN THE PUBLIC RIGHT-OF-WAY.

RESPONSIBILITY OF MAINTENANCE

MAINTENANCE OF ALL PLANTING AND IRRIGATION, INCLUDING THOSE WITHIN THE PUBLIC R.O.W., SHALL BE THE RESPONSIBILITY OF THE PROPERTY OWNER.

METHOD FOR COMPLYING WITH WATER CONSERVATION ORDINANCE THE LANDSCAPE PLAN SHALL LIMIT THE PROVISION OF HIGH WATER USE TURF TO A MAXIMUM OF 10 PERCENT OF THE REQUIRED LANDSCAPED AREA. THE PLANT PALETTE IS PREDOMINANTLY COMPRISED OF PLANTS WITH LOW TO MEDIUM WATER USE REQUIREMENTS, THEREBY MINIMIZING IRRIGATION NEEDS WHILE ENSURING THE VIABILITY OF THE PLANTS. AN EVAPOTRANSPIRATION MANAGEMENT CONTROLLER WILL BE INCLUDED IN THE DESIGN OF THE IRRIGATION SYSTEM TO MONITOR WEATHER CONDITIONS SO THAT THE OPTIMUM MOISTURE BALANCE IS ACHIEVED AND THE POSSIBILITY OF OVER-WATERING

COORDINATION WITH PNM'S NEW SERVICE DELIVERY DEPARTMENT IS NECESSARY REGARDING PROPOSED TREE LOCATION AND HEIGHT, SIGN LOCATION AND HEIGHT, AND LIGHTING HEIGHT IN ORDER TO ENSURE SUFFICIENT SAFETY CLEARANCES.

SCREENING WILL BE DESIGNED TO ALLOW FOR ACCESS TO ELECTRIC UTILITIES. IT IS NECESSARY TO PROVIDE ADEQUATE CLEARANCE OF TEN FEET IN FRONT AND AT LEAST FIVE FEET ON THE REMAINING THREE SIDES SURROUNDING ALL GROUND-MOUNTED EQUIPMENT FOR SAFE OPERATION, MAINTENANCE AND REPAIR PURPOSES.

LANDSCAPING AND SIGNAGE WILL NOT INTERFERE WITH CLEAR SIGHT REQUIREMENTS. THEREFORE, SIGNS, WALLS, TREES, AND SHRUBBERY BETWEEN 3 AND 8 FEET TALL (AS MEASURED FROM THE GUTTER PAN) WILL NOT BE ACCEPTABLE IN THE AREA.

ORGANIC MULCH AT TREES:

ORGANIC MULCH IS REQUIRED AS GROUND COVER UNDER TREES WITHIN A 5-FOOT RADIUS AROUND THE TREE TRUNK, BUT NOT DIRECTLY AGAINST THE TRUNK. IN THESE AREAS, WEED BARRIER FABRIC IS PROHIBITED.

LANDSCAPE CALCULATIONS

SITE AREA (1.74 AC)	75,850 S
BUILDING FOOTPRINT	- 44,987 S
NET LOT	30,863 5
REQUIRED/PROVIDED LANDSCAPE	3.087 SF (10%*)/12.278 SF (409

REQUIRED/PROVIDED VEGETATIVE COVER 9,209 SF (75%) / 12,051 SF (98%) REQUIRED/PROVIDED GROUND-LEVEL COVER 2,302 SF (25%) / 3,311 SF (36%)

PARKING LOT SPACES PROVIDED

REQUIRED/PROVIDED PARKING LOT TREES (1/10 SPACES) 8/13

THE SITE IS LOCATED IN THE UPTOWN URBAN CENTER. AT LEAST 5 PERCENT OF THE PARKING LOT AREA OF LOTS CONTAINING 50 OR FEWER SPACES SHALL BE LANDSCAPEL PARKING LOT AREA

CONSTITUTION AVE NE AT THIS SITE IS CATEGORIZED AS A LOCAL STREET AND NO STREET

EASEMENT NOTES

- 1. EXISTING 20' WATERLINE EASEMENT
- 2. EXISTING 10' P.U.E.
- 4. EXISTING 4' UNDERGROUND TELEPHONE EASEMENT
- 5. PRIVATE RECIPROCAL CROSS LOT ACCESS, PARKING, AND DRAINAGE EASEMENT FILED ON MAY 24, 2011, IN BOOK 2011C, PAGE 48, FOR THE BENEFIT AND USE BY AND FOR THE OWNERS OF TRACTS B-1-A AND B-1-B, AND IS TO BE MAINTAINED BY SAID OWNERS AND CONSISTS OF THE ENTIRE PARCEL EXCLUSIVE OF THE BUILDING AREA, BLANKET IN
- 6. EXISTING 30' COMMON ACCESS EASEMENT

- PLANT TREE ROOT COLLAR

1"-2" ABOVE FINISH GRADE

WATER RETENTION BASIN -

3" LAYER OF SHREDDED

— SPECIFIED PLANTING MIX

- WATER AND TAMP TO

REMOVE AIR POCKETS

- SEE PLANTING PLAN

— 3" LAYER OF ROCK MULCH

SCALE: N.T.S.

BARK MULCH

-ROOTBALL

2,136 SF

PLANT LEGEND

SHRUBS

DESERT ACCENTS

ORNAMENTAL GRASSES

FLOWERING PLANTS

BOULDERS AND MULCHES

SCIENTIFIC NAME

CELTIS RETICULATA

CHILOPSIS LINEARIS

DESERT WILLOW (LM)

PRUNUS CERASTIFERA

PURPLELEAF PLUM (M)

QUERCUS FUSIFORMIS ESCARPMENT LIVE OAK (M)

PURPLE BUTTERFLY BUSH (M)

CYTISUS X PRAECOX 'ALLGOLD'

GULF STREAM NANDINA (M)

HESPERALOE PARVIFLORA

TWISTLEAF YUCCA (RW)

YUCCA RUPICOLA

RED FLOWERING YUCCA (L+)

NANDINA DOMESTICA 'GULF STREAM'

RHUS TRILOBATA 'AUTUMN AMBER'

CREEPING THREE-LEAF SUMAC (L+)

PANICUM VIRGATUM 'SHENANDOAH'

REGAL MIST® PINK MUHLY GRASS (M)

SHENANDOAH SWITCH GRASS (M) MUHLENBERGIA CAPILLARIS 'LENCA'

FESTUCA GLAUCA 'ELIJAH BLUE'

ULTRA VIOLET HYBRID SAGE (L)

MUNSTEAD LAVENDER (M)

LANDSCAPE BOULDERS (3'X3' MIN)

(3" DEPTH OVER FILTER FABRIC) 2" TEQUILA SUNRISE ROCK MULCH

4" DEPTH OVER FILTER FABRIC)

2"-4" COYOTE MIST COBBLE MULCH (6" DEPTH OVER FILTER FABRIC)

3/8"-1" AMARETTO BROWN ROCK MULCH

RED RIDING HOOD BEARDTONGUE (L)

PENSTEMON SCHMIDEL 'RED RIDING HOOD'1 GAL.

LAVANDULA ANGUSTIFOLIA 'MUNSTEAD' 1 GAL. 18" HT. X 18" SPR.

ELIJAH BLUE FESCUE (M)

ACHILLEA 'MOONSHINE' MOONSHINE YARROW (M) SALVIA 'ULTRA VIOLET'

ALLGOLD BROOM (M)

NETLEAF HACKBERRY (LM)

WICHITA BLUE JUNIPER (M)

JUNIPERUS SCOPULORUM 'WICHITA BLUE' 24" BOX

BUDDLEIA DAVIDII NAN. 'NANHO PURPLE' 5-GAL.

SIZE

2" B&B

2" B&B

2" B&B

5-GAL.

5-GAL.

1-GAL.

MATURE SIZE

25' HT. X 25' SPR.

20' HT. X 25' SPR.

10' HT. X 4' SPR.

25' HT. X 30' SPR.

4' HT. X 4' SPR.

5' HT. X 5' SPR.

3' HT. X 3' SPR.

18" HT. X 6' SPR.

4' HT. X 4' SPR.

2' HT. X 3' SPR.

3' HT. X 2' SPR.

3' HT. X 3' SPR.

1' HT. X 1' SPR.

2' HT. X 2' SPR.

2' HT. X 2' SPR.

3' HT. X 2' SPR.


2" B&B 20' HT. X 20' SPR.

(FEMALE ONLY)

QTY. SYMBOL COMMON NAME (WATER USE)

- A. THE WATER RETENTION BASIN SHALL BE TWICE THE PLANTING PIT
- DIAMETER. B. THE EDGES OF THE WATER RETENTION BASIN SHALL BE SMOOTHLY
- FORMED WITH NO OBTRUSIVE EDGES.

C. REMOVE ROPE AND BURLAP AFTER PLANTING.

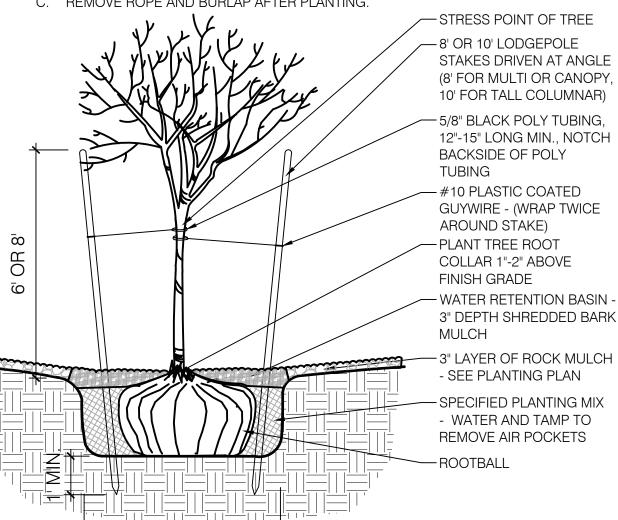


TREE PLANTING

★ 2 X CONTAINER DIA.

Landscape Architecture Urban Design Planning Services

302 EIGHTH ST. NW Albuquerque, NM 87102 Phone (505) 764-9801 Fax (505) 842-5495

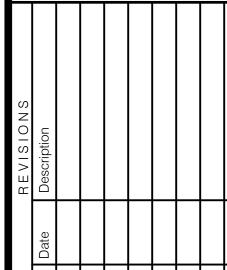

OPMEN. Z

_andscape Architect's Seal: CHRISTOPHER J. GREEN PAR #234 SCAPE ARCHIT

NOT FOR CONSTRUCTION Designed By: Checked By:


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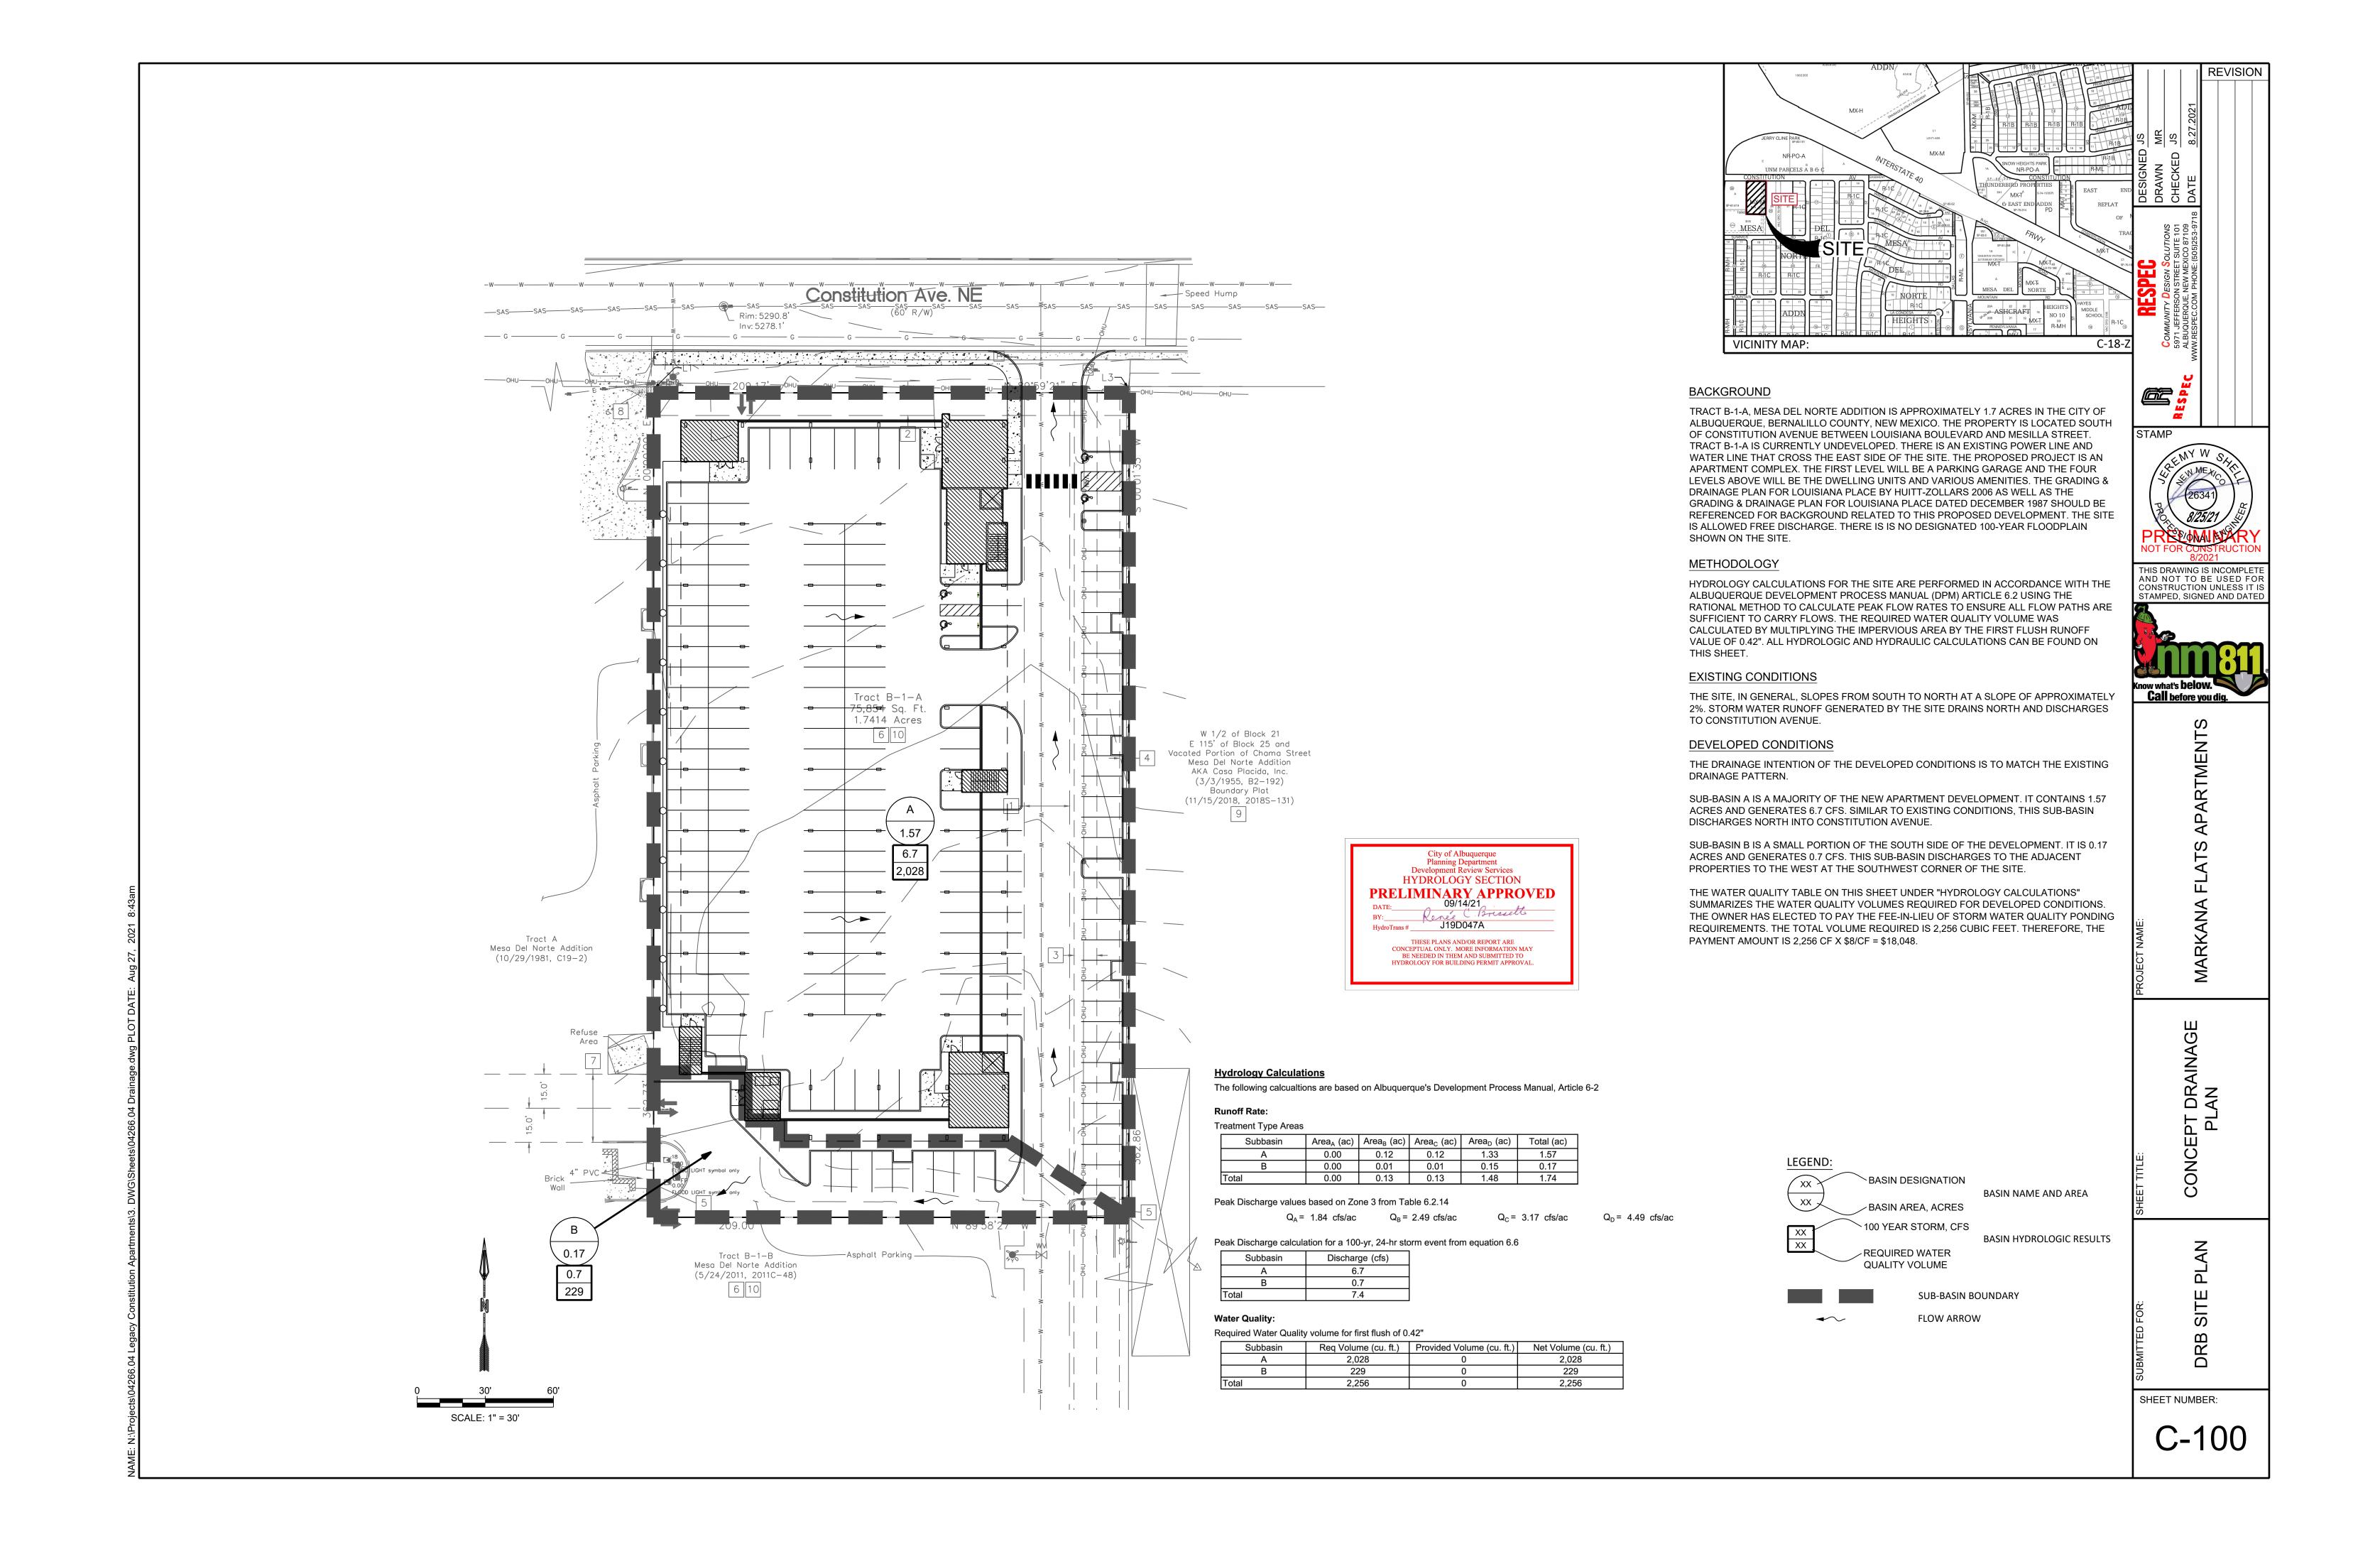
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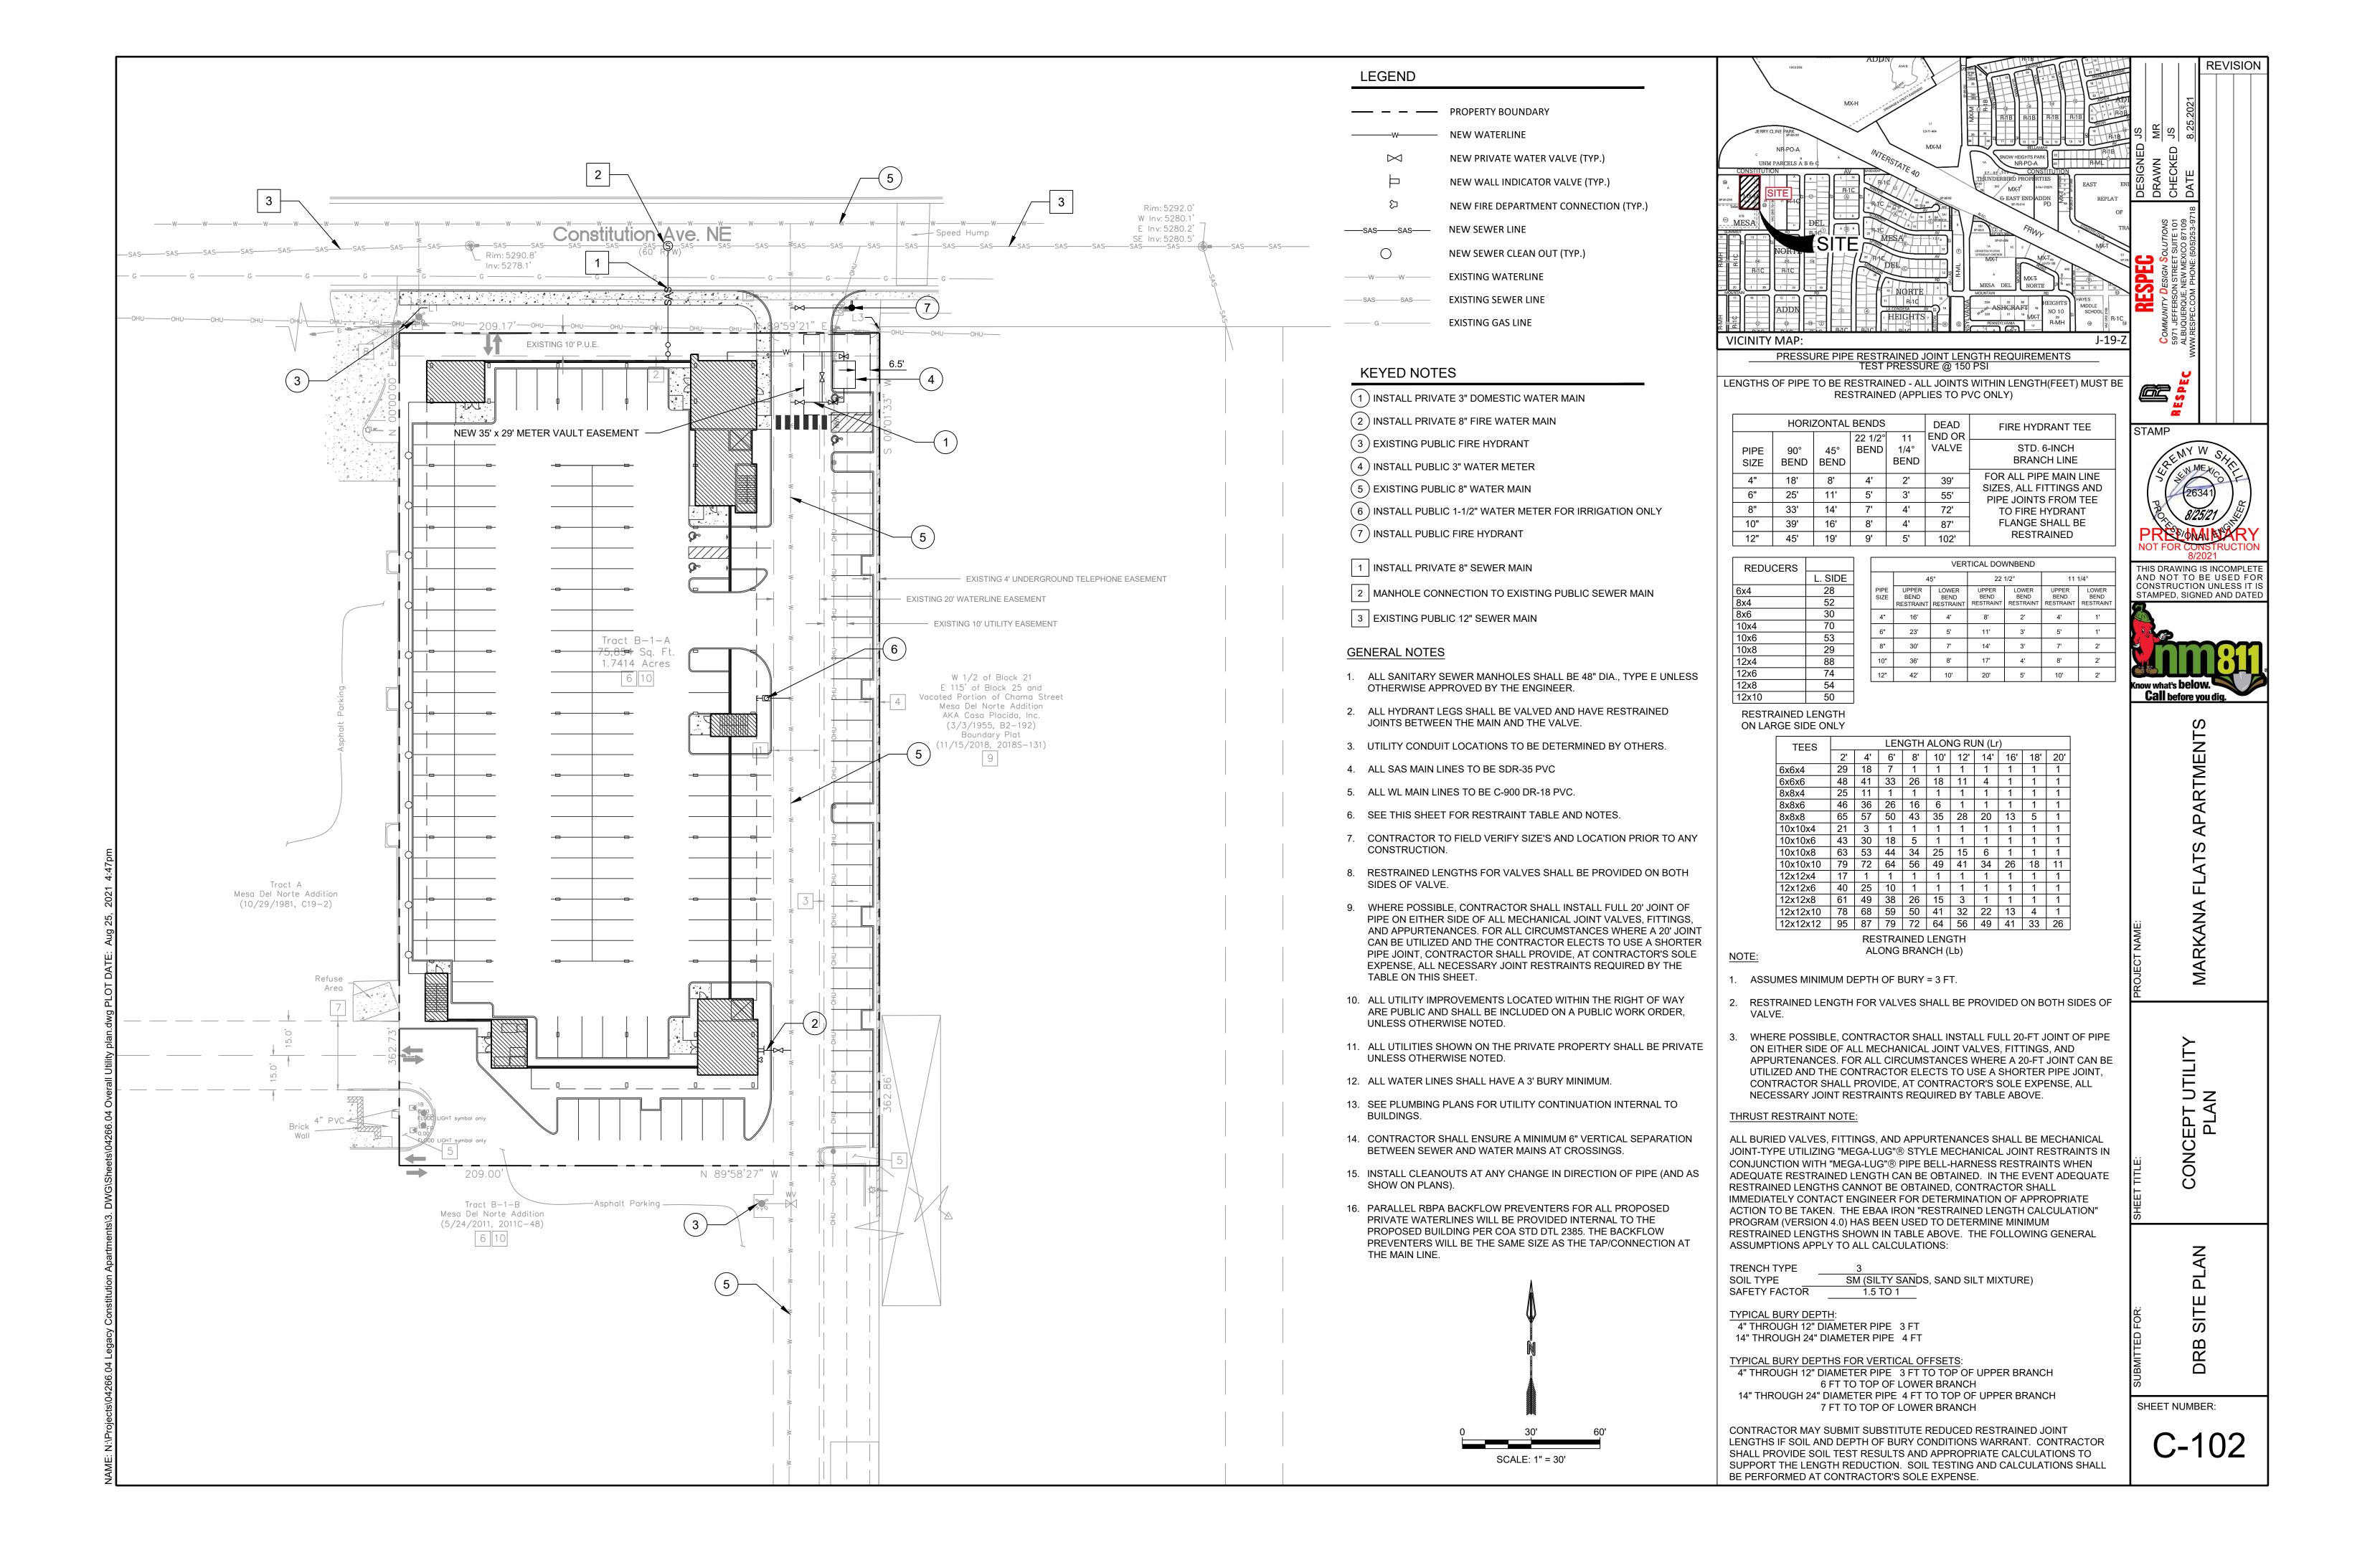
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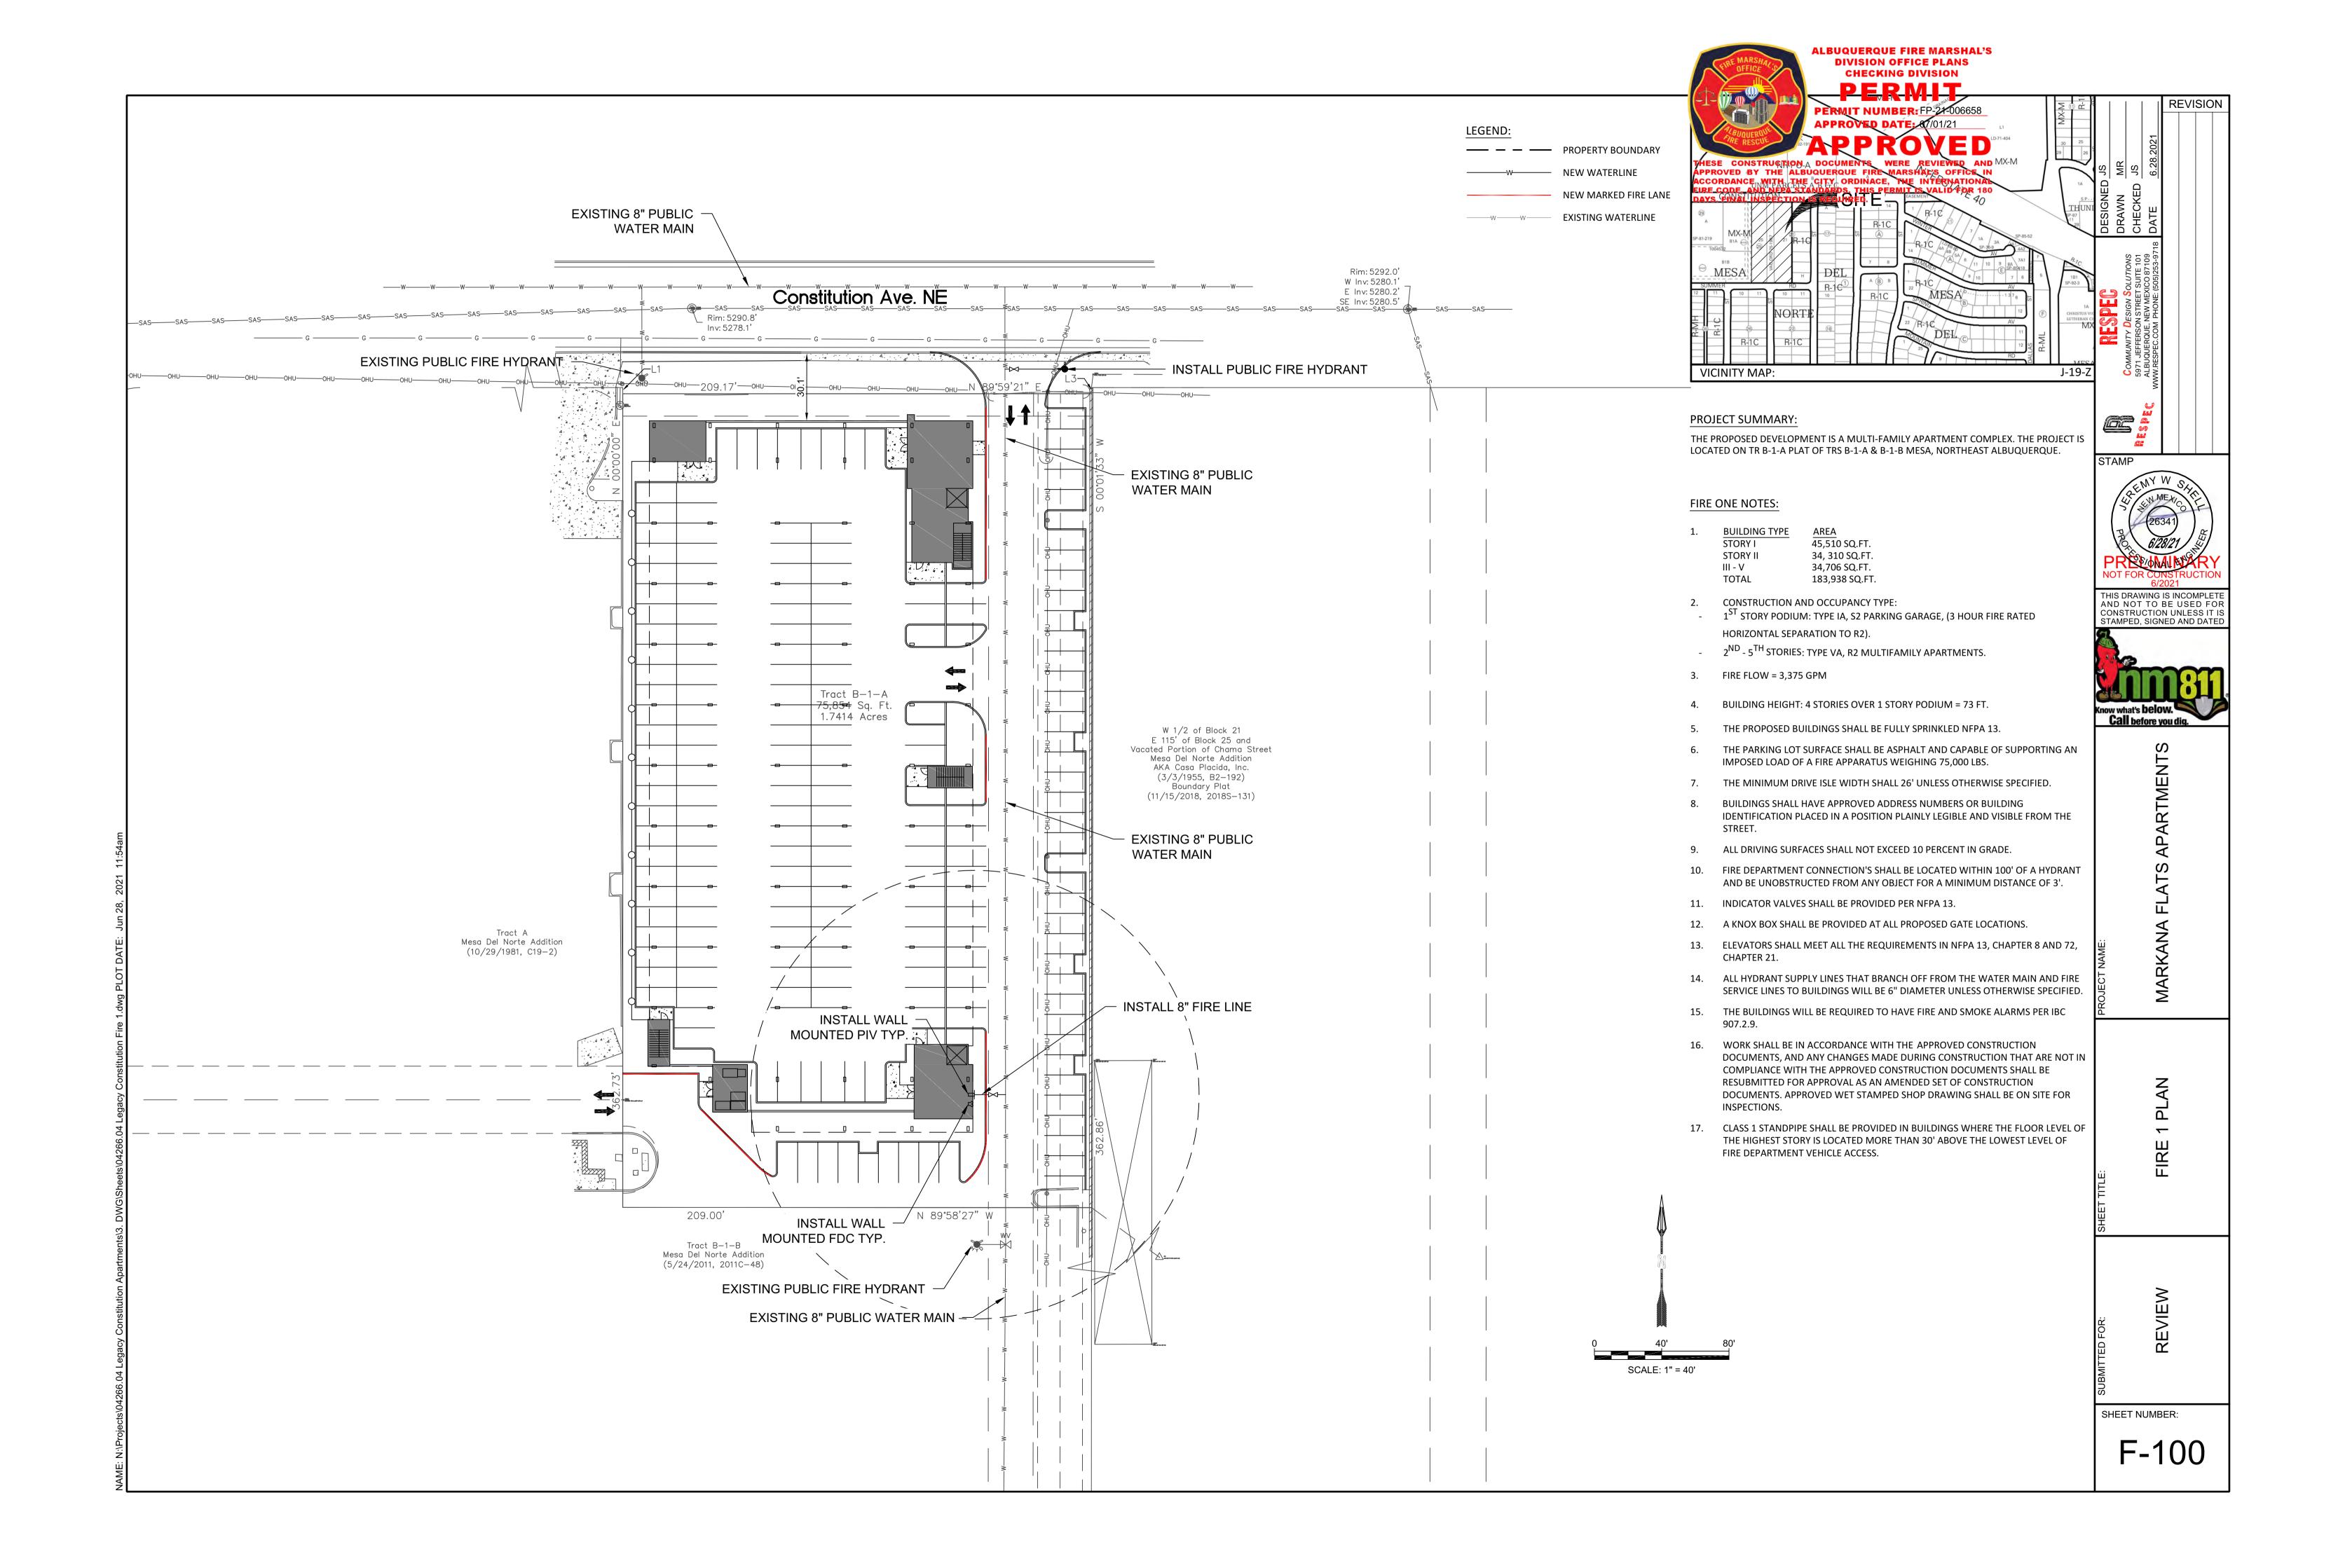
LANDSCAPE PLAN


L101







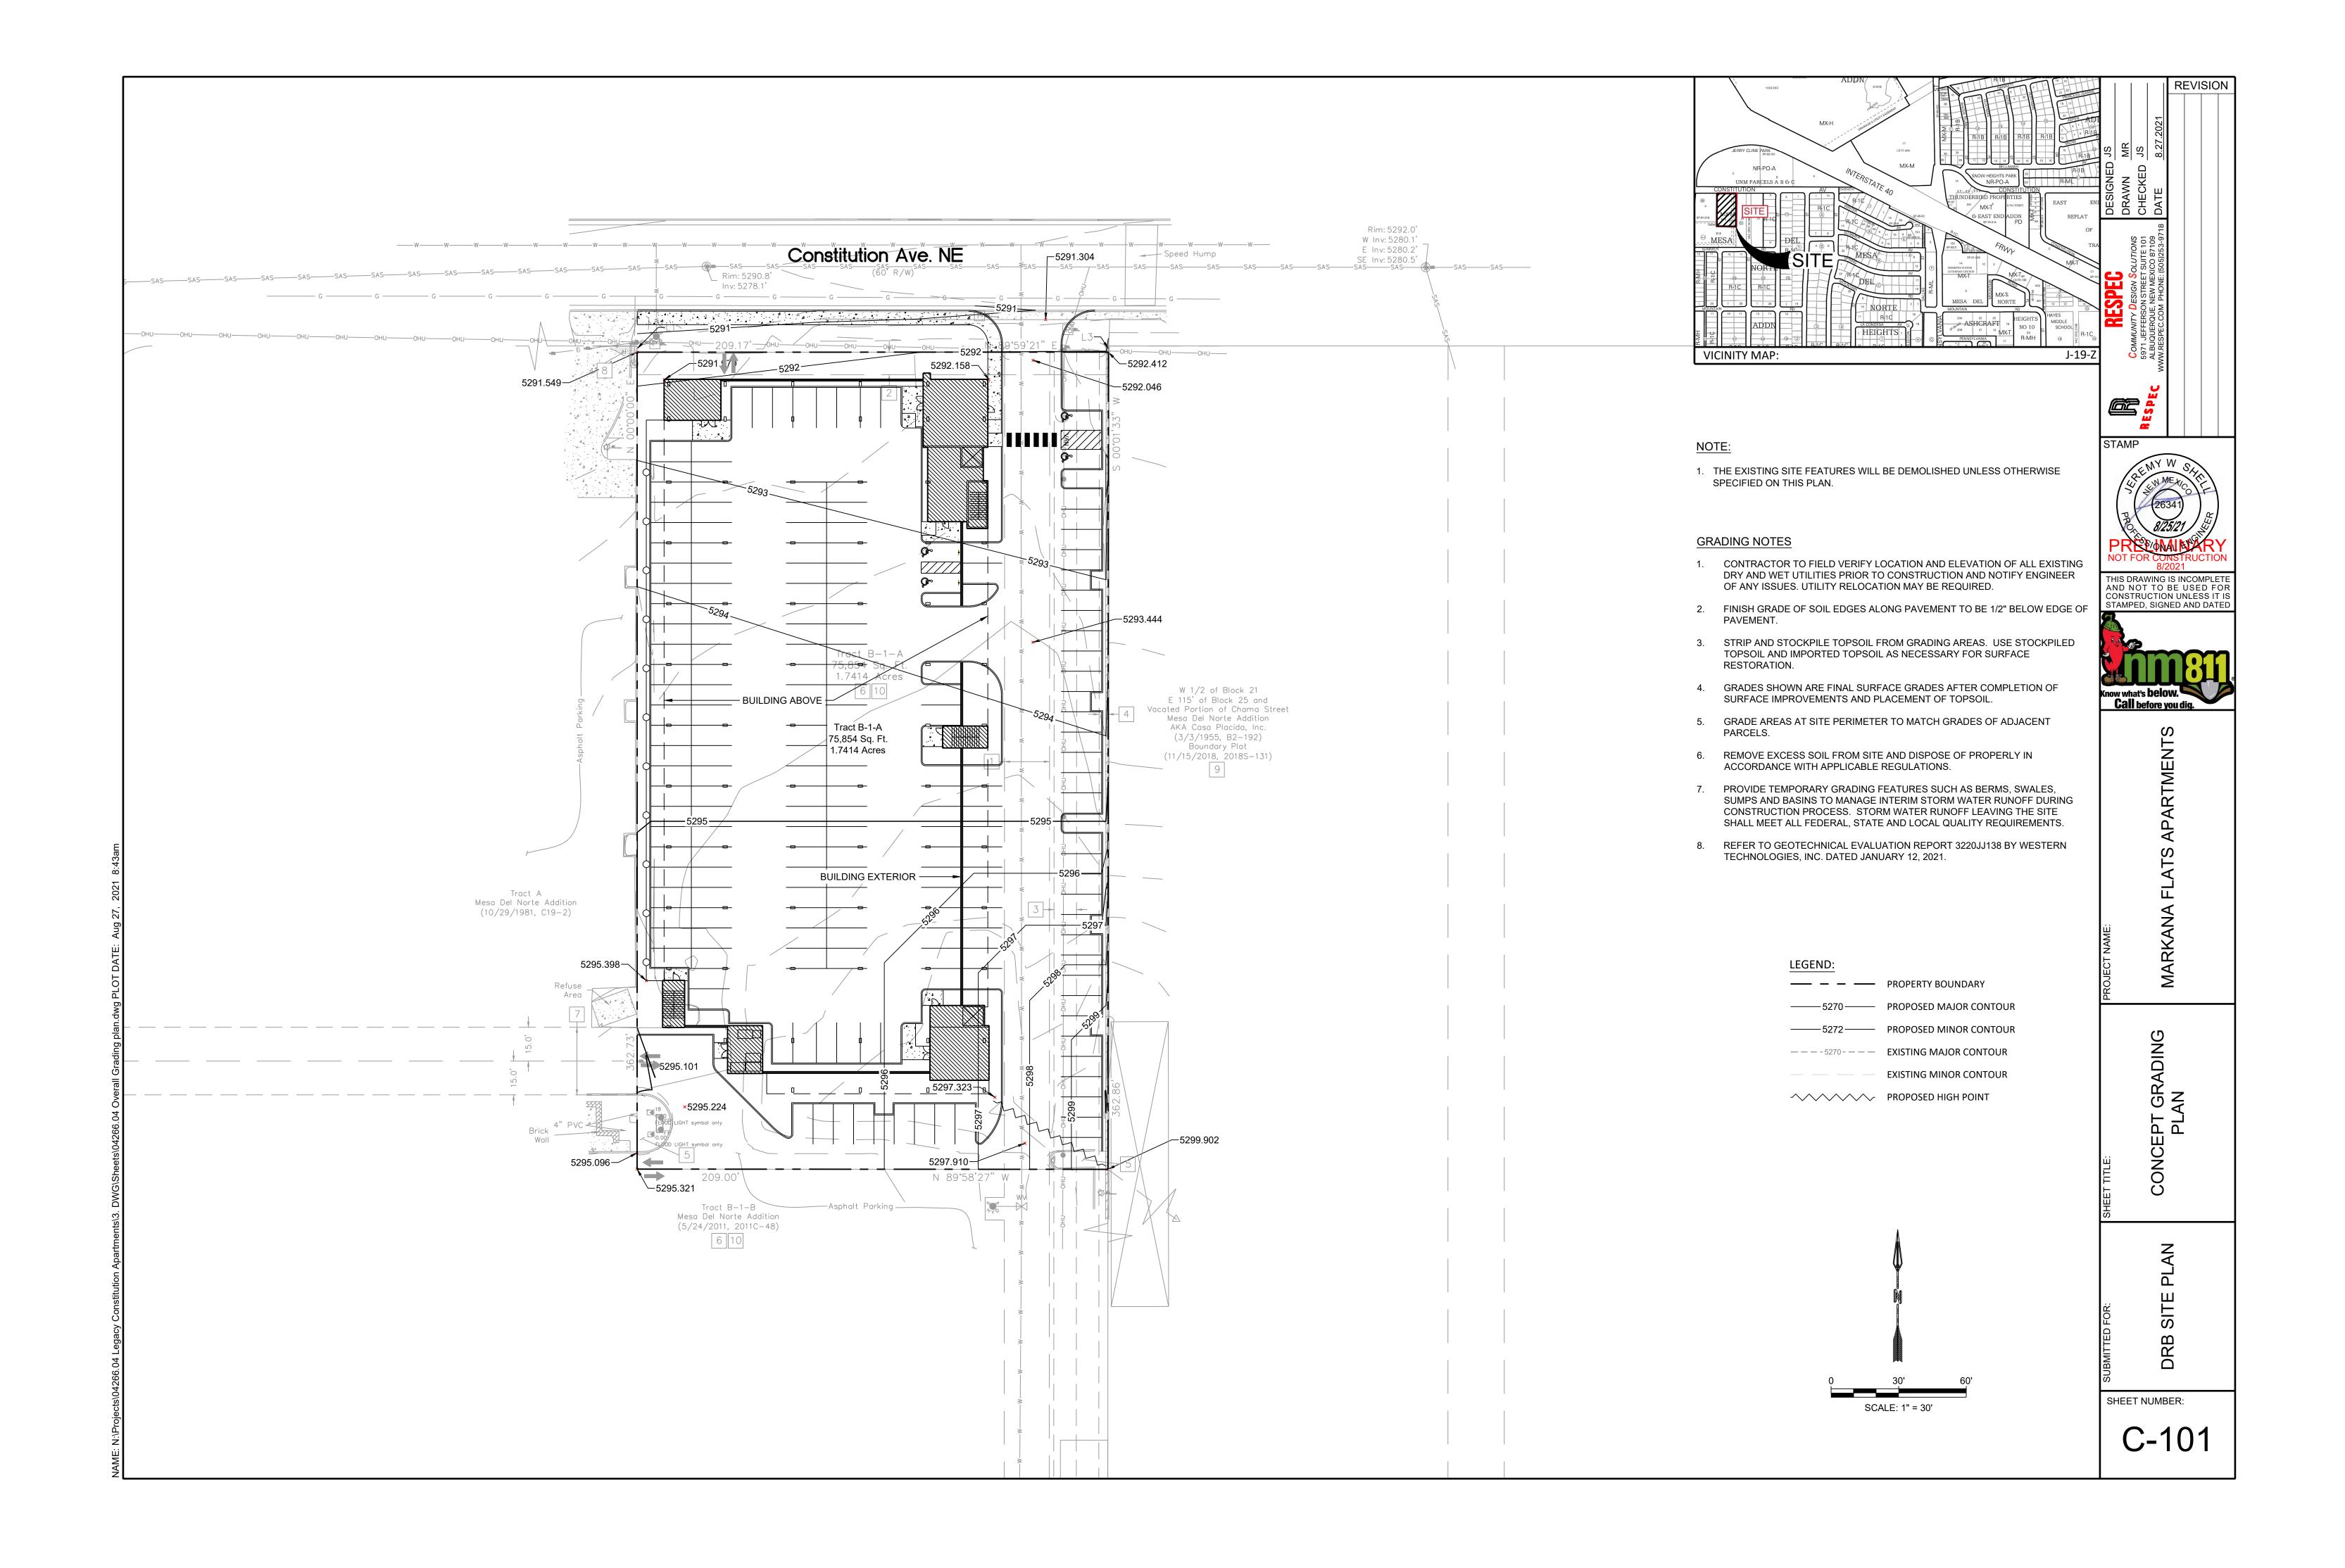

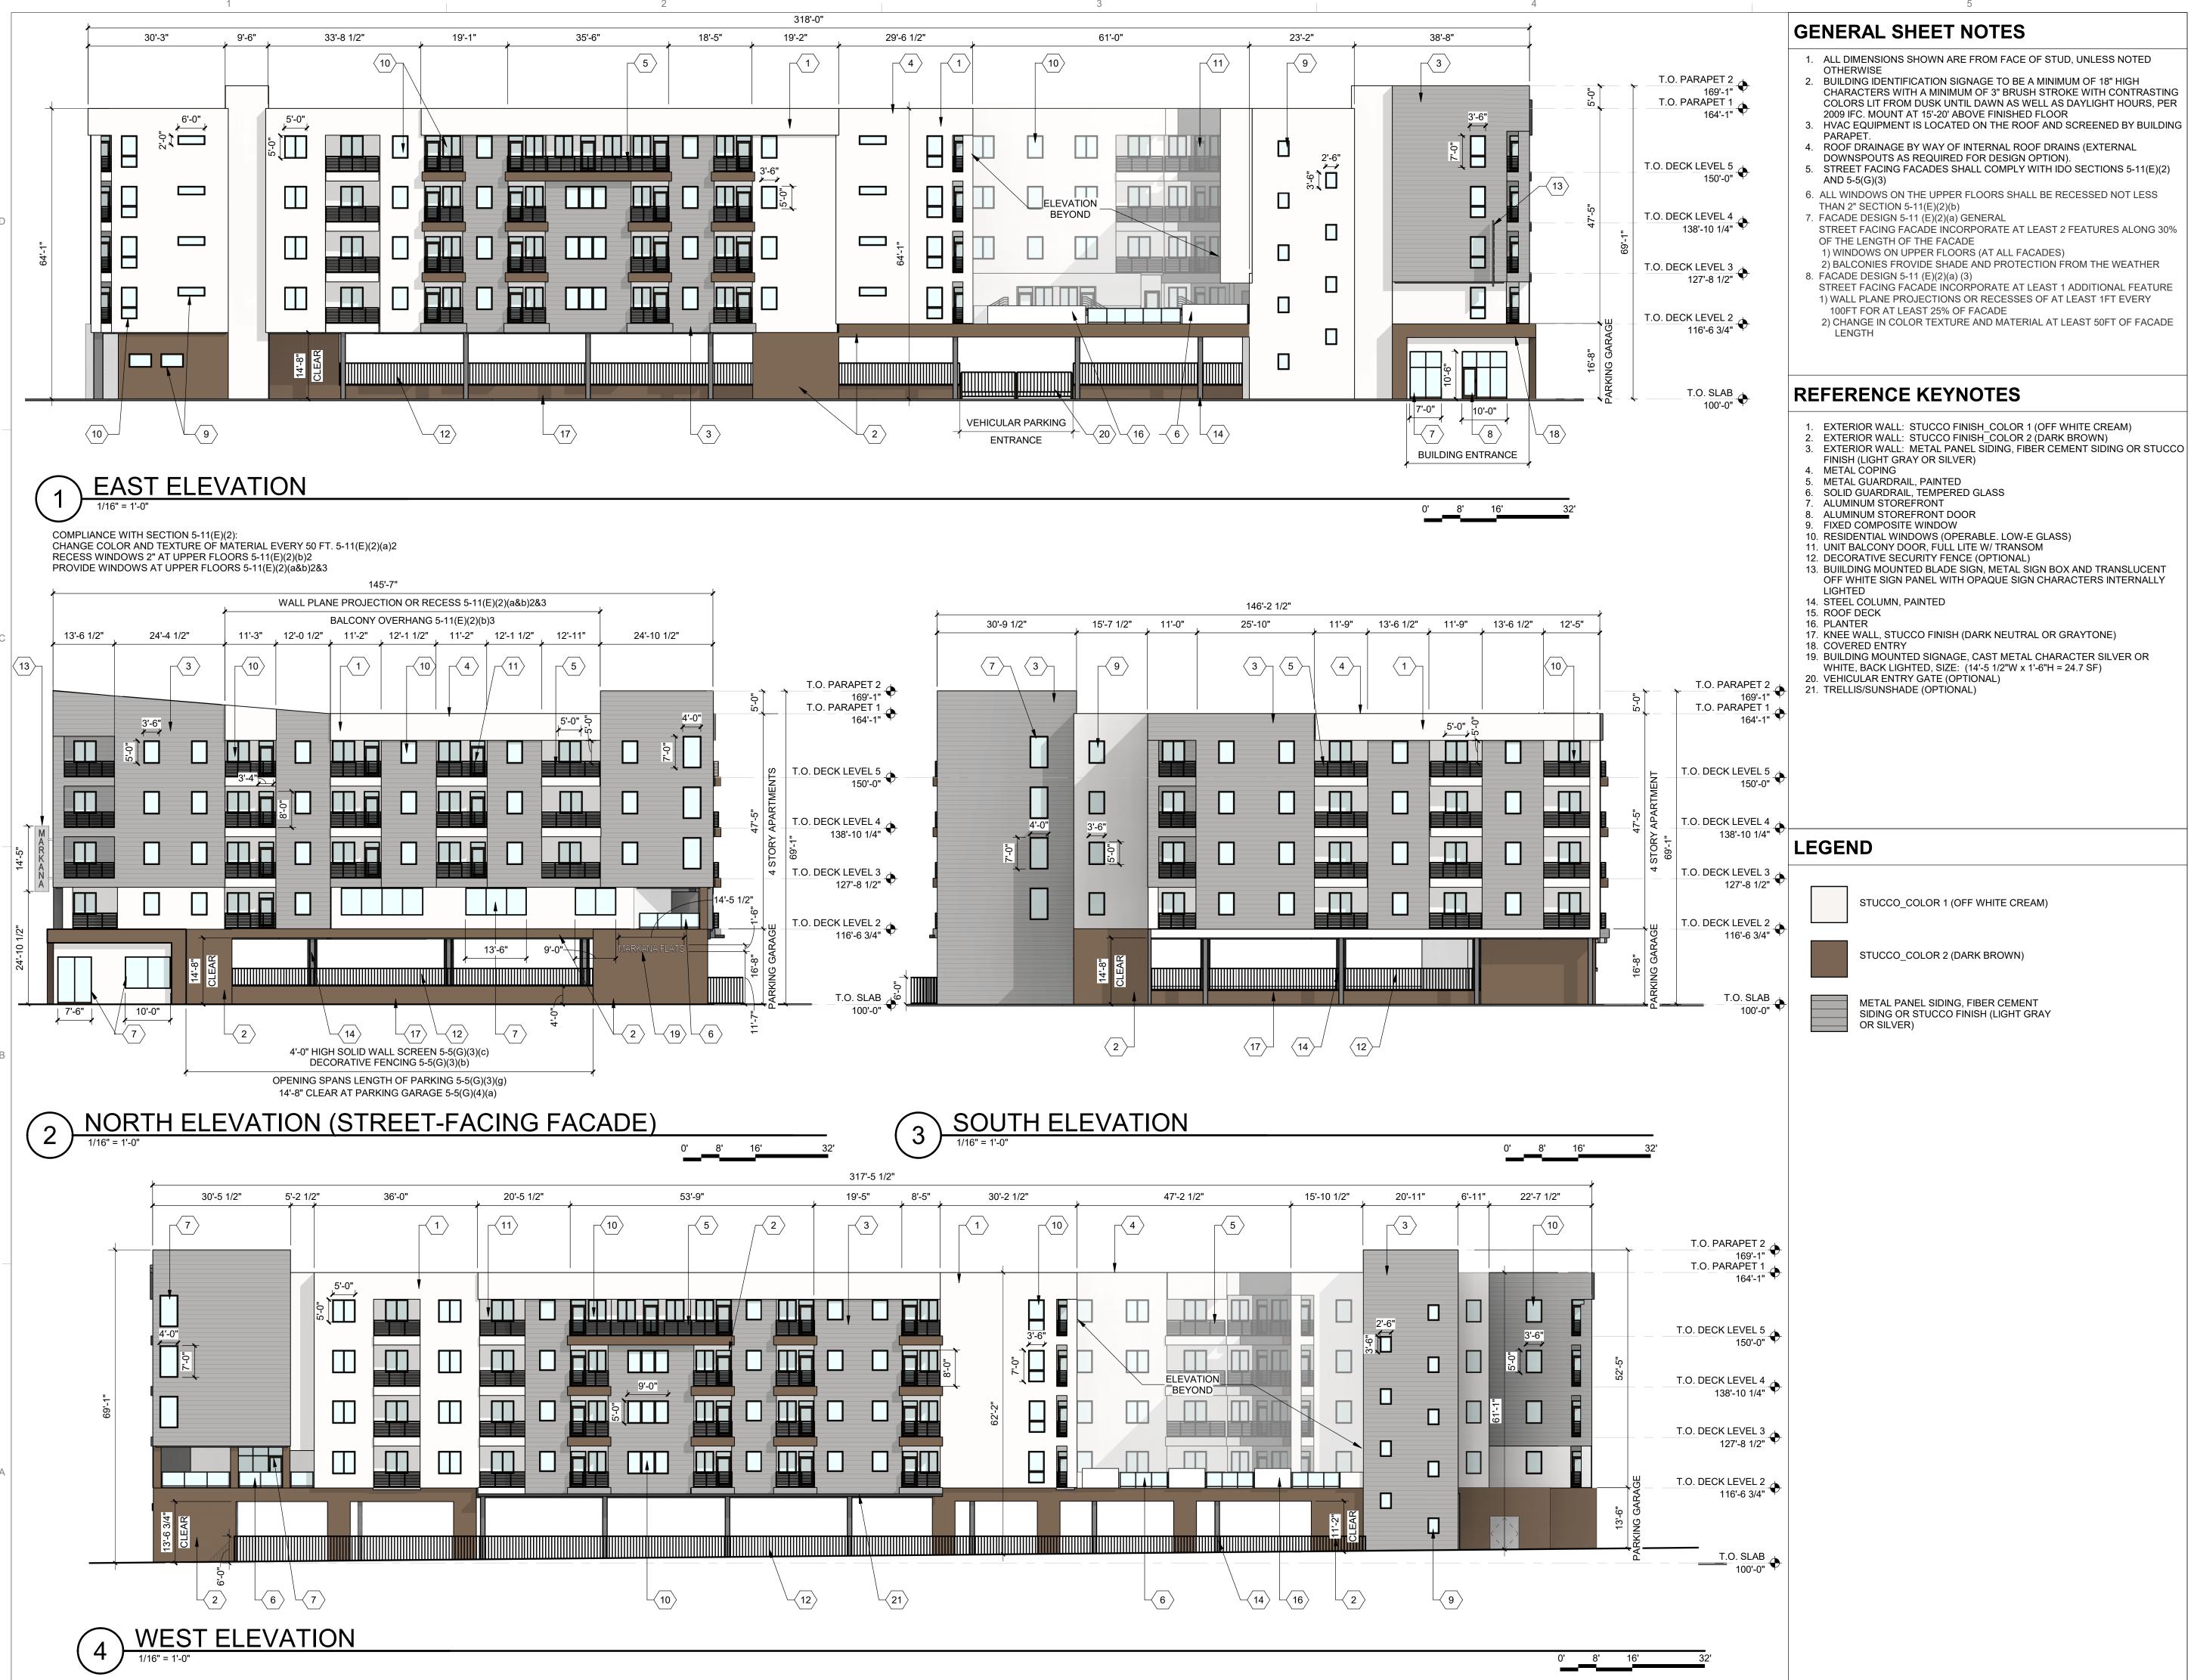

ARCHITECTURE IN PROGRESS

DEKKER
PERICH
SABATINI



SEAL

PROJECT

MAKKANA FLAIS LOUISIANA BLVD. NE ALBUQUERQUE, NM 87110

DRB SUBMITTAL

DRAWN BY

SP, AG

REVIEWED BY

DM

DATE

6/30/2021


PROJECT NO: 21-0020

DRAWING NAME

EXTERIOR ELEVATIONS

SDP5.1

DEK PER SAB

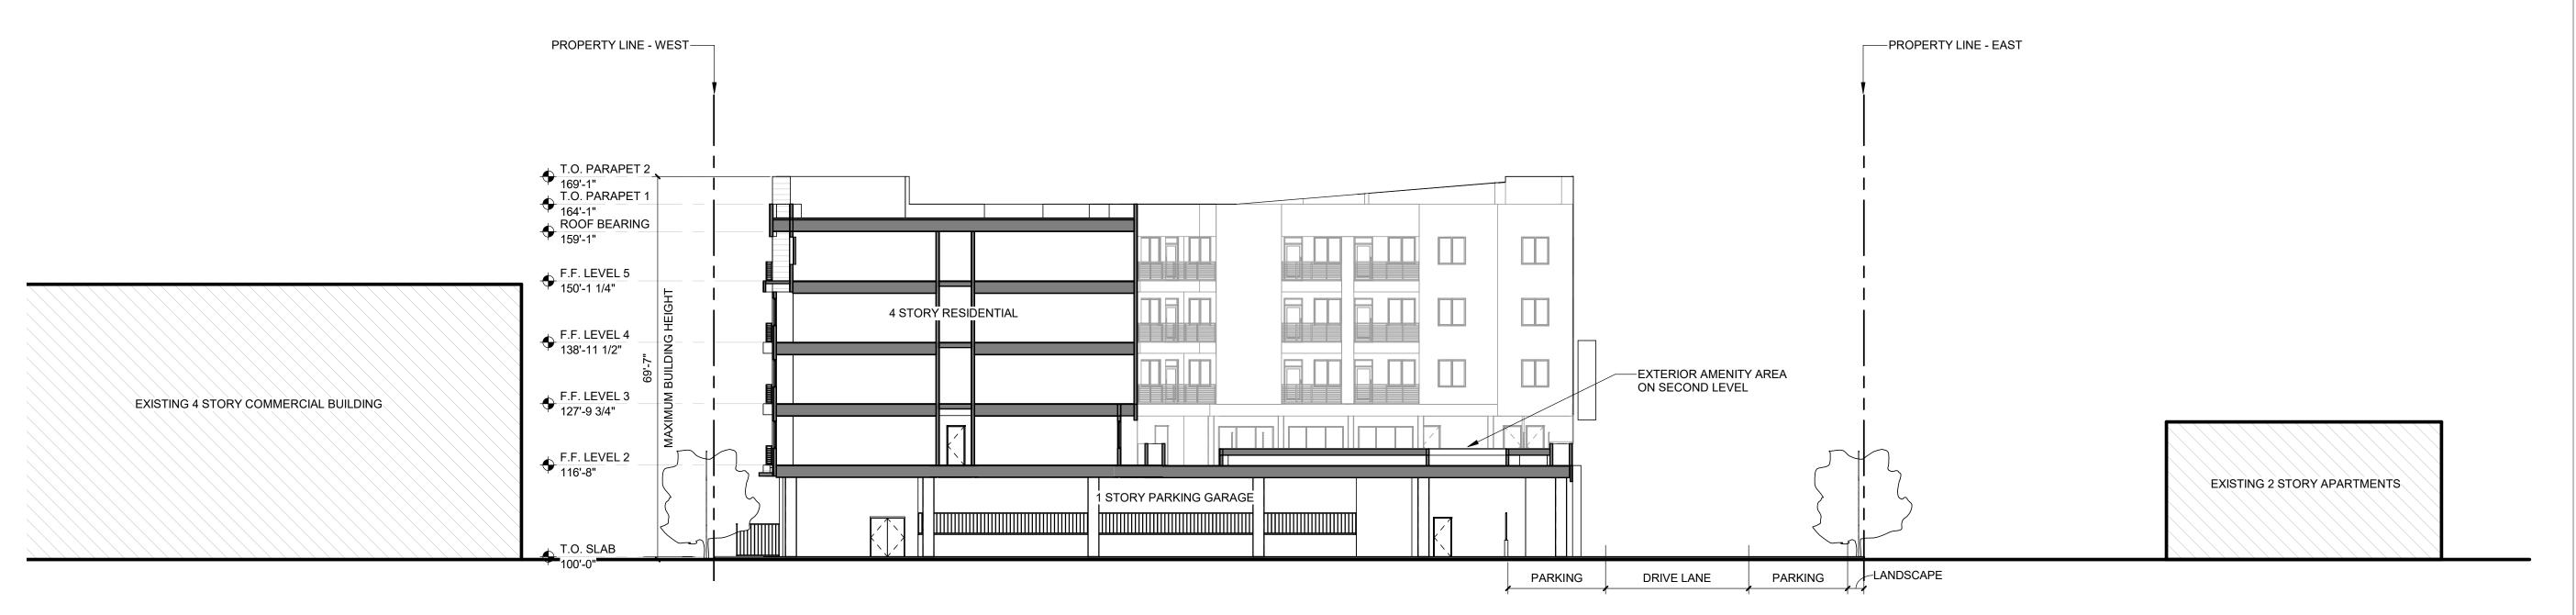

1) SITE SECTION NORTH

8' 16'

DEKKER PERICH SABATINI

ARCHITECTURE IN PROGRESS

PROJECT

MARKANA FLATS
LOUISIANA BLVD. NE
ALBUQUERQUE, NM 87110

DRB SUBMITTAL

DRAWN BY SP

REVIEWED BY DM

DATE 6/30/2021

21-0020

DRAWING NAME

PROJECT NO:

SITE SECTION

SDP5.2

MG 00.00.01 12.00.00 DM

DEKKER PERICH SABATINI

SEAL

MARKANA FLATS LOUISIANA BLVD. NE ALBUQUERQUE, NM 87110

DRB SUBMITTAL

WN BY SI
IEWED BY DN

REVIEWED BY DM

DATE 6/30/2021

PROJECT NO: 21-0020

DRAWING NAME

AERIAL VIEWS

SDP5.3







PR-2021-005689_SI-2021-00987_Site_Plan_Am endment_Approved_9-15-21_Signature_Sheets

Final Audit Report 2021-09-20

Created: 2021-09-16

By: Jay Rodenbeck (jrodenbeck@cabq.gov)

Status: Signed

Transaction ID: CBJCHBCAABAANjUvpZzfaeHyjNR0By4G5FFpziaDkVaX

"PR-2021-005689_SI-2021-00987_Site_Plan_Amendment_Approved_9-15-21_Signature_Sheets" History

- Document created by Jay Rodenbeck (jrodenbeck@cabq.gov) 2021-09-16 10:14:40 PM GMT- IP address: 143.120.132.106
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