
ADMINISTRATIVE AMENDMENT		
FILE #: PROJECT #:		
APPROVED BY	DATE	

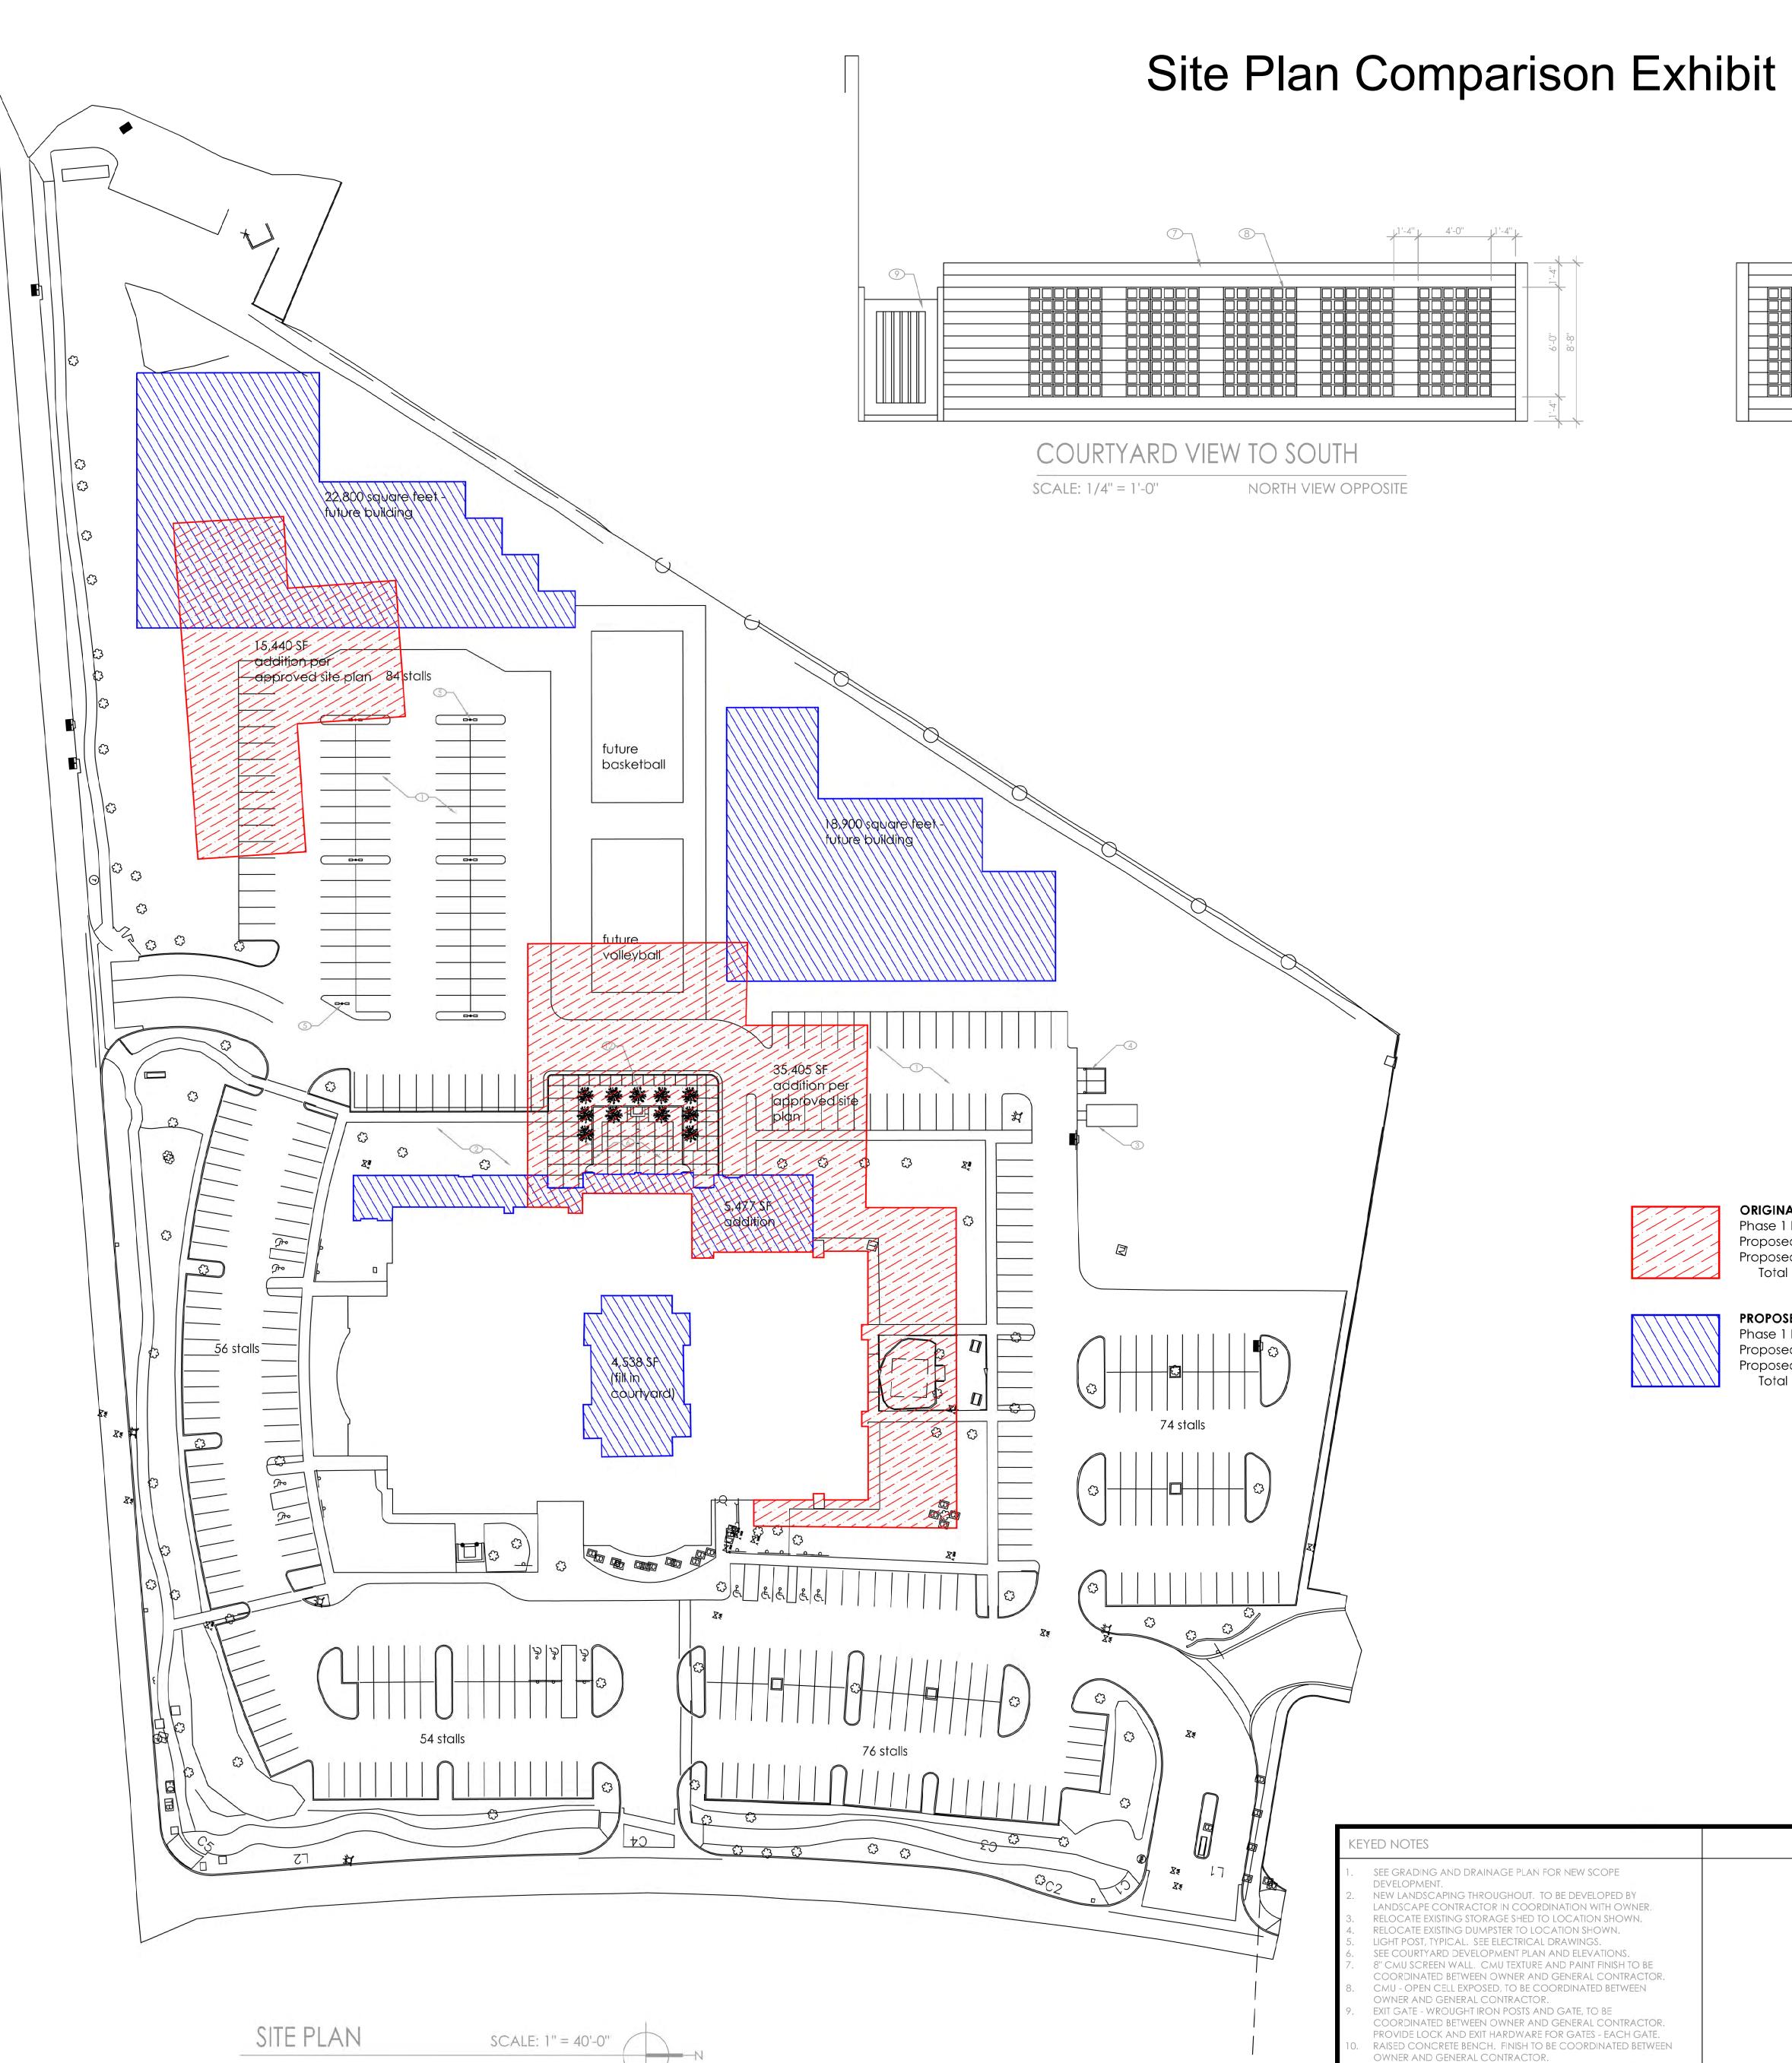

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COURTYARD VIEW TO WEST

SCALE: 1/4'' = 1'-0''

40,253 SF 35,405 SF <u>15,440 SF</u> 91,098 SF


40,253 SF 10,015 SF

41,700 SF 91,968 SF

	ORIGINAL APPROVAL
	Phase 1 Building
1////	Proposed Additions
/////	Proposed New Buildings
	Total Buildings

	PROPOSED
$\mathbf{N}$	Phase 1 Building
N	Proposed Additions
$\backslash$	Proposed New Buildings
$\backslash$	Total Buildings


		705
	GENERAL NOTES	Architect (
DPED BY ITH OWNER. I SHOWN, DWN.  ITIONS. FINISH TO BE CONTRACTOR. D BETWEEN BE CONTRACTOR. - EACH GATE. NATED BETWEEN ED BY ITH OWNER. IDSCAPE	<ul> <li>389 PARKING STALLS ARE PROPOSED ON-SITE.</li> <li>PER CITY OF ALBUQUERQUE PARKING REQUIREMENTS: <ul> <li>14.16.3.1 (A) (3) - ONE STALL IS REQUIRED PER EVERY FOUR SEATS IN SANCTUARY.</li> <li>SANCTUARY.</li> <li>SANCTUARY SEATING CAPACITY IS 901.</li> <li>226 PARKING STALLS ARE REQUIRED.</li> <li>PER CITY REQUIREMENTS - 8 MINIMUM MUST BE HANDICAPPED ACCESSIBLE.</li> <li>12 EXISTING HANDICAPPED ACCESSIBLE PARKING STALLS ARE PROVIDED.</li> </ul> </li> <li>FUTURE SCOPE PRESUMPTIONS: <ul> <li>ADDITIONAL BUILD OUT ON-SITE MAY BE 41,700 SQUARE FEET OF EDUCATIONAL FACILITY.</li> <li>EDUCATIONAL PARKING REQUIREMENTS PER CITY ARE EXTREMELY VAGUE (WITHOUT ADDITIONAL DESIGN DEVELOPMENT ESTABLISHED). ASSUME 250 STUDENT CAPACITY.</li> <li>PERHAPS 150 PARKING STALLS REQUIRED.</li> <li>REQUIRED PARKING IS THUS ACCOMMODATED EXCEPT THAT ADDITIONAL HANDICAPPED PARKING WOULD BE NEEDED.</li> </ul> </li> </ul>	3003 MC ALBU Stamp Date Issued JUNE Sheet Name

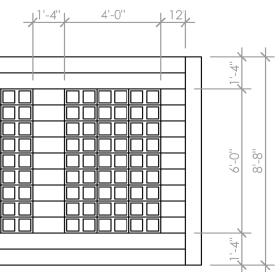


SYMBOLS			
KEYED NOTE INTERIOR ELEVATION FRAME ELEVATION WALL SECTION ENLARGED FLOOR PLAN DETAIL REFERENCE	7		
Project DESERT SPRINGS CHURCH - EXPANSION 705 Osuna Road, NE, Albuquerque, NM 87113			
Architect CTBASSOCIATES A R C H I T E C T S • P L A N N E R S 3003 MONTE VISTA BLVD. NE ALBUQUERQUE, NM 87106 P. (505) 268-3033 F. (505) 212-0354 ctb@ctbassociates.com			
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# SITE PLAN



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Date Issued Sheet Name
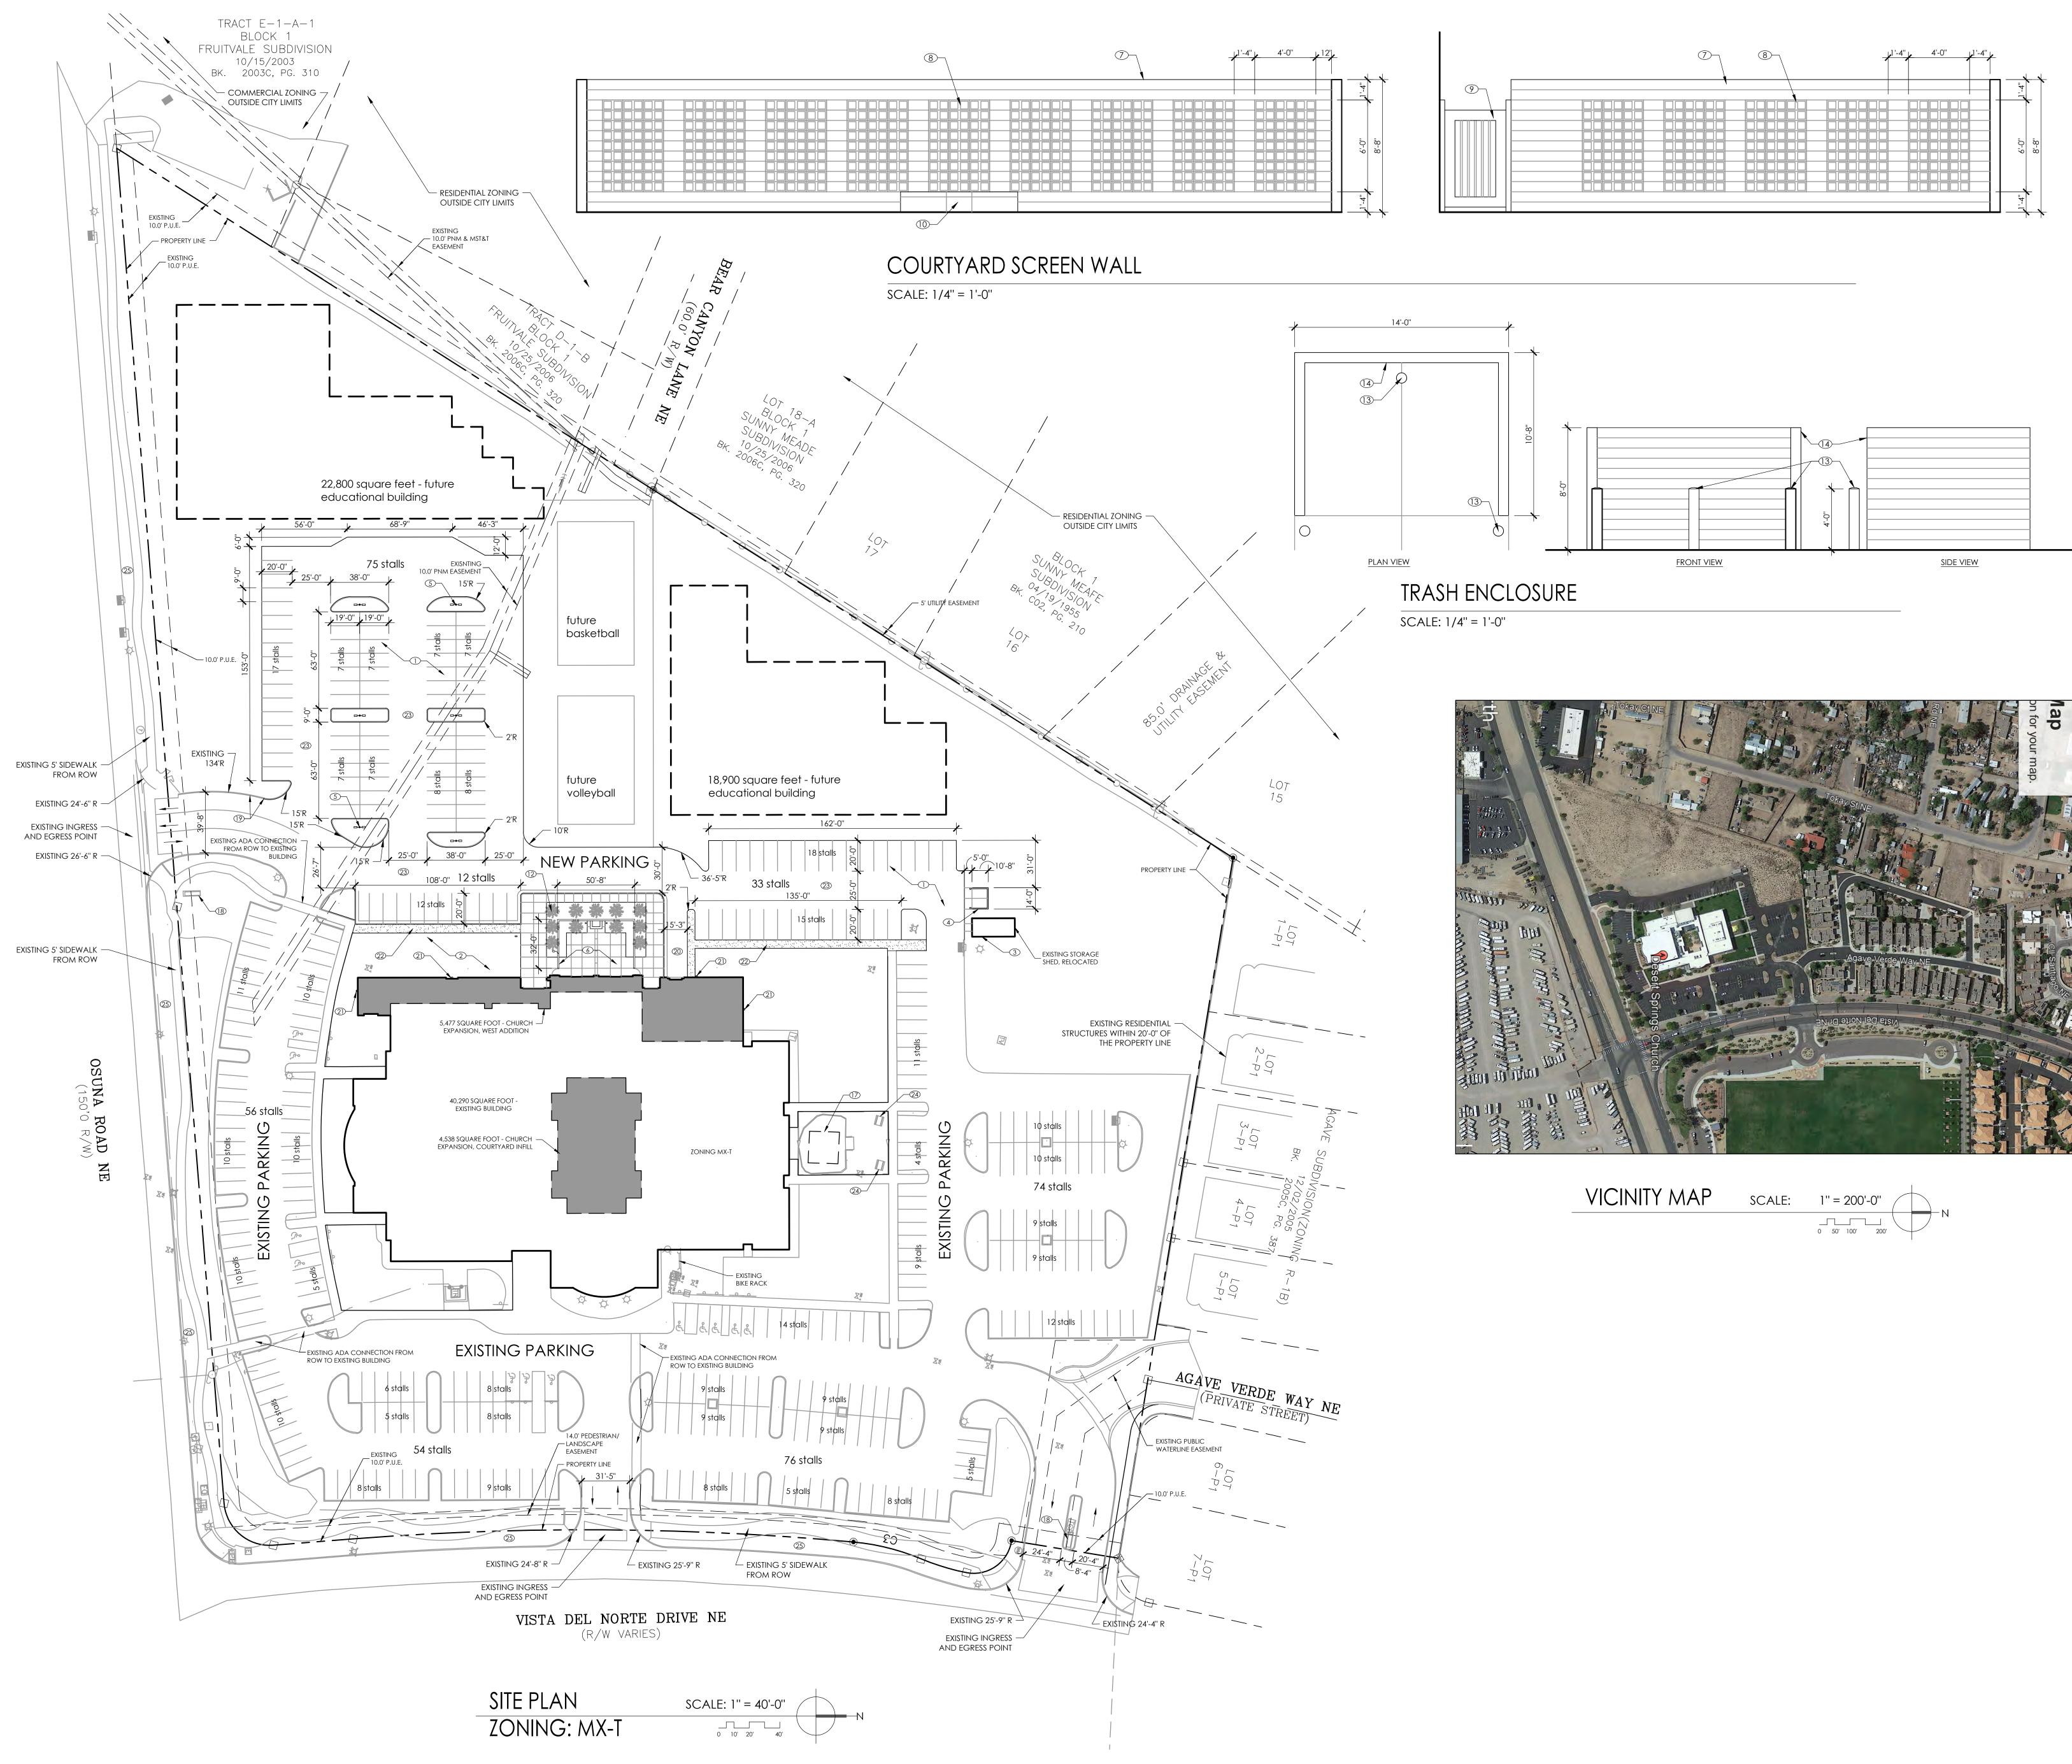
#### **KEYED NOTES**


SEE GRADING AND DRAINAGE PLAN FOR NEW SCOPE DEVELOPMENT. NEW LANDSCAPING THROUGHOUT. TO BE DEVELOPED BY LANDSCAPE CONTRACTOR IN COORDINATION WITH OWNER. RELOCATE EXISTING STORAGE SHED TO LOCATION SHOWN. RELOCATE EXISTING DUMPSTER TO LOCATION SHOWN. DUAL HORIZONTAL LIGHT FIXTURE SIDE ARM MOUNTED TOP OF 20'-0" POLE, TYPICAL. (MANUFACTURE - GARDCO 101L-16L-530-NW-G1-3-UNV-CE50-BZ) SEE ELECTRICAL DRAWINGS. SEE COURTYARD DEVELOPMENT PLAN AND ELEVATIONS. 8" CMU SCREEN WALL. CMU TEXTURE AND PAINT FINISH TO BE COORDINATED BETWEEN OWNER AND GENERAL CONTRACTOR. SEE STRUCTURAL DRAWINGS FOR FOOTING DETAIL. CMU - OPEN CELL EXPOSED, TO BE COORDINATED BETWEEN OWNER AND GENERAL CONTRACTOR. EXIT GATE - WROUGHT IRON POSTS AND GATE, TO BE COORDINATED BETWEEN OWNER AND GENERAL CONTRACTOR. PROVIDE LOCK AND EXIT HARDWARE FOR GATES - EACH GATE. RAISED CONCRETE BENCH. FINISH TO BE COORDINATED BETWEEN OWNER AND GENERAL CONTRACTOR. RAISED PLANTER - LANDSCAPING TO BE DEVELOPED BY LANDSCAPE CONTRACTOR IN COORDINATION WITH OWNER. NEW LANDSCAPE BEDS, TO BE DEVELOPED BY LANDSCAPE CONTRACTOR IN COORDINATION WITH OWNER. . 8" STEEL PIPE BOLLARD FILLED WITH CONCRETE. 4. 8" CMU TRASH ENCLOSURE WALL. CMU TEXTURE AND PAINT FINISH TO BE COORDINATED BETWEEN OWNER AND GENERAL CONTRACTOR. SEE STRUCTURAL DRAWING FOR FOOTING DETAIL. ELECTRICAL IN-GRADE JUNCTION BOX, SEE ELECTRICAL DRAWINGS. ELECTRICAL RECEPTACLE BOX, SEE ELECTRICAL DRAWINGS. EXISTING PLAYGROUND EQUIPMENT WITH SHADE CANOPY. B. EXISTING FREESTANDING MONUMENT SIGNS. P. EXISTING CURB TRANSITION TO NEW PARKING CURB. 20. NEW VEHICULAR DRIVE-UP ACCESS. 1. WALL MOUNTED CUTOFF TYPE LED WALL PACK, 12'-0" A.F.F. (MANUFACTURE - GARDCO 101L-16L-530-NW-G1-3-UNV-CE50-BZ) 2. NEW 5'-0" WIDE CONCRETE SIDEWALK. 23. HEAVY DUTY ASPHALT PAVING. 24. EXISTING PICNIC TABLE. 25. EXISTING LANDSCAPE BUFFER AREA. GENERAL NOTES 380 PARKING STALLS ARE PROPOSED ON-SITE. PER CITY OF ALBUQUERQUE PARKING REQUIREMENTS: • 14.16.3.1(A)(3) - ONE STALL IS REQUIRED PER EVERY FOUR SEATS IN SANCTUARY. • SANCTUARY SEATING CAPACITY IS 901. • 226 PARKING STALLS ARE REQUIRED. PER CITY REQUIREMENTS - 8 MINIMUM MUST BE HANDICAPPED ACCESSIBLE. • 12 EXISTING HANDICAPPED ACCESSIBLE PARKING STALLS ARE PROVIDED. FUTURE SCOPE PRESUMPTIONS: ADDITIONAL BUILD OUT ON-SITE MAY BE 41,700 SQUARE FEET OF EDUCATIONAL FACILITY. EDUCATIONAL PARKING REQUIREMENTS PER CITY REQUIRE ADDITIONAL DESIGN DEVELOPMENT ESTABLISHED. ASSUME 250 STUDENT CAPACITY. • PERHAPS 150 PARKING STALLS REQUIRED. REQUIRED PARKING IS THUS ACCOMMODATED EXCEPT THAT ADDITIONAL HANDICAPPED PARKING WOULD BE NEEDED. Symbols KEYED NOTE FOUND CONTROL MONUMENT (AS NOTED) ◬  $\Box$ Found Rebar (as noted) Found PK nail (AS noted) SET 1/2" REBAR WIT CAP STAMPED "CA MEDINA PS 15702" (UNLESS OTHERWISE NOTED) FIRE DEPARTMENT CONNECTION **IRRIGATION VALVE** BD HOT BOX FIRE HYDRANT WATER METER WATER VALVE CLEANOUT Sanitary sewer manhole S CURB INLET AREA INLET GAS METER

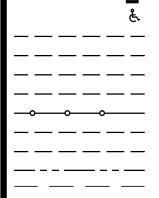ELECTRIC MANHOLE E TRANSFORMER TRAFFIC LIGHT -₩-← GUY WIRE ELECTRIC BOX E EPB ELECTRIC PULLBOX TCB JUNCTION BOX LIGHT POLE Φ. POWER POLE TELEPHONE PEDESTAL Π 🖸 CABLE TV TB TELEPHONE PULLBOX FIBER OPTIC PULLBOX **TELEPHONE MANHOLE** • BOLLARD 🗕 SIGN FINISH FLOOR ELEVATION >--- BIKE RACK PICNIC TABLE HANDICAP PARKING – – – – UNDERGROUND ELECTRIC LINE – – – – UNDERGROUND GAS LINE UNDERGROUND SANITARY SEWER LINE OVERHEAD POWER — — — — — WIRE FENCE — – – — – – — PROPERTY LINE — — EASEMENT

### DESERT SPRINGS CHURCH expansion

705 Osuna Road, NE, Albuquerque, NM 87113


CTBASSOCIATES ARCHITECTS • PLANNERS MONTE VISTA BLVD. NE BUQUERQUE, NM 87106 P. (505) 268-3033 F. (505) 212-0354 ctb@ctbassociates.com				
E NEW MEATS Charles T. Proger, Jr. 7/19/21 No. 2780	Revisions         1.         2.         3.			
LY 19, 2021 SITE	Sheet No. PLAN			

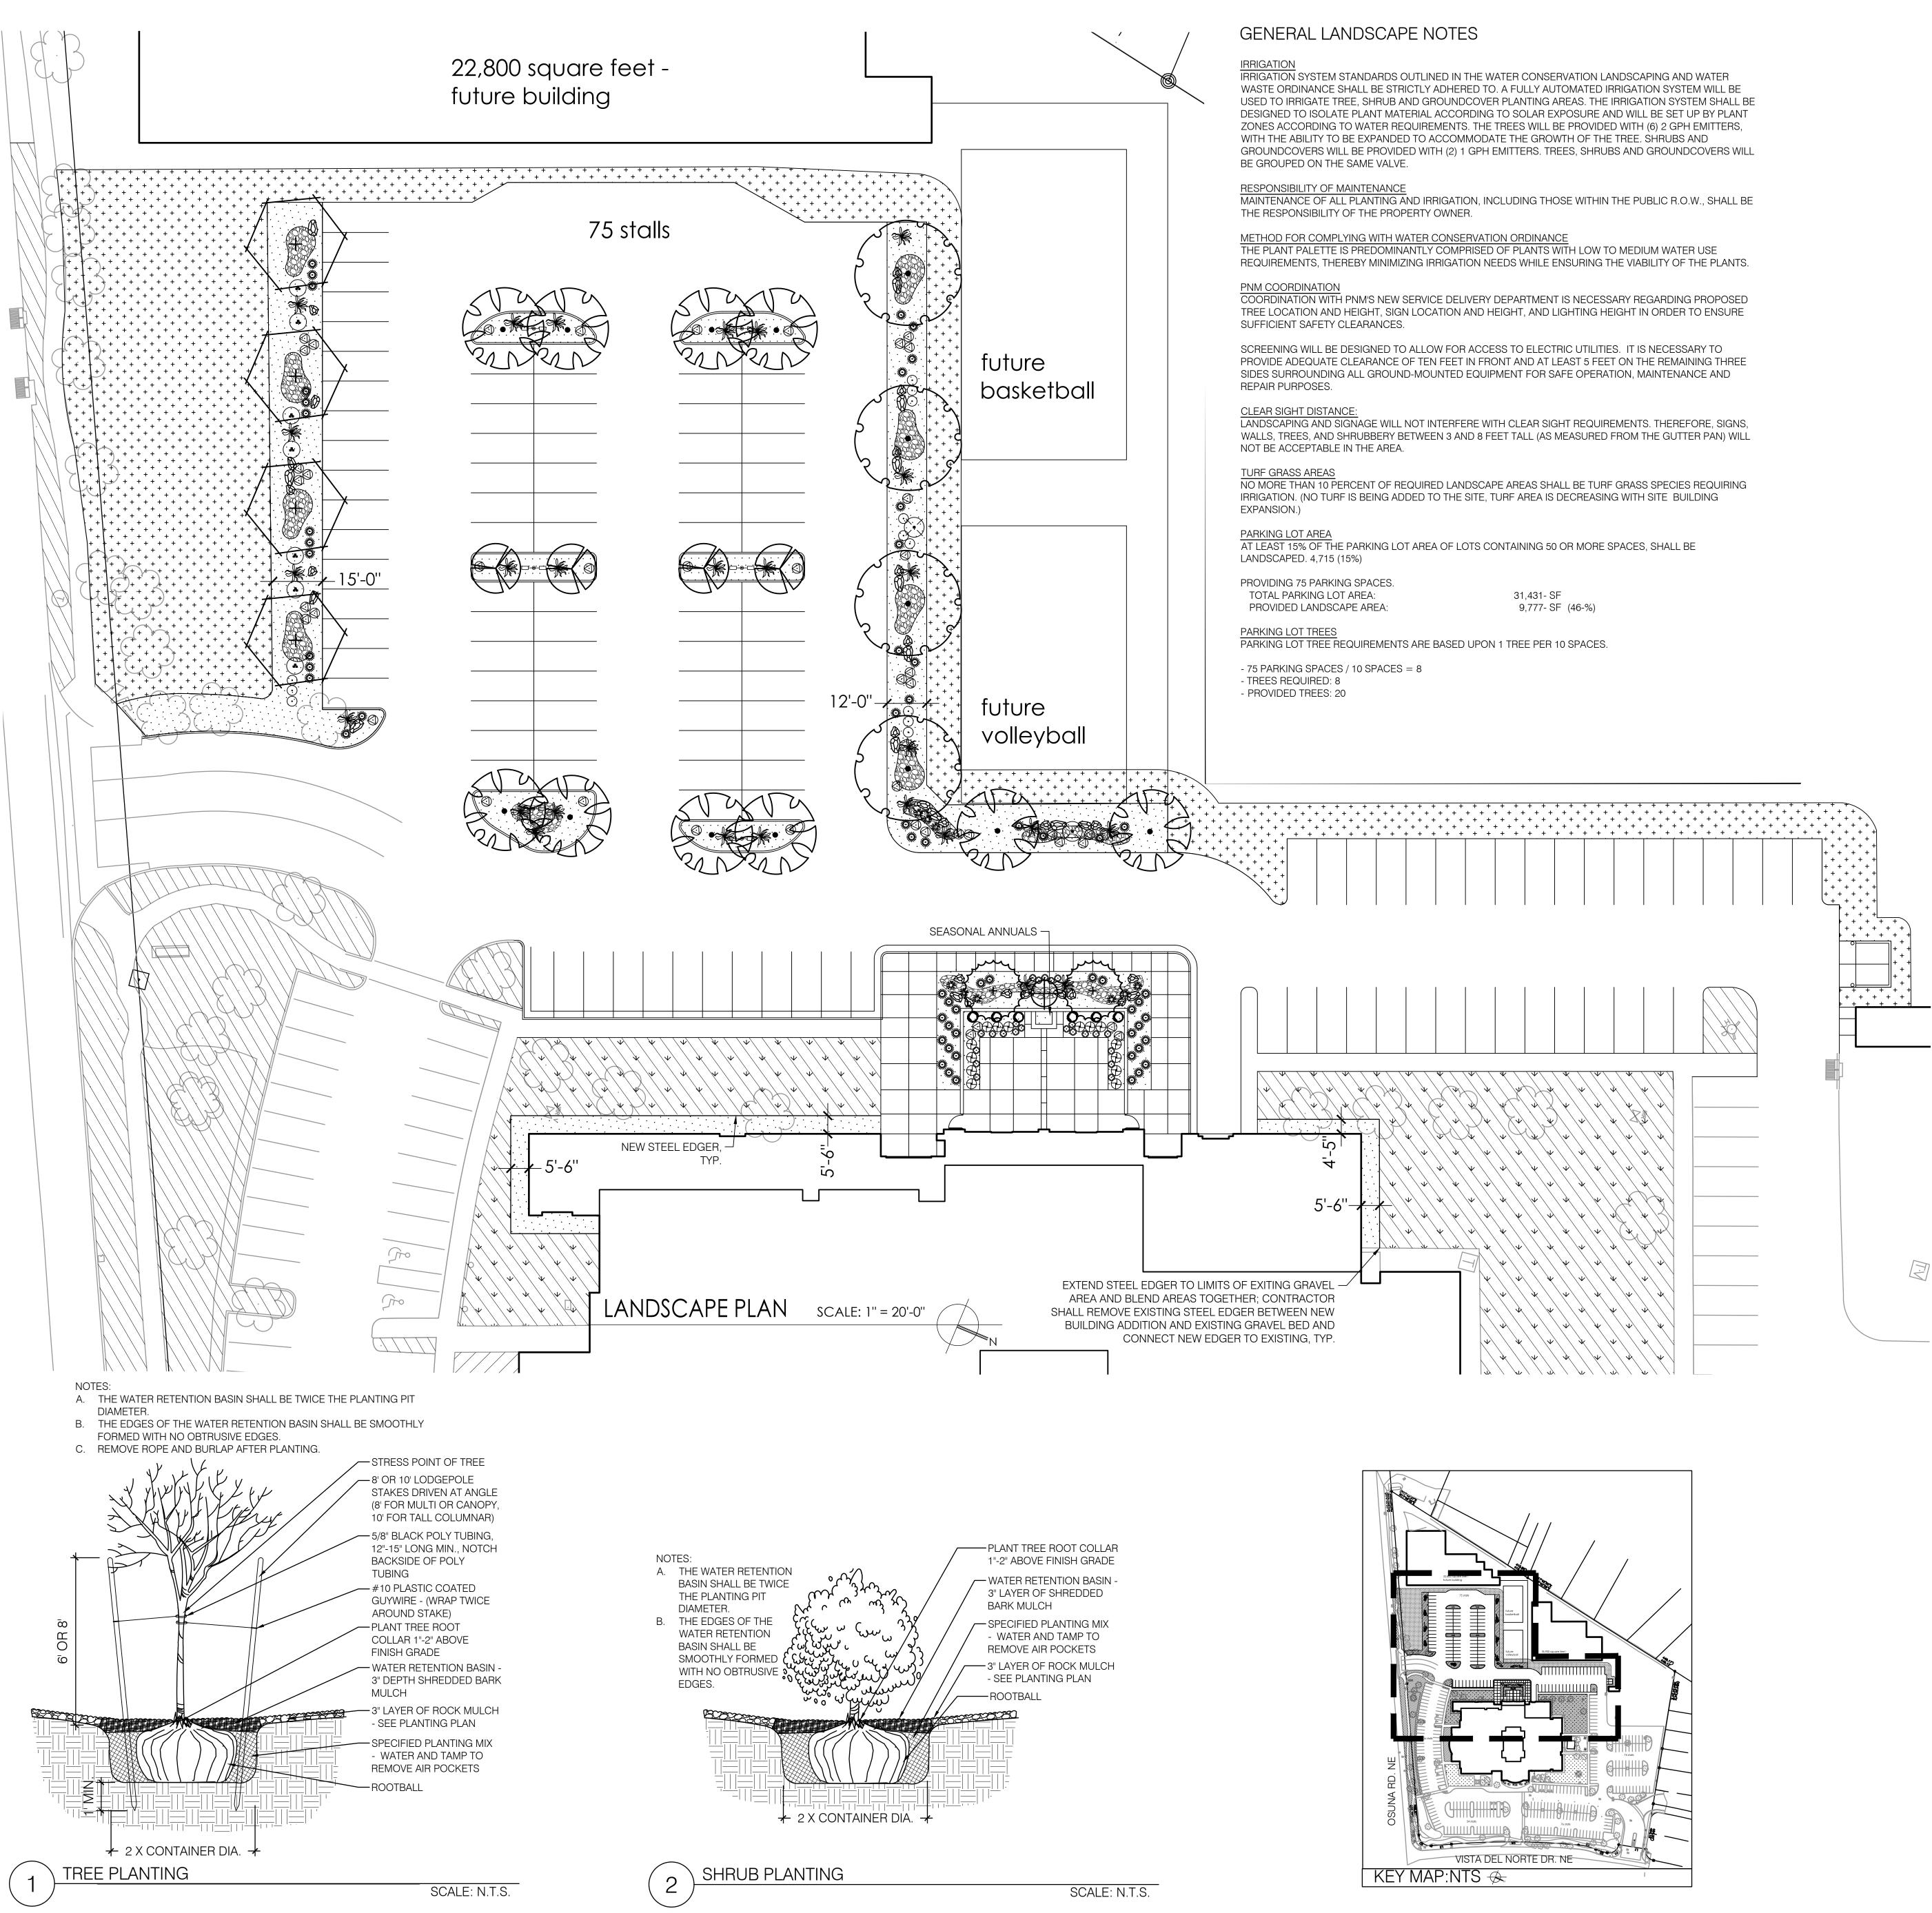

N LANDSCAPING AND WATER
ED IRRIGATION SYSTEM WILL BE
THE IRRIGATION SYSTEM SHALL BE
RE AND WILL BE SET UP BY PLANT
VIDED WITH (6) 2 GPH EMITTERS,
THE TREE. SHRUBS AND
HRUBS AND GROUNDCOVERS WILL

QTY.	SYMBOL	SCIENTIFIC NAME COMMON NAME (WATER USE)	SIZE	MATURE SIZE
	$\langle \cdot \rangle$	EXISTING TREE		
4	(·)	TREES GLEDITSIA TRICANTHOS INERMIS HONEY LOCUST 'SHADEMASTER'(H)	2.5"-CLPR	50 HT. X 45' SPR.
6	0	JUNIPERUS SCOPULORUM 'SKYROCKET' SKY ROCKET JUNIPER (FEMALES ONLY) (L)	15-GAL	15' HT. X 4' SPR.
10	A. A.	KOELREUTERIA PANICULATA GOLDEN RAIN TREE (M)	2"-CLPR	25' HT. X 25' SPR.
1	$\oplus$	LAGERSTROEMIA INDICA 'DYNAMITE' CREPE MYRTLE (L)	15-GAL	8" HT. X 8' SPR.
4	+	PISTACIA CHINENSIS CHINESE PISTACHE (M)	2"-CLPR	40' HT. X 30' SPR.
4	$\left\{ \right\}$	PYRUS CALLERYANA BRADFORD PEAR (M+)	2"-CLPR	25' HT. X 15' SPR.
2	+	VITEX AGNUS CASTUS CHASTE TREE (M)	2"-CLPR	20' HT. X 20' SPR.
		SHRUBS AND GROUNDCOVERS		
7		ARTEMISIA CANA SILVER SAGE (M+)	1-GAL	3" HT. X 5' SPR.
43	$\bigcirc \bigcirc$	LAVANDULA AGUSTIFOLIA LAVENDER (M)	1-GAL	3 HT. X 3' SPR.
2	$( \mathbf{\cdot} )$	PINUS MUGO VAR PUMILIO MUGO PINE (M)	5-GAL	3' HT. X 4' SPR.
14	$\oplus$	ROSA 'DOUBLE RED KNOCKOUT' DOUBLE RED KNOCK OUT ROSE (M)	3-GAL	3' HT. X 3' SPR.
27	Ř	ROSMARIUS OFFICINALIS 'PROSTRATUS' CREEPING ROSEMARY (L+)	1-GAL	2" HT. X 6' SPR.
23	$\bigcirc$	SEDUM REFEXUM 'BLUE SPRUCE' STONE CROP (L+)	1-GAL	2" HT. X 2' SPR.
12	•	SALVIA GREGGII CHERRY SAGE (L+)	1-GAL	2' HT. X 3' SPR.
		ORNAMENTAL GRASSES		
9	S MAR	CALAMAGROSTIS X ACUTIFLORA KARL FOERSTER GRASS (M)	1-GAL	2' HT. X 30" SPR.
59	燚	MUHLENBERGIA CAPILLARIS REGAL MIST MUHLY (L+)	1-GAL	2' HT. X 3' SPR.
58	90	MULCHES AND BOULDERS LANDSCAPE BOULDER, MOSS ROCK (TO M	ATCH EXISTI	NG), SIZE: 3'X3' MIN.
		3/4" SANTA FE BROWN GRAVEL MULCH (TO (2" DEPTH OVER FILTER FABRIC DEWITT PRO		
	+ + + + + + + + + + + + + + + + + + +	RE-VEGETATIVE SEEDING: AREAS SHALL BE REVEGETATED BY HYDROMULCH TACKIFIER APPLICATION PER COA SPECIFICATION SECTION 1012 (SANDY SOILS). CONTRACTOR SHALL APPLY REVEGETATED SEED TO LIMITS OF DISTURBANCE.		
	* *	EXISTING TURF- ADJUST TO NEW LIMITS		
		EXISTING LANDSCAPE AREA TO REMAIN		
		2"-4" GREY ROUND RIVER ROCK (TO MATCH (6" DEPTH OVER FILTER FABRIC DEWITT PRO		ONTROL, OR EQUAL)

PLANT LEGEND

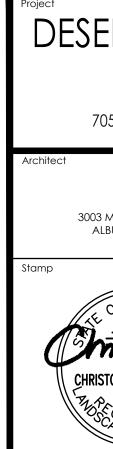




CONSENSUS PLANNING, INC. Planning / Landscape Architecture 302 Eighth Street NW Albuquerque, NM 87102 CONSENSUS (505) 764-9801 Fax 842-5495


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DESERT SPRINGS CHURCH - EXPANSION 705 Osuna Road, NE, Albuquerque, NM 87113			
Architect $\begin{array}{c ccccccccccccccccccccccccccccccccccc$			
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GRADING AND DRAINAGE PLAN

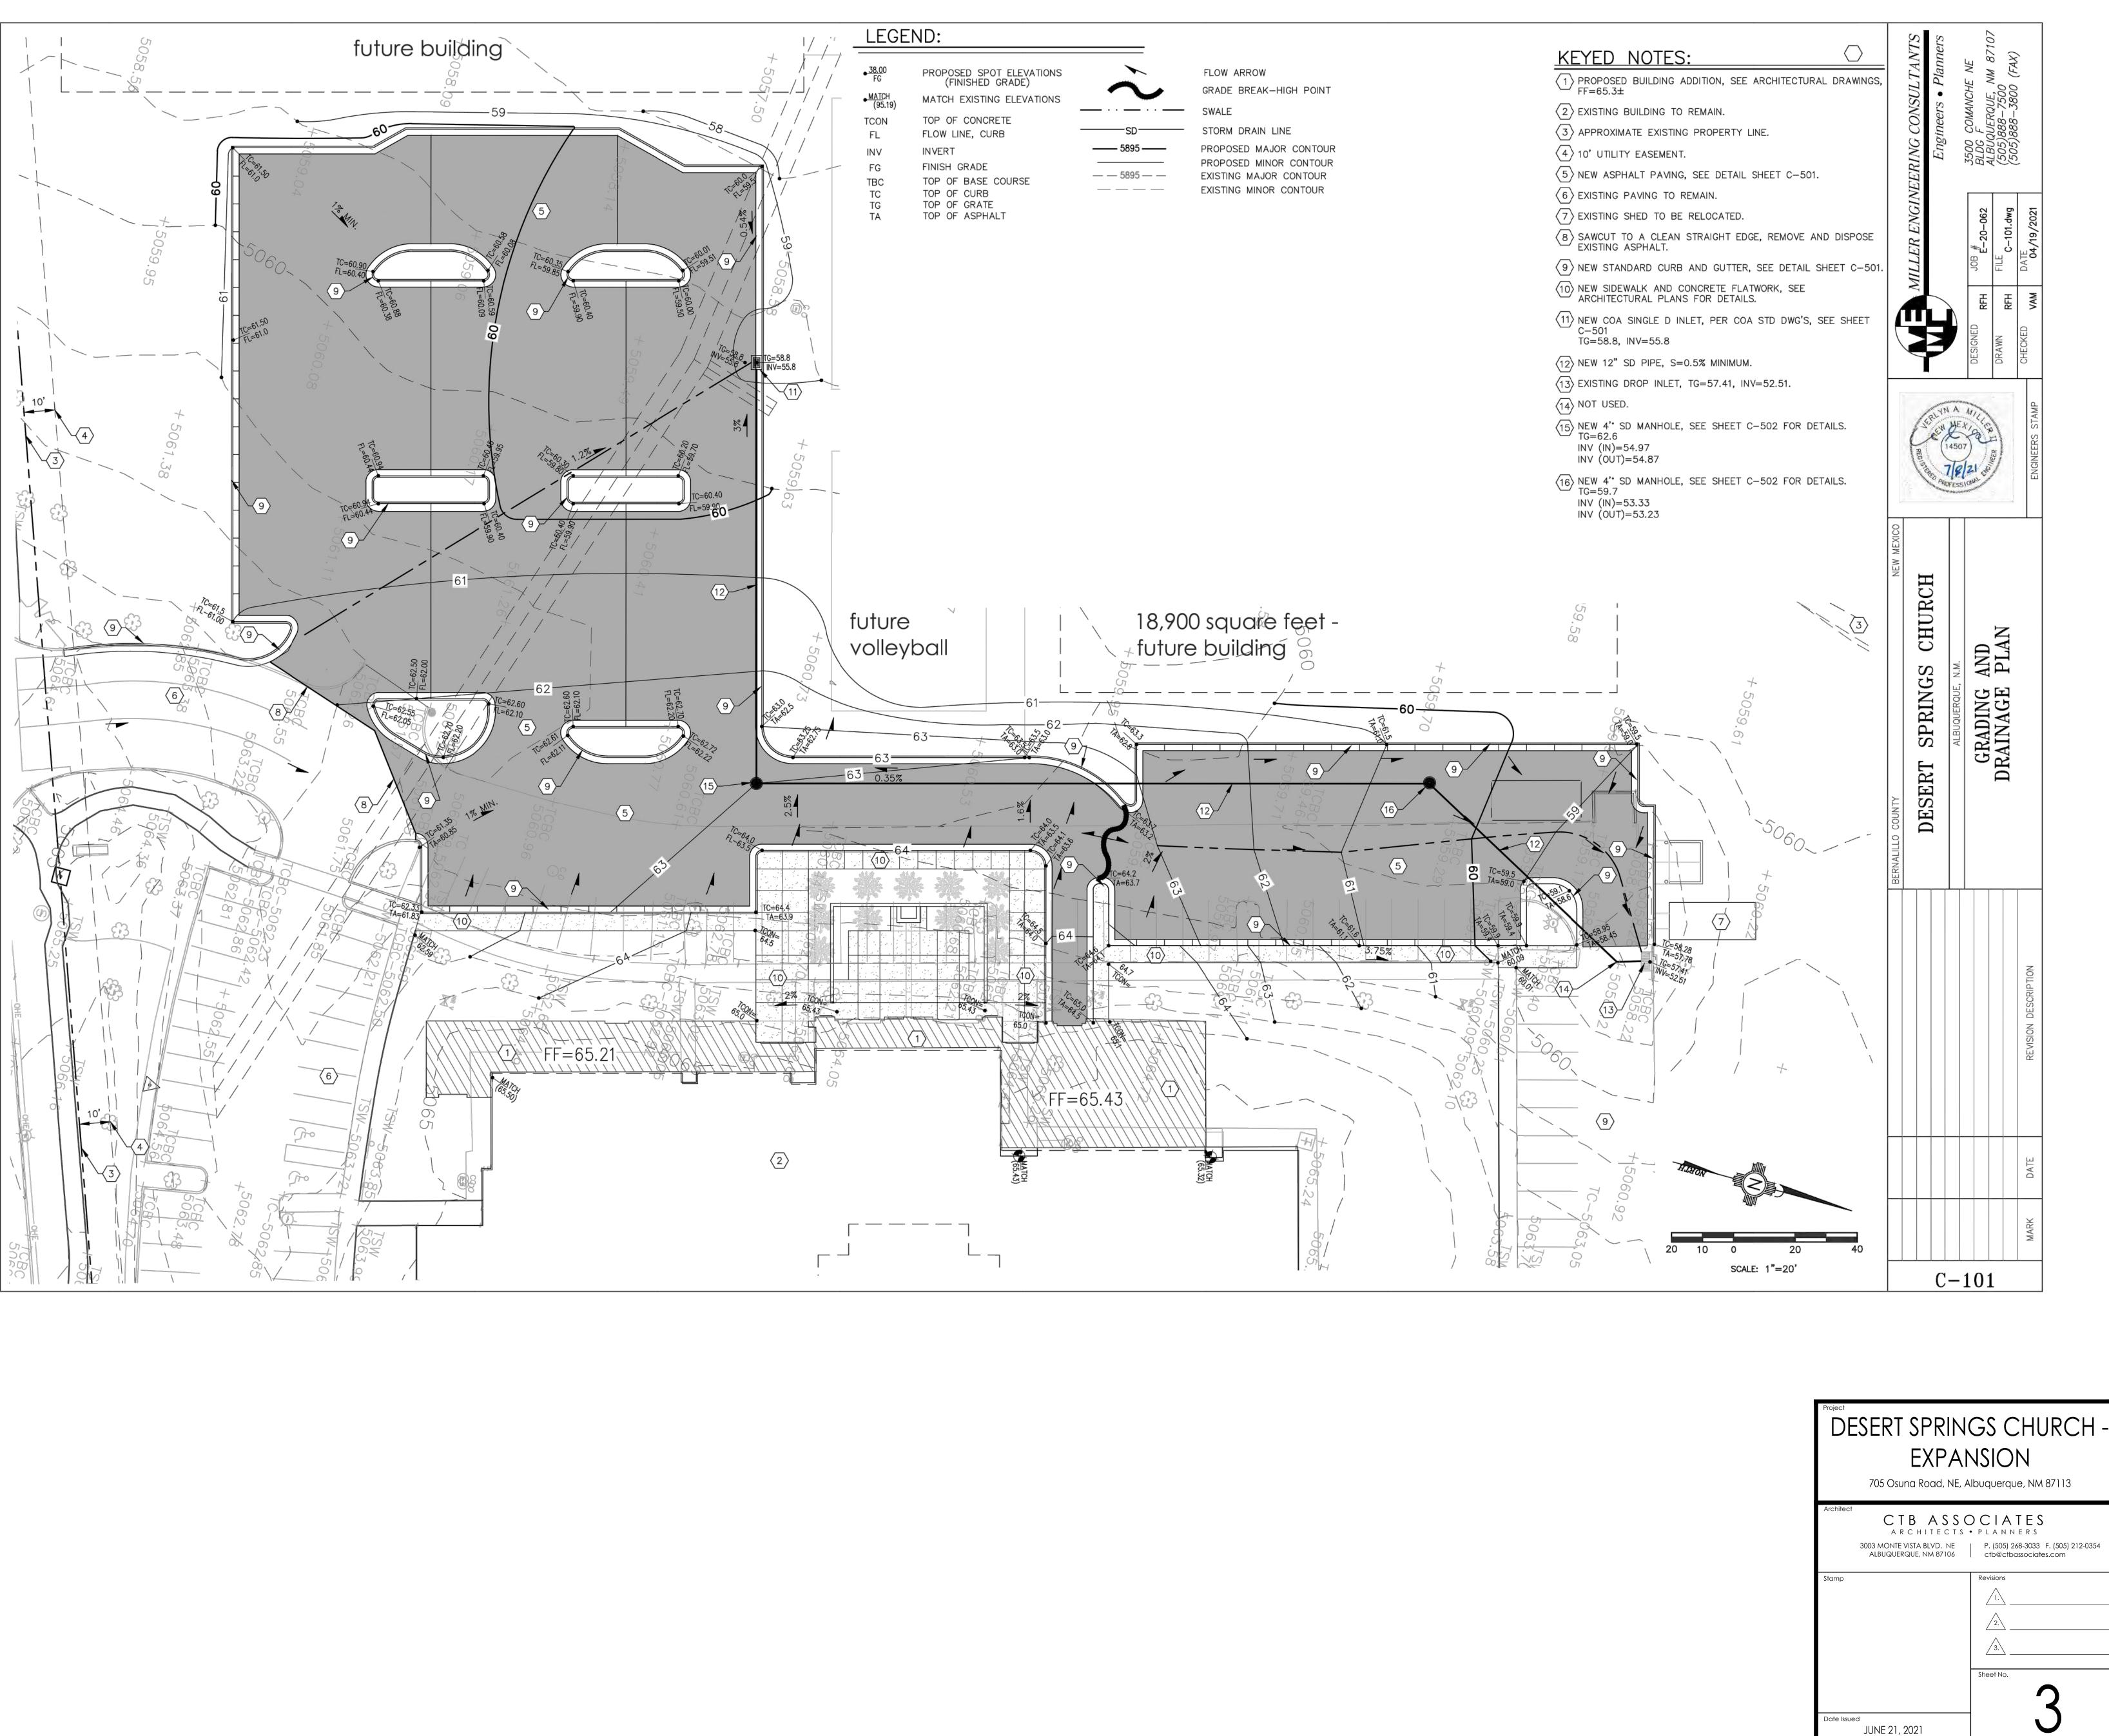

KEYED NOTES . NOTES

GENERAL NOTES

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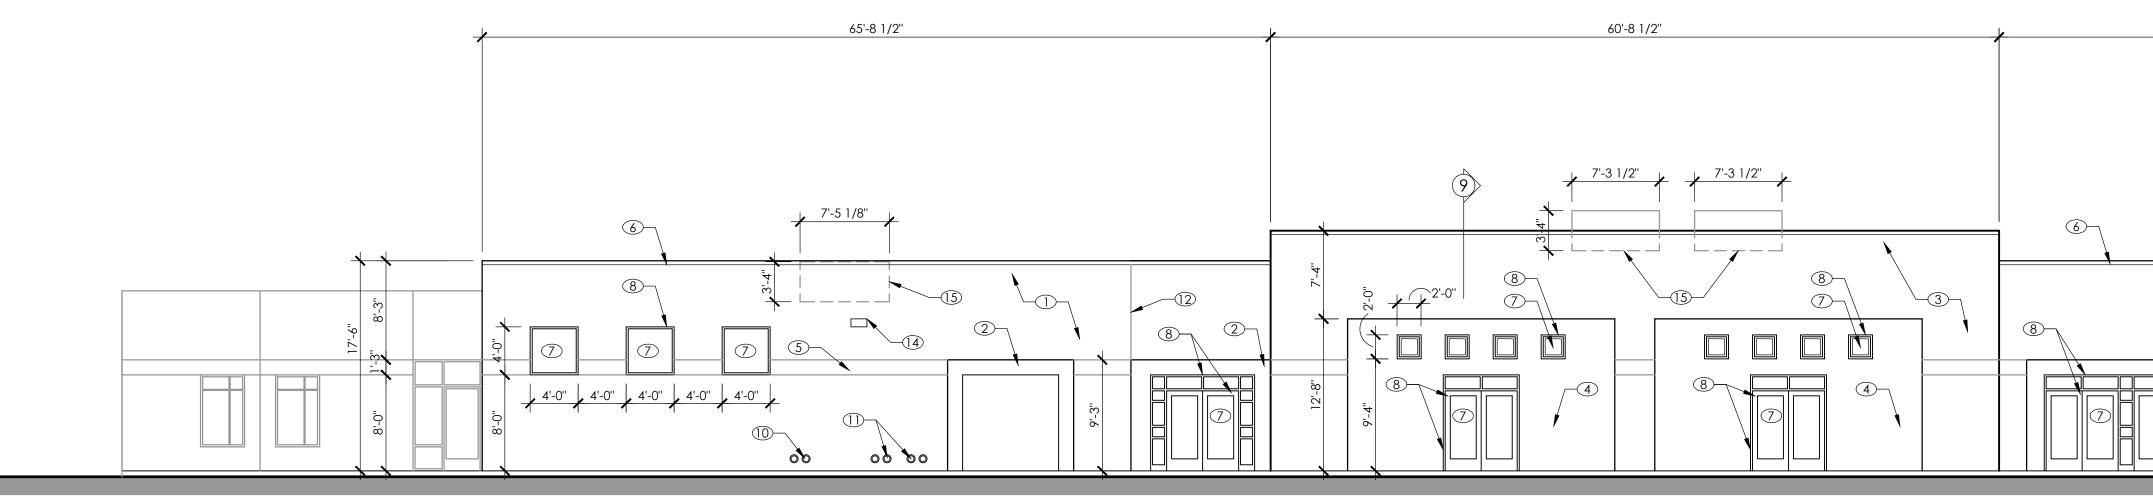
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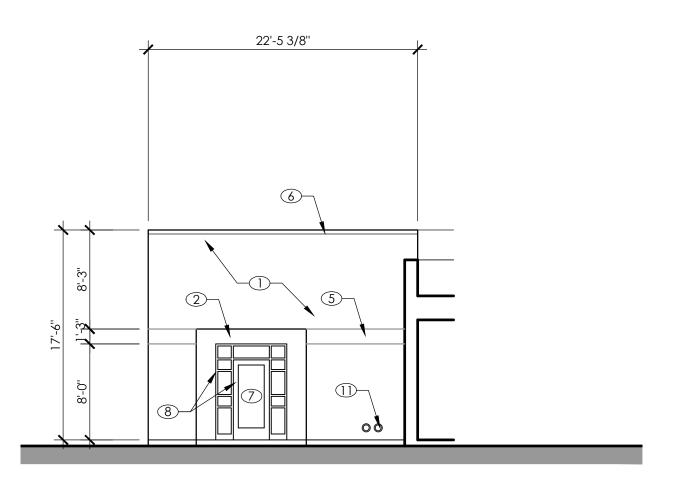
GENERAL NOTES

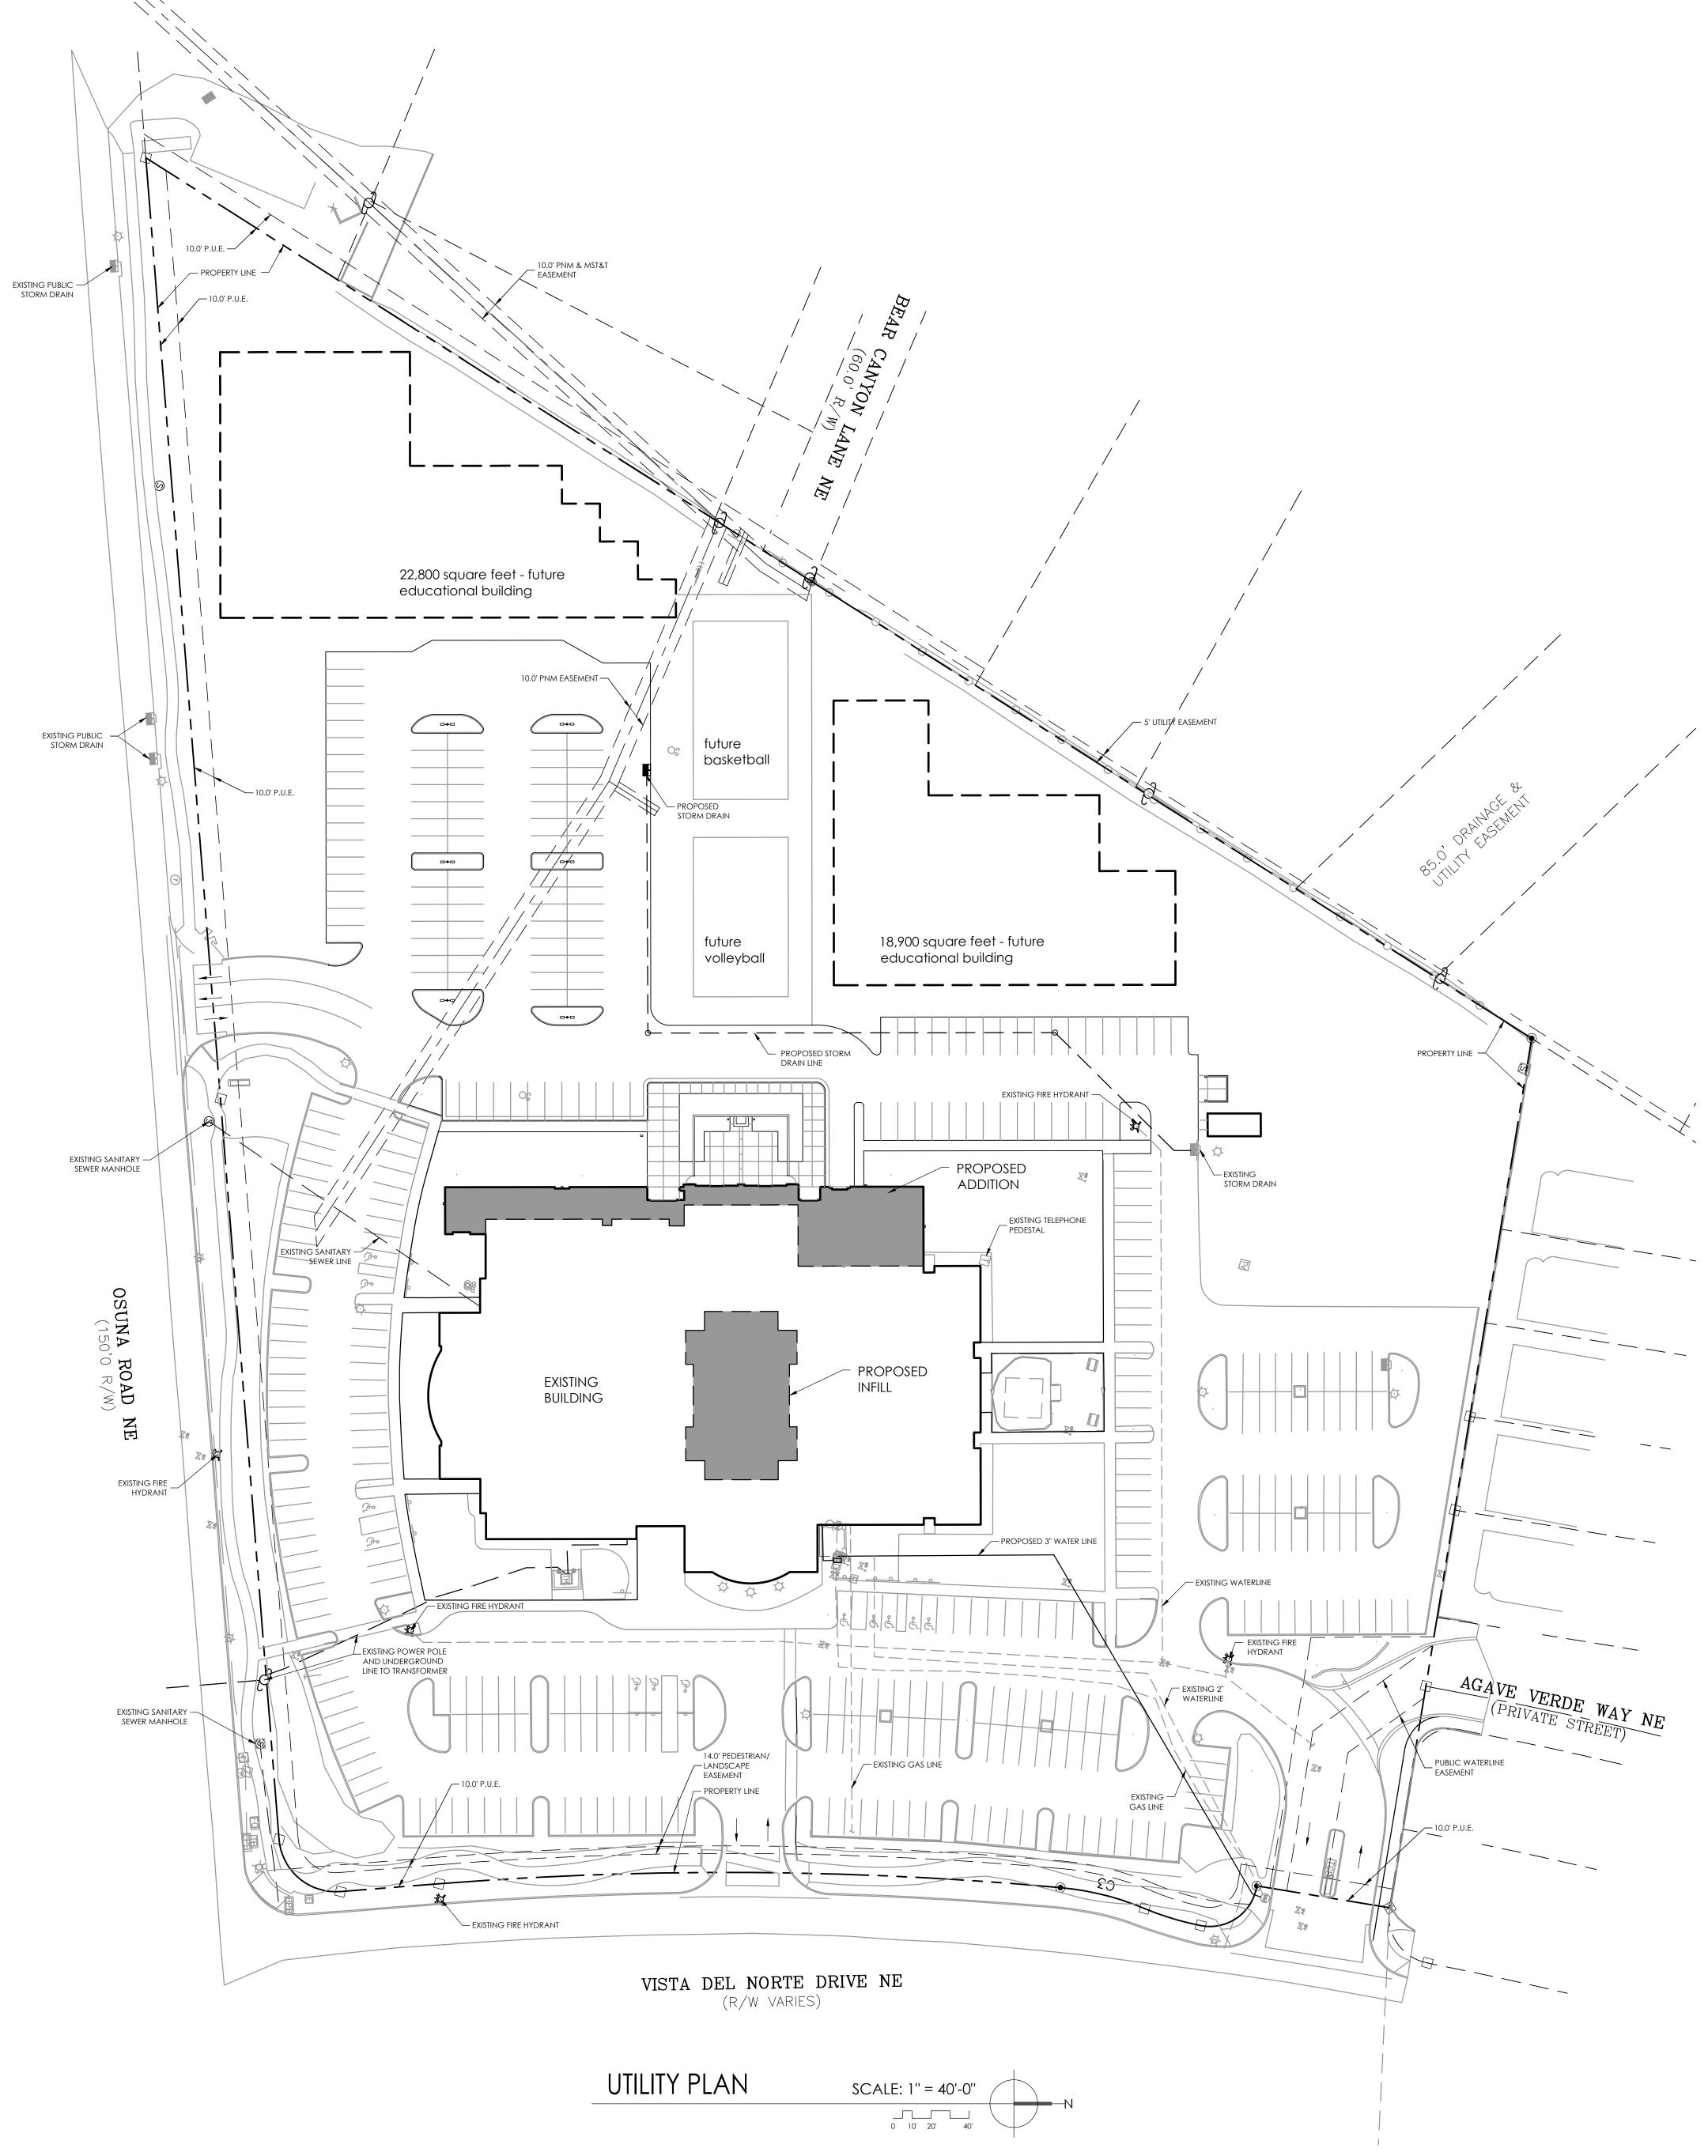

WEST ELEVATION



South elevation





### PARTIAL EAST ELEVATION


SCALE: 1/8'' = 1'-0''

SYNTHETIC STUCCO MATCH P-6 GREY FINISH. SYNTHETIC STUCCO MATCH P-7 CHARCOAL FINISH. SYNTHETIC STUCCO MATCH P-5 BROWN FINISH. SYNTHETIC STUCCO MATCH P-5 BROWN FINISH. CONTINUE HORIZONTAL CONTROL JOINTS IN EIFS WHERE SHOWN -4 MATCH EXISTING PROFILE. PRE-FINISHED ALUMINUM COPING SELECTED FROM MANUFACTURER'S STANDARD COLORS - TO BE SELECTED. SOLAR GREY GLASS COLOR ALUMINUM FINISH ON ALL EXTERIOR DOORS AND WINDOW FRAMES. 9. NEW WINDOWS WITHIN EXISTING BUILDING WALL. RESTORE FINISH AS REQUIRED. 10. NEW ROOF DRAIN AND OVER FLOW DRAIN OUTLET. SEE PLUMBING DRAWINGS. ROOF DRAIN AND OVERFLOW DRAIN OUTLETS, EXTENDED FROM EXISTING ROOFS. SEE PLUMBING DRAWINGS. VERTICAL CONTROL JOINT - ALIGNED WITH EXPANSION JOINT CONDITION TO EAST. REVIEW FINISH CONDITION AT SANCTUARY - BLACK FINISH AT CENTER MAY REQUIRE REFINISH - CONSULT WITH OWNER REGARDING CONDITION. 14. NEW WALL SCONCE - MOUNT AT 12'-0" A.F.F., SEE ELECTRICAL DRAWINGS.

15. MECHANICAL ROOF TOP UNIT ON ROOF BEYOND EXTERIOR PARAPET.

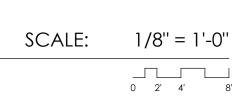

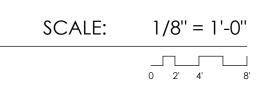

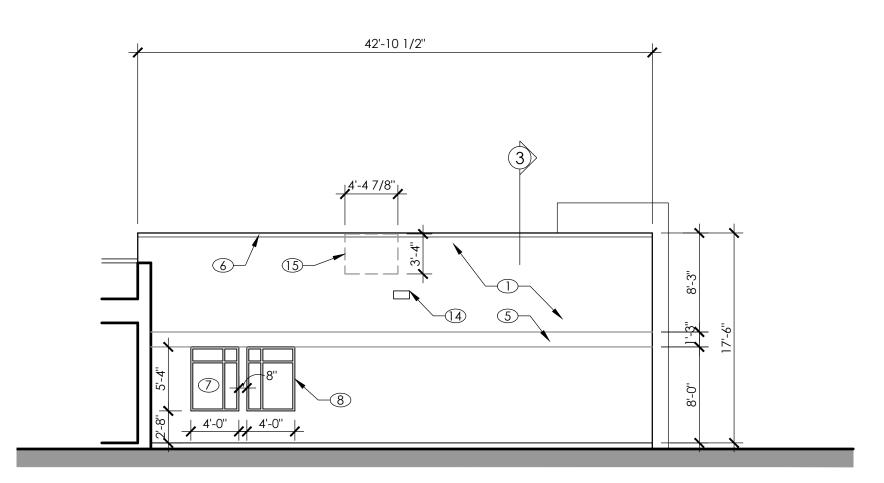

### PARTIAL NORTH ELEVATION

SCALE: 1/8'' = 1'-0''

KEYED NOTES

			125'-7 3/8"			
			2			
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		<u> </u>	(15)	3.4"		
2	5			8 (8)	8	8
		2-8" 5"-4"	8"			
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## EXISTING SOUTH ELEVATION PHOTO - FOR REFERENCE

GENERAL NOTES	SYMBOLS	Architect
	KEYED NOTE INTERIOR ELEVATION FRAME ELEVATION WALL SECTION	3003 M ALBI Stamp
	ENLARGED FLOOR PLAN DETAIL REFERENCE	REAL PROFESSION
	DESERT SPRINGS CHURCH -	Date Issued
	EXPANSION 705 Osuna Road, NE, Albuquerque, NM 87113	JULY Sheet Name BUILDII

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17'-6"				
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				-

SCALE: NTS

