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# ALLASO LOUISIANA

#### OWNER

TITAN DEVELOPMENT 6300 RIVERSIDE DEVELOPMENT, SUITE 200 ALBUQUERQUE, NM 87102 PHONE: 505.998.0163

### ARCHITECT

DEKKER/PERICH/SABATINI, LTD. 7601 JEFFERSON ST. NE, SUITE 100 ALBUQUERQUE, NM 87109 PHONE: 505.761.9700

## LANDSCAPE ARCHITECT

YELLOWSTONE LANDSCAPE 7525 2ND ST NW ALBUQUERQUE, NM 87107 PHONE: 505.898.9615

#### CIVIL ENGINEER

RESPEC 5971 JEFFERSON ST NE ALBUQUERQUE, NM 87109 505.251.0815

DEKKER PERICH SABATINI




**ENGINEER** 

DRAWN BY	AG, AS
REVIEWED BY	RAW, HFG
DATE	11/12/2021
PROJECT NO.	21-1013
DRAWING NAME	

SDP FOR **BUILDING PERMIT** 

COVER

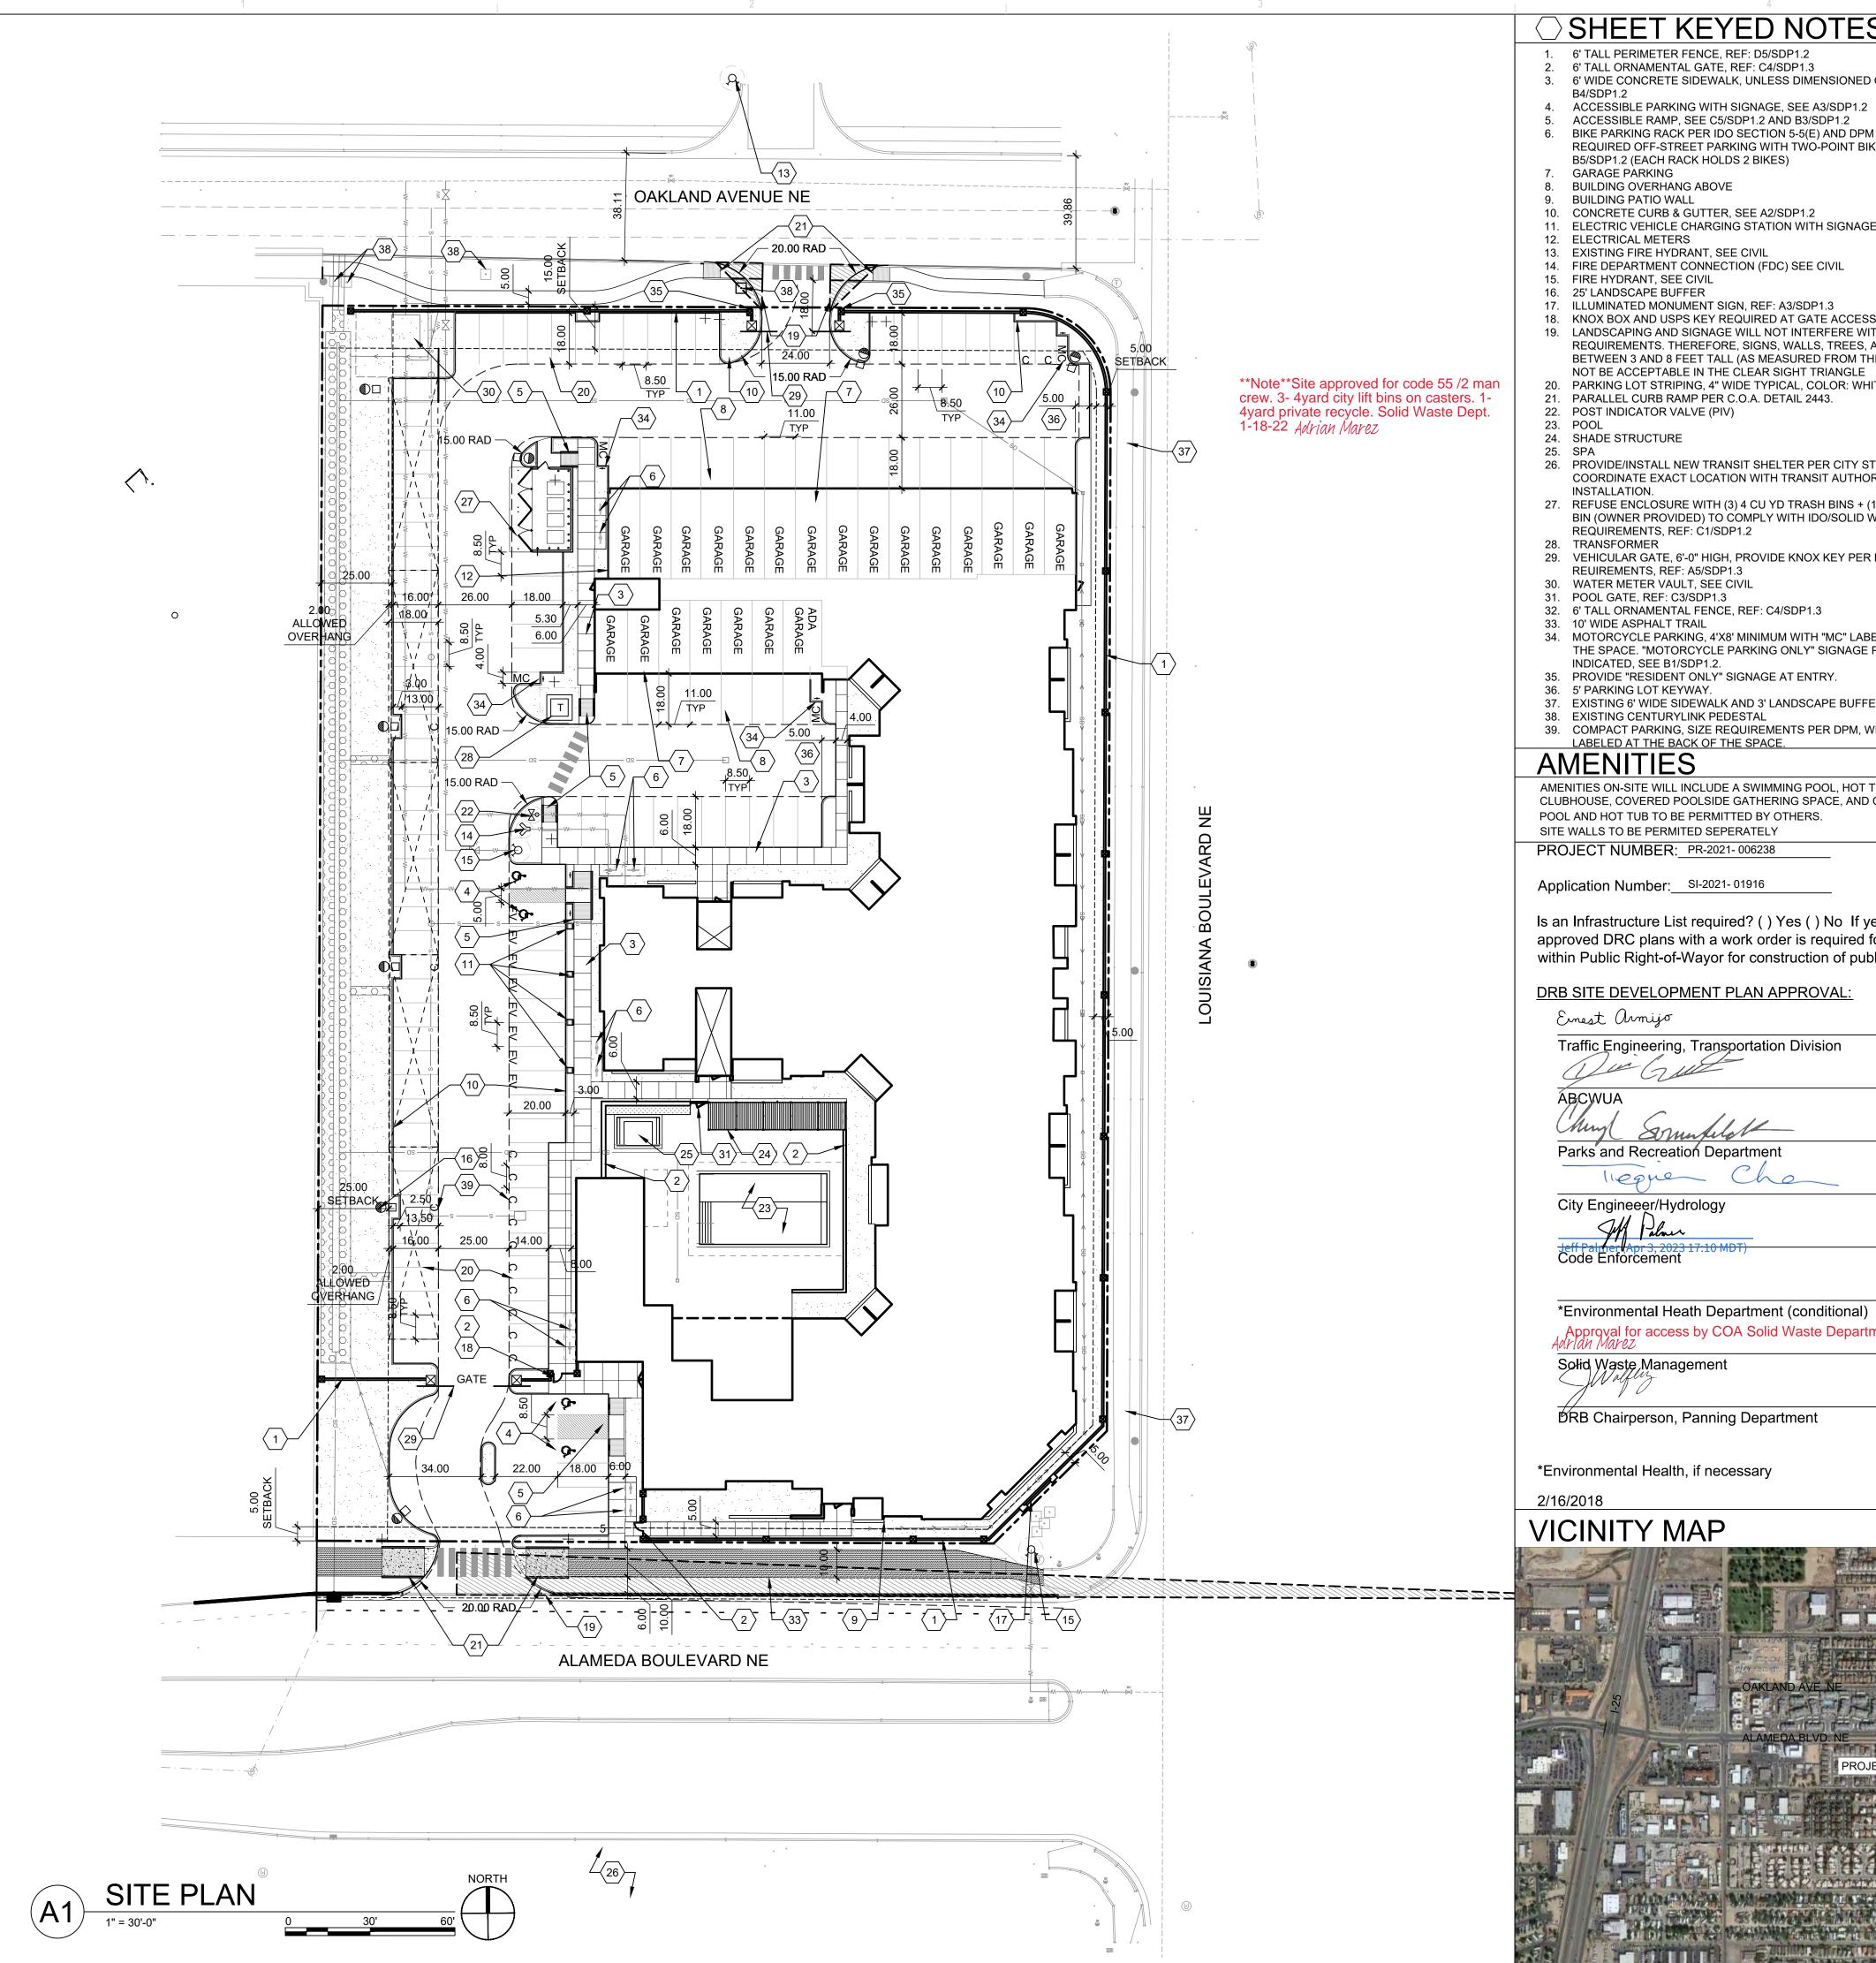

#### SHEET KEYED NOTES

- 1. 6' TALL PERIMETER FENCE, REF: D5/SDP1.2
- 2. 6' TALL ORNAMENTAL GATE, REF: C4/SDP1.3 3. 6' WIDE CONCRETE SIDEWALK, UNLESS DIMENSIONED OTHERWISE; SEE
- ACCESSIBLE PARKING WITH SIGNAGE, SEE A3/SDP1.2
- ACCESSIBLE RAMP, SEE C5/SDP1.2 AND B3/SDP1.2
- BIKE PARKING RACK PER IDO SECTION 5-5(E) AND DPM STANDARDS, 10% OF REQUIRED OFF-STREET PARKING WITH TWO-POINT BIKE LOCKING, SEE B5/SDP1.2 (EACH RACK HOLDS 2 BIKES)
- **BUILDING OVERHANG ABOVE**
- 10. CONCRETE CURB & GUTTER, SEE A2/SDP1.2

- 11. ELECTRIC VEHICLE CHARGING STATION WITH SIGNAGE, REF: B1/SDP1.2
- 13. EXISTING FIRE HYDRANT, SEE CIVIL
- 14. FIRE DEPARTMENT CONNECTION (FDC) SEE CIVIL
- 17. ILLUMINATED MONUMENT SIGN, REF: A3/SDP1.3
- 19. LANDSCAPING AND SIGNAGE WILL NOT INTERFERE WITH CLEAR SIGHT REQUIREMENTS. THEREFORE, SIGNS, WALLS, TREES, AND SHRUBBERY BETWEEN 3 AND 8 FEET TALL (AS MEASURED FROM THE GUTTER PAN) WILL NOT BE ACCEPTABLE IN THE CLEAR SIGHT TRIANGLE
- 20. PARKING LOT STRIPING, 4" WIDE TYPICAL, COLOR: WHITE
- 21. PARALLEL CURB RAMP PER C.O.A. DETAIL 2443.
- 22. POST INDICATOR VALVE (PIV)

- 26. PROVIDE/INSTALL NEW TRANSIT SHELTER PER CITY STANDARD DETAIL 2535. COORDINATE EXACT LOCATION WITH TRANSIT AUTHORITY PRIOR TO
- 27. REFUSE ENCLOSURE WITH (3) 4 CU YD TRASH BINS + (1) 4 CU YD RECYCLE BIN (OWNER PROVIDED) TO COMPLY WITH IDO/SOLID WASTE
- 29. VEHICULAR GATE, 6'-0" HIGH, PROVIDE KNOX KEY PER FIRE DEPARTMENT
- REUIREMENTS, REF: A5/SDP1.3
- 32. 6' TALL ORNAMENTAL FENCE, REF: C4/SDP1.3
- 33. 10' WIDE ASPHALT TRAIL
- 34. MOTORCYCLE PARKING, 4'X8' MINIMUM WITH "MC" LABELED AT THE BACK OF THE SPACE. "MOTORCYCLE PARKING ONLY" SIGNAGE PROVIDED AS
- 35. PROVIDE "RESIDENT ONLY" SIGNAGE AT ENTRY.
- 36. 5' PARKING LOT KEYWAY.
- 37. EXISTING 6' WIDE SIDEWALK AND 3' LANDSCAPE BUFFER. 38. EXISTING CENTURYLINK PEDESTAL
- 39. COMPACT PARKING, SIZE REQUIREMENTS PER DPM, WITH "COMPACT" LABELED AT THE BACK OF THE SPACE.

AMENITIES ON-SITE WILL INCLUDE A SWIMMING POOL, HOT TUB, FITNESS CENTER, CLUBHOUSE, COVERED POOLSIDE GATHERING SPACE, AND CABANAS. POOL AND HOT TUB TO BE PERMITTED BY OTHERS.

SITE WALLS TO BE PERMITED SEPERATELY

PROJECT NUMBER: PR-2021- 006238

Application Number: SI-2021- 01916

Is an Infrastructure List required? ( ) Yes ( ) No If yes, then a set of approved DRC plans with a work order is required for any construction within Public Right-of-Wayor for construction of public improvements.

#### DRB SITE DEVELOPMENT PLAN APPROVAL:

Einest armijo	Mar 31, 2023
Traffic Engineering, Transportation Division	Date
alu Cult	Apr 4, 2023
ÁBCWUA	Date

Parks and Recreation Department

City Engineeer/Hydrology

\*Environmental Heath Department (conditional)

Approval for access by COA Solid Waste Department. Solid Waste Management



#### **GENERAL NOTES**

- A. DIMENSIONS ARE TO FACE OF CURB, OR WALL, OR EDGE OF PAVEMENT UNLESS OTHERWISE NOTED.
- D. SITE PLAN SHALL COMPLY WITH LOCAL, STATE AND FEDERAL ADA STANDARDS & GUIDELINES, INCLUDING THE INTERNATIONAL FIRE CODE (IFC) 2015.
- CURBS AND ACCESSIBLE RAMPS WILL BE DESIGNED AND BUILT ACCORDING TO THE CITY OF ALBUQUERQUE STANDARDS. LIGHT FIXTURES AND DESIGN SHALL COMPLY WITH THE CITY OF ALBUQUERQUE
- INTEGRATED DEVELOPMENT ORDINANCE (IDO): SECTION 14-16-5-8 OUTDOOR
- LIGHTING. G. STREETS. PARKING SPACES AND ASSOCIATED DRIVES TO BE ASPHALT UNLESS
- NOTED OTHERWISE. H. LANDSCAPE AND SIGNAGE WILL NOT INTERFERE WITH CLEAR SIGHT REQUIREMENTS. SIGNS, WALLS AND PLANTING BETWEEN 3 FEET AND 8 FEET TALL (AS MEASURED FROM THE GUTTER PAN) WILL NOT BE PERMITTED IN THE CLEAR
- ALL PUBLIC INFRASTRUCTURE LOCATED WITHIN CITY RIGHT-OF-WAY SHALL BE INCLUDED IN A PUBLIC WORK ORDER. SOLID WASTE WILL BE PROVIDED WITH FOB ACCESS TO VEHICULAR GATES TO
- ACCESS SITE AS NEEDED PER WEEK BETWEEN THE HOURS OF 7:00 A.M AND 8:00

#### PROJECT DATA

IDO - MIXED USE - LOW INTENSITY ZONING DISTRICT (MX-L)

BUS STOP ROUTE 98 IS ALONG ALAMEDA BOULEVARD GOING IN THE WEST AND SOUTH DIRECTION.

**BIKE FACILITIES:** A BIKE LANE IS WITHIN ALAMEDA BOULEVARD AND LOUISIANA BOULEVARD. A PAVED MULTIPLE USE TRAIL NAMED ALAMEDA TRAIL IS ON THE SOUTH OF THE SUBJECT SITE

LEGAL DESCRIPTION 015 028TRACT A UNIT B NORTH ALBUQUERQUE ACRES; LT 16 BLK 28 (EXCL E'LY PORT OUT TO R/W) TR A UNIT B NORTHALBUQUERQUE ACRES: LT 18 BLK 28 (EXCL S'LY PORT OUT TO R/W) TR A UNIT B NORTHALBUQUERQUE ACRES; LT 17 BLK 28 (EXCL S'LY & E'LY PORT OUT TO R/W) TR A UNIT BNORTH ALBUQUERQUE ACRES LOT CONSOLIDATION PENDING REPLAT.

**SITE AREA:** 2.77 ACRES **ZONE ATLAS**: C-18-Z **SETBACKS:** FRONT= 5' MIN

SIDE = 0' MIN, STREET SIDE = 5' MIN REAR= 15' MIN

**BUILDING HEIGHT:** MAXIMUM ALLOWED: 38'-0" ACTUAL HEIGHT: 38"-0" SPRINKLERED: YES, NFPA 13

BUILDING OCCUPANCY: R-2 MULTIFAMILY RESIDENTIAL **CONSTRUCTION TYPE:** 3 STORY RESIDENTIAL BUILDING - TYPE VA

SECOND LEVEL THIRD LEVEL

41,240 GSF 40,774 GSF 34,404 GSF 116,418 GSF

PARKING CALCULATION: (TABLE 5-5-1, UC-MS-PT) REQUIRED SPACES: 142 SPACES

{1.5 SPACES / DWELLING UNITS: 105 X 1.5 = 158 SPACES MINUS PARKING CREDIT OF 16 SPACES FOR 5% PARKING REDUCTION FOR A TRANSIT SHELTER, AND 8 ELECTRIC CHARGING STATION PARKING SPACES}

PROVIDED PARKING = 146 TOTAL SPACES (INCLUDING 15 COMPACT SPACES = 11% OF TOTAL PARKING REQUIRED COMPACT SPACES ARE IDENTIFIED WITH "C", SEE LEGEND.) **ACCESSIBLE PARKING: (ADA 208.2.3)** 2% OF UNITS = 105 X .02 = 2.1 = 3 SPACES REQUIRED

MOTORCYCLE PARKING REQUIRED (TABLE 5-5-4, 101-150 OFF-STREET) = 4 SPACES

2 STANDARD SPACES + 2 VAN ACCESSIBLE SPACE = 4 SPACES PROVIDED

MOTORCYCLE PARKING PROVIDED = 4 SPACES BICYCLE PARKING REQUIRED, 10% (TABLE 5-5-5) = 14.2 = 15 SPACES

**BICYCLE PARKING PROVIDED** = 20 SPACES

{142 STANDARD SPACES + 4 ACCESSIBLE SPACES}

#### UNIT DATA

Apr 6, 2023

Mar 31, 2023

Apr 3, 2023

Date

1-18-22

Apr 7, 2023

UNIT TYPE	DESCRIPTION	GSF	#UNITS	TOTAL	
S1	STUDIO	592 SF	6	3,552 SF	
S2	STUDIO	520 SF	14	7,280 SF	
A1	1 BEDROOM / 1 BATHROOM	695 SF	6	4,170 SF	
A2	1 BEDROOM / 1 BATHROOM	775 SF	19	14,725 SF	
A3	1 BEDROOM / 1 BATHROOM	762 SF	3	2,286 SF	
A6	1 BEDROOM / 1 BATHROOM	859 SF	24	20,616 SF	
B1	2 BEDROOM / 2 BATHROOM	1,130 SF	16	18,080 SF	
B2	2 BEDROOM / 2 BATHROOM	1,016 SF	6	6,096 SF	
B3	2 BEDROOM / 2 BATHROOM	1,000 SF	6	6,000 SF	
B4	2 BEDROOM / 2 BATHROOM	1,049 SF	2	2,098 SF	
B5	2 BEDROOM / 2 BATHROOM	1,040 SF	3	3,120 SF	
		TOTAL:	105 UNITS	88,023 SF	

#### OPEN SPACE CALCULATIONS

TABLE 2-4-3 / MX-L ZONING

USABLE OPEN SPACE 1 BD: 225 SF PER UNIT 225 SF x 72 UNITS = 16,200 SF 285 SF x 33 UNITS = 9,405 SF = 25,605 SF BD: 285 SF PER UNIT

REQUIRED OPEN SPACE: = 25,605 SF PROVIDED OPEN SPACE: = 29,886 SF = 2,630 SF

**LEGEND** 

FIRELANE STRIPING MARKING FIRE ACCESS LANE; REF: A2/SDP1.3

= 32,516 SF

PROPERTY LINE

FIRE HYDRANT POST INDICATOR VALVE (PIV), RE: CONCEPTUAL UTILITY PLAN

FIRE DEPARTMENT CONNECTION (FDC) WALL-MOUNTED BIKE RACK (EACH BIKE RACK HOLDS TWO BIKES, SEE KEYNOTE)

SIDEWALK RAMP (ARROW POINTS DOWN)

TRANSFORMER WITH SAFETY BOLLARDS & 6" THICK CONCRETE PAD PER PNM STANDARDS

ACCESSIBLE PARKING WITH ACCESSIBLE SIGNAGE AND STRIPING, REF: A3/SDP1.2, b1/SDP1.2 & D4/SDP1.2.

MC MOTORCYCLE PARKING

COMPACT PARKING WITH "COMPACT" LABELED AT THE BACK OF THE

← 6" BOLLARD WITH SIGN, REF: B1/SDP1.2 6' WIDE PAINTED CROSSWALK, SEE B2/SDP1.2

LIGHT POLE; REF: D2/SDP1.2

PERICH SABATINI

ARCHITECT



**ENGINEER** 

**PROJECT** 

REVISIONS


DRAWN BY REVIEWED BY DATE 11/12/2021

21-1013

DRAWING NAME SITE PLAN

PROJECT NO.

**SDP1.1** 

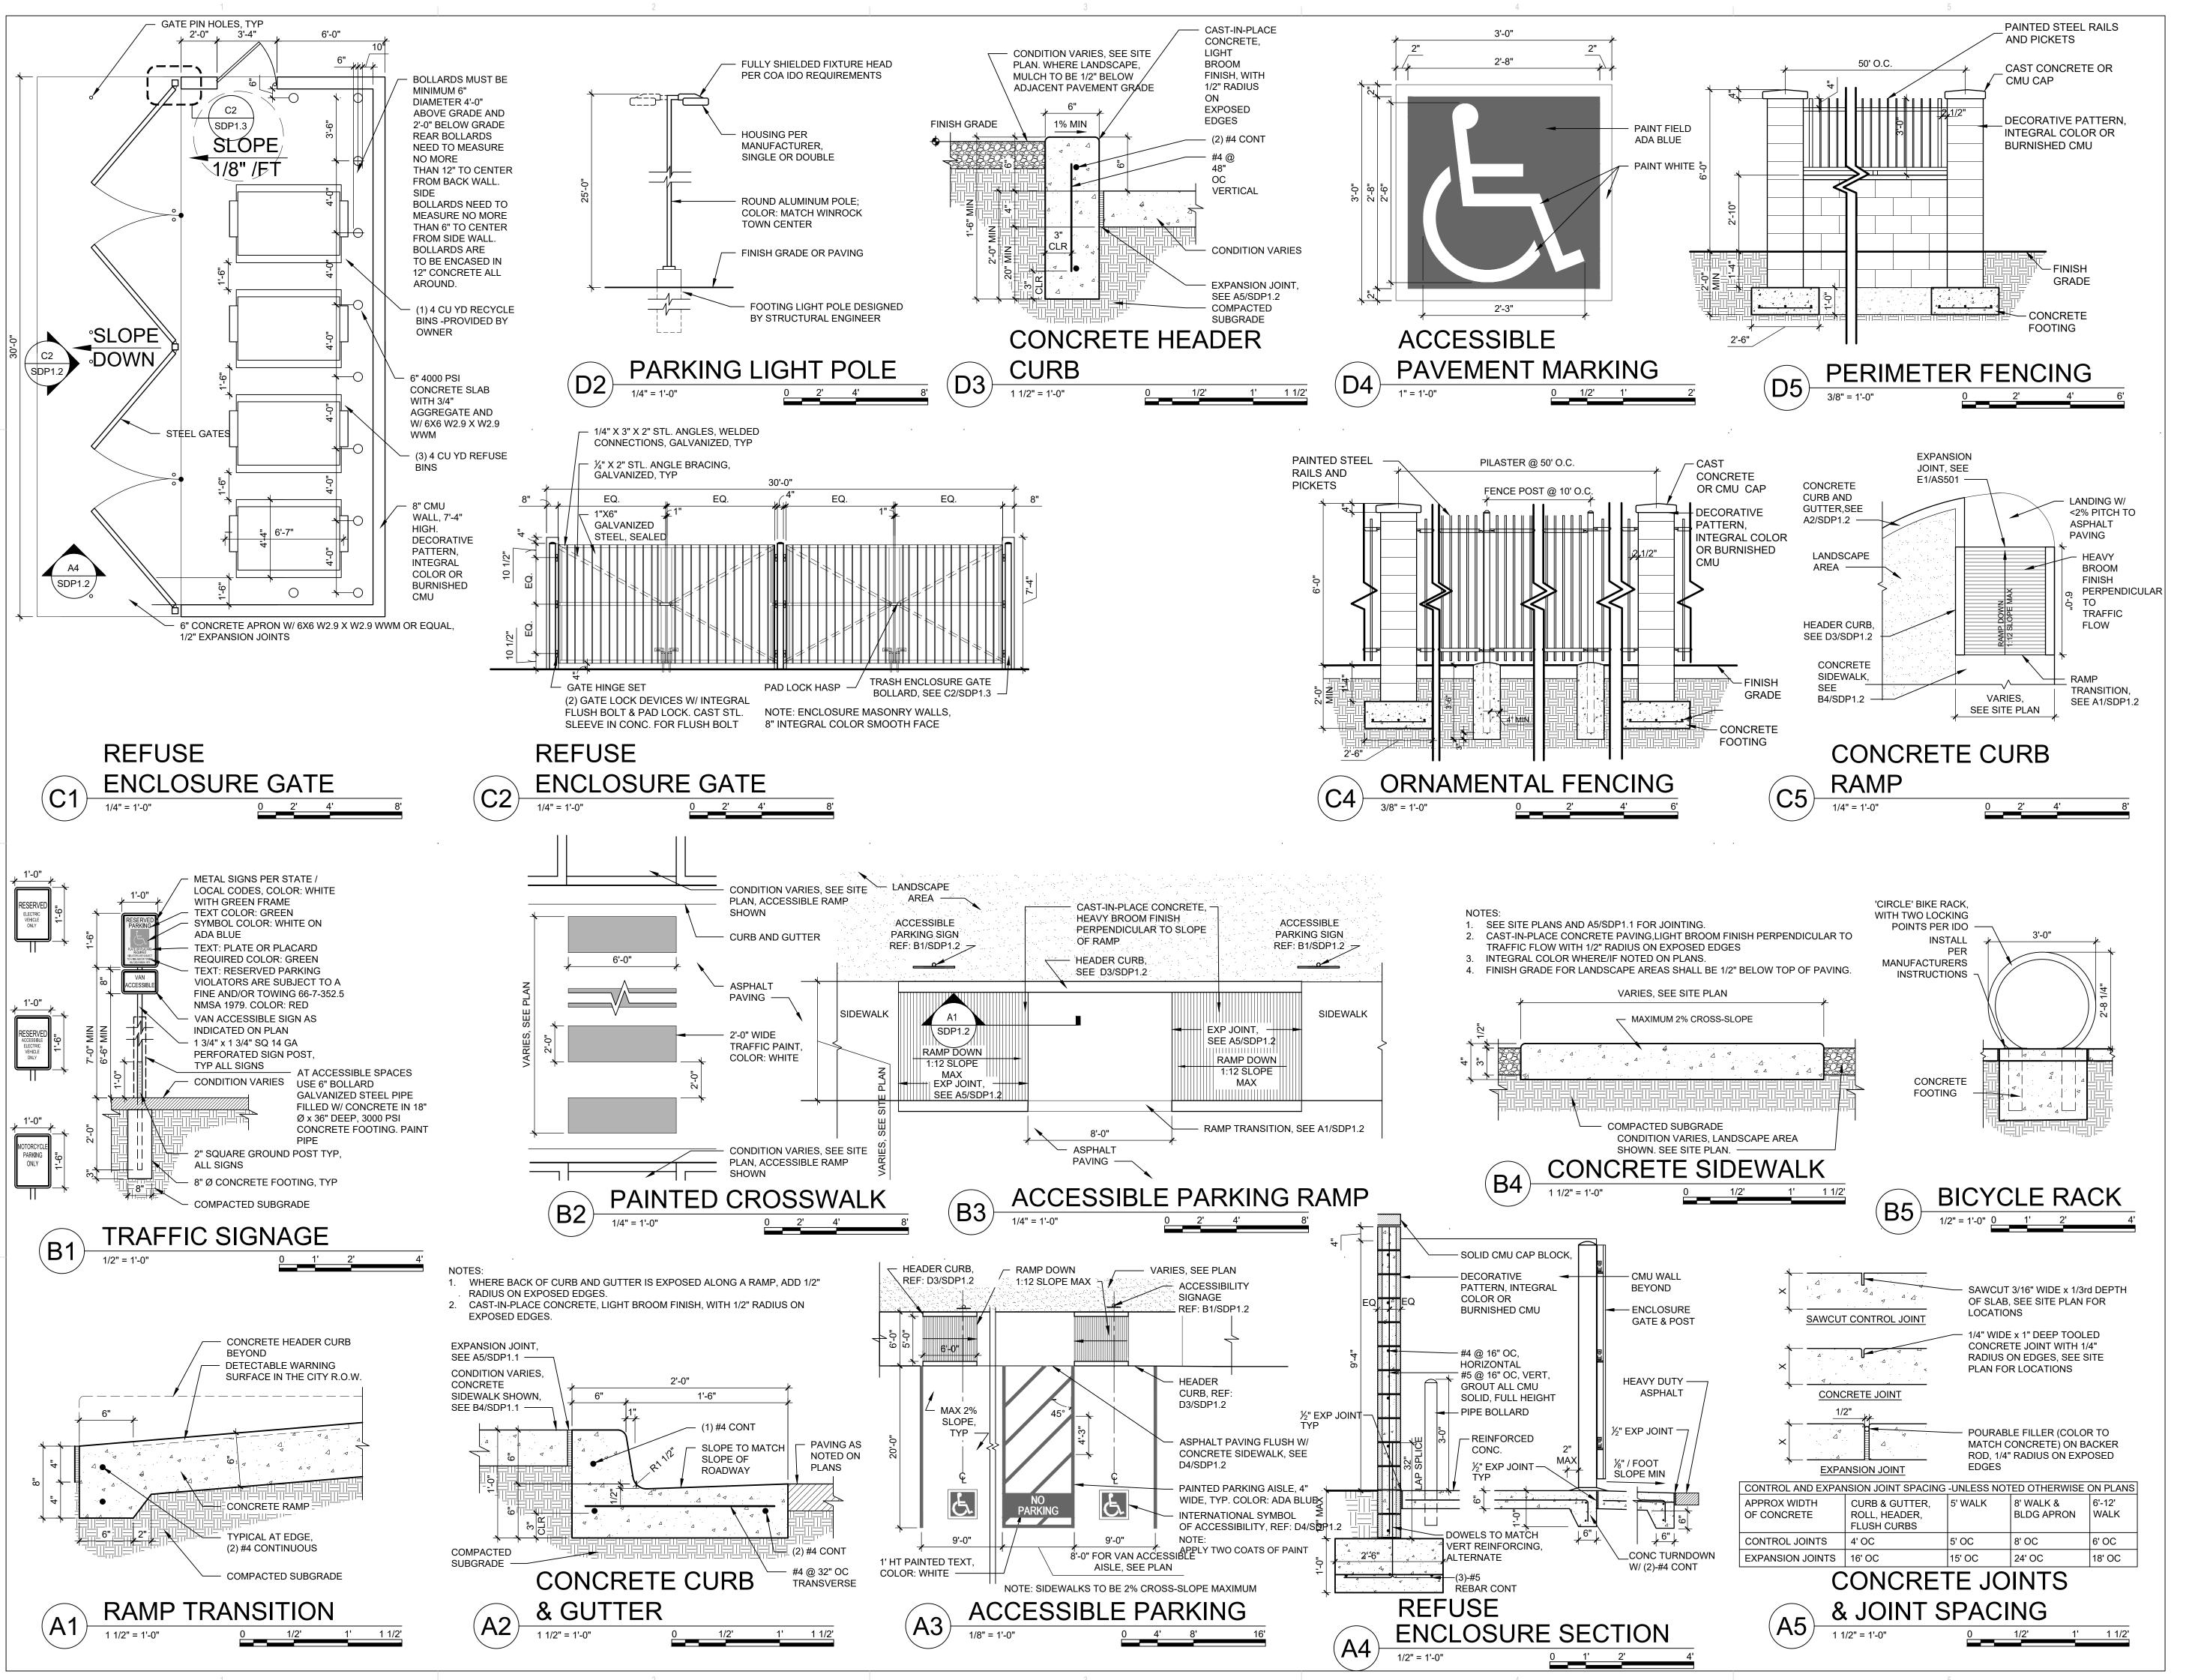

DEKKER
PERICH
SABATINI

ARCHITECT

OF NEW ME

II / 12/2021 CO

HANNAH FEIL

GREENHOOD

No. 5594

PROJECT

**ENGINEER** 

ALLASO LOUISIANA
NORTHWEST CORNER OF
ALAMEDA AND LOUISIANA
ALBUQUERQUE, NM

DRAWN BY DPS

REVIEWED BY DPS


DATE 11/12/2021

PROJECT NO. 21-1013

DRAWING NAME

SITE DETAILS

SHEET NO.
SDP1.2

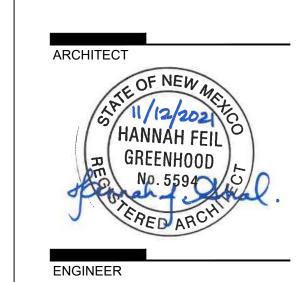

- 18" CAST ALUMINUM LETTERS, HELVETICA

SUPPORT

CONCRETE

SQ TUBE STEEL

POST, CAP TOP

**ROLLING GATE** 

TROUGH BEYOND

FONT, 2" STROKE, DARK GREY ANODIZED, BACKLIT


**BUILDING MOUNTED** 

VEHICULAR GATE

SIGN

1/2" = 1'-0"


APPROX 13'-0", SEE SITE PLAN

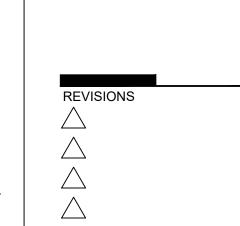

DRAWN BY	DPS
REVIEWED BY	DPS
DATE	11/12/2021
PROJECT NO.	21-1013
DRAWING NAME	


SITE DETAILS

SHEET NO. SDP1.3

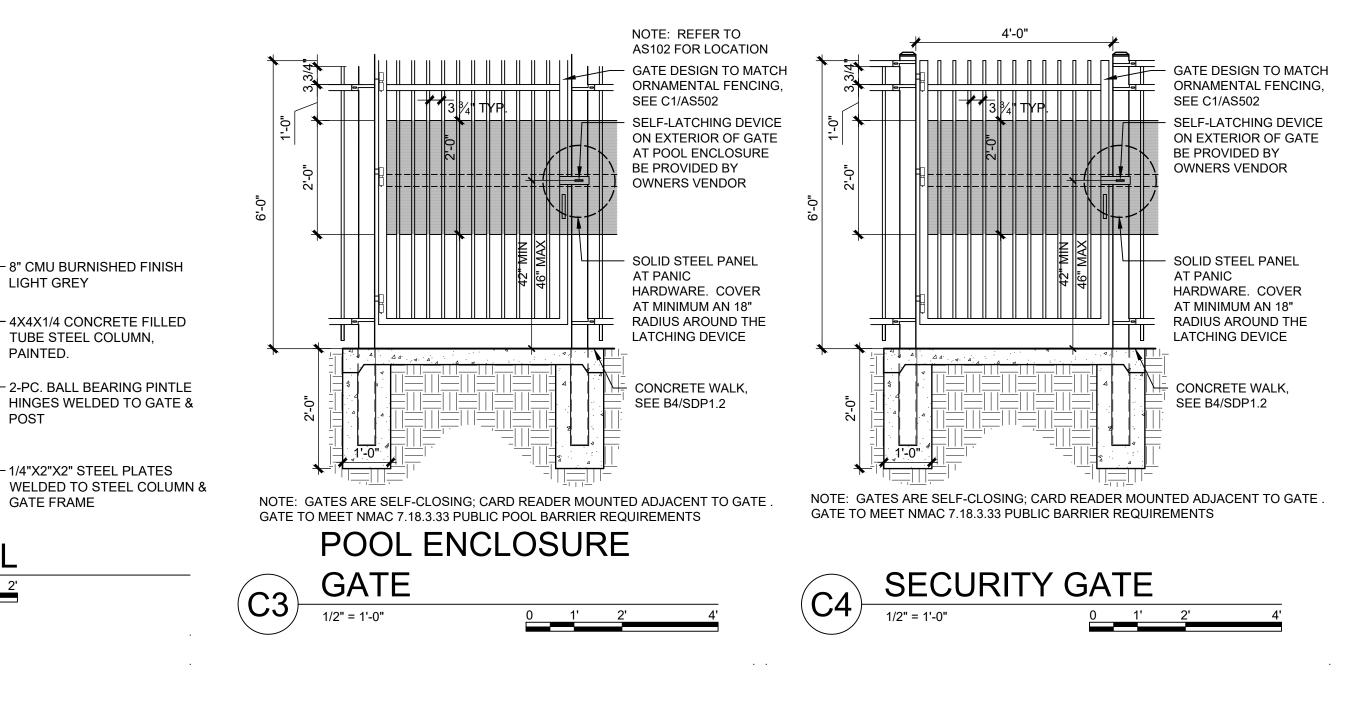

ALLASO

BUILDING MOUNTED SIGN, REF: C1/SDP5.1

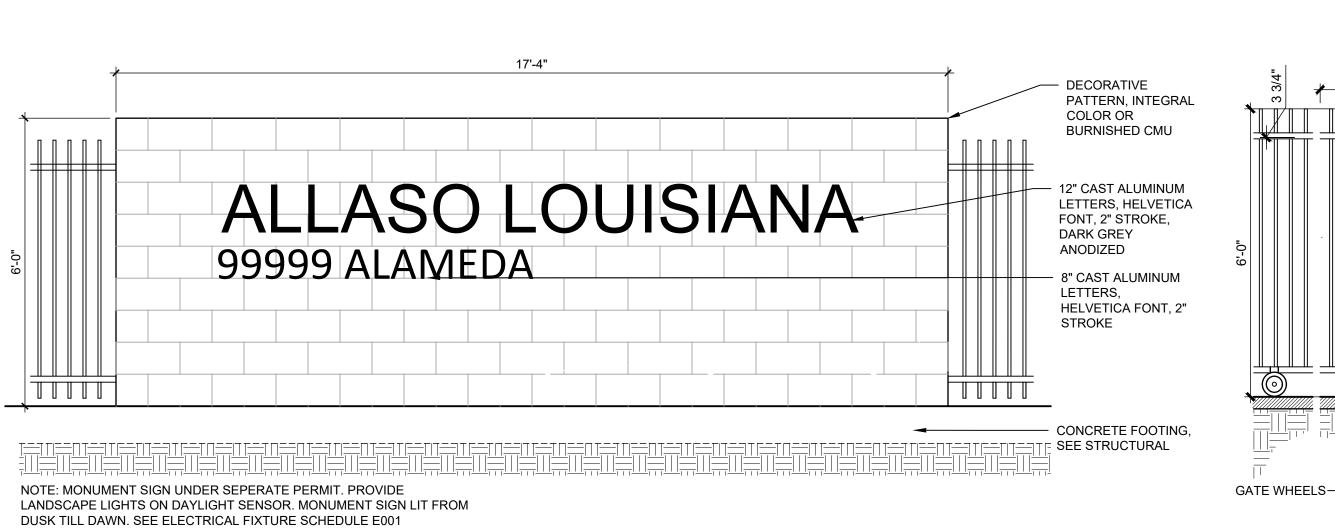

FIRELANE STRIPING AND SIGNAGE

METAL SIGNS PER

STATE/LOCAL

- MOUNT AS PER

B4/SDP1.2

1. SEE PLANS FOR EXTENTS OF CURB PAINT.

FIRE LANE SIGN

CODES

"FIRE LANE" AND "NO

PARKING", ALTERNATE LABELS EVERY 50',

REFLECTIVE PAINT

COLOR: WHITE

VERTICAL FACE

OF CURB ONLY

PAINT COLOR: RED

GATE ASSEMBLY

LIGHT GREY

PAINTED.


**GATE FRAME** 

6'-3/4"

1/4"X3"X2" ANGLE FRAME ~

NOTE: ALL PAINT COLORS T.B.D.



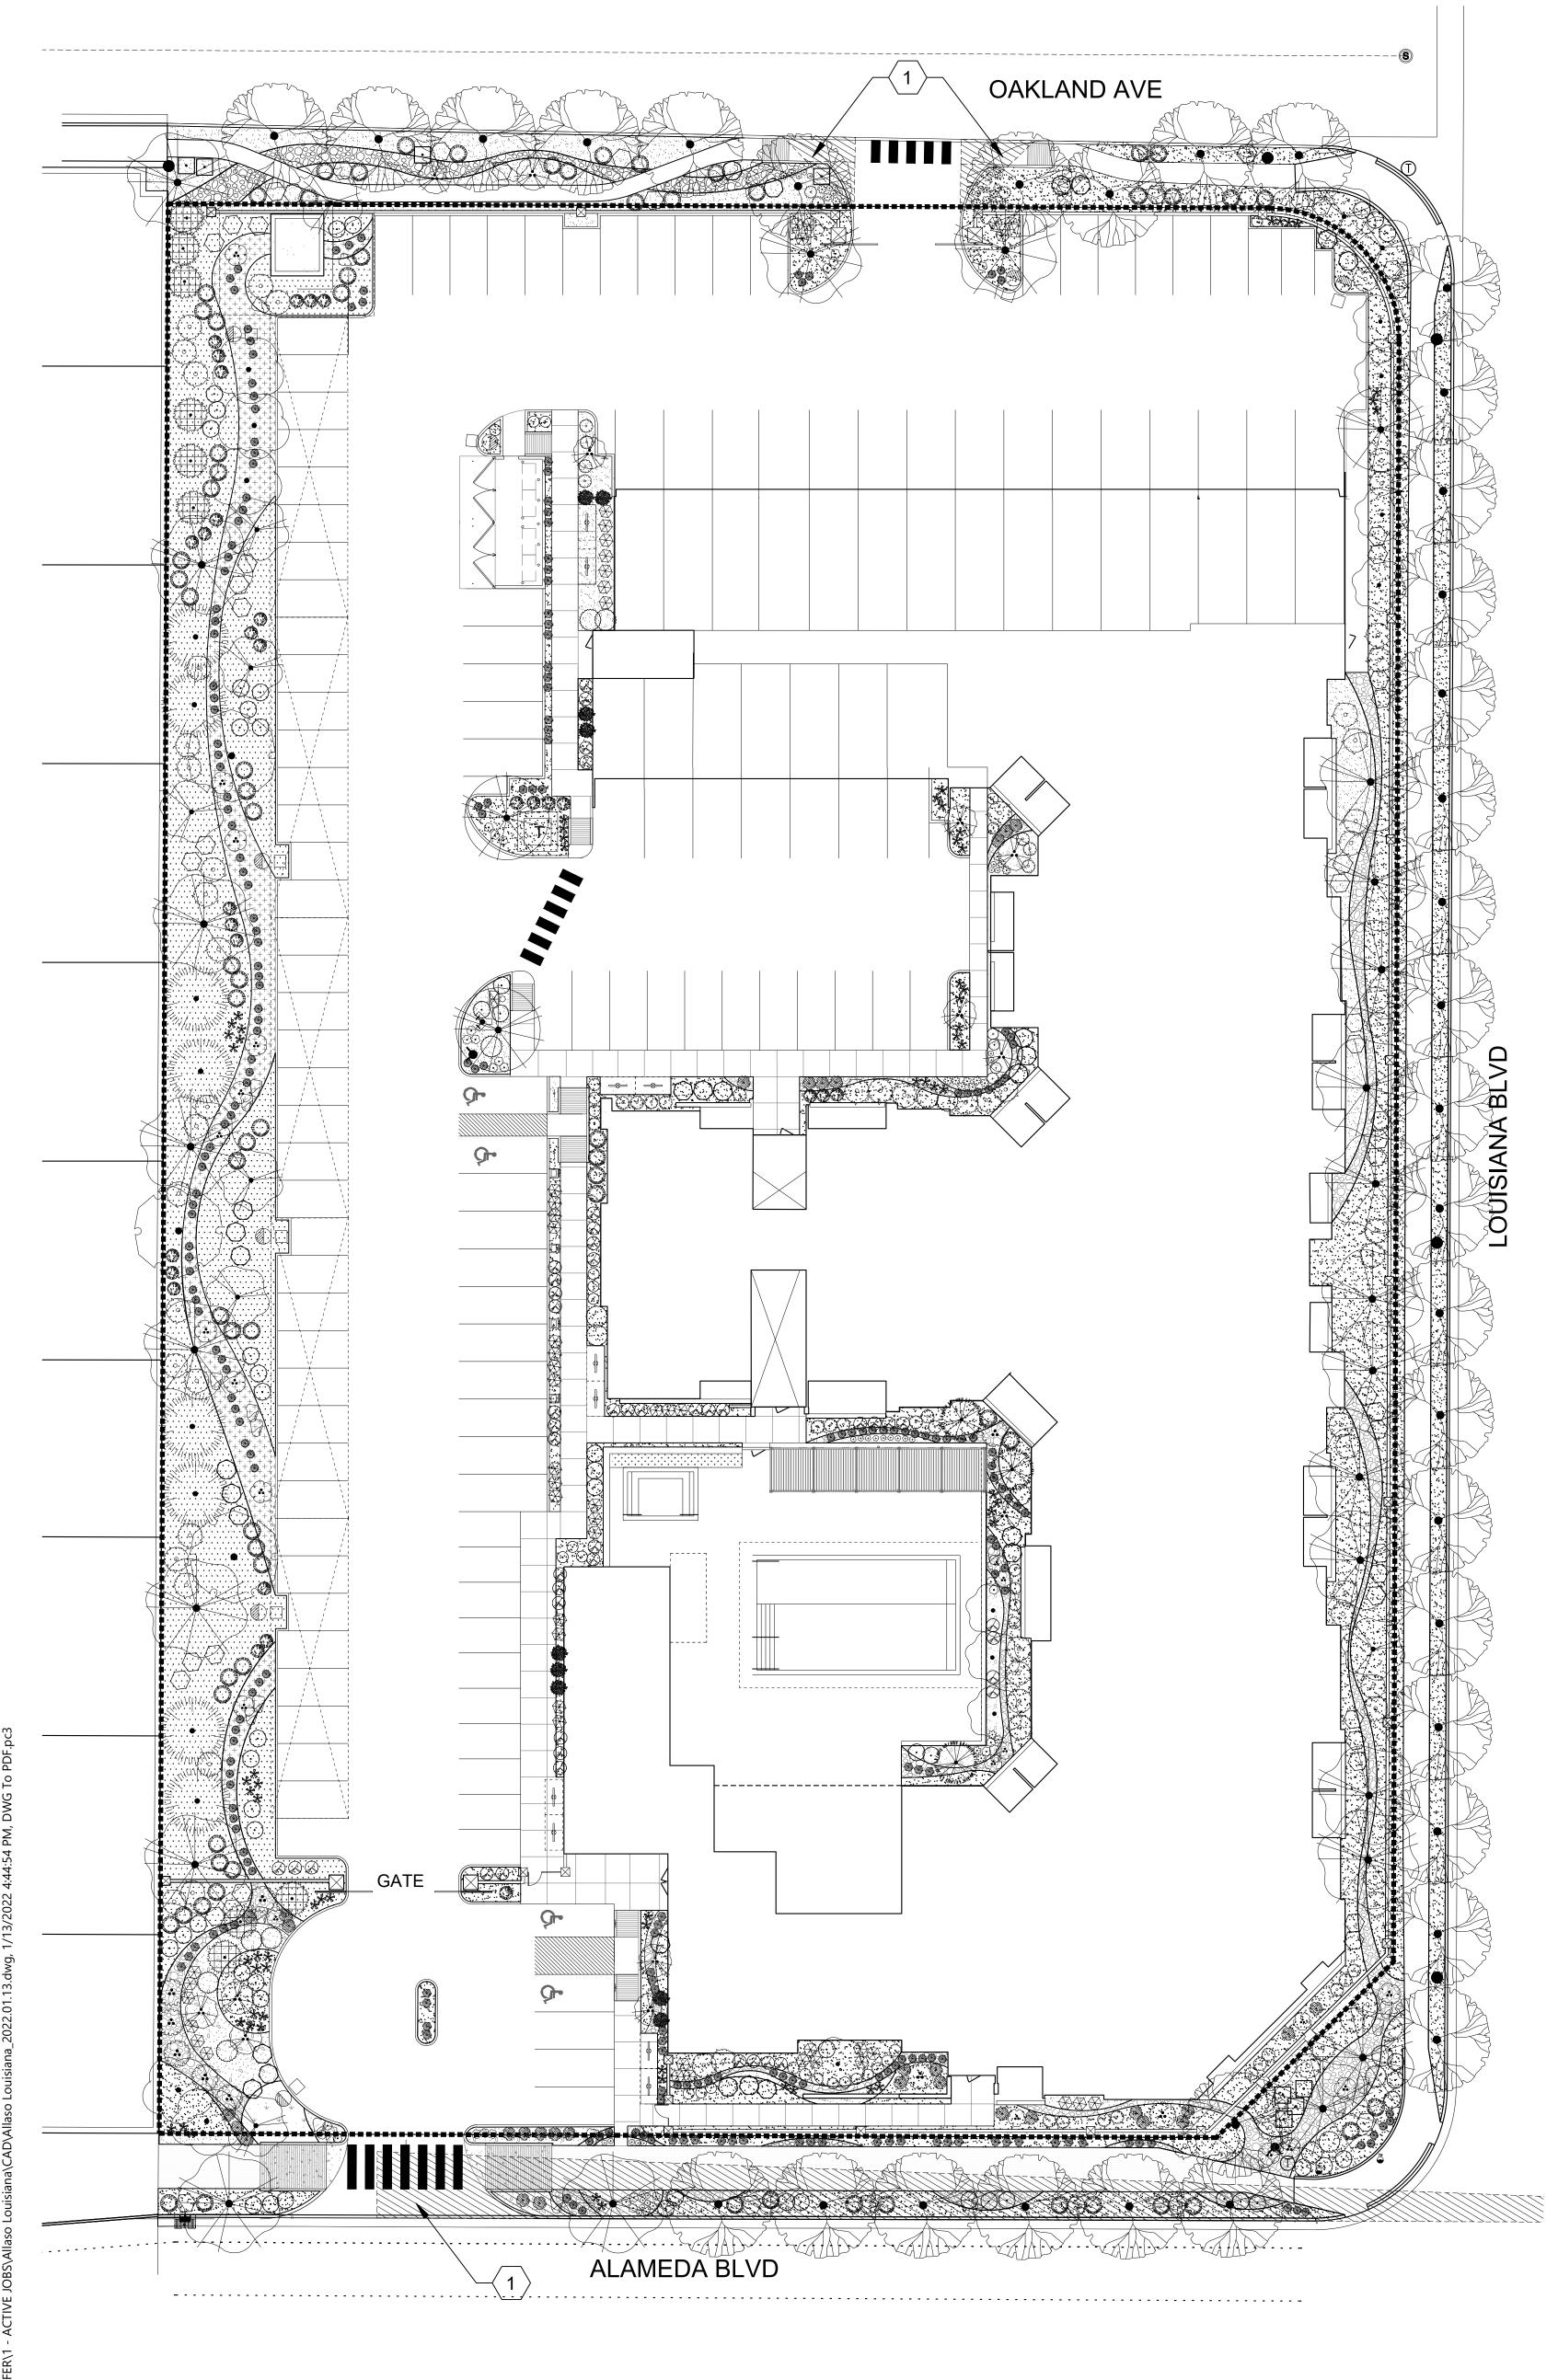

LANDSCAPE PLAN

#### PLANT SCHEDULE QTY BOTANICAL / COMMON NAME SIZE H X W COVERAGE 10 CHILOPSIS LINEARIS 'ART'S SEEDLESS' / ART'S SEEDLESS DESERT WILLOW 24"BOX 20` X 25` COTINUS COGGYGRIA / SMOKE TREE 177X5=885 SF 15 GAL 15` X 15` FORESTIERA NEOMEXICANA / NEW MEXICAN PRIVET 24"BOX 15` X 15` 177X8=1,416 SF GLEDITSIA TRIACANTHOS INERMIS / THORNLESS COMMON HONEYLOCUST 2" B&B 50` X 45` 1590X3=4770 SF LAGERSTROEMIA INDICA / CRAPE MYRTLE 15 GAL 15` X 15` 177X13=2,301 SF 24 PISTACIA CHINENSIS / CHINESE PISTACHE 707X24=16,968 SF QUERCUS LOBATA / VALLEY OAK 2" B&B 707X3=2,121 SF 35 ULMUS PARVIFOLIA `ALLEE` / ALLEE LACEBARK ELM 2" B&B 40` X 40` 1,256X35=43,960 SF QTY BOTANICAL / COMMON NAME COVERAGE JUNIPERUS CHINENSIS 'SPARTAN' / SPARTAN JUNIPER 7X9=63 SF 20 GAL 12` X 3` JUNIPERUS SCOPULORUM / ROCKY MOUNTAIN JUNIPER 314X8=2512 SF PINUS NIGRA / AUSTRIAN BLACK PINE 10` B&B 35` X 25` 491X3=1,473 SF DESERT ACCENTS COVERAGE QTY BOTANICAL / COMMON NAME DASYLIRION TEXANUM / TEXAS SOTOL 5 GAL 5` X 5` 20X14=280 SF HESPERALOE PARVIFLORA / RED YUCCA 5 GAL 3` X 4` 13X7=91 SF **€** •• } NOLINA MICROCARPA / BEARGRASS 5 GAL 5` X 6` 28X9=252 SF <u>GRASSES</u> COVERAGE QTY BOTANICAL / COMMON NAME 172 BOUTELOUA GRACILIS 'BLONDE AMBITION' / BLONDE AMBITION BLUE GRAMA 1 GAL 3` X 3` 7X172=1204 SF 68 CALAMAGROSTIS X ACUTIFLORA 'KARL FOERSTER' / FEATHER REED GRASS 1 GAL 30" X 2` 3X68=204 SF 32 MUHLENBERGIA CAPILLARIS 'REGAL MIST' TM / MUHLY 1 GAL 3` X 3` 7X32=224 SF DECIDUOUS SHRUBS QTY BOTANICAL / COMMON NAME BERBERIS THUNBERGII `CRIMSON PYGMY` / CRIMSON PYGMY BARBERRY 13X68=884 SF 5 GAL 4` X 4` 27 BUDDLEJA DAVIDII / BUTTERFLY BUSH 5 GAL 4` X 4` 13X27=251 SF 29 CARYOPTERIS X CLANDONENSIS `DARK KNIGHT` / BLUE MIST SPIREA 7X29=203 SF 1 GAL 3` X 3` DWELLING UNIT TREES REQUIRED GAILLARDIA X GRANDIFLORA / BLANKETFLOWER 3X27=81 SF 1 GAL 2` X 2` 18 LAVANDULA ANGUSTIFOLIA / ENGLISH LAVENDER 1 GAL 3` X 3` 7X18=126 SF DECIDUOUS TREES REACHING 25' MATURE CANOPY DIAMETER LEUCOPHYLLUM FRUTESCENS / TEXAS SAGE 5 GAL 6` X 6` 28X16=448 SF REQUIRED (50%) PROVIDED 28 NEPETA X FAASSENII `SELECT BLUE` / CATMINT 1 GAL 1` X 2` 42 PENSTEMON PINIFOLIUS / THREADLEAF BEARDTONGUE 13X54=702 SF 54 RHUS AROMATICA `GRO-LOW` / GRO-LOW FRAGRANT SUMAC 5 GAL 4` X 4` ROSA X `KNOCKOUT` TM / ROSE 5 GAL 6` X 5` 23 SALVIA GREGGII / AUTUMN SAGE CHERRY 1 GAL 2` X 3` 7X23=161 SF EVERGREEN SHRUBS QTY BOTANICAL / COMMON NAME 65 CERCOCARPUS LEDIFOLIUS / CURL-LEAF MOUNTAIN MAHOGANY 5 GAL 15` X 15` 177X65=11505 SF 28 ERICAMERIA LARICIFOLIA / TURPENTINE BUSH 5 GAL 3` X 4` 13X28=364 SF 56 FALLUGIA PARADOXA / APACHE PLUME 5 GAL 6` X 7` 38X56=2128 SF F. 75 PINUS MUGO MUGO / DWARF MUGO PINE 13X75=975 SF G. 5 GAL 4` X 4` 46 RHAPHIOLEPIS INDICA / INDIAN HAWTHORN 5 GAL 3` X 4` 13X46=598 SF 52 ROSMARINUS OFFICINALIS / ROSEMARY 5 GAL 6` X 6`

	HEATED ENCLOSURE  REDUCED PRESSURE BACKFLOW PREVENTER  GALVANIZED MALE ADAPTER  (1 OF 2) GALVANIZED UNION  (1 OF 2) GALVANIZED STREET 90*  (1 OF 4) 4" NIPPLE (TYP.)
4" THICK CONCRETE PAD————————————————————————————————————	AUTO DRAIN VALVE WITH GAL. TEE (TYP.) GAL. CLOSE NIPPLE (TYP.) GAL. UNION (TYP.) PVC SLEEVE THROUGH CONCRETE (TYP.)  GAL. 30" NIPPLE  30"
GAL. 90*  SCH 40 PVC MAIN  SLIP X THREAD MALE ADAPTER GAL. 12" NIPPLE	GAL. 30" NIPPLE  VALVE BOX AUTO VALVE  SLIP X THREAD MALE ADAPTER Sch 40 PVC MASTERLINE  NOTE:  1. INSTALL BACKFLOW PREVENTER AS REQUIRED BY LOCAL CODES AND HEALTH DEPARTMENT. VERIFY LOCAL REQUIREMENTS PRIOR TO INSTALLATION.

RP BACKFLOW/MASTER VALVE DETAIL

	MATE	RIAL SCHEDULE
	SYMBOL	DESCRIPTION
SF		LARGE BOULDER
	SYMBOL	DESCRIPTION

1" MOUNTAINAIR SUNRISE GOLD GRAVEL OVER FILTER

1" PUEBLO ROSE GRAVEL OVER FILTER FABRIC

2-4" BLUE SAIS COBBLE OVER FILTER FABRIC

4-8" WALLIN COBBLE

4-8" MOUNTAINAIR SUNRISE GOLD COBBLE

TOTAL AREA OF PROJECT LESS BUILDING	121,023 SF
NET LOT AREA	41,570 SF 79,453 SF
REQUIRED LANDSCAPE AREA MINIMUM 25% OF NET LOT AREA 19,864 SF ACTUAL LANDSCAPE AREA LANDSCAPE AREA REQUIREMENT EXCEEDED	30,782 SF 10,918 SF
LANDSCAPE COVERAGE REQUIRED - 75% COVERAGE PROVIDED REQUIREMENT EXCEEDED	23,087 SF 103,904 SF 80,817 SF
REQUIRED 25% COVERAGE BY GROUND-LEVEL PLANTS ACTUAL COVERAGE BY GROUND-LEVEL PLANTS REQUIREMENT EXCEEDED	5,772 SF 22,527 SF 16,755 SF
SOD ALLOWED (10%) SOD ACTUAL UNDER MINIMUM ALLOWED	2,267 SF 164 SF 2,103 SF
PARKING LOT TREES (1 TREE PER 10 PARKING SPACES 146 PARKING SPACES PROVIDED REQUIRED (146 / 10) PROVIDED	) 15 TREES 15 TREES
STREET TREES REQUIRED (1 TREE PER 25 LF) STREET TREES PROVIDED	39 TREES 39 TREES

(1 TREE PER 1ST STORY UNIT + 1 TREE PER 2ND

STORY UNIT. 67 UNITS TOTAL) 67 TREES

#### GENERAL LANDSCAPE NOTES

PROVIDED

CONTRACTOR TO VERIFY EXISTING UTILITY LOCATIONS BEFORE EXCAVATION AND RESPONSIBILITY FOR MAINTENANCE: THE CONTRACTOR WILL BE RESPONSIBLE FOR MAINTENANCE OF THE LANDSCAPE DURING CONSTRUCTION AND DURING A 90 DAY-MAINTENANCE PERIOD FOLLOWING SUBSTANTIAL COMPLETION. THE OWNER WILL BE RESPONSIBLE FOR MAINTENANCE FOLLOWING THE 90-DAY MAINTENANCE PERIOD. THE PROPERTY OWNER SHALL MAINTAIN RIGHT-OF-WAY (ROW) LANDSCAPING IN A NEAT AND HEALTHY CONDITION. STATEMENT OF COMPLIANCE WITH CITY OF ALBUQUERQUE: THE LANDSCAPING SHALL COMPLY WITH THE CITY OF ALBUQUERQUE INTEGRATED DEVELOPMENT ORDINANCE (IDO) INCLUDING, BUT NOT LIMITED TO, GENERAL LANDSCAPING REGULATIONS, WATER CONSERVATION LANDSCAPING AND WATER WASTE REGULATIONS, POLLEN-RELATED REGULATIONS, MINIMUM VEGETATIVE COVERAGE REQUIREMENTS AND STREET TREE TIMING OF LANDSCAPE INSTALLATION: INSTALLATION OF THE LANDSCAPING SHALL BE COMPLETE WITHIN 60 DAYS OF THE RELATED BUILDING'S OCCUPANCY. SURFACE TREATMENT: LANDSCAPE AREAS SHALL BE COVERED WITH MULCH. LANDSCAPE, FENCING, AND SIGNING WILL NOT INTERFERE WITH CLEAR SIGHT REQUIREMENTS. THEREFORE, SIGNS, WALLS, TREES, AND SHRUBBERY BETWEEN 3' AND 8' (AS MEASURED FROM THE GUTTER PAN) WILL NOT BE ACCEPTABLE IN THIS AREA. LANDSCAPING WILL BE WATERED WITH AN AUTOMATED IRRIGATION SYSTEM

34 TREES

35 TREES

THAT INCLUDES DRIP ZONES FOR LANDSCAPING. MINIMUM PLANT SIZES ARE AS PER CITY OF ALBUQUERQUE STANDARDS: 2" CALIPER TREES, 6' HEIGHT CONIFERS, AND 1 GALLON SHRUBS. AREAS DISTURBED DURING CONSTRUCTION, INCLUDING AREAS NOT WITHIN THE PROPERTY LINE, WILL BE STABILIZED. 28X52=1,456 SF J. ROOF DRAINS: SURFACE DRAINAGE OFF DOWNSPOUTS SHALL BE DIRECTED AWAY FROM BUILDINGS INTO LANDSCAPE AREAS OR ENGINEERED DRAINAGE SYSTEMS. REFER TO CIVIL. VEGETATIVE SCREENING SURROUNDING GROUND-MOUNTED TRANSFORMERS AND UTILITY


PADS SHALL ALLOW 10' OF CLEARANCE IN FRONT OF THE EQUIPMENT DOOR AND 5' OF CLEARANCE ON THE REMAINING SIDES FOR SAFE OPERATION AND MAINTENANCE. NEW PLANTINGS DO NOT EXCEED THE 10% LIMIT FOR HIGH WATER TURF. ORGANIC BARK MULCH IS PROVIDED AT EACH TREE FROM ROOT BALL EXTENDING OUT TO DRIPLINE PER CITY OF ALBUQUERQUE IDO 14-16-5-6(C)(5)(b) N. WHERE MULCH IS ADJACENT TO CONCRETE OR ASPHALT, FINISH GRADE OF

O. PLANT MATERIAL SHALL BE FREE OF DISEASE AND INSECTS AND SHALL CONFORM TO THE AMERICAN STANDARD FOR NURSERY STOCK (ASNA) OF THE AMERICAN NURSERY AND LANDSCAPE ASSOCIATION. P. ALL LANDSCAPING CONTIGUOUS TO INDIGENOUS AREAS TO BE PLANTED WITH INDIGENOUS

MULCH SHALL 1/2" BELOW TOP OF CONCRETE, UNLESS OTHERWISE INDICATED.

Q. PLANTINGS IN CLEAR SIGHT TRIANGLE NOT TO OBSTRUCT LINE OF VISION FROM 3' HEIGHT TO 8' HEIGHT'

#### **KEYED NOTES**

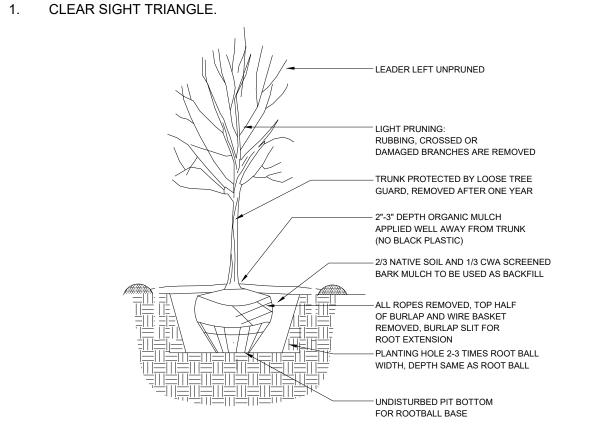

N.T.S.

TREE PLANTING DETAIL

**YELLOWSTONE** www.yellowstonelandscape.com PO Box 10597 Albuquerque, NM 87184


505.898.9615




Date: <u>11/12/2021</u> Revisions:

> 01/07/2022 HA 01/13/2022 HA

Drawn by: PL Reviewed by: <u>JB</u>

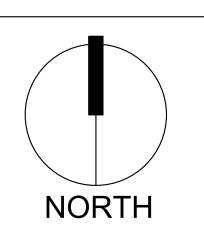

Scale: 1" = 20'

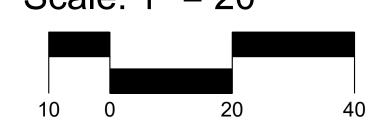

Sheet Title:


Landscape Plan


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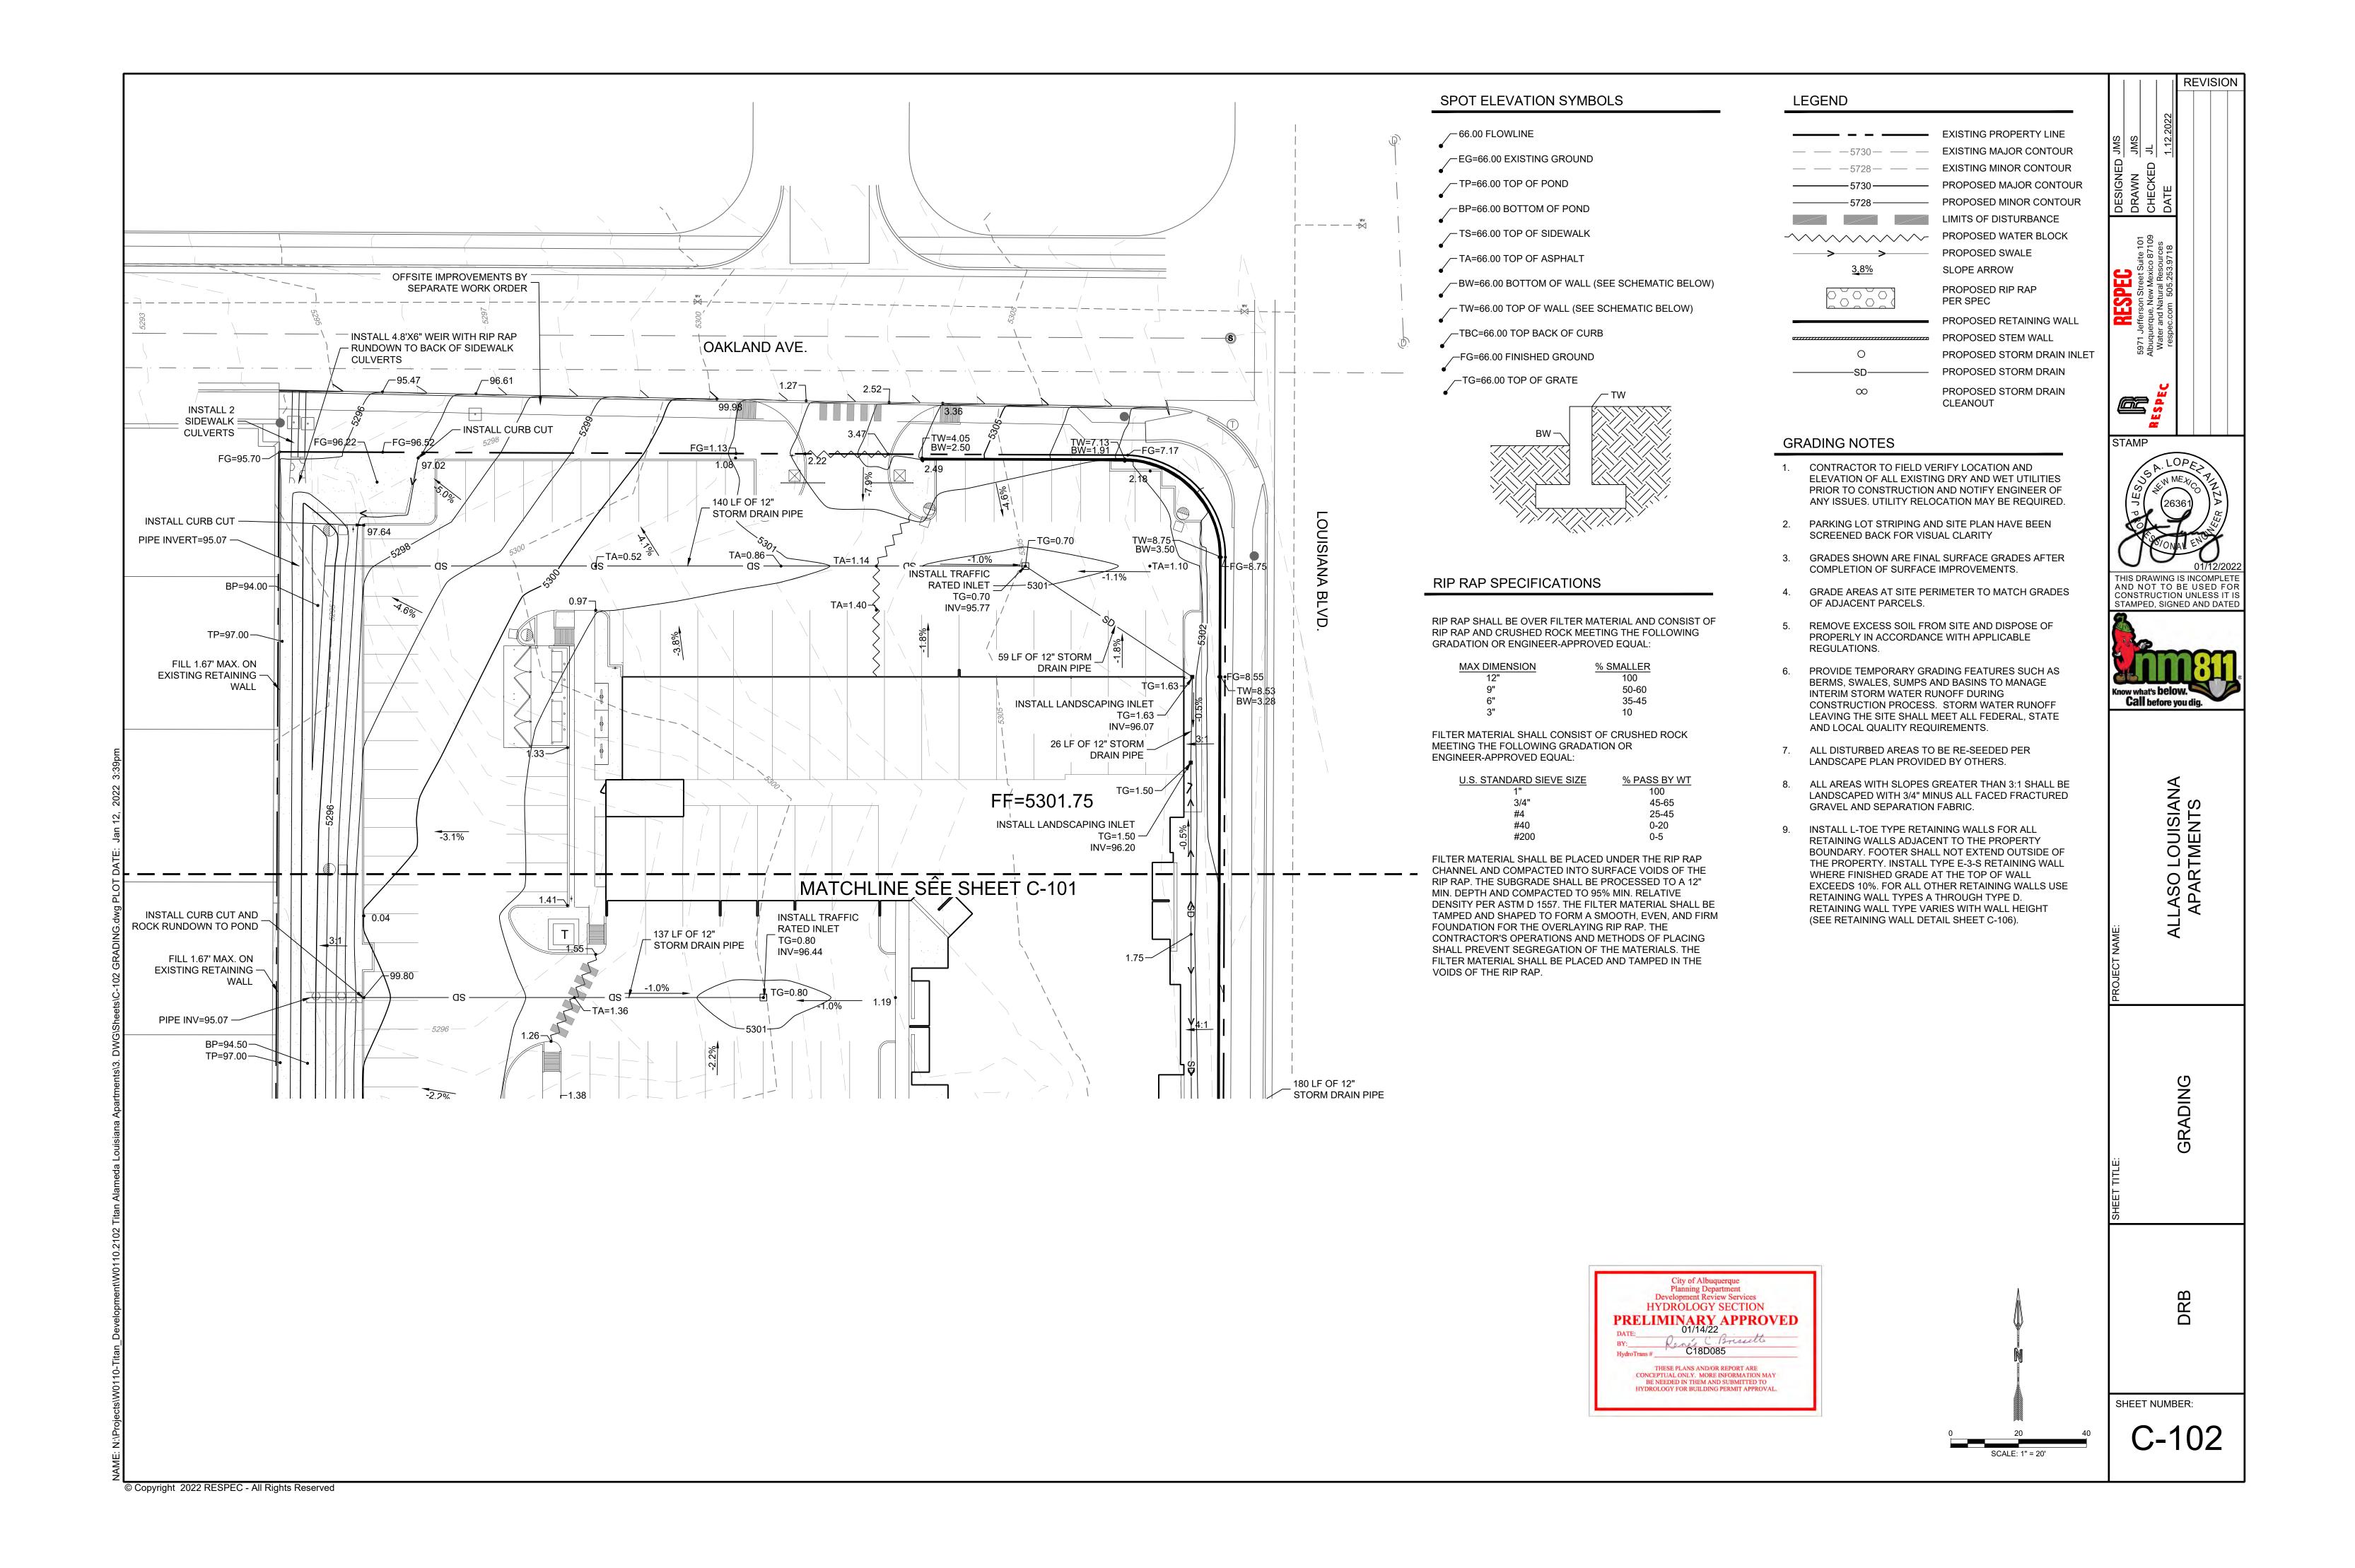
Subtotal Coverage


103,904 SF


Total Coverage




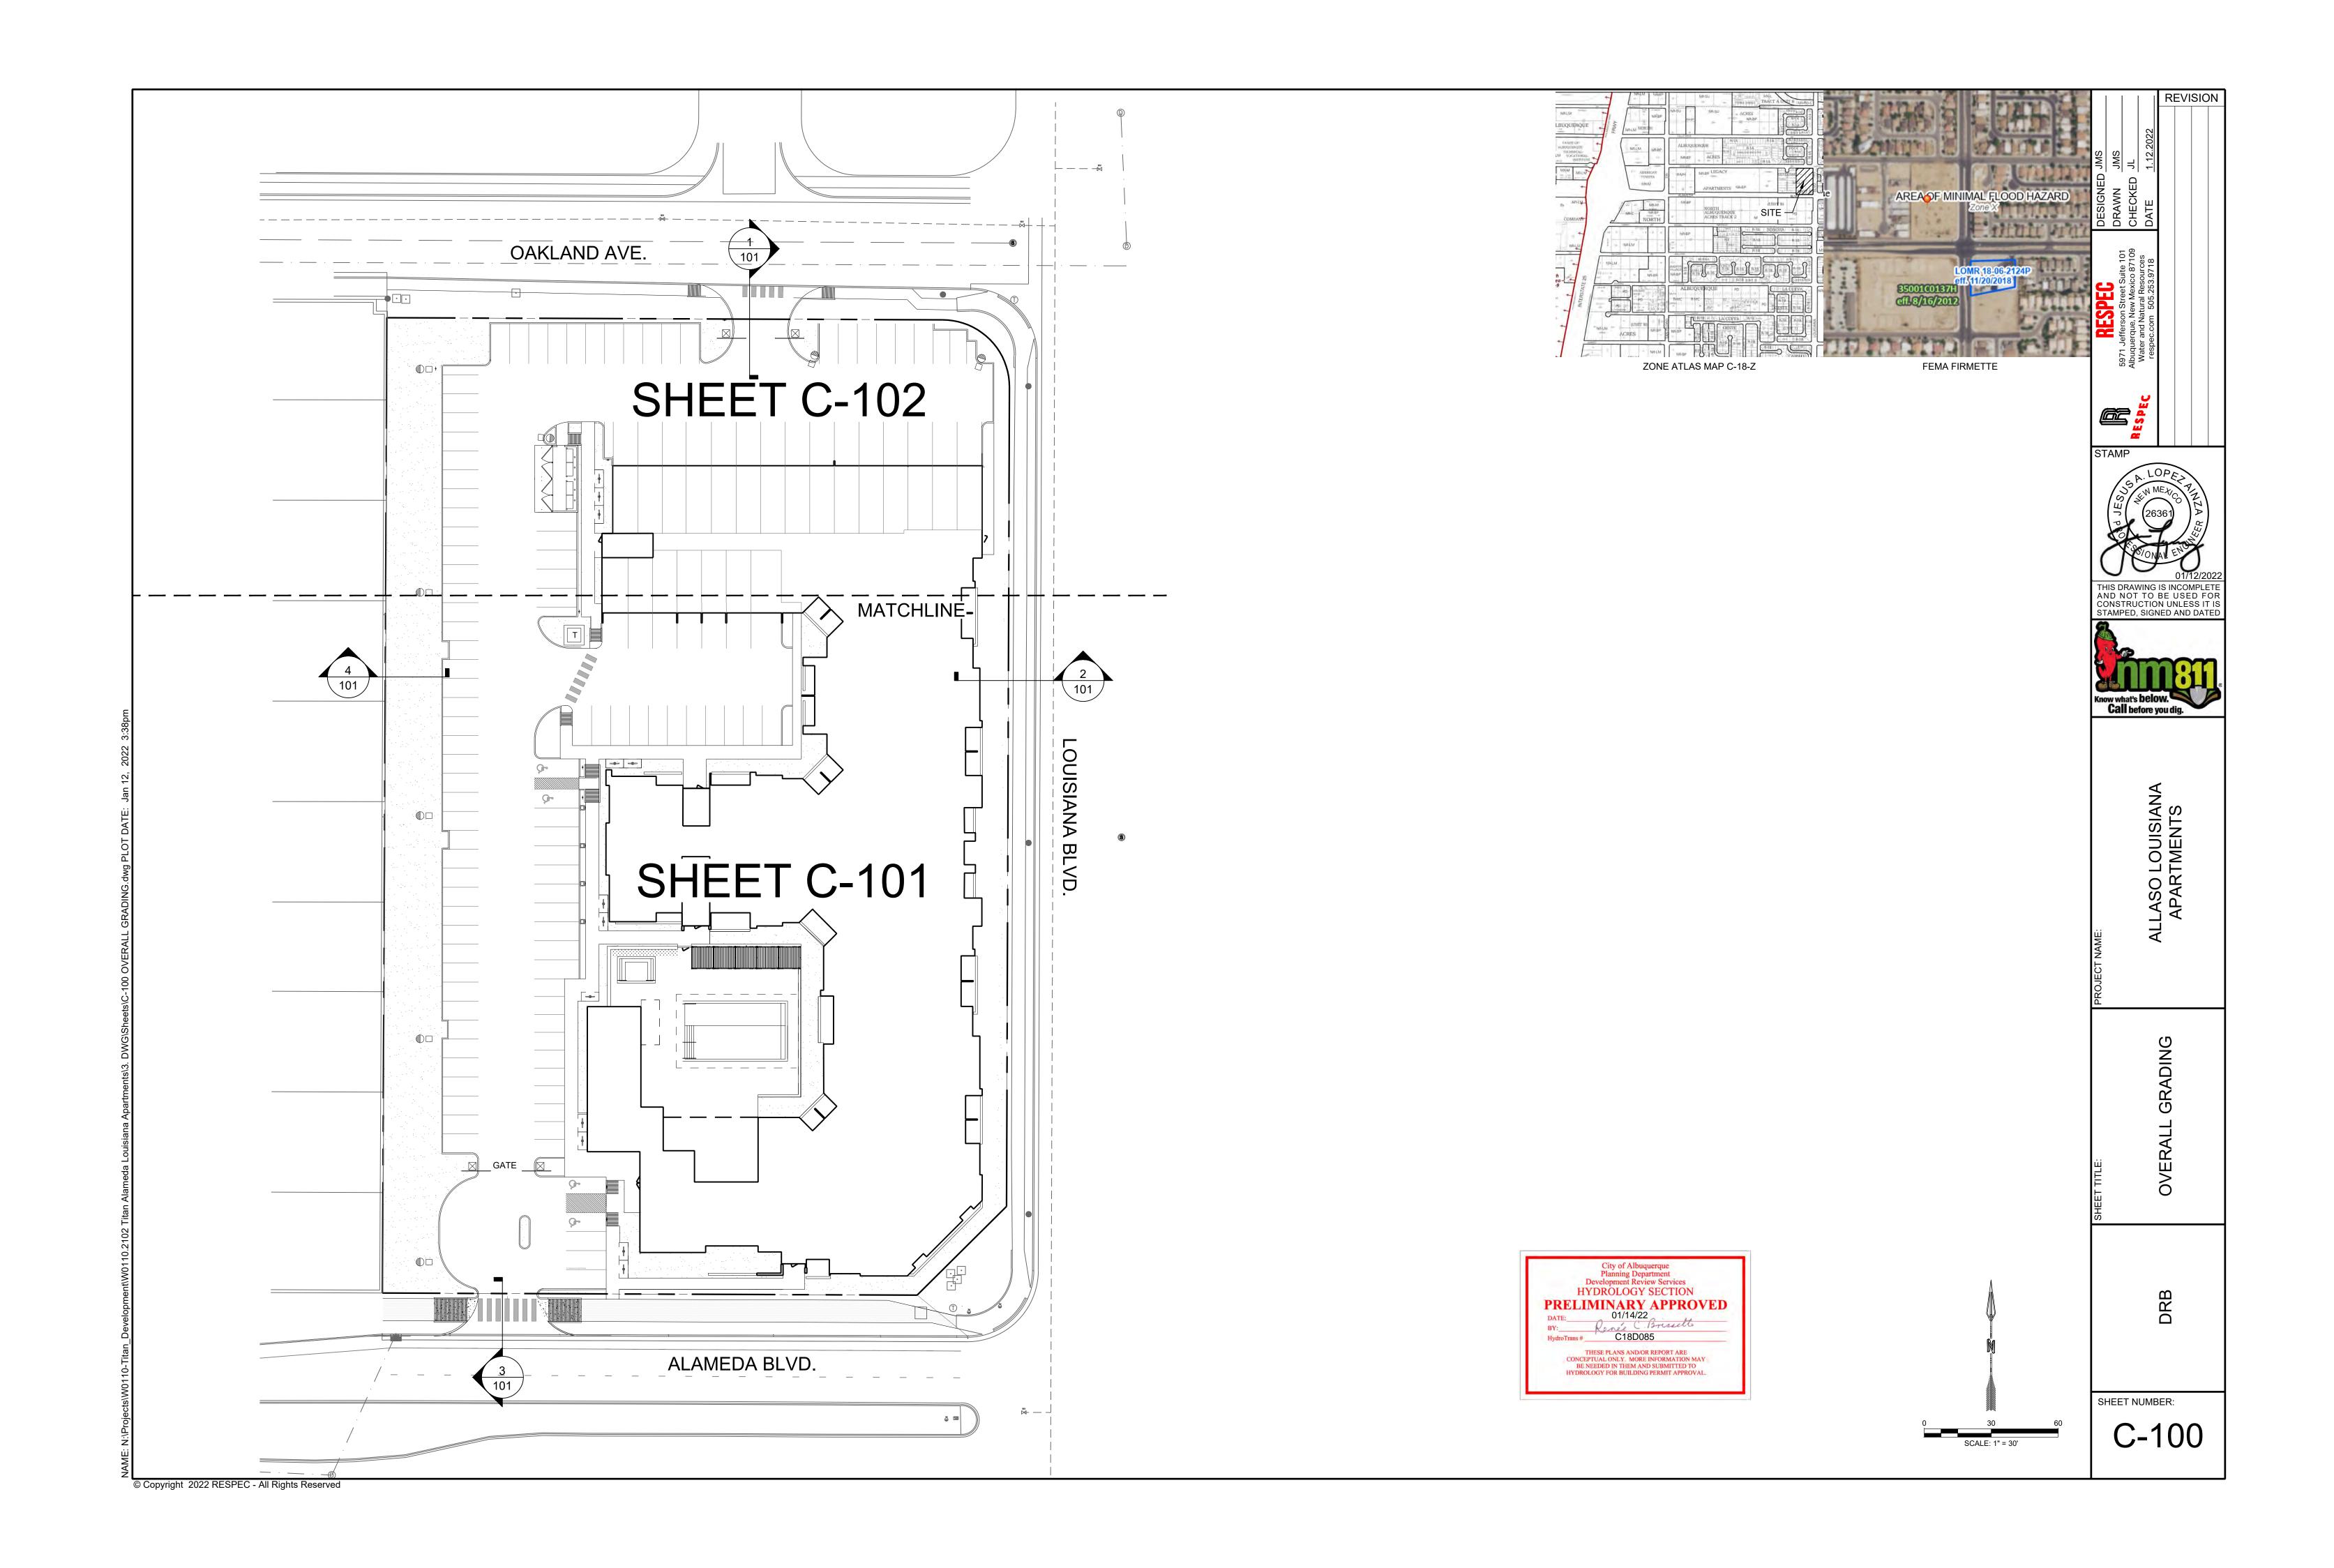

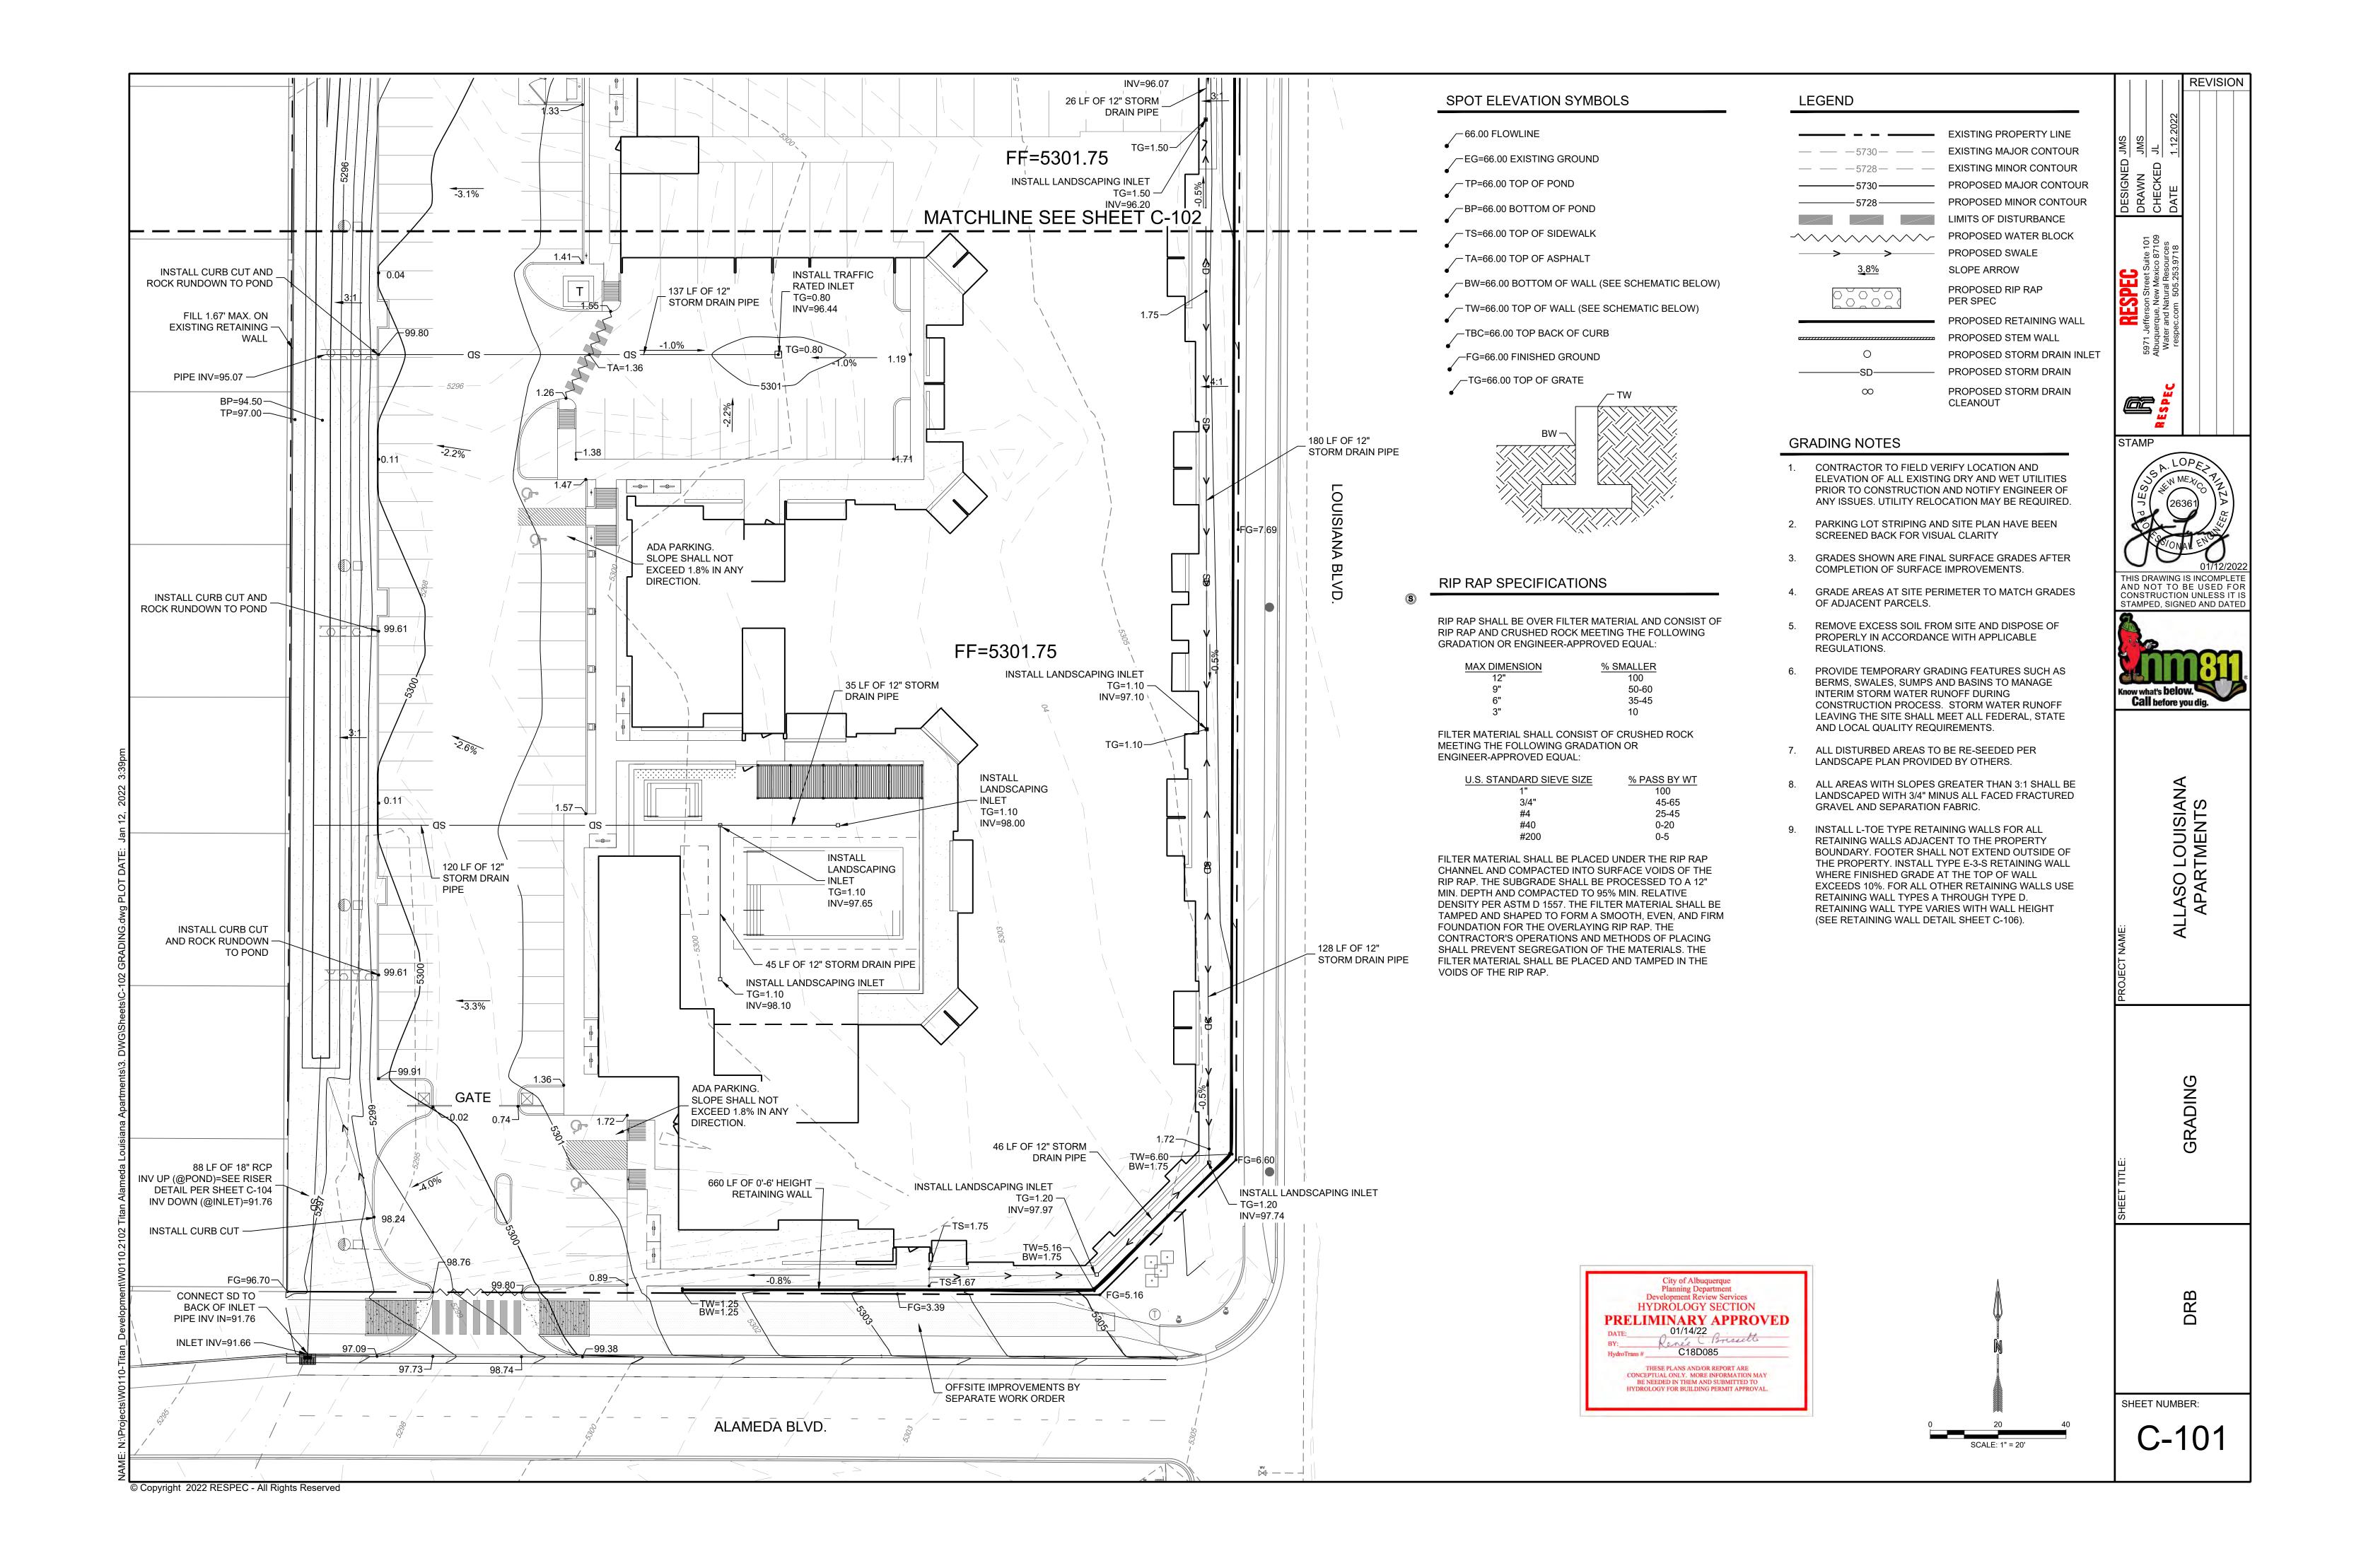

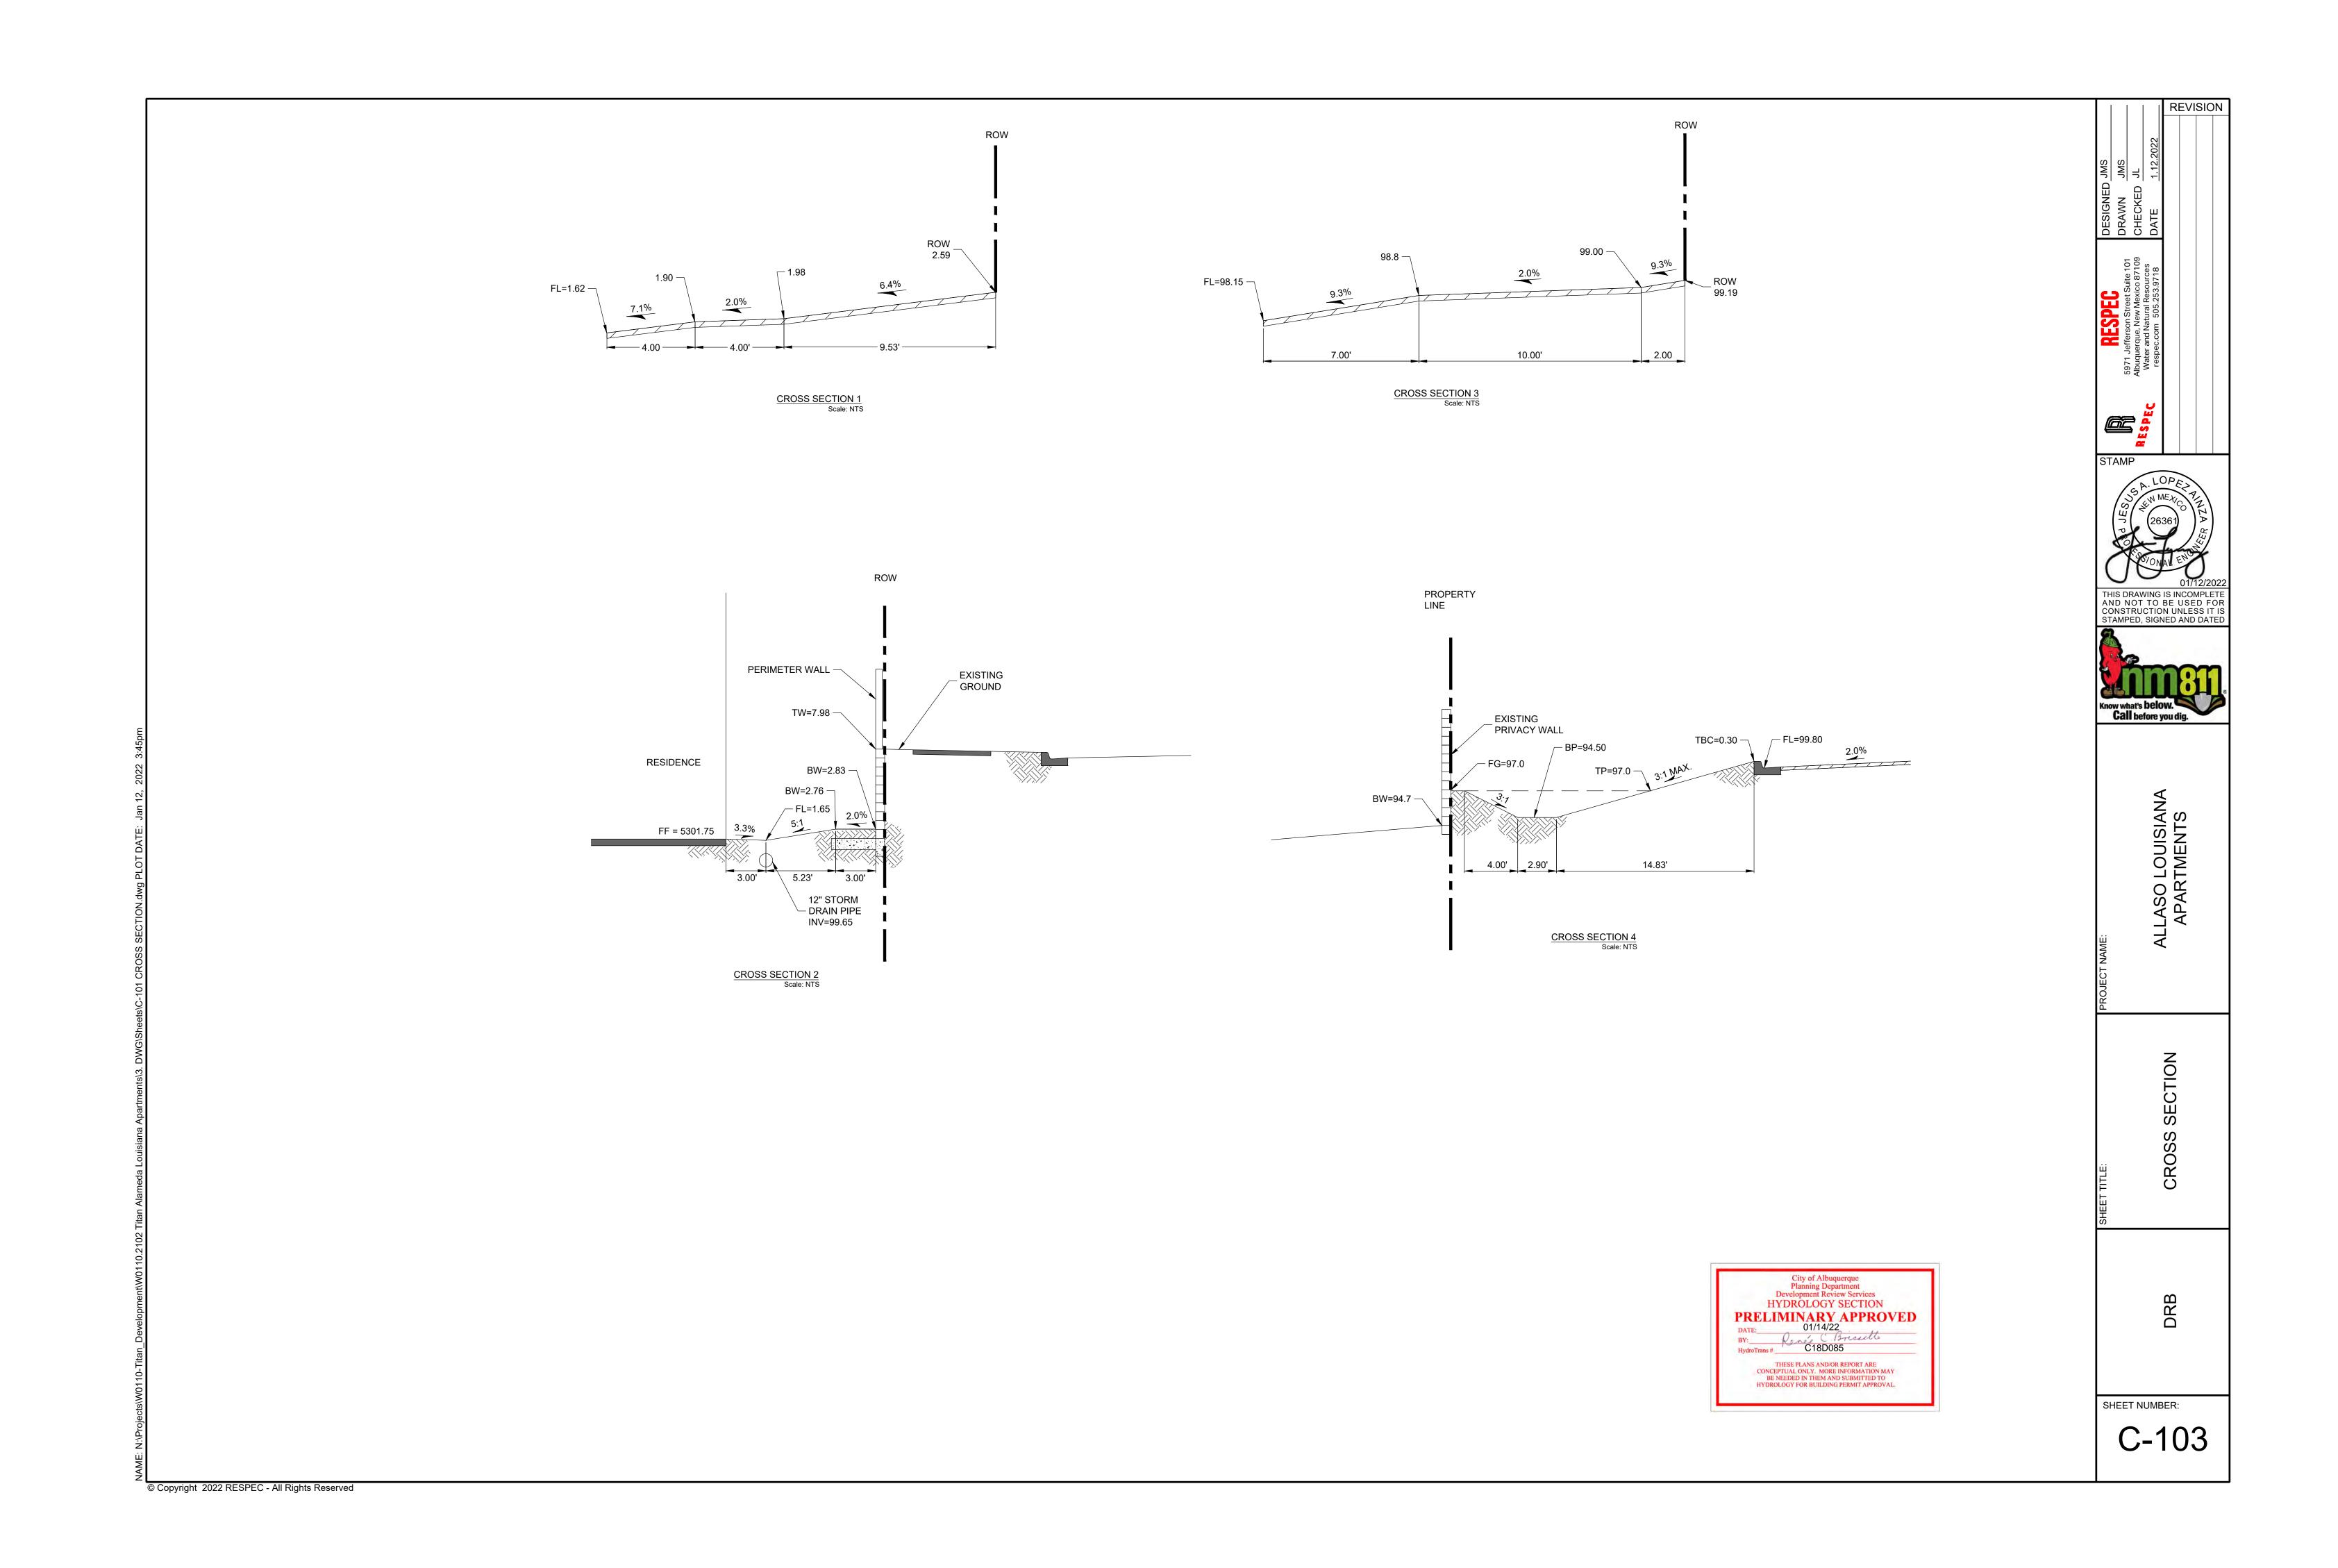

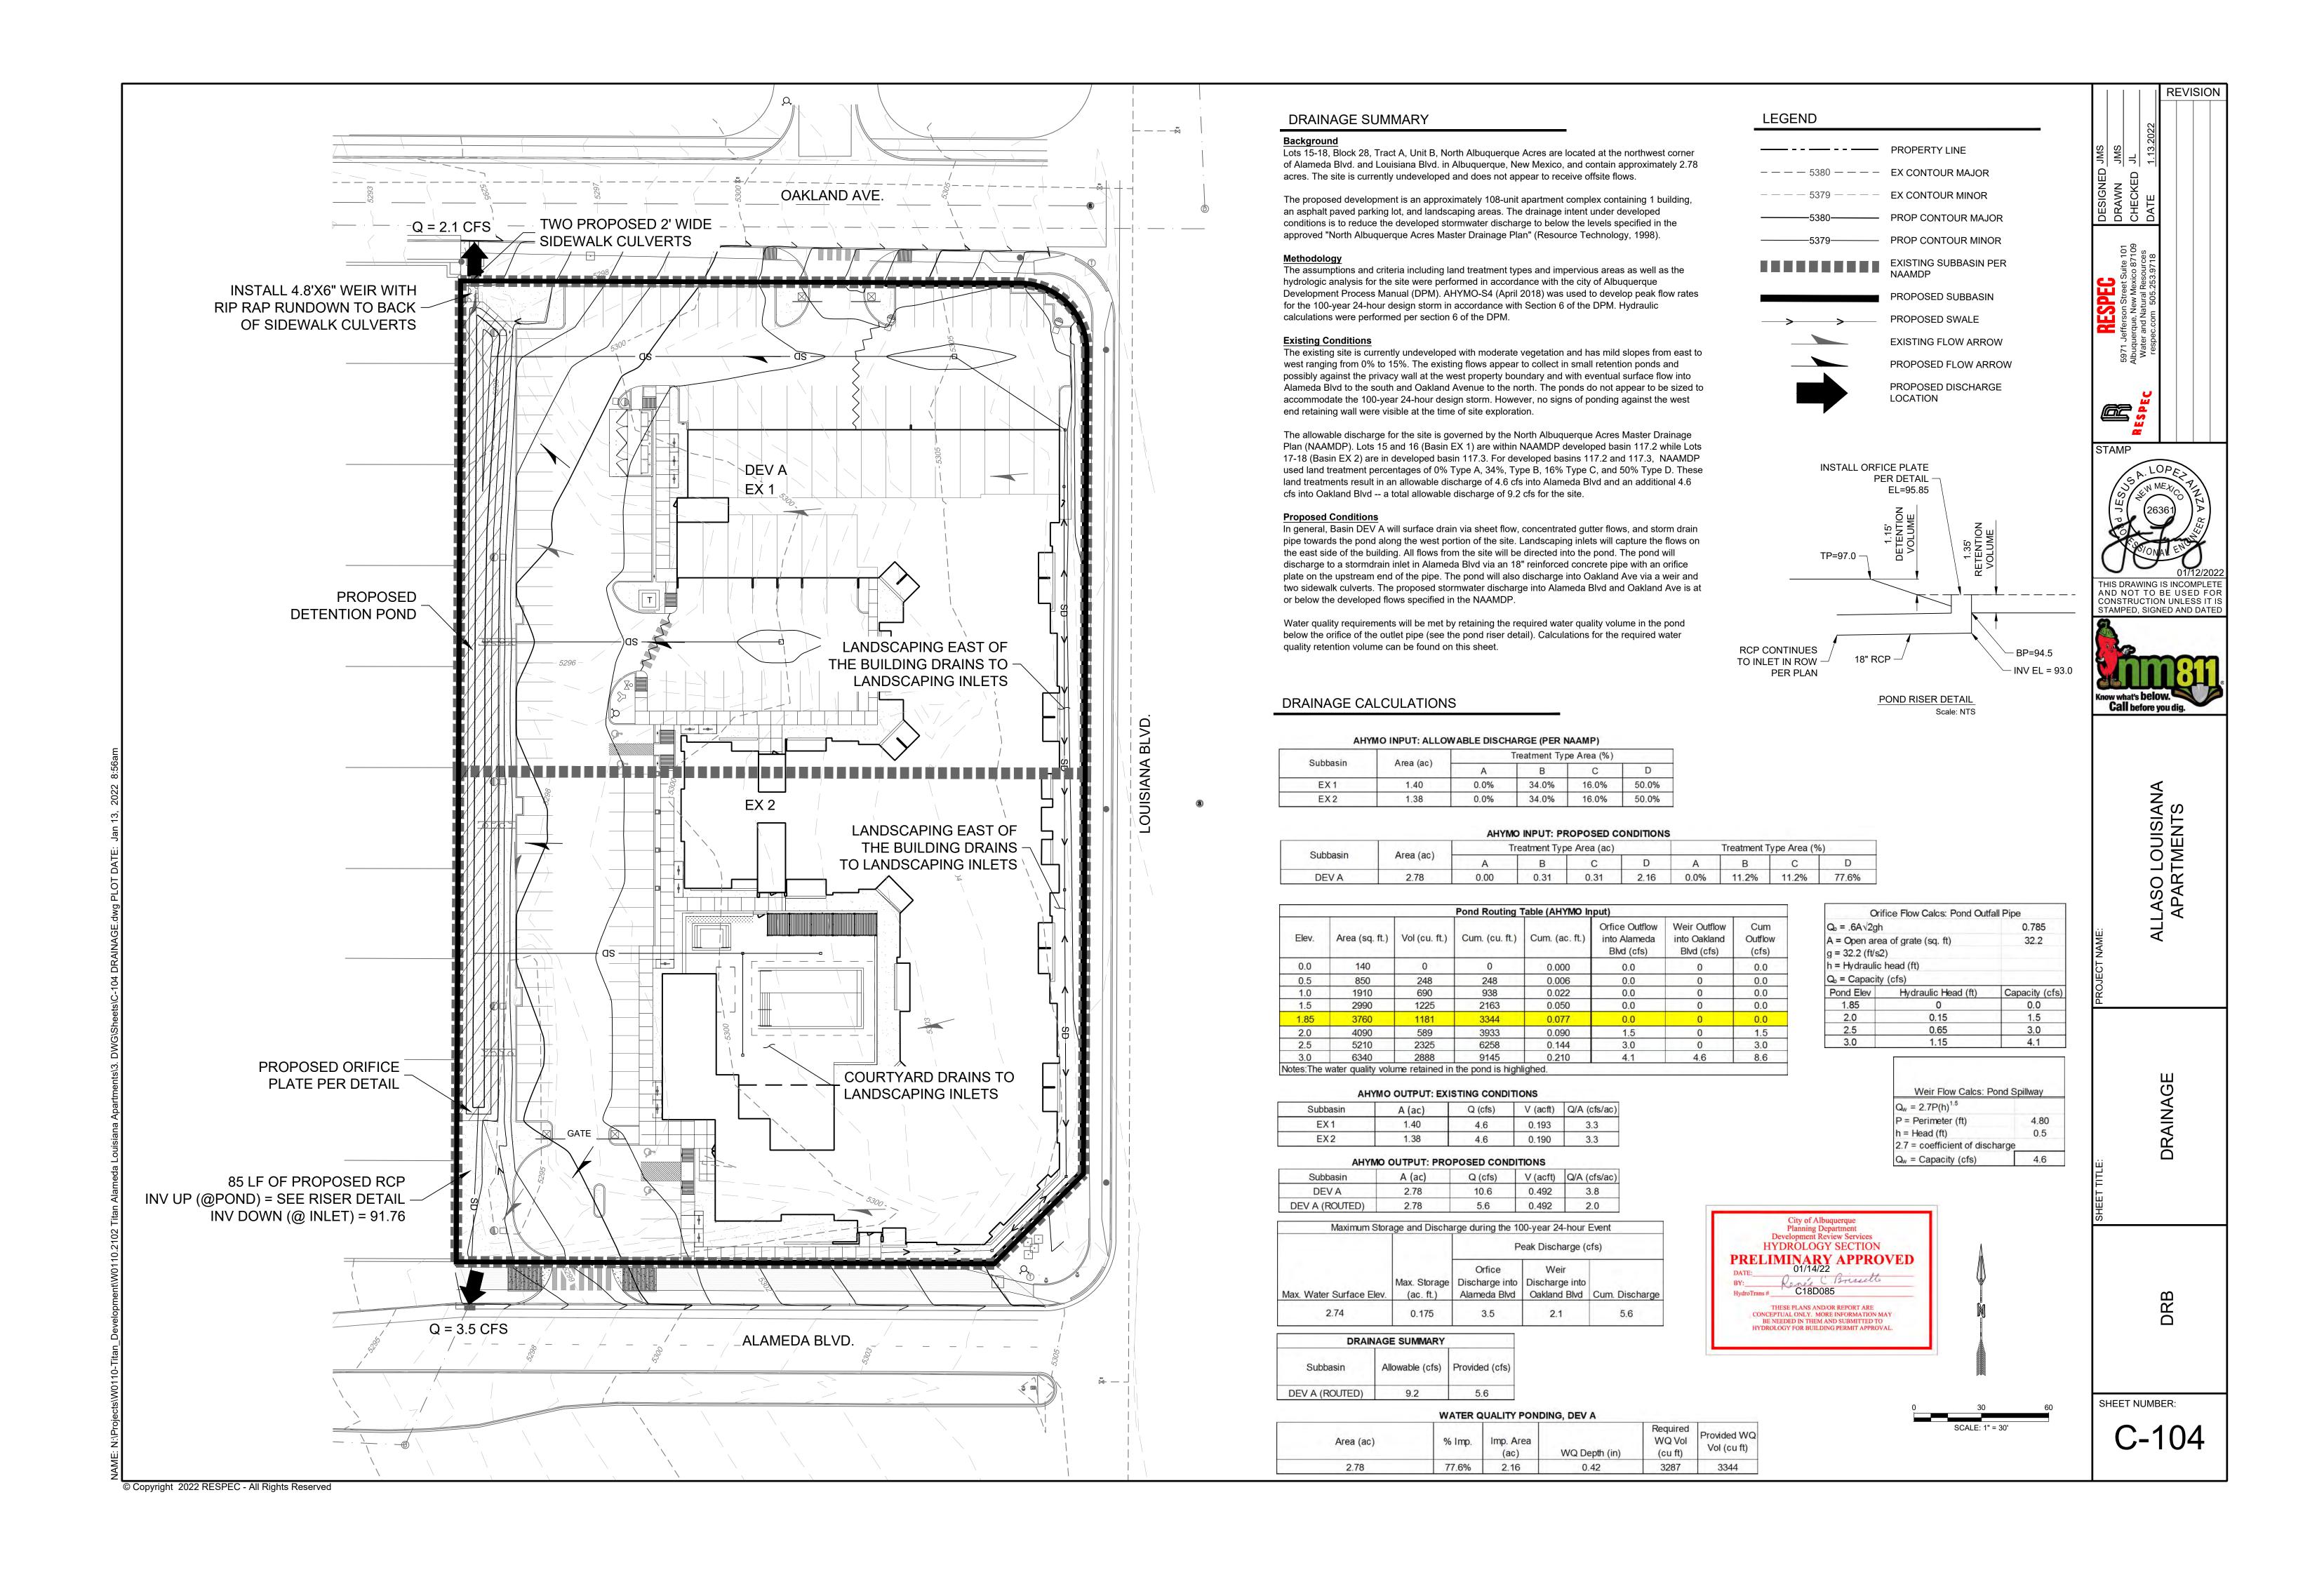

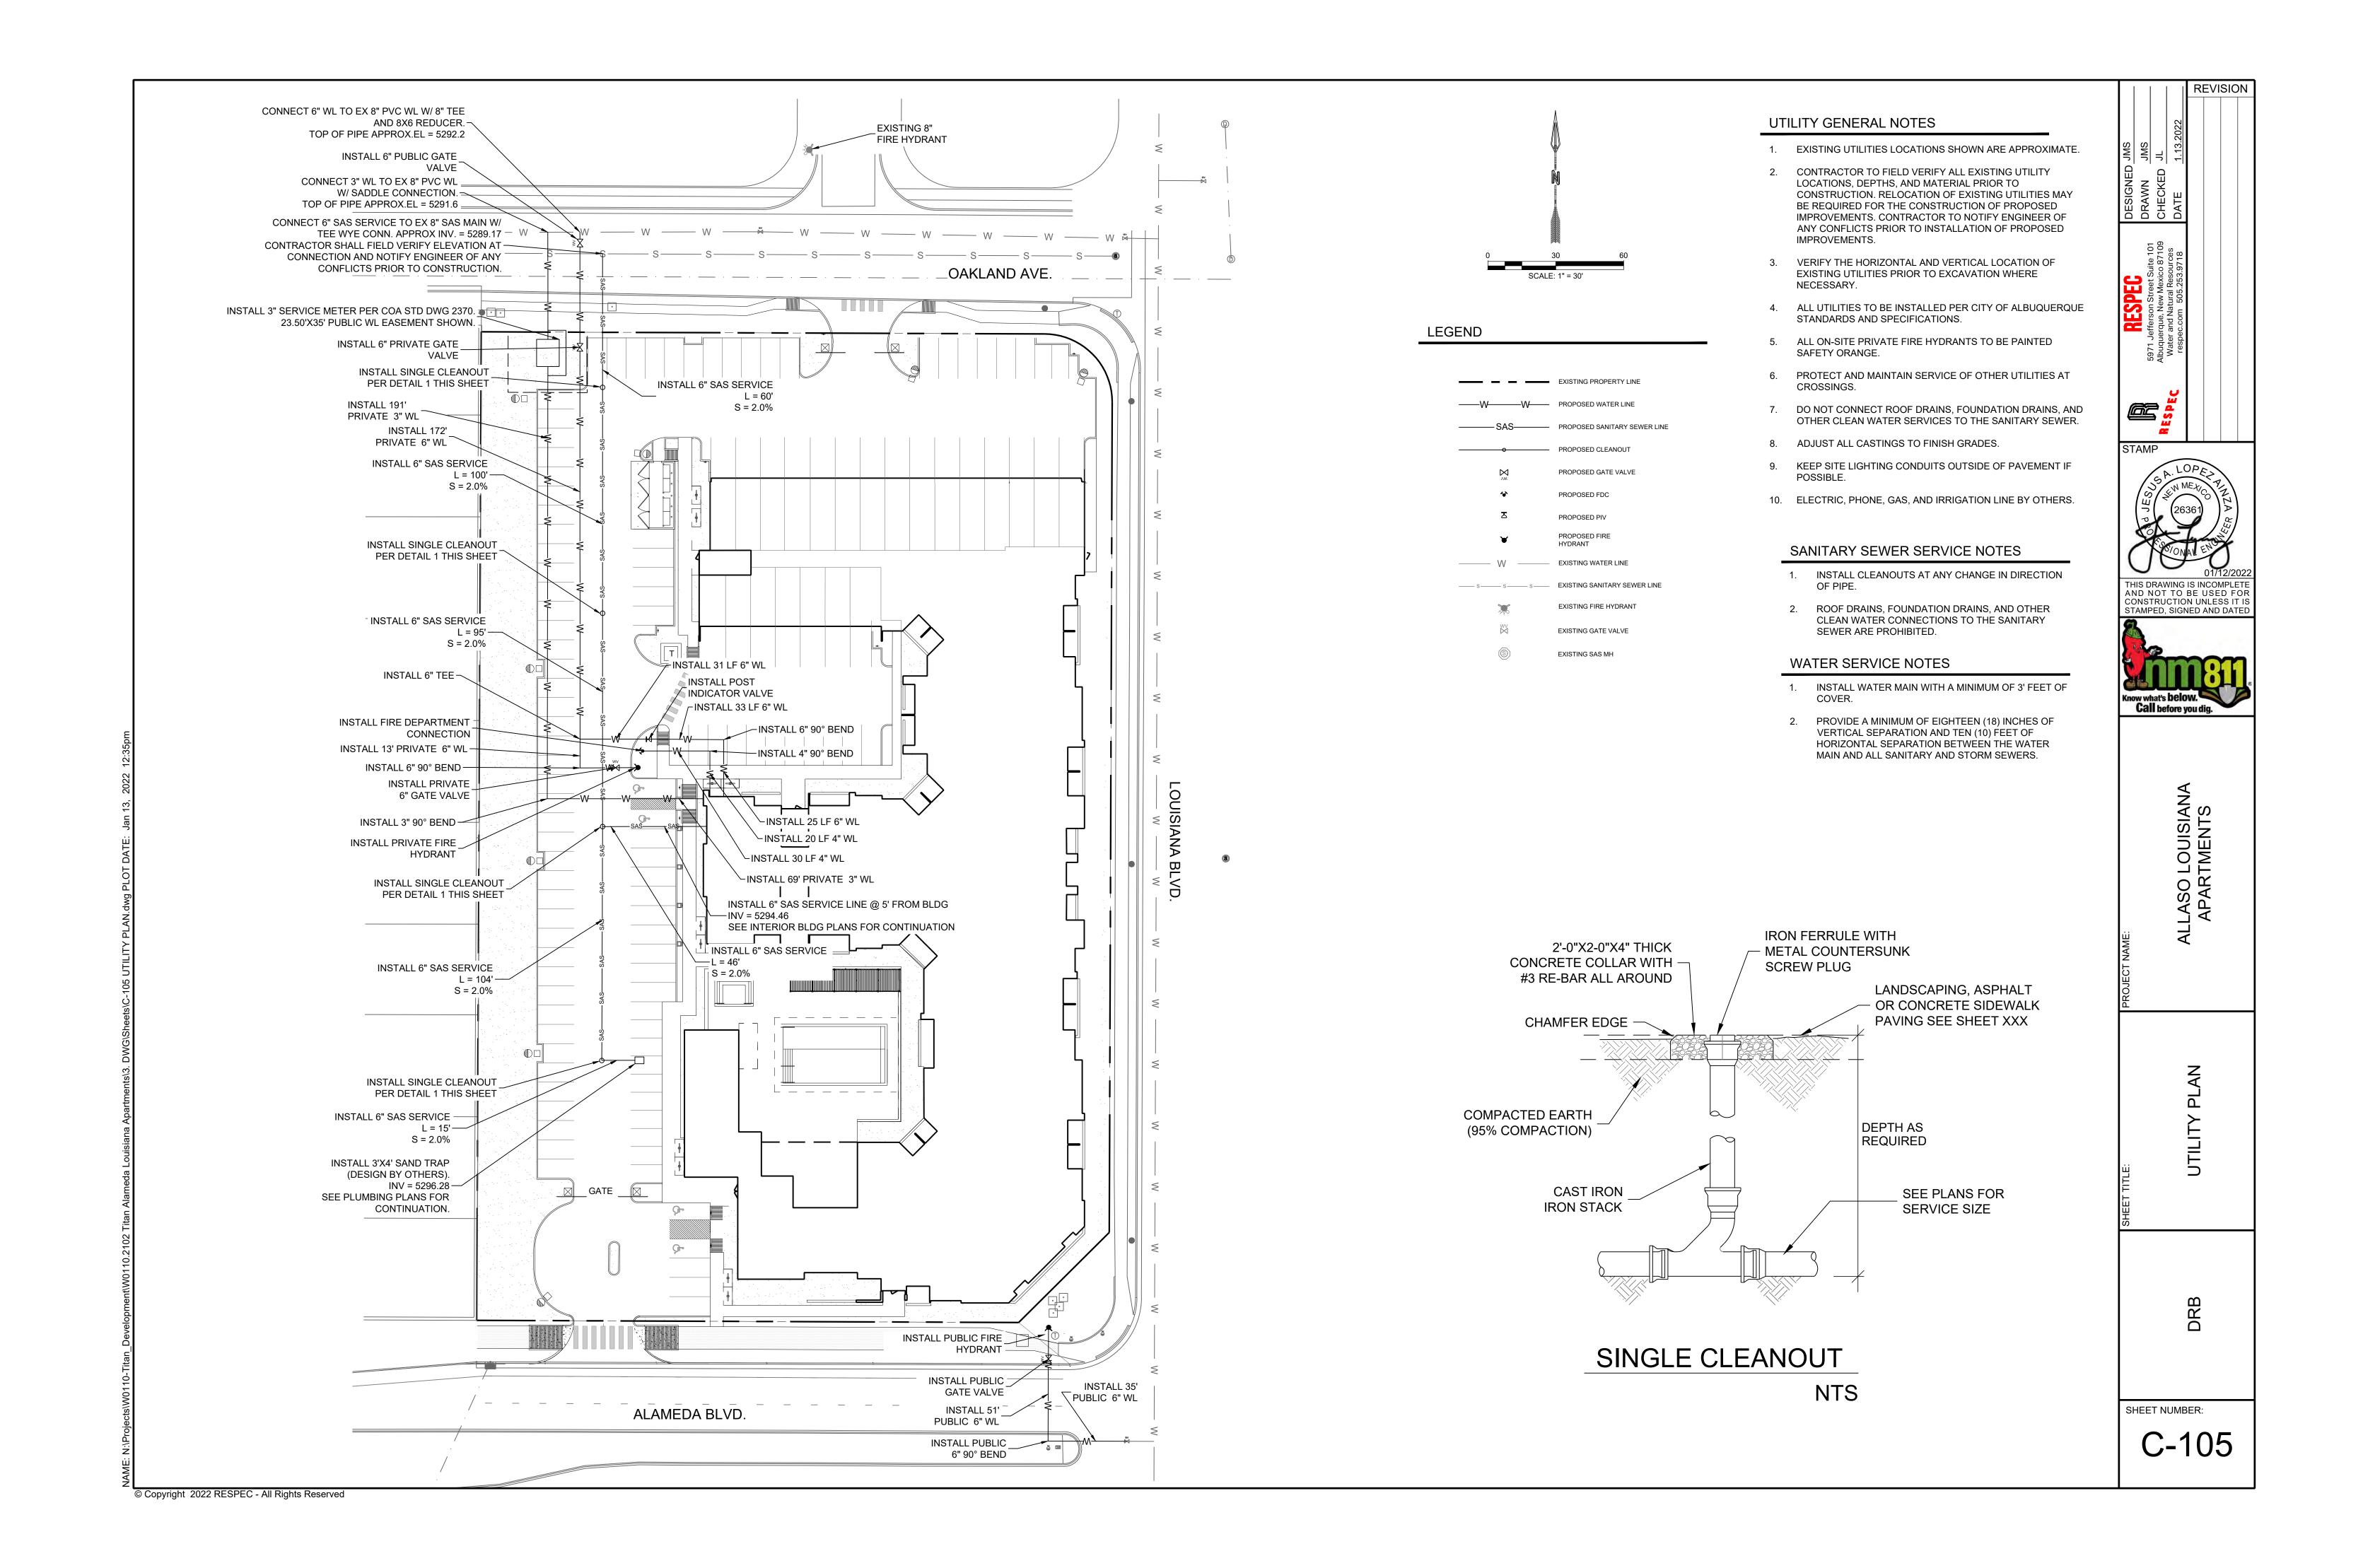




2'-0" 4'-0"

7'-0"

ELEVATION BEYOND



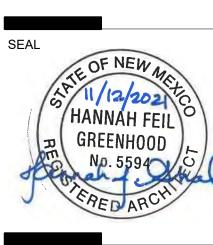

PROJECT

ALLASO LOUSIANA

NORTHWEST CORNER OF ALAMEDA

AND LOUISIANA

ALBUQUERQUE, NM

REVISIONS

T.O. PARAPET 1 136'-0"

ROOF BEARING 131'-4 1/2"

T.O. DECKING - LEVEL 3 121'-3 1/2"

T.O. DECKING - LEVEL 2 110'-7 3/4"

> LEVEL 1 100'-0"

DRAWN BY

VM, PMG, AG

REVIEWED BY

DM, HFG

DATE

11/12/2021

PROJECT NO:

DRAWING NAME

BUILDING ELEVATIONS

SDP5.1

4'-11"

7'-0"

**ELEVATION BEYOND-**

WEST ELEVATION



DOES NOT ACHIEVE >50%



NORTH ELEVATION -BUILDING A - MAY 21 9AM

3/64" = 1'-0" NO SOLAR EFFECT

**BUILDING A - MAY 21 9AM**3/64" = 1'-0"

EAST ELEVATION -



**EAST ELEVATION -**BUILDING A - MAY 21 12PM

NORTH ELEVATION -C4) BUILDING A - MAY 21 12PM

NO SOLAR EFFECT

ALLASO LOUISIA NORTHWEST CORNEF ALAMEDA AND LOUISI ALBUQUERQUE, NI

PROJECT

**REVISIONS** 

DRAWN BY

REVIEWED BY

PROJECT NO:

DRAWING NAME

SUN SHADE

**ANALYSIS** 

DEKKER

PERICH

SABATINI



EAST ELEVATION -B1 BUILDING A - MAY 21 4PM NO SOLAR EFFECT

ACHIEVES >50%

ACHIEVES >50%



NORTH ELEVATION -BUILDING A - MAY 21 4PM

3/64" = 1'-0" ACHIEVES >50%



EAST ELEVATION -BUILDING A - NOV 21 12PM



NO SOLAR EFFECT

**NORTH ELEVATION -**BUILDING A - NOV 21 12PM

SHEET NO **SDP5.2** 

11/12/2021

21-1013



DEKKER PERICH SABATINI

ALLASO LOUISIANA
NORTHWEST CORNER OF
ALAMEDA AND LOUISIANA
ALBUQUERQUE, NM


REVISIONS DRAWN BY REVIEWED BY 11/12/2021

DRAWING NAME

21-1013

SUN SHADE **ANALYSIS** 

SHEET NO SDP5.3

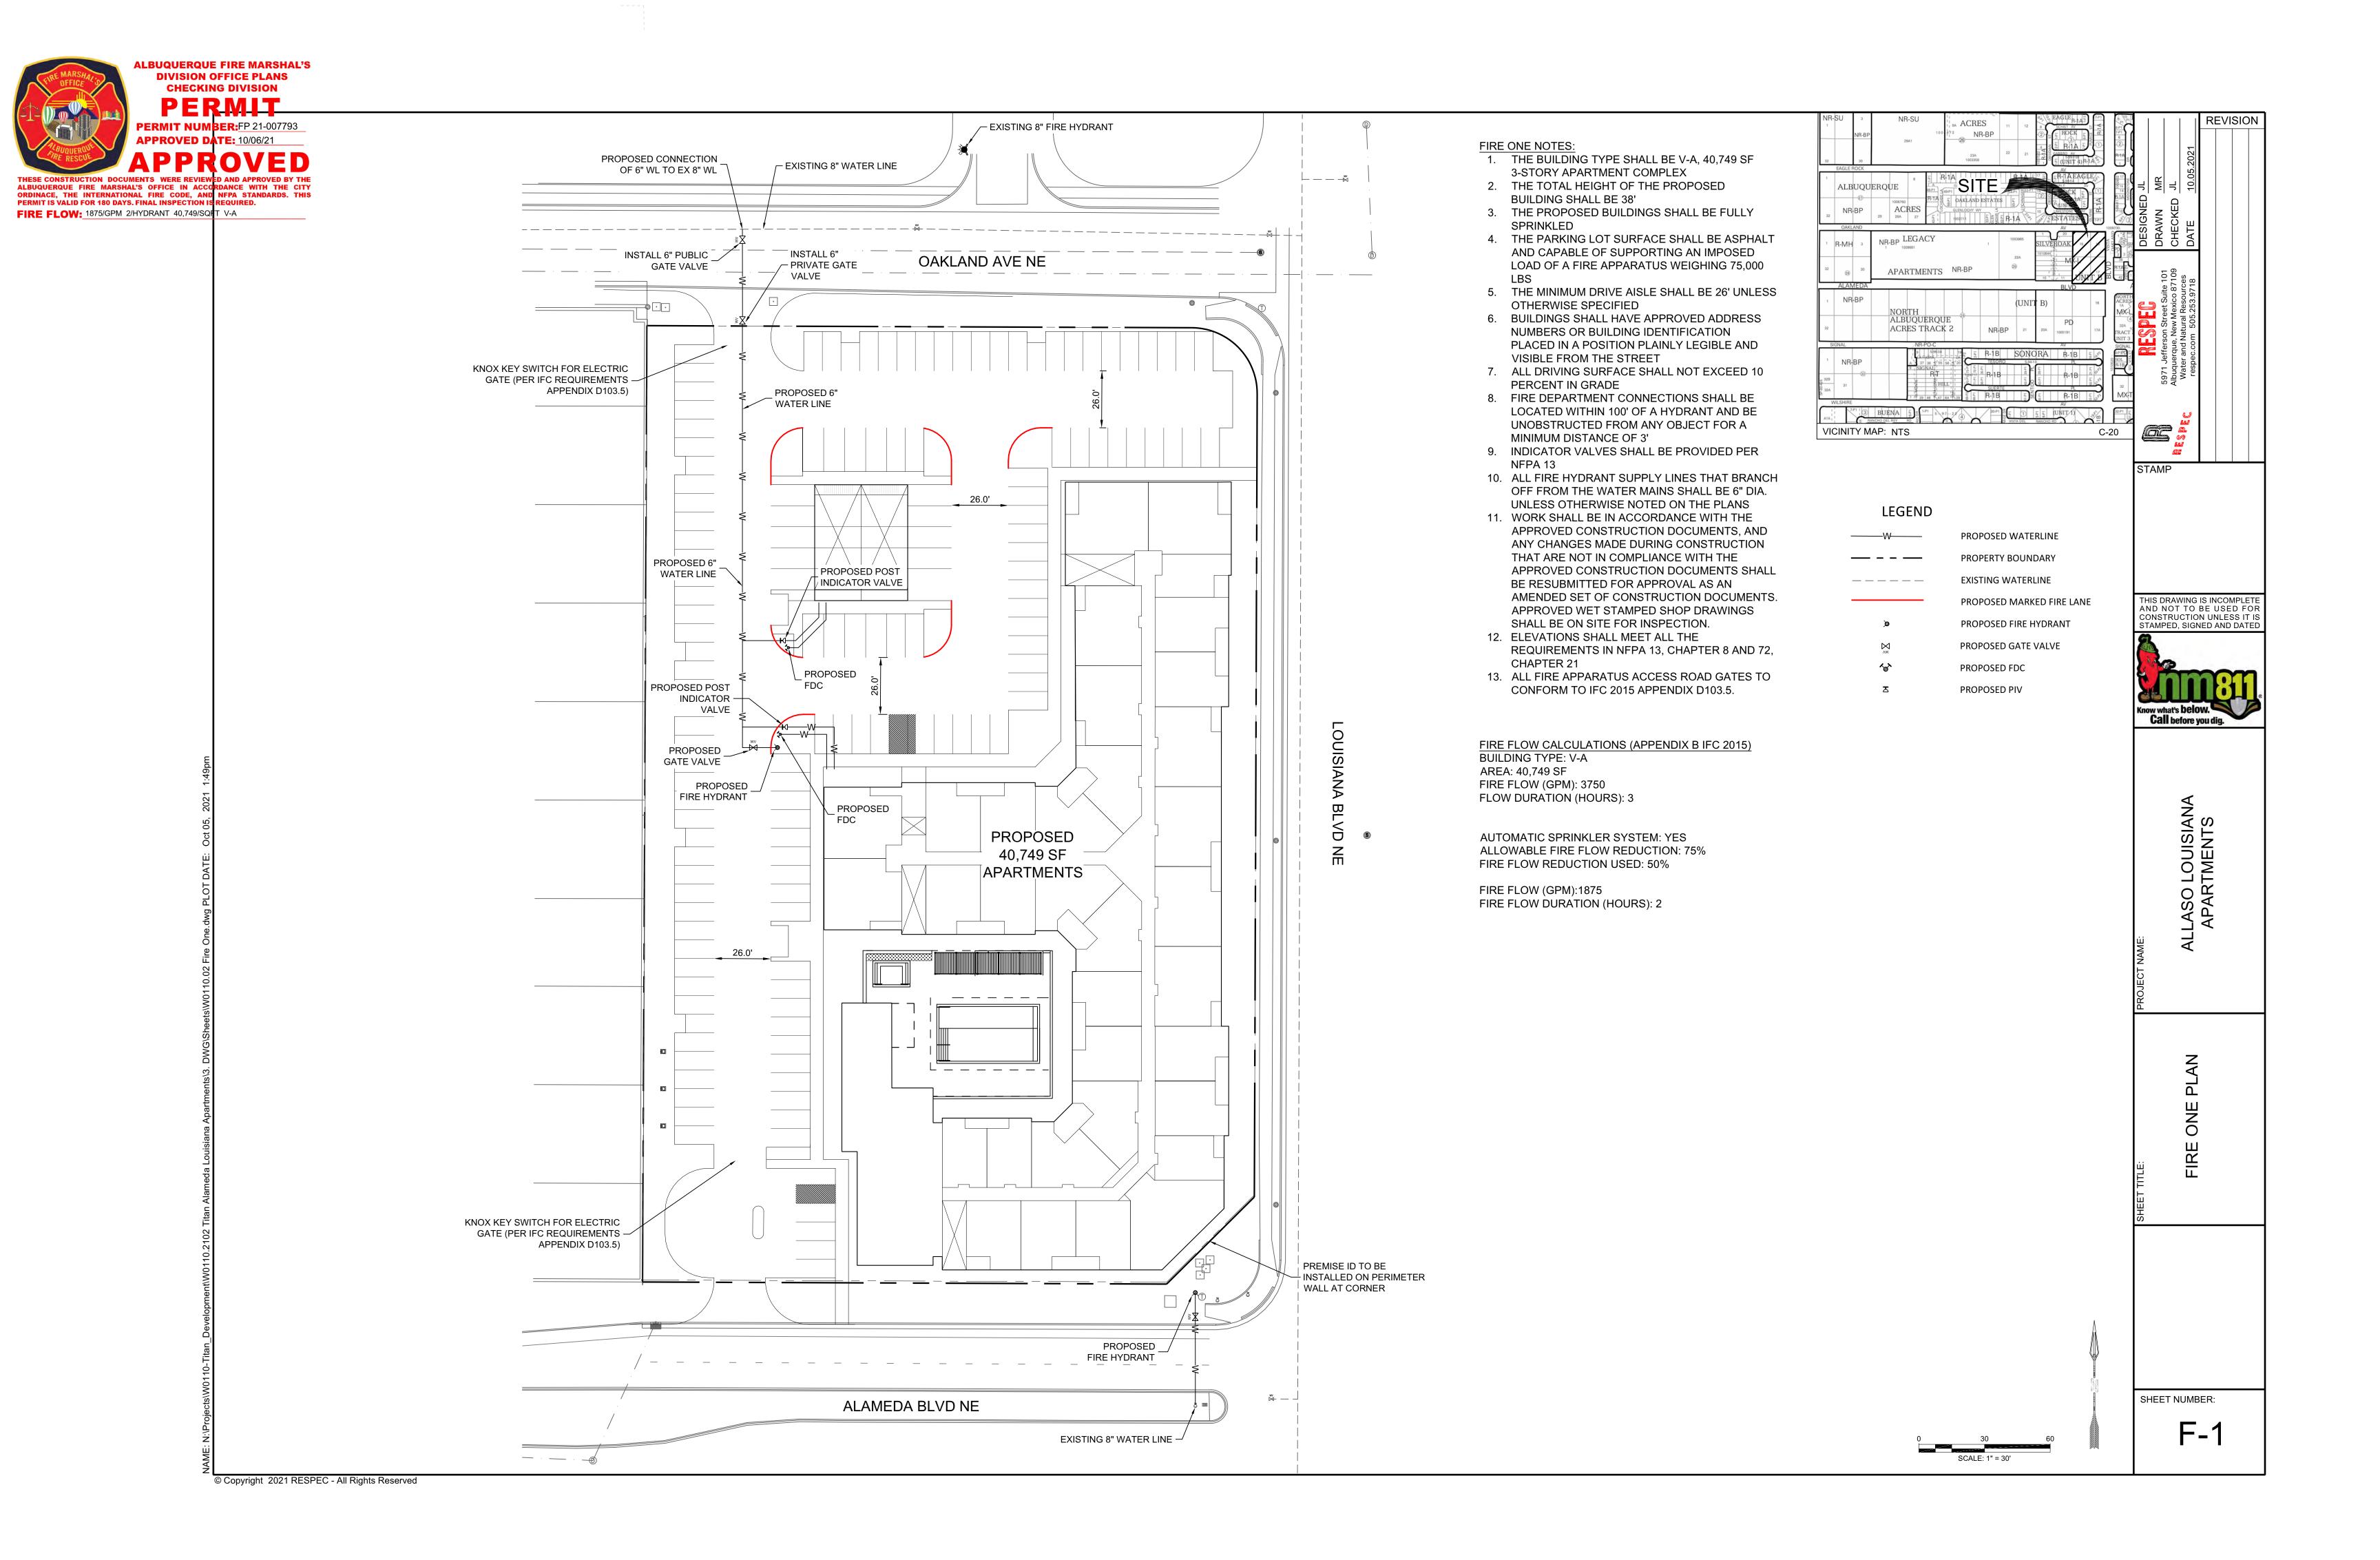

# PR-2021-006238\_SD-2021-01916\_Site\_Plan\_A pproved\_1-19-22

Final Audit Report 2023-04-07

Created: 2023-03-31

By: Jay Rodenbeck (jrodenbeck@cabq.gov)

Status: Signed

Transaction ID: CBJCHBCAABAAIIFqHFFYQmWOr4hseFNQUQjVhBvqkSjS

# "PR-2021-006238\_SD-2021-01916\_Site\_Plan\_Approved\_1-19-2 2" History

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