

DEVELOPMENT REVIEW BOARD SUPPLEMENTAL SUBMITTAL

(Deadline is Friday at noon unless noted on DRB calendar – late submittals will not be accepted unless approved by the DRB)

PROJECT NO. PR-2021-006238 Application No. SI-2021-01916

TO:

 $\underline{\times}$ Planning Department/Chair

 $\underline{\times}$ Hydrology

 $\underline{\times}$ Transportation Development

 \times ABCWUA

 \times Code Enforcement

 $\underline{\times}$ Parks & Rec

*(Please attach this sheet with each collated set for each board member)

NOTE: ELECTRONIC VERSION (ie disk, thumbdrive) is Required. Submittal will not be accepted without.

DRB SCHEDULED HEARING DATE: <u>January 12, 2022</u> HEARING DATE OF DEFERRAL: <u>December 8, 2021</u>

SUBMITTAL DESCRIPTION: Revised plan set, comment response memo, and proposed infrastructure list.

CONTACT NAME: Michael Vos, AICP

TELEPHONE: (505) 764-9801

EMAIL: vos@consensusplanning.com



Memorandum

To: Jolene Wolfley and DRB Members, City of Albuquerque

From: Michael Vos, AICP, Consensus Planning, Inc.

Date: January 7, 2022

Re: Allaso Louisiana Site Plan – DRB Comment Responses (PR-2021-006238)

This memo outlines the responses and changes made to the site plan for the Allaso Louisiana project based on the comments received and reviewed at the December 8, 2021 DRB meeting.

Code Enforcement

- 1. Development would need to meet all applicable standards and provisions of the IDO, the DPM, and any other adopted City regulations.
- 2. Project meeting neighborhood edge requirements including portions that are not required.
- 3. Multifamily is a permissive use. Please confirm all use specific standards are being met.
 - a. The project exceeds the use-specific standards for multi-family in the provision of additional landscaping (25% required) and trees located throughout the property for the number of dwelling units. A calculation has been added to the landscape plan clarifying that more than 50% of the trees are deciduous and capable of achieving a 25-foot mature canopy width.
- 4. Clarify buffering area provided on the West side of property separating area of change and consistency.
 - a. This buffer is dimensioned, as well as identified with Keynote #16 clearly showing the 25-foot width.
- 5. Is an alternative landscaping plan being submitted? Or clarify if all landscaping standards are being met. IDO section 5-6.
 - a. It is the intent of the plan to meet the landscaping requirements in IDO Section 5-6. Per Planning comments, we believe that the standards are met. An updated landscape plan is included in this submittal to make minor clarifications, as described above and in response to Parks and Recreation comments.
- Clarify how all design requirements of façade and building design are being met. IDO section 5-11.
 - a. See written description for this in response to Planning comments below.
- 7. Walls and fences must meet all requirements of 5-7-D.
 - a. The fences, as shown in the details meet the requirements for multi-family residential by utilizing view fencing above 3 feet and having a maximum height of 6 feet.
- 8. Is there a platting action already in process?
 - a. A plat has been submitted and will be heard concurrently with this request.
- 9. Is transit shelter and detail included in this proposed project?
 - a. A transit shelter is part of the proposed infrastructure list accompanying this request.

Transportation Development

- 1. For Alameda Boulevard, due to speed limit, the clear sight triangle should represent intersection sight distance. Reflect on landscape plan.
- 2. For the clear sight triangles shown on Oakland, project triangle all of the way to the curb line.
 - a. The clear sight triangles for both entrances have been updated on the Site Plan and Landscape Plan, as requested.
- 3. Typically, the City of Albuquerque would request a turn-around or a decel lane for Oakland in addition to the one shown on Alameda Boulevard if using as ingress. There is also no space for any type of a queue before the Oakland gate. If Oakland is wide enough for two-way traffic in addition to a queue, present dimensioning on the site plan.
 - a. Dimensioning has been added to the Site Plan showing adequate width for queueing and traffic.
- 4. Provide an infrastructure list for all improvements within the right-of-way, including the proposed asphalt trail and the transit shelter.
 - a. An infrastructure list has been prepared and is part of this supplemental submittal.
- 5. Label width of all on-site pedestrian ways. Use Keyed Note 3 where needed.
- 6. Label all curb radii in accordance with DPM requirements.
- 7. Dimension all parking spaces, and make sure dimensions are called out on all segments, including the width.
 - a. Additional dimensioning and labels have been added for these items.
- 8. If a parking space is compact, mark "Compact" in the back. If allowing for overhang as part of a standard parking space, label the overhang on the drawing. The maximum number of compact parking spaces in the IDO shall apply.
 - a. Compact spaces are marked with a "C" and the full wording required has been called out in the Site Plan legend and corresponding keynote.
- 9. Given the number of bicycle spaces actually required, indicate on the site plan where these will all be accounted for in addition to the one small area shown by Keyed Note 4 at the far north side of the site.

a. The project data has been updated with the correct bicycle parking calculation and keynotes have been added calling out all bicycle parking locations.

- 10. Label a 5-foot parking lot keyway at the end of the parking lot for both locations where applicable.
- 11. The parking lot in the middle of the site plan should show a crosswalk to complete the ADA pathway. The curb ramp on the far north side does not lead to any continuous pathway to the north and appears to not be needed since the ADA connection to the right-of-way is to the south.

a. Keyways are dimensioned and a crosswalk has been added to complete the ADA pathway across the middle parking area.

- 12. Where are motorcycle spaces shown? Also, provide motorcycle sign parking detail along with "MC" at the back of the parking space.
 - a. MC spaces are identified, and the calculation has been updated with an additional space as required by the IDO. Sign detail is part of the details sheet SDP1.2.
- 13. Call out all public sidewalk widths and landscape buffer widths on site plan. All new public roadway infrastructure shall be placed onto an infrastructure list.
 - a. Sidewalk widths are dimensioned and have been placed on the infrastructure list.

<u>ABCWUA</u>

- 1. Availability Statement #211013 has been executed and sets the criteria for service. Routine connections are available.
- 2. This project is within the adopted service area.
- 3. Pro Rata:
 - a. Pro rata is owed for this property in the following amounts:
 - i. Water = \$1,293.30 + \$2,314.66 + \$1,893.72 = \$5,501.68
 - ii. Sewer = \$1,526.85
 - iii. Total = \$7,028.53
 - b. Payment of pro rata is a requirement prior to approval.
 - a. The Applicant will pay the pro rata prior to final sign-off and expects this to be a condition of approval and delegation.
- 4. Utility Plan:
 - a. Please explain the proposed sand trap.
 - b. There shall be no trees, parallel fences/sidewalks/curbs, or structures within the public water and public sewer easement. Please revise landscape plan in the area of the water meter vault.
 - a. The landscape plan has been updated to remove landscaping from around the meter vault location.
- 5. Infrastructure List:
 - a. No public water or sewer main extensions are required for this project.

<u>Planning</u>

- The application submittal notes that Titan Development has had seven meetings with the surrounding neighborhoods, but the notes from only one meeting are included in the application submittal. It would be helpful if the meeting notes or a summary from the other six meetings could be obtained in a supplemental submittal.
 - a. A summary of the meetings held between Titan Development and various neighbors are summarized below:
 - Quail Springs 8/23/21 Gave zoning overview to the President and other members of the Neighborhood Association. Minutes were not taken down.
 - Nor Este NA- 8/24/21 Gave zoning overview to the Neighborhood Association. Minutes were not taken down.
 - Silver Oaks 9/8/21 Introduced the zoning to 4 members of the Neighborhood Association. Minutes were not taken down.
 - Nor Este 10/5/21 Introduced the site plan and received feedback. Minutes were not taken down.
 - Silver Oaks 10/6/21 12 members from the HOA attended. Mark Nueber, Phillip & Britney Lopez, Brian Fisher, and many others were in attendance, Introduced the site plan and received feedback. Minutes were not taken down.
 - Pre-App Facilitated 10/12/21 Made tweaks to the site plan based on feedback from the previous meetings to address the comments/concerns/feedback. Minutes are in the record from the facilitator
 - Nor Este 2 11/3/21 Followed up with Nor Este to address the 25' landscape setback requirement and presented the final site plan. General consensus to support the

project from Nor Este. This was Nor Este's annual meeting and they may have meeting minutes.

- Romero family from Silver Oaks NA 11/8/21 William Consuegra, Romero Family. Romero Family (Michael and Alice) and William Consuegra had the biggest concerns about the project, and we met with them individually to address their concerns including improving the landscaping, reducing building height in strategic locations, and talking through the project.
- Silver Oaks NA 11/11/21 Lastly, followed up with Silver Oaks one more time to go over the site plan. Mark Nueber (Silver Oaks HOA president) and William Consuegra were in attendance with a few others.
- 2. The street frontage landscaping, edge buffer landscaping, and parking lot landscaping requirements are being met on the Site Plan per 5-6 of the IDO.

a. Understood.

- 3. 4-3(B)(7)(c) of the IDO pertaining to landscaping requirements including for the use-specific standards of 4-3(B)(7) for multi-family dwellings requires at least 50 percent of the trees be deciduous canopy-style shade trees or coniferous trees capable of attaining a mature canopy diameter of at 25 feet. Confirmation needs to be provided if the shade trees on the Landscape Plan are capable of attaining a mature canopy diameter of at 25 feet.
 - a. This calculation has been added to the updated landscape plan. 34 are required to be deciduous of this size, and 35 are provided.
- 4. Please note that the 2020 IDO Update gave greater allowances for cool and warm seasons grasses for multi-family projects. Please see IDO Section 4-3(B)7 to see if there are allowances that would benefit your landscape plan.
- 5. Please provide a legible Landscape Plan ASAP. The Landscape Plan is difficult to discern details on unless the scale is close to 100% scale. It appears to staff to be depicted for a full-size physical plot sheet, and we need to be able to analyze it digitally at multiple scales effectively.
- 6. On Form P2 in the application submittal, an Infrastructure List is checked as included in the application submittal, but is not included in the application submittal. Confirm if there's an Infrastructure List with the application.

a. An infrastructure list has been prepared and is attached to this supplemental submittal.

7. The project and application numbers need to be added to the Site Plan prior to distribution of the Site Plan to the DRB members for their e-signatures.

a. These have been added to the plan.

- 8. The Solid Waste signature must be obtained on the Site Plan prior to final sign-off by Planning.
 - a. The updated plan is being routed to Solid Waste.
- 9. All Site Plan sheets need to be sealed and signed by a design professional (surveyor, engineer, architect, landscape architect) licensed in the State of New Mexico.
 - a. All drawings except the civil drawings have been stamped and signed. The Engineer will stamp and sign these plan sheets once Hydrology has completed their review and prior to final sign-off by the Board members.
- 10. The building facades must meet 5-11(D) of the IDO. Provide a comment response letter explaining how the requirements of 5-11(D) are being met.
 - a. A note has been added to the elevations demonstrating compliance with the glazing requirements for the street-facing facades. IDO Section 5-11(D) Multi-family Residential Development is met in the following ways:

 Building entrances are emphasized by contemporary architectural overhangs.
 The facade design incorporates elements of human scale by incorporating windows that make up 20% of the ground floor of street-facing facades (see calculations on south and east elevations) and are recessed 2 inches on upper floors. Windows facing west have been reduced in size to reduce heat impact or are shaded by balcony structure above or incorporate sunshade devices where needed.
 Facade articulation is achieved in combination of recesses and projections every 30 feet minimum (see dimensions on elevations for plane changes), more than one finish material or color is used on every facade (refer to exterior finish legend indicating up to 6 color and material selections), and balconies are incorporated at every dwelling unit for visual interest.

3. Facade length exceeds 60 feet; therefore, roofline extends from 36'-0" to 38'-0" at intervals less than 60 feet continuously.

4. 5-11(D)4 is not applicable.

- 11. There is no sun/shade analysis for this submittal. Please provide as part of your plan sheets. See the detail on Page 3 of the Climatic and Geographic Building design requirements.
 - a. The sun/shade analysis has been resubmitted as the last few sheets of the plan set.
- 12. These are preliminary Planning comments, and there could be additional and/or revised Planning comments on this application.

Parks and Recreation

- 13. Alameda Blvd NE has a proposed multi-purpose trail and is provided on the plan. Will there be an infrastructure list?
 - a. An infrastructure list has been prepared and includes the multi-purpose trail along Alameda Boulevard.
- 14. Alameda Blvd NE is a Regional Principal Arterial and Louisiana Blvd NE is a Major Collector, requiring street trees. The Parks and Recreation Department (PRD) is a partner with the Nature Conservancy who developed a Climate Ready Tree List for Albuquerque. PRD encourages developers to use this list for street trees (see insert below). Ash is not considered Climate Ready.

Lists linked here:

Trees must be recommended on the Official Albuquerque Plant Palette: <u>Official Albuquerque</u> <u>Plant Palette and Sizing List-2018-07-03.xlsx (cabq.gov)</u>

Please reference the CLIMATE-READY TREES FOR ALBUQUERQUE: <u>NMFO Climate-Ready Trees</u> Lists (nature.org)

a. The landscape plan has been updated to replace the Ash trees with different species.





OWNER

TITAN DEVELOPMENT 6300 RIVERSIDE DEVELOPMENT, SUITE 200 ALBUQUERQUE, NM 87102 PHONE: 505.998.0163

DRAWING INDEX

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ALLASO LOUISIANA

ARCHITECT

DEKKER/PERICH/SABATINI, LTD. 7601 JEFFERSON ST. NE, SUITE 100 ALBUQUERQUE, NM 87109 PHONE: 505.761.9700


LANDSCAPE ARCHITECT

YELLOWSTONE LANDSCAPE 7525 2ND ST NW ALBUQUERQUE, NM 87107 PHONE: 505.898.9615


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CIVIL ENGINEER

RESPEC 5971 JEFFERSON ST NE ALBUQUERQUE, NM 87109 505.251.0815

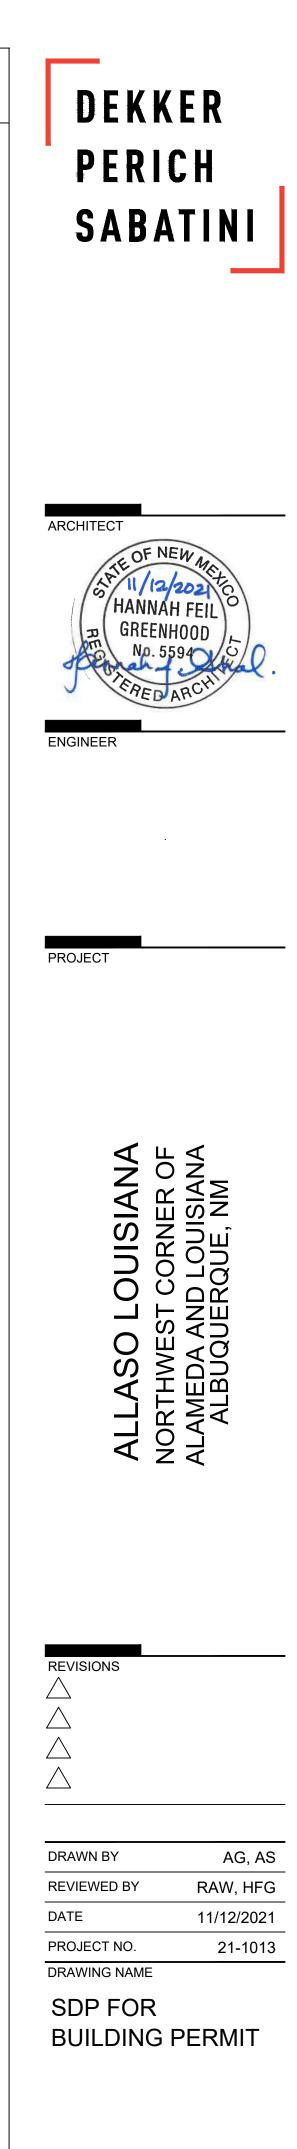

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5. 6.	
0.	REQUIRED OFF-STREET PARKING WITH TWO-POINT BIKE L B5/SDP1.2
7. 8.	GARAGE PARKING BUILDING OVERHANG ABOVE
9.	BUILDING PATIO WALL
11.	
12. 13.	EXISTING FIRE HYDRANT, SEE CIVIL
14. 15.	
16. 17.	25' LANDSCAPE BUFFER ILLUMINATED MONUMENT SIGN, REF: A3/SDP1.3
18. 19.	KNOX BOX AND USPS KEY REQUIRED AT GATE ACCESS
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20.	NOT BE ACCEPTABLE IN THE CLEAR SIGHT TRIANGLE
21.	PARALLEL CURB RAMP PER C.O.A. DETAIL 2443.
22. 23.	POOL
24. 25.	SPA
26.	PROVIDE/INSTALL NEW TRANSIT SHELTER PER CITY STAN COORDINATE EXACT LOCATION WITH TRANSIT AUTHORITY
27.	
28.	
29.	VEHICULAR GATE, 6'-0" HIGH, PROVIDE KNOX KEY PER FIR REUIREMENTS, REF: A5/SDP1.3
30. 31.	,
32. 33.	6' TALL ORNAMENTAL FENCE, REF: C4/SDP1.3 10' WIDE ASPHALT TRAIL
34.	
35.	INDICATED, SEE B1/SDP1.2.
36.	
38.	EXISTING CENTURYLINK PEDESTAL COMPACT PARKING, SIZE REQUIREMENTS PER DPM, WITH
	LABELED AT THE BACK OF THE SPACE.
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	NITIES ON-SITE WILL INCLUDE A SWIMMING POOL, HOT TUB BHOUSE, COVERED POOLSIDE GATHERING SPACE, AND CAE
	L AND HOT TUB TO BE PERMITTED BY OTHERS. WALLS TO BE PERMITED SEPERATELY
	DJECT NUMBER: PR-2021- 006238
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Арр	lication Number: <u>SI-2021- 01916</u>
	n Infrastructure List required? () Yes () No If yes,
	roved DRC plans with a work order is required for a in Public Right-of-Wayor for construction of public
DRE	<u>3 SITE DEVELOPMENT PLAN APPROVAL:</u>
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M STANDARDS, 10% OF KE LOCKING, SEE	 E. CURBS AND ACCESSIBLE RAMPS WILL BE DESIGNED AND BUILT ACCORDING TO THE CITY OF ALBUQUERQUE STANDARDS. F. LIGHT FIXTURES AND DESIGN SHALL COMPLY WITH THE CITY OF ALBUQUERQUE INTEGRATED DEVELOPMENT ORDINANCE (IDO): SECTION 14-16-5-8 OUTDOOR 	
E, REF: B1/SDP1.2	 LIGHTING. G. STREETS, PARKING SPACES AND ASSOCIATED DRIVES TO BE ASPHALT UNLESS NOTED OTHERWISE. H. LANDSCAPE AND SIGNAGE WILL NOT INTERFERE WITH CLEAR SIGHT REQUIREMENTS. SIGNS, WALLS AND PLANTING BETWEEN 3 FEET AND 8 FEET TALL (AS MEASURED FROM THE GUTTER PAN) WILL NOT BE PERMITTED IN THE CLEAR SIGHT TRIANGLE. I. ALL PUBLIC INFRASTRUCTURE LOCATED WITHIN CITY RIGHT-OF-WAY SHALL BE INCLUDED IN A PUBLIC WORK ORDER. 	
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Date	B4 2 BEDROOM / 2 BATHROOM 1,049 SF 2 2,098 SF B5 2 BEDROOM / 2 BATHROOM 1,040 SF 3 3,120 SF TOTAL: 105 UNITS	
Date	OPEN SPACE CALCULATIONS	
Date	USABLE OPEN SPACE 1 BD: 225 SF PER UNIT 225 SF x 72 UNITS = 16,200 SF 2 BD: 285 SF PER UNIT 285 SF x 33 UNITS = 9,405 SF TOTAL = 25,605 SF	
Date	REQUIRED OPEN SPACE: $= 25,605 \text{ SF}$ PROVIDED OPEN SPACE: $= 29,886 \text{ SF}$ LEVEL 1 $= 29,886 \text{ SF}$ LEVEL 2 $= 2,630 \text{ SF}$ TOTAL $= 32,516 \text{ SF}$	REV
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	 6" BOLLARD WITH SIGN, REF: B1/SDP1.2 6' WIDE PAINTED CROSSWALK, SEE B2/SDP1.2 	SHEE

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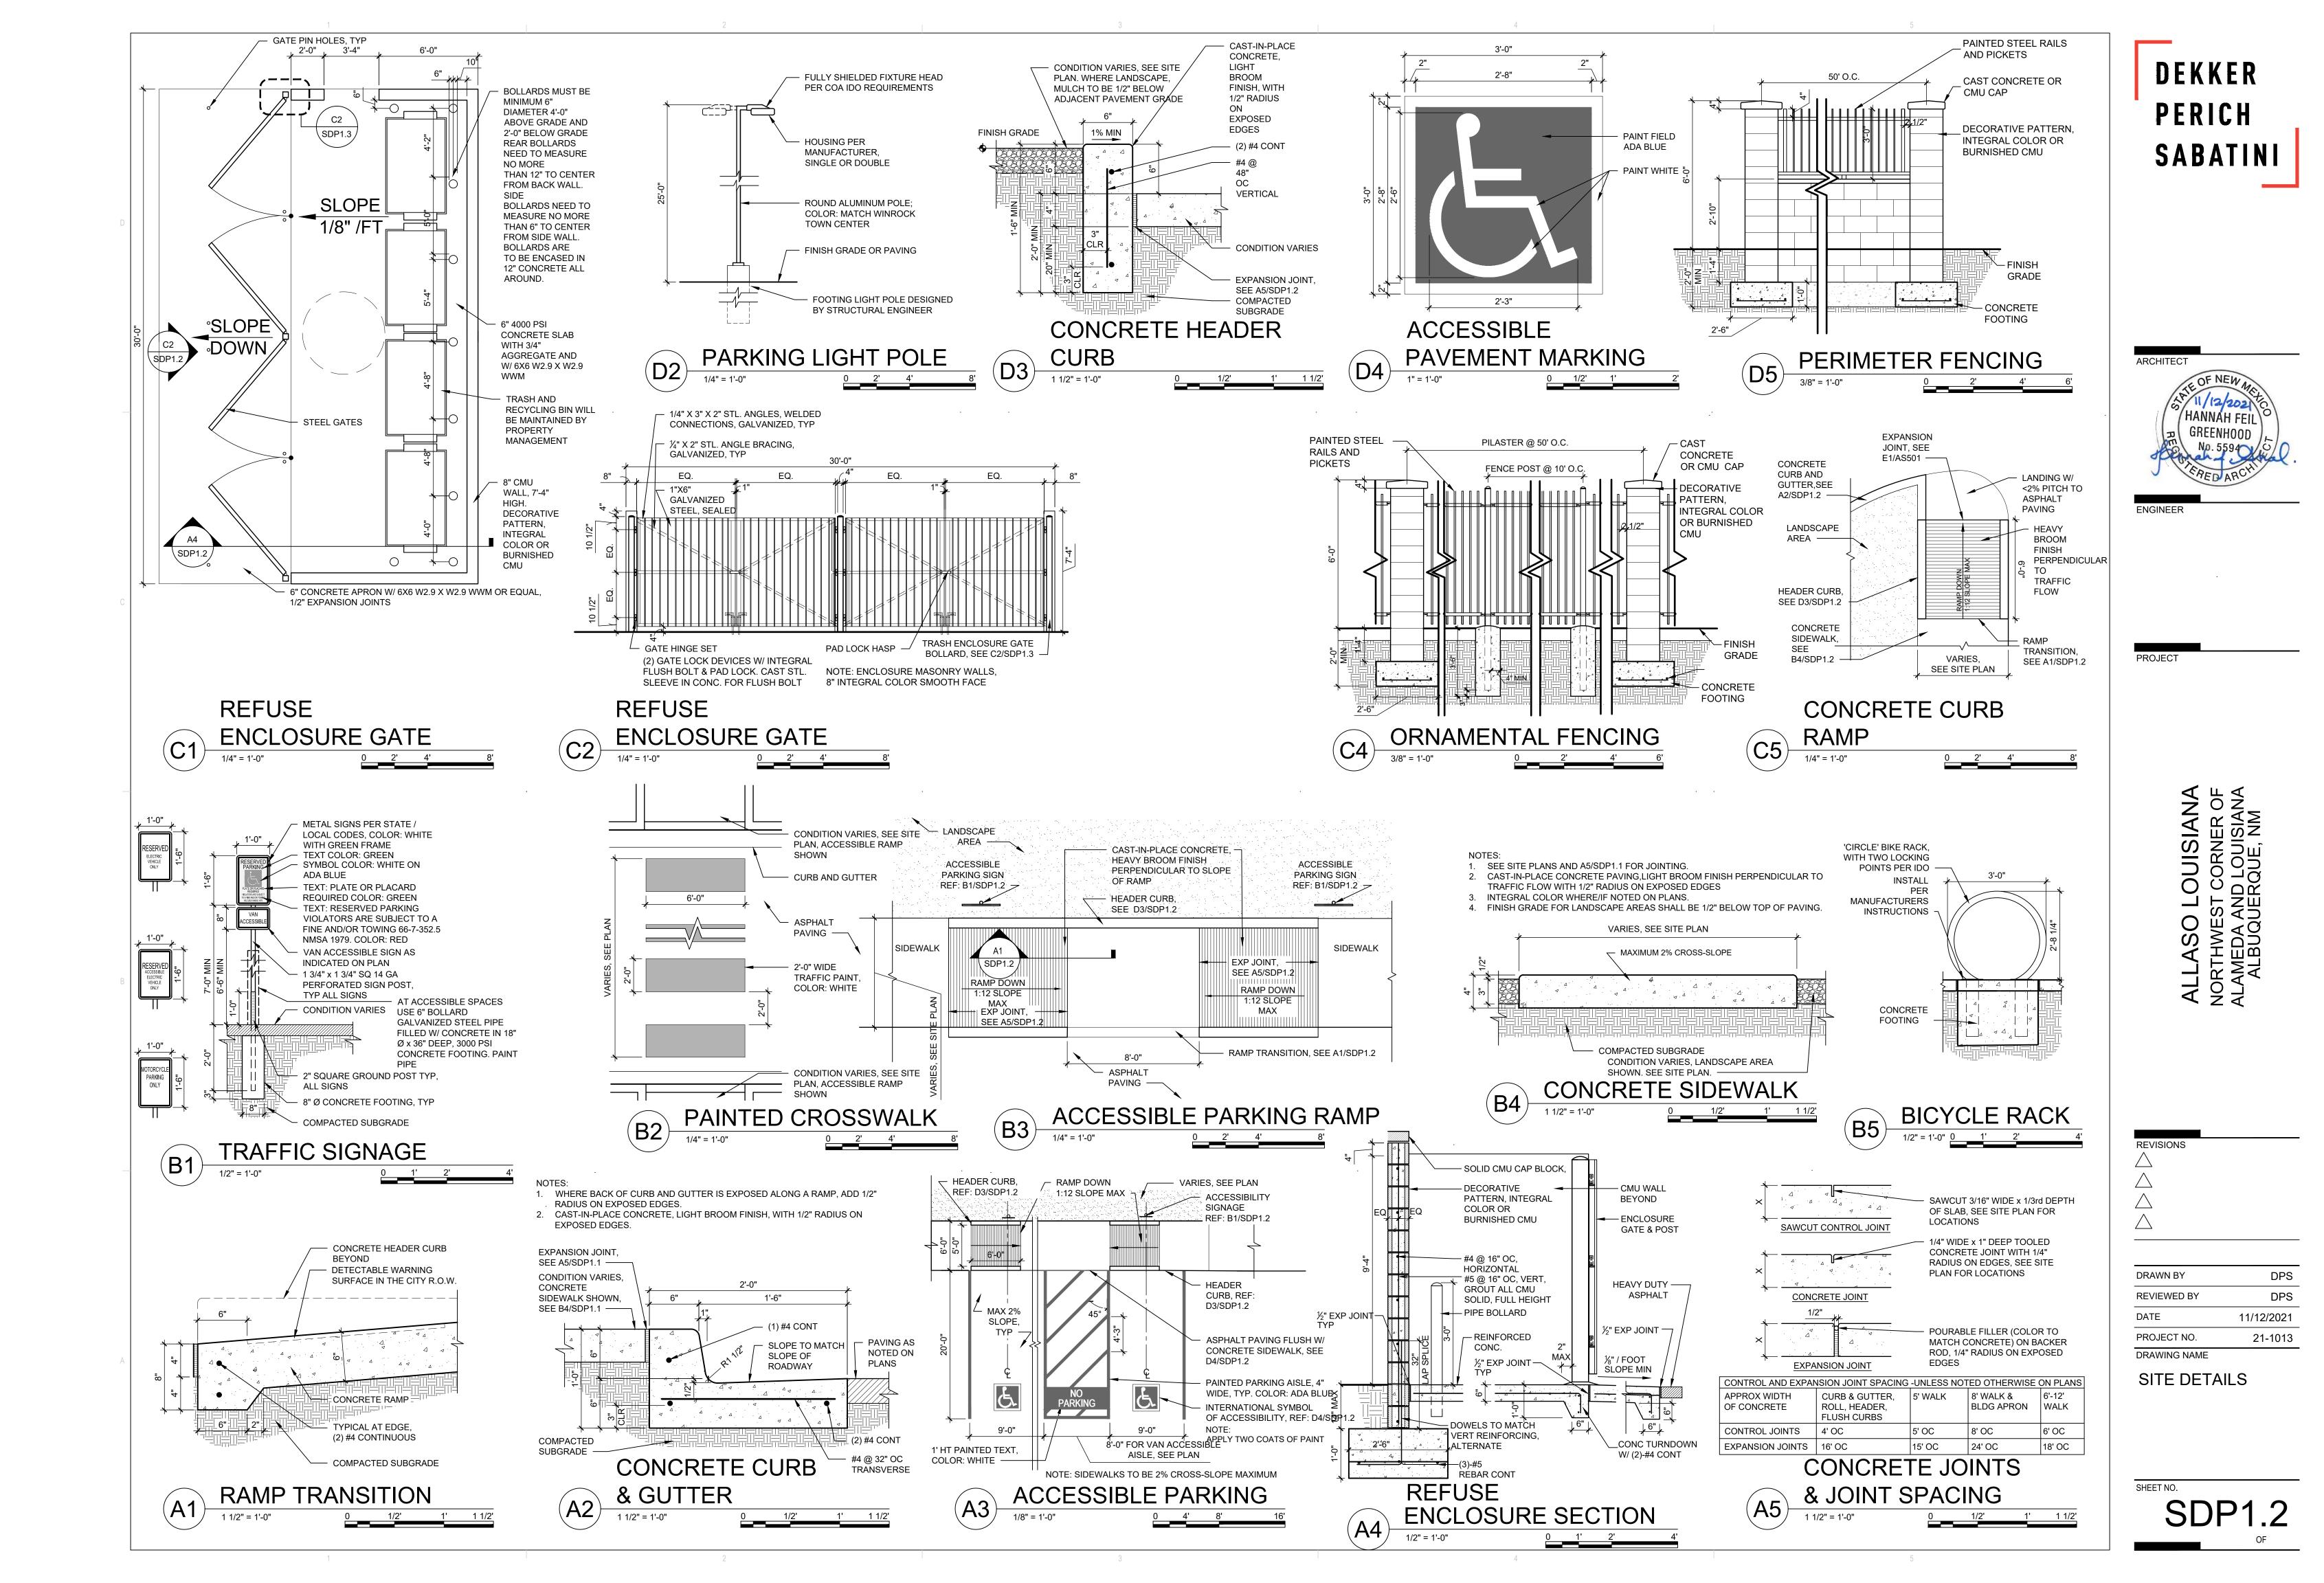
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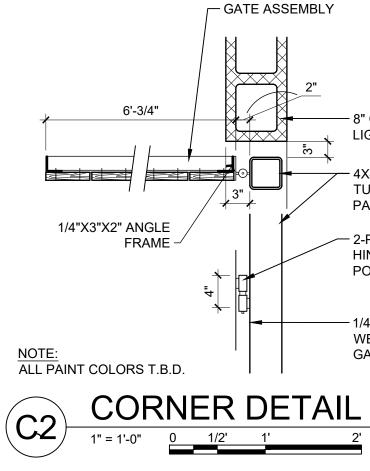
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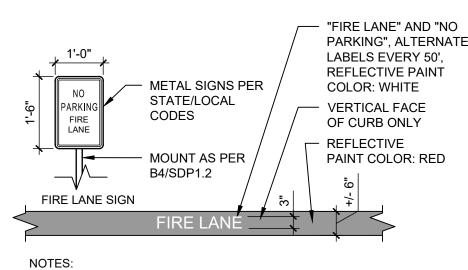
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PLAN

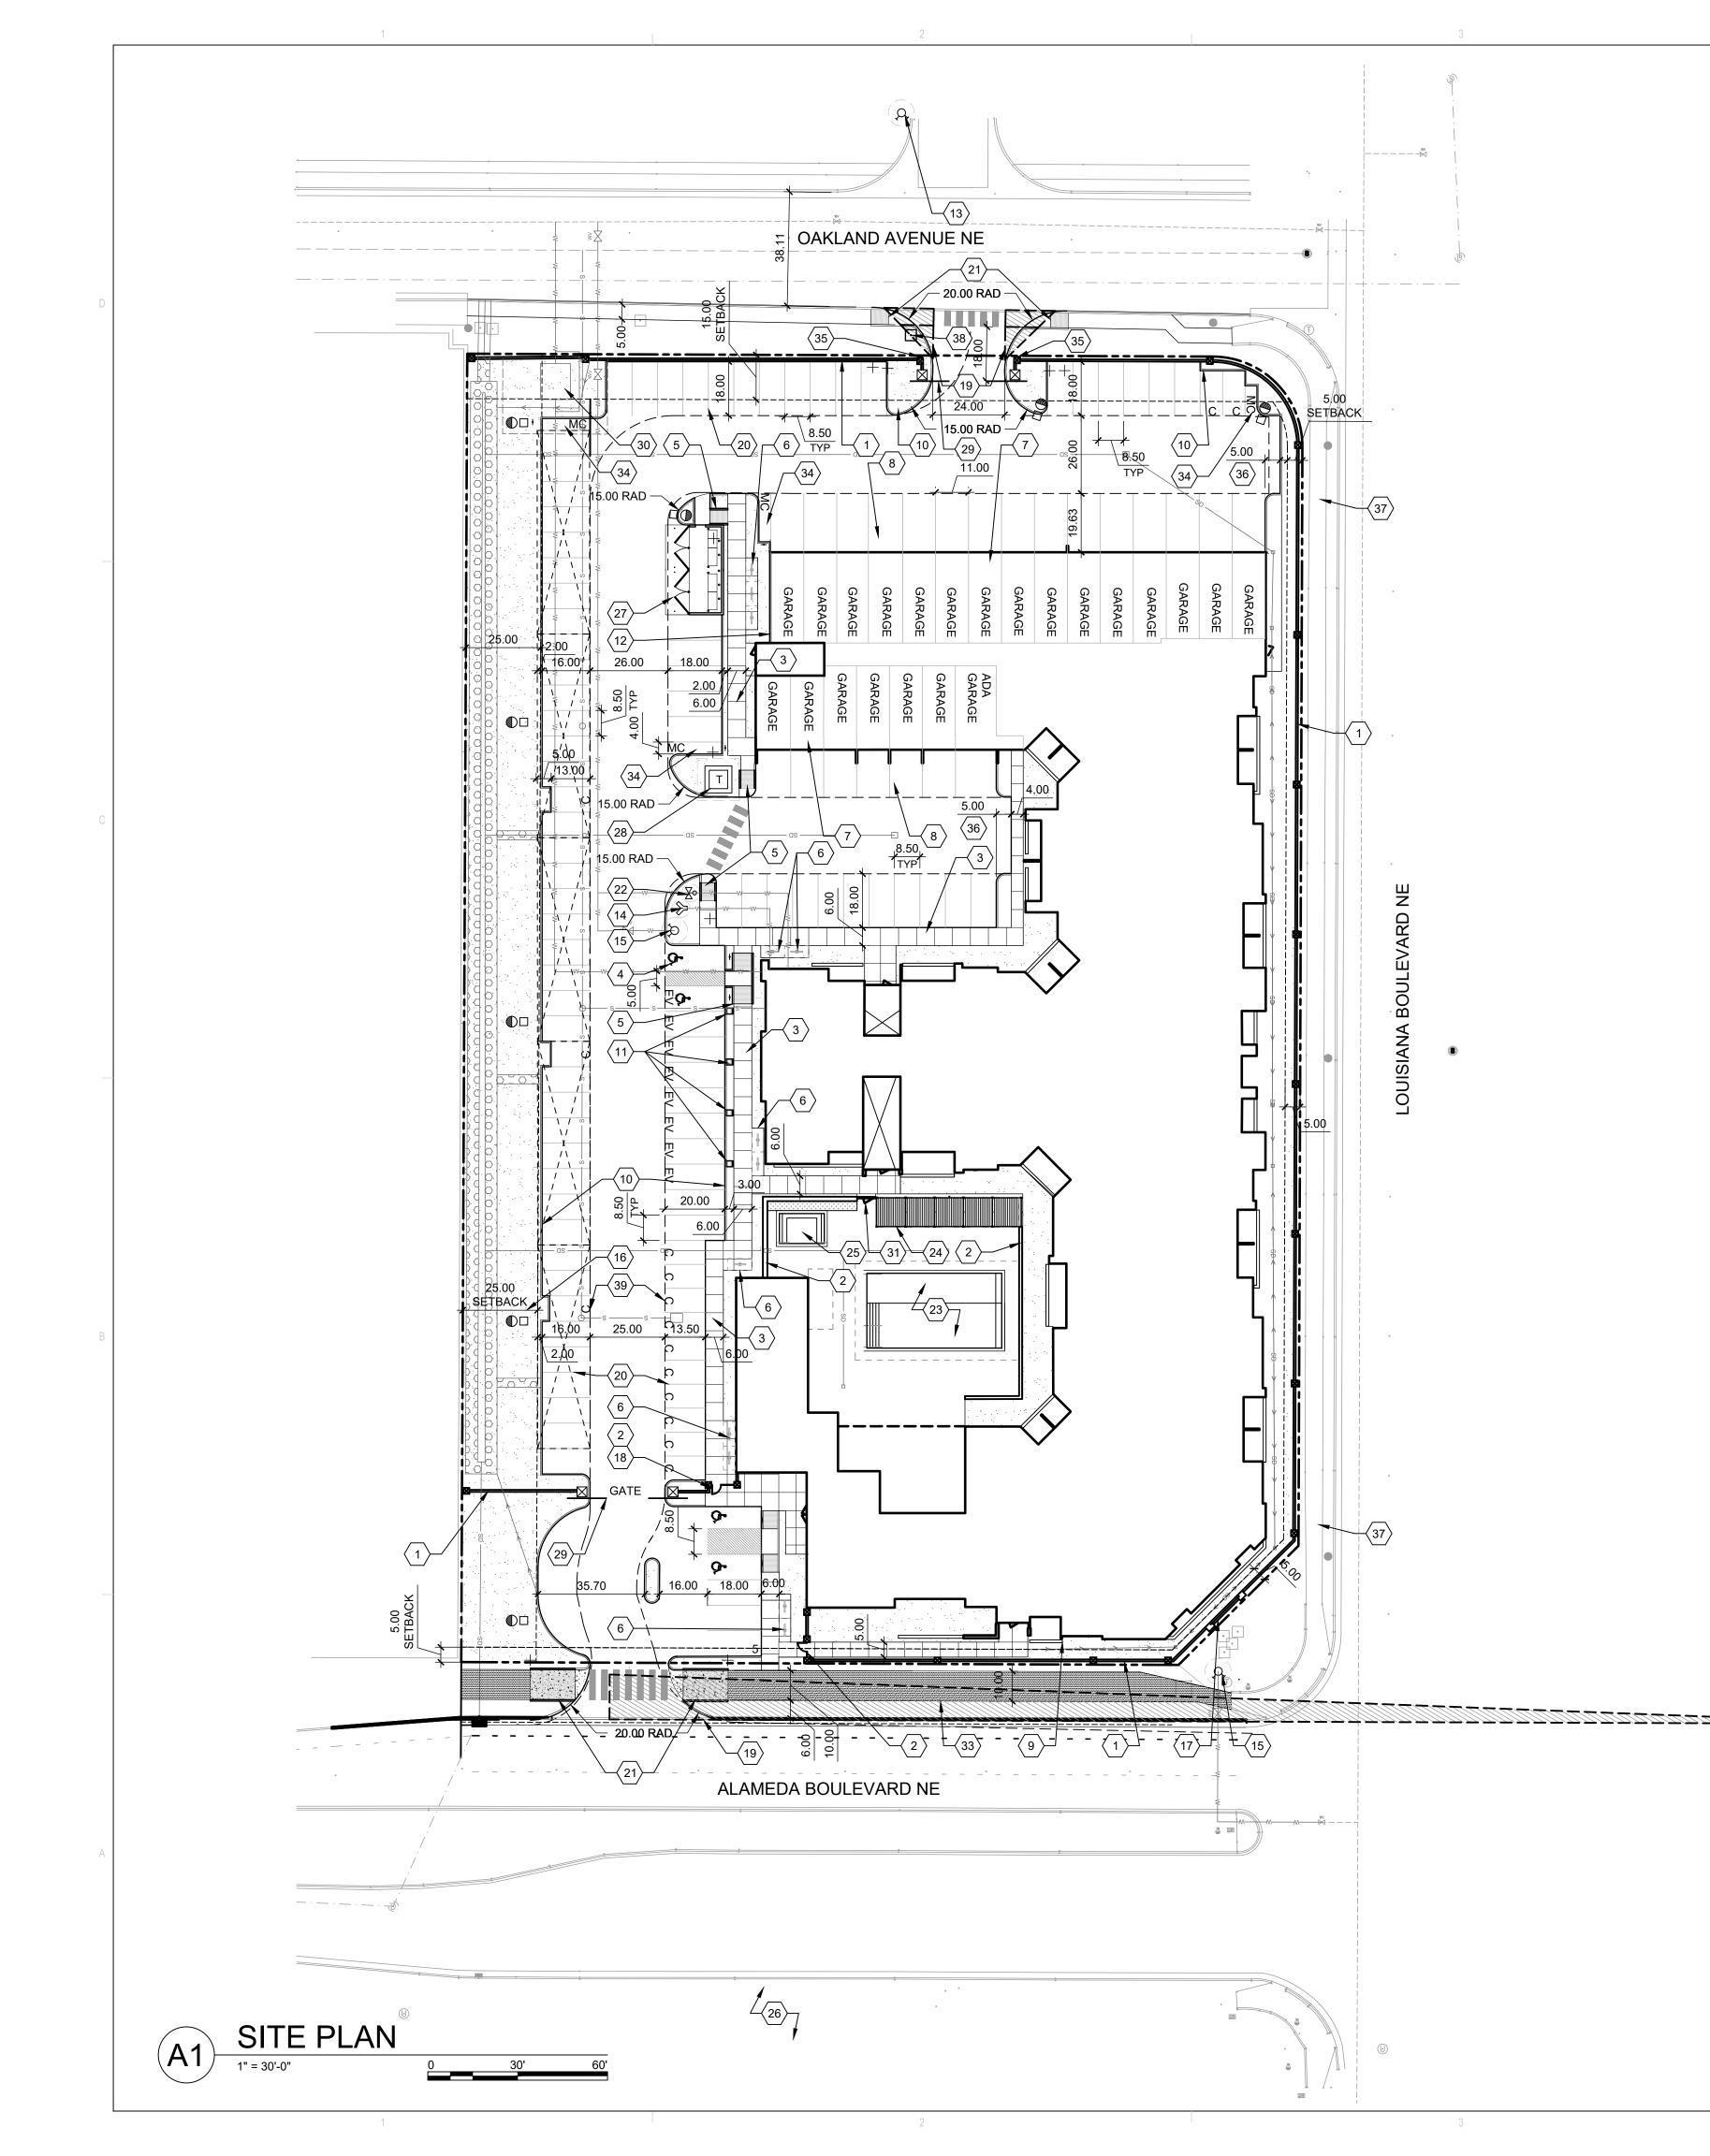








1. SEE PLANS FOR EXTENTS OF CURB PAINT.







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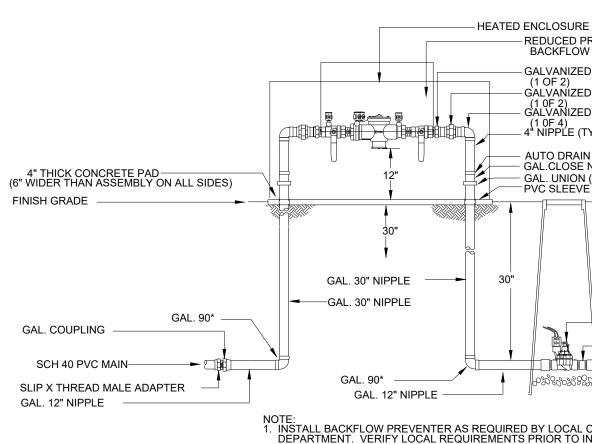


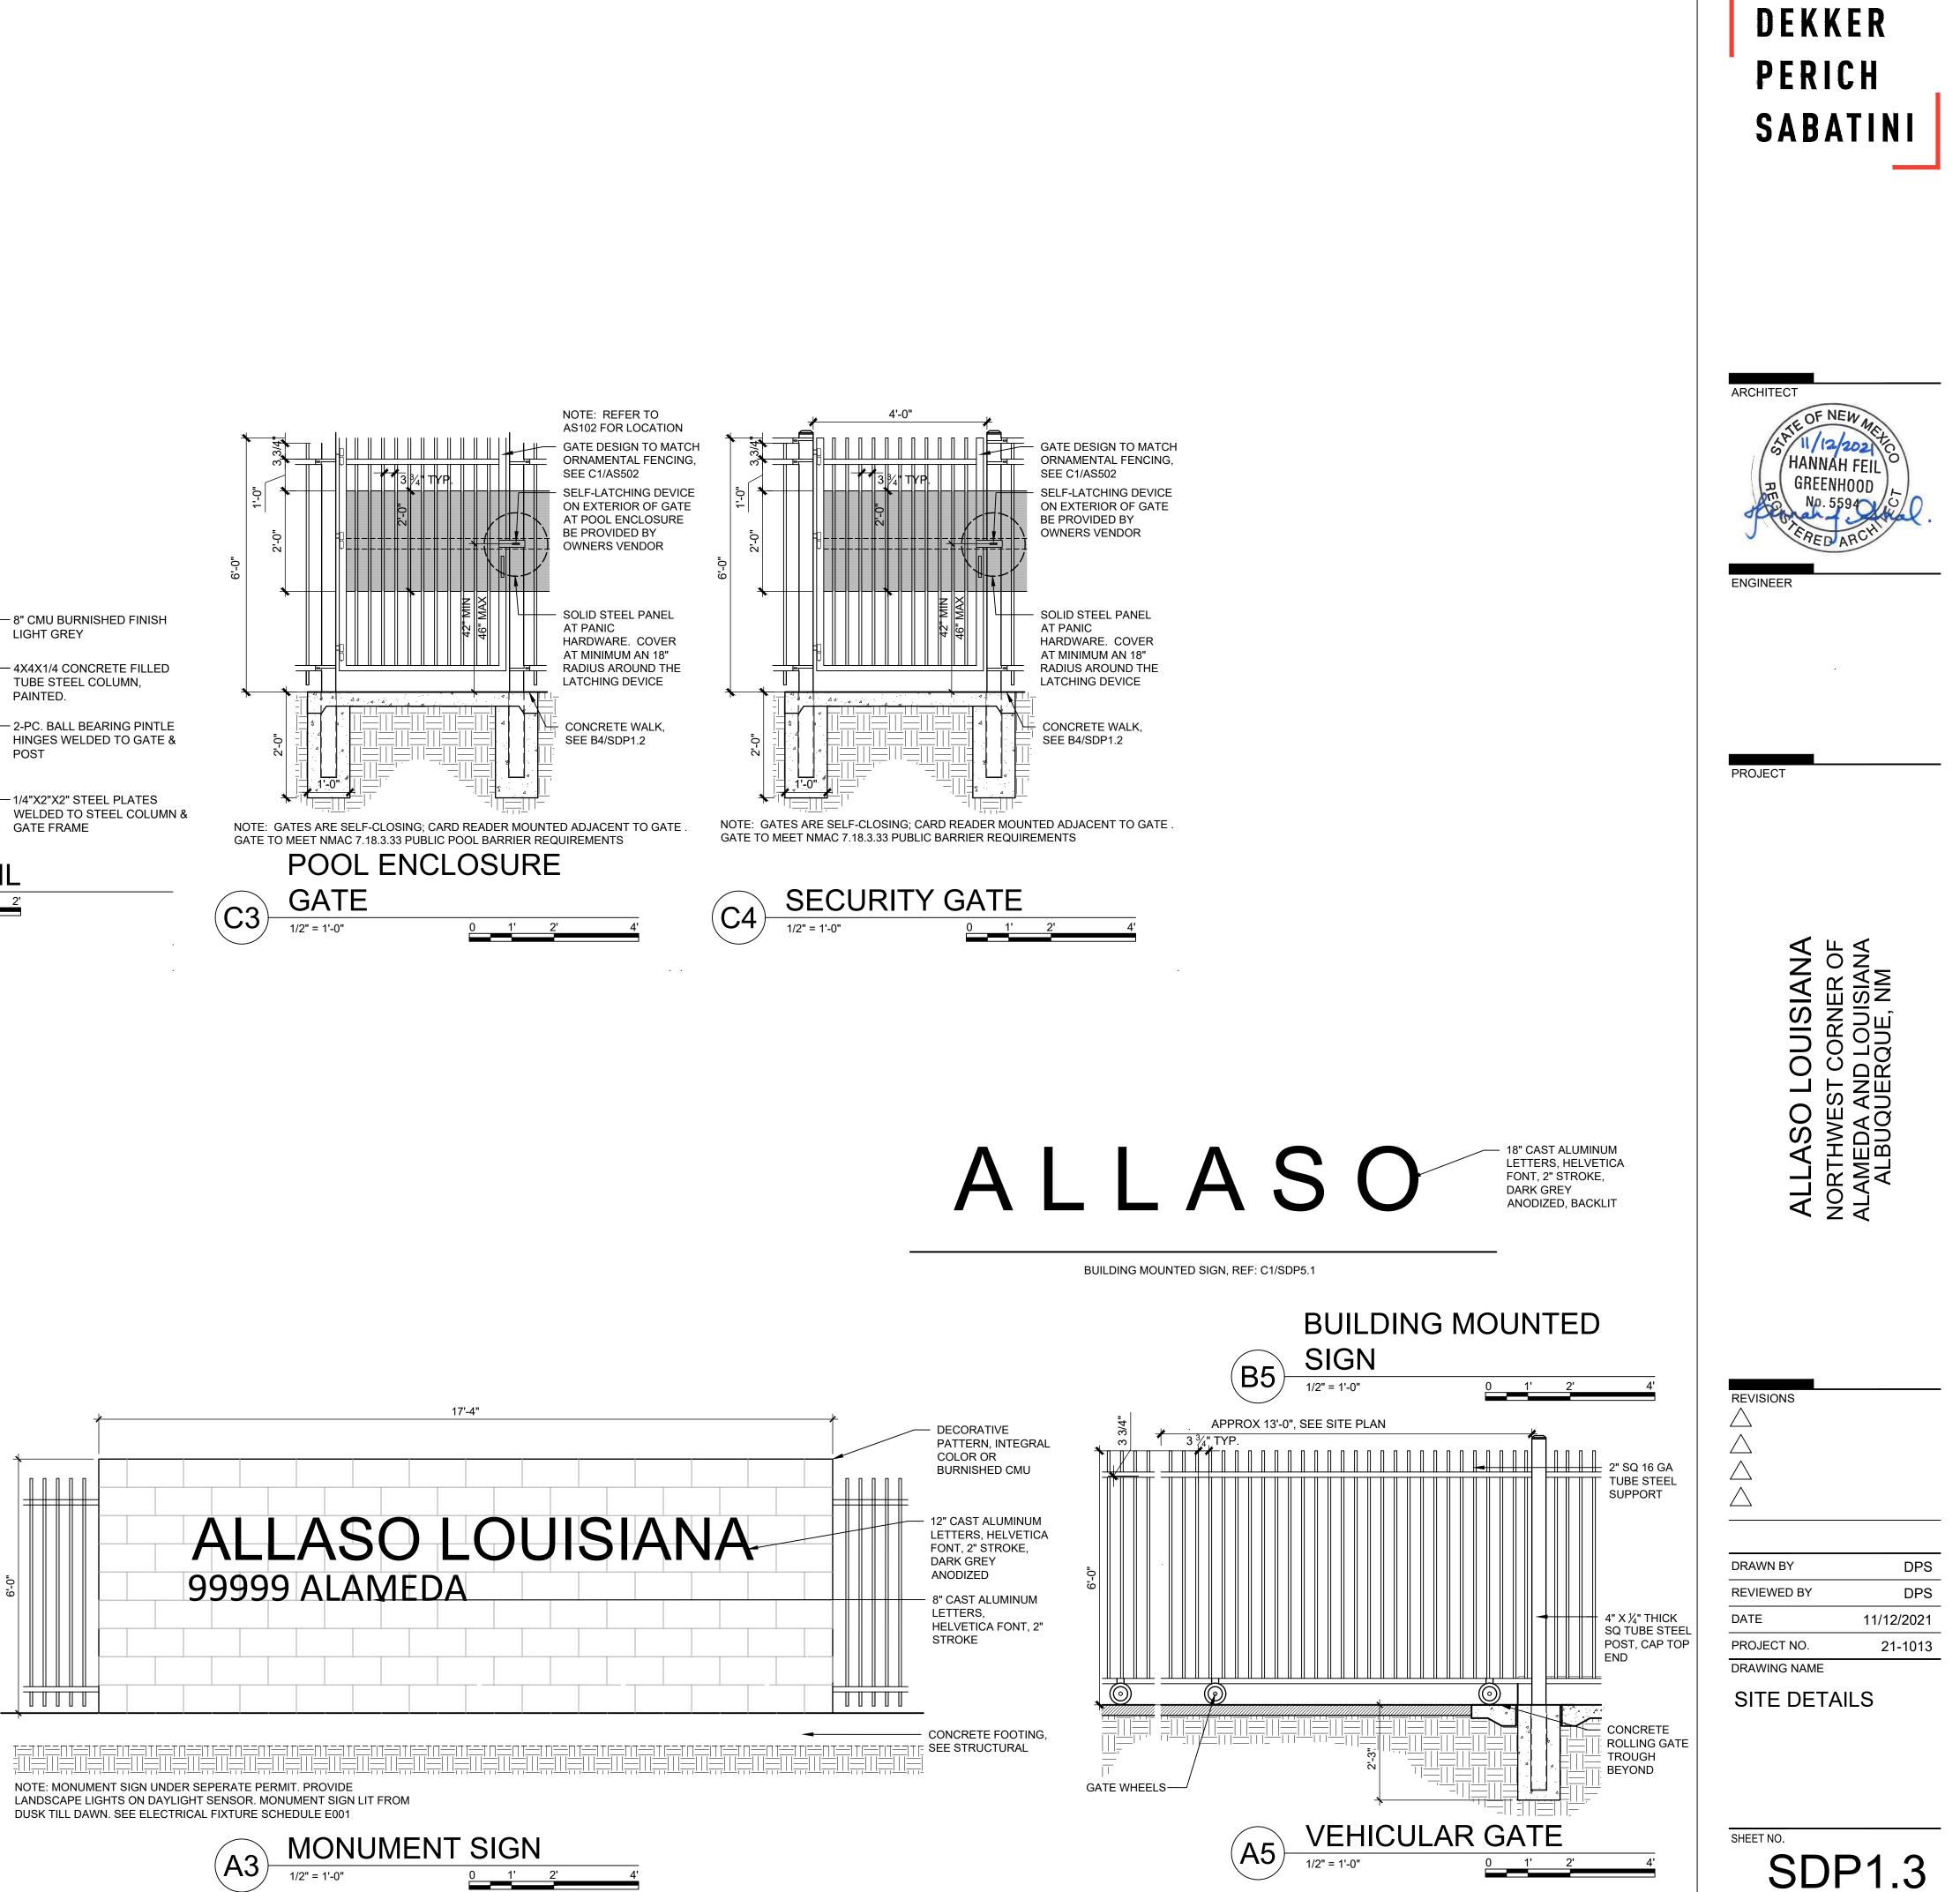LANDSCAPE PLAN


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+	23	SALV			
EVERGREEN SHRUBS	<u>QTY</u>	<u>Bot</u> a			
$\langle \circ \rangle$	65	CERC			
for a grant	28	ERIC			
\bigcirc	56	Fall			
	75	PINU			
\bigotimes	46	Rhaf			
\bigotimes	52	ROSM			

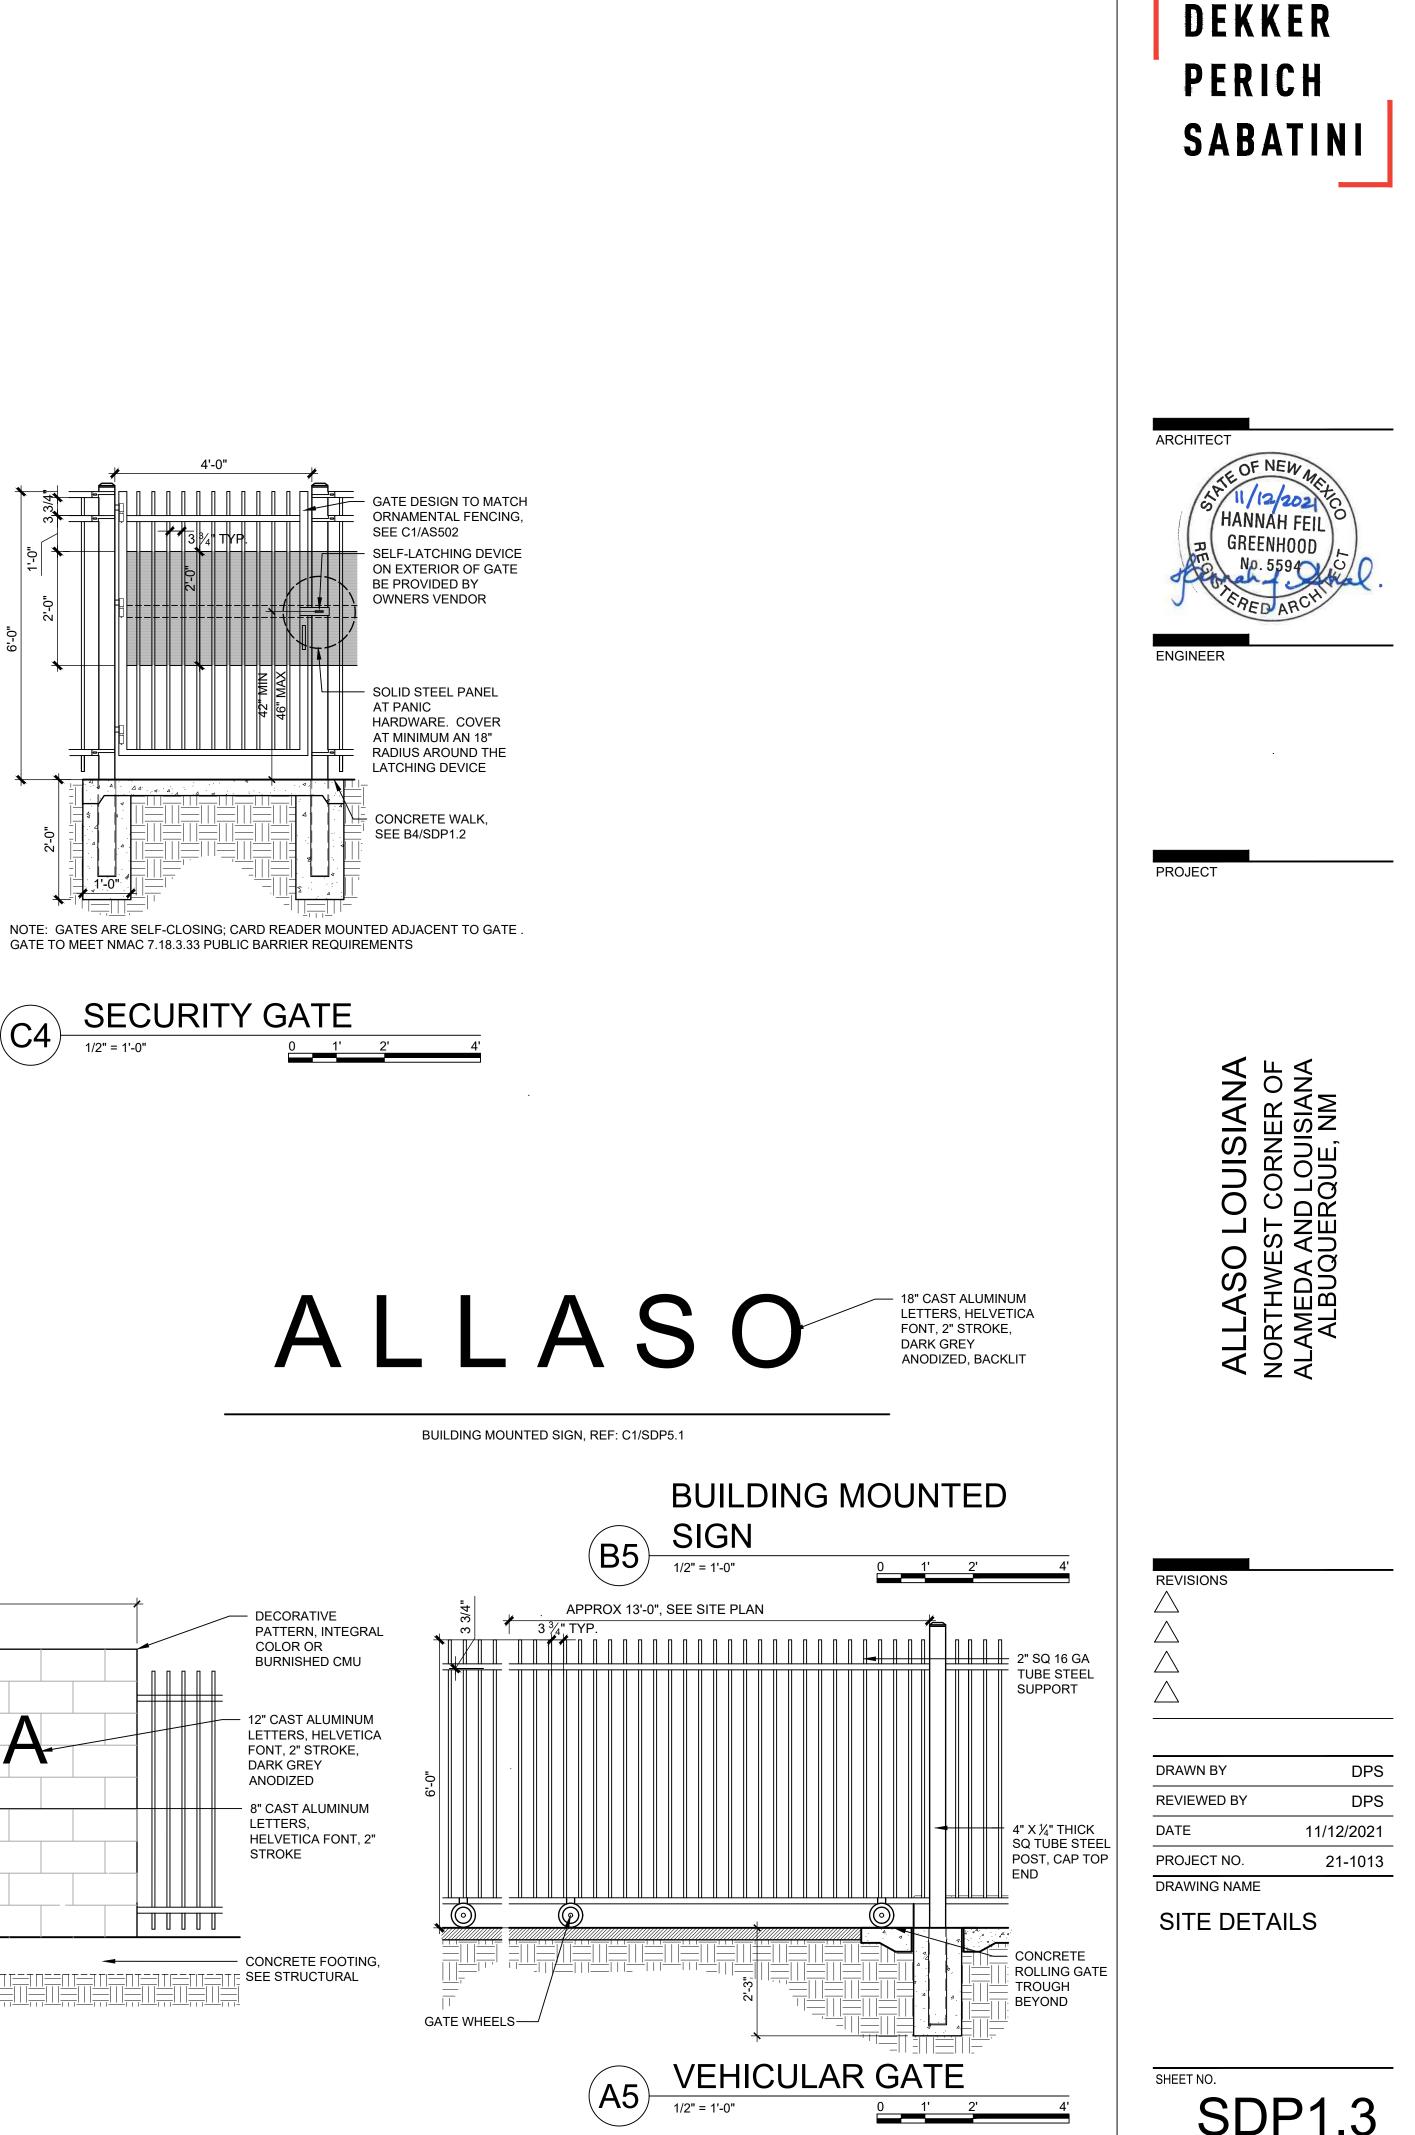ILE				MATERIAL SCHEDULE
BOTANICAL / COMMON NAME	<u>SIZE</u>	<u>H X W</u>	<u>COVERAGE</u>	SYMBOL DESCRIPTION LARGE BOULDER
CHILOPSIS LINEARIS 'ART'S SEEDLESS' / ART'S SEEDLESS DESERT WILLOW	24"BOX	20' X 25'	491X10=4910 SF	SYMBOL DESCRIPTION
COTINUS COGGYGRIA / SMOKE TREE	15 GAL	15' X 15'	177X5=885 SF	1" MOUNTAINAIR SUNRISE GOLD GRAVEL OVER FILTER FABRIC
FORESTIERA NEOMEXICANA / NEW MEXICAN PRIVET	24"BOX	15' X 15'	177X8=1,416 SF	
ulmus parvifolia / lacebark elm	2" B&B	40' X 40'	1,256X35=43,960 SF	1" PUEBLO ROSE GRAVEL OVER FILTER FABRIC
gleditsia triacanthos inermis / thornless common honeylocust	2"B&B	50' X 45'	1590X3=4770 SF	TURF
LAGERSTROEMIA INDICA / CRAPE MYRTLE	15 GAL	15' X 15'	177X13=2,301 SF	
PISTACIA CHINENSIS / CHINESE PISTACHE	2"B&B	40' X 30'	707X24=16,968 SF	
QUERCUS LOBATA / VALLEY OAK	2"B&B	45' X 30'	707X3=2,121 SF	4-8" MOUNTAINAIR SUNRISE GOLD COBBLE
BOTANICAL / COMMON NAME	<u>SIZE</u>	<u>h x w</u>	<u>COVERAGE</u>	LANDSCAPE CALCULATIONS
juniperus chinensis 'spartan' / spartan juniper	20 GAL	12' X 3'	7X9=63 SF	TOTAL AREA OF PROJECT 121,023 SF LESS BUILDING 41,570 SF
JUNIPERUS SCOPULORUM / ROCKY MOUNTAIN JUNIPER	15 GAL	40' X 20'	314X8=2512 SF	NET LOT AREA 79,453 SF
PINUS NIGRA / AUSTRIAN BLACK PINE			491X3=1,473 SF	REQUIRED LANDSCAPE AREA MINIMUM 25% OF NET LOT AREA 19,864 SF
BOTANICAL / COMMON NAME	Subtotal <u>SIZE</u>	Coverage <u>HXW</u>	81,377 SF <u>COVERAGE</u>	ACTUAL LANDSCAPE AREA30,303 SFLANDSCAPE AREA REQUIREMENT EXCEEDED10,439 SF
DASYLIRION TEXANUM / TEXAS SOTOL	5 GAL	5' X 5'	20X14=280 SF	LANDSCAPE COVERAGE REQUIRED – 75% 22,673 SF COVERAGE PROVIDED <u>103,904 SF</u>
HESPERALOE PARVIFLORA / RED YUCCA	5 GAL	3' X 4'	13X7=91 SF	REQUIREMENT EXCEEDED 81,231 SF
NOLINA MICROCARPA / BEARGRASS	5 GAL	5' X 6'	28X9=252 SF	REQUIRED 25% COVERAGE BY GROUND-LEVEL PLANTS 5,669 SF ACTUAL COVERAGE BY GROUND-LEVEL PLANTS <u>22,527 SF</u>
<u>botanical / common name</u> bouteloua gracilis 'blonde ambition' / blonde ambition blue grama	<u>SIZE</u> 1. gai	<u>HXW</u> .3` X .3`	<u>coverage</u> 7x172=1204 sf	REQUIREMENT EXCEEDED 16,858 SF
CALAMAGROSTIS X ACUTIFLORA 'KARL FOERSTER' / FEATHER REED GRASS			3X68=204 SF	SOD ALLOWED (10%)2,267 SFSOD ACTUAL164 SFUNDER MINIMUM ALLOWED2.107 SE
MUHLENBERGIA CAPILLARIS 'REGAL MIST' TM / MUHLY			7X32=224 SF	UNDER MINIMUM ALLOWED 2,103 SF PARKING LOT TREES (1 TREE PER 10 PARKING SPACES)
BOTANICAL / COMMON NAME	<u>SIZE</u>	HXW	COVERAGE	146 PARKING SPACES PROVIDED REQUIRED (146 / 10) 15 TREES
	5 GAL	 4' × 4'	13X68=884 SF	PROVIDED 15 TREES
BUDDLEJA DAVIDII / BUTTERFLY BUSH	5 GAL	4' X 4'	13X27=251 SF	STREET TREES REQUIRED (1 TREE PER 25 LF)39 TREESSTREET TREES PROVIDED39 TREES
CARYOPTERIS X CLANDONENSIS 'DARK KNIGHT' / BLUE MIST SPIREA	1 GAL	3' X 3'	7X29=203 SF	DWELLING UNIT TREES REQUIRED (1 TREE PER 1ST STORY UNIT + 1 TREE PER 2ND
GAILLARDIA X GRANDIFLORA / BLANKETFLOWER	1 GAL	2' X 2'	3X27=81 SF	STORY UNIT.67 UNITS TOTAL)67 TREESPROVIDED72 TREES
LAVANDULA ANGUSTIFOLIA / ENGLISH LAVENDER	1 GAL	3' X 3'	7X18=126 SF	DECIDUOUS TREES REACHING 25' MATURE CANOPY DIAMETER REQUIRED (50%) 34 TREES
LEUCOPHYLLUM FRUTESCENS / TEXAS SAGE	5 GAL	6' X 6'	28X16=448 SF GEN	PROVIDED35 TREESNERAL LANDSCAPE NOTES
NEPETA X FAASSENII 'SELECT BLUE' / CATMINT	1 GAL	1' X 2'	JA20-04 JI	CONTRACTOR TO VERIFY EXISTING UTILITY LOCATIONS BEFORE EXCAVATION AND PLANTING.
PENSTEMON PINIFOLIUS / THREADLEAF BEARDTONGUE	1 GAL	1" X 20"	в. 3X42=126 SF	RESPONSIBILITY FOR MAINTENANCE: THE CONTRACTOR WILL BE RESPONSIBLE FOR MAINTENANCE OF THE LANDSCAPE DURING CONSTRUCTION AND DURING A 90 DAY-MAINTENANCE PERIOD FOLLOWING SUBSTANTIAL COMPLETION. THE OWNER WILL BE RESPONSIBLE FOR MAINTENANCE FOLLOWING THE 90-DAY MAINTENANCE
RHUS AROMATICA 'GRO-LOW' / GRO-LOW FRAGRANT SUMAC	5 GAL	4' X 4'	13X54=702 SF	PERIOD. THE PROPERTY OWNER SHALL MAINTAIN RIGHT-OF-WAY (ROW) LANDSCAPING IN A NEAT AND HEALTHY CONDITION.
ROSA X 'KNOCKOUT' TM / ROSE	5 GAL	6' X 5'	20X9=180 SF C.	
SALVIA GREGGII / AUTUMN SAGE CHERRY	1 GAL	2' X 3'	7X23=161 SF	REGULATIONS, WATER CONSERVATION LANDSCAPING AND WATER WASTE REGULATIONS, POLLEN-RELATED REGULATIONS, MINIMUM VEGETATIVE COVERAGE REQUIREMENTS AND STREET TREE REGULATIONS.
BOTANICAL / COMMON NAME	<u>SIZE</u>	<u>HXW</u> 15' X 15'	<u>COVERAGE</u> D. 177X65=11505 SFE.	TIMING OF LANDSCAPE INSTALLATION: INSTALLATION OF THE LANDSCAPING SHALL BE COMPLETE WITHIN 60 DAYS OF THE RELATED BUILDING'S OCCUPANCY. SURFACE TREATMENT: LANDSCAPE AREAS SHALL BE COVERED WITH MULCH.
CERCOCARPUS LEDIFOLIUS / CURL-LEAF MOUNTAIN MAHOGANY ERICAMERIA LARICIFOLIA / TURPENTINE BUSH	5 GAL 5 GAL	3' X 4'	F.	LANDSCAPE, FENCING, AND SIGNING WILL NOT INTERFERE WITH CLEAR SIGHT REQUIREMENTS. THEREFORE, SIGNS, WALLS, TREES, AND SHRUBBERY BETWEEN 3'
FALLUGIA PARADOXA / APACHE PLUME		6' X 7'		AND 8' (AS MEASURED FROM THE GUTTER PAN) WILL NOT BE ACCEPTABLE IN THIS AREA. LANDSCAPING WILL BE WATERED WITH AN AUTOMATED IRRIGATION SYSTEM THAT INCLUDES DRIP ZONES FOR LANDSCAPING.
PINUS MUGO MUGO / DWARF MUGO PINE	5 GAL	4° X 4°		MINIMUM PLANT SIZES ARE AS PER CITY OF ALBUQUERQUE STANDARDS: 2" CALIPER TREES, 6' HEIGHT CONIFERS, AND 1 GALLON SHRUBS.
RHAPHIOLEPIS INDICA / INDIAN HAWTHORN	5 GAL	3' X 4'	13X46=598 SF	AREAS DISTURBED DURING CONSTRUCTION, INCLUDING AREAS NOT WITHIN THE PROPERTY LINE, WILL BE STABILIZED. ROOF DRAINS: SURFACE DRAINAGE OFF DOWNSPOUTS SHALL BE DIRECTED AWAY FROM BUILDINGS INTO LANDSCAPE AREAS OR ENGINEERED DRAINAGE SYSTEMS.
ROSMARINUS OFFICINALIS / ROSEMARY	5 GAL	6' X 6'		REFER TO CIVIL. VEGETATIVE SCREENING SURROUNDING GROUND-MOUNTED TRANSFORMERS AND UTILITY PADS SHALL ALLOW 10' OF CLEARANCE IN FRONT OF THE EQUIPMENT
	Subtotal	Coverage	22,527 SF	DOOR AND 5' OF CLEARANCE ON THE REMAINING SIDES FOR SAFE OPERATION AND MAINTENANCE.
	Total Cov	rage	103,904 Sr M.	NEW PLANTINGS DO NOT EXCEED THE 10% LIMIT FOR HIGH WATER TURF. ORGANIC BARK MULCH IS PROVIDED AT EACH TREE FROM ROOT BALL EXTENDING OUT TO DRIPLINE PER CITY OF ALBUQUERQUE IDO 14-16-5-6(C)(5)(b)
				WHERE MULCH IS ADJACENT TO CONCRETE OR ASPHALT, FINISH GRADE OF MULCH SHALL 1/2" BELOW TOP OF CONCRETE, UNLESS OTHERWISE INDICATED. PLANT MATERIAL SHALL BE FREE OF DISEASE AND INSECTS AND SHALL CONFORM
HEATED ENCLOSURE			P	TO THE AMERICAN STANDARD FOR NURSERY STOCK (ASNA) OF THE AMERICAN NURSERY AND LANDSCAPE ASSOCIATION. ALL LANDSCAPING CONTIGUOUS TO INDIGENOUS AREAS TO BE PLANTED WITH
BACKFLOW PREVENTER GALVANIZED MALE ADAPTER (1 OF 2) GALVANIZED UNION				INDIGENOUS TREES AND SHRUBS. PLANTINGS IN CLEAR SIGHT TRIANGLE NOT TO OBSTRUCT LINE OF VISION FROM 3'
				HEIGHT TO 8' HEIGHT'
AUTO DRAIN VALVE WITH GAL. TEE (TY GAL.CLOSE NIPPLE (TYP.)	P.)			LEADER LEFT UNPRUNED
PAD	P.)			LIGHT PRUNING: RUBBING, CROSSED OR DAMAGED BRANCHES ARE REMOVED
				TRUNK PROTECTED BY LOOSE TREE GUARD, REMOVED AFTER ONE YEAR
GAL. 30" NIPPLE				2"-3" DEPTH ORGANIC MULCH APPLIED WELL AWAY FROM TRUNK (NO BLACK PLASTIC) 2/3 NATIVE SOIL AND 1/3 CWA SCREENED
	HREAD MALE AD			BARK MULCH TO BE USED AS BACKFILL
GAL. 12" NIPPLE []				OF BURLAP AND WIRE BASKET REMOVED, BURLAP SLIT FOR ROOT EXTENSION PLANTING HOLE 2-3 TIMES ROOT BALL WIDTH DEPTH SAME AS ROOT BALL
DEPARTMENT. VERIFY LOCAL REQUIREMENTS PRIOR TO INSTALLATION.				WIDTH, DEPTH SAME AS ROOT BALL
RP BACKFLOW/MASTER VALVE DETAIL				TREE PLANTING DETAIL
N.T.S.				(2) N.T.S.

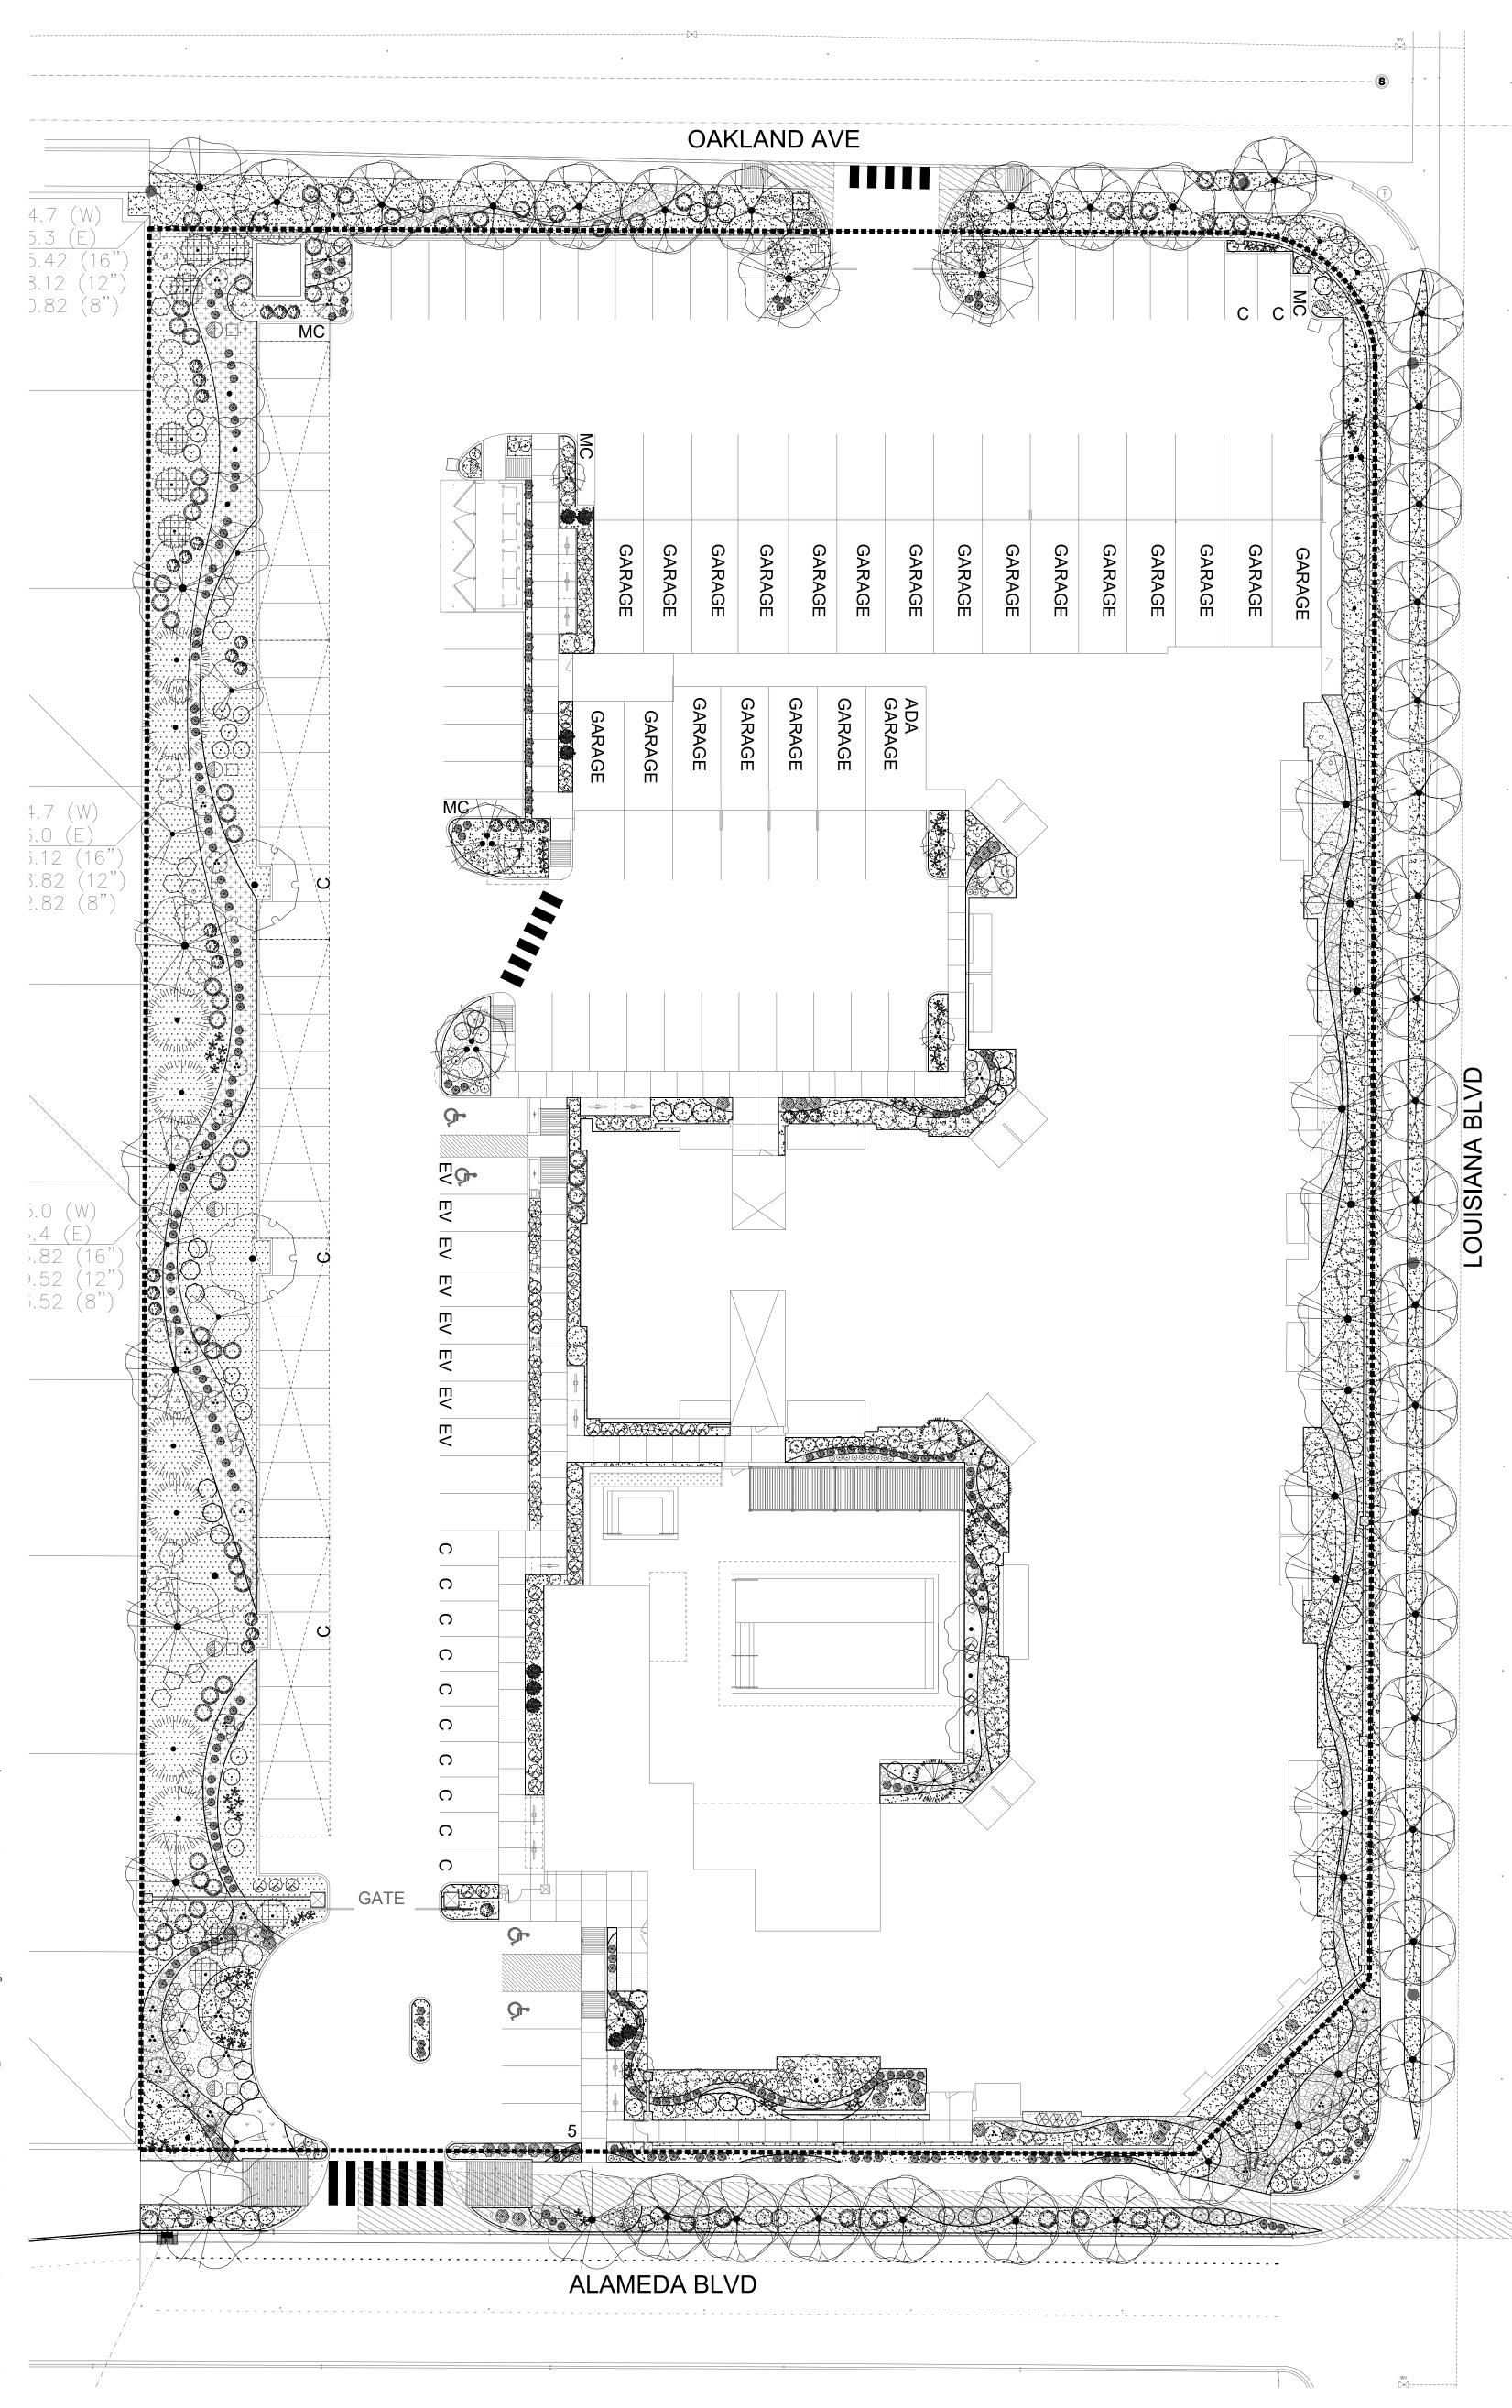
MATERIAL SCHEDULE




CONCEPTUAL PLAN NOT FOR CONSTRUCTION

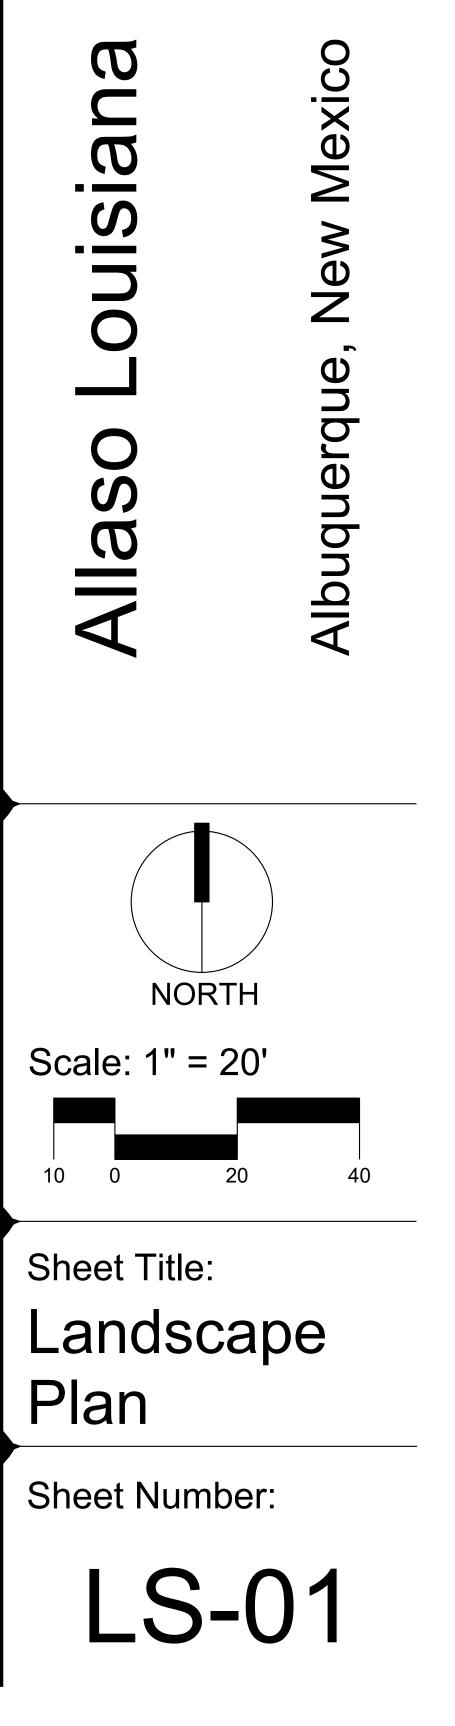



YELLOWSTONE www.yellowstonelandscape.com PO Box 10597 Albuquerque, NM 87184 505.898.9615 design@yellowstonelandscape. com Date: <u>11/12/2021</u> **Revisions**: 01/07/2022 HA Drawn by: PL Reviewed by: <u>JB</u>

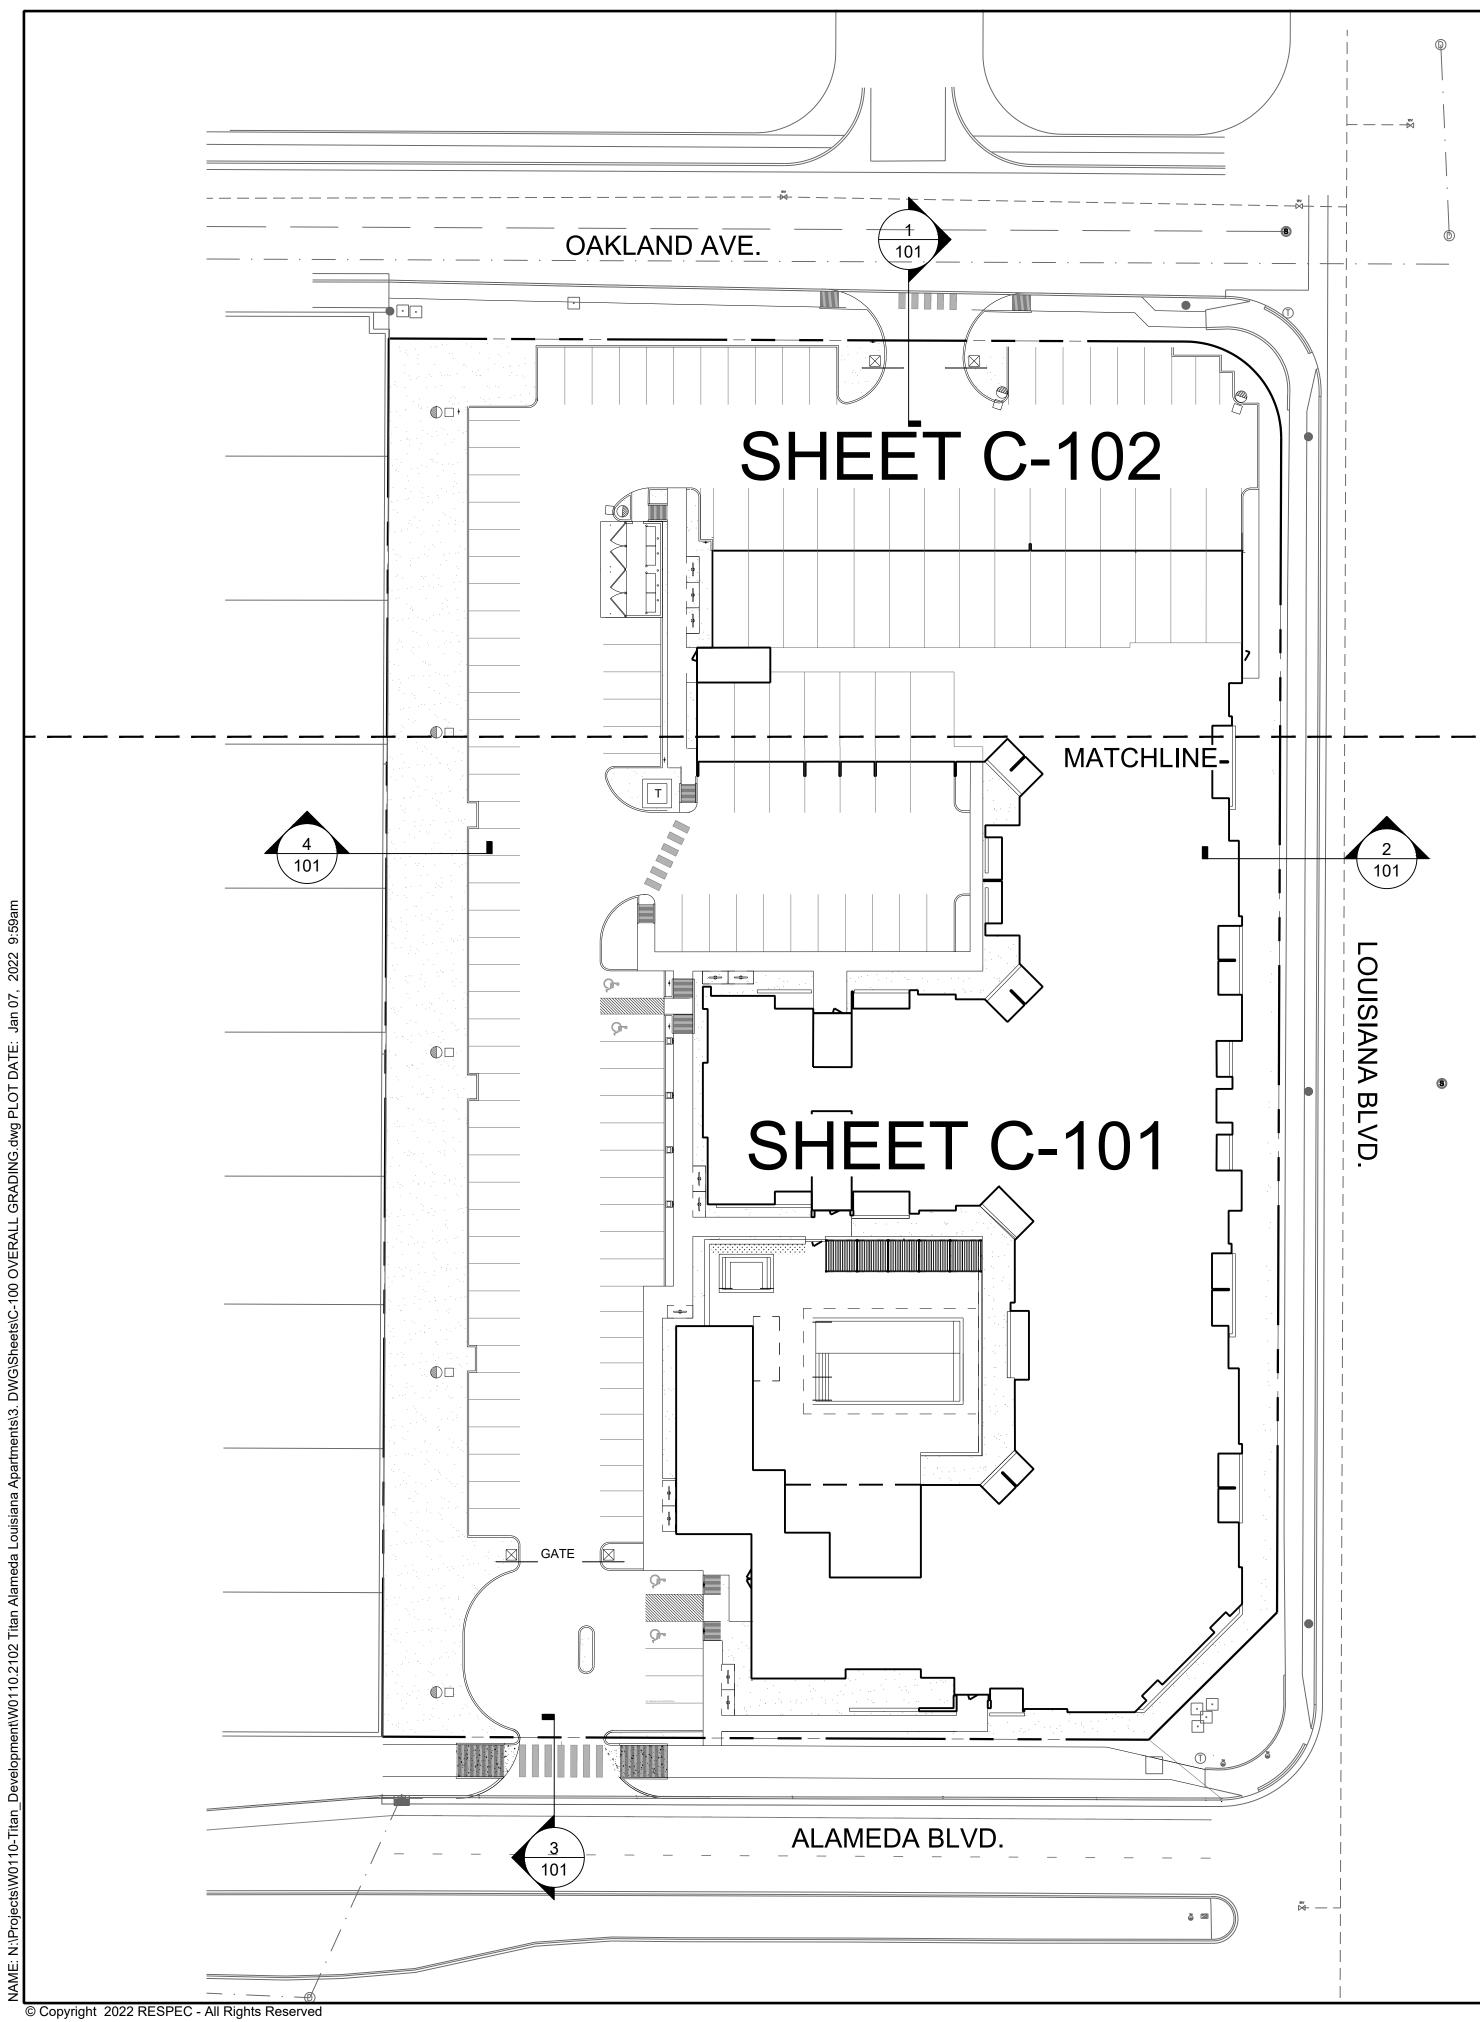

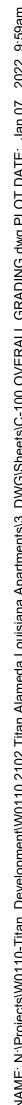



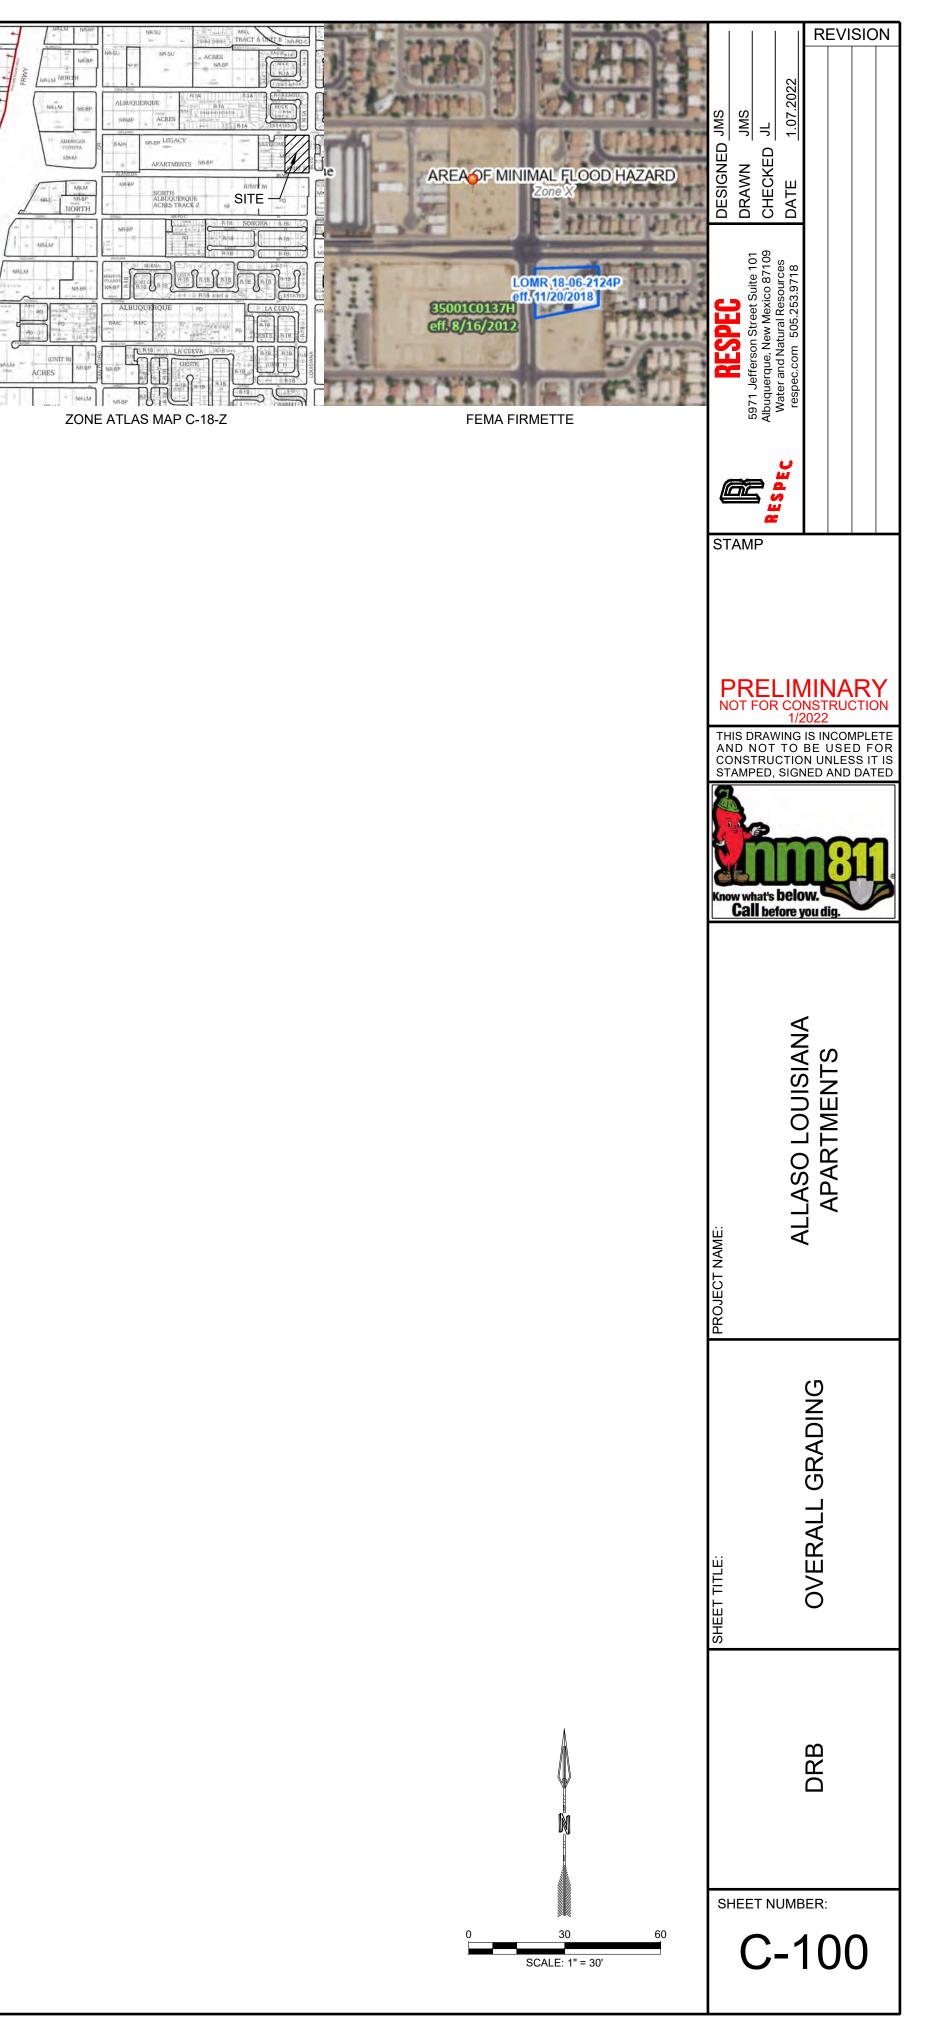

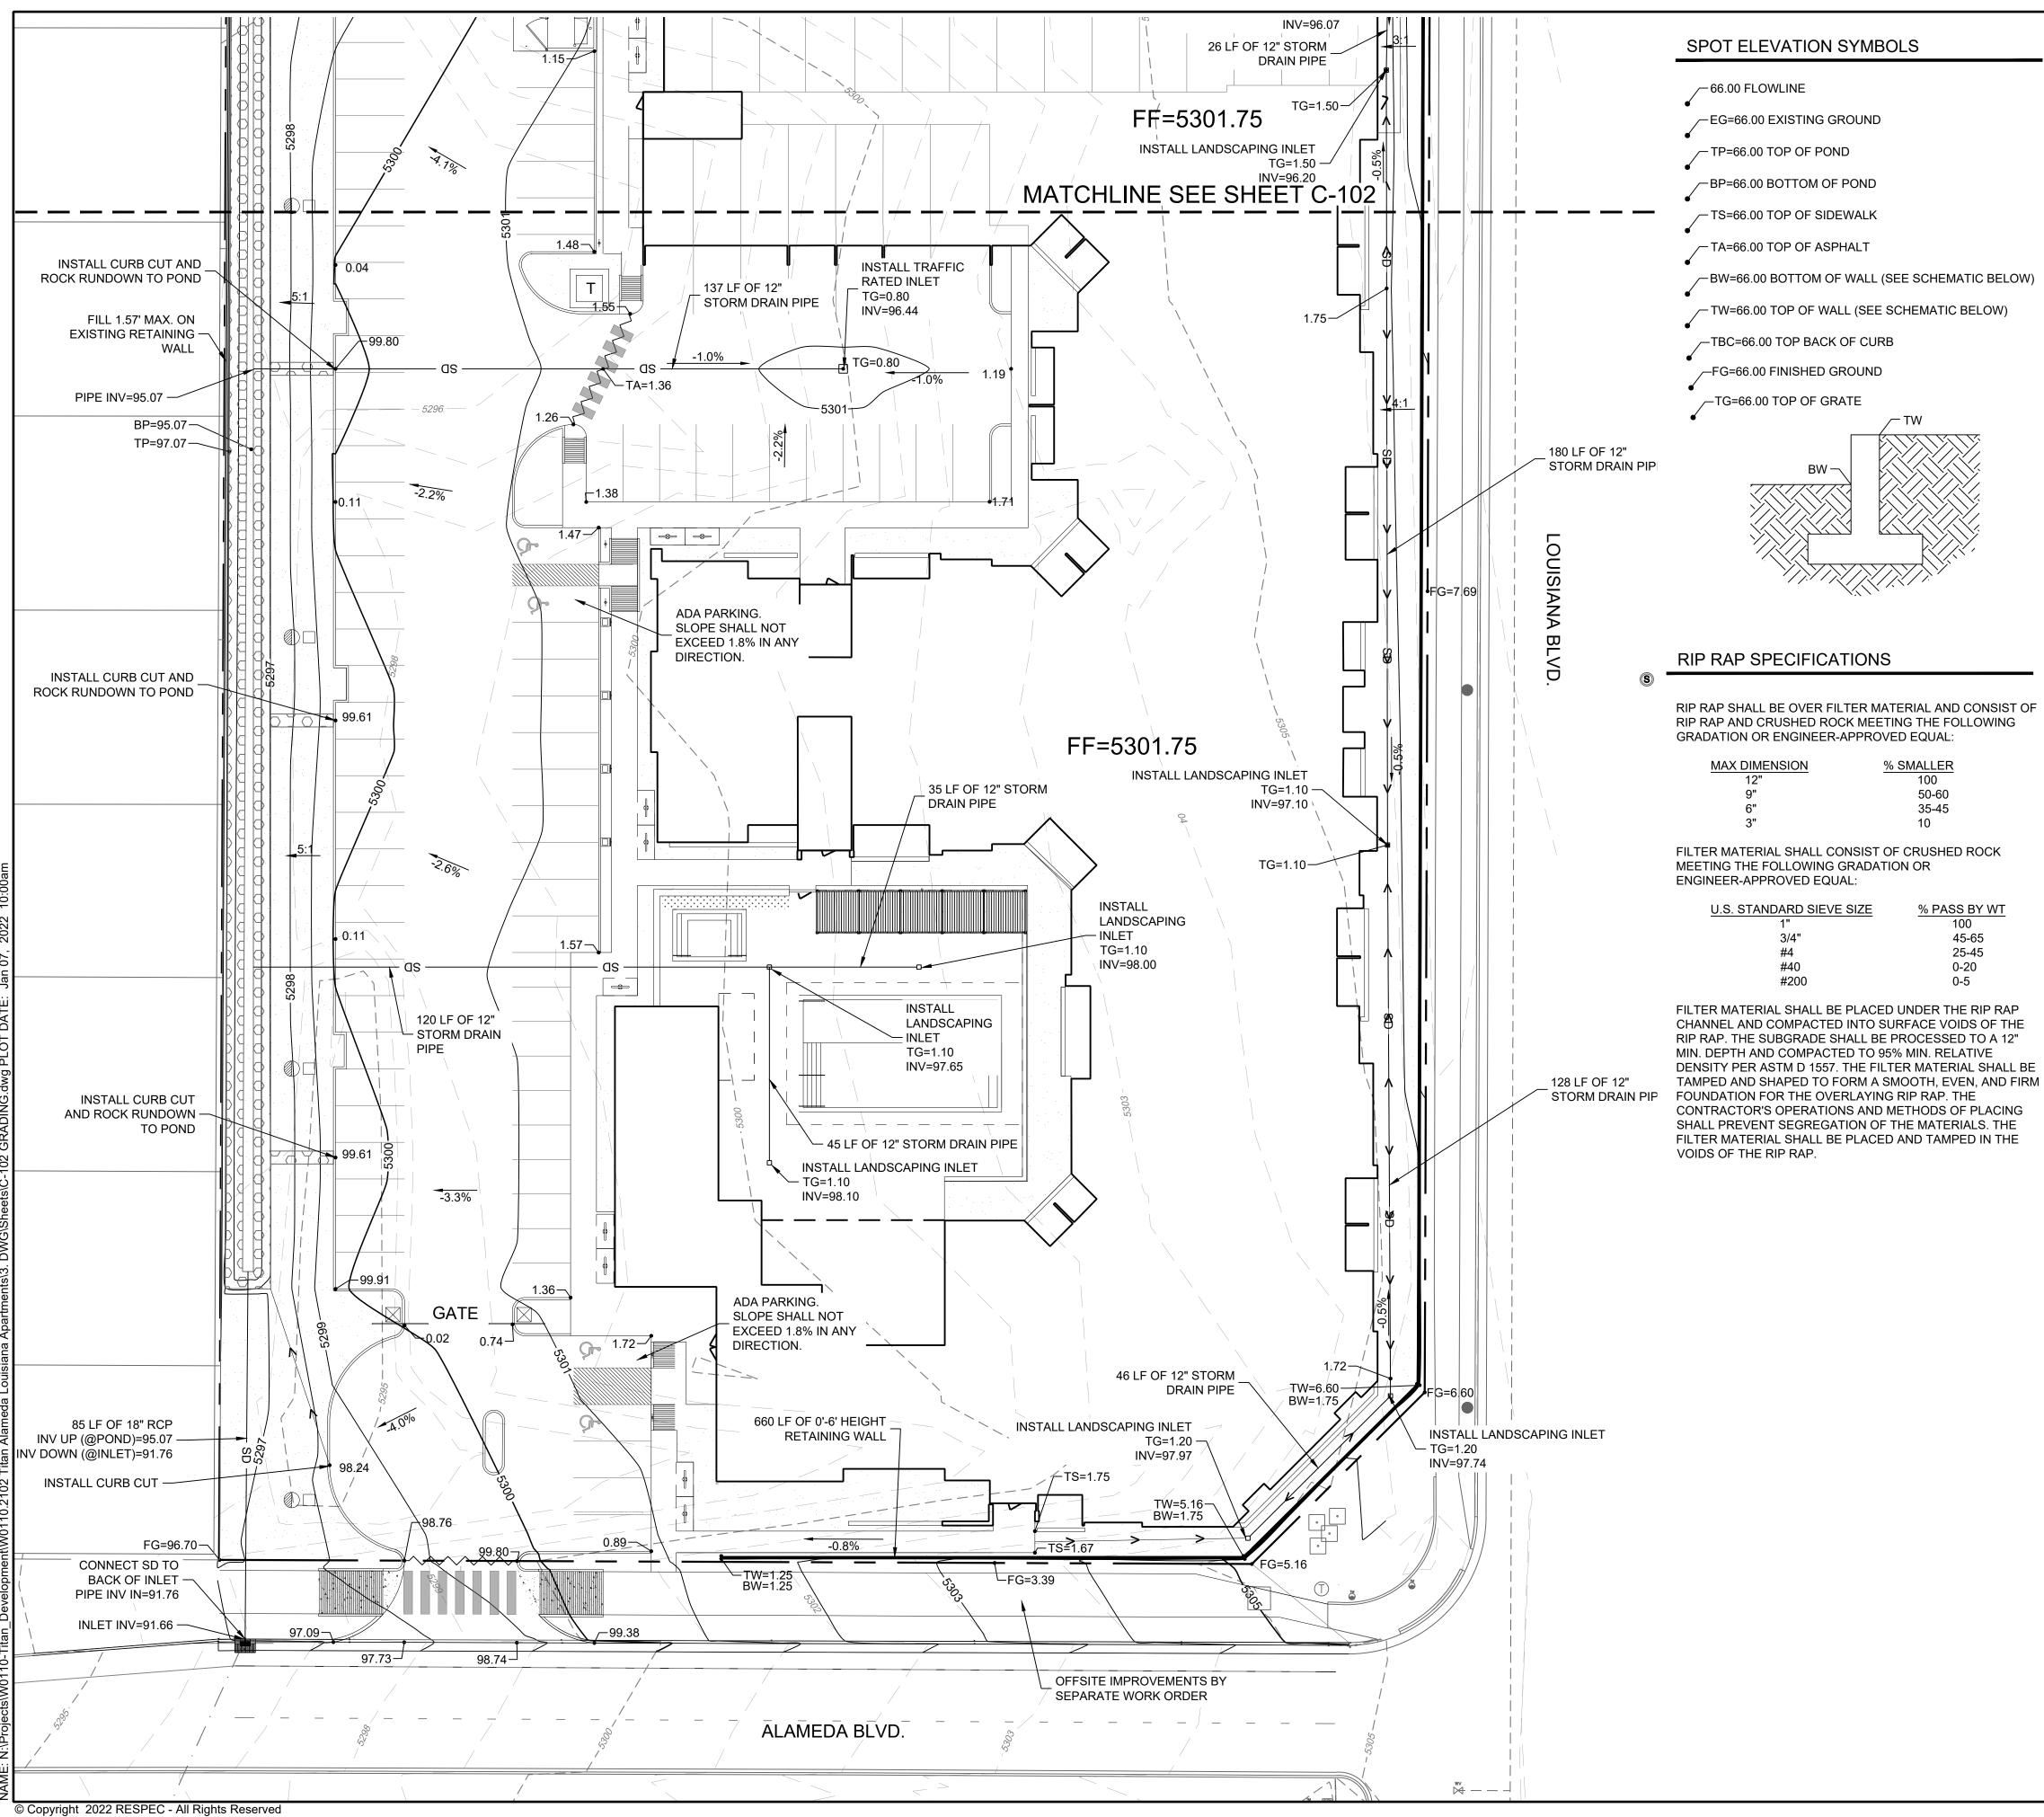




% PASS BY WT


LEGEND		
— — — 5730— — — — — 5728— — — — 5730— — 5728—	EXISTING PROPERTY LINE EXISTING MAJOR CONTOUR EXISTING MINOR CONTOUR PROPOSED MAJOR CONTOUR PROPOSED MINOR CONTOUR	DESIGNED JMS DRAWN JMS CHECKED JL DATE 1.072022
	LIMITS OF DISTURBANCE PROPOSED WATER BLOCK PROPOSED SWALE SLOPE ARROW PROPOSED RIP RAP PER SPEC	SPEC son Street Suite 101 , New Mexico 87109 Vatural Resources
 SD ∞	PROPOSED RETAINING WALL PROPOSED STEM WALL PROPOSED STORM DRAIN INLET PROPOSED STORM DRAIN PROPOSED STORM DRAIN CLEANOUT	RES FS71 Jefferson Albuquerque, Ne Water and Nati
GRADING NOTES		STAMP
PRIOR TO CONSTRUCTION	ERIFY LOCATION AND NG DRY AND WET UTILITIES AND NOTIFY ENGINEER OF OCATION MAY BE REQUIRED.	

PARKING LOT STRIPING AND SITE PLAN HAVE BEEN SCREENED BACK FOR VISUAL CLARITY

- 3. GRADES SHOWN ARE FINAL SURFACE GRADES AFTER COMPLETION OF SURFACE IMPROVEMENTS.
- 4. GRADE AREAS AT SITE PERIMETER TO MATCH GRADES OF ADJACENT PARCELS.
- REMOVE EXCESS SOIL FROM SITE AND DISPOSE OF PROPERLY IN ACCORDANCE WITH APPLICABLE REGULATIONS.
- 6. PROVIDE TEMPORARY GRADING FEATURES SUCH AS BERMS, SWALES, SUMPS AND BASINS TO MANAGE INTERIM STORM WATER RUNOFF DURING CONSTRUCTION PROCESS. STORM WATER RUNOFF LEAVING THE SITE SHALL MEET ALL FEDERAL, STATE AND LOCAL QUALITY REQUIREMENTS.
- 7. ALL DISTURBED AREAS TO BE RE-SEEDED PER LANDSCAPE PLAN PROVIDED BY OTHERS.
- 8. ALL AREAS WITH SLOPES GREATER THAN 3:1 SHALL BE LANDSCAPED WITH 3/4" MINUS ALL FACED FRACTURED GRAVEL AND SEPARATION FABRIC.
- INSTALL L-TOE TYPE RETAINING WALLS FOR ALL RETAINING WALLS ADJACENT TO THE PROPERTY BOUNDARY. FOOTER SHALL NOT EXTEND OUTSIDE OF THE PROPERTY. INSTALL TYPE E-3-S RETAINING WALL WHERE FINISHED GRADE AT THE TOP OF WALL EXCEEDS 10%. FOR ALL OTHER RETAINING WALLS USE RETAINING WALL TYPES A THROUGH TYPE D. RETAINING WALL TYPE VARIES WITH WALL HEIGHT (SEE RETAINING WALL DETAIL SHEET C-106).

SCALE: 1" = 20'

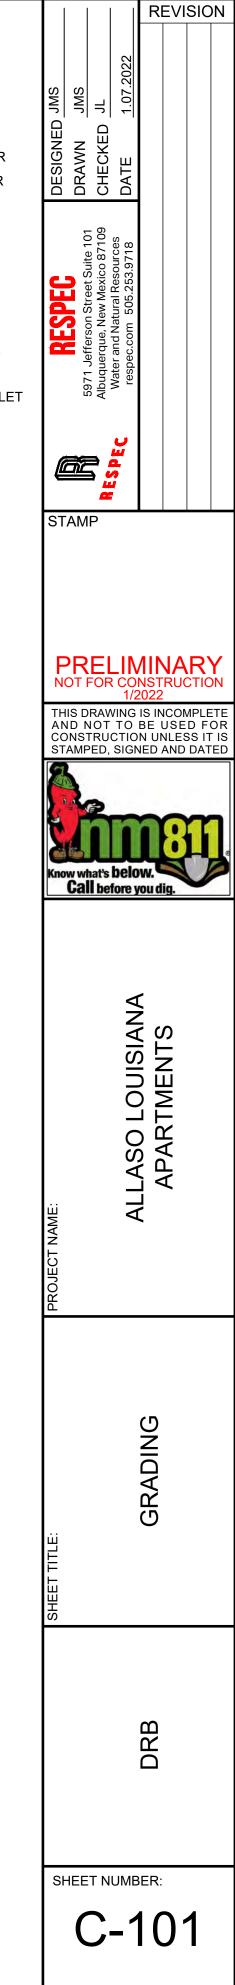

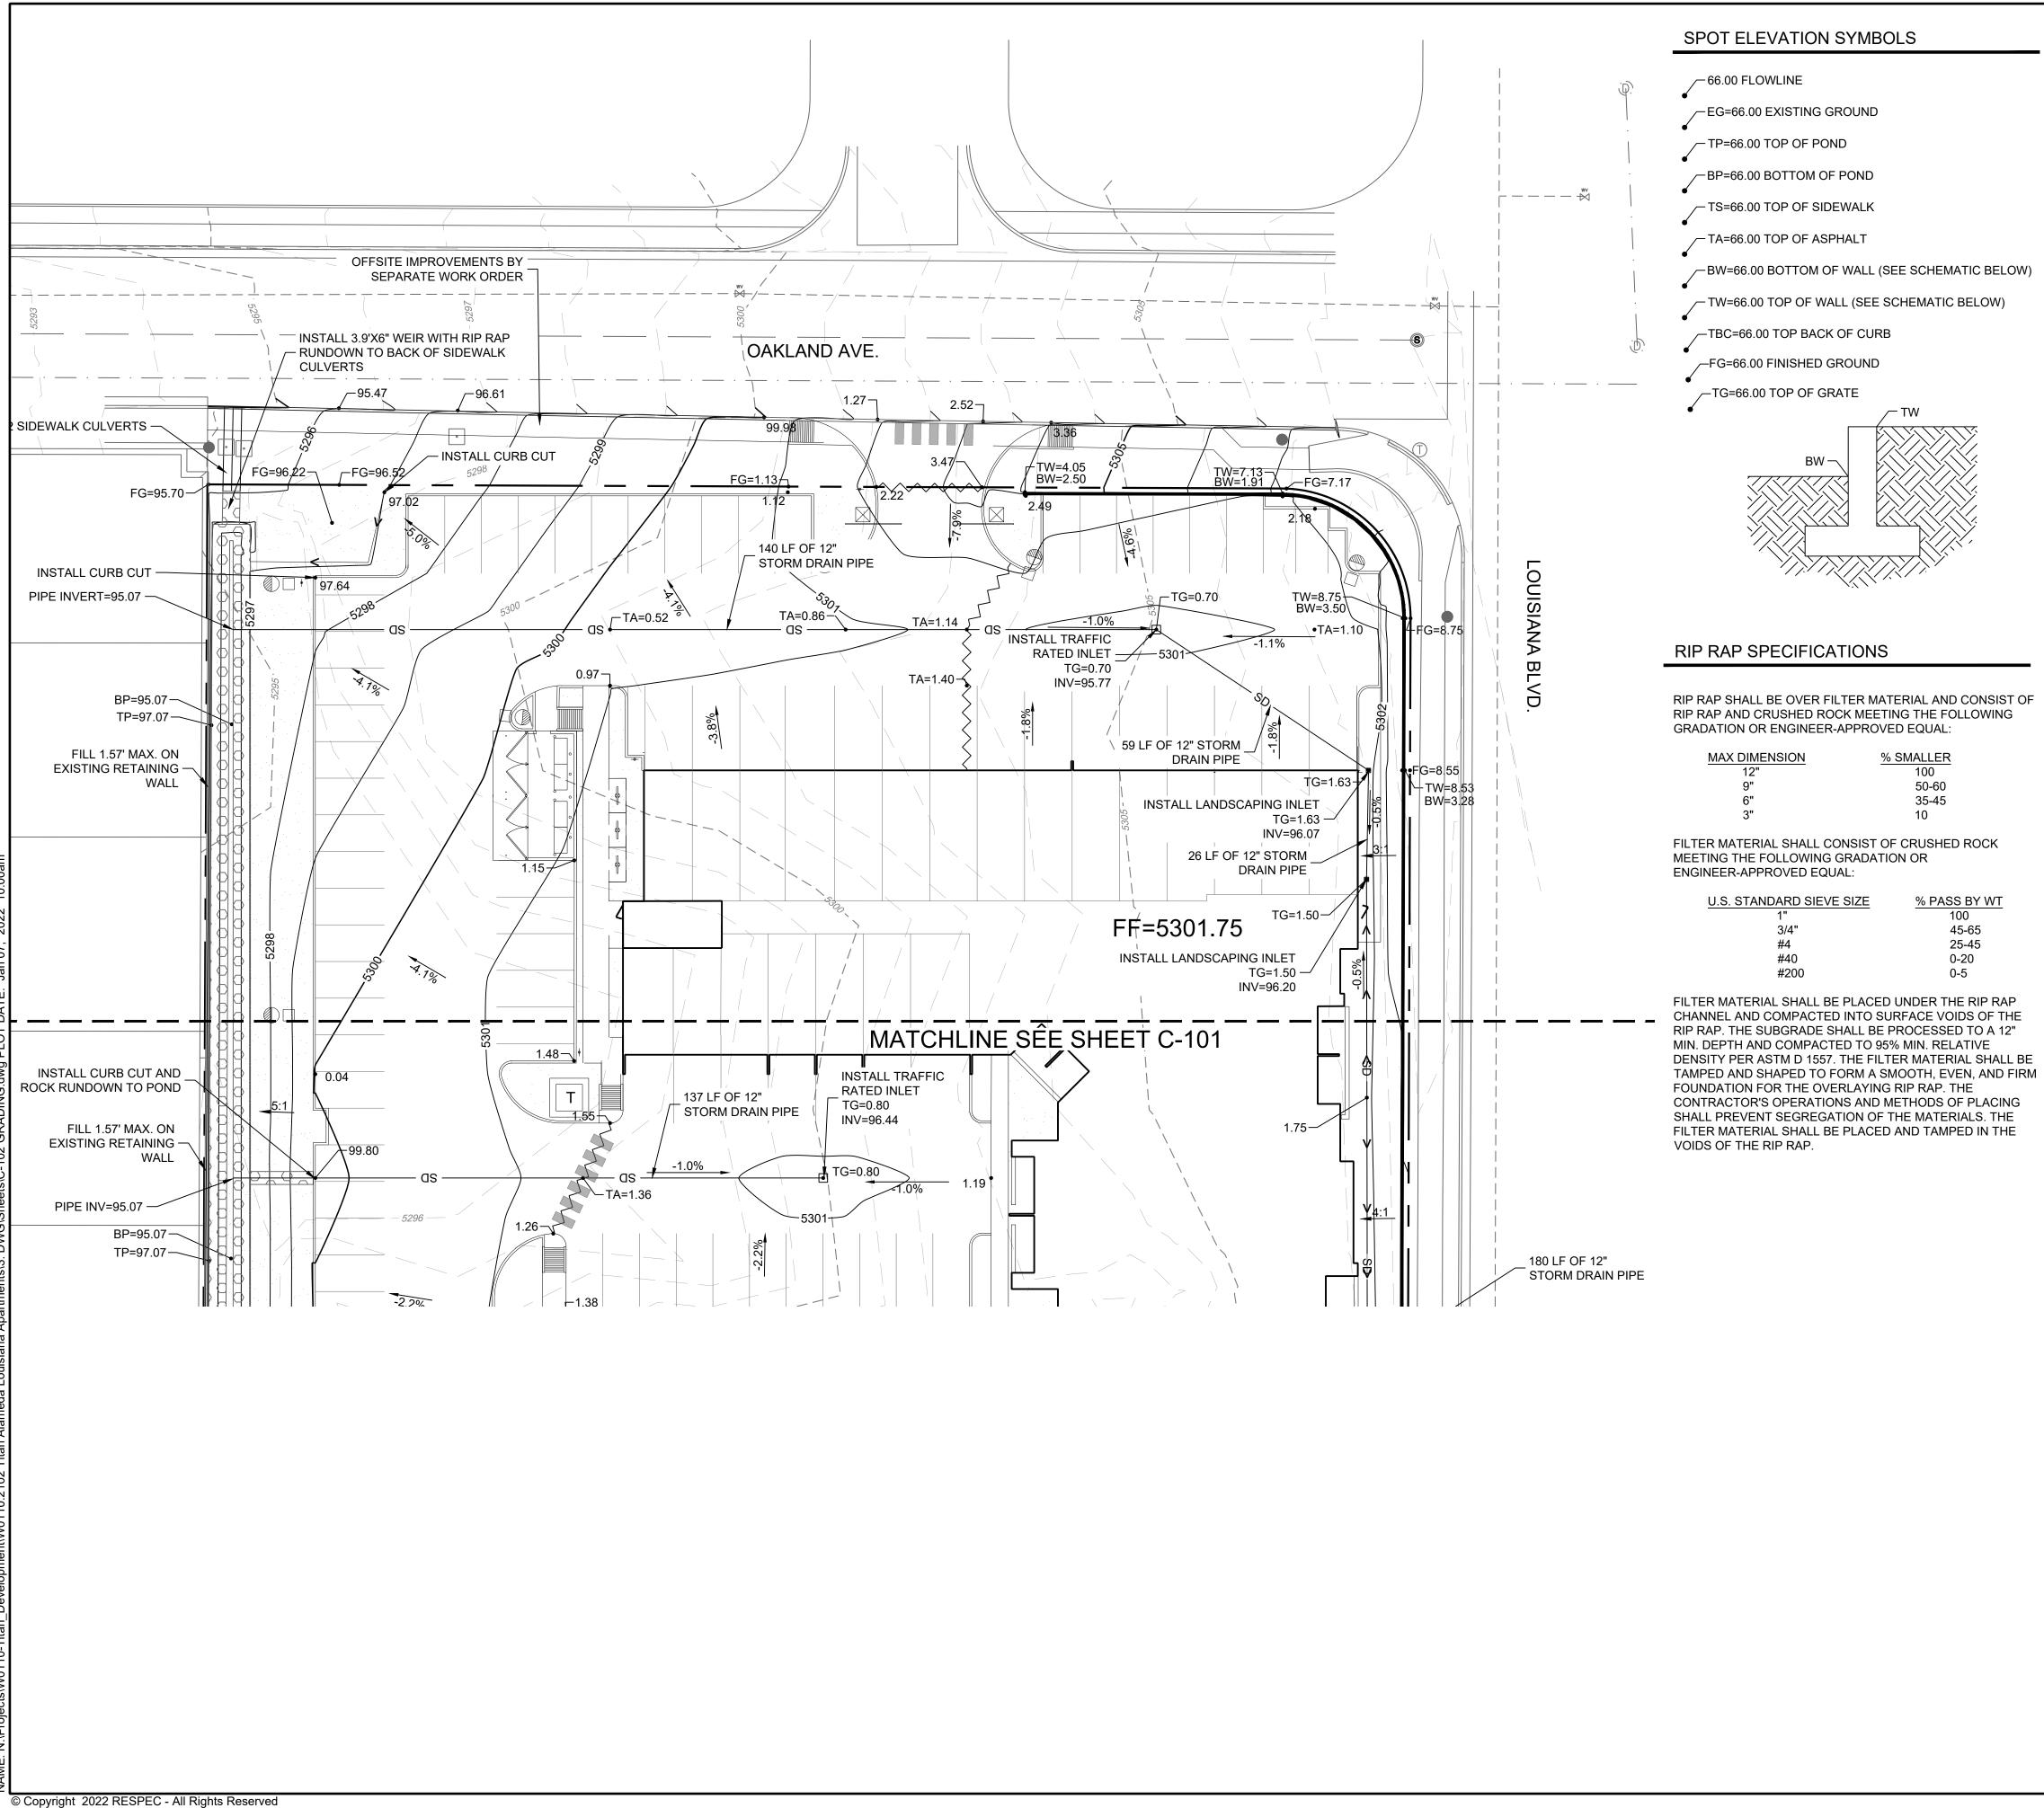

- <u>% SMALLER</u> 100 50-60 35-45 10

% PASS BY WT 100


45-65 25-45 0-20 0-5


					F
_	LEGEND				
•	— — — 5730— — — — — — 5728— — —	EXISTING PROPERTY LINE EXISTING MAJOR CONTOUR EXISTING MINOR CONTOUR	DESIGNED JMS DRAWN JMS CHECKED JL	1.07.2022	
	5730	PROPOSED MAJOR CONTOUR PROPOSED MINOR CONTOUR LIMITS OF DISTURBANCE	DESIGNEI DRAWN CHECKED	DATE	
		PROPOSED WATER BLOCK PROPOSED SWALE	et Suite 101 Mexico 87109	.9718	
		SLOPE ARROW PROPOSED RIP RAP PER SPEC	SPI on Stre	m 505.253.	
	0 SD	PROPOSED RETAINING WALL PROPOSED STEM WALL PROPOSED STORM DRAIN INLET PROPOSED STORM DRAIN	5971 Jefferso Albuquerque,	respec.com	
	∞	PROPOSED STORM DRAIN CLEANOUT		241	
G	RADING NOTES		STAMP		
1.	CONTRACTOR TO FIELD VE ELEVATION OF ALL EXISTIN PRIOR TO CONSTRUCTION ANY ISSUES. UTILITY RELO	IG DRY AND WET UTILITIES			
2.	PARKING LOT STRIPING AN	ID SITE PLAN HAVE BEEN			


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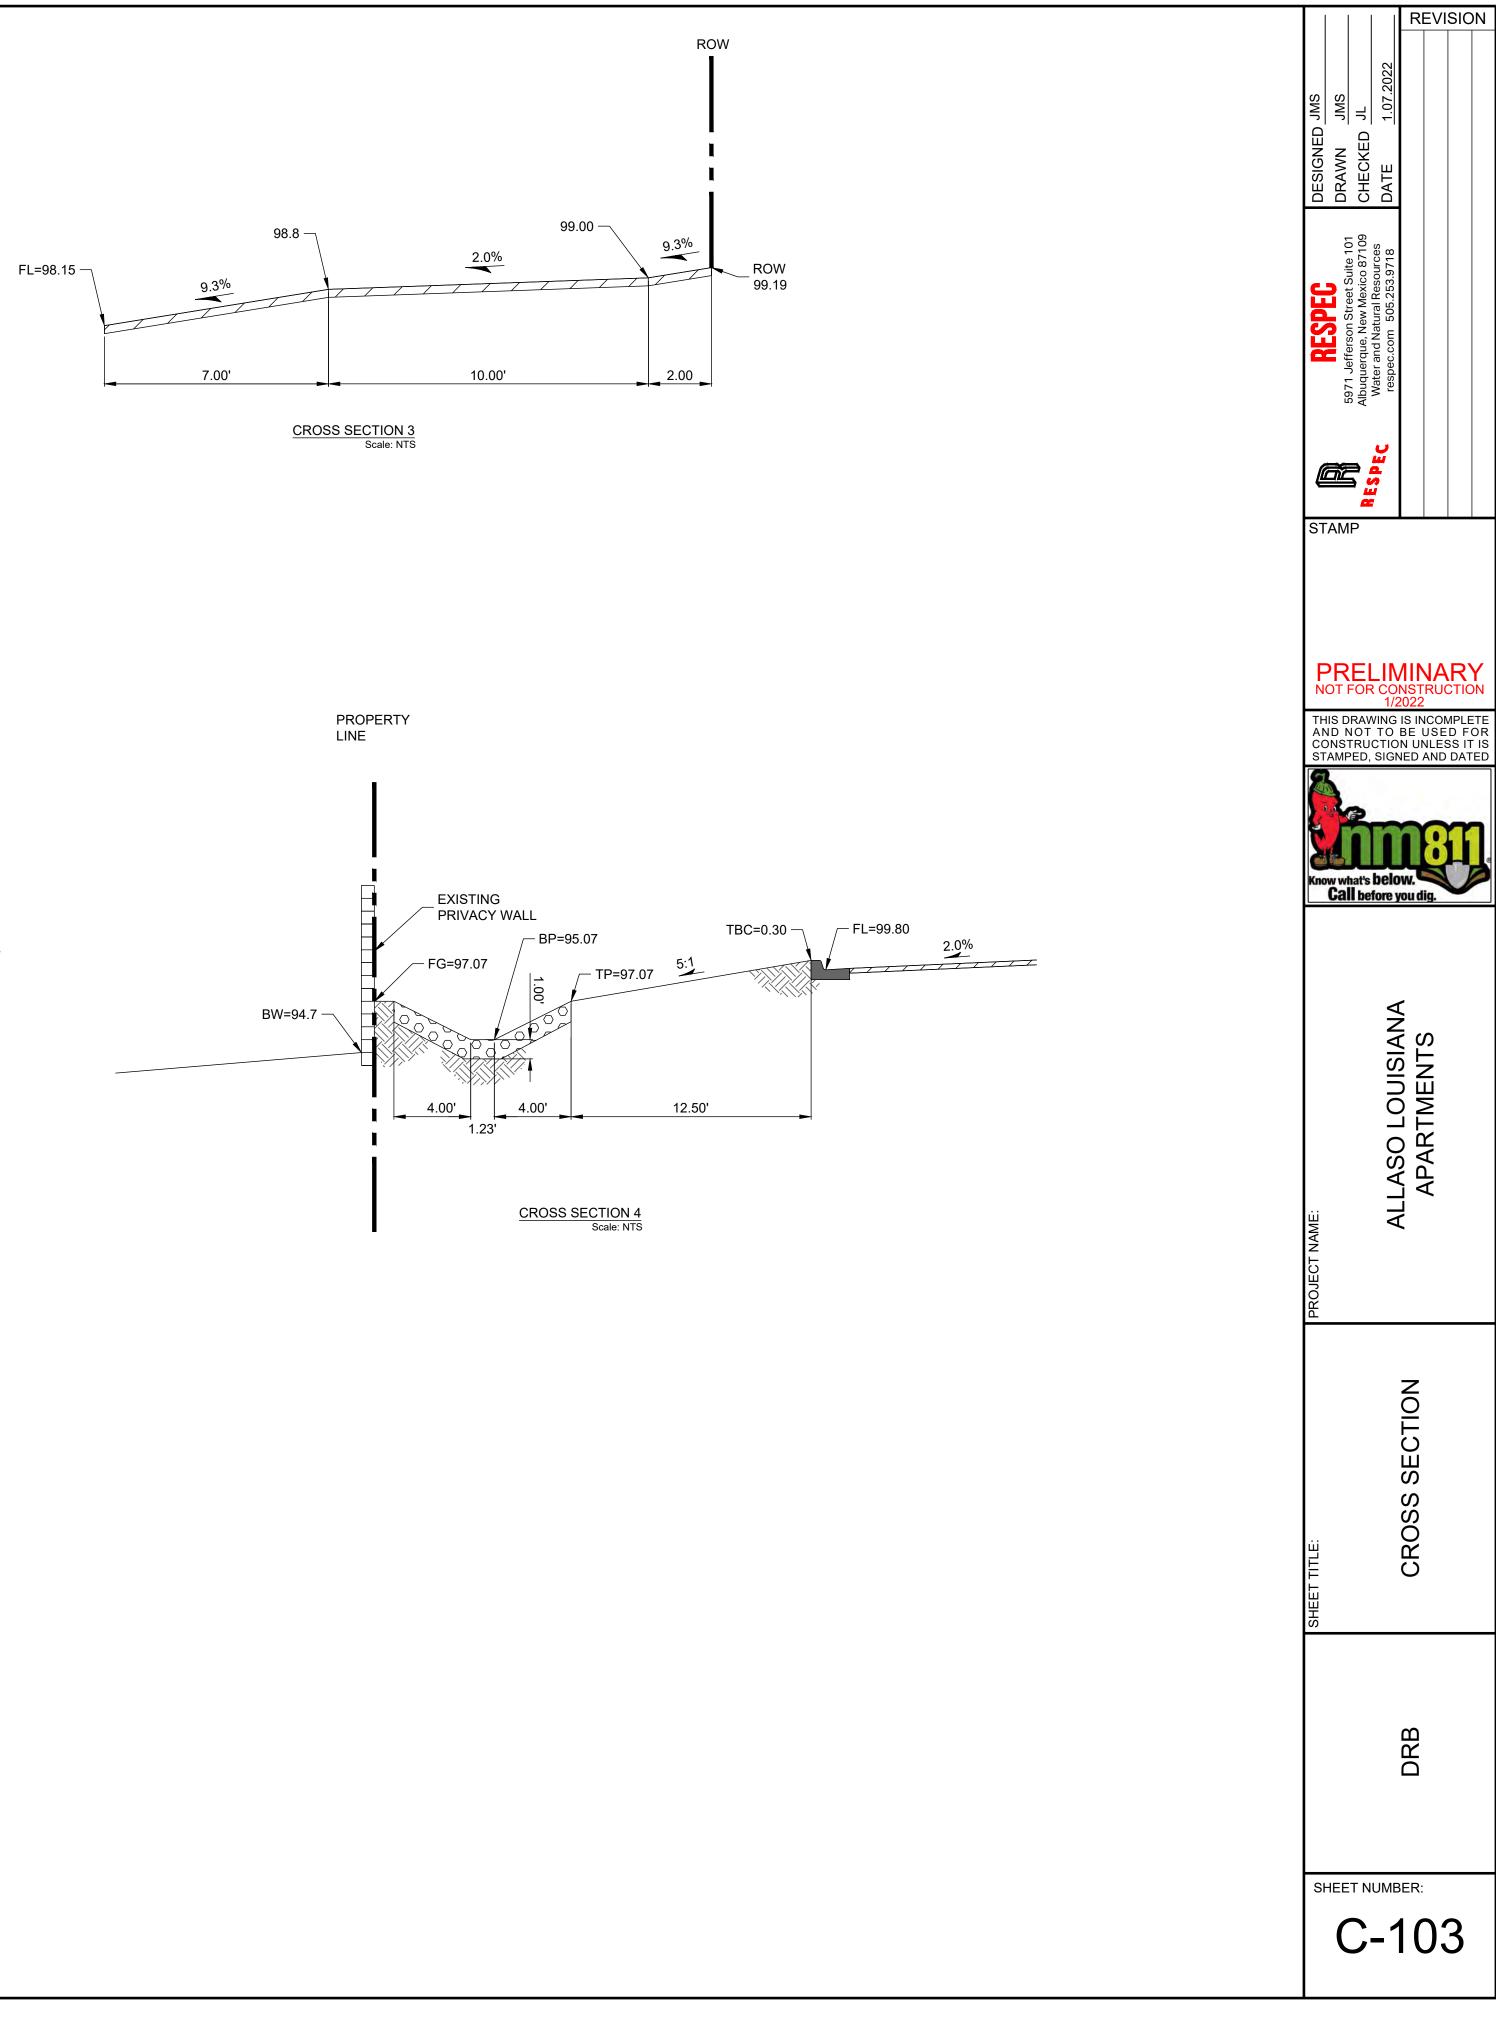
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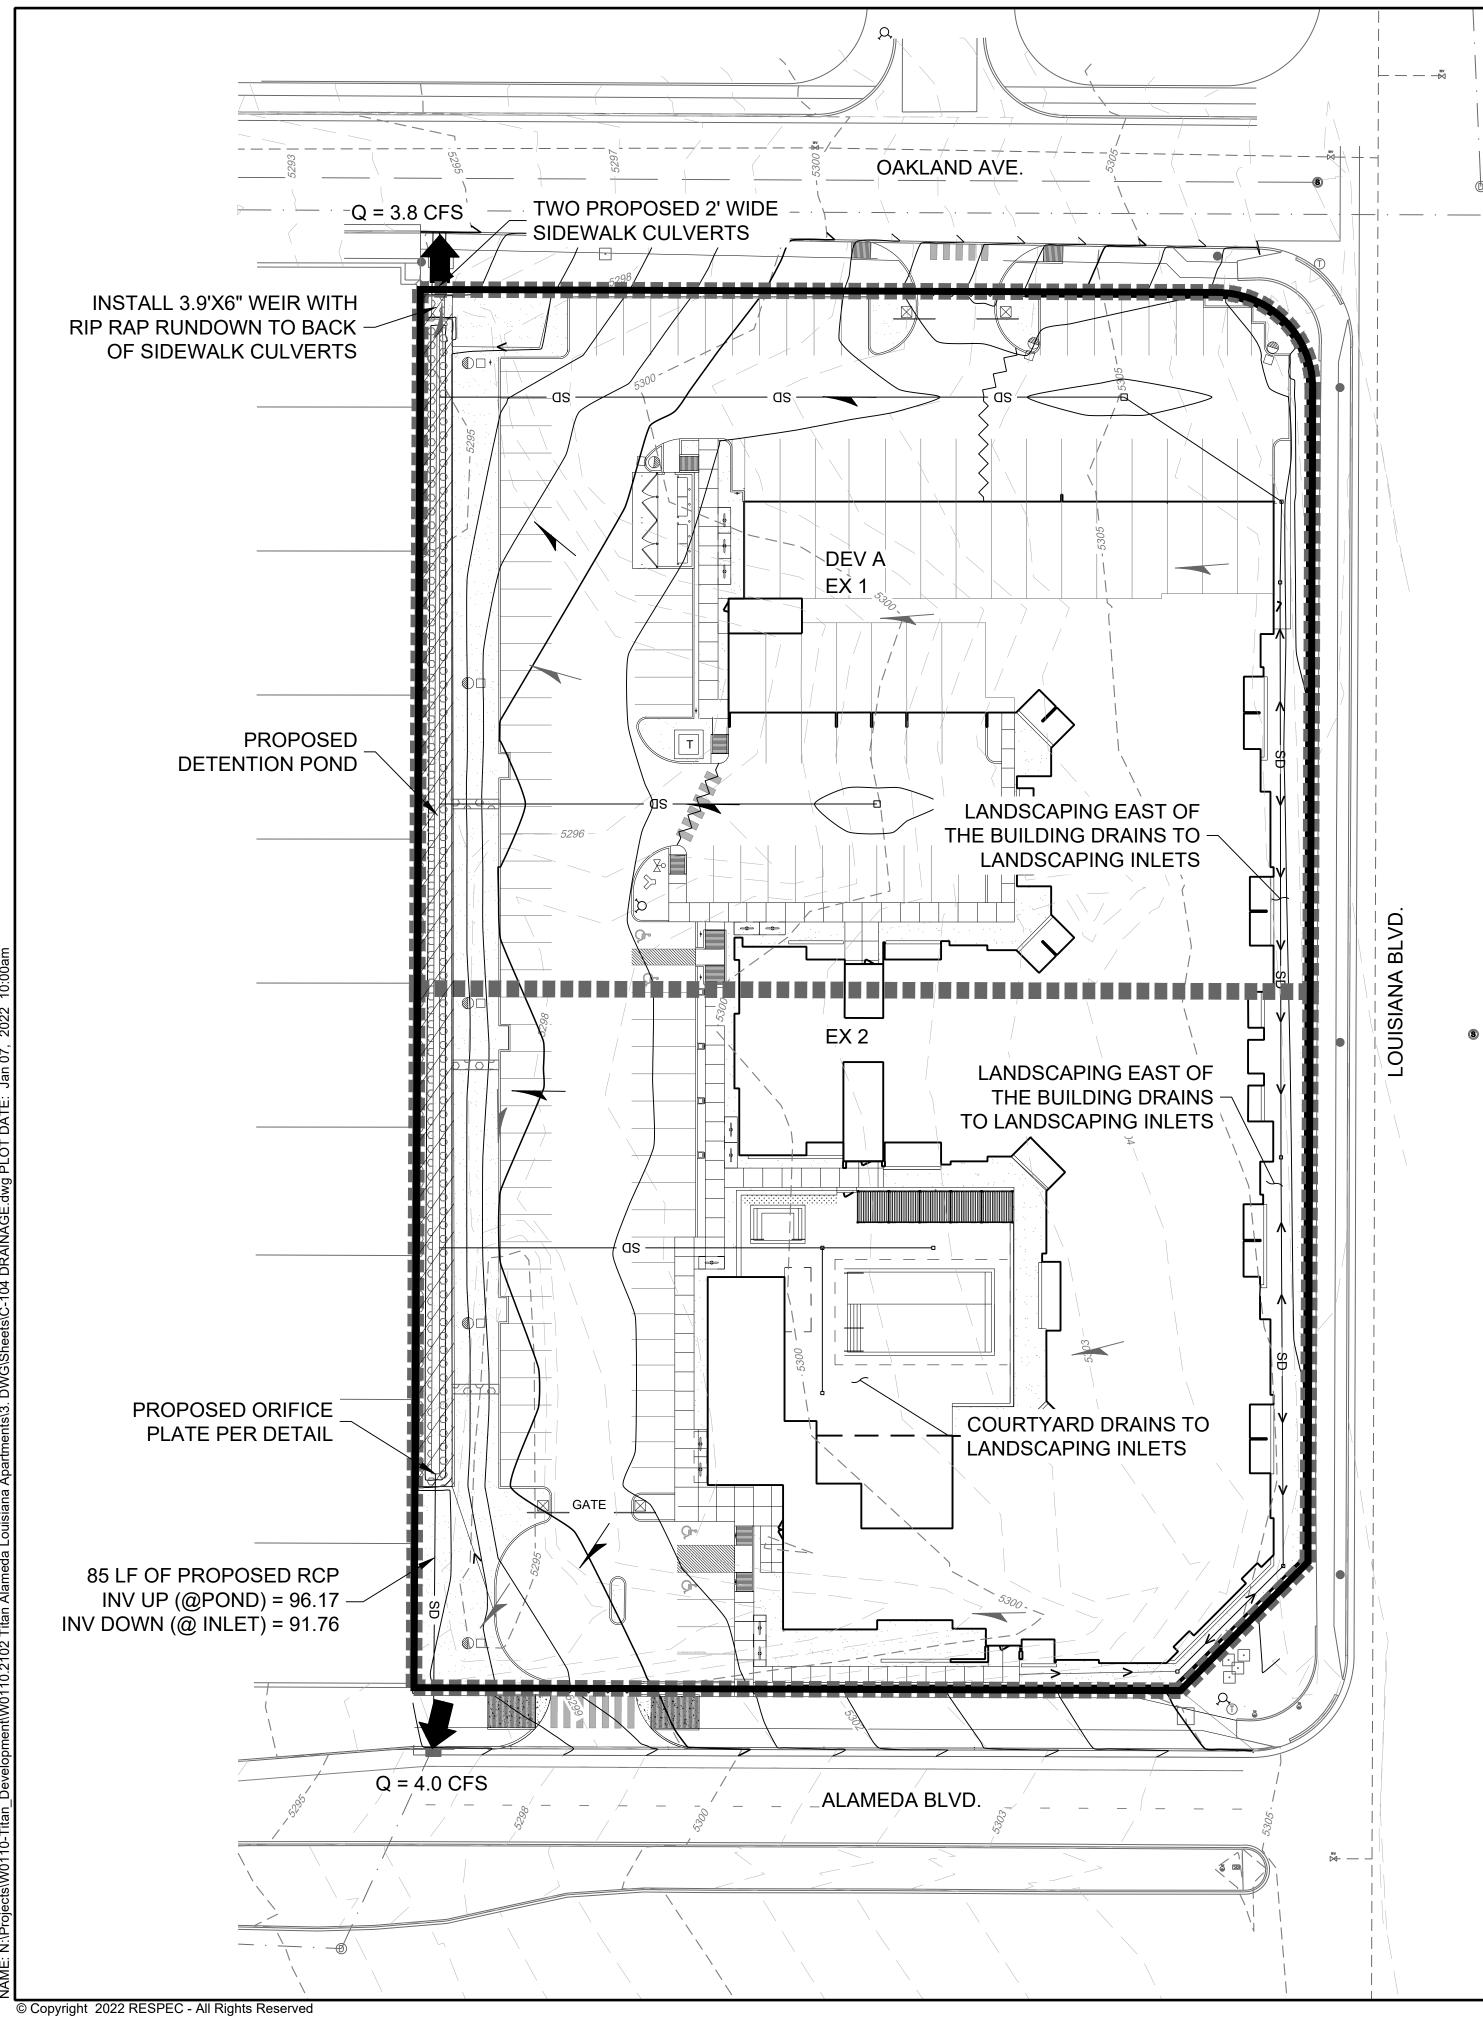
SCALE: 1" = 20'





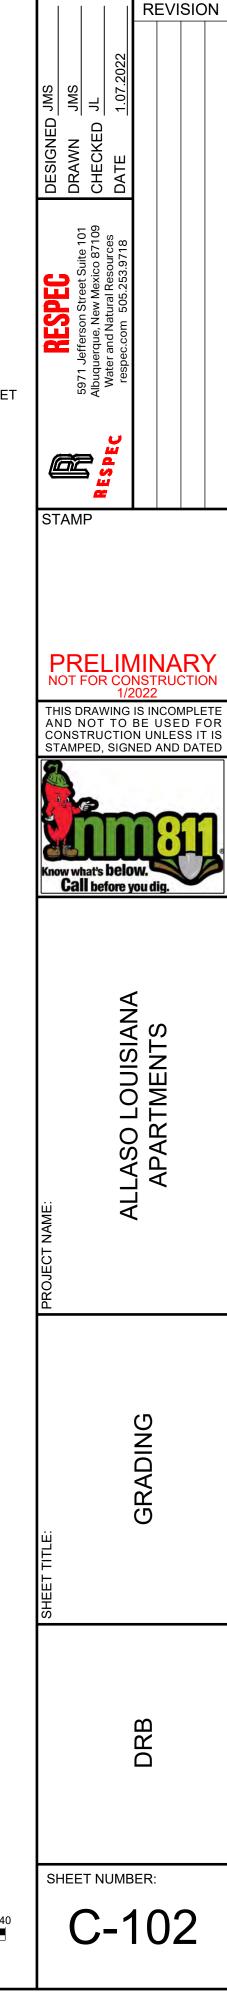

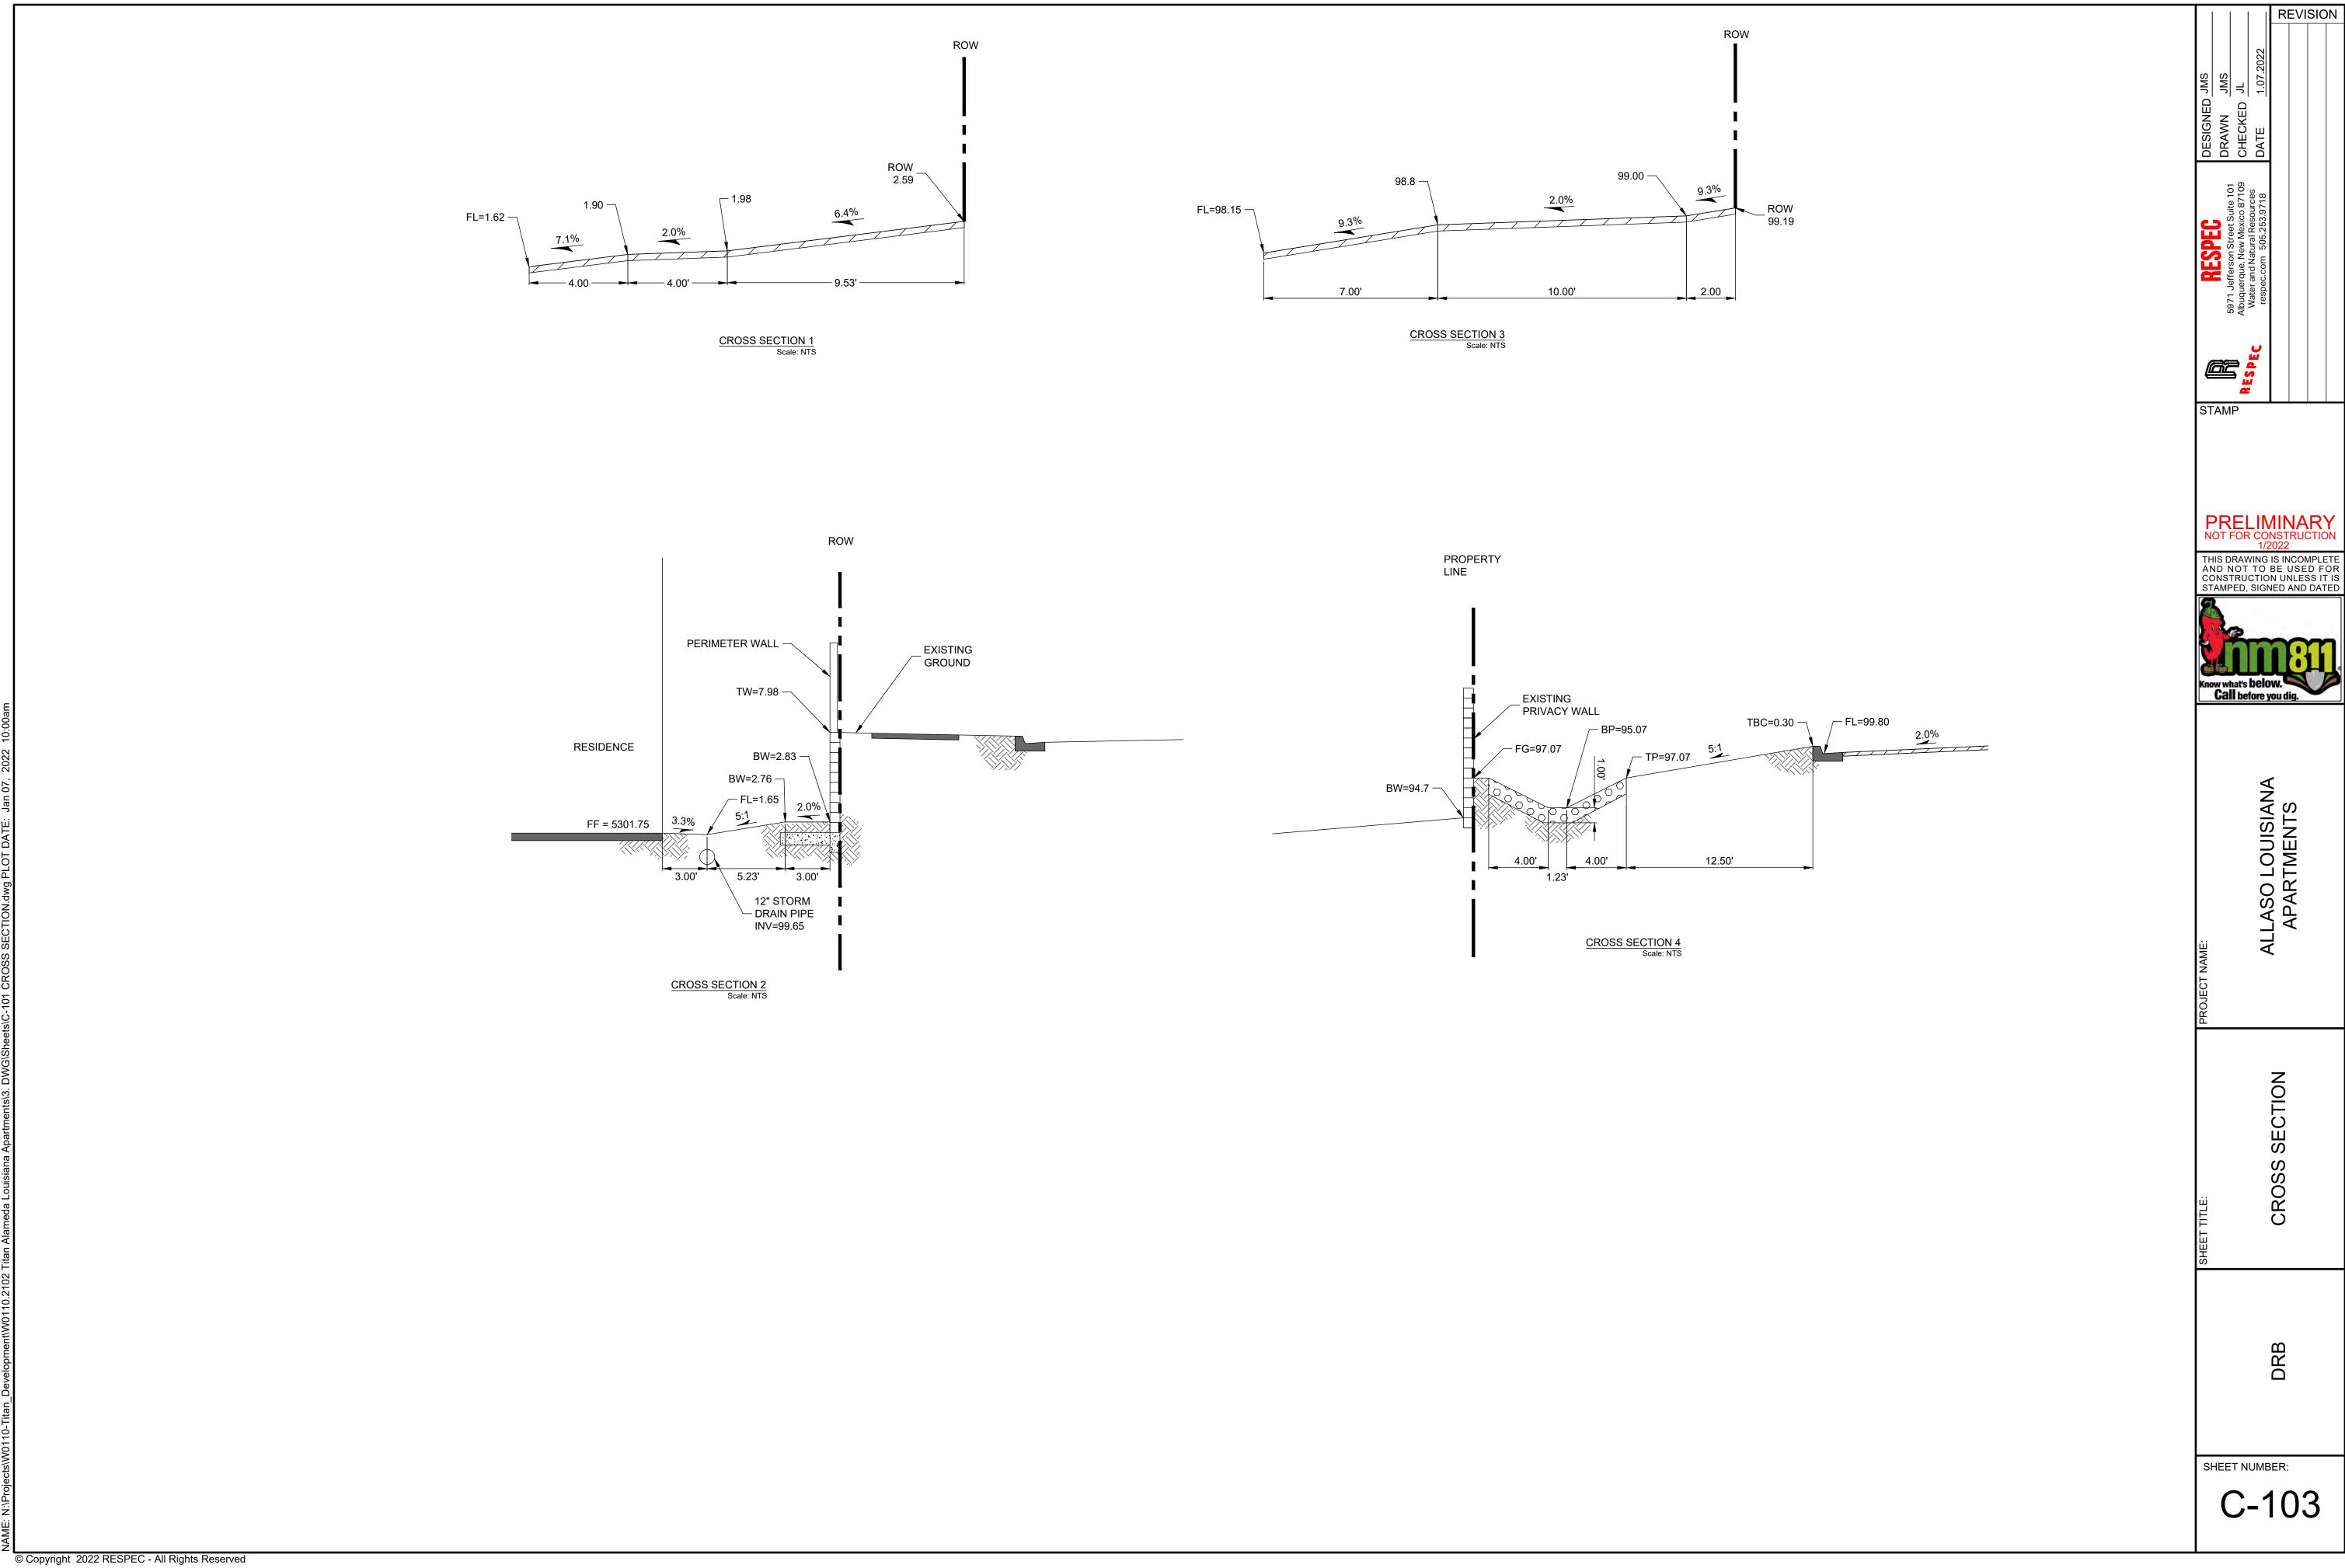

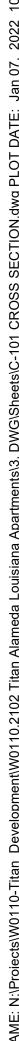

DRAINAGE SUMMARY

Background

Lots 15-18, Block 28, Tract A, Unit B, North Albuquerque Acres are located at the northwest corner of Alameda Blvd. and Louisiana Blvd. in Albuquerque, New Mexico, and contain approximately 2.78 acres. The site is currently undeveloped and does not appear to receive offsite flows.

The proposed development is an approximately 108-unit apartment complex containing 1 building, an asphalt paved parking lot, and landscaping areas. The drainage intent under developed conditions is to reduce the developed stormwater discharge to below the levels specified in the approved "North Albuquerque Acres Master Drainage Plan" (Resource Technology, 1998).

Methodology

The assumptions and criteria including land treatment types and impervious areas as well as the hydrologic analysis for the site were performed in accordance with the city of Albuquerque Development Process Manual (DPM). AHYMO-S4 (April 2018) was used to develop peak flow rates for the 100-year 24-hour design storm in accordance with Section 6 of the DPM. Hydraulic calculations were performed per section 6 of the DPM.

Existing Conditions

The existing site is currently undeveloped with moderate vegetation and has mild slopes from east to west ranging from 0% to 15%. The existing flows appear to collect in small retention ponds and possibly against the privacy wall at the west property boundary and with eventual surface flow into Alameda Blvd to the south and Oakland Avenue to the north. The ponds do not appear to be sized to accommodate the 100-year 24-hour design storm. However, no signs of ponding against the west end retaining wall were visible at the time of site exploration.

The allowable discharge for the site is governed by the North Albuquerque Acres Master Drainage Plan (NAAMDP). Lots 15 and 16 (Basin EX 1) are within NAAMDP developed basin 117.2 while Lots 17-18 (Basin EX 2) are in developed basin 117.3. For developed basins 117.2 and 117.3, NAAMDP used land treatment percentages of 0% Type A, 34%, Type B, 16% Type C, and 50% Type D. These land treatments result in an allowable discharge of 4.6 cfs into Alameda Blvd and an additional 4.6 cfs into Oakland Blvd -- a total allowable discharge of 9.2 cfs for the site.

Proposed Conditions

In general, Basin DEV A will surface drain via sheet flow, concentrated gutter flows, and storm drain pipe towards the pond along the west portion of the site. Landscaping inlets will capture the flows on the east side of the building. All flows from the site will be directed into the pond. The pond will discharge to a stormdrain inlet in Alameda Blvd via an 18" reinforced concrete pipe with an orifice plate on the upstream end of the pipe. The pond will also discharge into Oakland Ave via a weir and two sidewalk culverts. The proposed stormwater discharge into Alameda Blvd and Oakland Ave is at or below the developed flows specified in the NAAMDP.

Water quality requirements will be met by payment in-lieu. Calculations for the payment in-lieu amount can be found on this sheet.

Hydrologic and hydraulic calculations can be found on this sheet.

DRAINAGE CALCULATIONS

AHYMO INPUT: ALLOW ABLE DISCHARGE (PER NAAMP)						
Subbasin Area (ac)			Treatment Typ	e Area (%)		
Subbasin	ibbasin Area (ac)	А	В	С	D	
EX 1	1.40	0.0%	34.0%	16.0%	50.0%	
EX2	1.38	0.0%	34.0%	16.0%	50.0%	

AHYMO INPUT: PROPOSED CONDITIONS

Subbasin Area (ac)		Treatment Type Area (ac)				Treatment Type Area (%)			
Subbasin	Area (ac)	А	В	С	D	A	В	B C	D
DEV A	2.78	0.00	0.24	0.24	2.30	0.0%	8.6%	8.6%	82.8%

Subbasin	A (ac)	Q (cfs)	V (acft)	Q/A (cfs/ac)
EX 1	1.40	4.6	0.193	3.3
EX2	1.38	4.6	0.190	3.3

AHYMO OUTPUT: PROPOSED CONDITIONS

Subbasin	A (ac)	Q (cfs)	V (acft)	Q/A (cf
DEV A	2.78	10.8	0.512	3.9
DEV A (ROUTED)	2.78	7.8	0.512	2.8

DRAINAGE SUMMARY					
Subbasin	Allowable (cfs)	Provided (cfs)			
DEV A (ROUTED)	9.2	7.8			

Pond									
Elev.	Area (Sq. Ft.)	Vol (Cu. Ft.)	Cum. (Cu. Ft.)	Cum. (Ac. Ft.)	Orfice Outflow into Alameda Blvd (cfs)	Weir Outflow into Oakland Blvd (cfs)	Cum Outflow (cfs)		
0.0	839	0	0	0.000	0.0	0	0.0		
0.5	1562	600	600	0.014	1.4	0	1.4		
1.0	2294	964	1564	0.036	2.7	0	2.7		
1.5	3034	1332	2896	0.066	3.8	0	3.8		
2.0	3781	1704	4600	0.106	4.6	4.6	9.2		

WATER QUALITY PONDING, DEV A

Area (ac)	% Imp.	lmp. Area (ac)	WQ Depth (in)	Required WQ Vol (cu ft)	Provided WQ Vol (cu ft)
2.78	82.8%	2.30	0.42	3507	0

PAYMENT IN-LIEU AMOUNT IS: 3,507 CF X \$8/CF = \$28,056

LEGEND

----- PROPERTY LINE

---- 5380 ---- EX CONTOUR MAJOR

---- 5379 ---- EX CONTOUR MINOR

EXISTING SUBBASIN PER NAAMDP

PROPOSED SUBBASIN

PROPOSED SWALE

LOCATION

EXISTING FLOW ARROW


PROPOSED FLOW ARROW

PROPOSED DISCHARGE


(cfs/ac) 3.9 2.8

Weir Flow Calcs: Pond Sp	oillway
$Q_w = 3.3P(h)^{1.5}$	11.5
P = Perimeter (ft)	3.90
h = Head (ft)	0.5
3.3 = coefficient of discharge	
Q _w = Capacity (cfs)	4.6

Ori	fice Flow Calcs: Pond Outfa	all Pipe
$Q_o = .6A\sqrt{2gh}$	Huffernanden er state	
A = Open are	a of grate (sq. ft)	0.785
g = 32.2 (ft/s2	32.2	
h = Hydraulic	head (ft)	
Q _o = Capacity	/ (cfs)	1
Pond Elev	Hydraulic Head (ft)	Capacity (cfs)
0.0	below orfice springline	0.0
0.5	orfice springline	1.4
1.0	0.5	2.7
1.5	1	3.8
2.0	1.5	4.6

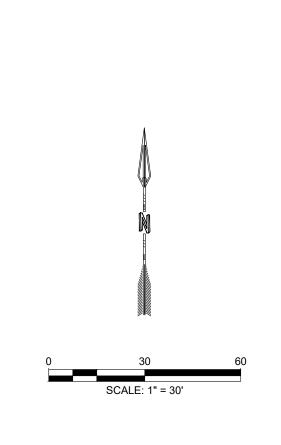

	REVISION
DESIGNED JMS DRAWN JMS CHECKED JL	DATE 1.07.2022
RESPEC 5971 Jefferson Street Suite 101 Albuquerque, New Mexico 87109	Water and Natural Resources respec.com 505.253.9718
STAMP	Э И desi
NOT FOR THIS DRAW AND NOT CONSTRUC STAMPED,	LIMINARY CONSTRUCTION 1/2022 VING IS INCOMPLETE TO BE USED FOR CTION UNLESS IT IS SIGNED AND DATED
PROJECT NAME:	ALLASO LOUISIANA APARTMENTS
SHEET TITLE:	DRAINAGE
	DRB
SHEET N	

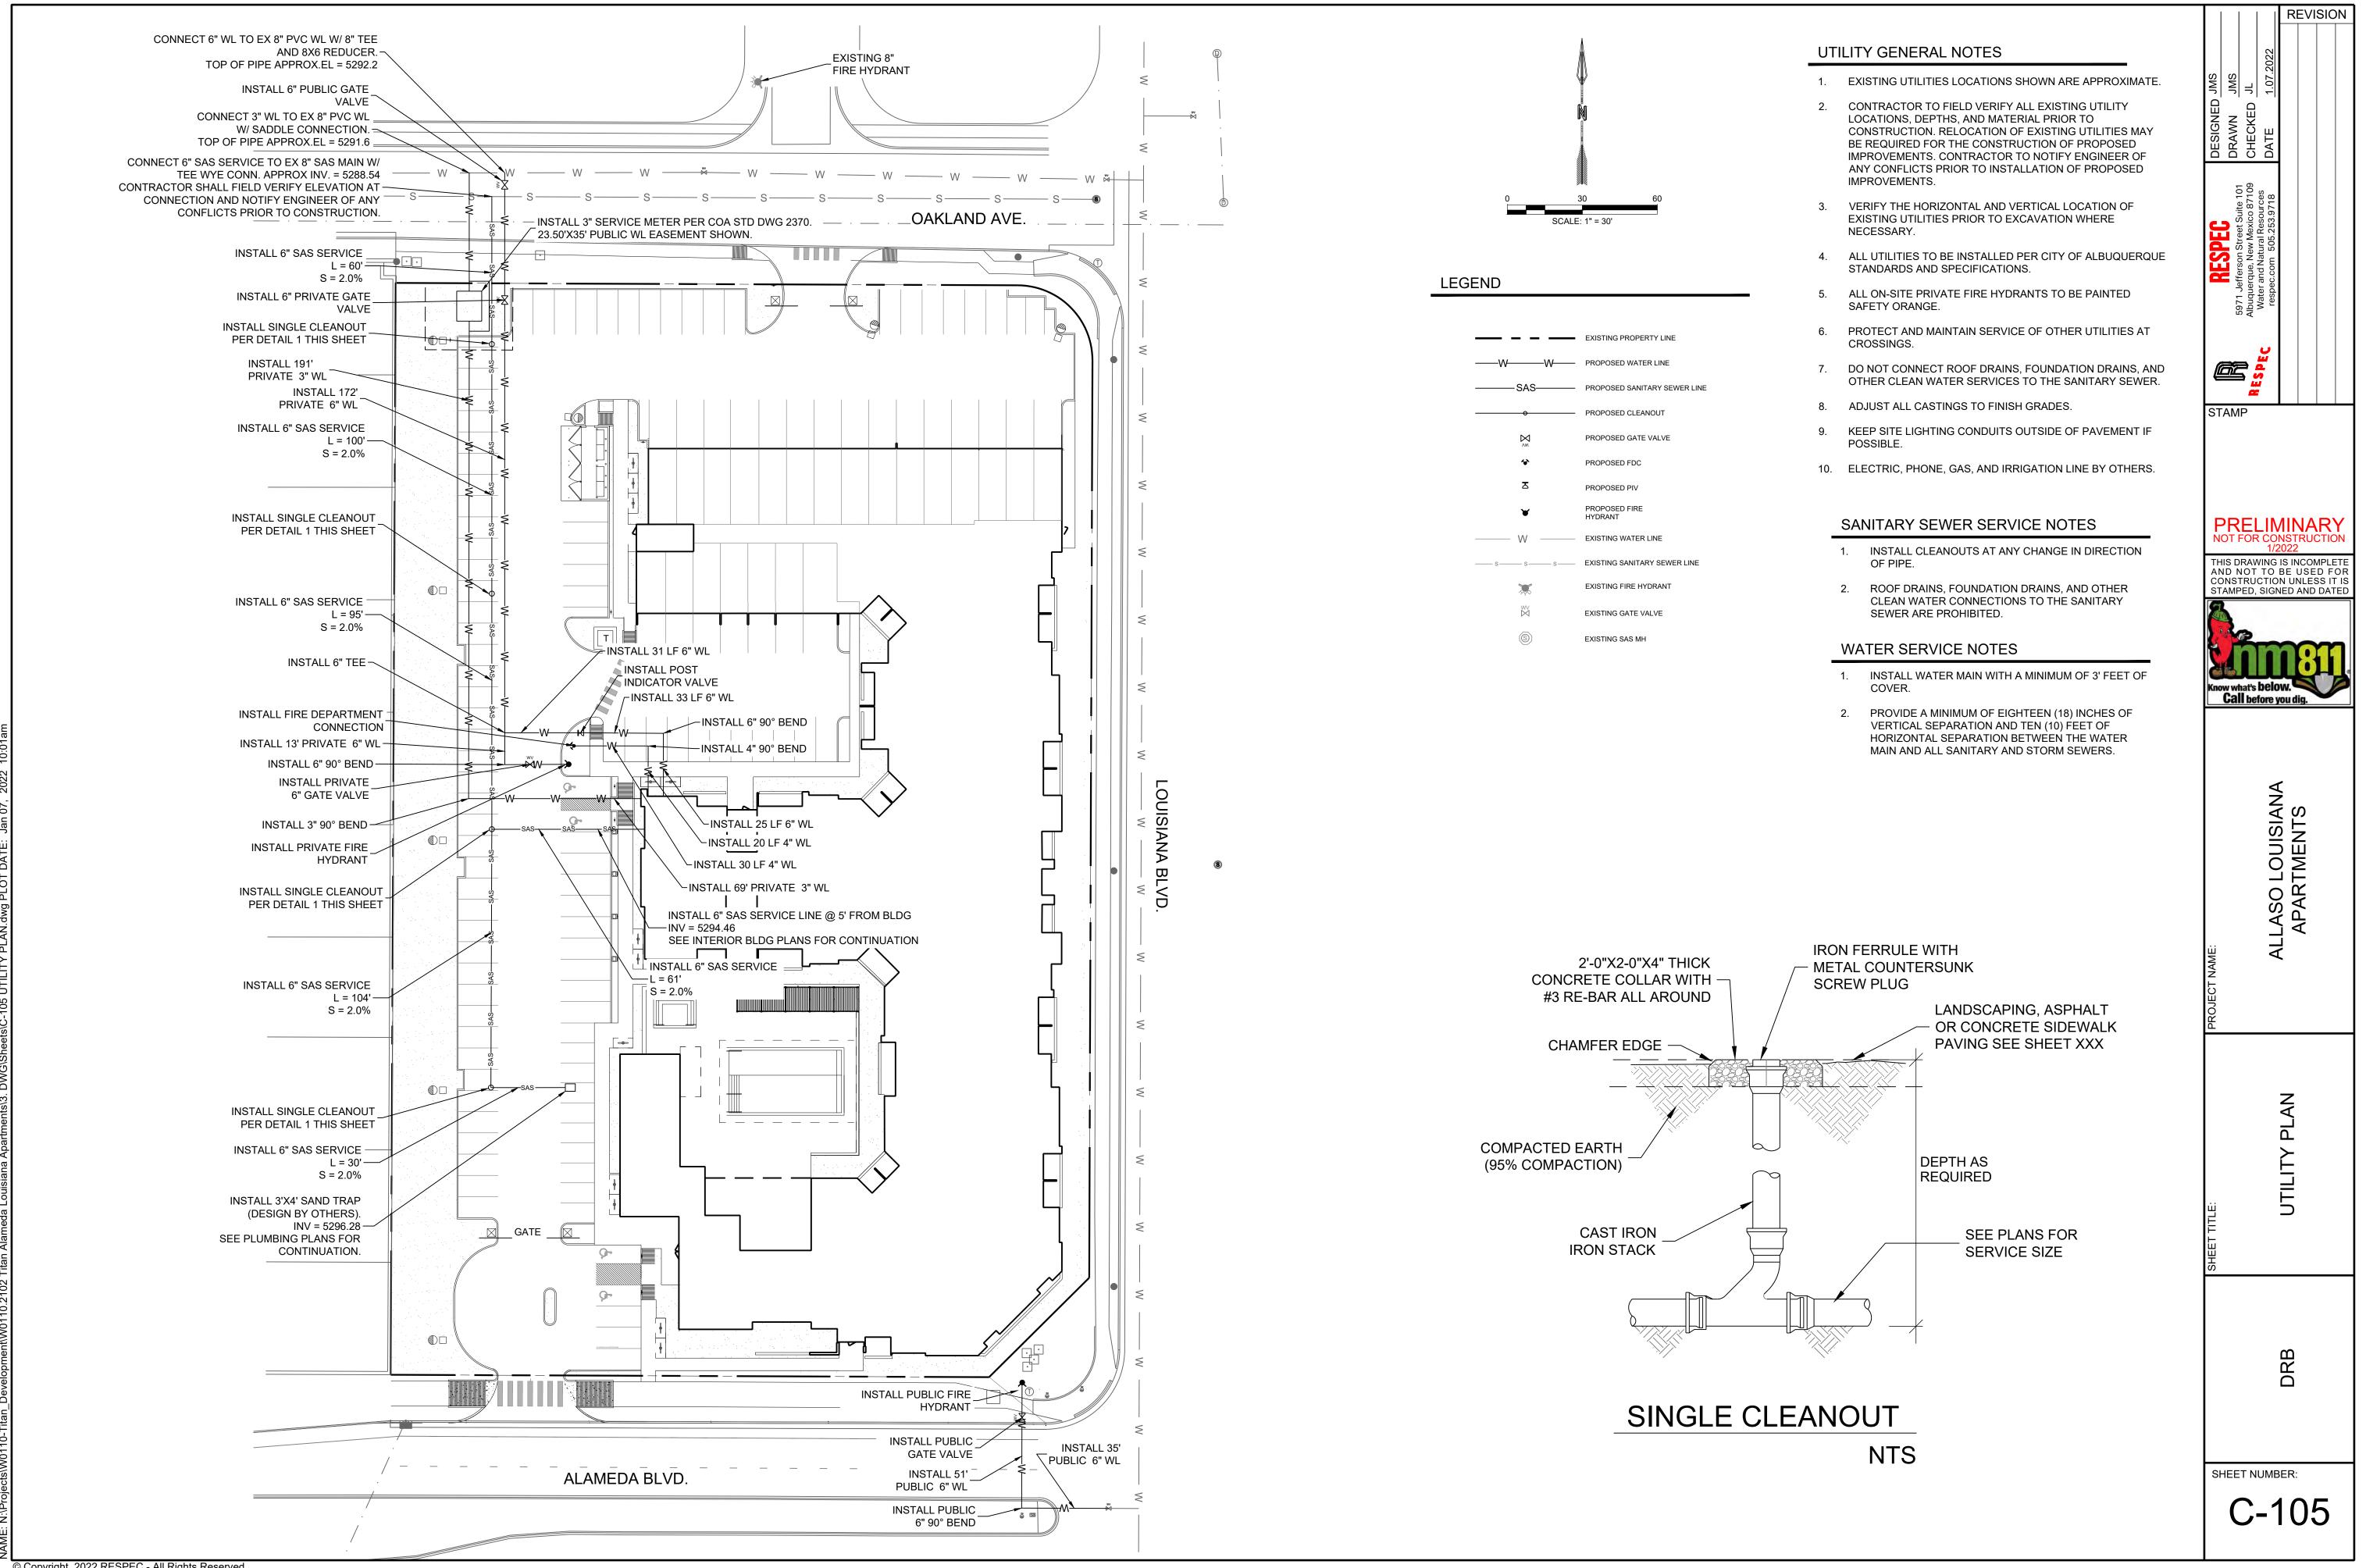

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- A. ALL ROOF MOUNTED MECHANICAL EQUIPMENT SHALL BE SCREENED BY PARAPET WALL AND NOT BE VISIBLE WHEN VIEWED FROM 5' ABOVE
- GRADE AT ANY PROPERTY LINE. B. ALL DIMENSIONS SHOWN ARE TO OUTSIDE FACE OF FINISH UNLESS
- OTHERWISE NOTED. C. BUILDING IDENTIFICATION SIGNAGE TO BE A MINIMUM OF 18" HIGH CHARACTERS WITH A MINIMUM OF 3" BRUSH STROKE WITH CONTRASTING
- ALUMINUM COLORS LIT FROM DUSK UNTIL DAWN AS WELL AS DAYLIGHT HOURS, PER 2009 IFC. MOUNT AT 15'-20' ABOVE FINISH FLOOR. D. ROOF DRAINAGE BY WAY OF EXTERNAL DOWNSPOUTS. E. IDO SECTION 5-11(D) MULTI-FAMILY RESIDENTIAL DEVELOPMENT IS MET IN
- THE FOLLOWING WAYS: 1. BUILDING ENTRANCES ARE EMPHASIZED BY CONTEMPORARY


ARCHITECTURAL OVERHANGS. 2A. THE FACADE DESIGN INCORPORATES ELEMENTS OF HUMAN SCALE BY INCORPORATING WINDOWS THAT MAKE UP 20% OF THE GROUND FLOOR OF STREET-FACING FACADES (SEE CALCULATIONS ON SOUTH AND EAST ELEVATIONS) AND ARE RECESSED 2 INCHES ON UPPER FLOORS. WINDOWS FACING WEST HAVE BEEN REDUCED IN SIZE TO REDUCE HEAT IMPACT OR ARE SHADED BY BALCONY STRUCTURE ABOVE OR INCORPORATE SUN SHADE DEVICES WHERE NEEDED.

2B. FACADE ARTICULATION IS ACHIEVED IN COMBINATION OF RECESSES AND PROJECTIONS EVERY 30 FEET MINIMUM (SEE DIMENSIONS ON ELEVATIONS FOR PLANE CHANGES), MORE THAN ONE FINISH MATERIAL OR COLOR IS USED ON EVERY FACADE (REFER TO EXTERIOR FINISH LEGEND INDICATING UP TO 6 COLOR AND MATERIAL SELECTIONS), BALCONIES ARE INCORPORATED AT EVERY DWELLING UNIT FOR VISUAL INTEREST. 3. FACADE LENGTH EXCEEDS 60 FEET, THEREFORE ROOFLINE EXTENDS FROM 36'-0" TO 38'-0" AT INTERVALS LESS THAN 60 FEET CONTINUOUSLY. 4. 5-11(D)4 - NOT APPLICABLE

SHEET KEYNOTES $\langle ? \rangle$

- 1. FIELD COLOR NEUTRAL WHITE STUCCO FINISH MATERIAL
- ACCENT COLOR/MATERIAL #1 DARK MASONRY VENEER 3. ACCENT COLOR/MATERIAL #2 - DARK GRAY - ACCENT FIBER CEMENT
- BOARD 4. ACCENT COLOR #3 - LIGHT WARM GRAY - ACCENT STUCCO FINISH
- 5. ACCENT COLOR #4 DARK WARM GRAY ACCENT STUCCO FINISH
- ACCEMT COLOR #5 DARKEST WARM GRAY ACCENT STUCCO FINISH FIBER CEMENT BOARD FACIA - DARK BRONZE
- 8. PREFINISHED METAL COPING COLOR TO MATCH ADJACENT MATERIAL OR
- STANDARD NEUTRAL COLOR GUARDRAIL - METAL CUSTOM FABRICATED - DARK BRONZE
- 10. BUILDING IDENTIFICATION SIGNAGE FOR WAYFINDING 11. RESIDENTIAL WINDOWS - FRAME COLOR: DARK BRONZE
- 12. GARAGE OVERHEAD DOOR 13. NOT USED
- 14. NOT USED
- 15. STEEL COLUMN PAINTED 16. GLAZED PATIO DOOR
- **17. ALUMINUM STOREFRONT**
- 18. METAL UNIT ENTRY DOOR 19. PREFINISHED METAL COPING - DARK BRONZE



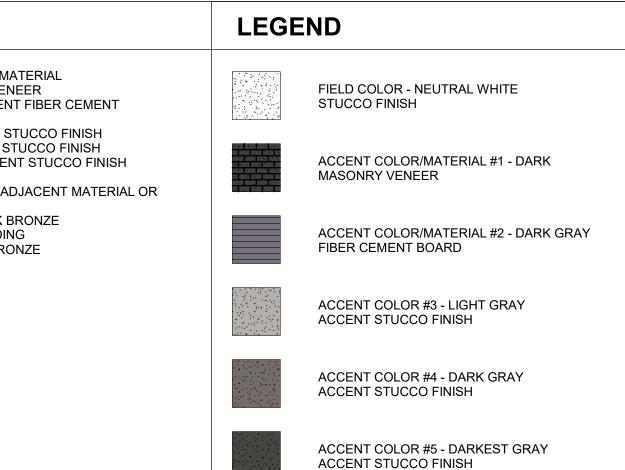

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REVIEWED BY

VM, PMG, AG DM, HFG 11/12/2021

DRAWN BY

PROJECT NO:

DRAWING NAME

SHEET NO


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ELEVATIONS

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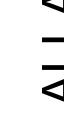







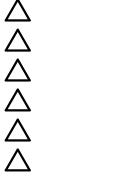

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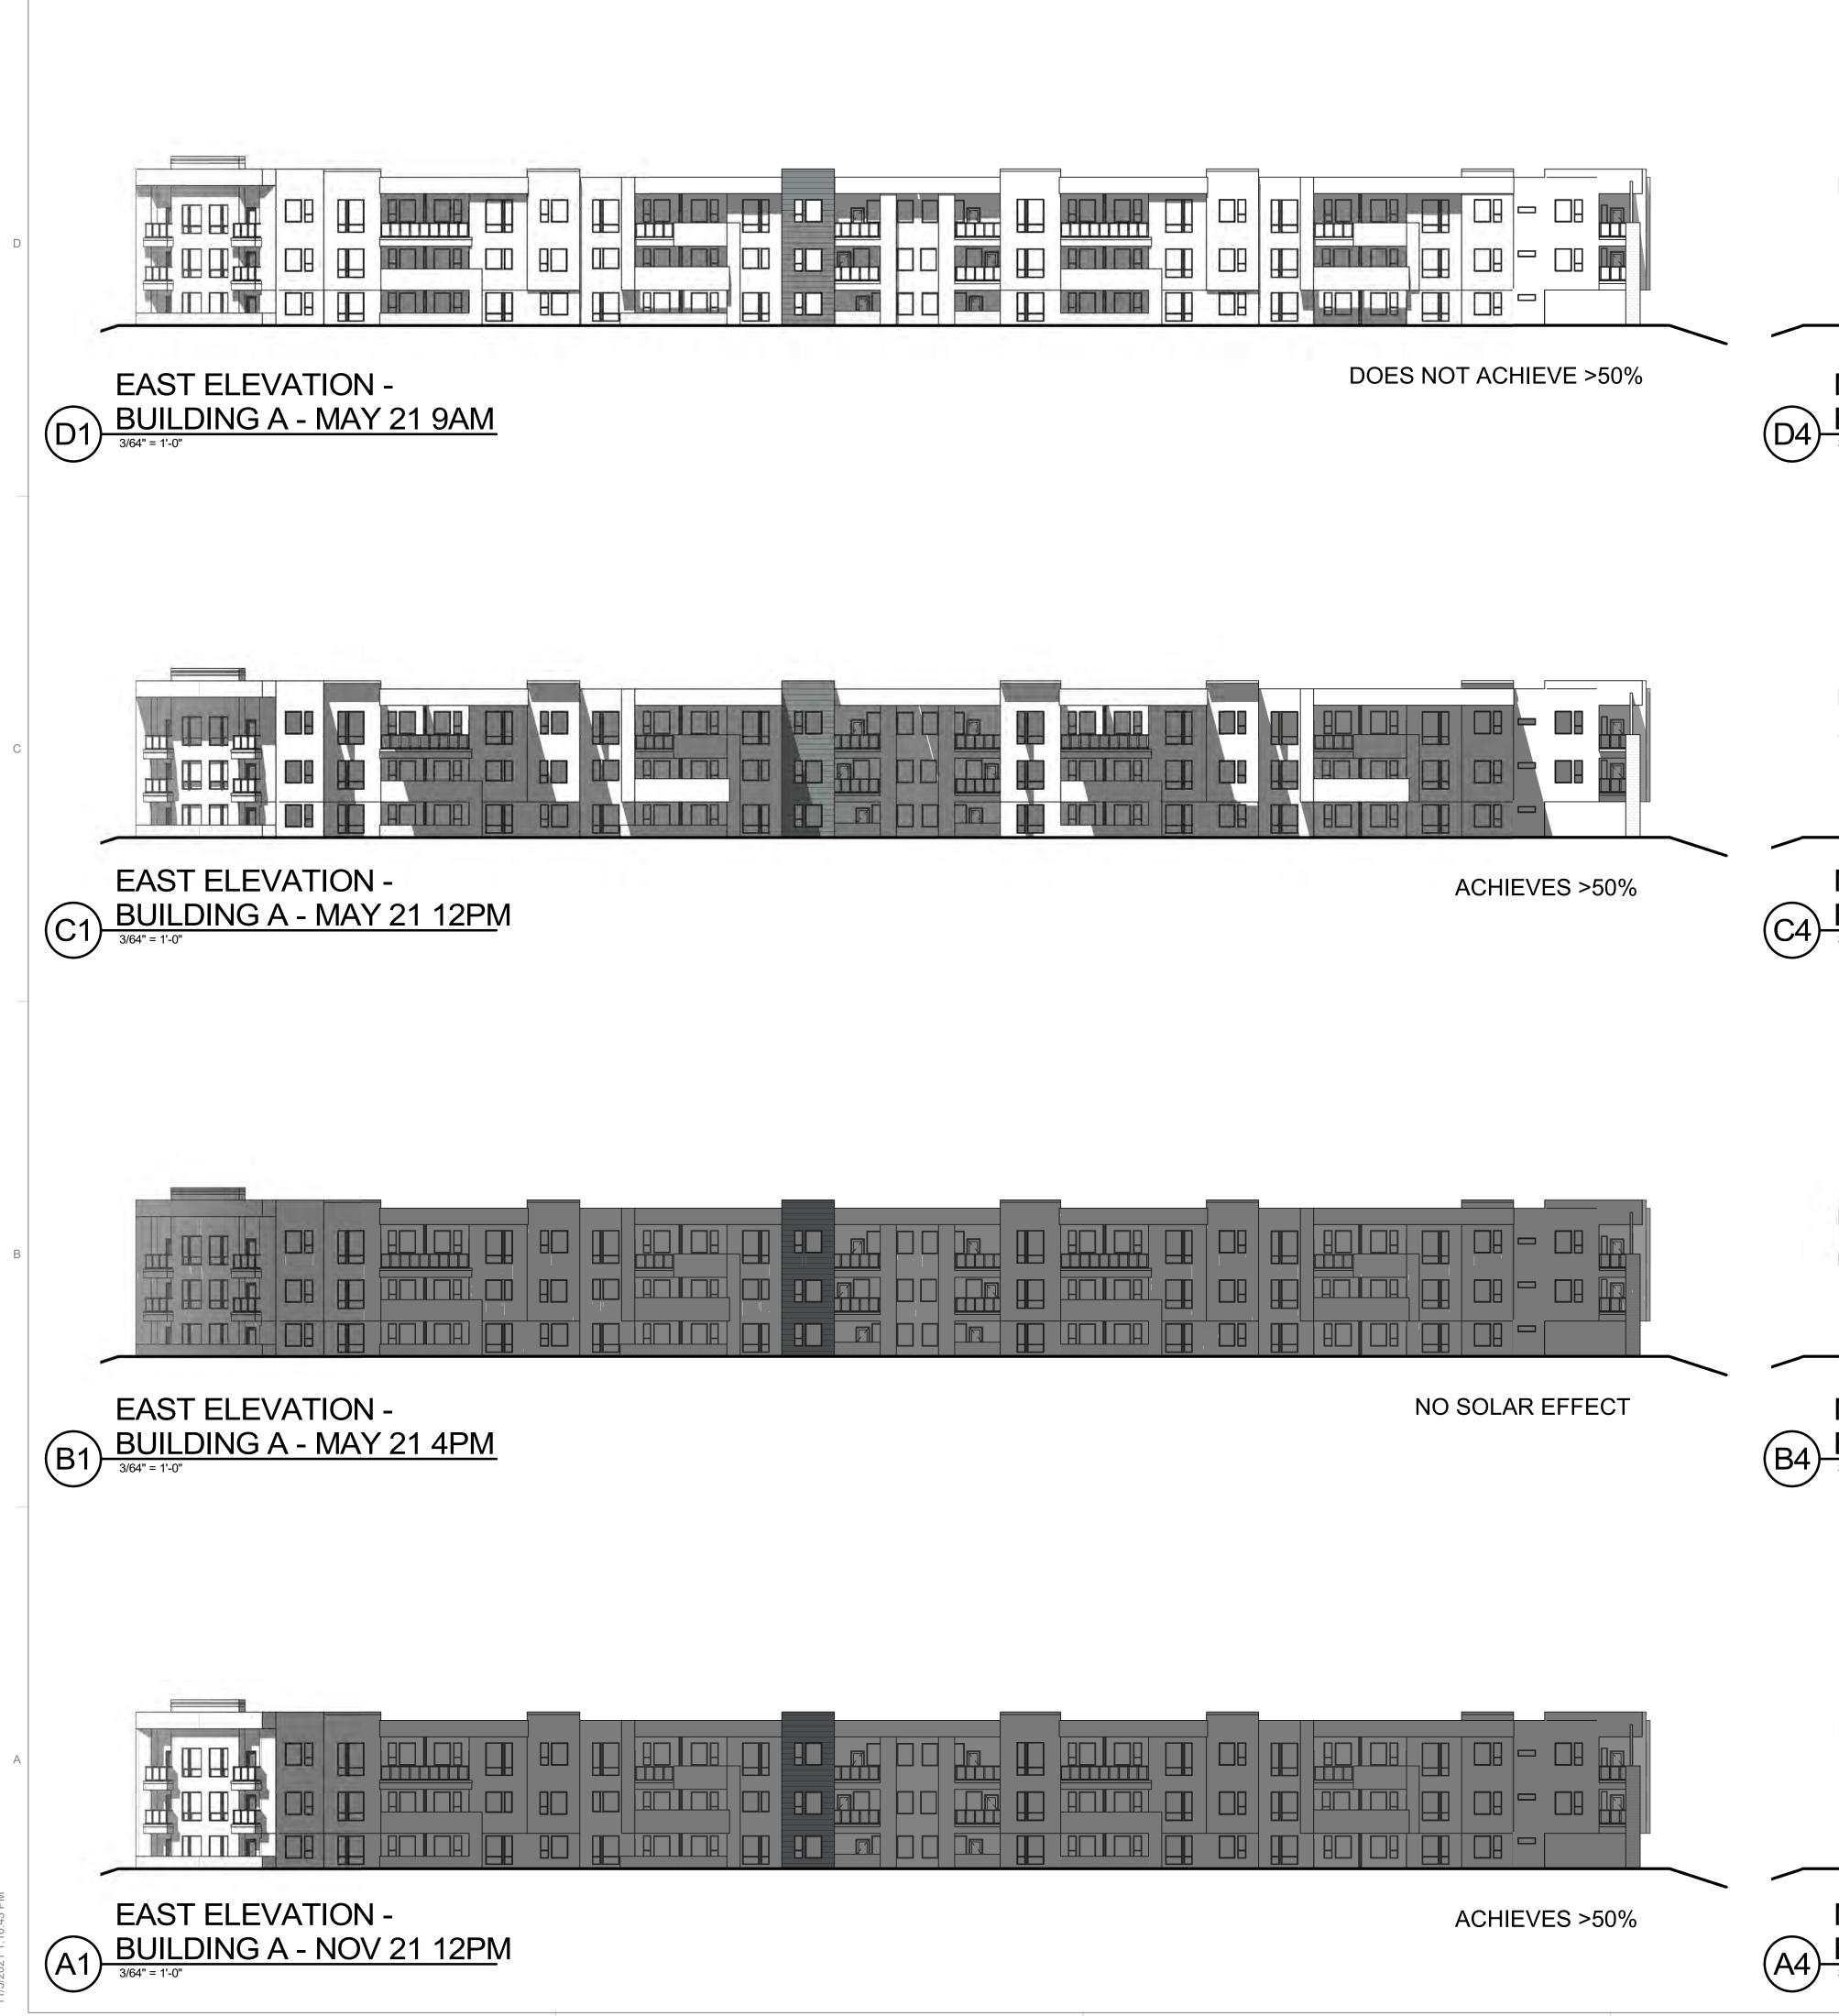




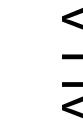








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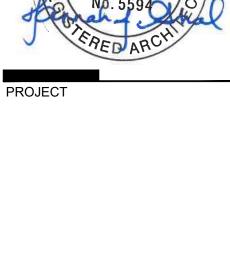
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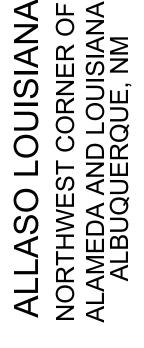


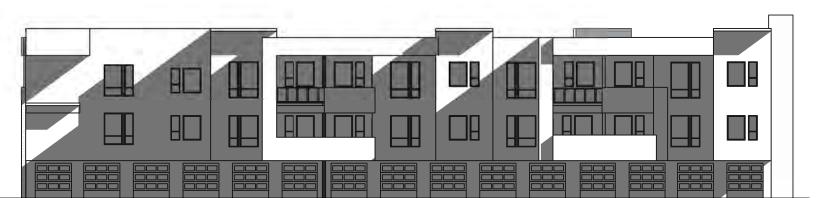

NO SOLAR EFFECT



SEAL









NORTH ELEVATION -BUILDING A - NOV 21 12PM

NO SOLAR EFFECT

5

DRAWING NAME SUN SHADE ANALYSIS

VM

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11/12/2021

21-1013

REVISIONS

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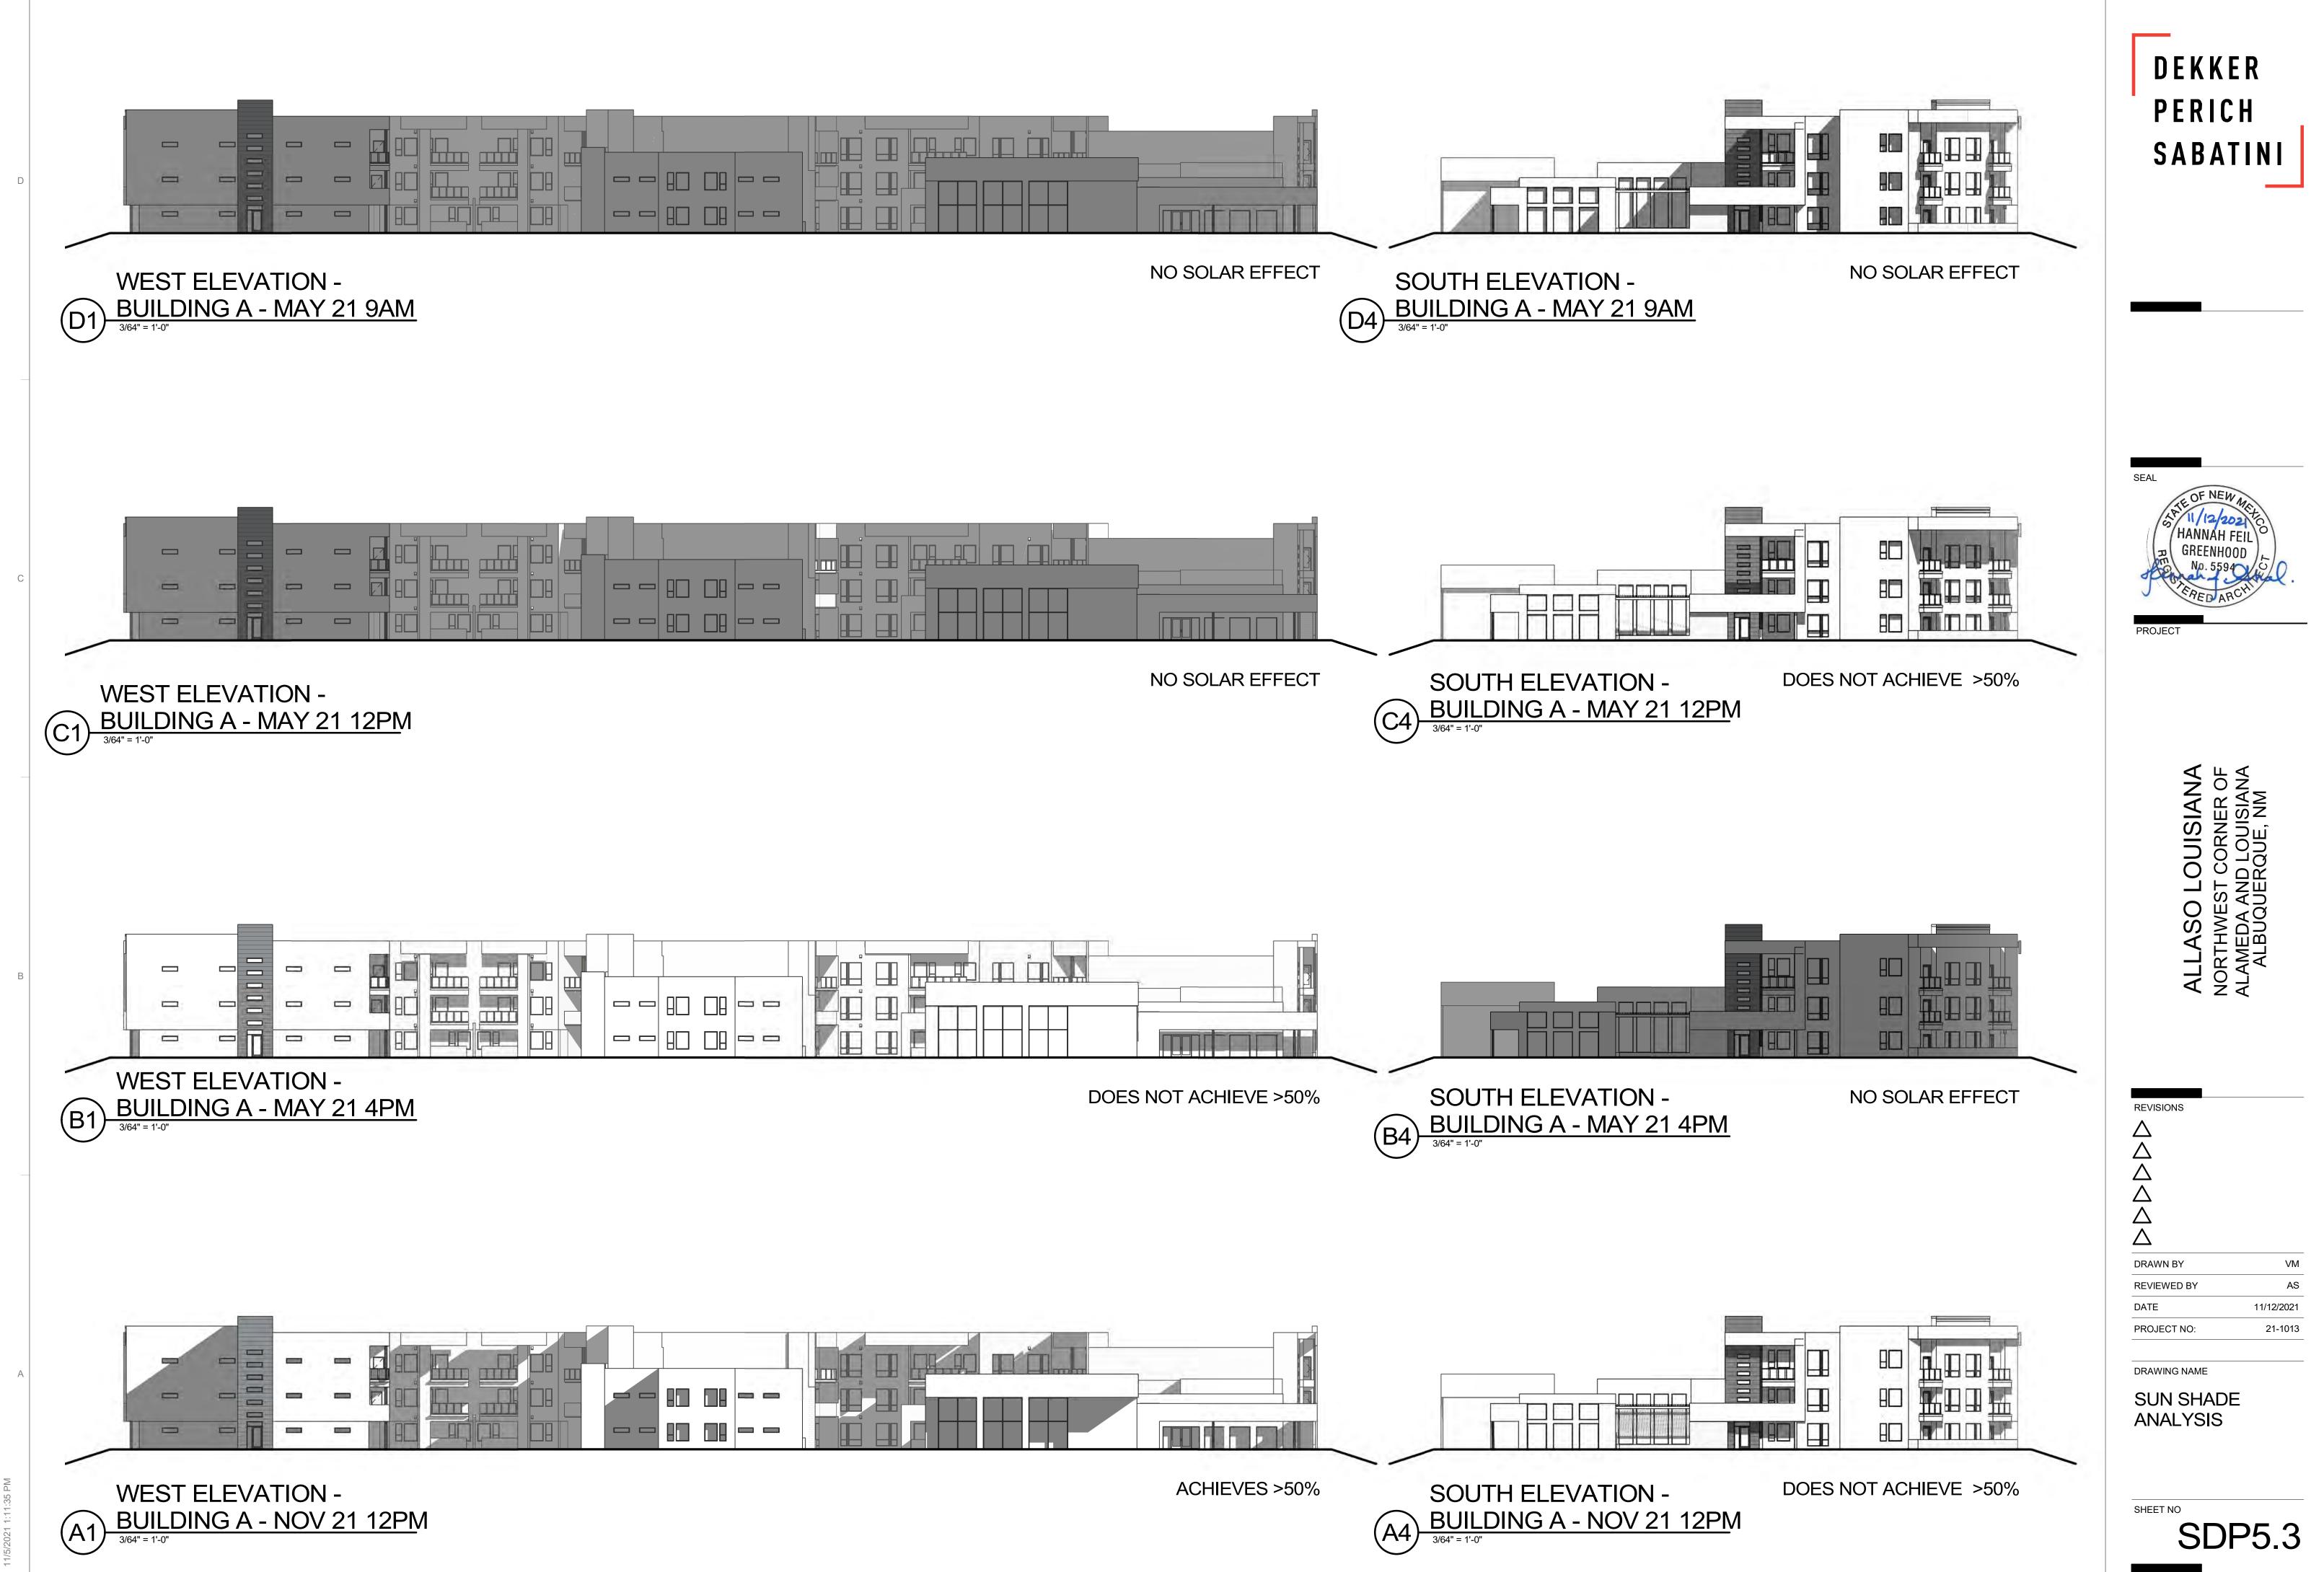
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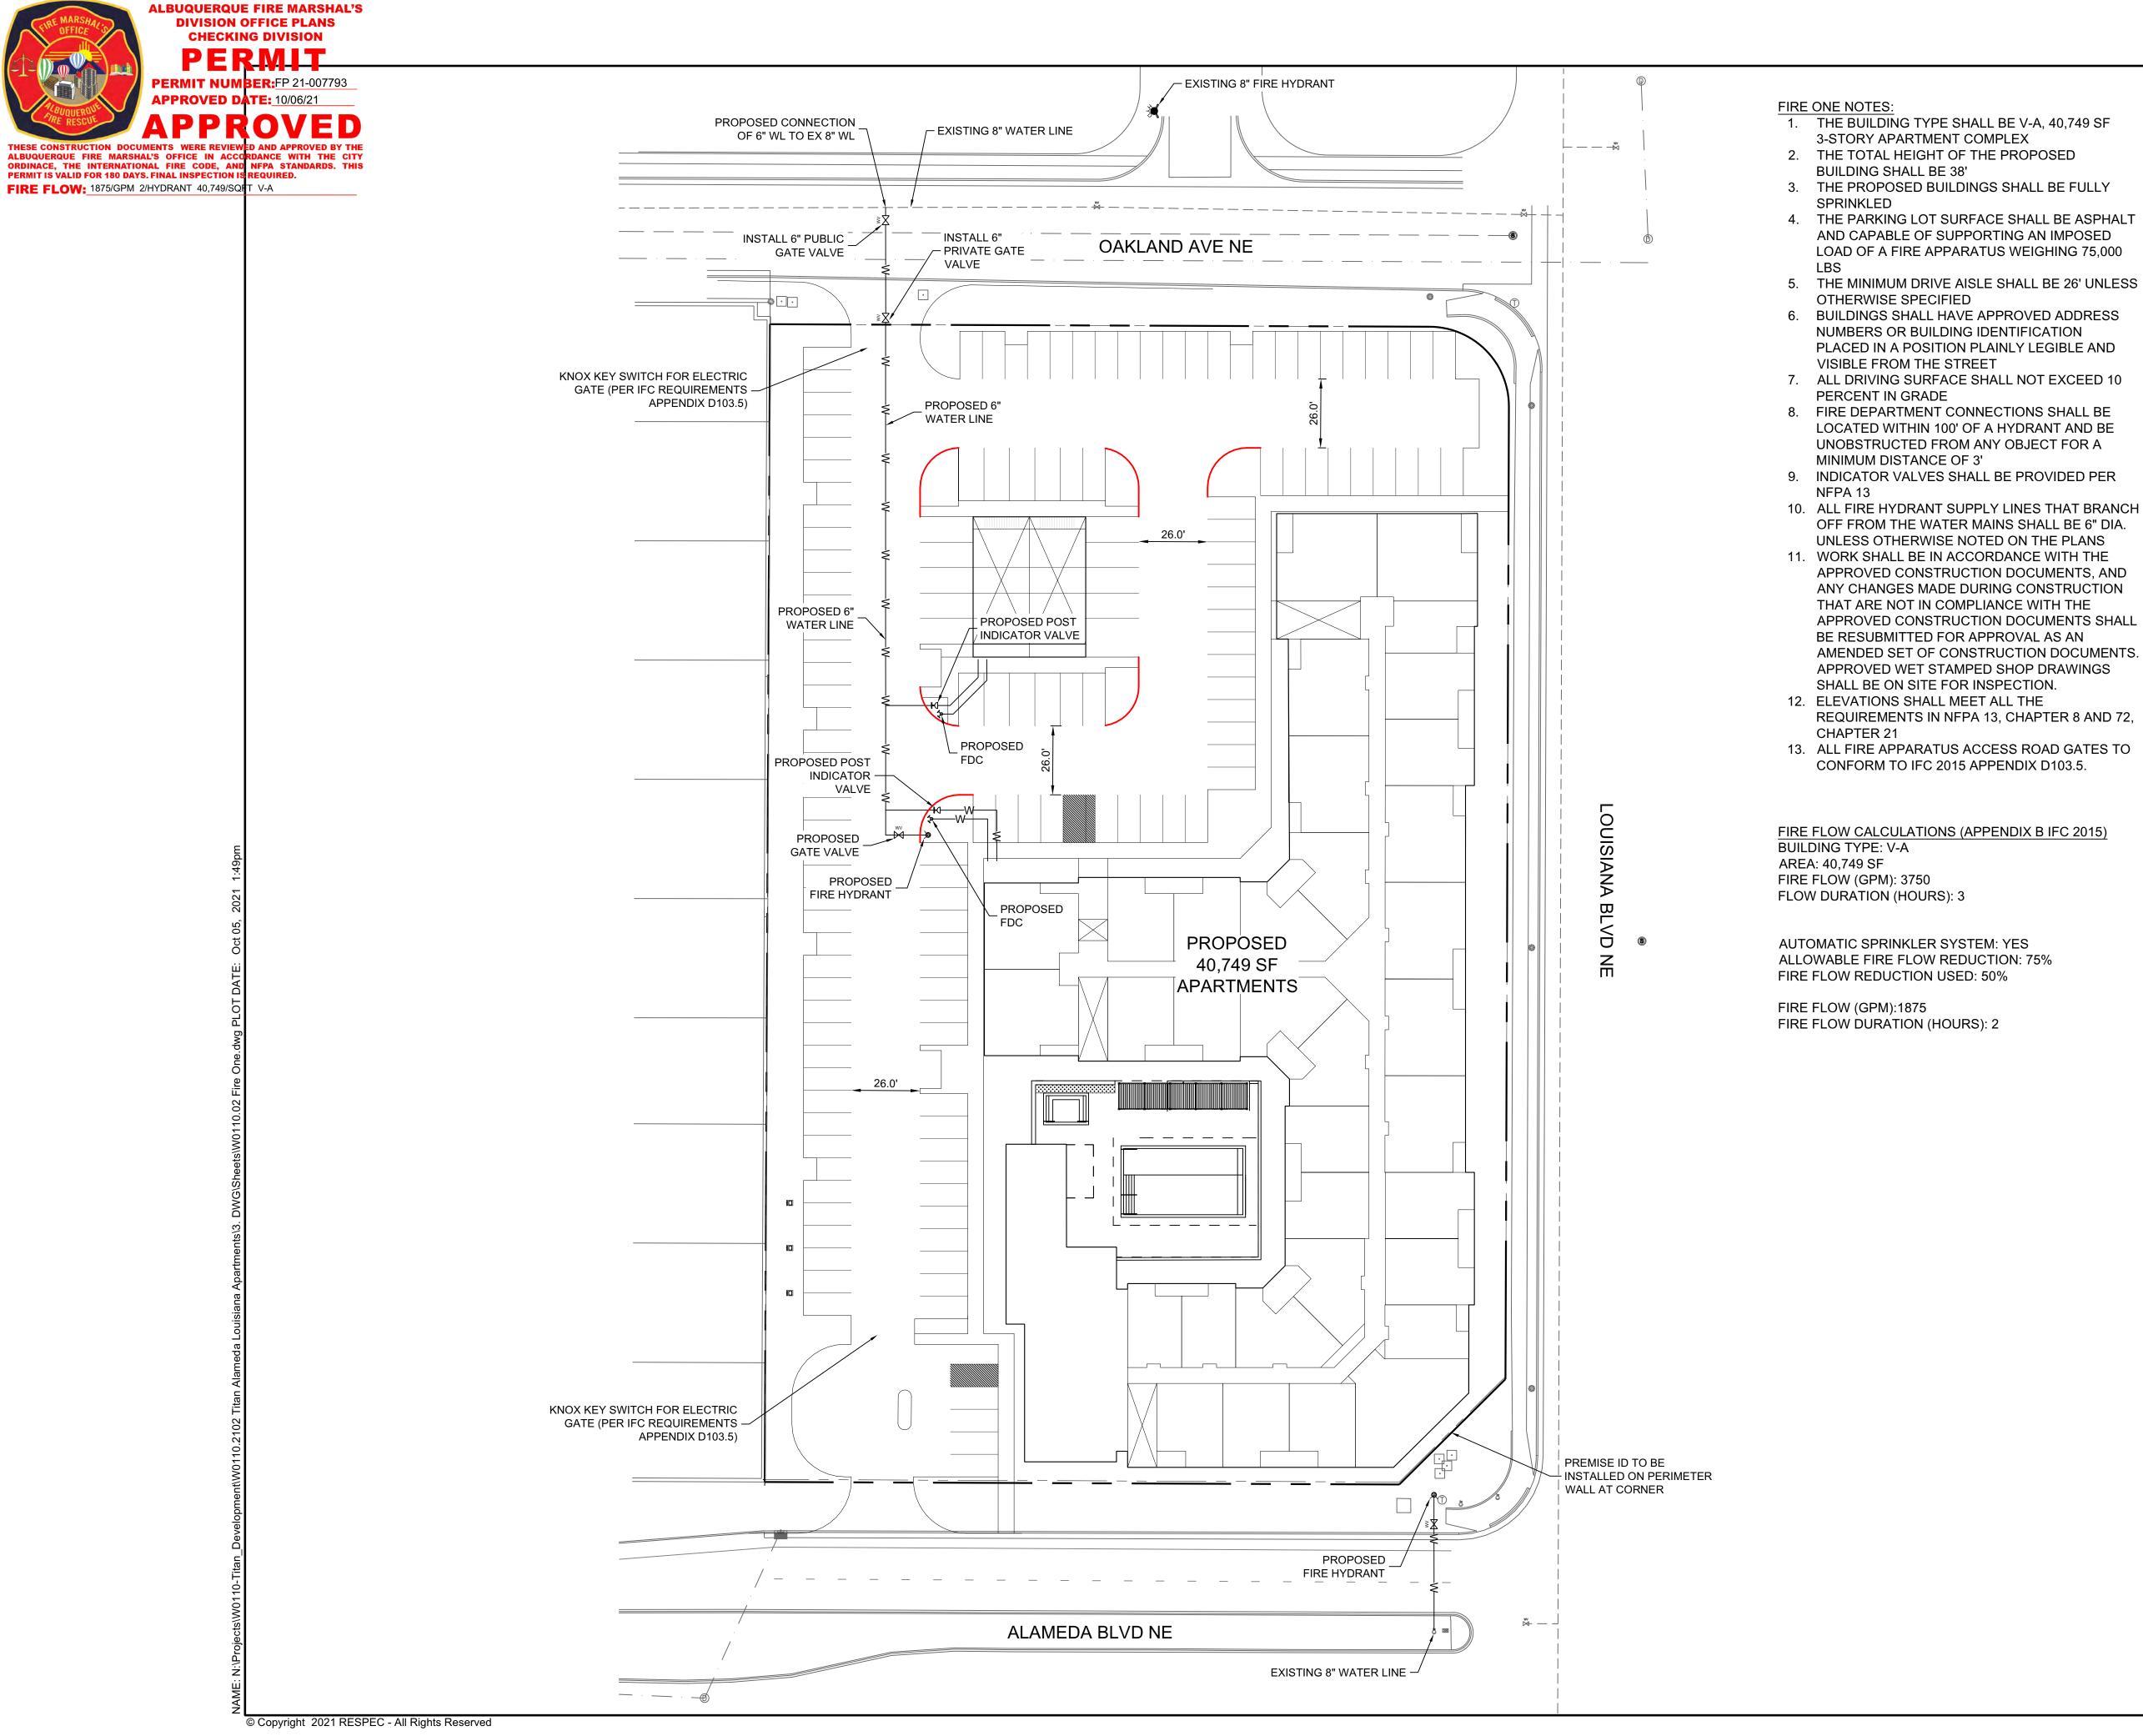
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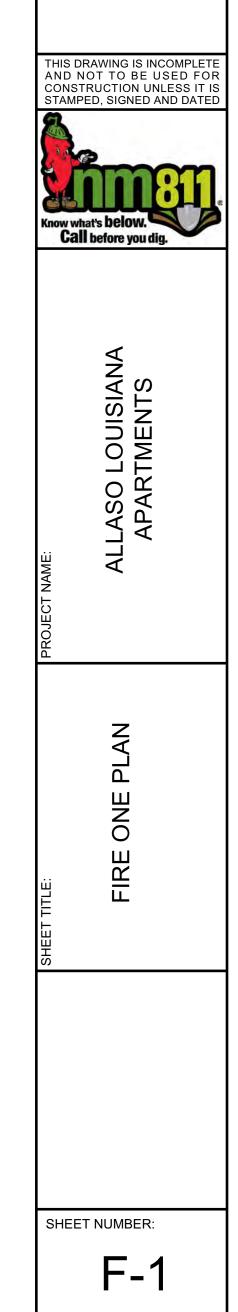


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LEGEND

W	PROPOSED WATERLINE
	PROPERTY BOUNDARY
	EXISTING WATERLINE
	PROPOSED MARKED FIRE LANE
ø	PROPOSED FIRE HYDRANT
	PROPOSED GATE VALVE
۲ <u>۵</u> ۲	PROPOSED FDC
Σ	PROPOSED PIV

SCALE: 1" = 30'



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STAMP

Current DRC

Project Number:

FIGURE 12

INFRASTRUCTURE LIST

(Rev. 2-16-18)

EXHIBIT "A"

Date Submitted:

Date Site Plan Approved:

Date Preliminary Plat Approved:

Date Preliminary Plat Expires:

DRB Project No.: PR-2021-006238

Construction Contificatio

DRB Application No.: SI-2021-01915

TO SUBDIVISION IMPROVEMENTS AGREEMENT DEVELOPMENT REVIEW BOARD (D.R.B.) REQUIRED INFRASTRUCTURE LIST

ALLASO LOUISIANA

PROPOSED NAME OF PLAT AND/OR SITE DEVELOPMENT PLAN

LOTS 15-18, BLOCK 28, NAA TRACT A, UNIT B

EXISTING LEGAL DESCRIPTION PRIOR TO PLATTING ACTION

Following is a summary of PUBLIC/PRIVATE Infrastructure required to be constructed or financially guaranteed for the above development. This Listing is not necessarily a complete listing. During the SIA process and/or in the review of the construction drawings, if the DRC Chair determines that appurtenant items and/or unforeseen items have not been included in the infrastructure listing, the DRC Chair may include those items in the listing and related financial guarantee. Likewise, if the DRC Chair determines that appurtenant or non-essential items can be deleted from the listing, those items may be deleted as well as the related portions of the financial guarantees. All such revisions require approval by the DRC Chair, the User Department and agent/owner. If such approvals are obtained, these revisions to the listing will be incorporated administratively. In addition, any unforeseen items which arise during construction which are necessary to complete the project and which normally are the Subdivider's responsibility will be required as a condition of project acceptance and close out by the City.

						Constit			
Financially Guaranteed	Constructed Under	Size	Type of Improvement	Location	From	То	Priv. Inspector	ate P.E.	City Cnst Engineer
DRC #	DRC #	205'	6' SIDEWALK 4" PCC	NORTH ALONG FRONTAGE OF SITE	NW CORNER OF SITE	NE CORNER OF SITE	/	/	/
		195'	10' ASPHALT MULTI-USE TRAIL	SOUTH ALONG FRONTAGE OF SITE	SW CORNER OF SITE	SE CORNER OF SITE	/	/	/
		26' WIDE	ACCESS DRIVE INCL 2 ACCESS RAMPS	OAKLAND AVE	NE CORNER OF SITE	80' WEST	/	/	/
		26' WIDE	ACCESS DRIVE INCL 2 ACCESS RAMPS	ALAMEDA AVE	SW CORNER OF SITE	26' EAST	/	/	/
		660'	6' CMU RETAINING WALL	NORTH, EAST, AND SOUTH ALONG FRONTAGE OF SITE	90' WEST OF NE INTERSECTION	160' WEST OF SE INTERSECTION	/	/	/
		235'	PCC STD C&G	OAKLAND AVE	NW CORNER OF SITE	NE CORNER OF SITE	1	/	/
		1	BUS STOP INCL BUS SHELTER	ALAMEDA BLVD	SE CORNER OF SITE	75' WEST	/	/	/
							/	/	/

PAGE <u>1</u> OF <u>2</u>

			ved for Impact Fee credits. Signature standard SIA requirements.	s from the Impact Fee Admi	nistrator and the City Use	er Department is require	ed prior to DRB approval o	f this
Financially	Constructed						Construction Cert	ification
Guaranteed	Under	Size	Type of Improvement	Location	From	То	Private	City Cnst
DRC #	DRC #						Inspector P.E.	Engineer
							1 1	/
					P		1 1	/
					Approval of Creditab	le Items:	Approval of Creditable In	ems:
					Impact Fee Admistrat	or Signature Date	City User Dept. Signati	ure Date
				NOTES				
		If the s	site is located in a floodplain, then the	financial guarantee will not	be released until the LON	IR is approved by FEM	IA.	
			Street	ights per City rquirements.				
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	AGENT / OWNER			DEVELOPMENT R	EVIEW BOARD MEMBER	APPROVALS		
	Jesus Lopez NAME (print)			HAIR - date				
			DRB C	HAIR - Gale	PA	RKS & RECREATION - 0	uale	
	RESPEC							
	FIRM		TRANSPORTATION	DEVELOPMENT - date	•	AMAFCA - date		
:	SIGNATURE - date		UTILITY DEVI	ELOPMENT - date		DE ENFORCEMENT - d	date	
			CITY ENG	BINEER - date		date		
			DESIGN	REVIEW COMMITTEE REV	ISIONS			1
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REVISION	DATE	DRC CHAIR	USER DEPARTMENT	AGENT /OWNER