

VICINITY MAP

D-16Z, D-17Z

35001C0136G



NOTICE TO CONTRACTORS


- 1. AN EXCAVATION/CONSTRUCTION PERMIT WILL BE REQUIRED BEFORE BEGINNING ANY WORK WITHIN CITY RIGHT-OF-WAY.
- 2. ALL WORK DETAILED ON THESE PLANS TO BE PERFORMED, EXCEPT AS OTHERWISE STATED OR PROVIDED HERON, SHALL BE CONSTRUCTED IN ACCORDANCE WITH CITY OF RIO RANCHO STANDARD SPECIFICATIONS FOR PUBLIC WORKS CONSTRUCTION.
- 3. TWO WORKING DAYS PRIOR TO ANY EXCAVATION, CONTRACTOR MUST CONTACT LINE LOCATING SERVICE, 765-1234, FOR LOCATION OF EXISTING UTILITIES.
- 4. PRIOR TO CONSTRUCTION, THE CONTRACTOR SHALL EXCAVATE AND VERIFY THE HORIZONTAL AND VERTICAL LOCATIONS OF ALL CONNECTIONS. SHOULD A CONFLICT EXIST, THE CONTRACTOR SHALL NOTIFY THE ENGINEER SO THAT THE CONFLICT CAN BE RESOLVED WITH A MINIMUM AMOUNT OF DELAY.
- 5. BACKFILL COMPACTION SHALL BE ACCORDING TO TRAFFIC/STREET USE.
- 6. MAINTENANCE OF THESE FACILITIES SHALL BE THE RESPONSIBILITY OF THE OWNER OF THE PROPERTY
- 7. WORK ON ARTERIAL STREETS SHALL BE PERFORMED ON A 24-HOUR BASIS.

EROSION CONTROL NOTES:

CONTRACTOR.


- 1. CONTRACTOR IS RESPONSIBLE FOR OBTAINING A TOPSOIL DISTURBANCE PERMIT PRIOR TO BEGINNING WORK.
- 2. CONTRACTOR IS RESPONSIBLE FOR MAINTAINING RUN-OFF ON SITE DURING
- 3. CONTRACTOR IS RESPONSIBLE FOR CLEANING ALL SEDIMENT THAT GETS INTO EXISTING RIGHT-OF-WAY.
- 4. REPAIR OF DAMAGED FACILITIES AND CLEANUP OF SEDIMENT ACCUMULATIONS ON ADJACENT PROPERTIES AND IN PUBLIC FACILITIES IS THE RESPONSIBILITY OF THE
- 5. ALL EXPOSED EARTH SURFACES MUST BE PROTECTED FROM WIND AND WATER EROSION PRIOR TO FINAL (CITY) ACCEPTANCE OF ANY PROJECT.
- 6. ALL SLOPES NOT STABILIZED AT THE END OF THE PROJECT SHALL BE STABILIZED IN ACCORDANCE WITH COA SPECS OR ₹" GRAVEL


ENGINEER'S SEAL	RUTLEDGE OFFICE/WAREHOUSE ALBUQUERQUE, NM	<i>DRAWN BY</i> pm
DR. BOH	ALBOQUENQUE, NM	DATE
ON METICO Z	RUTLEDGE SPEC BUILDING	3-7-22
((7868))	GRADING AND DRAINAGE PLAN	DRAWING
PROPERTY OF THE PROPERTY OF TH		SHEET #
3-7-22	TIERRA WEST, LLC 5571 MIDWAY PARK PL NE ALBUQUERQUE, NEW MEXICO 87109 (505) 858-3100 www.tierrawestllc.com	GR-1
RONALD R. BOHANNAN P.E. #7868		<i>JOB #</i> 2021051

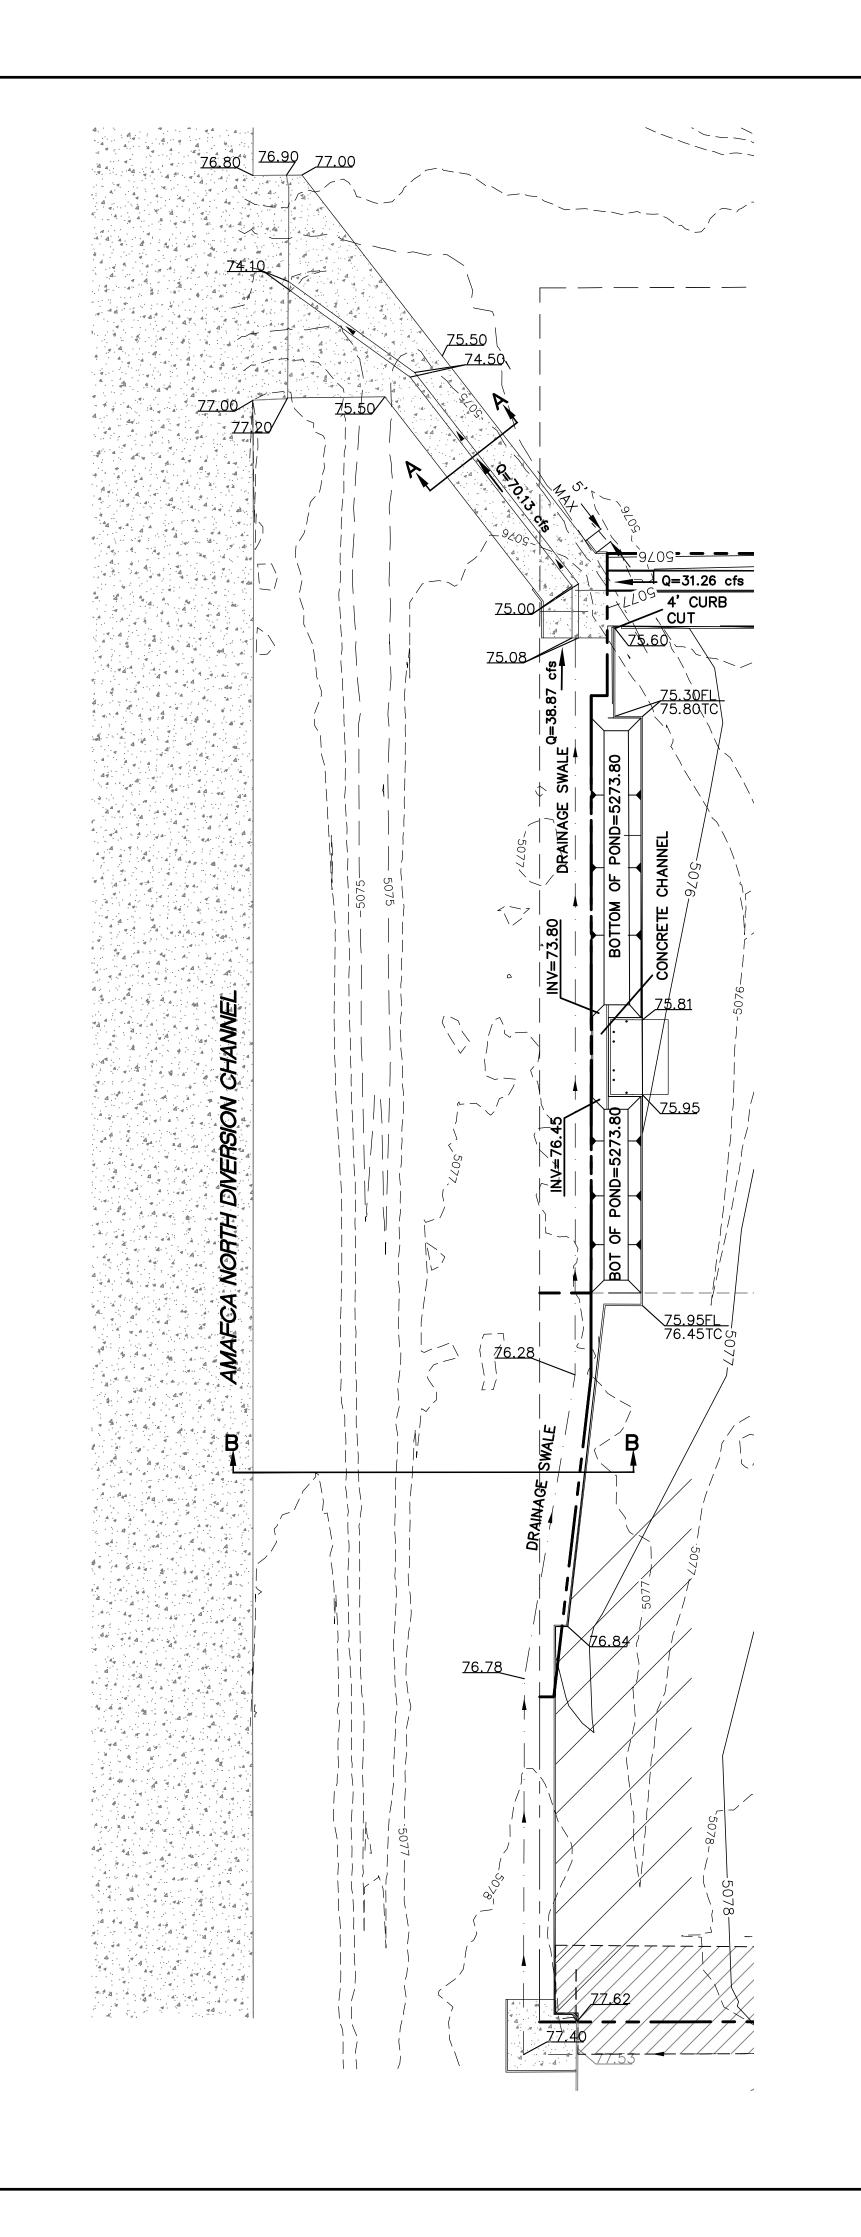


NOTES

SEE CHANNEL RUNDOWN DETAILS ON SHEET GR-3

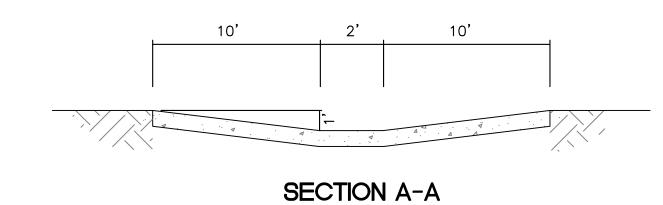

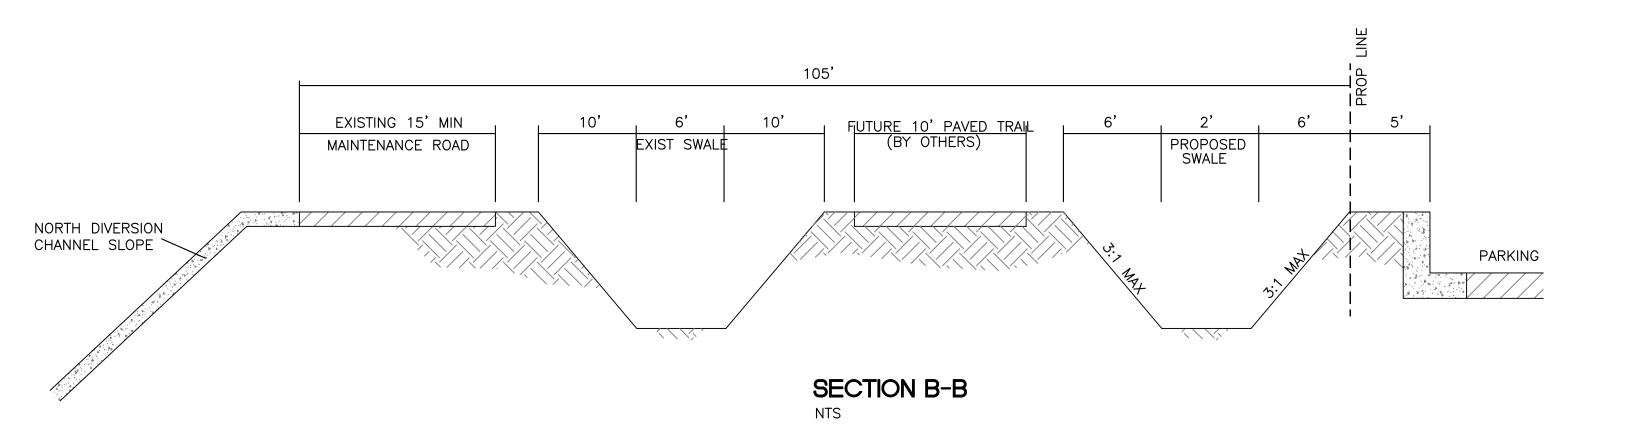

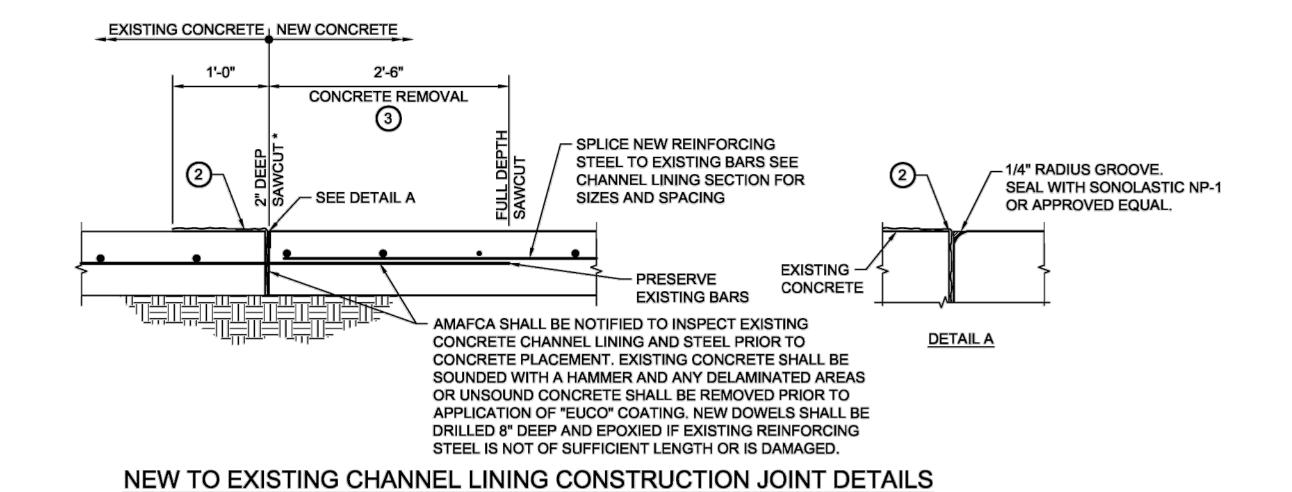


AMAFCA GENERAL NOTES


- 1. AMAFCA'S PROJECT MANAGER SHALL BE NOTIFIED 48 HOURS PRIOR TO START OF ANY WORK AND PRIOR TO FINAL INSPECTION OF THE WORK WITHIN THE AMAFCA RIGHT-OF-WAY OR EASEMENT. TELEPHONE NUMBER IS 884-2215.
- 2. NO WORK WILL BE PERFORMED IN THE AMAFCA RIGHT-OF-WAY OR EASEMENT BETWEEN MAY 15 AND OCTOBER 15 WITHOUT WRITTEN PERMISSION FROM AMAFCA.
- 3. ALL SUBGRADE, BACKFILL AND EMBANKMENT SHALL BE COMPACTED TO 95% (MODIFIED PROCTOR) WITHIN THE AMAFCA RIGHT—OF—WAY OR EASEMENT. TESTING REPORTS SHALL BE PROVIDED TO AMAFCA.
- 4. CERTIFIED AS-BUILT PLANS MUST BE SUBMITTED TO AMAFCA FOR THE CONSTRUCTION WITHIN THE AMAFCA RIGHT-OF-WAY OR EASEMENT.
- 5. CONTRACTOR SHALL PROVIDE A CERTIFICATE OF LIABILITY INSURANCE IN THE AMOUNT OF \$2,000,000.00, NAMING AMAFCA AS ADDITIONAL INSURED, PRIOR TO STARTING WORK.
- 6. ALL DISTURBED GROUND AREAS SHALL BE REVEGETATED IN ACCORDANCE WITH CITY OF ALBUQUERQUE STANDARD SPECIFICATIONS FOR PUBLIC WORKS CONSTRUCTION, SECTION 1012 NATIVE GRASS SEEDING, AS CURRENTLY UPDATED.
- 7. ANY EXISTING SURVEY CONTROL MONUMENTS THAT ARE MOVED OR DESTROYED AS A RESULT OF THE CONSTRUCTION SHALL BE REPLACED BY A LICENSED SURVEYOR AT THE OWNER'S EXPENSE.
- 8. THE MAXIMUM WHEEL LOAD ALLOWED IN THE AMAFCA CHANNEL IS 12,000 POUNDS.
- 9. NO TRACKED VEHICLES WILL BE ALLOWED IN THE AMAFCA CHANNEL WITHOUT WRITTEN PERMISSION FROM AMAFCA.

APPROVED FOR CONSTRUCTION WITHIN AMAFCA RIGHT-OF-WAY / EASEMENT:

(FOR AMAFCA)

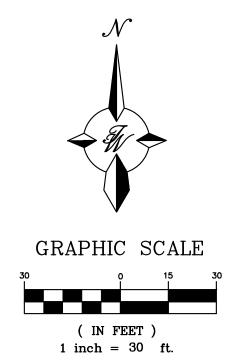

ENGINEER'S SEAL	RUTLEDGE OFFICE/WAREHOUSE ALBUQUERQUE, NM	<i>DRAWN BY</i> pm
ON MEXICO Z	CHANNEL SECTIONS	<i>DATE</i> 3–7–22
(7868)		DRAWING
PERSONAL ENGINE		SHEET #
3-7-22	5571 MIDWAY PARK PL NE ALBUQUERQUE, NEW MEXICO 87109	GR-2
RONALD R. BOHANNAN P.E. #7868	(505) 858-3100 www.tierrawestllc.com	<i>JOB #</i> 2021051

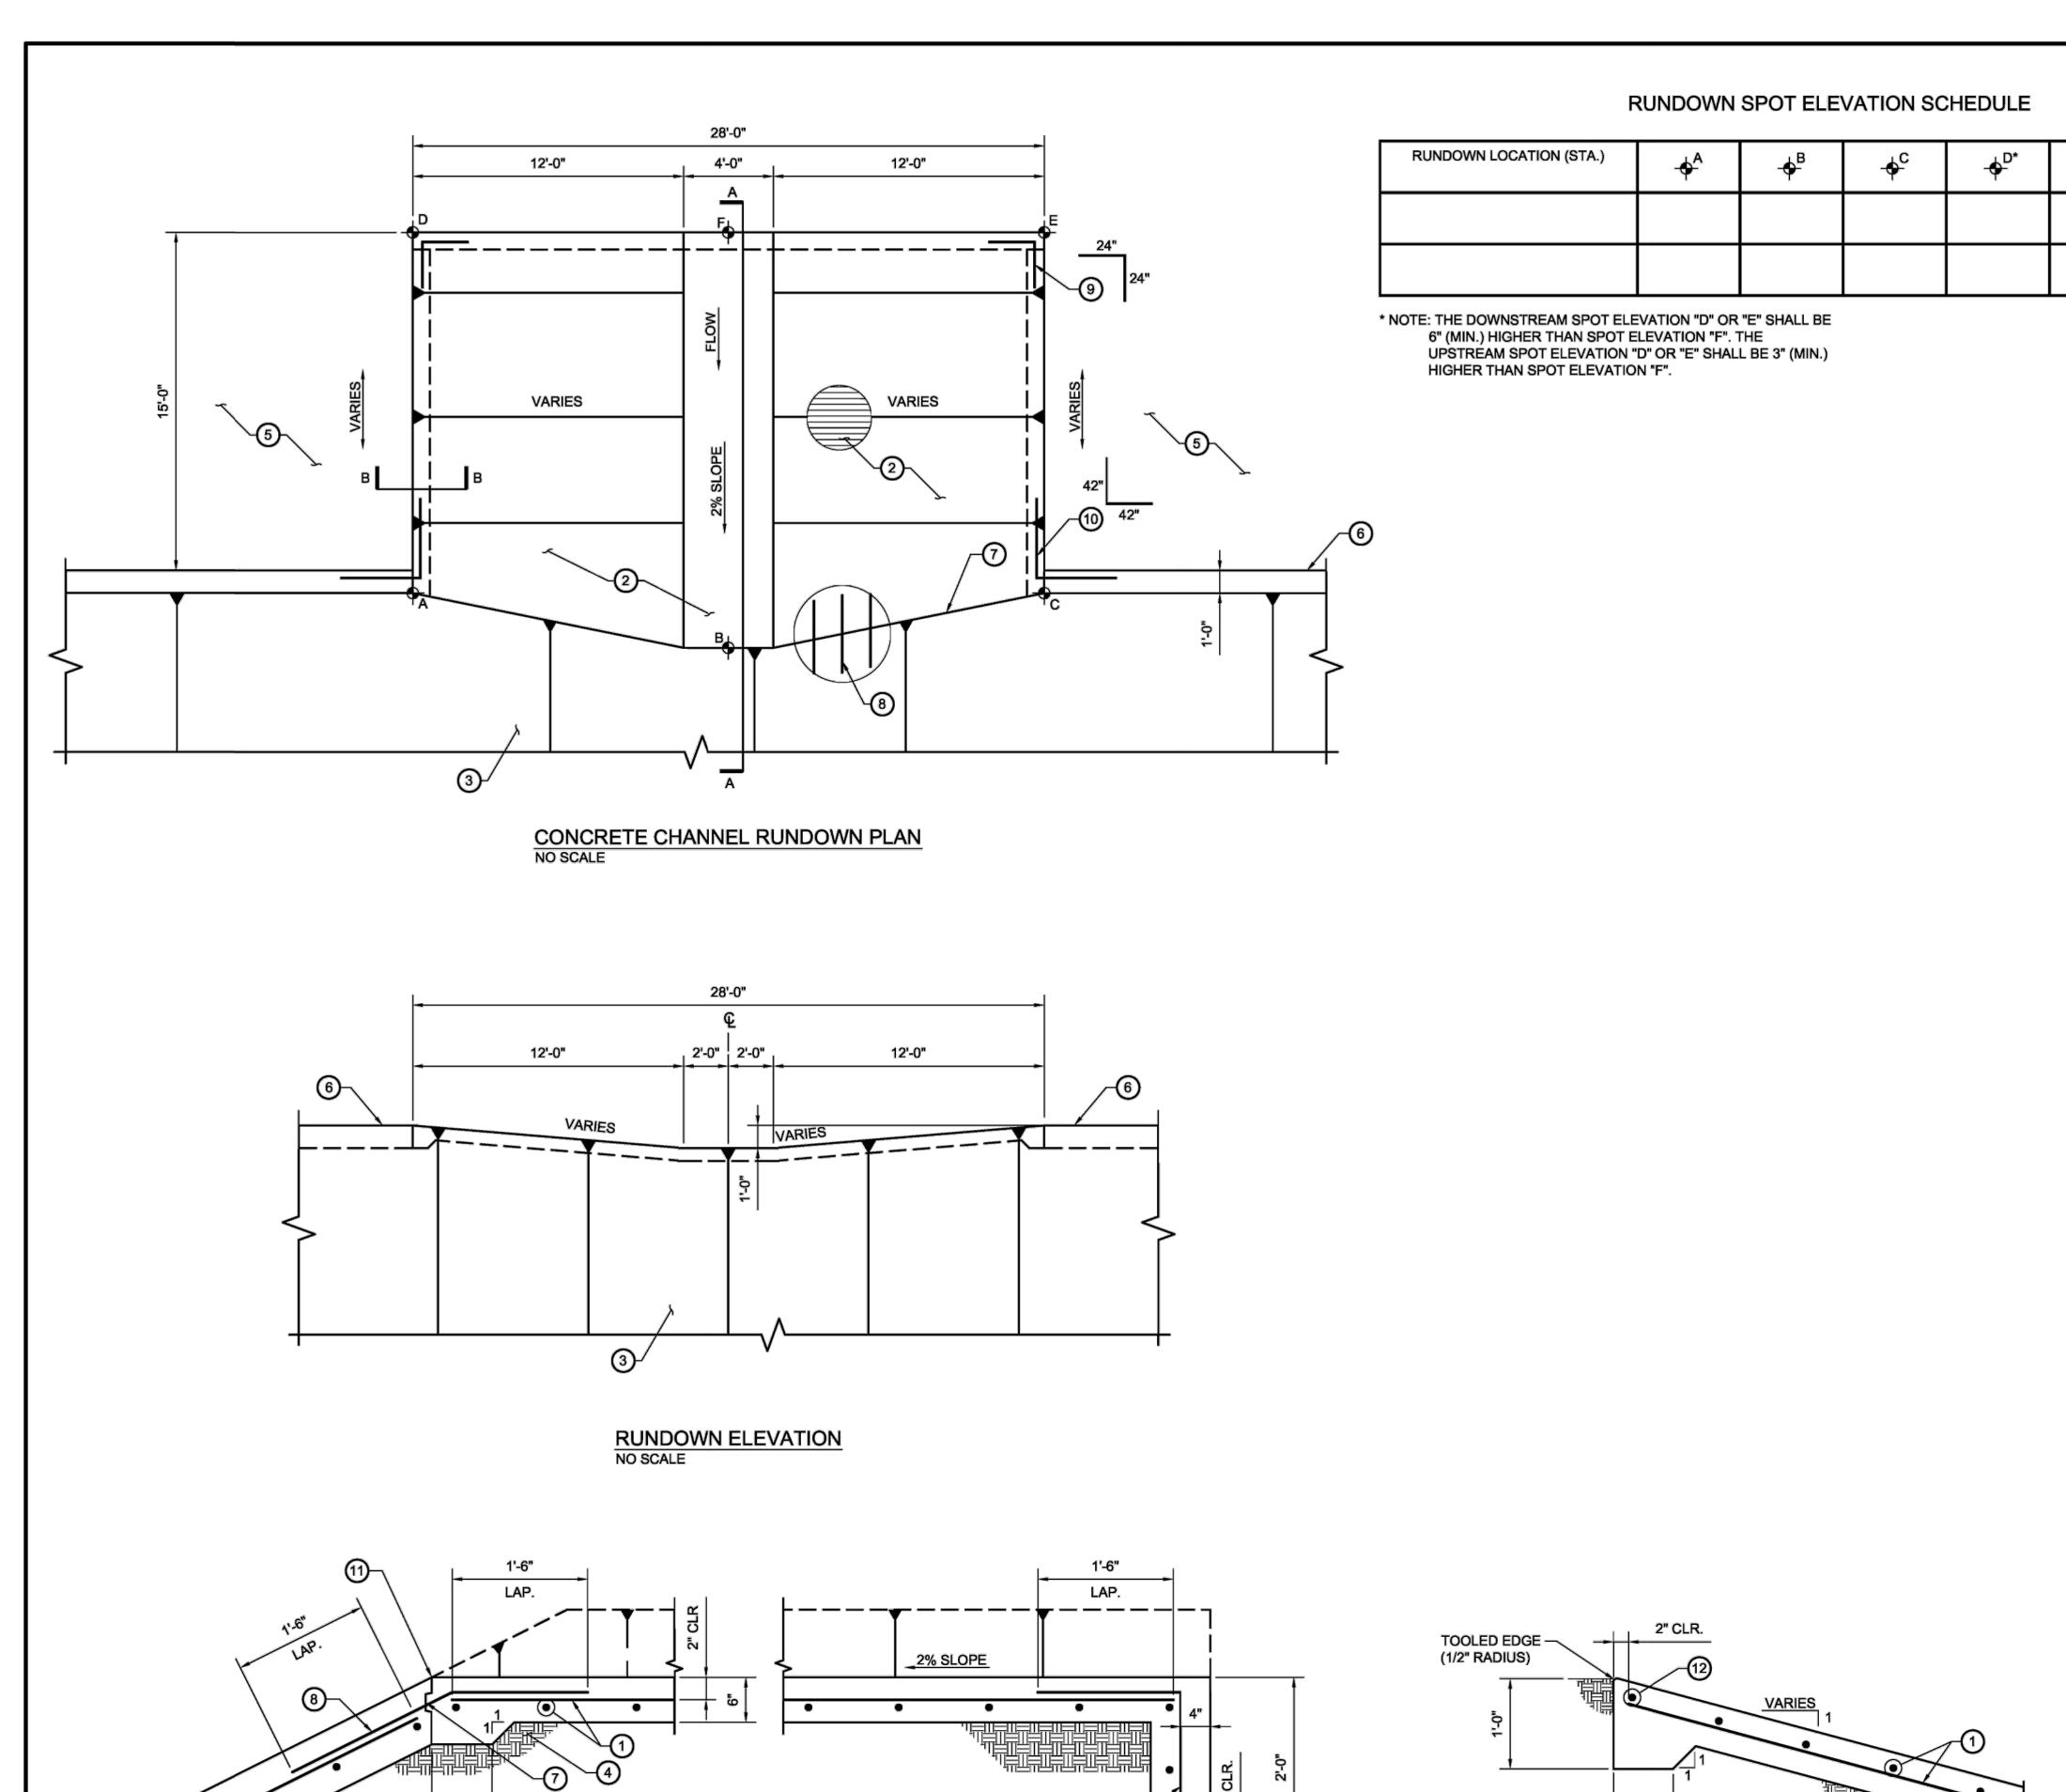

RUNDOWN SECTION A-A
NO SCALE

P:\080313\Struct\ACAD\Submittals\100% Final\8-12-08\Acad dwg\AMAFCA-108.dwg August 12, 2008 - 9:25am

RUNDOWN SECTION B-B NO SCALE

ISSUE DATE: 8-12-2008

O KEYED NOTES

1. RUNDOWNS SHALL BE CONSTRUCTED OF 6" THICK CONCRETE WITH #5 BARS AT 15" O.C. CONCRETE SHALL BE TINTED TO MATCH CHANNEL COLOR.

2. EXPOSED CONCRETE SURFACE OF THE RUNDOWN SHALL BE FINISHED WITH A TINE FINISH TRANSVERSE TO RUNDOWN FLOW

3. 8" CHANNEL LINING

4. COMPACTED SUBGRADE - 95% MODIFIED PROCTOR, SAME CONDITIONING AS UNDER CHANNEL LINING

5. MAINTENANCE ROAD

6. CHANNEL SILL

7. ALLOWABLE CONSTRUCTION JOINT WITH KEYWAY

8. #5 DOWEL @ 15" O.C.

9. #5 CORNER BAR, TYP.

10. #8 CORNER BAR, TYP.

11. TOOLED 1/4" RADIUS BOTH SIDES WITH NP-1 SEALANT OR APPROVED EQUAL

12. #8 ON 6" SAND SHAIR

DESIGN DATA

A. CAST-IN-PLACE CONCRETE:


F'C = 3000 PSI

B. REINFORCING STEEL:


ASTM A615 GRADE 60

C. MOISTURE AND DENSITY CONTROL:

ASTM D-1557 ALL FILL MATERIAL SHALL BE PLACED IN HORIZONTAL LIFTS OF 8" MAXIMUM AND COMPACTED TO 95 PERCENT OF MAXIMUM DRY DENSITY. THE MOISTURE CONTENT SHALL BE OPTIMUM TO ±2 PERCENT.

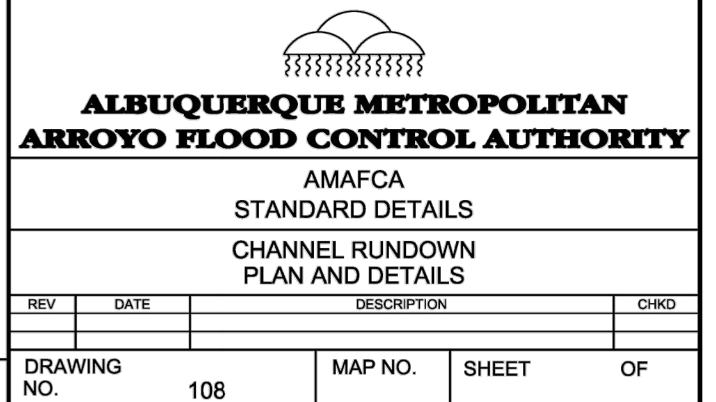

OF

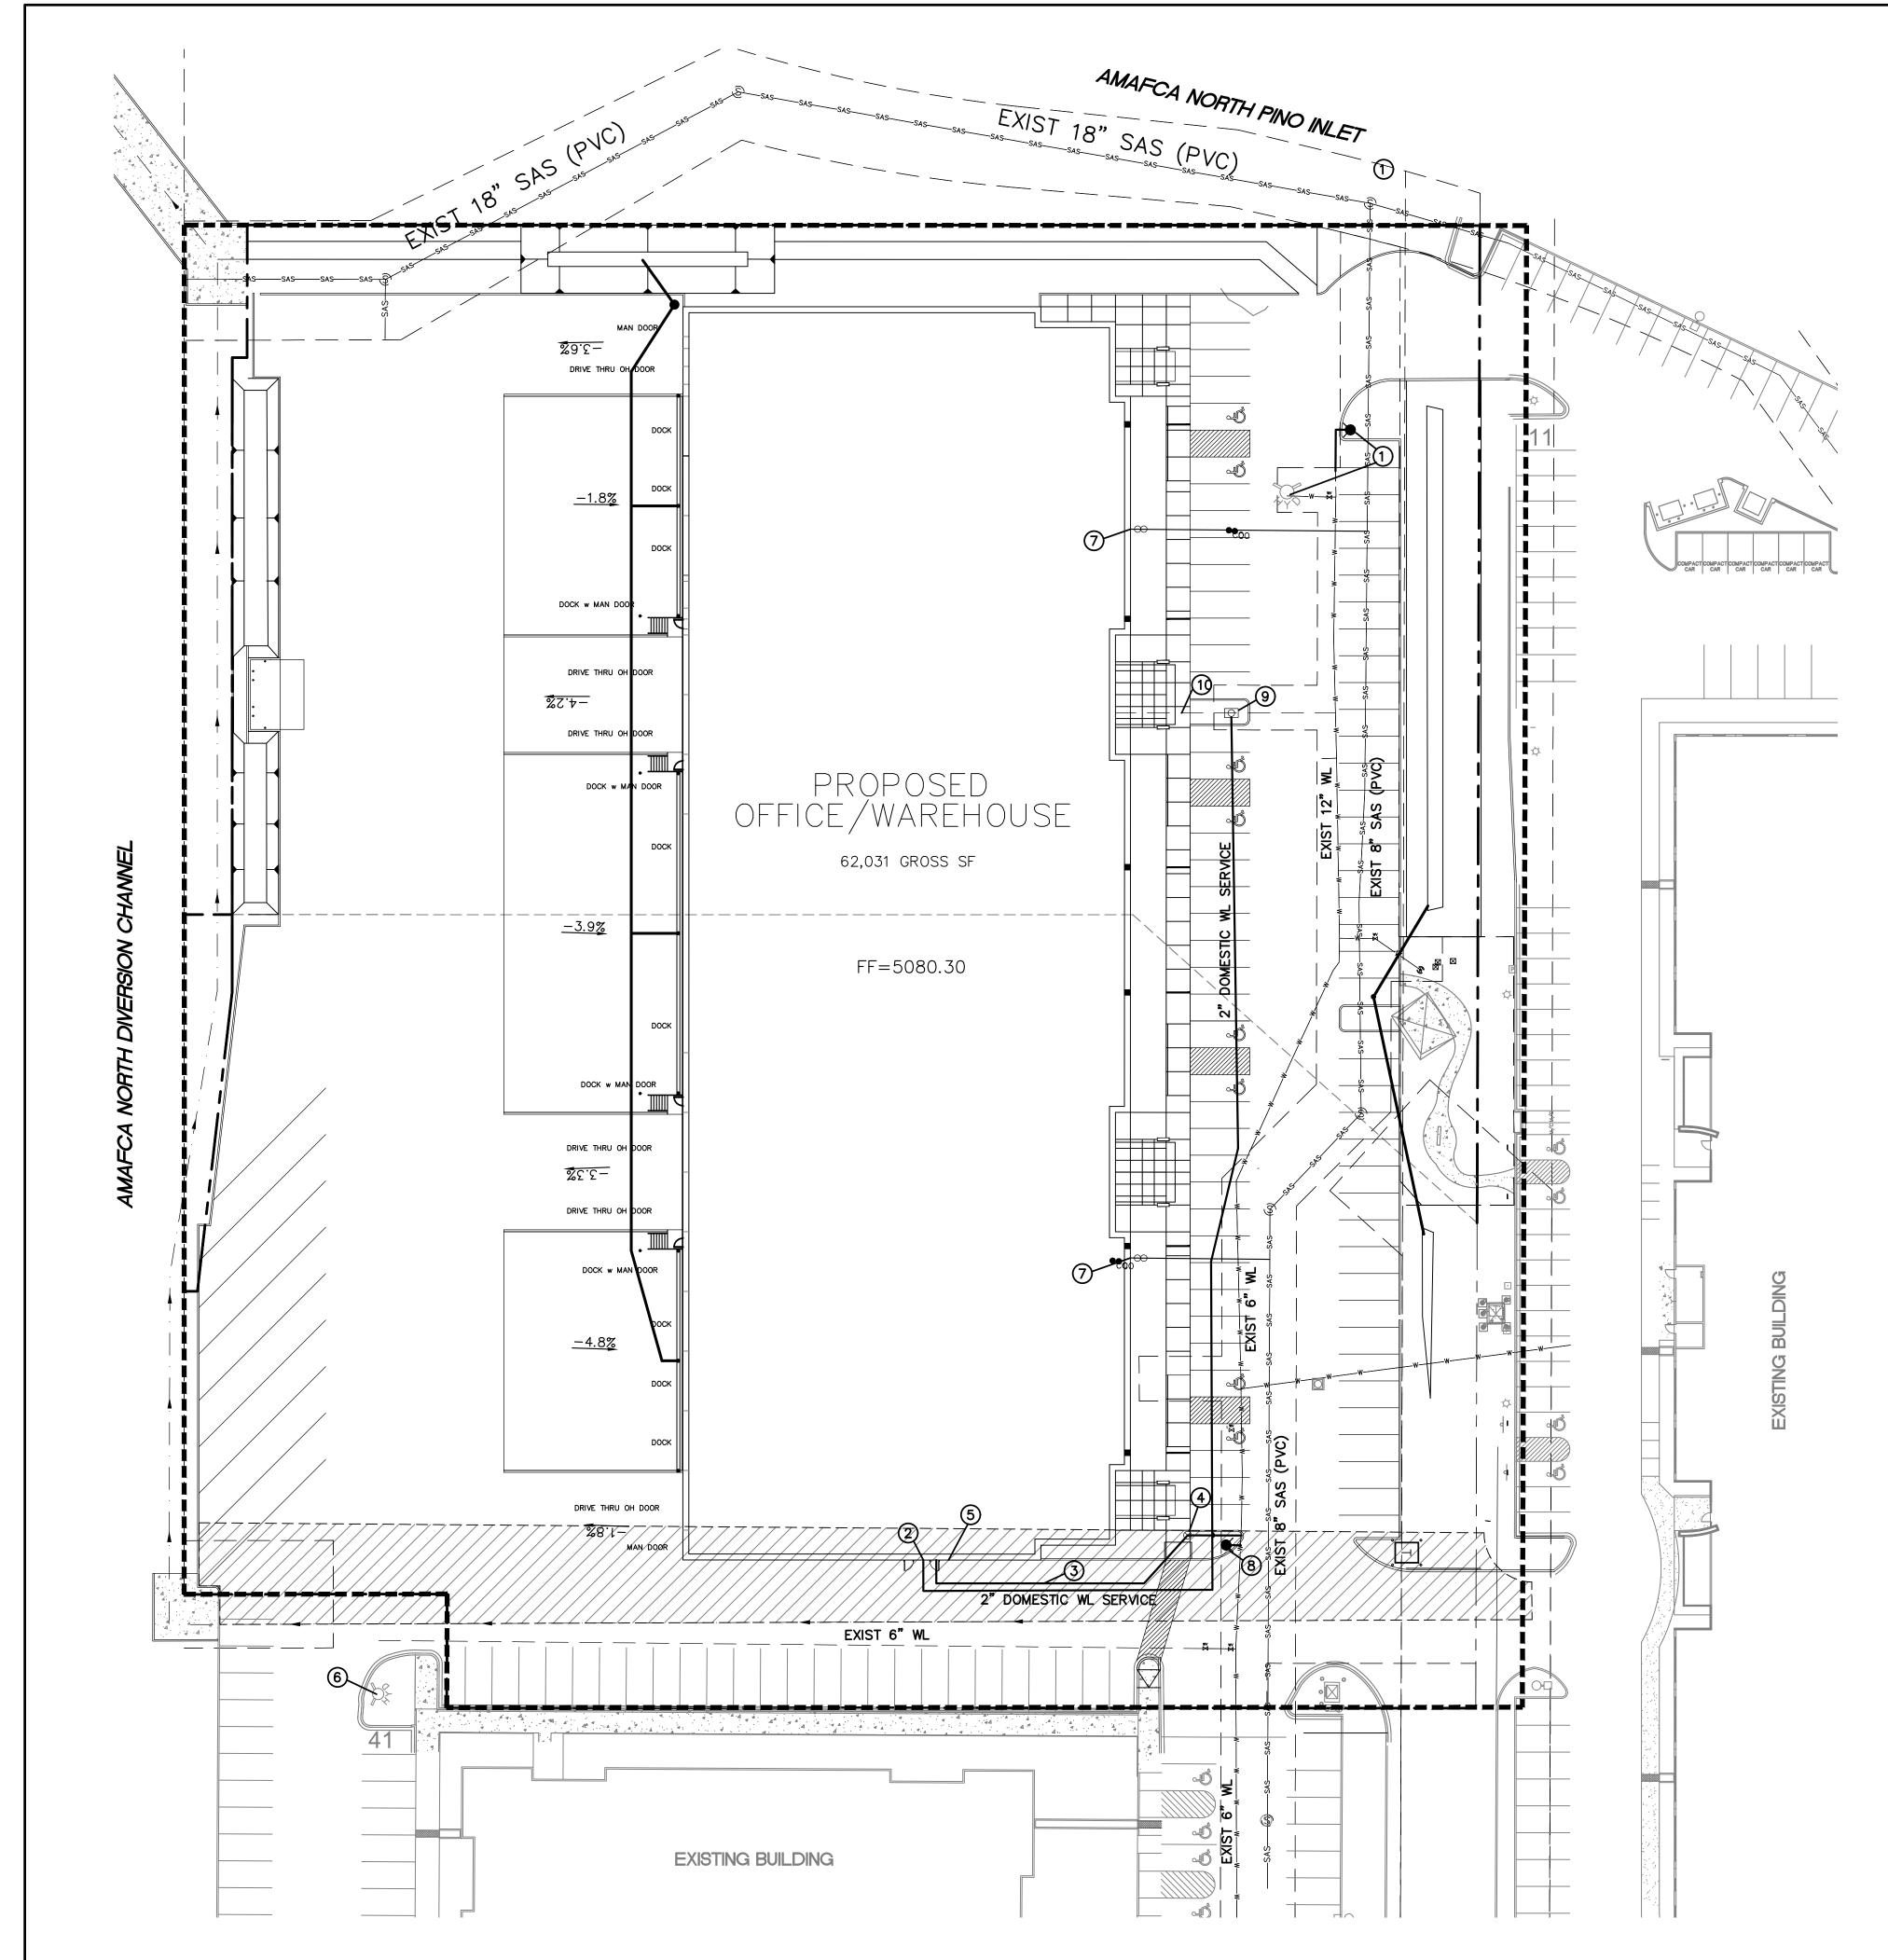


LEGEND


	CURB & GUTTER
	BOUNDARY LINE
	BUILDING
	EXISTING CURB & GUTTER
	EXISTING BOUNDARY LINE
	PROJECT LIMITS
.	PROPOSED HYDRANT
8" SAS	SANITARY SEWER LINE
8" WL	WATERLINE
S	EXISTING SAS MH
\bowtie	EXISTING GATE VALVE
	EXISTING WATERLINE
SAS	EXISTING SAS

KEYED NOTES

- 1 RELOCATE EXIST FIRE HYDRANT (PUBLIC) PER COA STD DWG 2340
- 2 2" DOMESTIC WL SERVICE
- 3 8" FIRELINE
- (4) PIV
- 5 FDC
- 6 EXISTING FIRE HYDRANT (PUBLIC)
- 7 EXISTING 4" SAS SERVICE W/CLEANOUTS
- 8 NEW FIRE HYDRANT W/GATE VALVE (PUBLIC)
 PER COA STD DWG 2340
- 9 EXISTING 2" WATER METER TO REMAIN
- (10) REMOVE AND DISPOSE 36 LF EXISTING WL SERVICE

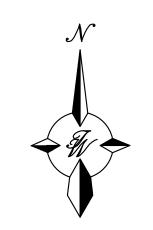

GRAPHIC SCALE

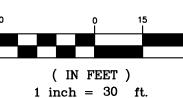

CAUTION

ALL EXISTING UTILITIES SHOWN WERE OBTAINED FROM RESEARCH, AS—BUILTS, SURVEYS OR INFORMATION PROVIDED BY OTHERS. IT SHALL BE THE SOLE RESPONSIBILITY OF THE CONTRACTOR TO CONDUCT ALL NECESSARY FIELD INVESTIGATIONS PRIOR TO AND INCLUDING ANY EXCAVATION, TO DETERMINE THE ACTUAL LOCATION OF UTILITIES AND OTHER IMPROVEMENTS, PRIOR TO STARTING THE WORK. ANY CHANGES FROM THIS PLAN SHALL BE COORDINATED WITH AND APPROVED BY THE ENGINEER.


GENERAL UTILITY NOTES:

- ALL WATER AND SEWER UTILITY WORK TO BE DONE IN ACCORDANCE WITH COA STANDARDS AND SPECIFICATIONS LATEST EDITION.
- 2. 4' MINIMUM BURY REQUIRED FOR ALL UTILITIES UNLESS OTHERWISE NOTED.
- 3. REFERENCE PLUMBING PLANS FOR WATER LINE RISER LOCATIONS. BACKFLOW PREVENTOR LOCATED INSIDE
- 4. CLEAN OUTS ARE TO BE BUILT PER UNIFORM PLUMBING CODE STANDARDS AT LOCATIONS INDICATED AND AT MID RUN IF LONGER THAN 100'
- 5. ALL PLUMBING PIPE MATERIAL TO BE USED PER UPC.
- 6. FIRE LINE AND DOMESTIC WATERLINE MUST HAVE BACKFLOW PREVENTORS PER UPC. TO BE PROVIDED IN THE BUILDING
- 7. ALL EX. SD INLETS AND MH'S SHALL HAVE CONCRETE COLLARS POURED AND BE ADJUSTED TO FINISHED GRADE.
- 8. ALL EXCAVATION, TRENCHING AND SHORING ACTIVITIES MUST BE CARRIED-OUT IN ACCORDANCE WITH OSHA 29 CFR 1926.650 SUBPART P.
- 9. ALL UTILITY DISTANCES SHOWN ARE FOR REFERENCE ONLY.
- 10. PNM HAS NUMEROUS ELECTRIC FACILITIES AT THIS SITE CURRENTLY SERVING EXISTING CUSTOMERS. THE APPLICANT SHALL COORDINATE WITH PNM REGARDING THESE EXISTING FACILITIES. ANY RELOCATION, CHANGES OR REALIGNMENT OF EXISTING ELECTRIC UTILITIES WILL BE THE DEVELOPER EXPENSE. IN SOME CASES, RELOCATION OR CHANGES TO EXISTING FACILITIES MAY NOT BE FEASIBLE DUE TO PHYSICAL, USE OR SAFETY CLEARANCE CONSTRAINTS.
- 11. PNM WILL REVIEW ALL TECHNICAL NEEDS, ISSUES AND SAFETY CLEARANCES FOR ITS ELECTRIC POWER SYSTEMS. ANY EXISTING AND PROPOSED PUBLIC UTILITY EASEMENTS SHALL BE INDICATED ON THE SITE PLAN UTILITY SHEET PRIOR TO DRB REVIEW. PNM'S STANDARD FOR PUBLIC UTILITY EASEMENTS IS 10 FEET IN WIDTH TO ENSURE ADEQUATE, SAFE CLEARANCES.
- 12. SCREENING SHALL BE DESIGNED TO ALLOW FOR ACCESS TO UTILITY FACILITIES. IT IS NECESSARY TO PROVIDE ADEQUATE CLEARANCE OF TEN FEET SURROUNDING ALL GROUND-MOUNTED UTILITIES FOR SAFE OPERATION, MAINTENANCE AND REPAIR PURPOSES.
- 13. DURING MAINTENANCE OF THE PUBLIC WATER AND/OR PUBLIC SEWER MAINS THE EASTERN ROW OF PARKING SPACES MAY NEED TO BE CLEARED OF ALL VEHICLES

INSPECTION NOTE

CONTRACTOR SHALL CONSULT THE LOCAL BUILDING
DEPARTMENT OFFICIALS FOR ANY PLAN REVIEW, PERMITTING
REQUIREMENTS OR BUILDING CODE INSPECTIONS THAT MAY
BE REQUIRED TO ENFORCE LOCAL, STATE OR NATIONAL
BUILDING CODES PRIOR TO CONSTRUCTING IMPROVEMENTS

ENGINEER'S SEAL	RUTLEDGE OFFICE/WAREHOUSE	<i>DRAWN BY</i> pm
OR. BOHANDE	ALBUQUERQUE, NM	<i>DATE</i> 2–22–22
7868 PRO (7868)	RUTLEDGE SPEC BUILDING CONCEPTUAL UTILITY PLAN	DRAWING
		SHEET #
2-22-22	TIERRA WEST, LLC 5571 MIDWAY PARK PL NE ALBUQUERQUE, NEW MEXICO 87109	MU-1
RONALD R. BOHANNAN P.E. #7868	(505) 858-3100 www.tierrawestllc.com	<i>JOB #</i> 2021051

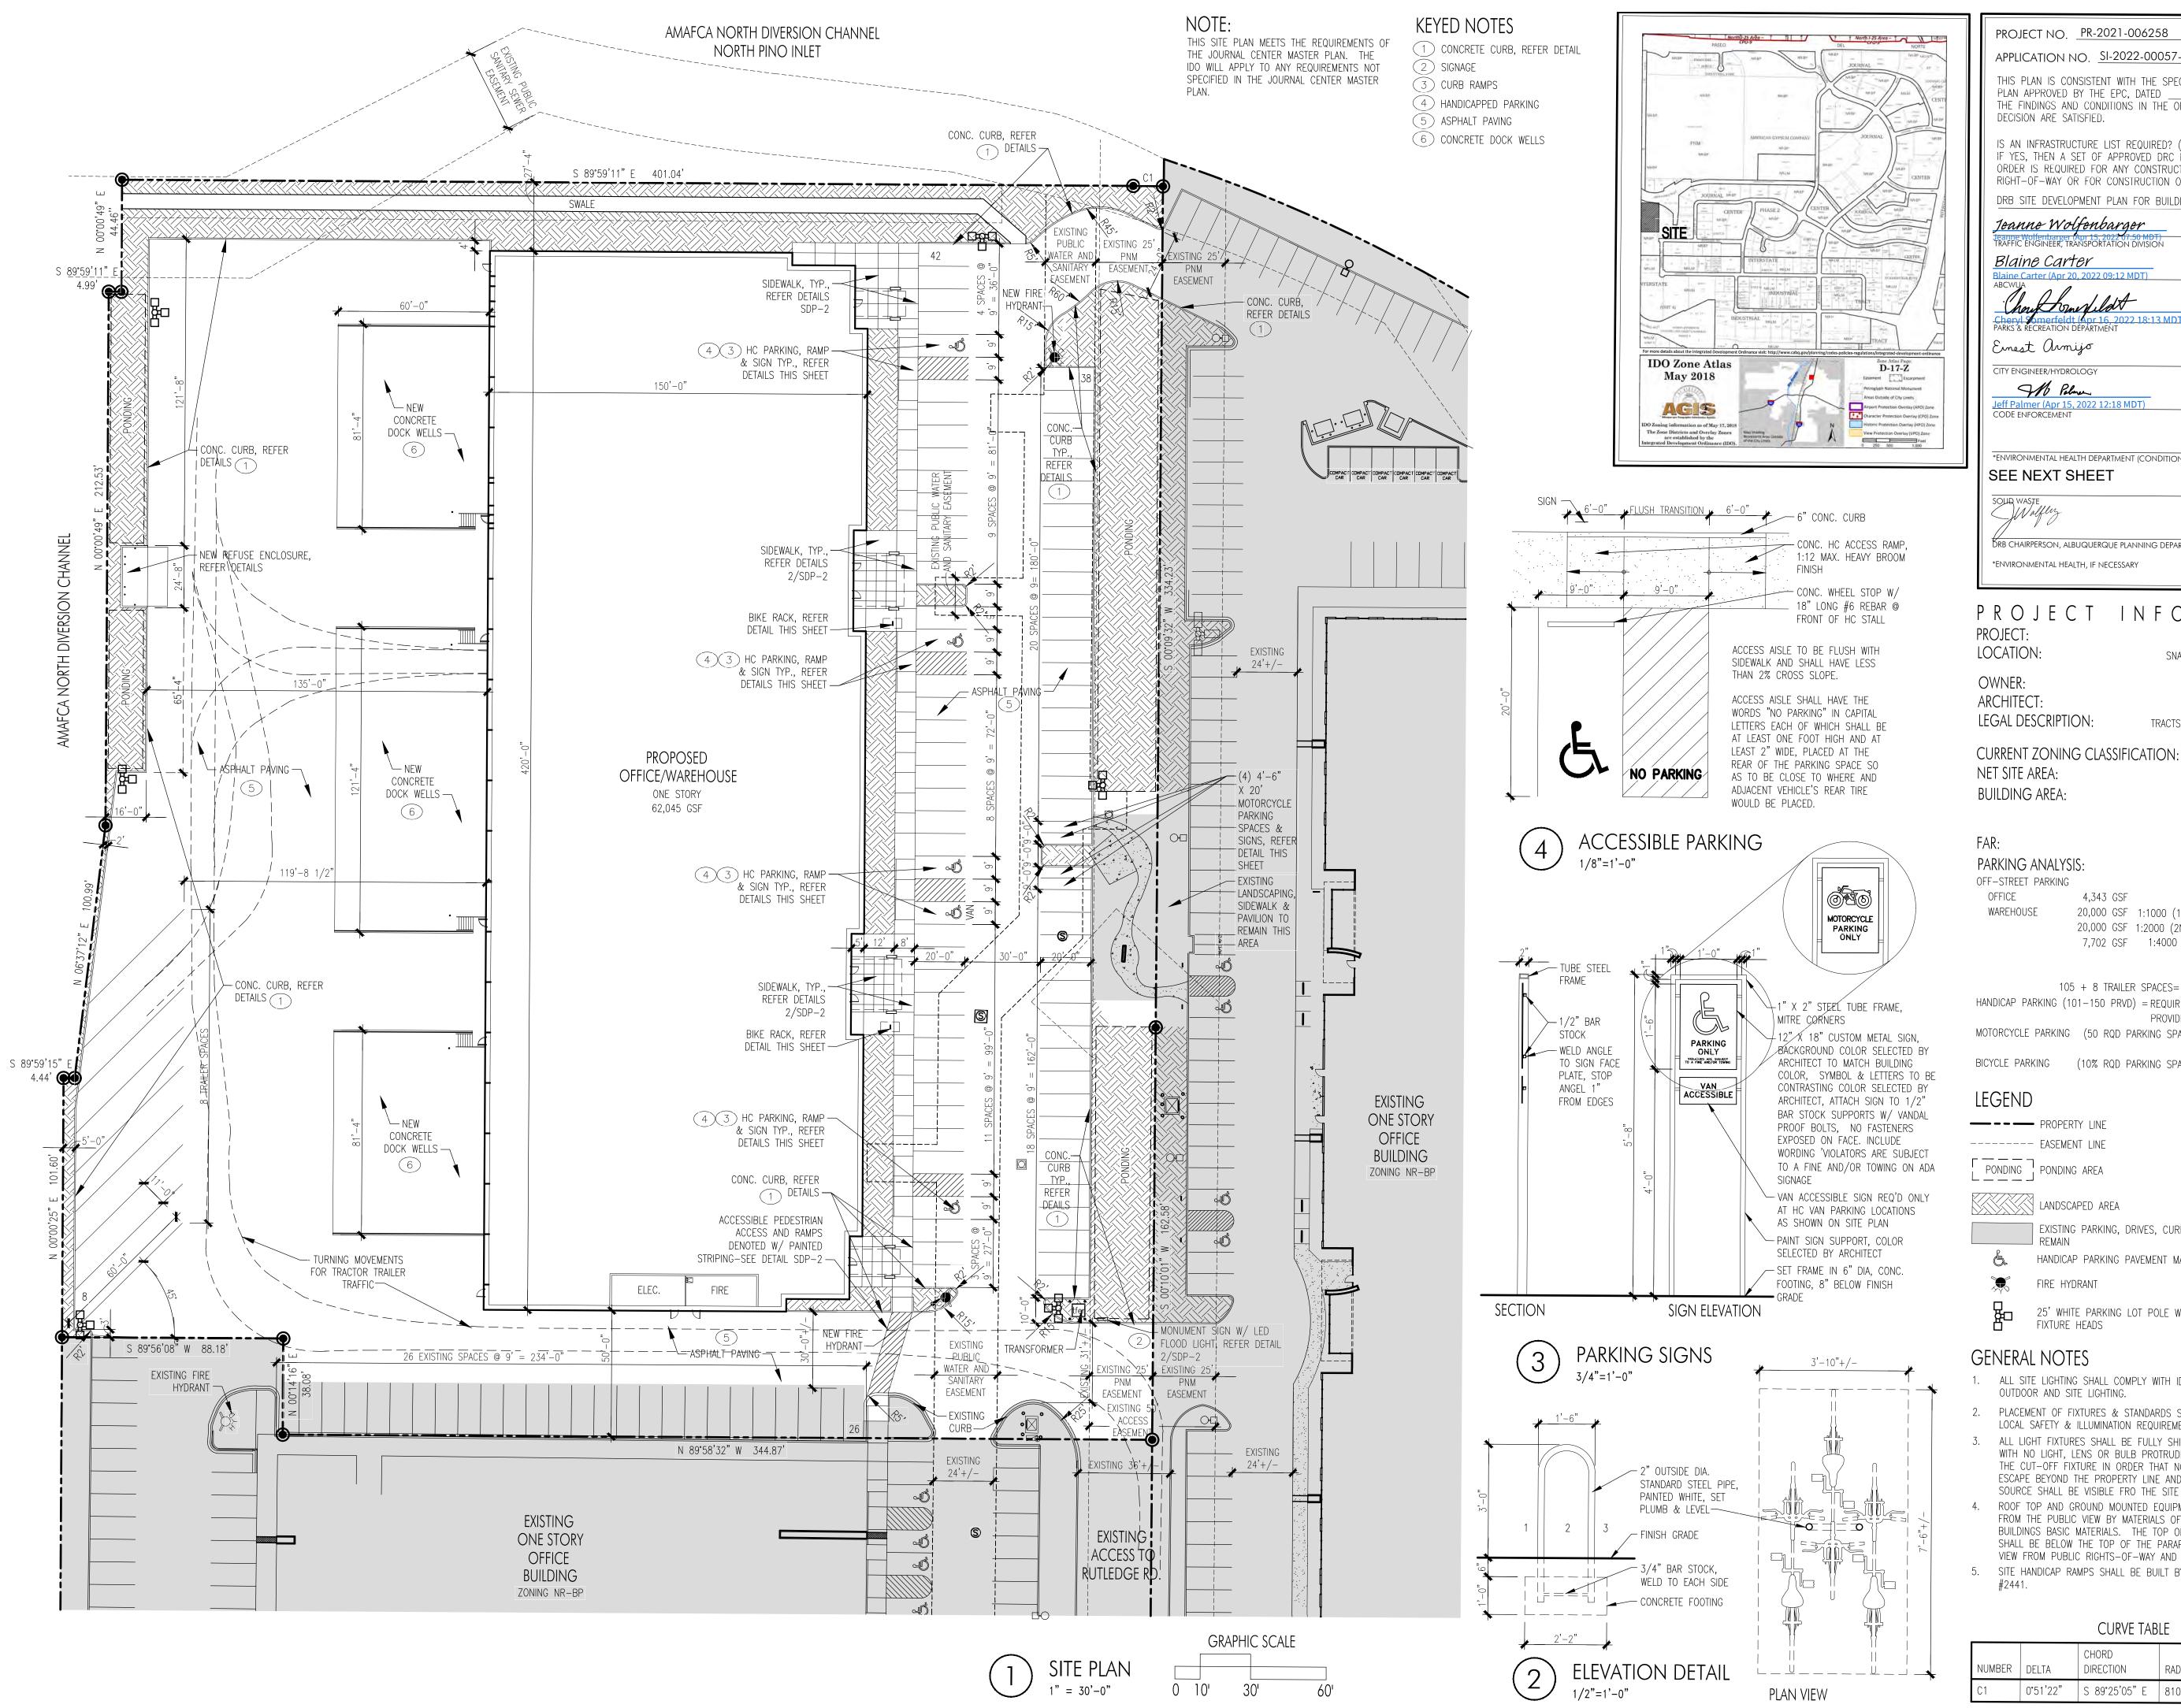

PROJECT NO. <u>PR-2021-006258</u>

APPLICATION NO. SI-2022-00057-SITE PLAN

THIS PLAN IS CONSISTENT WITH THE SPECIFIC SITE DEVELOPMENT PLAN APPROVED BY THE EPC, DATED THE FINDINGS AND CONDITIONS IN THE OFFICIAL NOTIFICATION OF DECISION ARE SATISFIED.

IS AN INFRASTRUCTURE LIST REQUIRED? () YES () NO IF YES, THEN A SET OF APPROVED DRC PLANS WITH A WORK ORDER IS REQUIRED FOR ANY CONSTRUCTION WITHIN PUBLIC RIGHT-OF-WAY OR FOR CONSTRUCTION OF PUBLIC IMPROVEMENTS.

DRB SITE DEVELOPMENT PLAN FOR BUILDING PERMIT: Jeanne Wolfenbarger Apr 15, 2022 Jeanne Wolfenbarger (Apr. 15, 2022 07.50 MDT)
TRAFFIC ENGINEER, TRANSPORTATION DIVISION

Blaine Carter Apr 20, 2022 Apr 16, 2022

Einest Urmijo Apr 15, 2022 CITY ENGINEER/HYDROLOGY All Polmer Apr 15, 2022

'ENVIRONMENTAL HEALTH DEPARTMENT (CONDITIONAL)

SEE NEXT SHEET

SOLID WASTE Walfley Apr 20, 2022 DRB CHAIRPERSON, ALBUQUERQUE PLANNING DEPARTMENT

*ENVIRONMENTAL HEALTH, IF NECESSARY

PROJECT INFORMATION PROJECT: NEW OFFICE/WAREHOUSE LOCATION: SNAPROLL & RUTLEDGE ROAD, NE

ALBUQUERQUE, NEW MEXICO OWNER: BRUNACINI DEVELOPMENT ARCHITECT: TATE FISHBURN ARCHITECT LEGAL DESCRIPTION TRACTS A-2-A AND A-3-A JOURNAL CENTER PHASE 2, UNIT 2

NET SITE AREA: 206,704 SF 4.7453 ACRES **BUILDING AREA:** OFFICE 4,343 GSF WAREHOUSE 57,702 GSF

PARKING ANALYSIS:

OFF-STREET PARKING OFFICE 1:300 = 15 SPACES20,000 GSF 1:1000 (1ST 20000SF) = 20 SPACES 20,000 GSF 1:2000 (2ND 20000SF) = 10 SPACES 7,702 GSF 1:4000 (REMAINDER) = 5 SPACES REQUIRED 50 SPACES

PROVIDED 105 SPACES 105 + 8 TRAILER SPACES= 113 TOTAL SPACES PROVIDED HANDICAP PARKING (101-150 PRVD) = REQUIRED 5 SPACES TOTAL (1 VAN) PROVIDED 5 SPACES TOTAL (1 VAN)

MOTORCYCLE PARKING (50 RQD PARKING SPACES) = REQUIRED 2 SPACES PROVIDED 4 SPACES BICYCLE PARKING (10% RQD PARKING SPACES) = REQUIRED 5 SPACES PROVIDED 6 SPACES

---- EASEMENT LINE

PONDING PONDING AREA

LANDSCAPED AREA

EXISTING PARKING, DRIVES, CURBS AND LANDSCAPING TO HANDICAP PARKING PAVEMENT MARKING

FIRE HYDRANT

25' WHITE PARKING LOT POLE W/ (3) 100 WATT LED FIXTURE HEADS

GENERAL NOTES

- 1. ALL SITE LIGHTING SHALL COMPLY WITH IDO SECTION 14-16-5-8. OUTDOOR AND SITE LIGHTING.
- PLACEMENT OF FIXTURES & STANDARDS SHALL CONFORM TO STATE & LOCAL SAFETY & ILLUMINATION REQUIREMENTS.
- ALL LIGHT FIXTURES SHALL BE FULLY SHIELDED HORIZONTAL LAMPS WITH NO LIGHT, LENS OR BULB PROTRUDING BELOW THE BOTTOM OF THE CUT-OFF FIXTURE IN ORDER THAT NO FUGITIVE LIGHT SHALL ESCAPE BEYOND THE PROPERTY LINE AND NO SITE LIGHTING LIGHT SOURCE SHALL BE VISIBLE FRO THE SITE PERIMETER.
- ROOF TOP AND GROUND MOUNTED EQUIPMENT SHALL BE SCREENED FROM THE PUBLIC VIEW BY MATERIALS OF THE SAME NATURE AS THE BUILDINGS BASIC MATERIALS. THE TOP OF ALL ROOFTOP EQUIPMENT SHALL BE BELOW THE TOP OF THE PARAPET OR SCREENED FROM VIEW FROM PUBLIC RIGHTS-OF-WAY AND THE SITE ACCESS EASEMENT. 5. SITE HANDICAP RAMPS SHALL BE BUILT BY COA STANDARD DRAWING

CURVE TABLE

NUMBER	DELTA	CHORD DIRECTION	RADIUS	LENGTH	CHORD LENGTH
21	0°51'22"	S 89°25'05" E	810.00'	12.10'	12.10'

ARCHITECT SEAL TATE FISHBURN

PROJECT

62,045 GSF

ENGINEER SEAL

ш PROLL E


FEBRUARY 16, 2022


REVISIONS

1"=30' OR AS NOTED DRAWING NAME SITE DEVELOPMENT

PLAN FOR **BUILDING PERMIT**

SHEET NUMBER

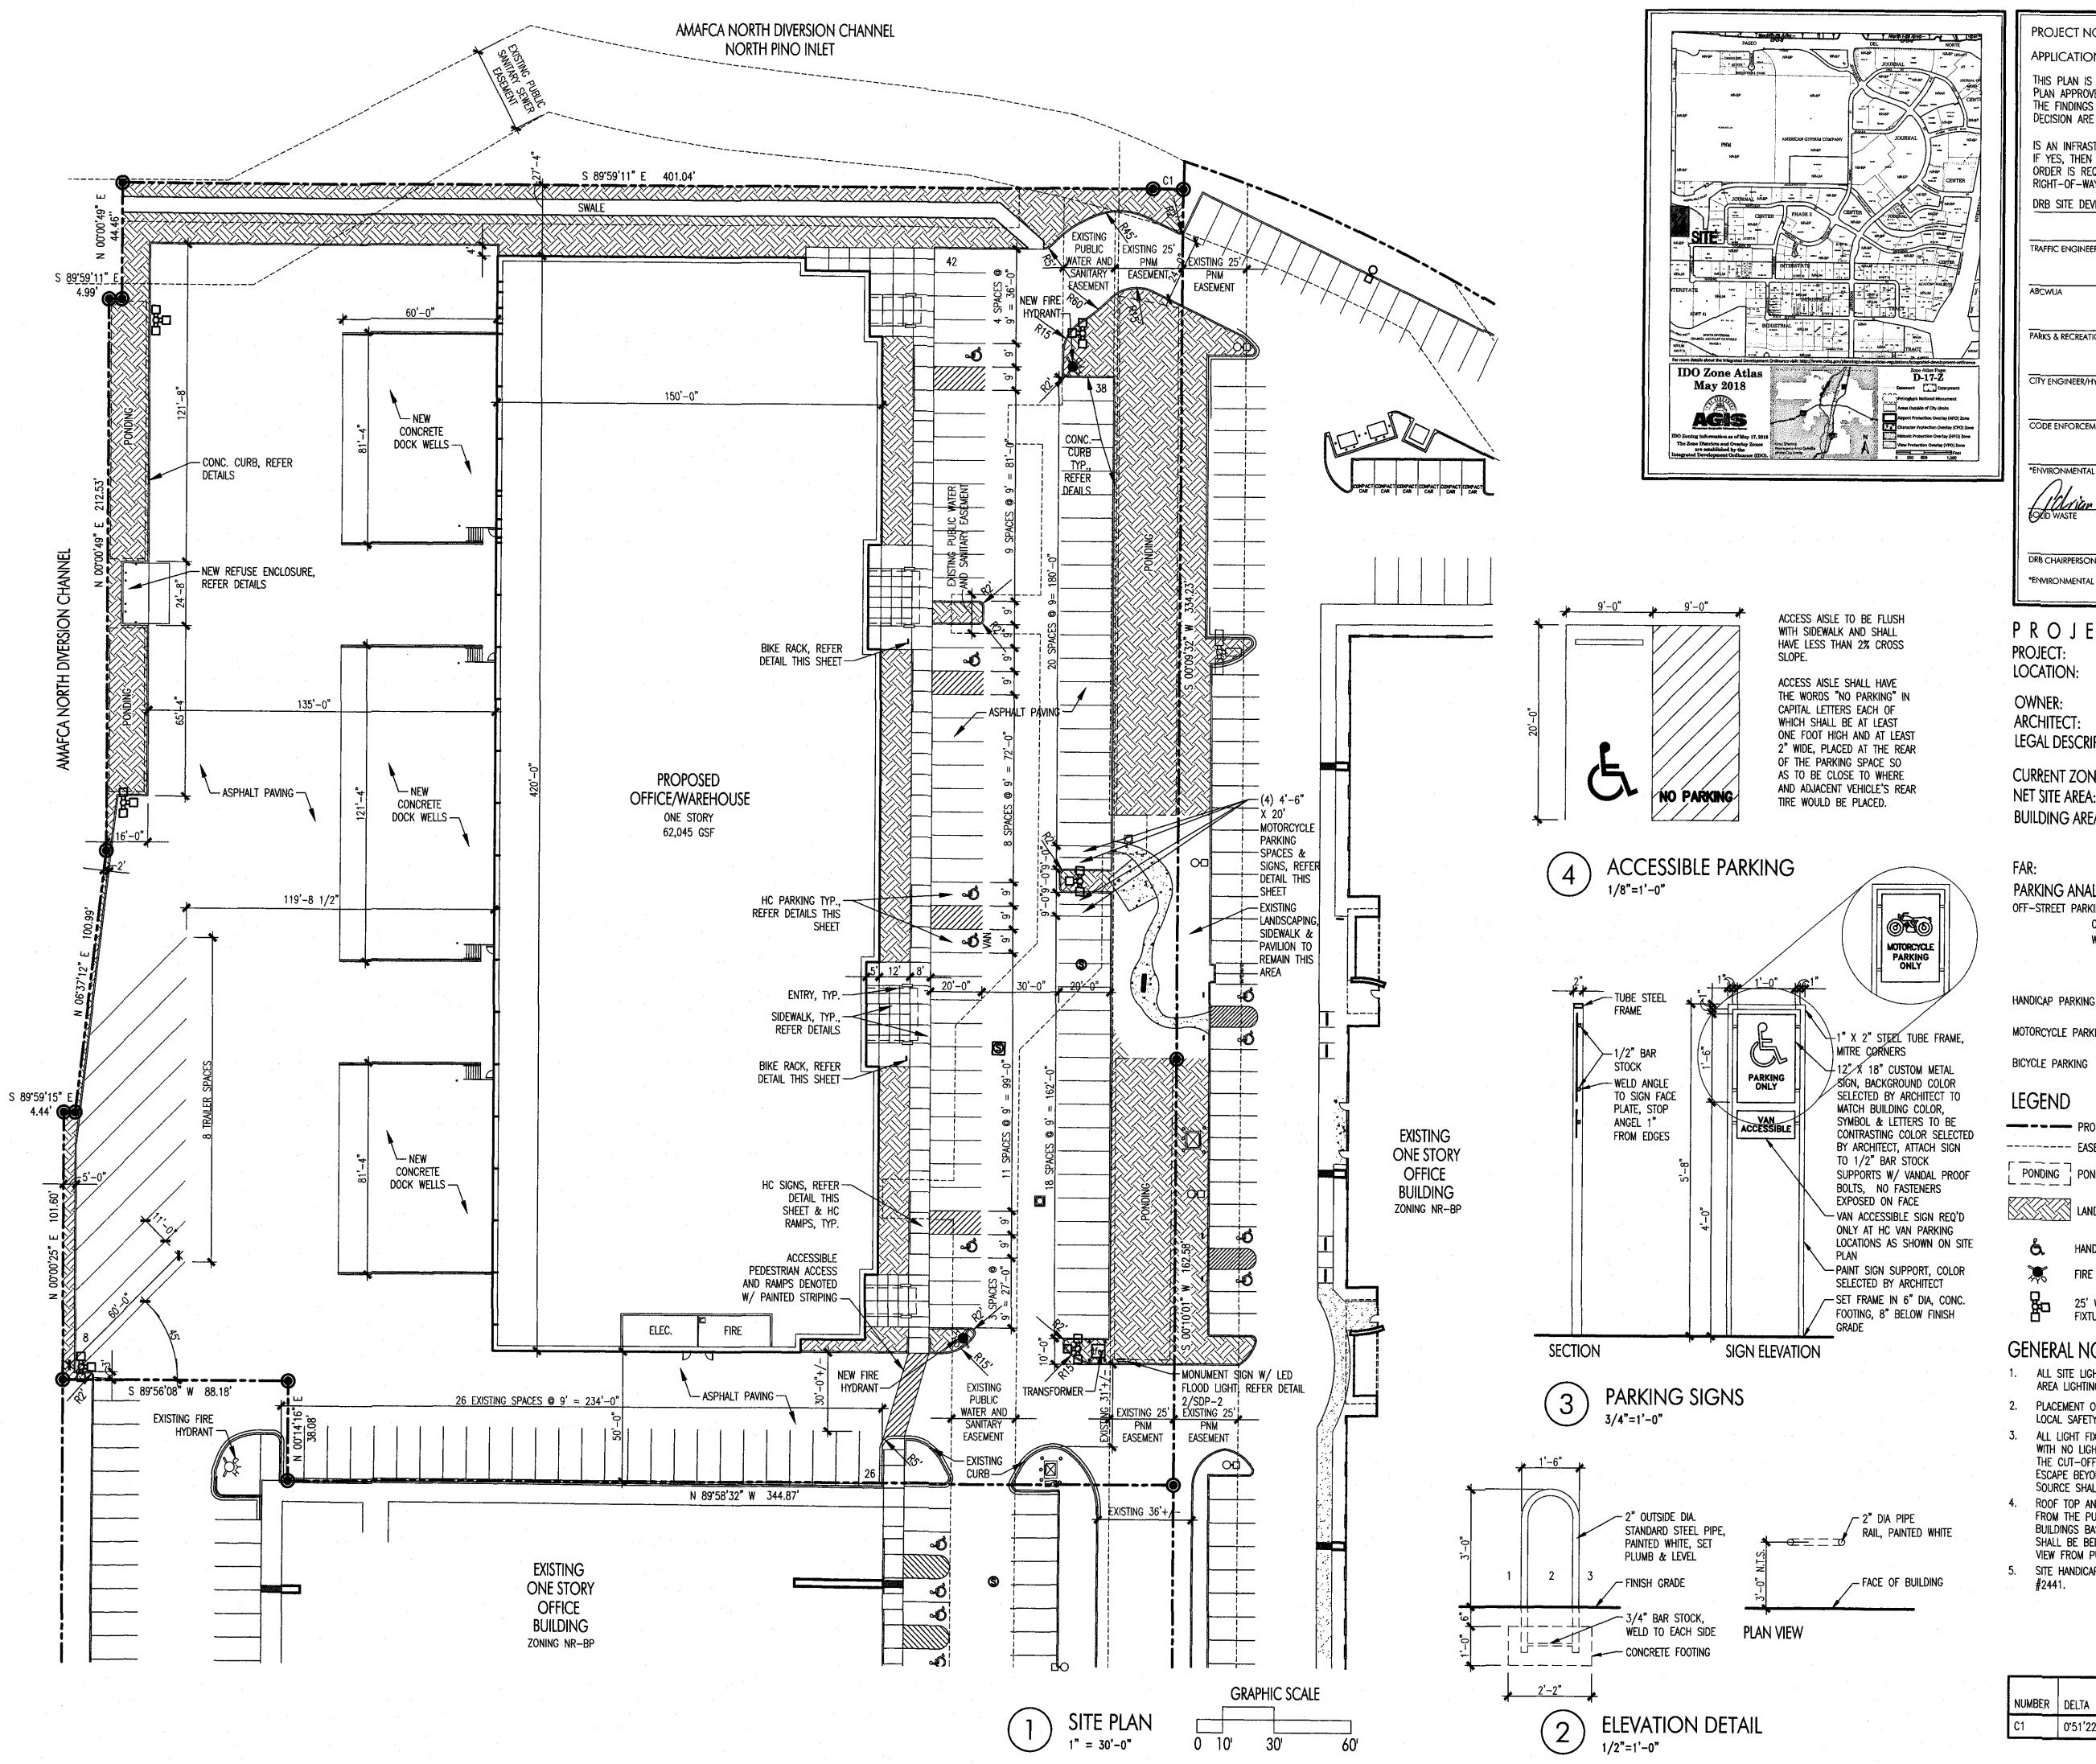

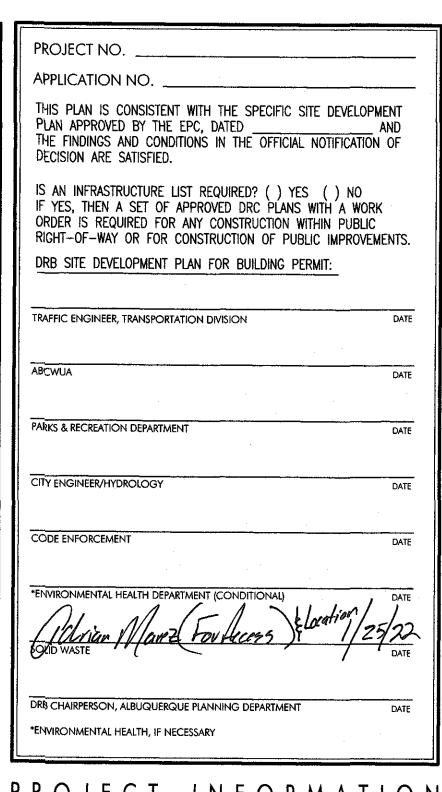



9721 RUTLEDGE ROAD, NE

ALBUQUERQUE, NEW MEXICO

BRUNACINI DEVELOPMENT

TATE FISHBURN ARCHITECT

CENTER PHASE 2, UNIT 2

206,704 SF 4.7453 ACRES

WAREHOUSE 57,702 GSF

REQUIRED 5 SPACES TOTAL (1 VAN)

PROVIDED 5 SPACES TOTAL (1 VAN)

REQUIRED 3 SPACES

PROVIDED 4 SPACES

REQUIRED 7 SPACES

PROVIDED 9 SPACES

OFFICE 4,343 GSF

62,045 GSF

LOCATION: OWNER:

ARCHITECT: LEGAL DESCRIPTION:

TRACTS A-2-A AND A-3-A JOURNAL **CURRENT ZONING CLASSIFICATION:**

NET SITE AREA: BUILDING AREA:

FAR:

PARKING ANALYSIS: OFF-STREET PARKING

OFFICE 4,343 GSF WAREHOUSE 57,702 GSF 0 = 0 SPACES REQUIRED 16 SPACES PROVIDED 105 SPACES 105 + 8 TRAILER SPACES= 113 TOTAL SPACES PROVIDED

MOTORCYCLE PARKING

BICYCLE PARKING

LEGEND

----- EASEMENT LINE

PONDING PONDING AREA LANDSCAPED AREA

HANDICAP PARKING PAVEMENT MARKING

FIRE HYDRANT


25' WHITE PARKING LOT POLE W/ (3) 100 WATT LED

GENERAL NOTES

- 1. ALL SITE LIGHTING SHALL BE CONSISTENT WITH SECTION 14-16-9, AREA LIGHTING REGULATIONS & NIGHT SKY ORDINANCE.
- 2. PLACEMENT OF FIXTURES & STANDARDS SHALL CONFORM TO STATE & LOCAL SAFETY & ILLUMINATION REQUIREMENTS.
- 3. ALL LIGHT FIXTURES SHALL BE FULLY SHIELDED HORIZONTAL LAMPS WITH NO LIGHT, LENS OR BULB PROTRUDING BELOW THE BOTTOM OF THE CUT-OFF FIXTURE IN ORDER THAT NO FUGITIVE LIGHT SHALL ESCAPE BEYOND THE PROPERTY LINE AND NO SITE LIGHTING LIGHT SOURCE SHALL BE VISIBLE FRO THE SITE PERIMETER.
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CURVE TABLE

NUMBER	DELTA	CHORD DIRECTION	RADIUS	LENGTH	CHORD LENGTH
C1	0'51'22"	S 89°25'05" E	810.00'	12.10'	12.10'

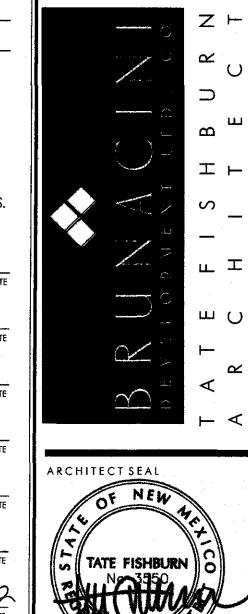

PROJECT

ENGINEERSEAL

8 ARE RUTI


REVISIONS

·	
ΑΤΕ	DECEMBER 8, 20
NORTH	SCA
	1"=3
	OR AS NOTE

DRAWING NAME

SITE DEVELOPMENT PLAN FOR **BUILDING PERMIT**

SHEET NUMBER

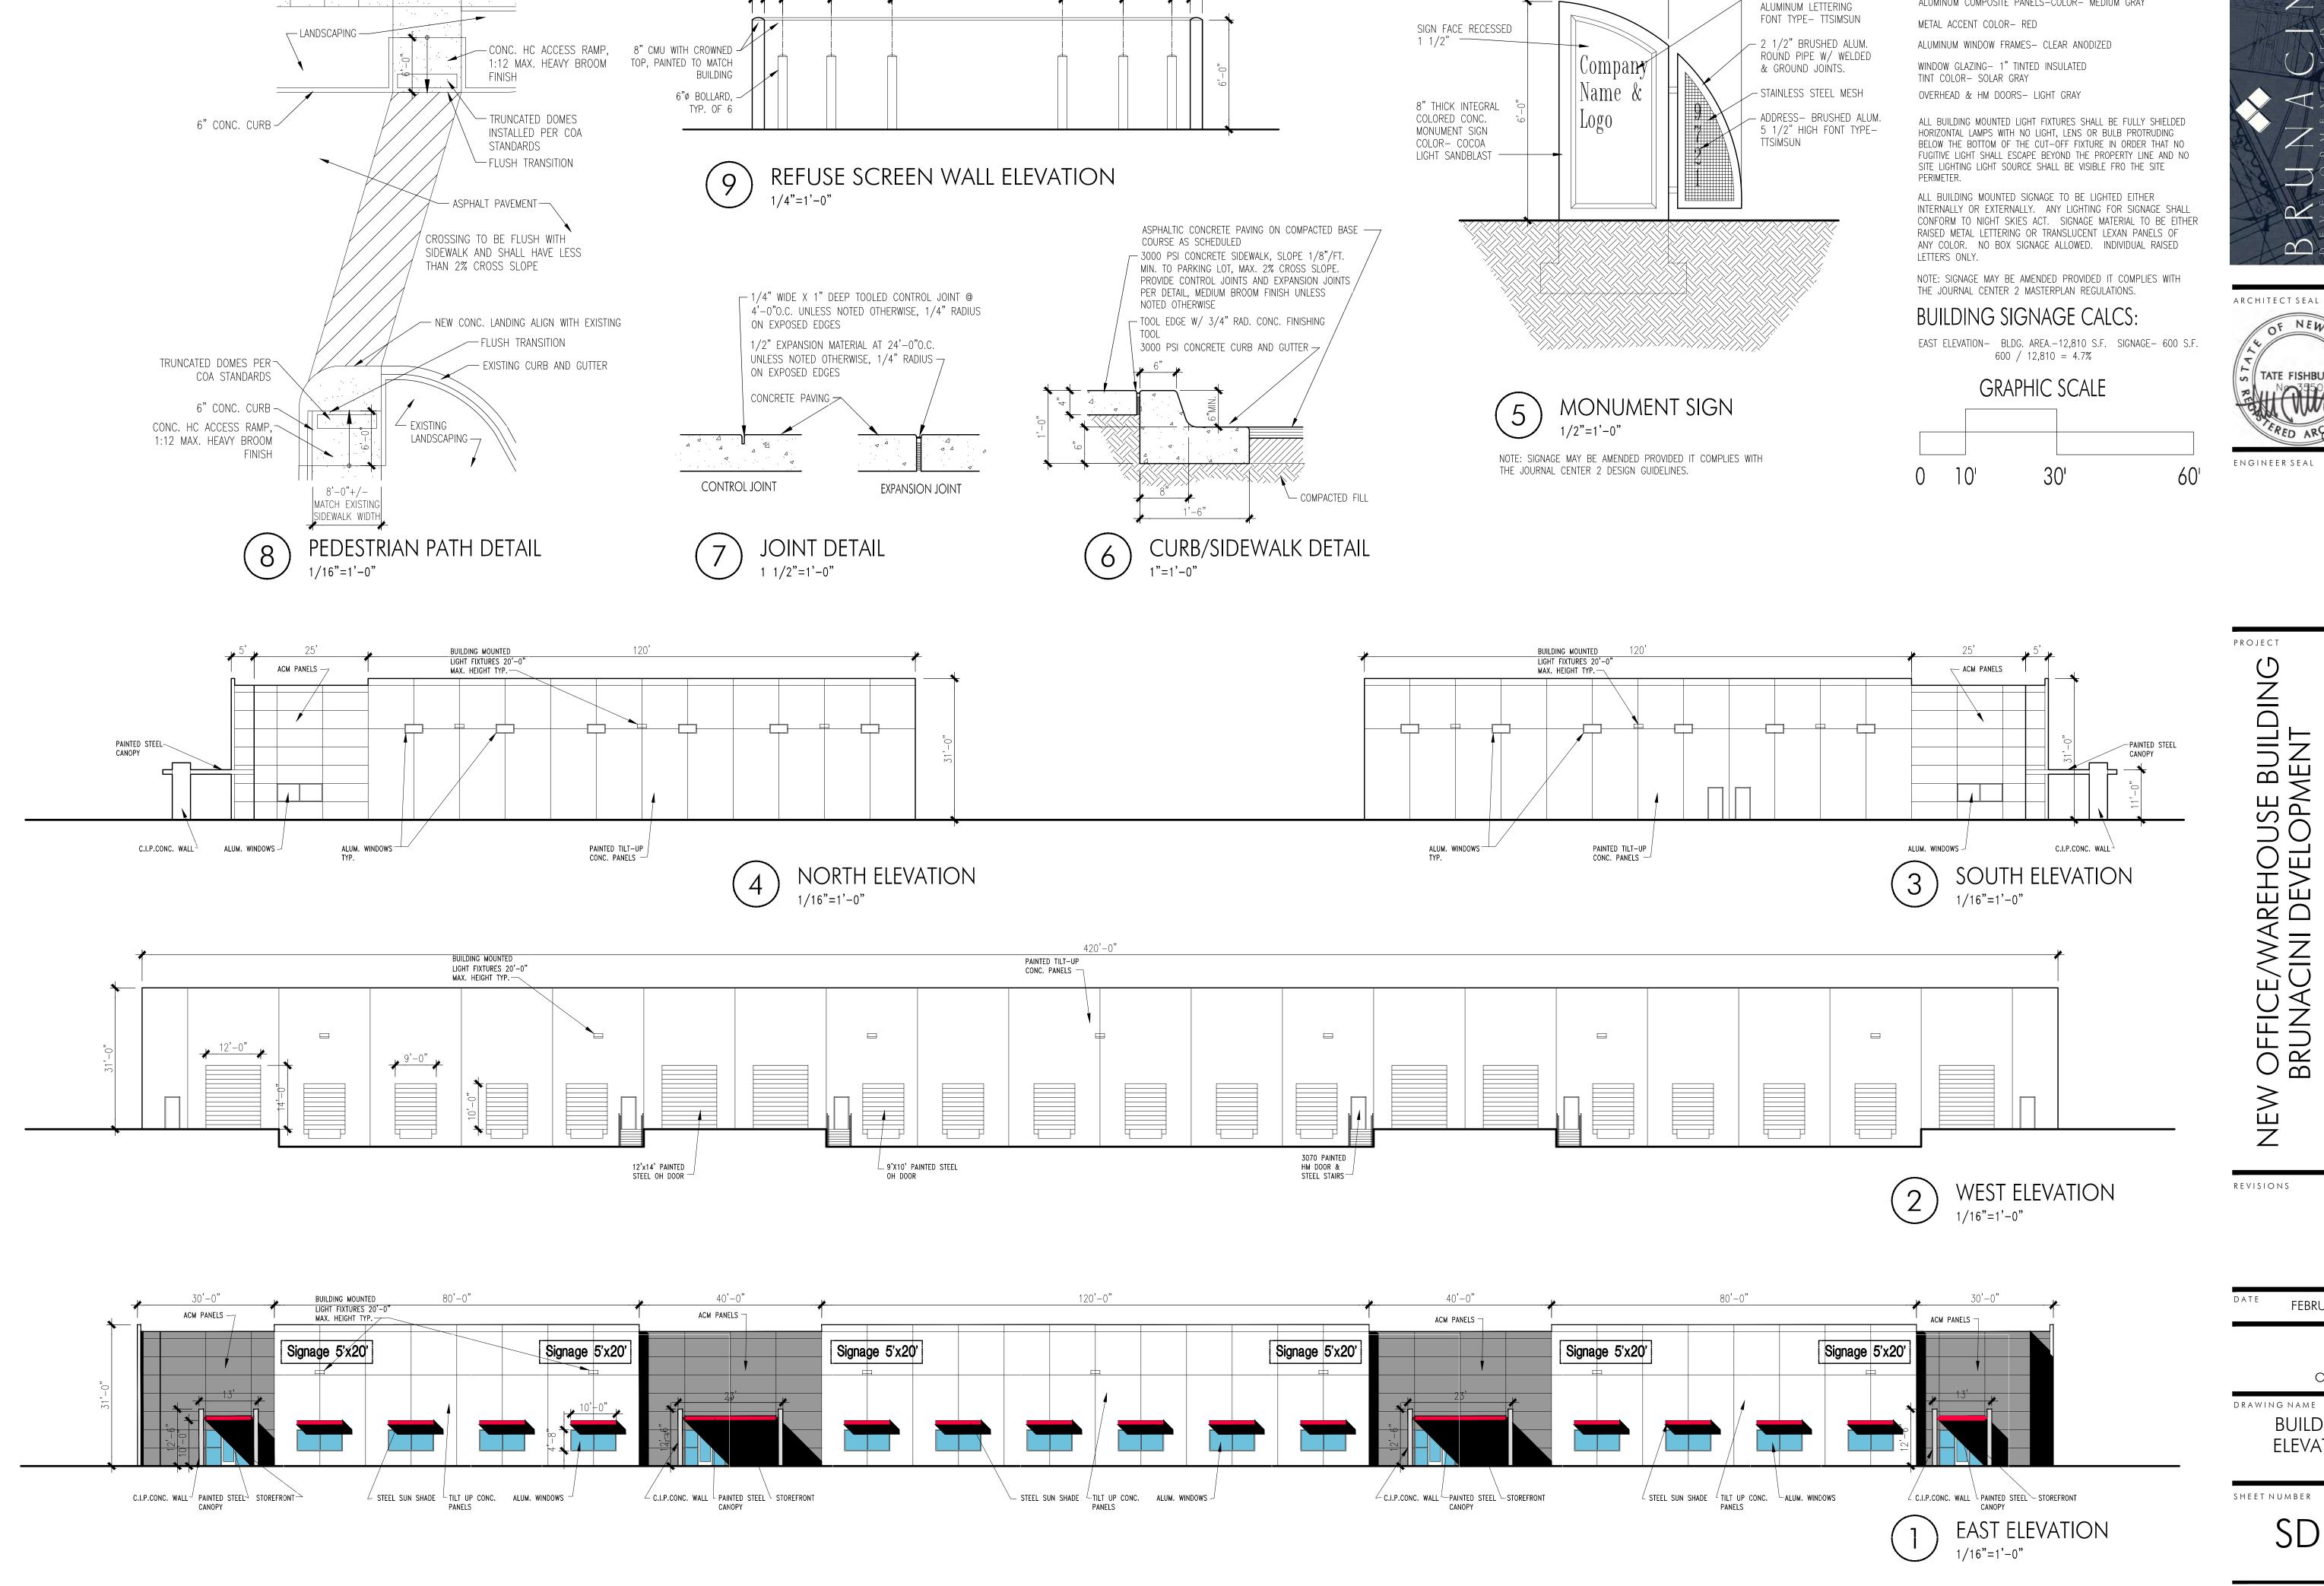

24'-8"

9'-4"

SIDEWALK, MAX. 2%


CROSS SLOPE

EXTERIOR FINISHES

TILT-UP CONC. PANELS- COLOR - LIGHT GRAY

-6" RAISED BRUSHED

ALUMINUM COMPOSITE PANELS-COLOR- MEDIUM GRAY

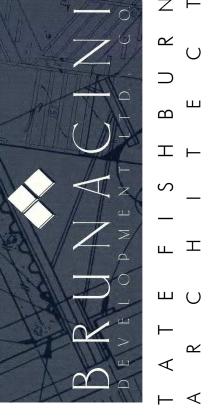




FEBRUARY 16, 2022

1/16"=1'-0" OR AS NOTED

BUILDING ELEVATIONS

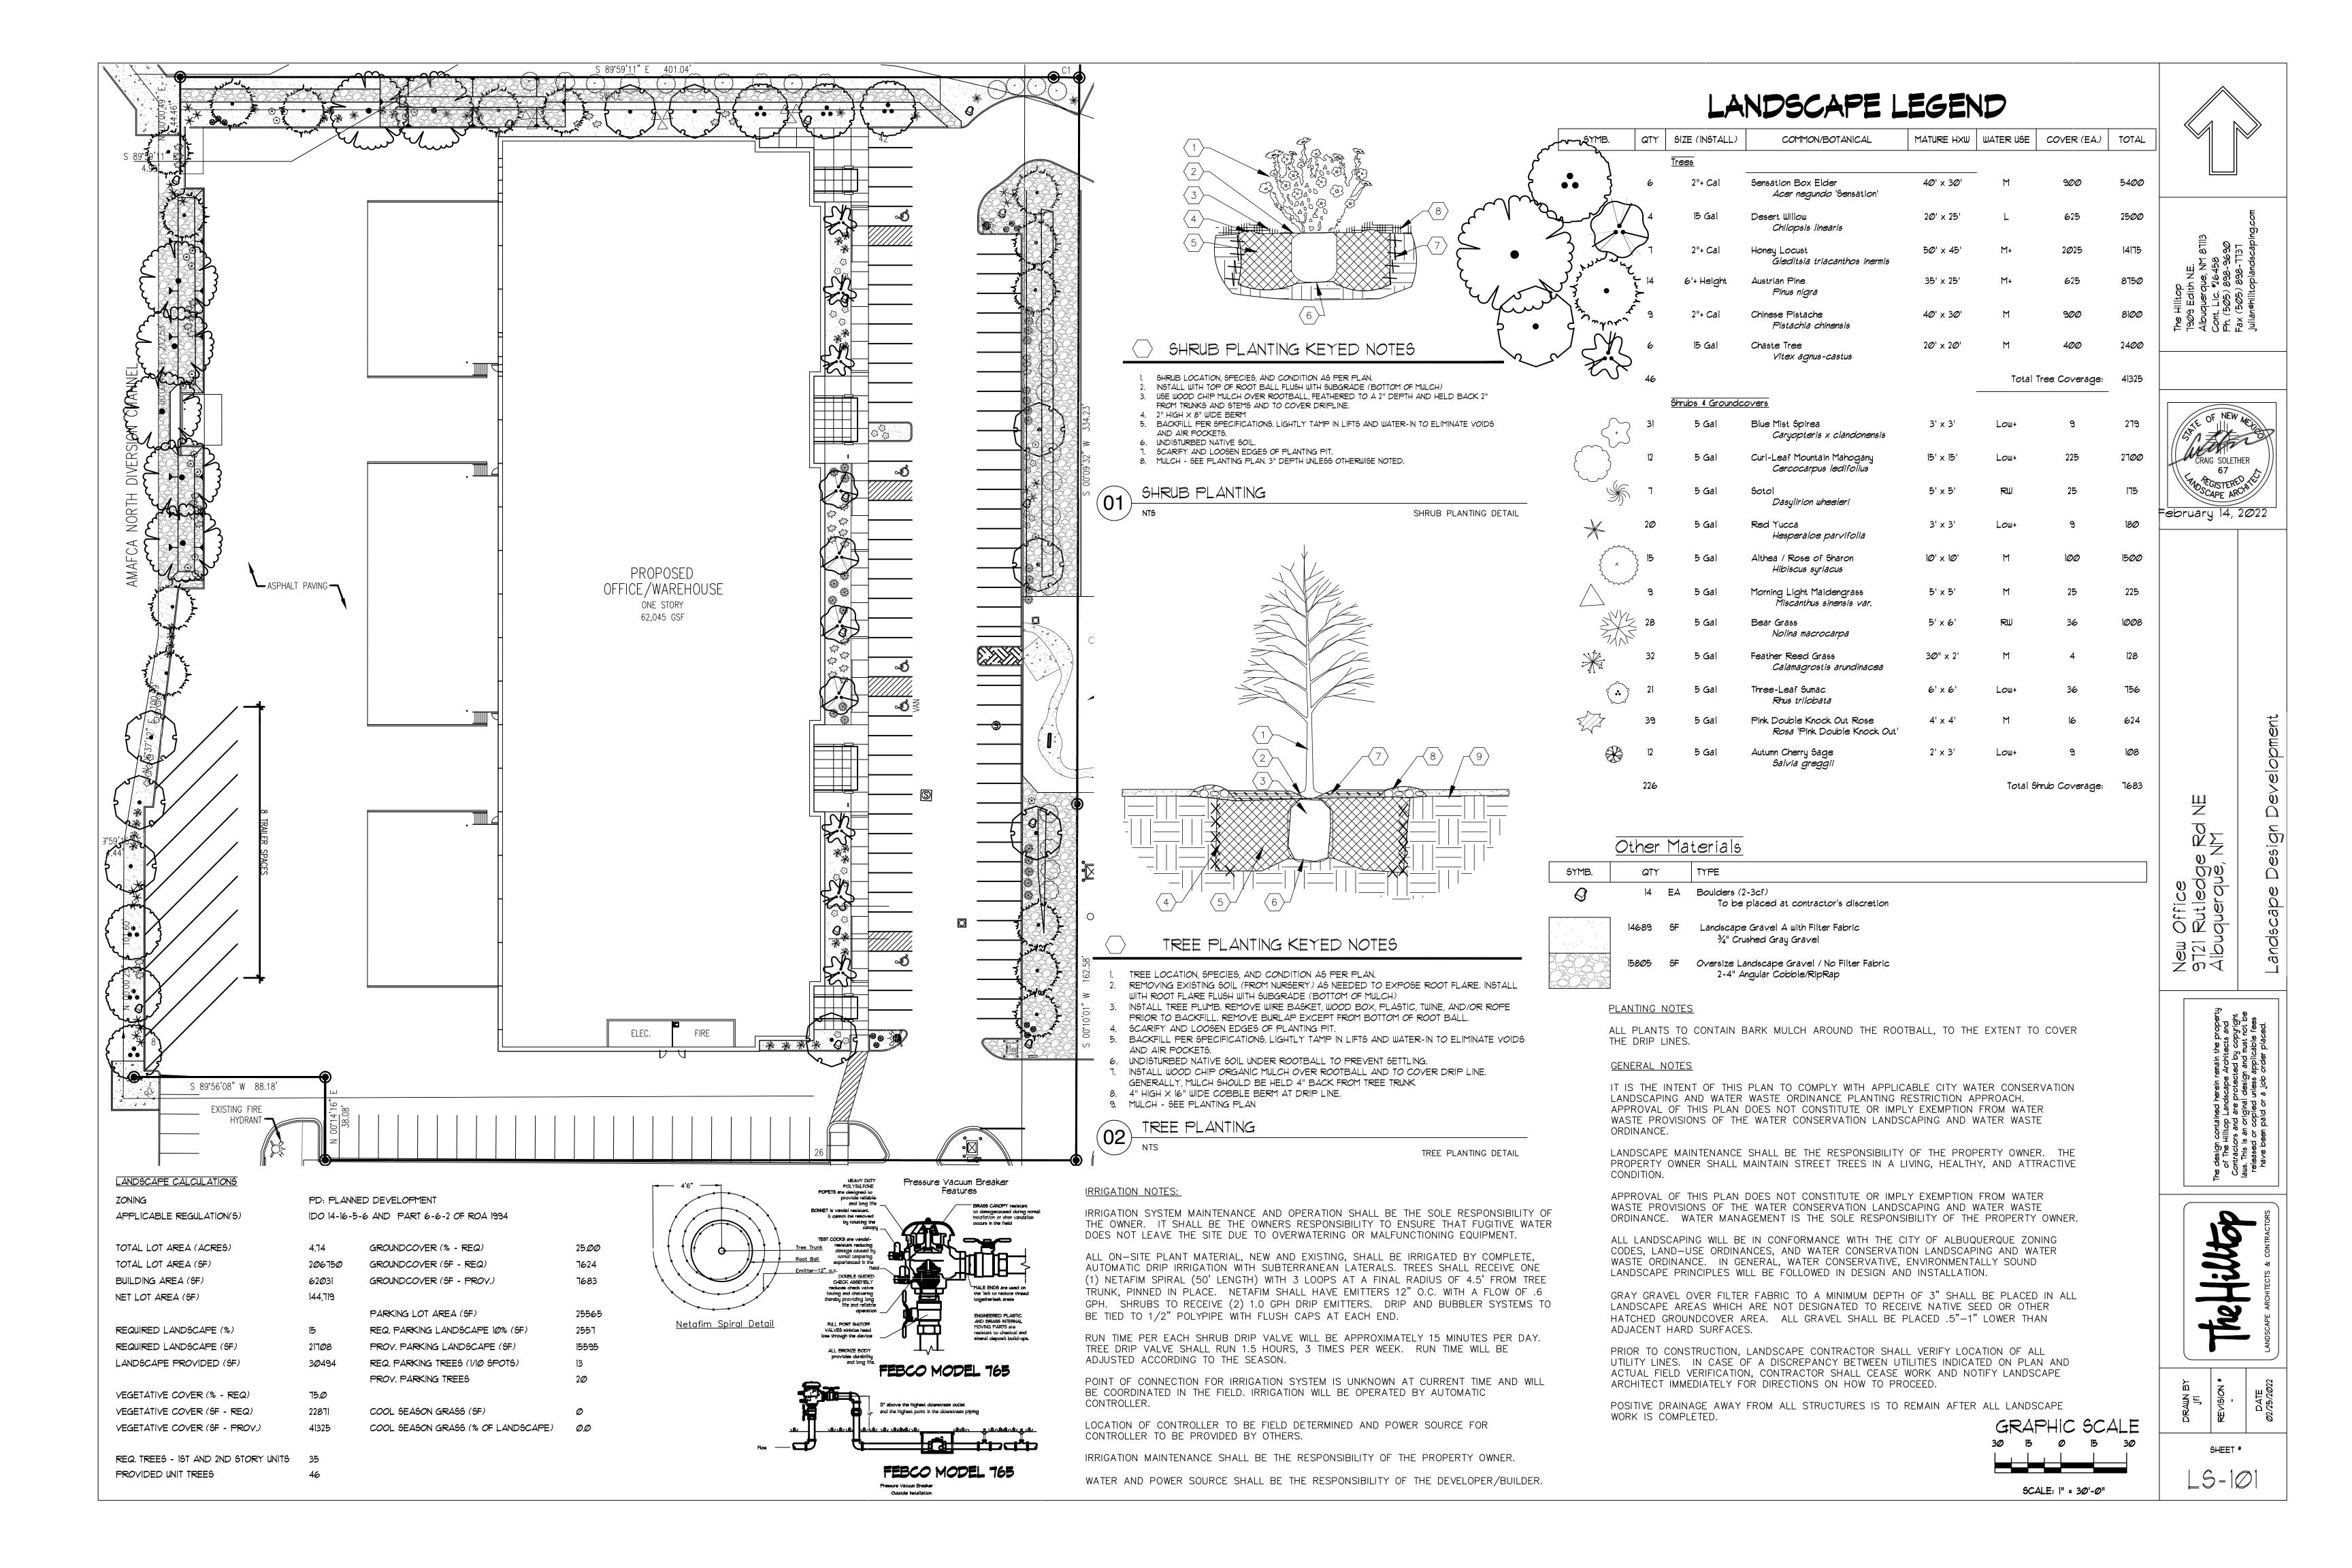

PR-2021-006258_SI-2022-00057_Site_Plan_Ap proved_3-9-22

Final Audit Report 2022-04-20

Created: 2022-04-15

By: Jay Rodenbeck (jrodenbeck@cabq.gov)

Status: Signed

Transaction ID: CBJCHBCAABAA73EyijL9yHlOUoesmbqDlclagV0qkX3d

"PR-2021-006258_SI-2022-00057_Site_Plan_Approved_3-9-22" History

- Document created by Jay Rodenbeck (jrodenbeck@cabq.gov) 2022-04-15 0:02:15 AM GMT
- Document emailed to Jolene Wolfley, CABQ Planning (jwolfley@cabq.gov) for signature 2022-04-15 0:06:17 AM GMT
- Document emailed to Jeanne Wolfenbarger (jwolfenbarger@cabq.gov) for signature 2022-04-15 0:06:17 AM GMT
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- Document emailed to Cheryl Somerfeldt (csomerfeldt@cabq.gov) for signature 2022-04-15 0:06:17 AM GMT
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- Email viewed by Jeanne Wolfenbarger (jwolfenbarger@cabq.gov) 2022-04-15 1:45:04 PM GMT



Document e-signed by Jeanne Wolfenbarger (jwolfenbarger@cabq.gov)

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Email viewed by Blaine Carter (bcarter@abcwua.org)
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Email viewed by Blaine Carter (bcarter@abcwua.org) 2022-04-19 - 2:06:47 AM GMT- IP address: 174.240.22.89

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Document e-signed by Blaine Carter (bcarter@abcwua.org)

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Email viewed by Jolene Wolfley, CABQ Planning (jwolfley@cabq.gov) 2022-04-20 - 10:36:29 PM GMT

Document e-signed by Jolene Wolfley, CABQ Planning (jwolfley@cabq.gov)
Signature Date: 2022-04-20 - 10:37:10 PM GMT - Time Source: server

Agreement completed.
 2022-04-20 - 10:37:10 PM GMT