

OTHER IMPACTS ASSOCIATED WITH PROXIMITY TO THIS FACILITY

16		IARKANA MO Evelopment					
11 L. 10	Andread and and an or own	STORY RESIDENT	an an concernant in Arman	ANAGI			2/2
UNIT NAME	UNIT TYPE	NET AREA(SF)	UNIT	BEDS COUNT	UNITS %	TOTAL AREA	% BREAKDOWN
			0	0	C 70/	070 05	
UNIT A1L UNIT A1U	1BR/1BA 1BR/1BA	859 SF 859 SF	8	8	6.7% 6.7%	6873 SF 6868 SF	
UNIT A2	1BR/1BA	699 SF	12	12	10.0%	8390 SF	
UNIT A2-TYPE A	1BR/1BA	699 SF	2	2	1.7%	1398 SF	60%
UNIT A3	1BR/2BA	776 SF	28	28	23.3%	21714 SF	
UNIT A4	1BR/1BA	781 SF	8	8	6.7%	6248 SF	
UNIT A5	1BR/1BA	845 SF	6	6	5.0%	5072 SF	
UNIT B1	2BR/2BA	1139 SF	22	44	18.3%	25053 SF	
UNIT B2	2BR/2BA	1347 SF	3	6	2.5%	4041 SF	
UNIT B2-ALT1	2BR/2BA	1318 SF	2	4	1.7%	2636 SF	
UNIT B2-ALT2	8-10-203 Secon-10-200 Is	1347 SF	1	2	0.8%	1347 SF	
JNIT B2-ALT3	2BR/2BA	1318 SF	1	2	0.8%	1318 SF	40%
UNIT B2-TYPE A	2BR/2BA	1750 SF	1	2	0.8%	1750 SF	
UNIT B3	2BR/2BA	1219 SF	2	4	1.7%	2438 SF	
UNIT B4	2BR/2BA	1073 SF	16 120	32 168	13.3% 100.0%	17175 SF 112322 SF	
NET AREA IS COMP NCLUDE PATIOS, BA PROJECT UNIT AVERAG	PUTED TO INCLU ALCONIES, PATIC	DE SQUARE FOOTAGE FRO VBALCONY STORAGE.	OM EXTERIOR	S.F.		WALLS THAT ENCLOS	SE A/C SPACE. IT DOES N
	PUTED TO INCLU ALCONIES, PATIC	DE SQUARE FOOTAGE FRO VBALCONY STORAGE.	0M EXTERIOR 4.27 28			WALLS THAT ENCLOS	SE A/C SPACE. IT DOES N
NET AREA IS COMP NCLUDE PATIOS, BA PROJECT UNIT AVERACE ACREAGE: DENSITY:	PUTED TO INCLU ALCONIES, PATIC DATA BE NET SF :	DE SQUARE FOOTAGE FRO VBALCONY STORAGE.	4.27	S.F. GROSS /		WALLS THAT ENCLOS	SE A/C SPACE. IT DOES N
NET AREA IS COMP NCLUDE PATIOS, BA PROJECT UNIT AVERAC ACREAGE:	PUTED TO INCLU ALCONIES, PATIC DATA BE NET SF :	DE SQUARE FOOTAGE FRO VBALCONY STORAGE.	4.27	S.F. GROSS / UNITS/A	ACRES		SE A/C SPACE. IT DOES N
NET AREA IS COMP NCLUDE PATIOS, B/ PROJECT UNIT AVERAC ACREAGE: DENSITY: VEHICULAR I REQUIRED	Puted to Inclui Lonies, Patic DATA SE NET SF : PARKING:	DE SQUARE FOOTAGE FR VBALCONY STORAGE.	4.27 28 180	S.F. GROSS A UNITS/A	ACRES CRE 1.5 space		SE A/C SPACE. IT DOES N
NET AREA IS COMP NCLUDE PATIOS, BA PROJECT UNIT AVERAC ACREAGE: DENSITY: VEHICULAR I	Puted to inclui Liconies, Patic DATA SE NET SF : PARKING: RPORT PAR	DE SQUARE FOOTAGE FR VBALCONY STORAGE.	4.27 28	S.F. GROSS / UNITS/AU SPACES SPACES PER IDO DESIGNE	ACRES CRE 1.5 space 5-5(F)(1) 25	s / DU % OF TOTAL P ACT PARKING	PARKING MAY BE
NET AREA IS COMP NCLUDE PATIOS, B/ PROJECT UNIT AVERAGE ACREAGE: DENSITY: VEHICULAR I REQUIRED SURFACE/CA	Puted to Inclui Loonies, Patic DATA SE NET SF : PARKING: RPORT PAR	DE SQUARE FOOTAGE FR VBALCONY STORAGE.	4.27 28 180 113	S.F. GROSS / UNITS/AU SPACES SPACES PER IDO DESIGNE	ACRES CRE 1.5 space 5-5(F)(1) 25 ED AS COMP 3 SPACES A	s / DU % OF TOTAL P ACT PARKING	ARKING MAY BE
NET AREA IS COMP NCLUDE PATIOS, B/ PROJECT UNIT AVERAGE: DENSITY: VEHICULAR I REQUIRED SURFACE/CA SURFACE CO	Puted to inclui Loonies, Patic DATA SE NET SF : PARKING: MPACT PAR ARKING	DE SQUARE FOOTAGE FR VBALCONY STORAGE.	4.27 28 180 113 31	S.F. GROSS / UNITS/AU SPACES SPACES PER IDO DESIGNE PARKING SPACES	ACRES CRE 1.5 space 5-5(F)(1) 25 ED AS COMP 3 SPACES A	s / DU % OF TOTAL P ACT PARKING	PARKING MAY BE
NET AREA IS COMP NCLUDE PATIOS, B/ PROJECT UNIT AVERACE ACREAGE: DENSITY: VEHICULAR I REQUIRED SURFACE/CA SURFACE CO	Puted to Inclui LCONIES, PATIC DATA E NET SF : PARKING: MPACT PAI ARKING PARKING	DE SQUARE FOOTAGE FR VBALCONY STORAGE.	4.27 28 180 113 31 7	S.F. GROSS / UNITS/AU SPACES SPACES PER IDO DESIGNE PARKING SPACES	ACRES CRE 1.5 space 5-5(F)(1) 25 ED AS COMP 3 SPACES A 1 SPACE = 2	s / DU % of total p Act parking Llowed)	PARKING MAY BE
NET AREA IS COMP NCLUDE PATIOS, B/ PROJECT UNIT AVERAGE ACREAGE: DENSITY: VEHICULAR I REQUIRED SURFACE/CA SURFACE/CA SURFACE CO ADA/1 VAN P/ EV SURFACE GARAGE PAR EV GARAGE F	Puted to inclui Loonies, Patic DATA SE NET SF : PARKING: MPACT PAR MPACT PAR ARKING PARKING PARKING PARKING	DE SQUARE FOOTAGE FR VBALCONY STORAGE.	4.27 28 180 113 31 7 2	S.F. GROSS A UNITS/AU SPACES SPACES PER IDO DESIGNE PARKING SPACES SPACES SPACES	ACRES CRE 1.5 space 5-5(F)(1) 25 ED AS COMP G SPACES A 1 SPACE = 2	s / DU % of total p Act parking Llowed)	PARKING MAY BE 3 (36 COMPACT (C)(5)(d)
NET AREA IS COMP NCLUDE PATIOS, B/ PROJECT UNIT AVERAGE ACREAGE: DENSITY: VEHICULAR I REQUIRED SURFACE/CA SURFACE/CA SURFACE CO ADA/1 VAN P/ EV SURFACE GARAGE PAR EV GARAGE F TANDEM PAR	Puted to inclui Loonies, Patic DATA SE NET SF : PARKING: MPACT PAR MPACT PAR ARKING PARKING PARKING PARKING	DE SQUARE FOOTAGE FR VBALCONY STORAGE.	4.27 28 180 113 31 7 2 23 4 0	S.F. GROSS A UNITS/AU SPACES SPACES PER IDO DESIGNE PARKINO SPACES SPACES SPACES SPACES SPACES	ACRES CRE 1.5 space 5-5(F)(1) 25 ED AS COMP 3 SPACES A 1 SPACE = 2 1 SPACE = 2	s / DU % OF TOTAL P ACT PARKING LLOWED) 2 PER IDO 5-56	PARKING MAY BE 3 (36 COMPACT (C)(5)(d)
NET AREA IS COMP NCLUDE PATIOS, B/ PROJECT UNIT AVERAG ACREAGE: DENSITY: VEHICULAR I REQUIRED SURFACE/CA SURFACE/CA SURFACE CO ADA/1 VAN P/ EV SURFACE GARAGE PAR	Puted to inclui Loonies, Patic DATA SE NET SF : PARKING: MPACT PAR MPACT PAR ARKING PARKING PARKING PARKING	DE SQUARE FOOTAGE FR VBALCONY STORAGE.	4.27 28 180 113 31 7 2 23 4	S.F. GROSS / UNITS/AU SPACES SPACES PER IDO DESIGNE PARKING SPACES SPACES SPACES SPACES	ACRES CRE 1.5 space 5-5(F)(1) 25 ED AS COMP 3 SPACES A 1 SPACE = 2 1 SPACE = 2	s / DU % OF TOTAL P ACT PARKING LLOWED) 2 PER IDO 5-56	PARKING MAY BE 3 (36 COMPACT (C)(5)(d)
NET AREA IS COMP NCLUDE PATIOS, B/ PROJECT UNIT AVERAGE ACREAGE: DENSITY: VEHICULAR I REQUIRED SURFACE/CA SURFACE CO ADA/1 VAN P/ EV SURFACE GARAGE PAR EV GARAGE F TANDEM PAR	Puted to inclui Loones, Patic DATA SE NET SF : PARKING: MPACT PAR MPACT PAR	DE SQUARE FOOTAGE FR VBALCONY STORAGE.	4.27 28 180 113 31 7 2 23 4 0	S.F. GROSS A UNITS/AU SPACES SPACES PER IDO DESIGNE PARKINO SPACES SPACES SPACES SPACES SPACES	ACRES CRE 1.5 space 5-5(F)(1) 25 ED AS COMP 3 SPACES A 1 SPACE = 2 1 SPACE = 2	s / DU % OF TOTAL P ACT PARKING LLOWED) 2 PER IDO 5-56	PARKING MAY BE 3 (36 COMPACT (C)(5)(d)
NET AREA IS COMP NCLUDE PATIOS, B/ PROJECT UNIT AVERAG ACREAGE: DENSITY: VEHICULAR I REQUIRED SURFACE/CA SURFACE/CA SURFACE CO ADA/1 VAN P/ EV SURFACE GARAGE PAR EV GARAGE PAR EV GARAGE F TANDEM PAR PROVIDED	Puted to inclui Loones, Patic DATA SE NET SF : PARKING: MPACT PAR MPACT PAR	DE SQUARE FOOTAGE FR VBALCONY STORAGE.	4.27 28 180 113 31 7 2 23 4 0	S.F. GROSS A UNITS/AU SPACES SPACES PER IDO DESIGNE PARKING SPACES SPACES SPACES SPACES SPACES SPACES	ACRES CRE 1.5 space 5-5(F)(1) 25 ED AS COMP 3 SPACES A 1 SPACE = 2 1 SPACE = 2	s / DU % OF TOTAL P ACT PARKING LLOWED) 2 PER IDO 5-50 2 PER IDO 5-50	PARKING MAY BE 3 (36 COMPACT (C)(5)(d)
NET AREA IS COMP NCLUDE PATIOS, B/ PROJECT UNIT AVERACE ACREAGE: DENSITY: VEHICULAR I REQUIRED SURFACE/CA SURFACE/CA SURFACE CO ADA/1 VAN P/ EV SURFACE GARAGE PAR EV GARAGE PAR	Puted to inclui Loones, Patic DATA SE NET SF : PARKING: MPACT PAR MPACT PAR	DE SQUARE FOOTAGE FR VBALCONY STORAGE.	4.27 28 180 113 31 7 2 23 4 0 180	S.F. GROSS A UNITS/AU SPACES SPACES PER IDO DESIGNE PARKING SPACES SPACES SPACES SPACES SPACES SPACES	ACRES CRE 1.5 spaces 5-5(F)(1) 25 ED AS COMP 3 SPACES A 1 SPACE = 2 1 SPACE = 2	s / DU % OF TOTAL P ACT PARKING LLOWED) 2 PER IDO 5-50 2 PER IDO 5-50	PARKING MAY BE 3 (36 COMPACT (C)(5)(d)
NET AREA IS COMP NCLUDE PATIOS, B/ PROJECT UNIT AVERAG ACREAGE: DENSITY: VEHICULAR I REQUIRED SURFACE/CA SURFACE/CA SURFACE CO ADA/1 VAN P/ EV SURFACE CO ADA/1 VAN P/ EV SURFACE GARAGE PAR EV GARAGE PAR EV GARAGE PAR PROVIDED MOTORCYCLI REQUIRED PROVIDED BIKE STOR	Puted to inclui Loones, Patic DATA SE NET SF : PARKING: PARKING PARKING PARKING PARKING KING PARKING KING E PARKING	DE SQUARE FOOTAGE FR VBALCONY STORAGE.	4.27 28 180 113 31 7 2 23 4 0 180 4 4 4	S.F. GROSS A UNITS/AU SPACES SPACES PER IDO DESIGNE PARKING SPACES SPACES SPACES SPACES SPACES SPACES	ACRES CRE 1.5 space 5-5(F)(1) 25 ED AS COMP 3 SPACES A 1 SPACE = 2 1 SPACE = 2 PER IDO (5	s / DU % OF TOTAL P ACT PARKING LLOWED) 2 PER IDO 5-50 2 PER IDO 5-50	PARKING MAY BE 3 (36 COMPACT (C)(5)(d)
NET AREA IS COMP NCLUDE PATIOS, B/ PROJECT UNIT AVERACE ACREAGE: DENSITY: VEHICULAR I REQUIRED SURFACE/CA SURFACE/CA SURFACE CO ADA/1 VAN P/ EV SURFACE CO ADA/1 VAN P/ EV SURFACE GARAGE PAR EV GARAGE PAR	Puted to inclui Loonies, Patic DATA SE NET SF : PARKING: RPORT PAR MPACT PAR	DE SQUARE FOOTAGE FR VBALCONY STORAGE.	4.27 28 180 113 31 7 2 23 4 0 180 4 4 4 18	S.F. GROSS A UNITS/AU SPACES SPACES SPACES SPACES SPACES SPACES SPACES SPACES SPACES SPACES SPACES SPACES	ACRES CRE 1.5 space 5-5(F)(1) 25 ED AS COMP 3 SPACES A 1 SPACE = 2 1 SPACE = 2 PER IDO (5- PER IDO 5-5-	s / DU % OF TOTAL P ACT PARKING LLOWED) 2 PER IDO 5-50 2 PER IDO 5-50	PARKING MAY BE 3 (36 COMPACT (C)(5)(d)
NET AREA IS COMP NCLUDE PATIOS, B/ PROJECT UNIT AVERAGE ACREAGE: DENSITY: VEHICULAR I REQUIRED SURFACE/CA SURFACE/CA SURFACE CO ADA/1 VAN P/ EV SURFACE GARAGE PAR EV GARAGE PAR EV GARAGE PAR PROVIDED MOTORCYCLI REQUIRED PROVIDED BIKE STOR REQUIRED EXTERIOR ST	PUTED TO INCLUI LCONIES, PATIC DATA SE NET SF : PARKING: PARKING PARKING PARKING KING PARKING KING PARKING KING PARKING KING PARKING KING PARKING KING PARKING KING PARKING KING PARKING KING	DE SQUARE FOOTAGE FR VBALCONY STORAGE.	4.27 28 180 113 31 7 2 23 4 0 180 4 4 4 18 12	S.F. GROSS A UNITS/AU SPACES SPACES PER IDO DESIGNE PARKINO SPACES SPACES SPACES SPACES SPACES SPACES SPACES SPACES SPACES SPACES	ACRES CRE 1.5 space 5-5(F)(1) 25 ED AS COMP 3 SPACES A 1 SPACE = 2 1 SPACE = 2 PER IDO (5 PER IDO 5-5- RAMADA	s / DU % OF TOTAL P ACT PARKING LLOWED) 2 PER IDO 5-5(2 PER IDO 5-5(-5-4:)	PARKING MAY BE 5 (36 COMPACT (C)(5)(d) (C)(5)(d)
NET AREA IS COMP NCLUDE PATIOS, B/ PROJECT UNIT AVERAG ACREAGE: DENSITY: VEHICULAR I REQUIRED SURFACE/CA SURFACE/CA SURFACE CO ADA/1 VAN P/ EV SURFACE CO ADA/1 VAN P/ EV SURFACE GARAGE PAR EV GARAGE PAR EV GARAGE PAR PROVIDED MOTORCYCLI REQUIRED PROVIDED BIKE STOR	PUTED TO INCLUI LCONIES, PATIC DATA SE NET SF : PARKING: PARKING PARKING PARKING KING PARKING KING PARKING KING PARKING KING PARKING KING PARKING KING PARKING KING PARKING KING PARKING KING	DE SQUARE FOOTAGE FR VBALCONY STORAGE.	4.27 28 180 113 31 7 2 23 4 0 180 4 4 4 18	S.F. GROSS A UNITS/AU SPACES SPACES PER IDO DESIGNE PARKINO SPACES SPACES SPACES SPACES SPACES SPACES SPACES SPACES SPACES SPACES	ACRES CRE 1.5 space 5-5(F)(1) 25 ED AS COMP 3 SPACES A 1 SPACE = 2 1 SPACE = 2 PER IDO (5- PER IDO (5- RAMADA SARAGES UN	s / DU % OF TOTAL P ACT PARKING LLOWED) 2 PER IDO 5-50 2 PER IDO 5-50	PARKING MAY BE 5 (36 COMPACT (C)(5)(d) (C)(5)(d)

					AREA		
BLDG TYPE	BLDG COUNT	OCCUPANCY	1ST FLR	2ND FLR	3RD FLR	TOTAL PER BLDG	TOTAL
1	2	U/R-2	13015	13232	7806	34053	68106
11	2	U/R-2	12201	12493	7872	32566	65132
BBQ RAMADA	1	U	411				411
BIKE RAMADA	1	U	334		1		334
MAIL ROOM	1	U	289				289
POOL RR/M	1	U	211				211
TOTAL		- 8			8		134483

PR-2021-006307 PROJECT NUMBER:

SI-2022-00327

Application Number:

Is an Infrastructure List required? () Yes () No If yes, then a set of approved DRC plans with a work order is required for any construction within Public Right-of-Way or for construction of public improvements.


DRB SITE DEVELOPMENT PLAN APPROVAL:

Ernest Armijo	Aug 8, 2022
Traffic Engineering, Transportation Division	Date
Blaine Carter	Aug 8, 2022
Blaine Carter (Aug 8, 2022 08:20 MDT) ABC WUA	Date
Cheryl Somerfeldt (Aug 7, 2022 10:13 EDT)	Aug 7, 2022
Parks and Recreation Department	Date
Shahab Biazar	Aug 7, 2022
City Engineer/Hydrology	Date
- All Palmer	Aug 8, 2022
Jeff Palmer Aug 8, 2022 10:22 MDT) Code Enforcement	Date
* Environmental Health Department (conditional)	Date
<u>Herman Gallegos</u> <u>Herman Gallegos</u> Solid Waste Management	04-06-22 Date

Aug 8, 2022


Date

0 Solid Waste Management Jay Rodenbeck ØRB Chairperson, Planning Department

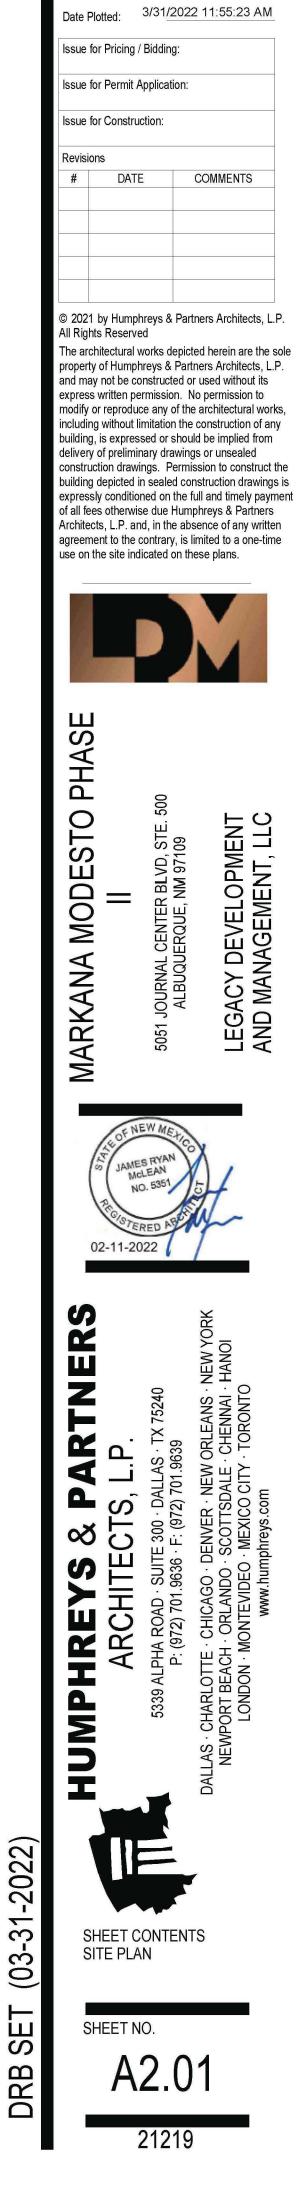


Designed by Drawn by

Architect of Record:

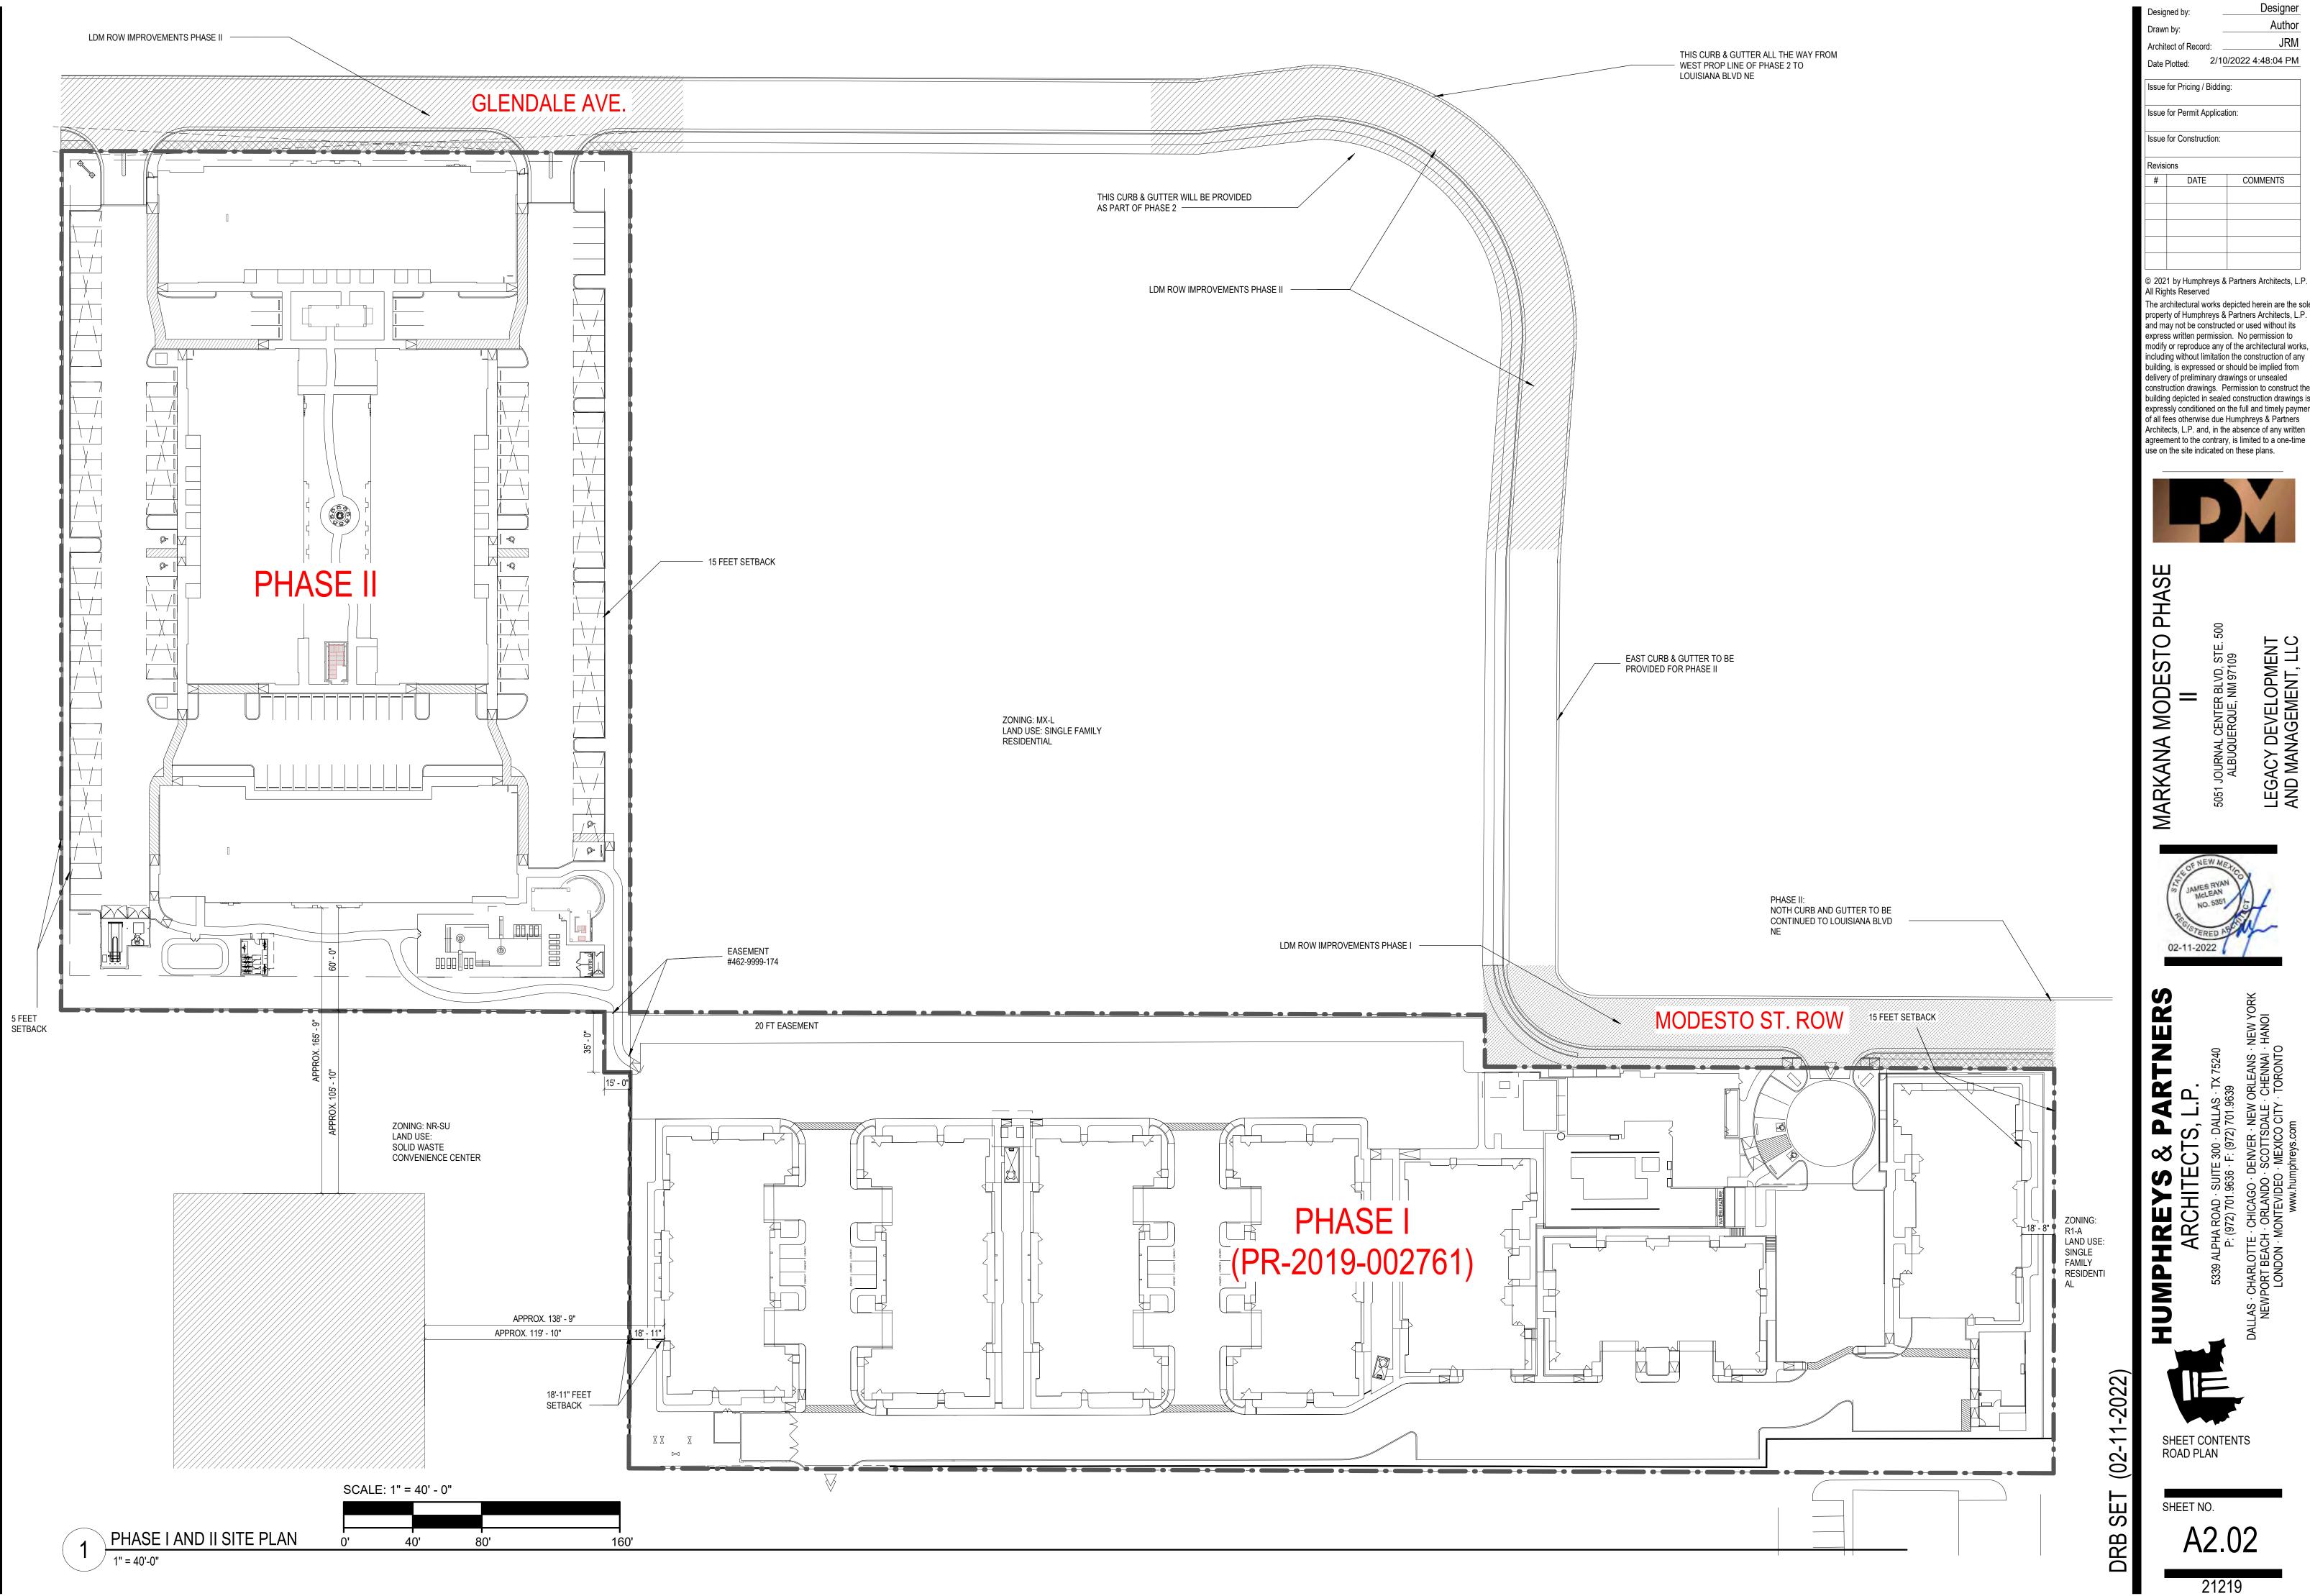

The architectural works depicted herein are the sole property of Humphreys & Partners Architects, L.P. and may not be constructed or used without its express written permission. No permission to modify or reproduce any of the architectural works, including without limitation the construction of any building, is expressed or should be implied from construction drawings. Permission to construct the building depicted in sealed construction drawings is expressly conditioned on the full and timely payment of all fees otherwise due Humphreys & Partners Architects, L.P. and, in the absence of any written agreement to the contrary, is limited to a one-time

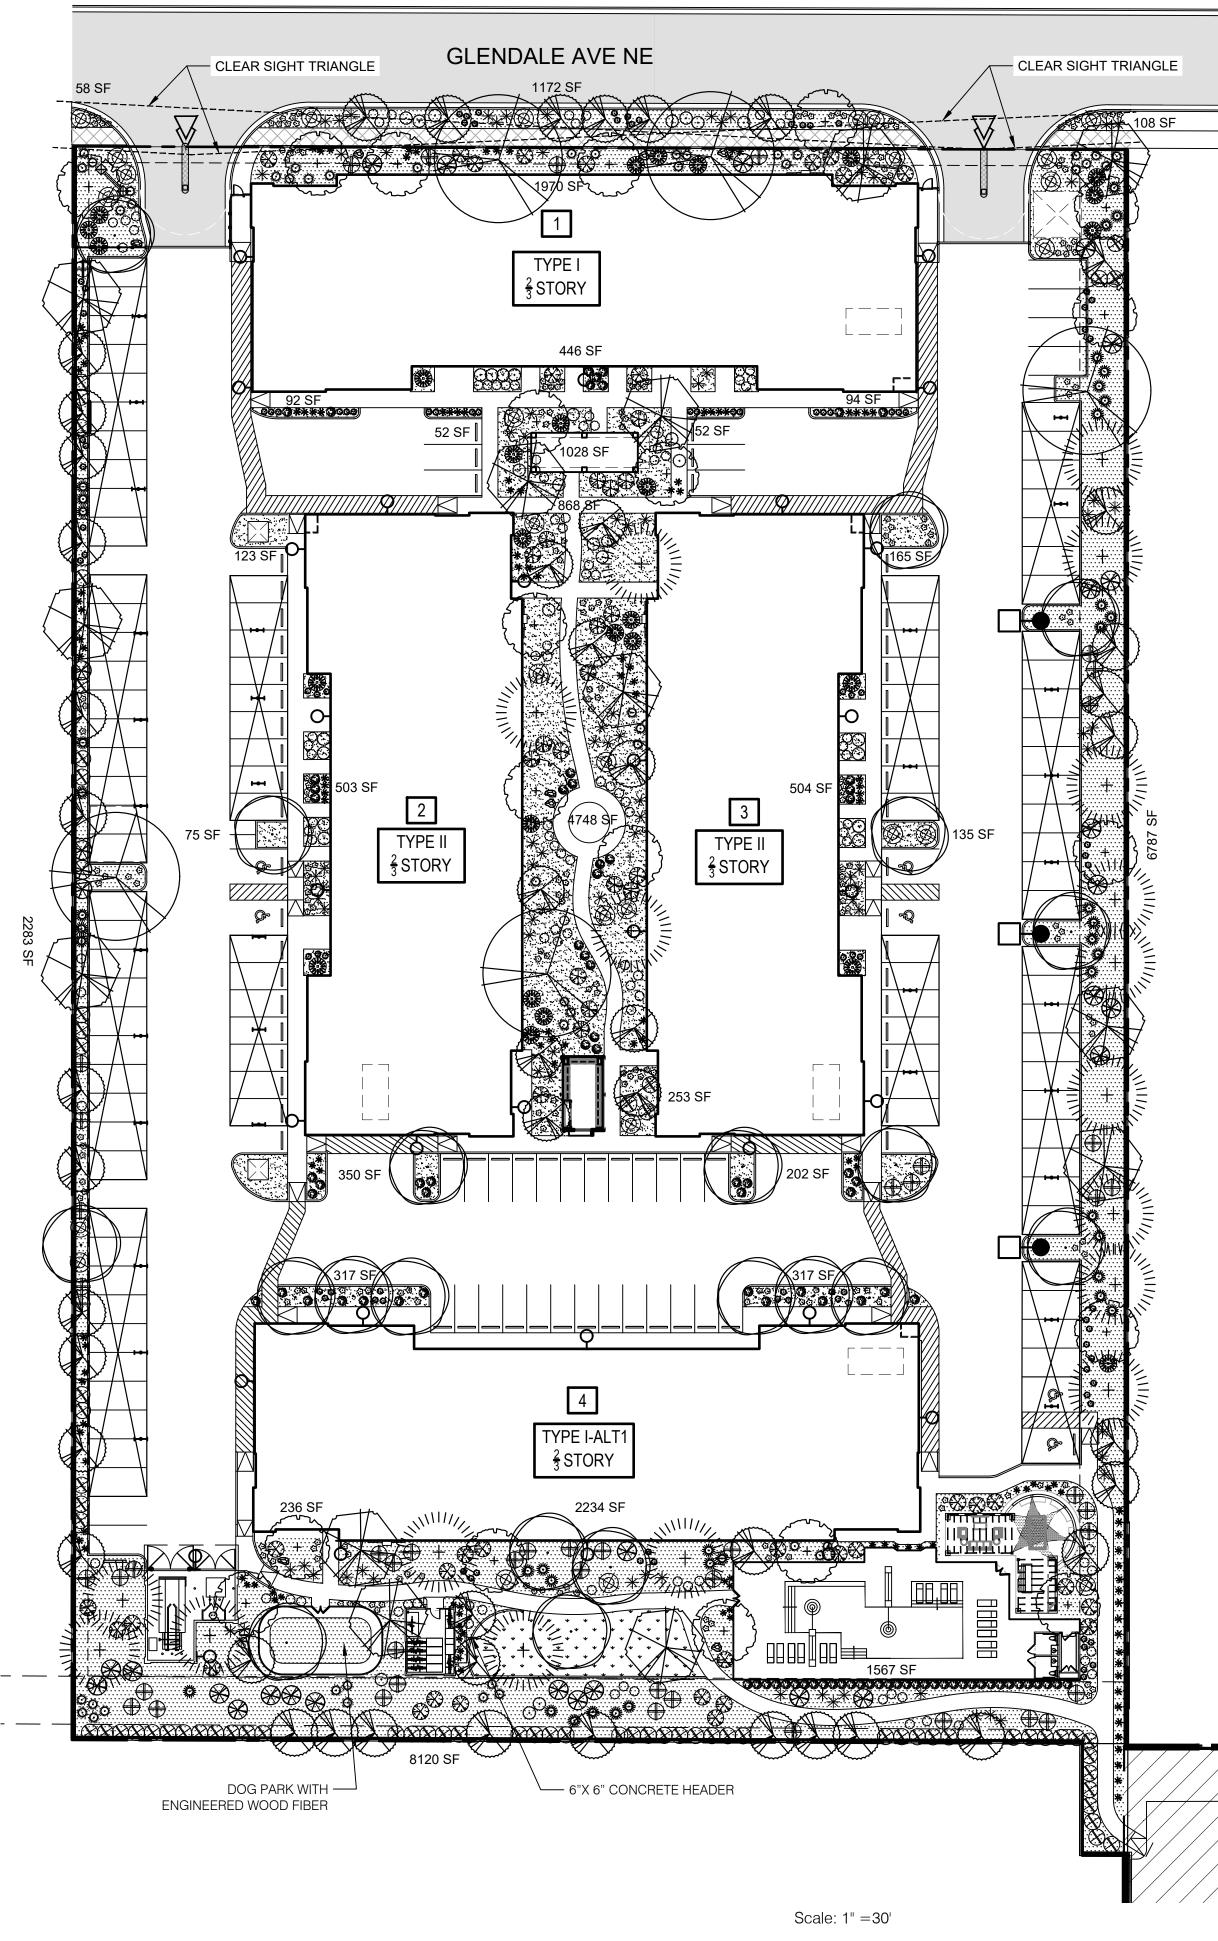



NORTH

15 0

GENERAL LANDSCAPE NOTES

LANDSCAPE DESIGN ALL PLANTING AREAS SHALL BE TOP DRESSED WITH ROCK MULCH OVER FILTER FABRIC.

RGANIC MULCH AT TREES

DRGANIC MULCH IS REQUIRED AS GROUND COVER UNDER TREES WITHIN A 5-FOOT RADIUS AROUND THE TREE TRUNK, BUT NOT DIRECTLY AGAINST THE TRUNK. IN THESE AREAS, WEED BARRIER FABRIC IS PROHIBITED.

IRRIGATION IRRIGATION SYSTEM STANDARDS OUTLINED IN THE WATER CONSERVATION LANDSCAPING AND WATER WASTE ORDINANCE SHALL BE STRICTLY ADHERED TO. A FULLY AUTOMATED IRRIGATION SYSTEM WILL BE USED TO IRRIGATE TREE, SHRUB AND GROUNDCOVER PLANTING AREAS. THE IRRIGATION SYSTEM SHALL BE DESIGNED TO ISOLATE PLANT MATERIAL ACCORDING TO SOLAR EXPOSURE AND WILL BE SET UP BY PLANT ZONES ACCORDING TO WATER REQUIREMENTS. THE TREES WILL BE PROVIDED WITH (6) 2 GPH EMITTERS, WITH THE ABILITY TO BE EXPANDED TO ACCOMMODATE THE GROWTH OF THE TREE. SHRUBS AND GROUNDCOVERS WILL BE PROVIDED WITH (2) 1 GPH EMITTERS. TREES, SHRUBS, ACCENTS, AND GROUNDCOVERS WILL BE GROUPED ON THE SAME VALVE.

RESPONSIBILITY OF MAINTENANC

MAINTENANCE OF ALL PLANTING AND IRRIGATION, INCLUDING THOSE WITHIN THE PUBLIC R.O.W., SHALL BE THE RESPONSIBILITY OF THE PROPERTY OWNER.

METHOD FOR COMPLYING WITH WATER CONSERVATION ORDINANC

THE LANDSCAPE PLAN SHALL LIMIT THE PROVISION OF HIGH WATER USE TURF TO A MAXIMUM OF 10 PERCENT OF THE REQUIRED LANDSCAPED AREA. THE PLANT PALETTE IS PREDOMINANTLY COMPRISED OF PLANTS WITH LOW TO MEDIUM WATER USE REQUIREMENTS, THEREBY MINIMIZING IRRIGATION NEEDS WHILE ENSURING THE VIABILITY OF THE PLANTS. AN EVAPOTRANSPIRATION MANAGEMENT CONTROLLER WILL BE INCLUDED IN THE DESIGN OF THE IRRIGATION SYSTEM TO MONITOR WEATHER CONDITIONS SO THAT THE OPTIMUM MOISTURE BALANCE IS ACHIEVED AND THE POSSIBILITY OF OVER-WATERING IS REDUCED.

PNM COORDINATION

COORDINATION WITH PNM'S NEW SERVICE DELIVERY DEPARTMENT IS NECESSARY REGARDING PROPOSED TREE LOCATION AND HEIGHT, SIGN LOCATION AND HEIGHT, AND LIGHTING HEIGHT IN ORDER TO ENSURE SUFFICIENT SAFETY CLEARANCES.

SCREENING WILL BE DESIGNED TO ALLOW FOR ACCESS TO ELECTRIC UTILITIES. IT IS NECESSARY TO PROVIDE ADEQUATE CLEARANCE OF TEN FEET IN FRONT AND AT LEAST FIVE FEET ON THE REMAINING THREE SIDES SURROUNDING ALL GROUND-MOUNTED EQUIPMENT FOR SAFE OPERATION, MAINTENANCE AND REPAIR PURPOSES.

CLEAR SIGHT DISTANCE

LANDSCAPING AND SIGNAGE WILL NOT INTERFERE WITH CLEAR SIGHT REQUIREMENTS. THEREFORE, SIGNS, WALLS, TREES, AND SHRUBBERY BETWEEN 3 AND 8 FEET TALL (AS MEASURED FROM THE GUTTER PAN) WILL NOT BE ACCEPTABLE IN THE AREA.

LANDSCAPE AREA COVERAGE

TOTAL SITE AREA:	186,002 SF (4.27 AC)
BUILDING AREA (BUILDING ENVELOPE):	<u>- 51,677 SF</u>
NET AREA	134,325 SF
REQUIRED LANDSCAPE AREA (15% OF NET AREA):	27,900 SF
PROVIDED LANDSCAPE AREA	35,289 SF (128%)

LANDSCAPE LIVE VEGETATIVE COVERAGE

LANDSCAPE COVERAGE REQUIREMENTS SPECIFY TREE CANOPIES AND GROUND-LEVEL PLANTS SHALL COVER A MINIMUM OF 75% OF THE TOTAL LANDSCAPE AREA. A MINIMUM OF 25% SHALL BE PROVIDED AS GROUND-LEVEL PLANTS (SHRUBS, GRASSES, ETC.) OF THE REQUIRED VEGETATIVE COVERAGE.

REQUIRED LIVE VEGETATIVE COVERAGE (75%):	20,925 SF
PROVIDED LIVE VEGETATIVE COVERAGE:	56,536 SF (270%)
REQUIRED GROUND-LEVEL PLANT COVERAGE (25%):	6,975 SF
ROVIDED GROUND-LEVEL PLANT COVERAGE:	9,943 SF (143%)

PARKING LOT AREA

AT LEAST 10% OF LOTS CONTAINING 50 OR FEWER PARKING SPACES AND 15% OF THE LOTS CONTAINING 50 OR MORE PARKING SPACES SHALL BE LANDSCAPED. TOTAL PARKING LOT AREA: 48,273 SF TOTAL REQUIRED LANDSCAPED LOT AREA: 6,883 SF PROVIDED LANDSCAPE AREA: 13,706 SF (44%)

PARKING LOT TREES

PARKING LOT TREE REQUIREMENTS ARE BASED UPON 1 TREE PER 10 SPACES THAT IS CAPABLE OF REACHING A 25' CANOPY AT MATURITY.

PROVIDING 152 PARKING SPACES, EXCLUDING GARAGE PARKING. PARKING LOT TREES REQUIRED: 16


PARKING LOT TREES PROVIDED: 35

STREET TREES GLENDALE AVENUE IS A LOCAL STREET AND THEREFORE DOES NOT REQUIRE STREET TREES PER PART 6-6-2 OF ROA 1994 (STREET TREES).

SITE TREES TREE REQUIREMENTS FOR MULTI-FAMILY RESIDENTIAL DEVELOPMENTS ARE AT A RATE OF ONE TREE PER GROUND FLOOR DWELLING UNIT AND ONE TREE PER SECOND FLOOR DWELLING UNIT. NO ADDITIONAL TREES ARE REQUIRED FOR UNITS ABOVE SECOND STORY. 48 FIRST FLOOR UNITS AND 72 SECOND STORY UNITS ARE PROVIDED. SITE TREES REQUIRED: 120 SITE TREES PROVIDED: 120


LANDSCAPE TURF

PER IDO SECTION 4-3(B)(7)(b)3, COOL SEASON GRASSES ARE RESTRICTED TO 20% OF THE LANDSCAPE AREA. THE TURF AREA SHOWN ON THE LANDSCAPE PLAN IS 4% OF THE TOTAL PROVIDED LANDSCAPED AREA.

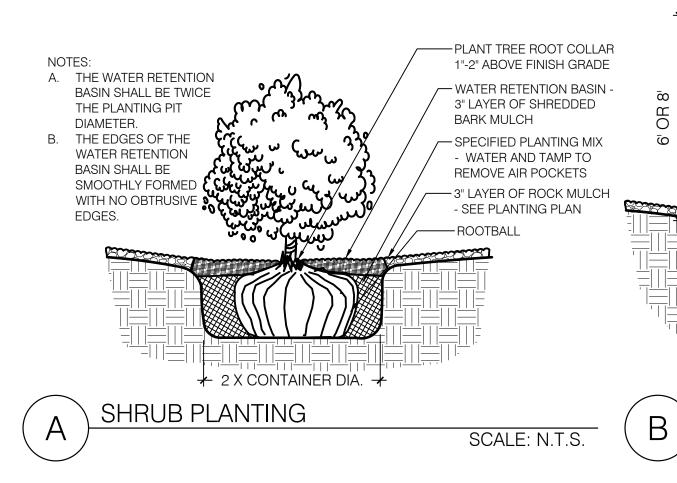

PLANT LEGEND

QTY.	SYMBOL
TREE	
20	+ 2

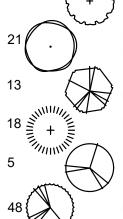

SHRUBS & GROUN

EX.


JYN A


220

54

88

106

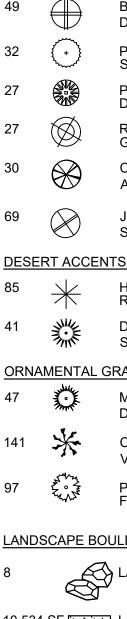

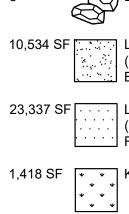

SCIENTIFIC NAME COMMON NAME (WATER USE)	SIZE	MATURE SIZE
ICE DETAIL B/L101		
LAGERSTROEMIA I. 'WATERMELON RED' WATERMELON RED CRAPE MYRTLE (M)	2" MS/ 24" BOX	20' HT X 20' SPR
ULMUS PROPINQUA 'JFS-BIEBERICH' EMERALD SUNSHINE ELM (M)	2.5" B&B	30' HT X 25' SPR
CHILOPSIS LINEARIS DESERT WILLOW (L+)	24" BOX	20' HT X 25' SPR
PINUS NIGRA AUSTRIAN PINE (M+)	6'-8' HT.	35' HT X 25' SPR
GLEDITSIA TRIA. 'SHADEMASTER' SHADEMASTER HONEYLOCUST (M)	2.5" B&B	45' HT X 40' SPR
PYRUS CALLERYANA 'CLEVELAND' CLEVELAND FLOWERING PEAR (M+)	2.5" B&B	25' HT X 15' SPR
NDCOVERS - REFERENCE DETAIL A/L101		
ACHILLEA TAYGETEA 'MOONSHINE' MOONSHINE YARROW (M)	1-GAL	2' HT X 2' SPR
CARYOPTERIS CLANDONENSIS BLUE MIST SPIREA (M)	5-GAL	5' HT X 5' SPR
NANDINA DOMESTICA 'GULF STREAM' GULF STREAM NANDINA (M)	5-GAL	3' HT X3' SPR
LAVANDULA ANGUSTIFOLIA ENGLISH LAVENDER (M)	1-GAL	3' HT X 3' SPR
BUDDLEIA D. N. 'NANHO BLUE' DWARF BLUE BUTTERFLY BUSH (M)	1-GAL	5' HT X 5' SPR
POTENTILLA FRUTICOSA SHRUBBY CINQUEFOIL (M)	5-GAL	3' HT X 4' SPR
PINUS MUGO DWARF MUGO PINE (L)	5-GAL.	4' HT X 6' SPR
RHUS AROMATICA 'GRO-LOW' GRO-LOW SUMAC (L+)	5-GAL	2' HT X 6' SPR
CYTISUS X PRAECOX 'ALL GOLD' ALL GOLD BROOM (M)	5-GAL	5' HT X 5' SPR
JUNIPERUS CHINENSIS 'SPARTAN' SPARTAN JUNIPER (L+)	15 GAL	15' HT X 5' SPR
<u>S</u> - REFERENCE DETAIL A/L101		
HESPERALOE PARVIFLORA 'RED' RED YUCCA (L+)	5-GAL	3' HT X 4' SPR
DASYLIRION TEXANUM SOTOL (RW)	5-GAL	4' HT X 4' SPR
ASSES - REFERENCE DETAIL A/L101		
MISCANTHUS SINENSIS 'YAKUSHIMA' DWARF MAIDEN GRASS (M)	5-GAL	4' HT X 4' SPR
CALAMAGROSTIS A. 'OVERDAM' VARIEGATED REED GRASS (M)	5-GAL	4' HT X 2' SPR
PENNISETUM ALOPECUROIDES 'HAMELN' FOUNTAIN GRASS 'HAMELN' (M)	1-GAL	2' HT X 2' SPR

LANDSCAPE BOULDERS AND GRAVEL MULCH

LANDSCAPE BOULDER: (3'X3' MIN)


10,534 SF LANDSCAPE AREA TO INCLUDE ROCK MULCH OVER FILTER FABRIC (DEWITT PRO-5 WEED CONTROL, OR EQUAL). MULCH TO BE 7/16"MOUNTAINAIR BROWN GRAVEL ROCK MULCH AT 3" DEPTH.


> LANDSCAPE AREA TO INCLUDE ROCK MULCH OVER FILTER FABRIC (DEWITT PRO-5 WEED CONTROL, OR EQUAL). MULCH TO BE 1" CRUSHED ROSESTONE ROCK MULCH AT 3" DEPTH

1,418 SF 💽 KENTUCKY BLUEGRASS/FESCUE MIX – SOD

NOTES: A. THE WATER RETENTION BASIN SHALL BE TWICE THE PLANTING PIT

- DIAMETER B. THE EDGES OF THE WATER RETENTION BASIN SHALL BE SMOOTHLY
- FORMED WITH NO OBTRUSIVE EDGES.

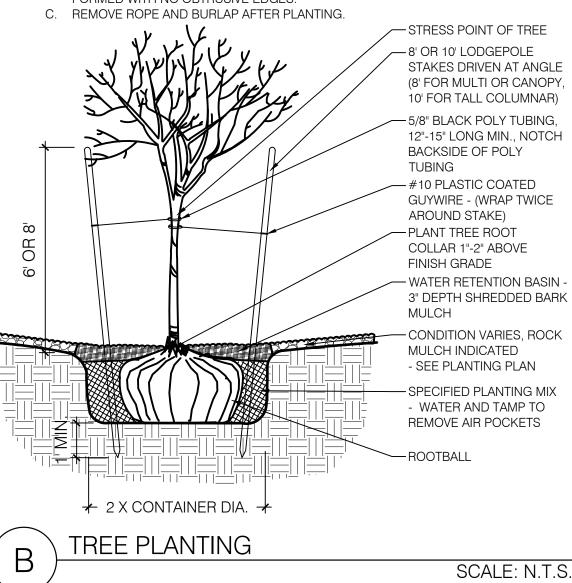


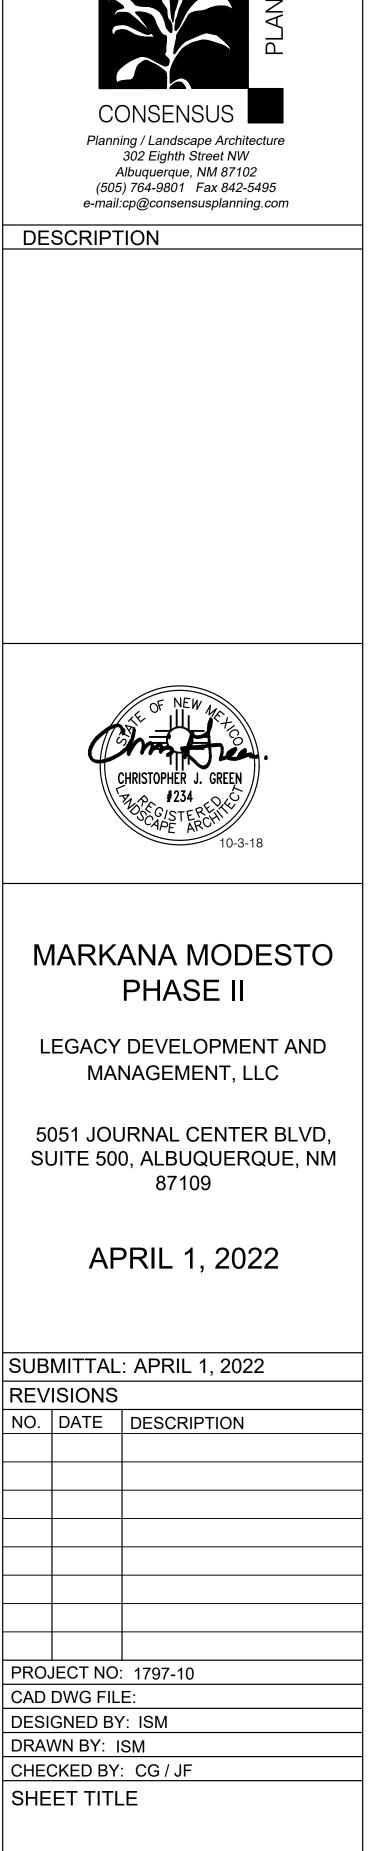


LANDSCAPE PLAN


DRAWING SHEET


SCALE: N.T.S.

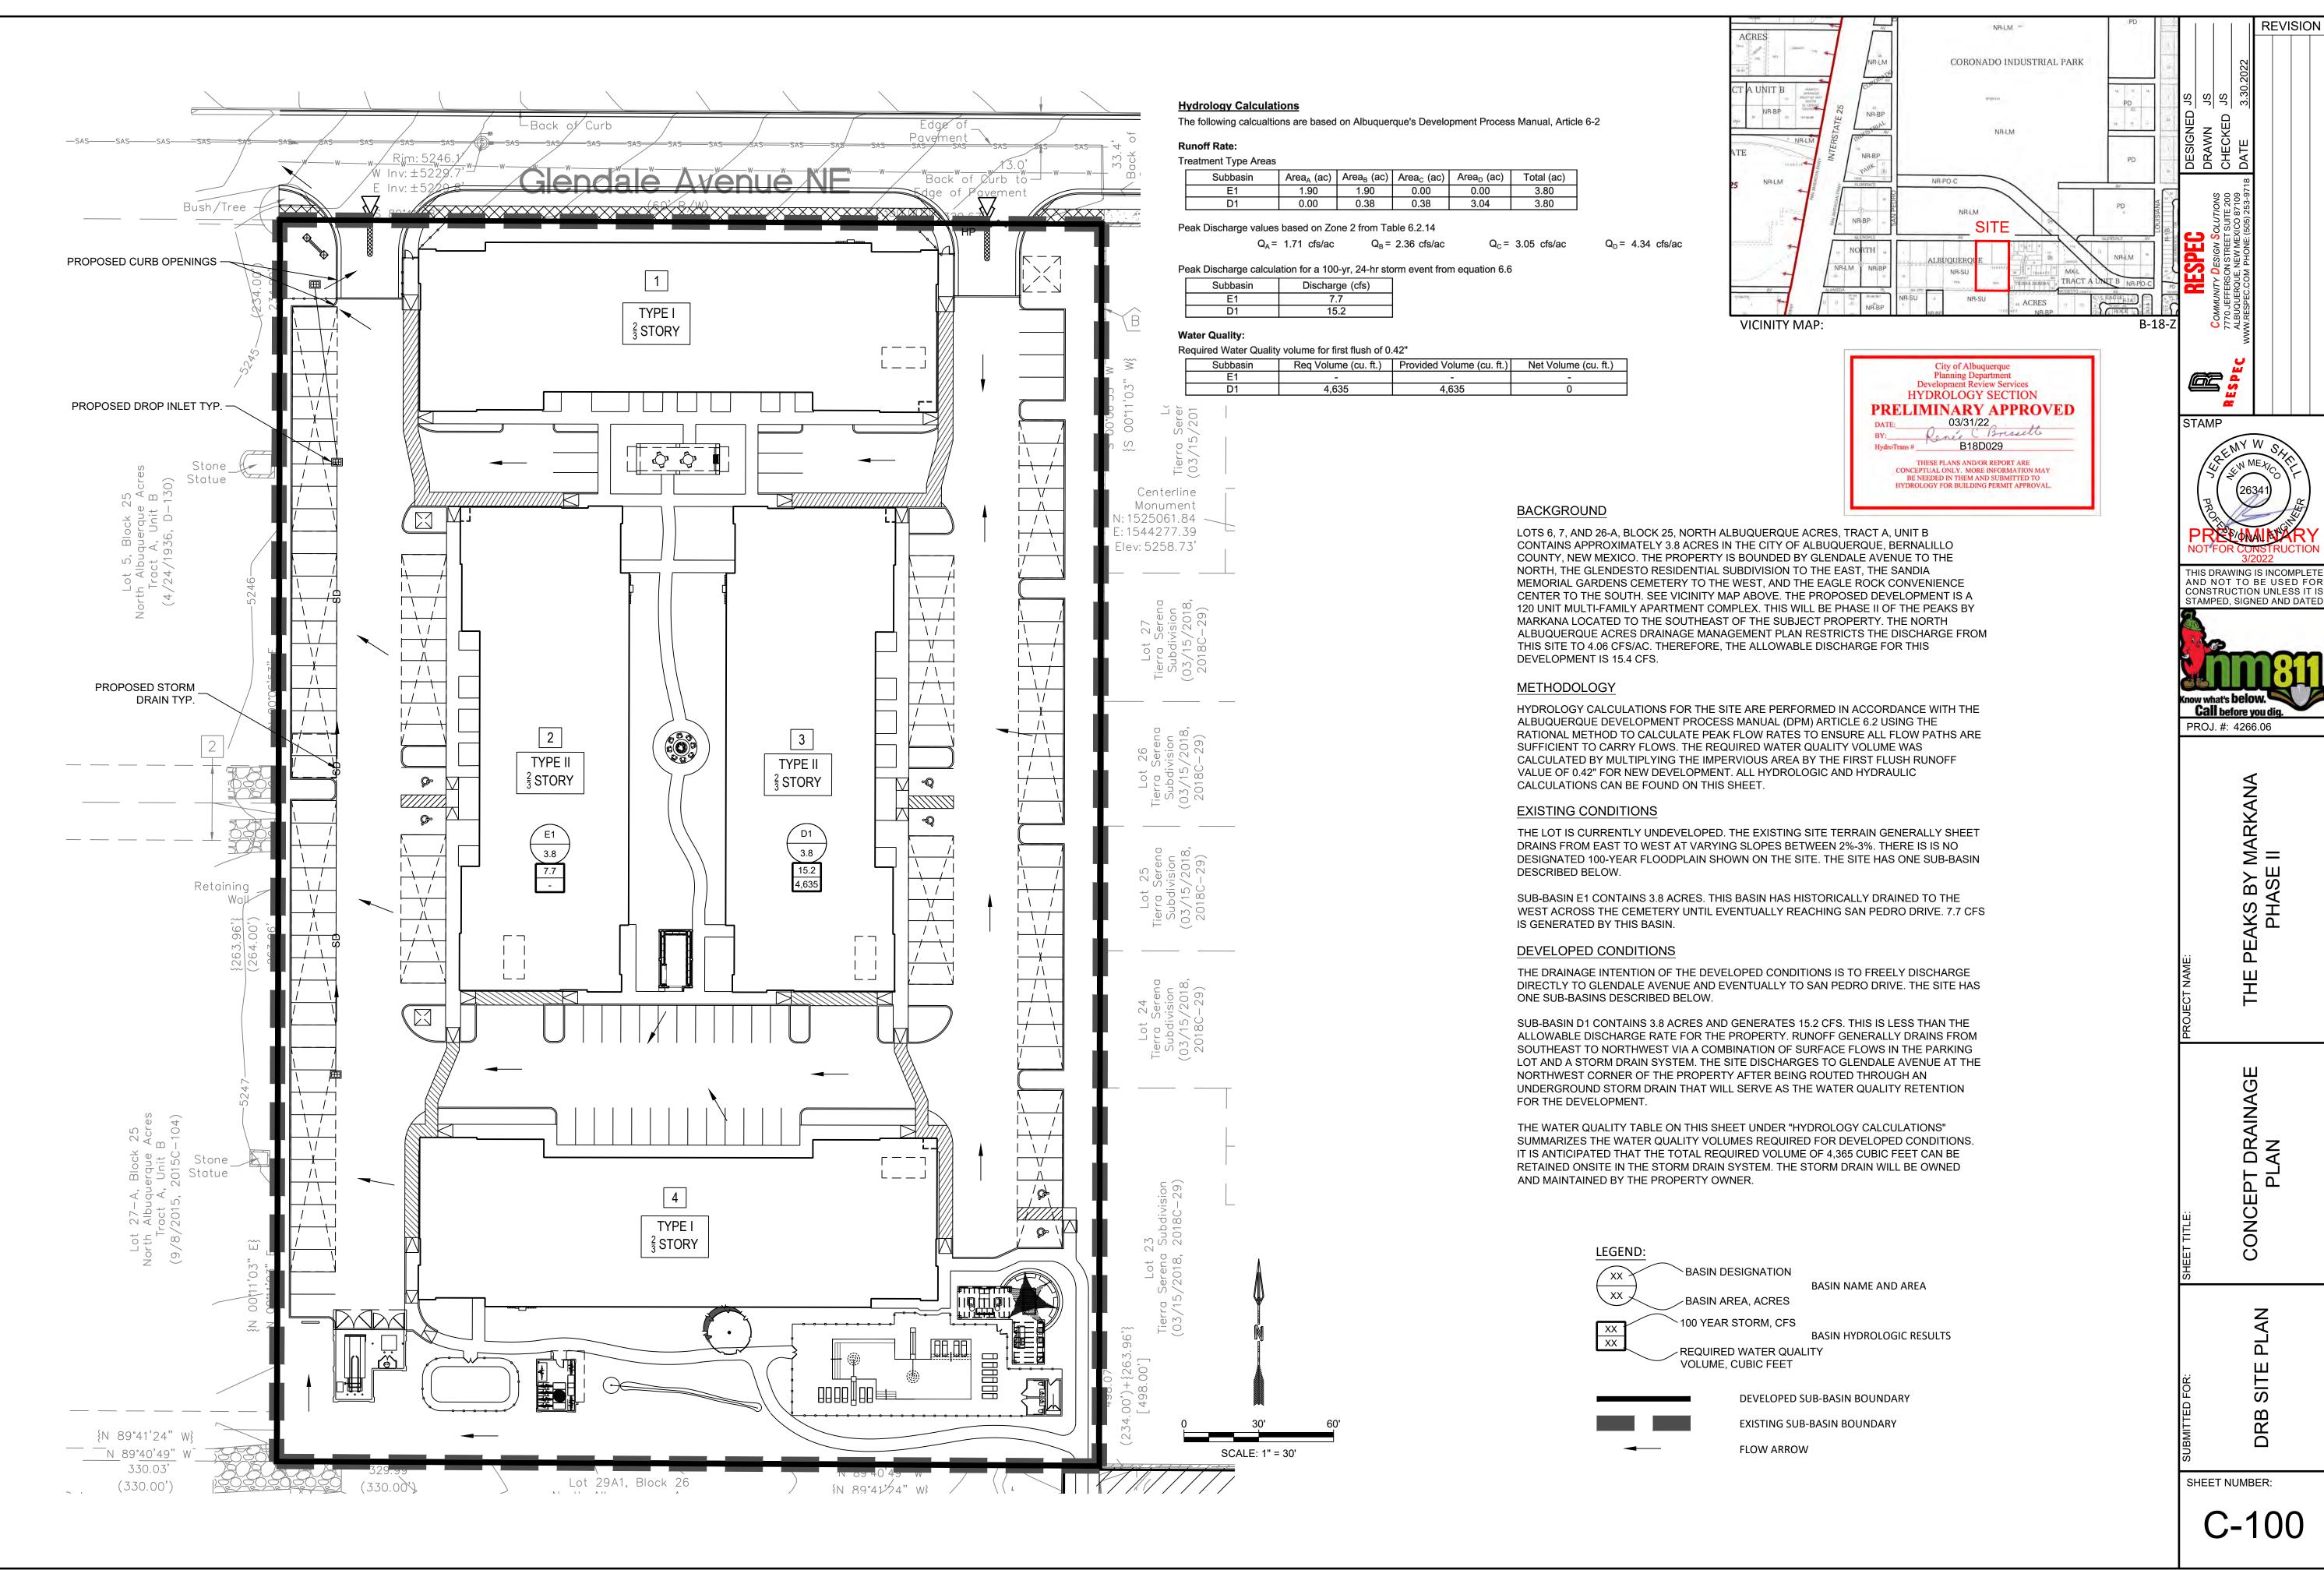

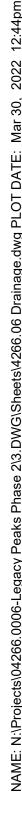


The following calcualtions are based on Albuquerque's Development Process Manual, Article 6-2	
Demosff Defea	

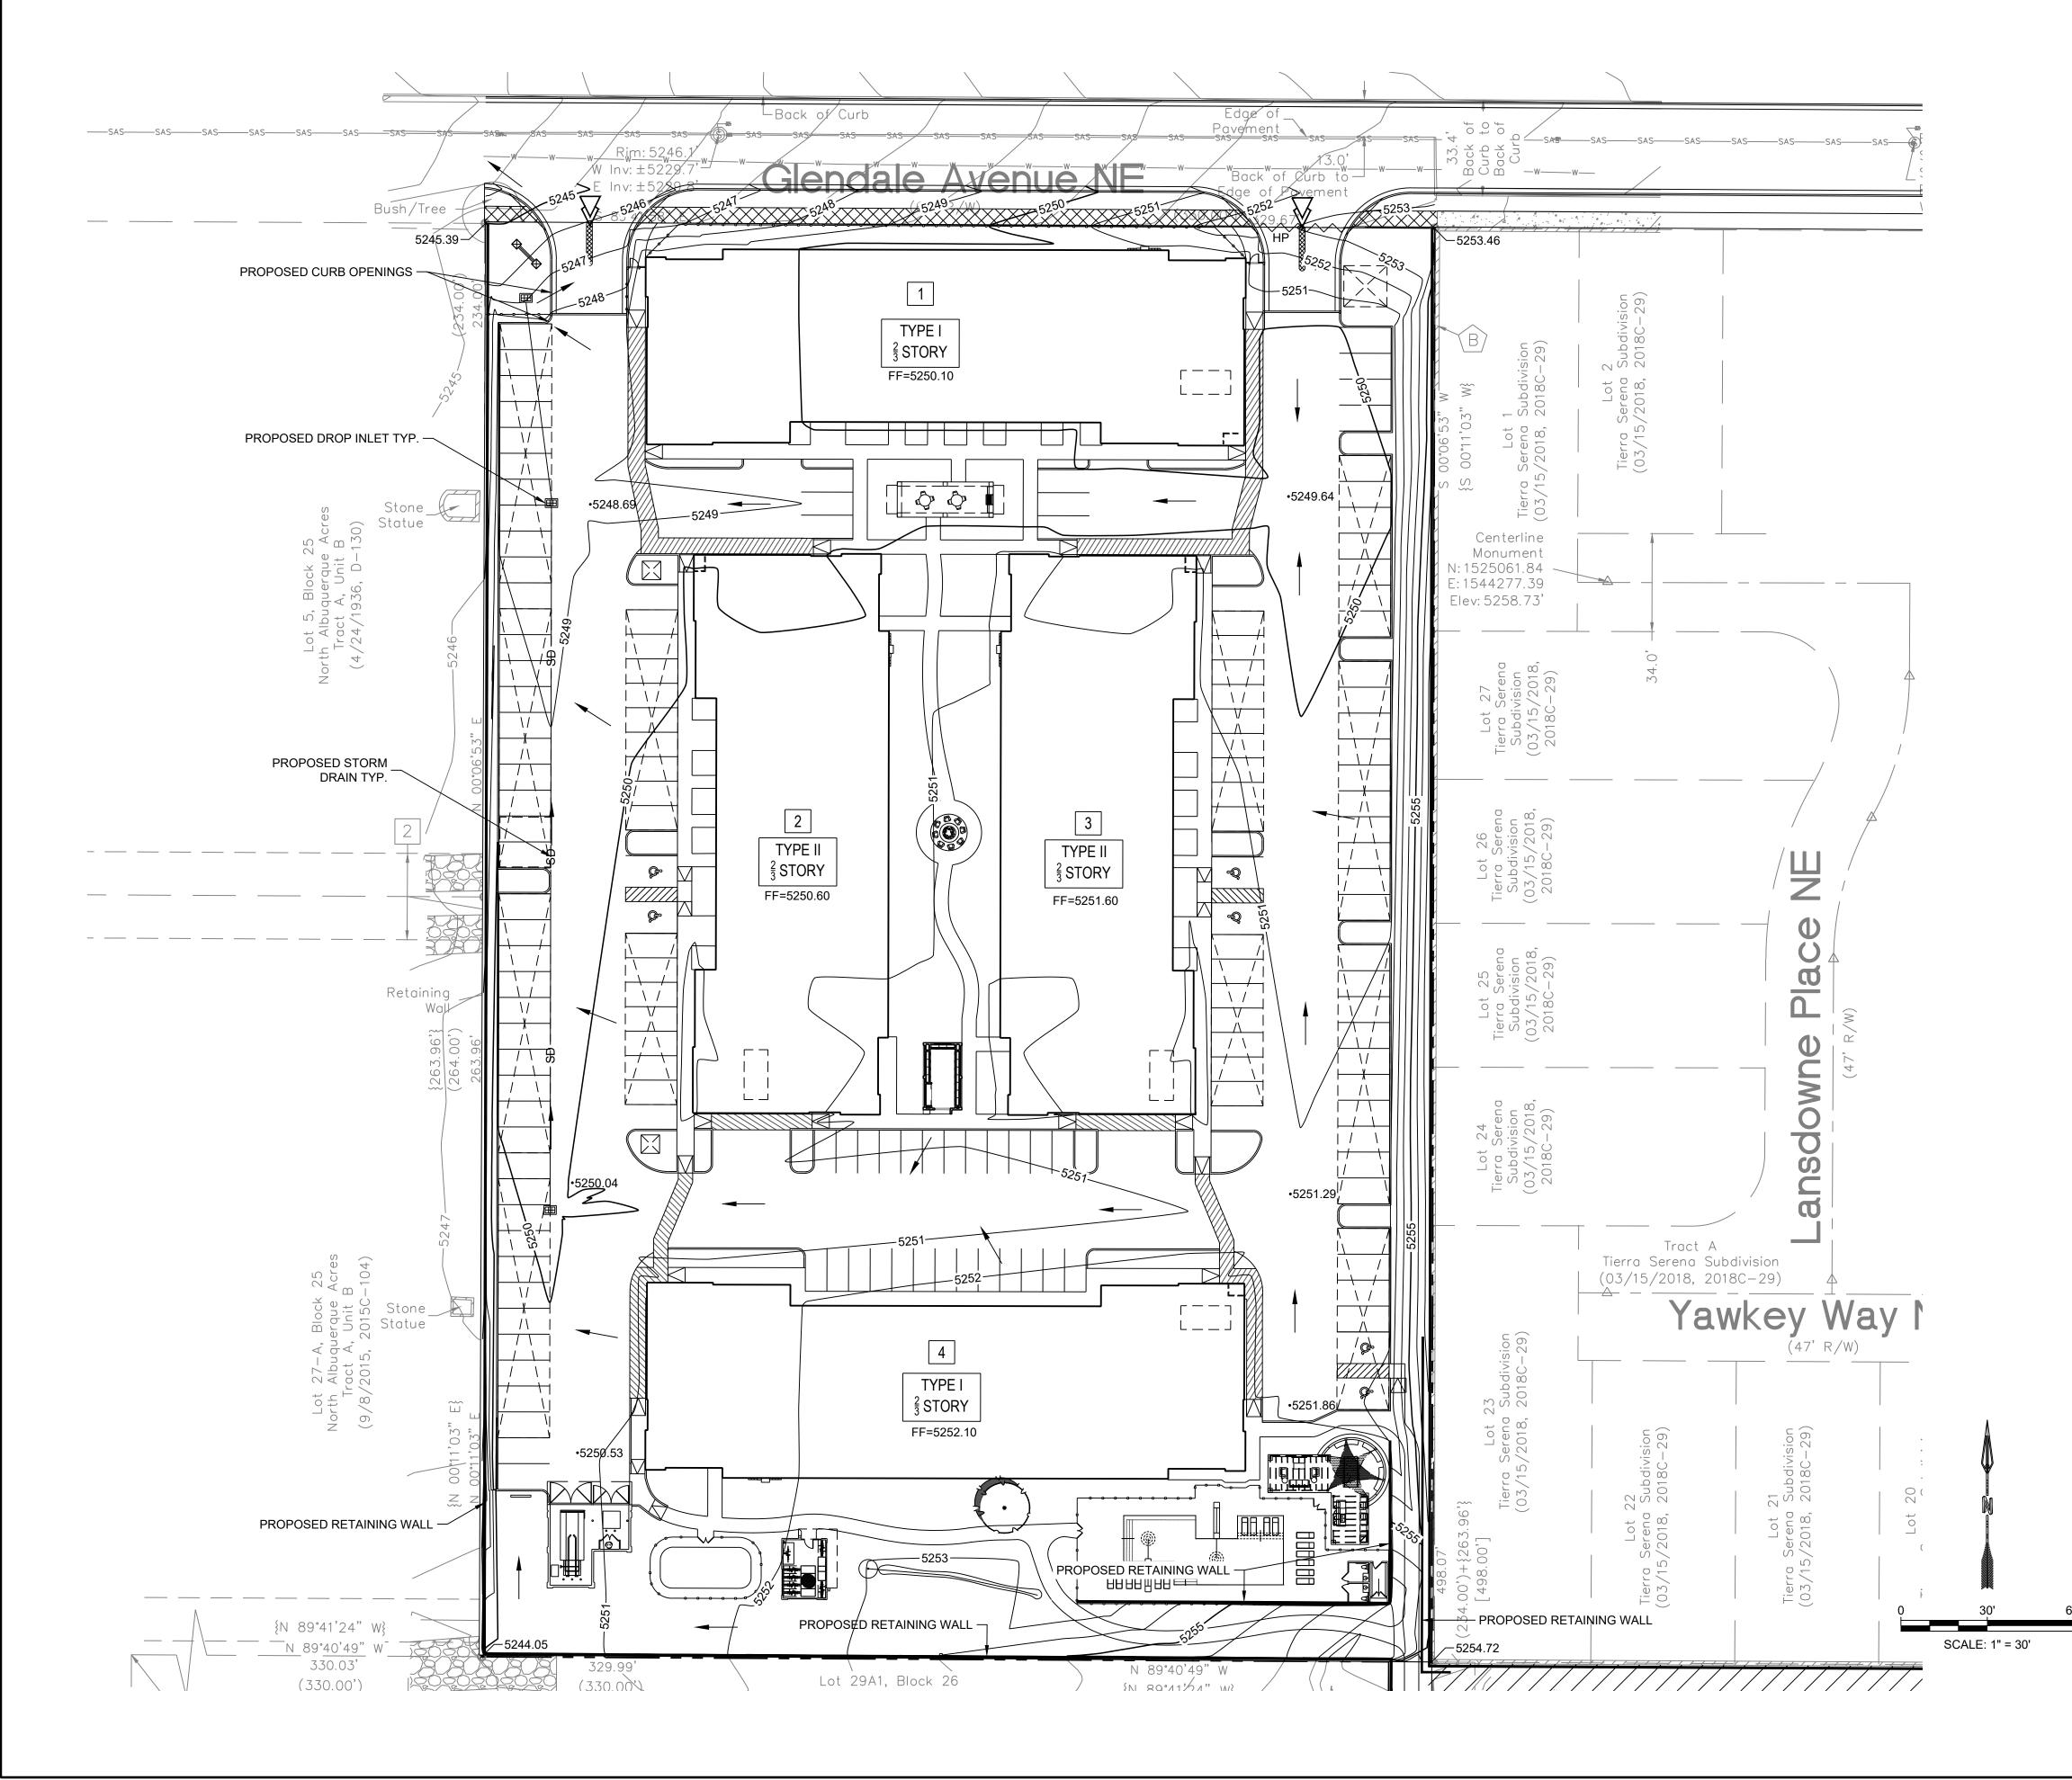

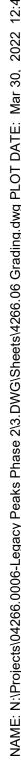



LEGEND: ----- PROPERTY BOUNDARY ---- 5270---- EXISTING MAJOR CONTOUR EXISTING MINOR CONTOUR PROPOSED HIGH POINT PROPOSED RETAINING WALL ------- SD ------- PROPOSED STORM DRAIN PROPOSED DROP INLET FLOW ARROW



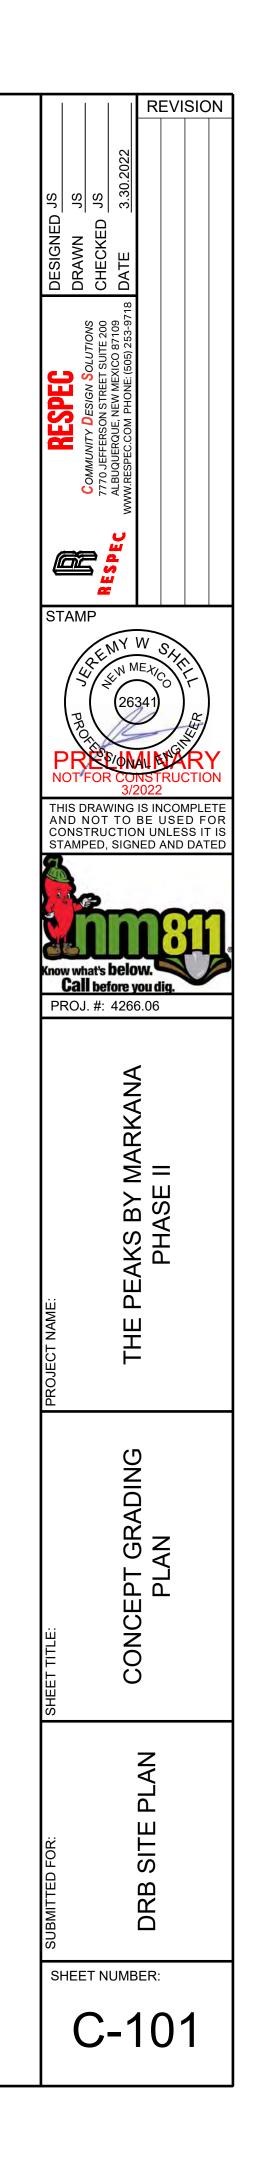



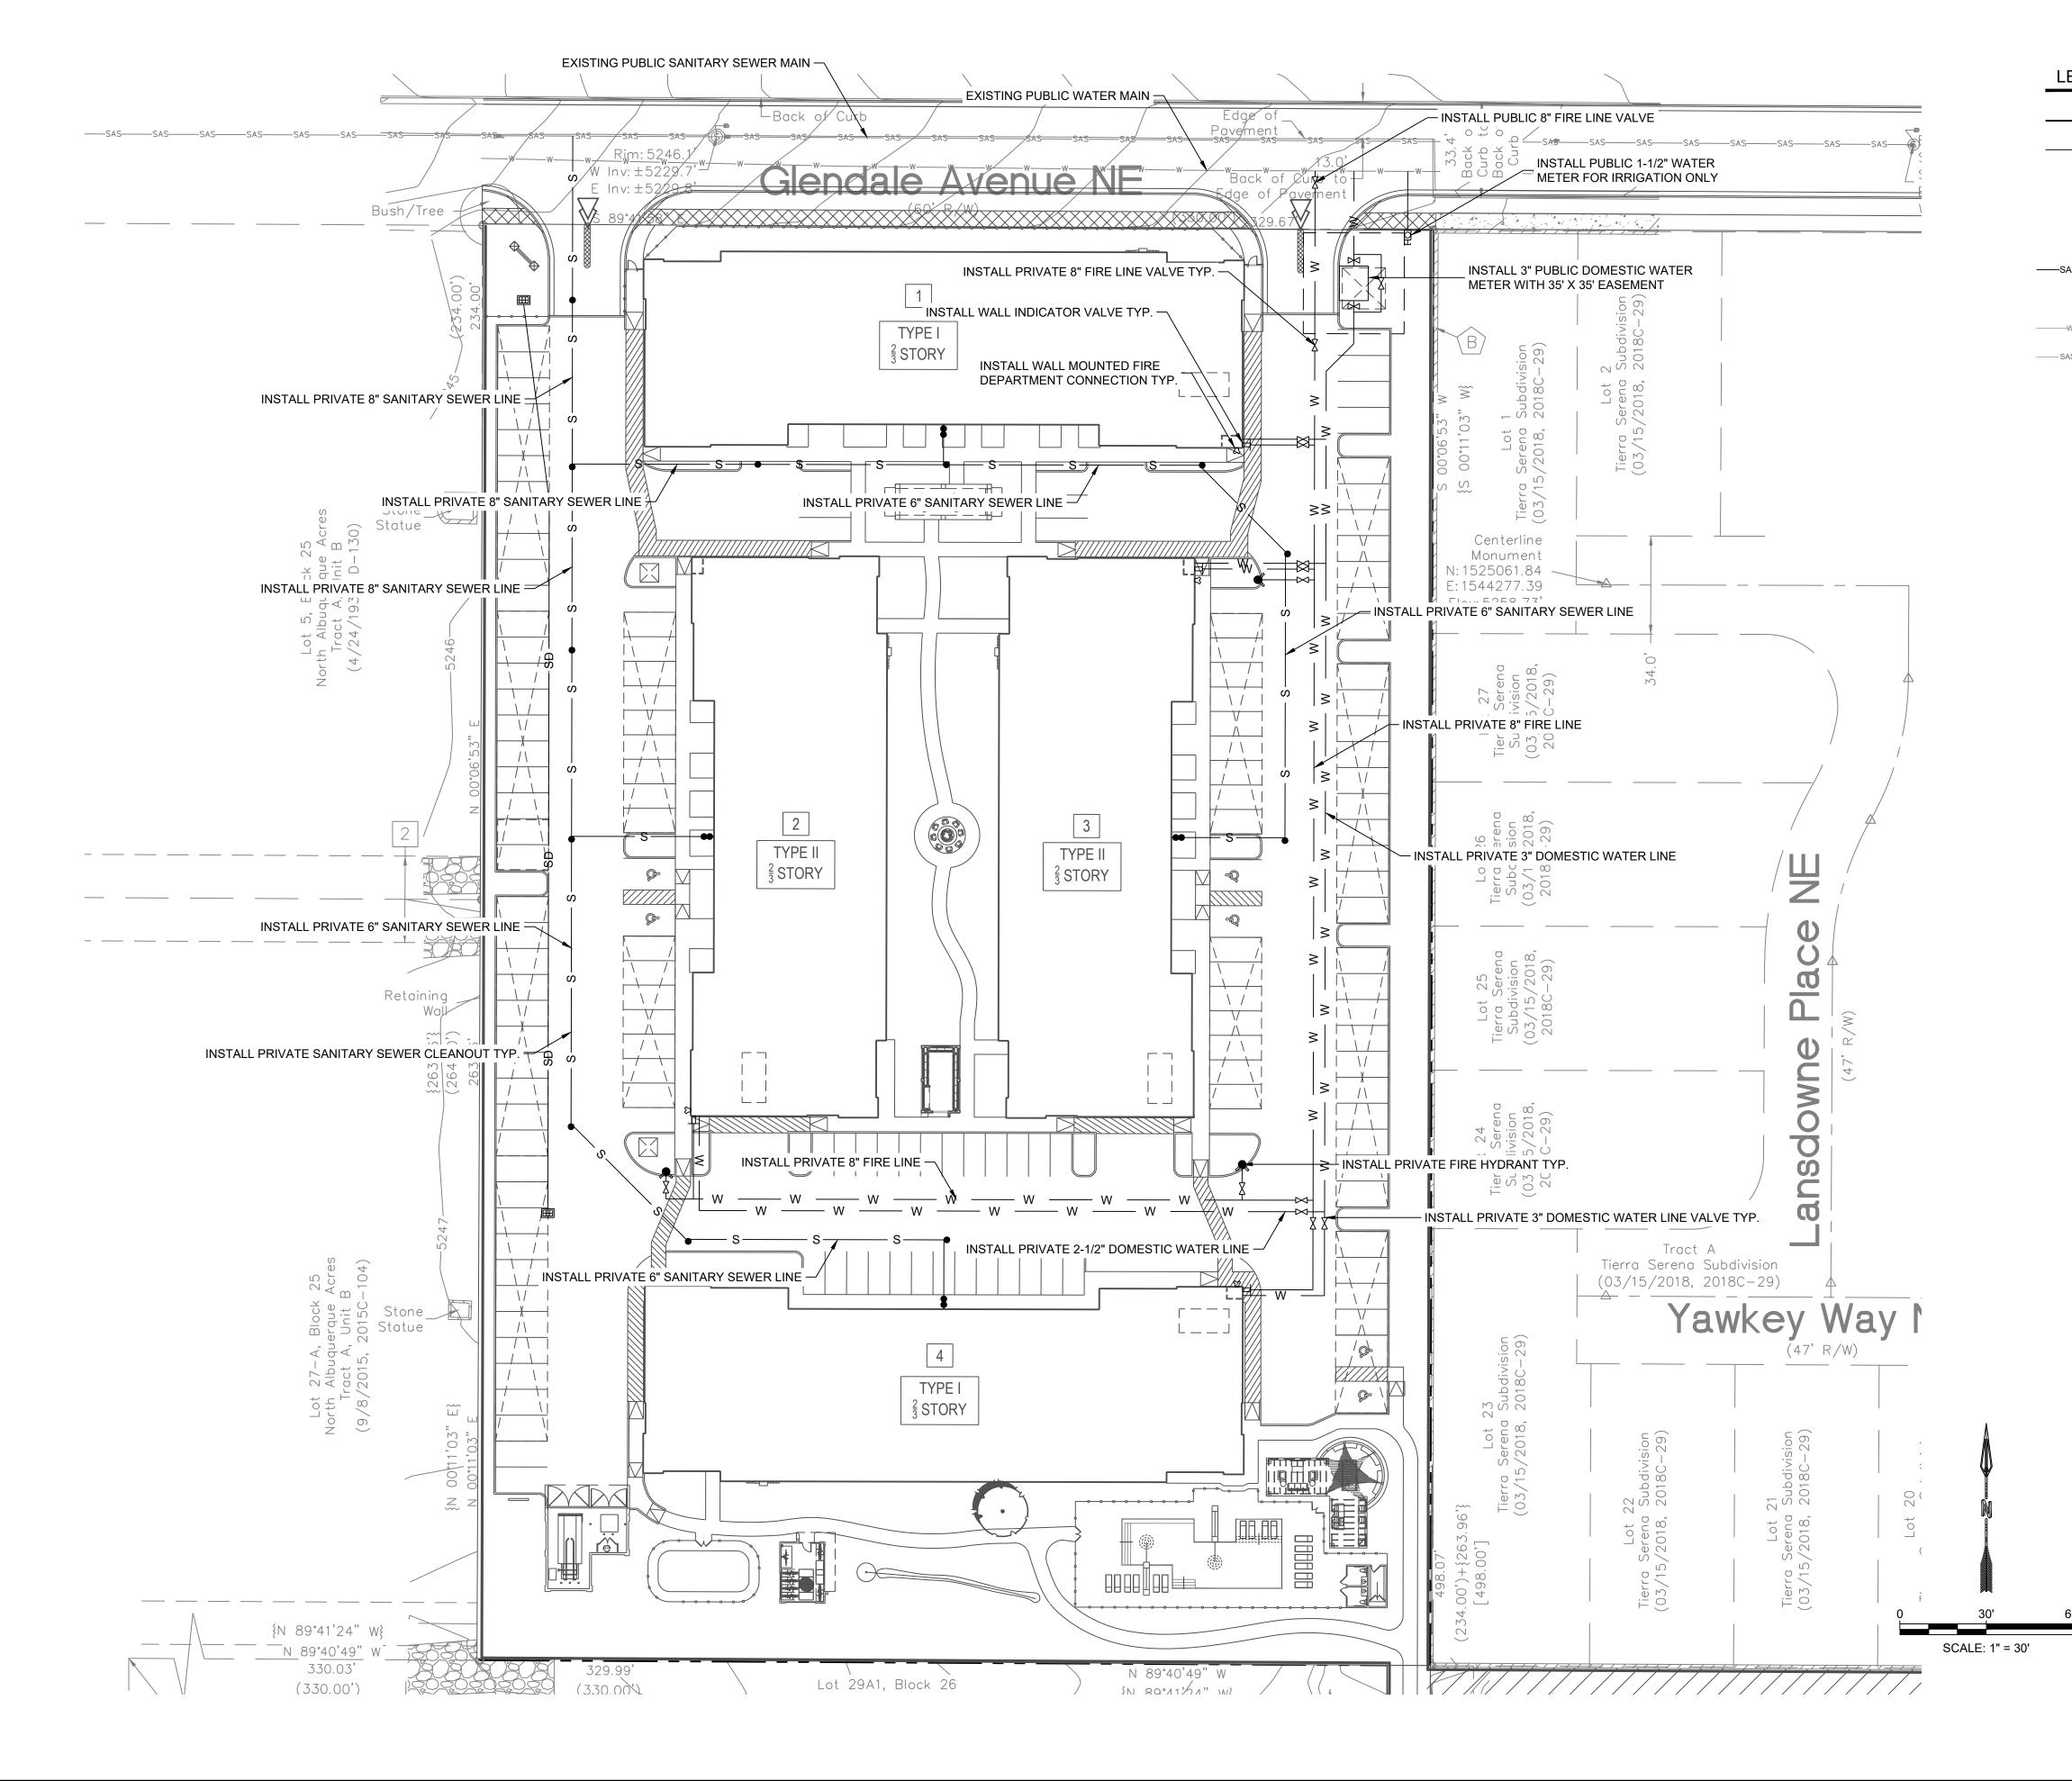


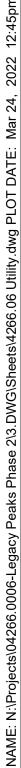


LEGEND

		• Pl
		N
	\bowtie	Ν
	Þ	Ν
	ŝ	Ν
SAS	—SAS——	N
•		N
W	W	Eک
SAS	SAS	E۷

-	PROPERTY BOUNDARY
-	NEW WATERLINE
	NEW WATER VALVE TYP.
	NEW WALL INDICATOR VALVE
	NEW FIRE DEPARTMENT CONNECTION
	NEW SEWER LINE
	NEW SEWER CLEAN OUT (TYP.)
	EXISTING WATERLINE
	EXISTING SEWER LINE

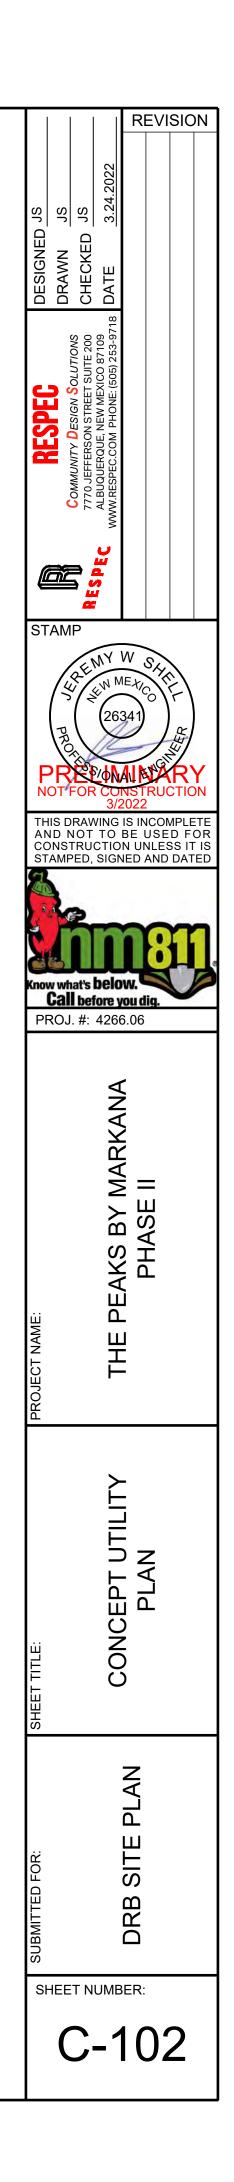



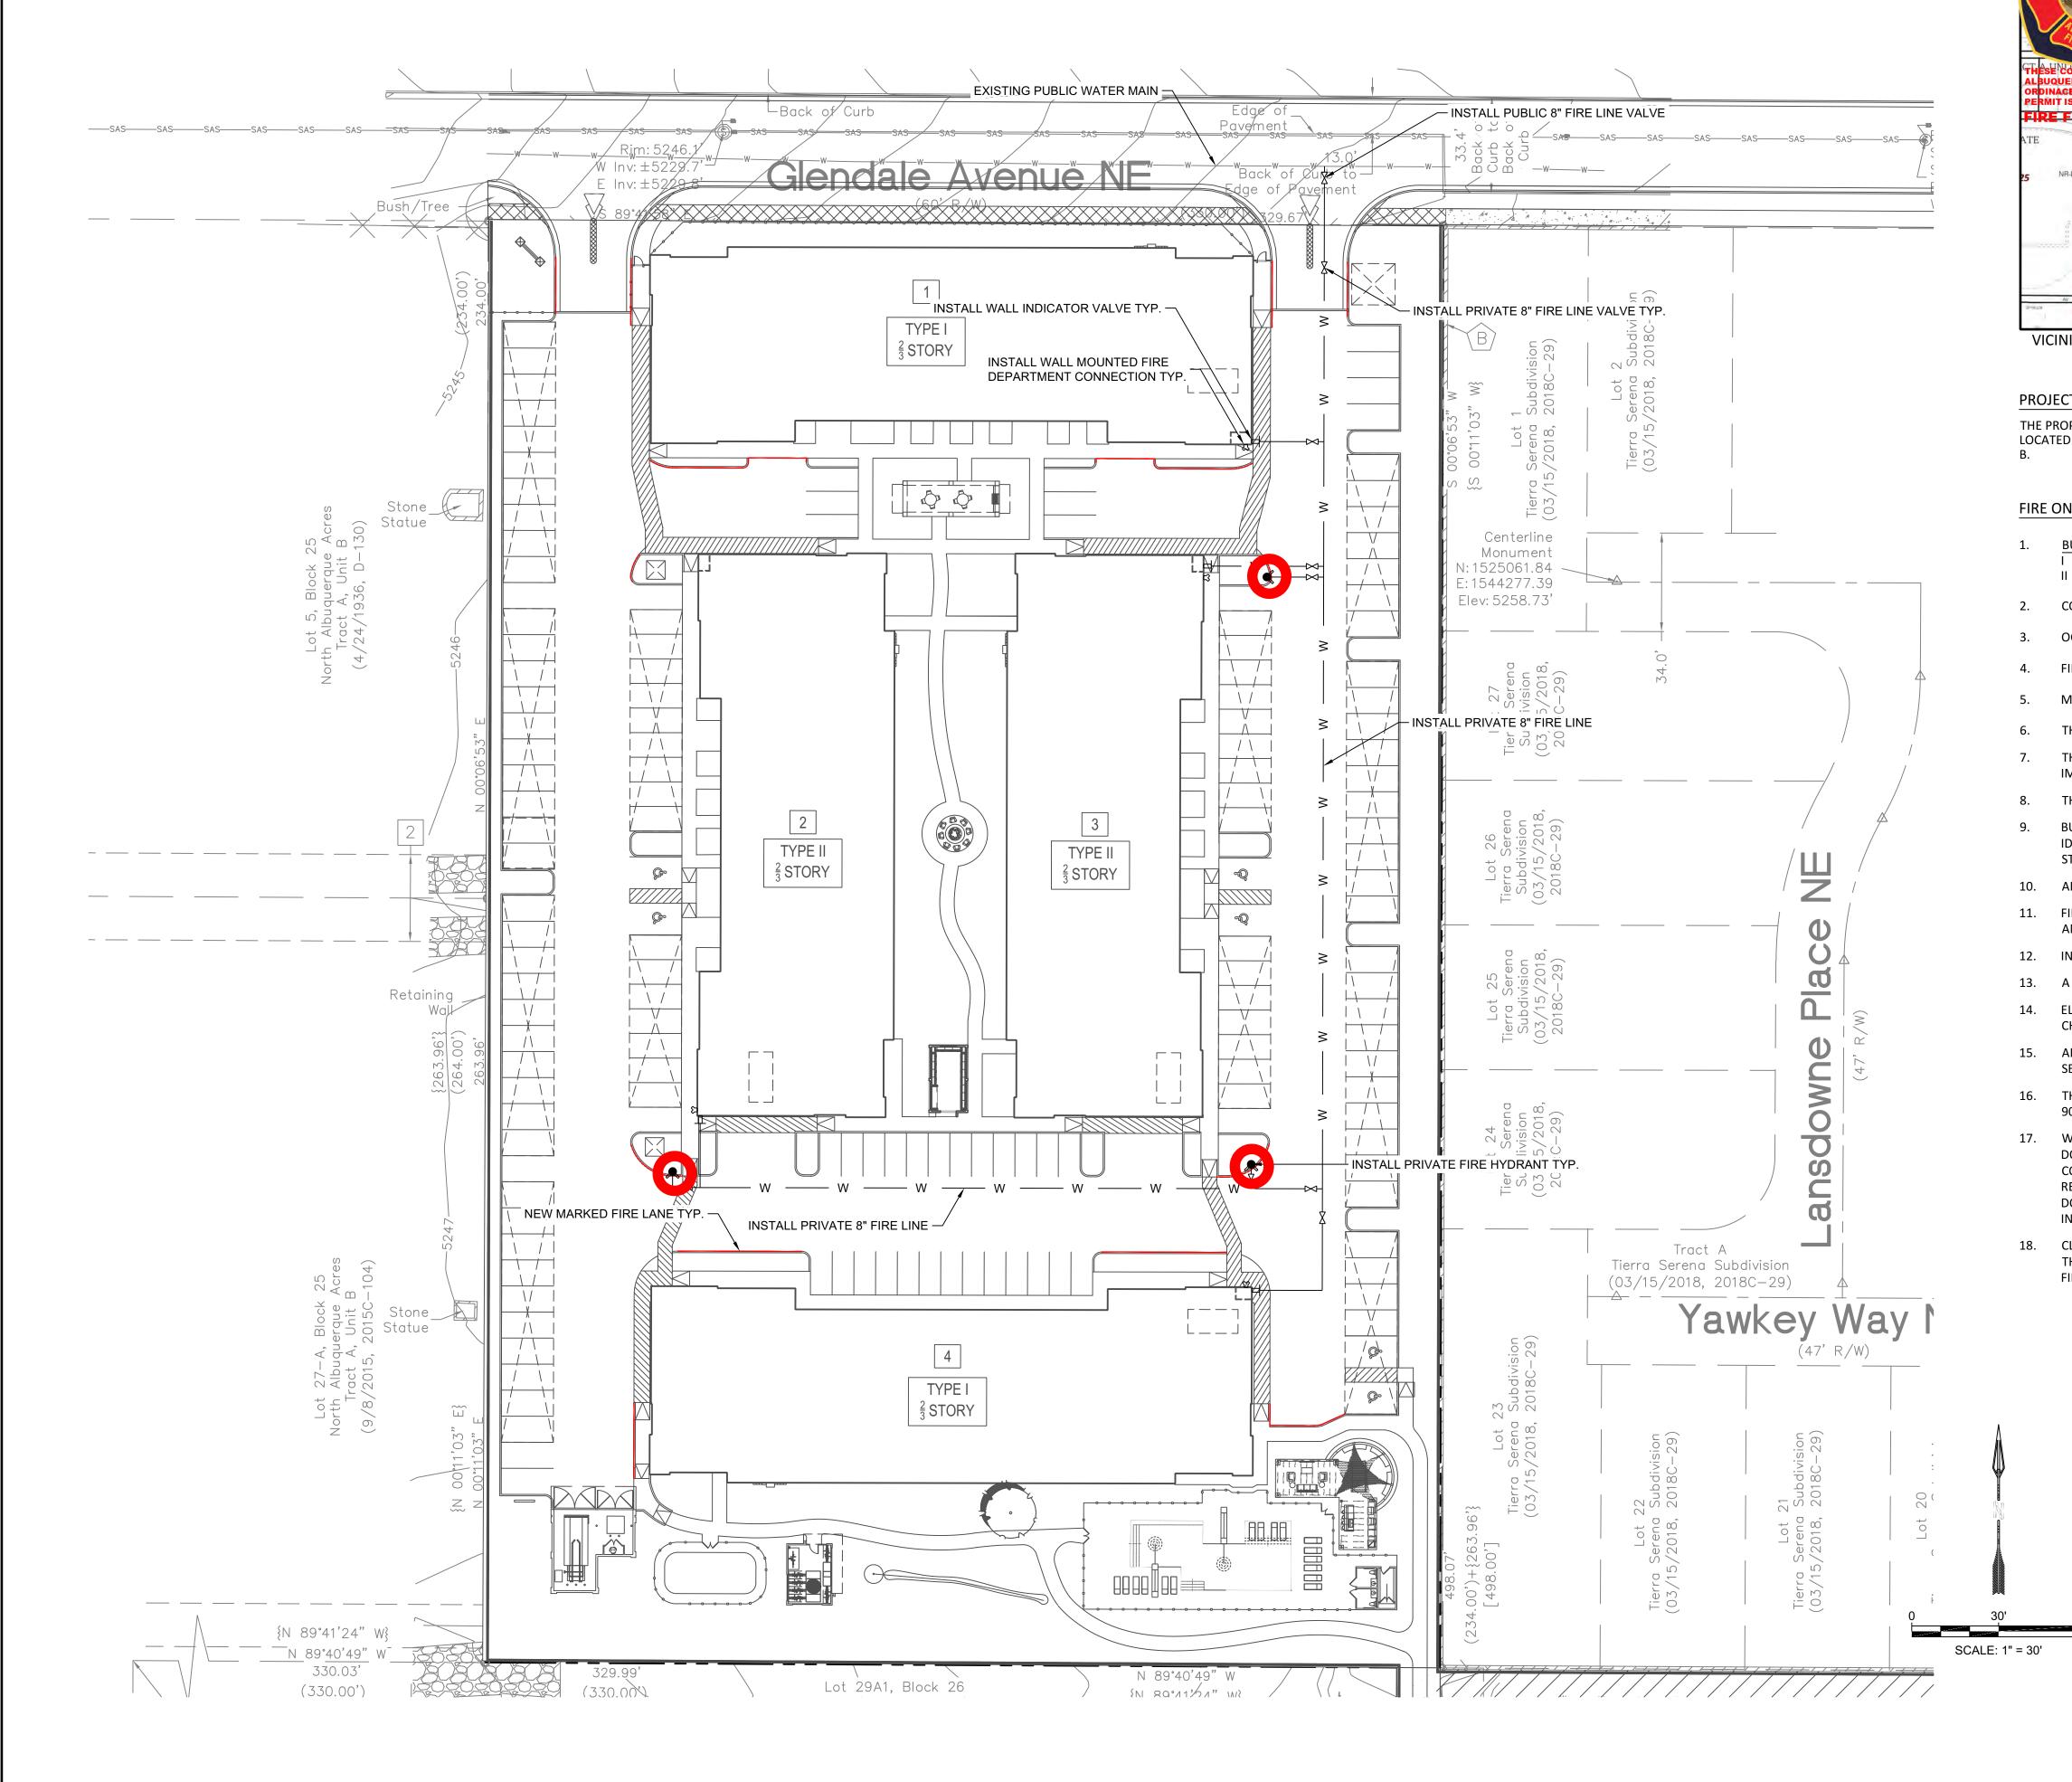



ALBUQUERQUE FIRE MARSHAL'S DIVISION OFFICE PLANS CHECKING DIVISION	
	REVISIO
PERMIT NUMBER:FP-22-009106 APPROVED DATE: 02/21/22	
Rhoursouth and	
THESE CONSTRUCTION DOCUMENTS WERE REVIEWED AND APPROVED BY THE ALBUQUERQUE FIRE MARSHAL'S OFFICE IN ACCORDANCE WITH THE CITY	
ALBUQUERQUE FIRE MARSHAL'S OFFICE IN ACCORDANCE WITH THE CITY ORDINACE, THE INTERNATIONAL FIRE CODE, AND NFPA STANDARDS. THIS PERMIT IS VALID FOR 180 DAYS. FINAL INSPECTION IS REQUIRED.	
PERMIT IS VALID FOR 180 DAYS. FINAL INSPECTION IS REQUIRED. FIRE FLOW: VA, 35,053SOFT 625 FIRE FLOW, 1 HYDRANIM ATE	
2 2 M ()	
NR-LM NR-BP // NR-SU TERRA SERENA // TRACT A UNIT B NR-PO-C	
VICINITY MAP: B-18-Z ŬÈ₽	
PROJECT SUMMARY: THE PROPOSED DEVELOPMENT IS A MULTI-FAMILY APARTMENT COMPLEX. THE PROJECT IS LOCATED ON LOTS 6, 7, AND 26-A, BLOCK 25, NORTH ALBUQUERQUE ACRES, TRACT A, UNIT	
B. STAMP	
EMYW	$\mathcal{O}_{\mathcal{A}}$
FIRE ONE NOTES:	W/E
	$)^{\circ})^{r}$
1. <u>BUILDING TYPE</u> <u>AREA</u> 및 및	一
I 34,053 SQ. FT. II 32,566 SQ. FT.	
2. CONSTRUCTION TYPE = V-A	TRUCTION
3. OCCUPANCY TYPE: R-2 THIS DRAWING IS AND NOT TO BE	
4. FIRE FLOW = 1,625 GPM	
5. MAXIMUM BUILDING HEIGHT = 32'	
6. THE PROPOSED BUILDINGS SHALL BE FULLY SPRINKLED NFPA 13.	RT
7. THE PARKING LOT SURFACE SHALL BE ASPHALT AND CAPABLE OF SUPPORTING AN IMPOSED LOAD OF A FIRE APPARATUS WEIGHING 75,000 LBS.	
8. THE MINIMUM DRIVE ISLE WIDTH SHALL 26' UNLESS OTHERWISE SPECIFIED. Call before you PROJ. #: 4266.0	

- 9. BUILDINGS SHALL HAVE APPROVED ADDRESS NUMBERS OR BUILDING
- IDENTIFICATION PLACED IN A POSITION PLAINLY LEGIBLE AND VISIBLE FROM THE STREET.
- 10. ALL DRIVING SURFACES SHALL NOT EXCEED 10 PERCENT IN GRADE.
- 11. FIRE DEPARTMENT CONNECTION'S SHALL BE LOCATED WITHIN 100' OF A HYDRANT AND BE UNOBSTRUCTED FROM ANY OBJECT FOR A MINIMUM DISTANCE OF 3'.

A Z

AKS BY MARI PHASE II

Д

Ω

뿌

 $\overline{}$

FIRE

REVIEW

SHEET NUMBER:

F-100

- 12. INDICATOR VALVES SHALL BE PROVIDED PER NFPA 13.
- 13. A KNOX BOX SHALL BE PROVIDED AT ALL PROPOSED GATE LOCATIONS.
- 14. ELEVATORS SHALL MEET ALL THE REQUIREMENTS IN NFPA 13, CHAPTER 8 AND 72, CHAPTER 21.
- 15. ALL HYDRANT SUPPLY LINES THAT BRANCH OFF FROM THE WATER MAIN AND FIRE SERVICE LINES TO BUILDINGS WILL BE 6" DIAMETER UNLESS OTHERWISE SPECIFIED.
- 16. THE BUILDINGS WILL BE REQUIRED TO HAVE FIRE AND SMOKE ALARMS PER IBC 907.2.9.
- 17. WORK SHALL BE IN ACCORDANCE WITH THE APPROVED CONSTRUCTION DOCUMENTS, AND ANY CHANGES MADE DURING CONSTRUCTION THAT ARE NOT IN COMPLIANCE WITH THE APPROVED CONSTRUCTION DOCUMENTS SHALL BE RESUBMITTED FOR APPROVAL AS AN AMENDED SET OF CONSTRUCTION DOCUMENTS. APPROVED WET STAMPED SHOP DRAWING SHALL BE ON SITE FOR INSPECTIONS.
- CLASS 1 STANDPIPE SHALL BE PROVIDED IN BUILDINGS WHERE THE FLOOR LEVEL OF THE HIGHEST STORY IS LOCATED MORE THAN 30' ABOVE THE LOWEST LEVEL OF FIRE DEPARTMENT VEHICLE ACCESS.

LEGEND:

- ---- PROPERTY BOUNDARY
- NEW MARKED FIRE LANE
- -w----- NEW WATERLINE







Designed


















0 2' 4' 8'

MATERIAL KEY NOTE

- WOOD-LOOK FIBER CEMENT SIDING BROWN

- WALL SIGNAGE, LIMITED TO 10% FACADE AREA.


DRB - BLDG TYPE II - FRONT ELEVATION 1/8" = 1'-0"

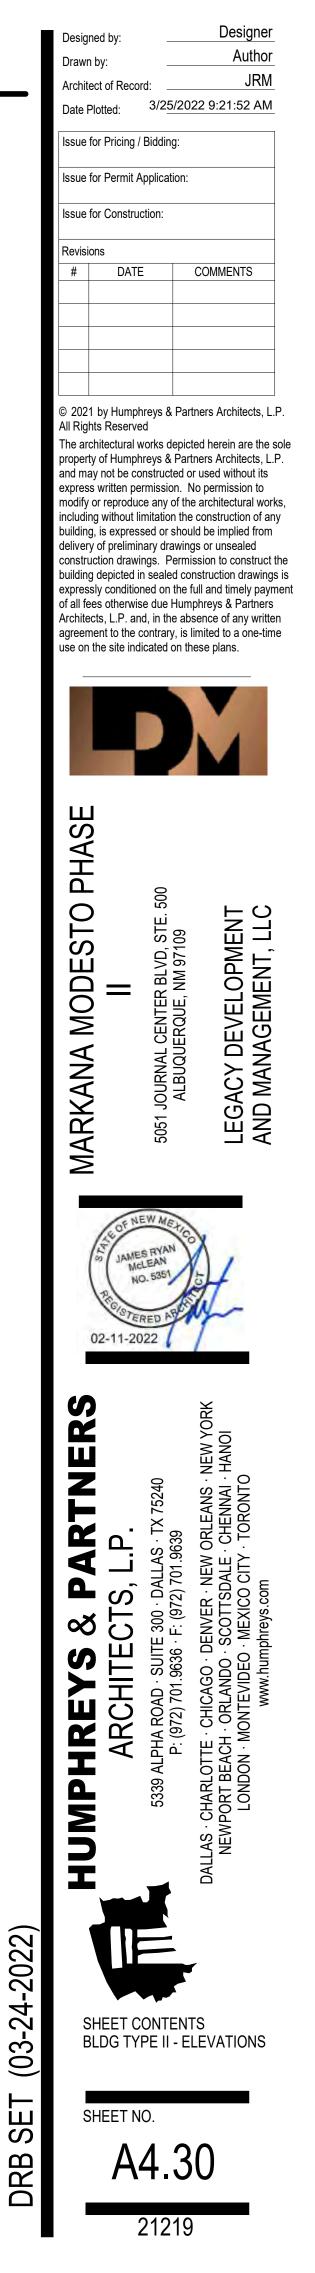









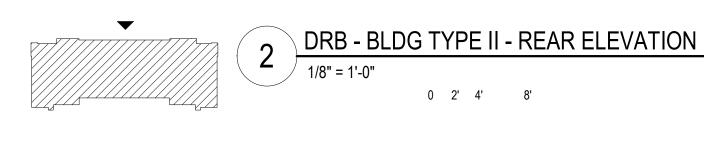

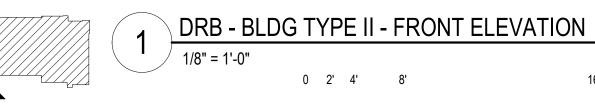



16'

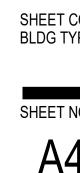

(03-24-2022)

DRB SET

SHEET CONTENTS BLDG TYPE II - ELEVATIONS SHEET NO. A4.30b

21219

E

Designer


Author


LEGACY DEVELOPMENT AND MANAGEMENT, LLC

ANS · NNAI ·

CHARLOTTE · PORT BEACH · I ONDON · M(

JRM

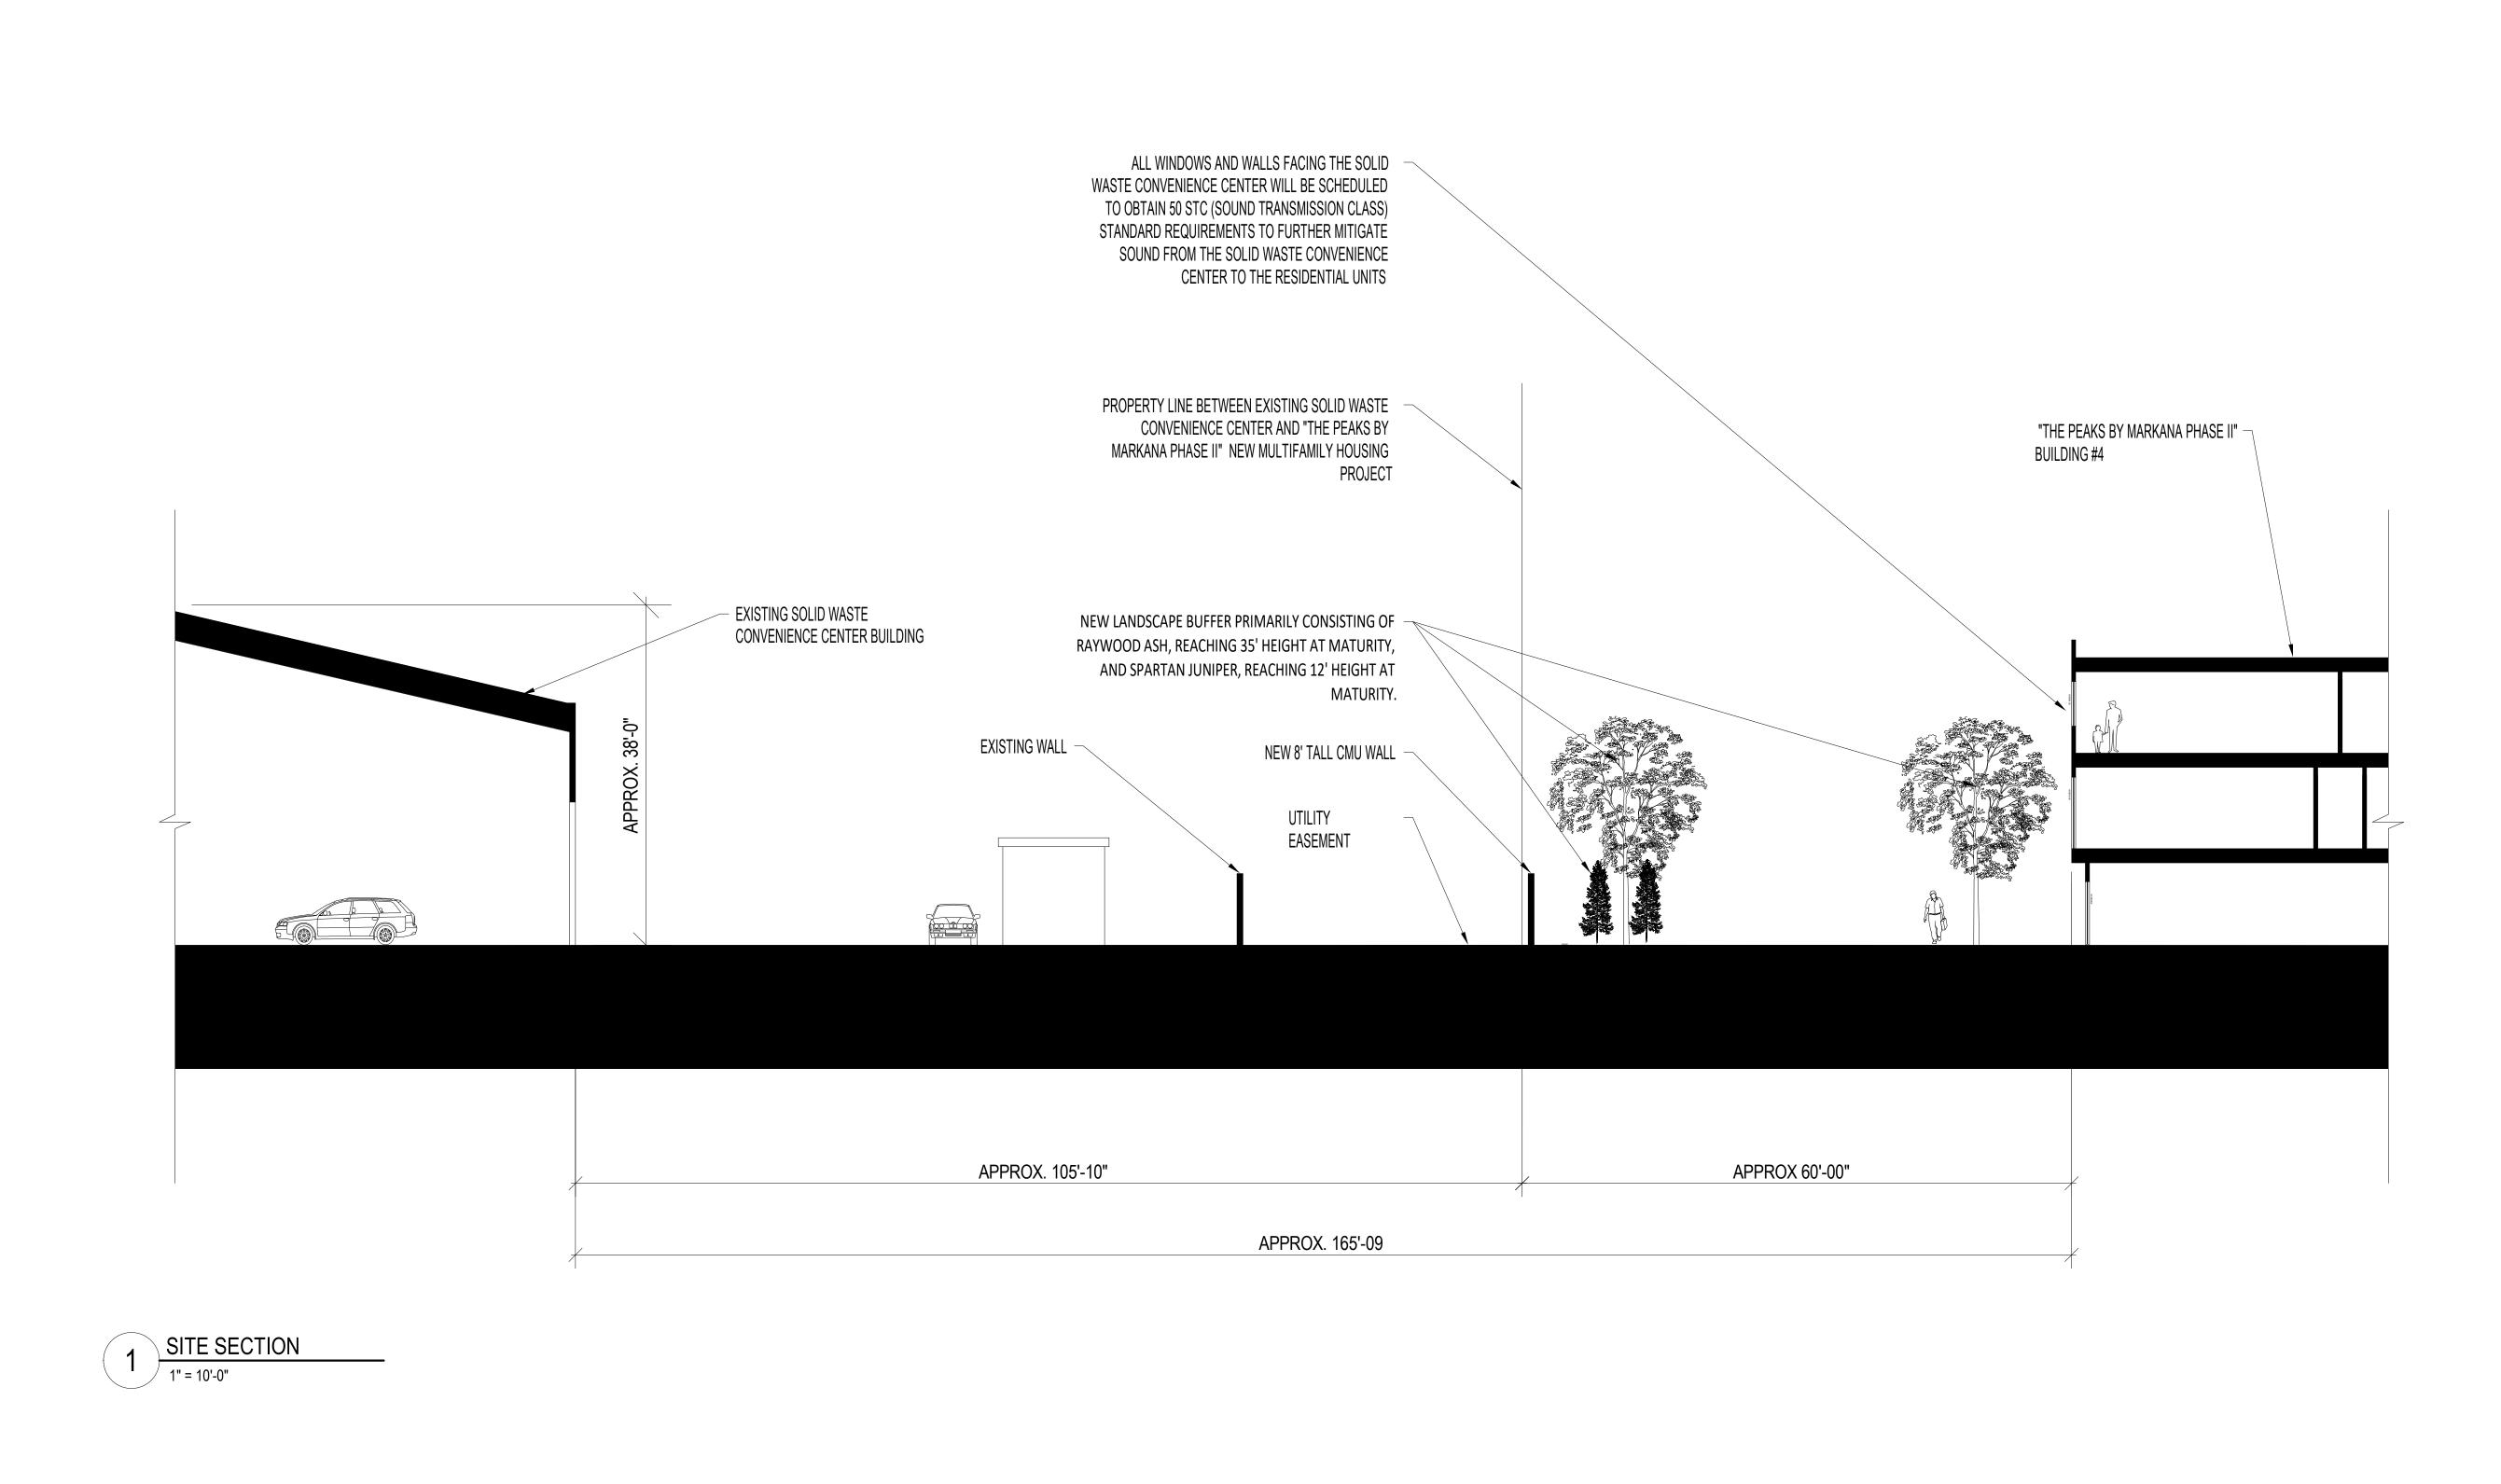

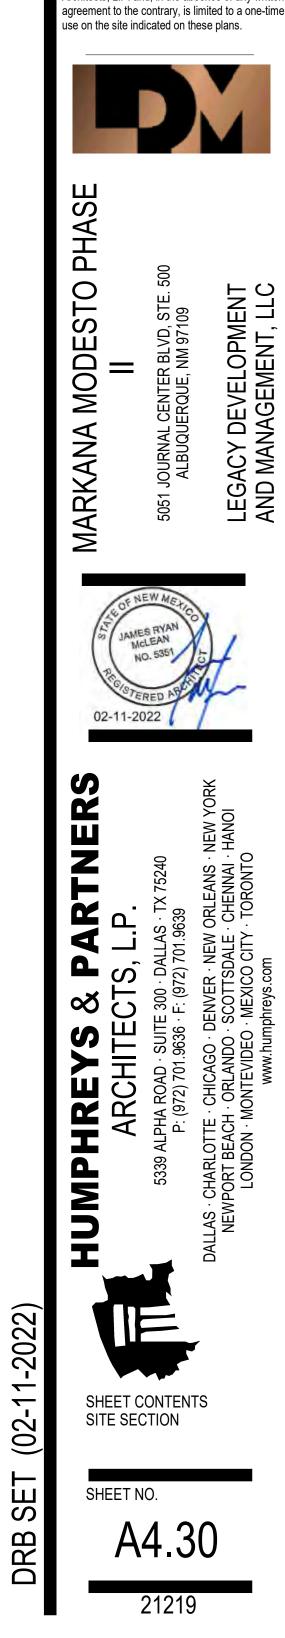

modify or reproduce any of the architectural works, including without limitation the construction of any building, is expressed or should be implied from delivery of preliminary drawings or unsealed construction drawings. Permission to construct the building depicted in sealed construction drawings is expressly conditioned on the full and timely payment of all fees otherwise due Humphreys & Partners Architects, L.P. and, in the absence of any written agreement to the contrary, is limited to a one-time use on the site indicated on these plans.

© 2021 by Humphreys & Partners Architects, L.P.

The architectural works depicted herein are the sole property of Humphreys & Partners Architects, L.P. and may not be constructed or used without its express written permission. No permission to

Date	Plotted:	2/10	/2022 4:20:24 PM
Issue	for Pricing /	Biddin	g:
Issue	for Permit A	pplicat	ion:
Issue	for Construc	ction:	
Revisi	ons		
#	DATE		COMMENTS

Designed b

Drawn by:


Architect of Record:


All Rights Reserved

Designer


Author

JRM

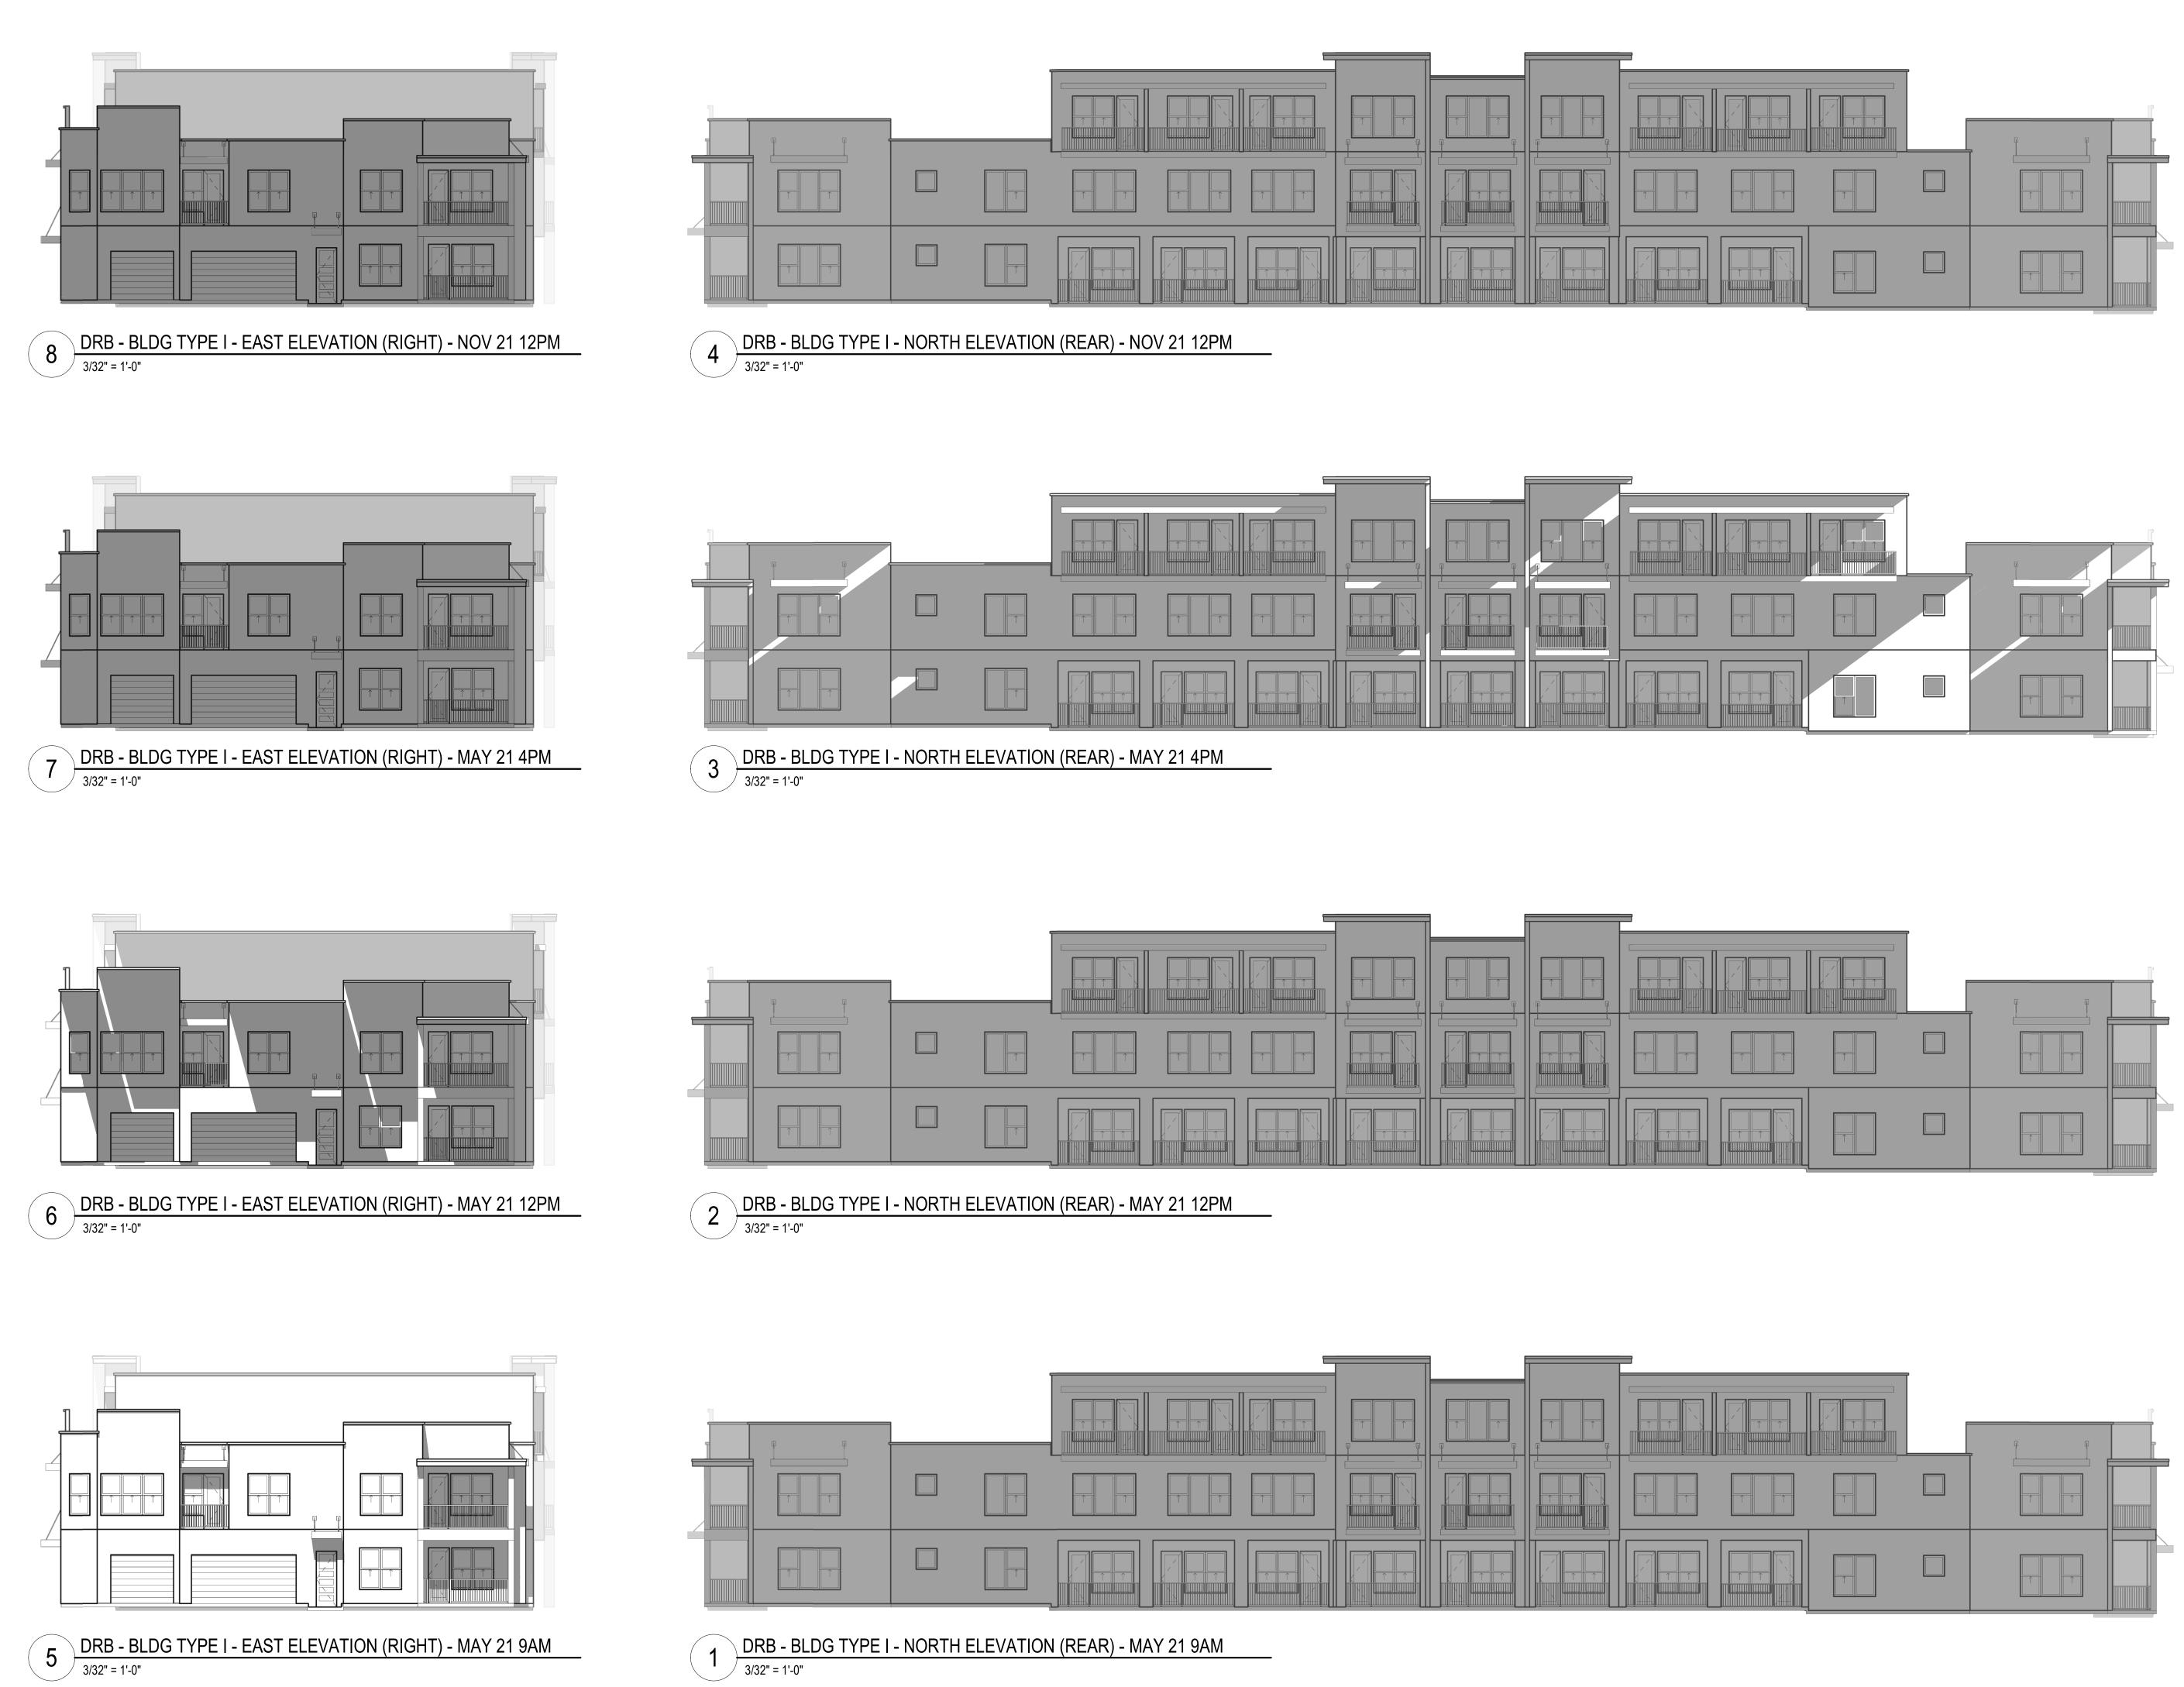


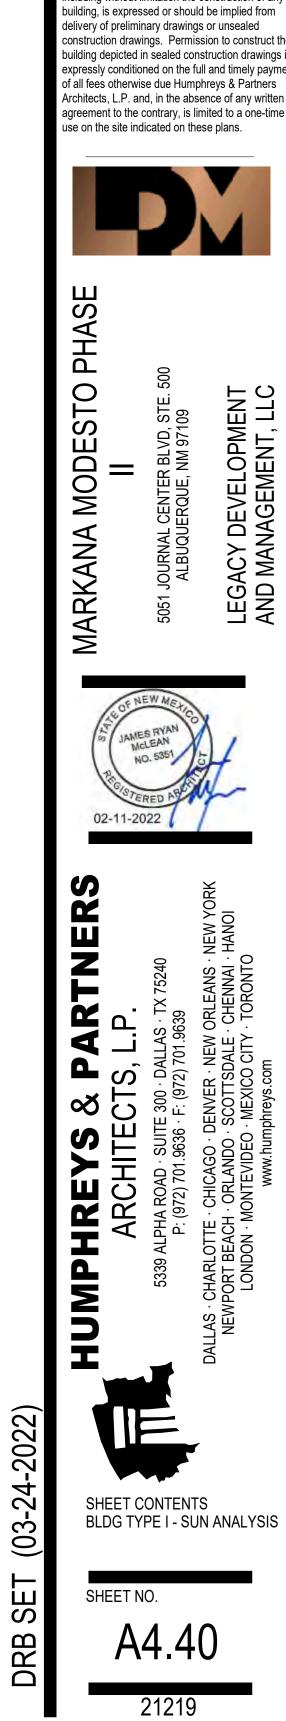

Desia	ned by:	Designer
Draw	•	Author
	ect of Record:	JRM
Date I	Plotted: 3/25/	2022 11:06:12 AM
Issue	for Pricing / Biddir	ng:
Issue	for Permit Applica	tion:
Issue	for Construction:	
Revisi	ons	
#	DATE	COMMENTS
The ar proper and m express modify includi buildin deliver constru- buildin express of all fe Archite agreer	ty of Humphreys 8 ay not be construct s written permission or reproduce any ng without limitation g, is expressed or y of preliminary dr uction drawings. F g depicted in sealed sely conditioned on bes otherwise due bects, L.P. and, in th	depicted herein are the s Partners Architects, L.I ted or used without its on. No permission to of the architectural work on the construction of an should be implied from awings or unsealed Permission to construct the ed construction drawings the full and timely paym Humphreys & Partners he absence of any writte y, is limited to a one-tim on these plans.
Ц	í	

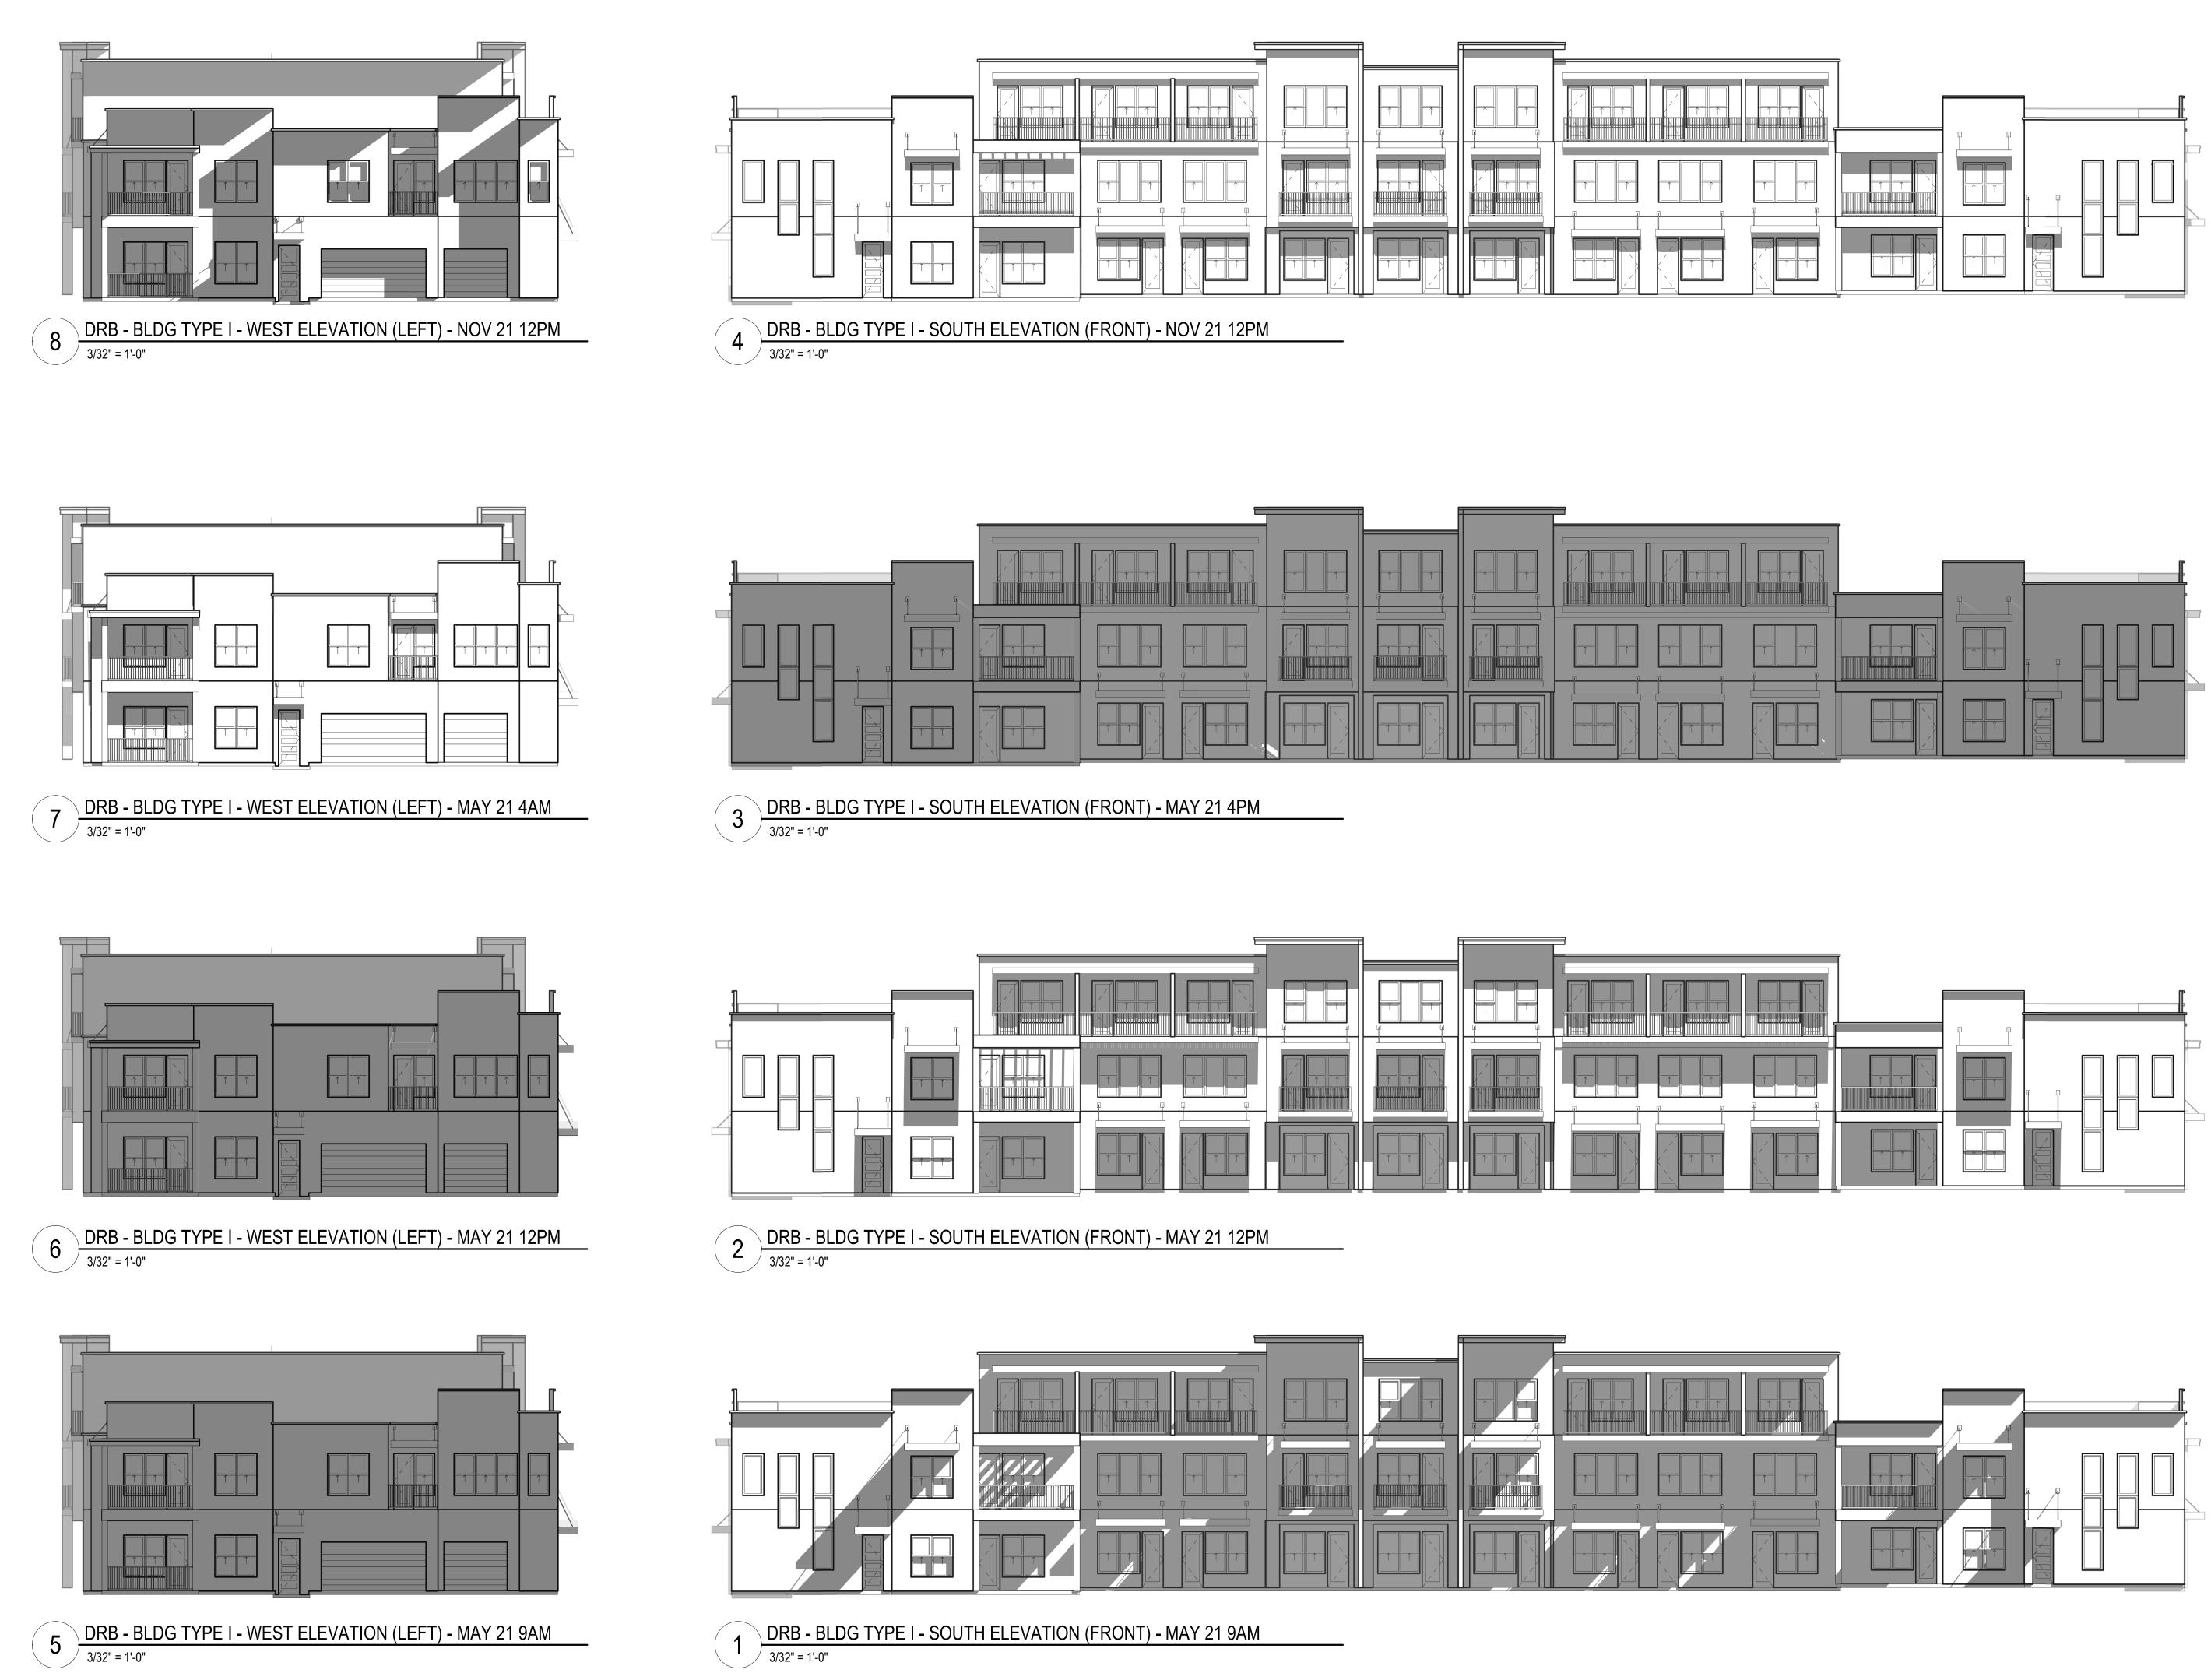



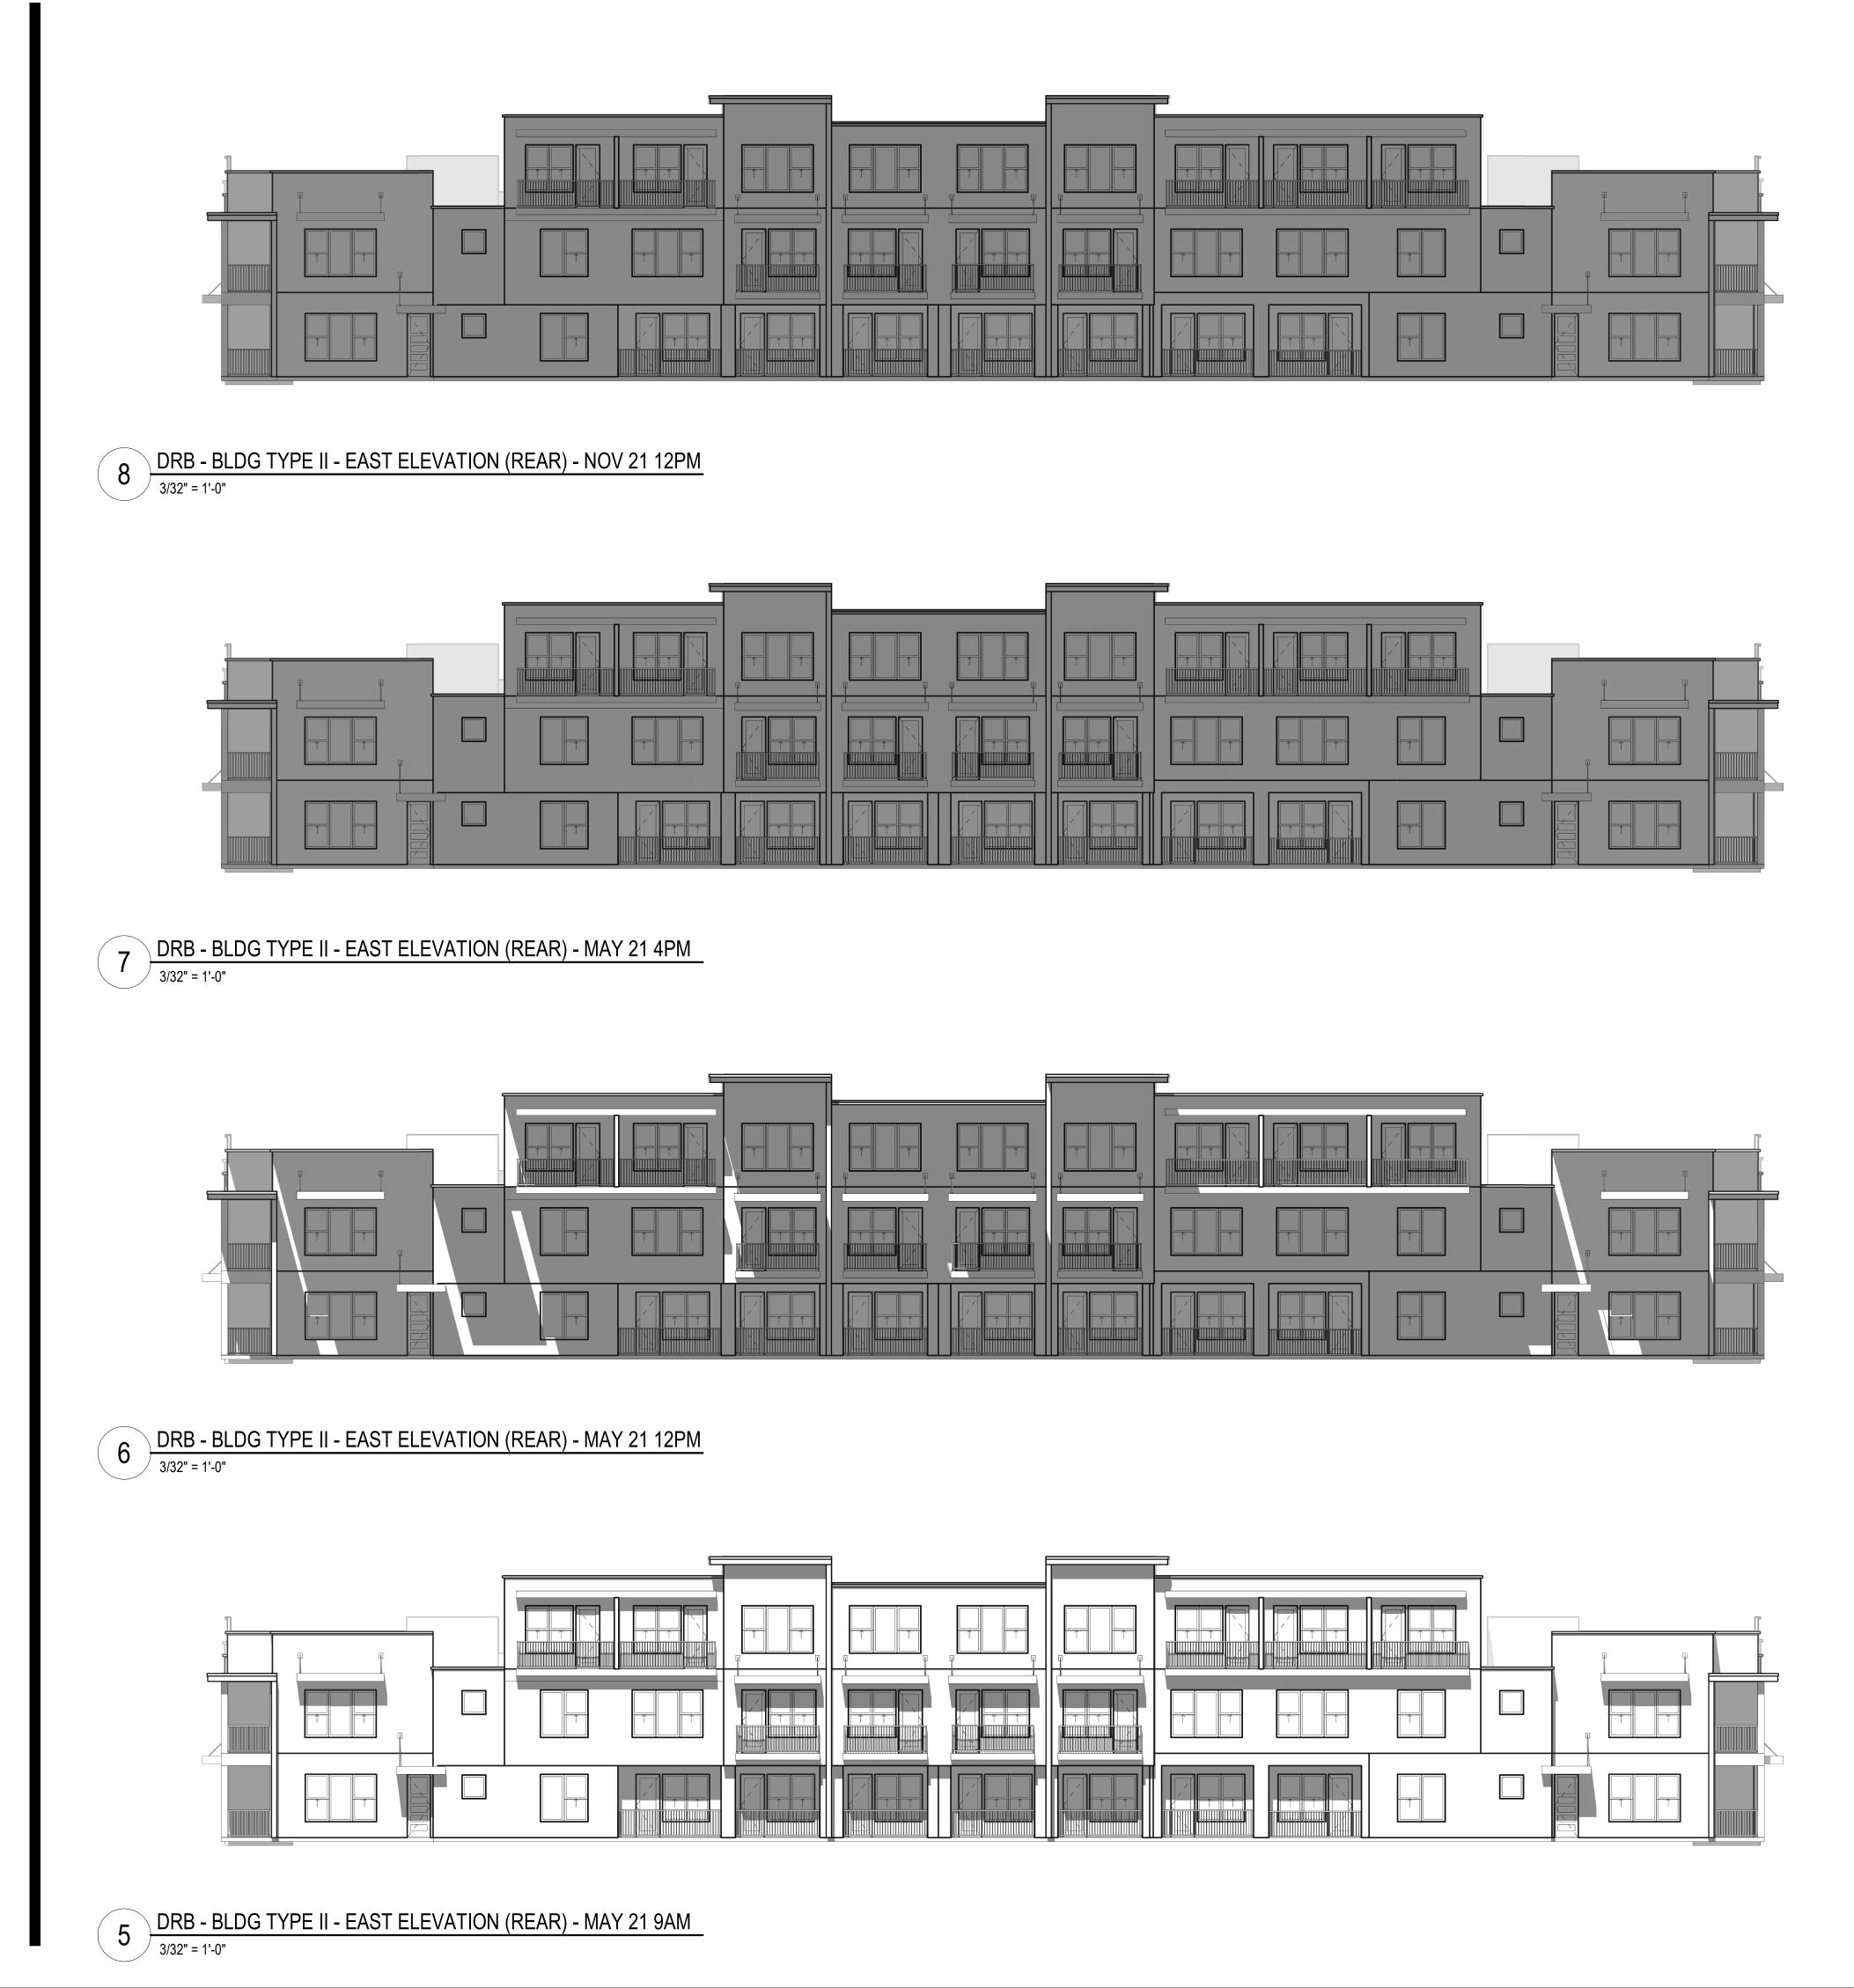












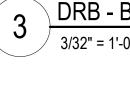



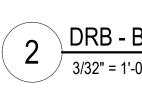



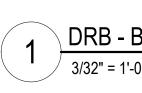


DRB - BLDG TYPE II - NORTH ELEVATION (LEFT) - NOV 21 12PM 3/32" = 1'-0"

DRB - BLDG TYPE II - NORTH ELEVATION (LEFT) - MAY 21 4PM 3/32" = 1'-0"

DRB - BLDG TYPE II - NORTH ELEVATION (LEFT) - MAY 21 12PM 3/32" = 1'-0"

DRB - BLDG TYPE II - NORTH ELEVATION (LEFT) - MAY 21 9AM 3/32" = 1'-0"

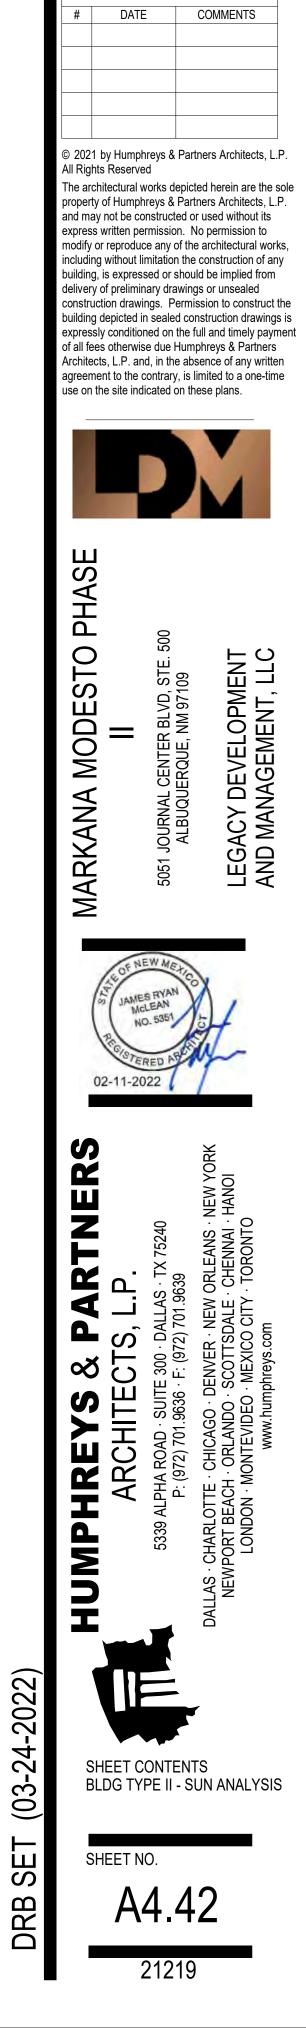

Designer

Author

JRM

Designed

Drawn by

Architect of Record:


Issue for Pricing / Bidding:

Issue for Permit Application:


Issue for Construction:

Revisions


Date Plotted: 3/25/2022 11:08:03 AM

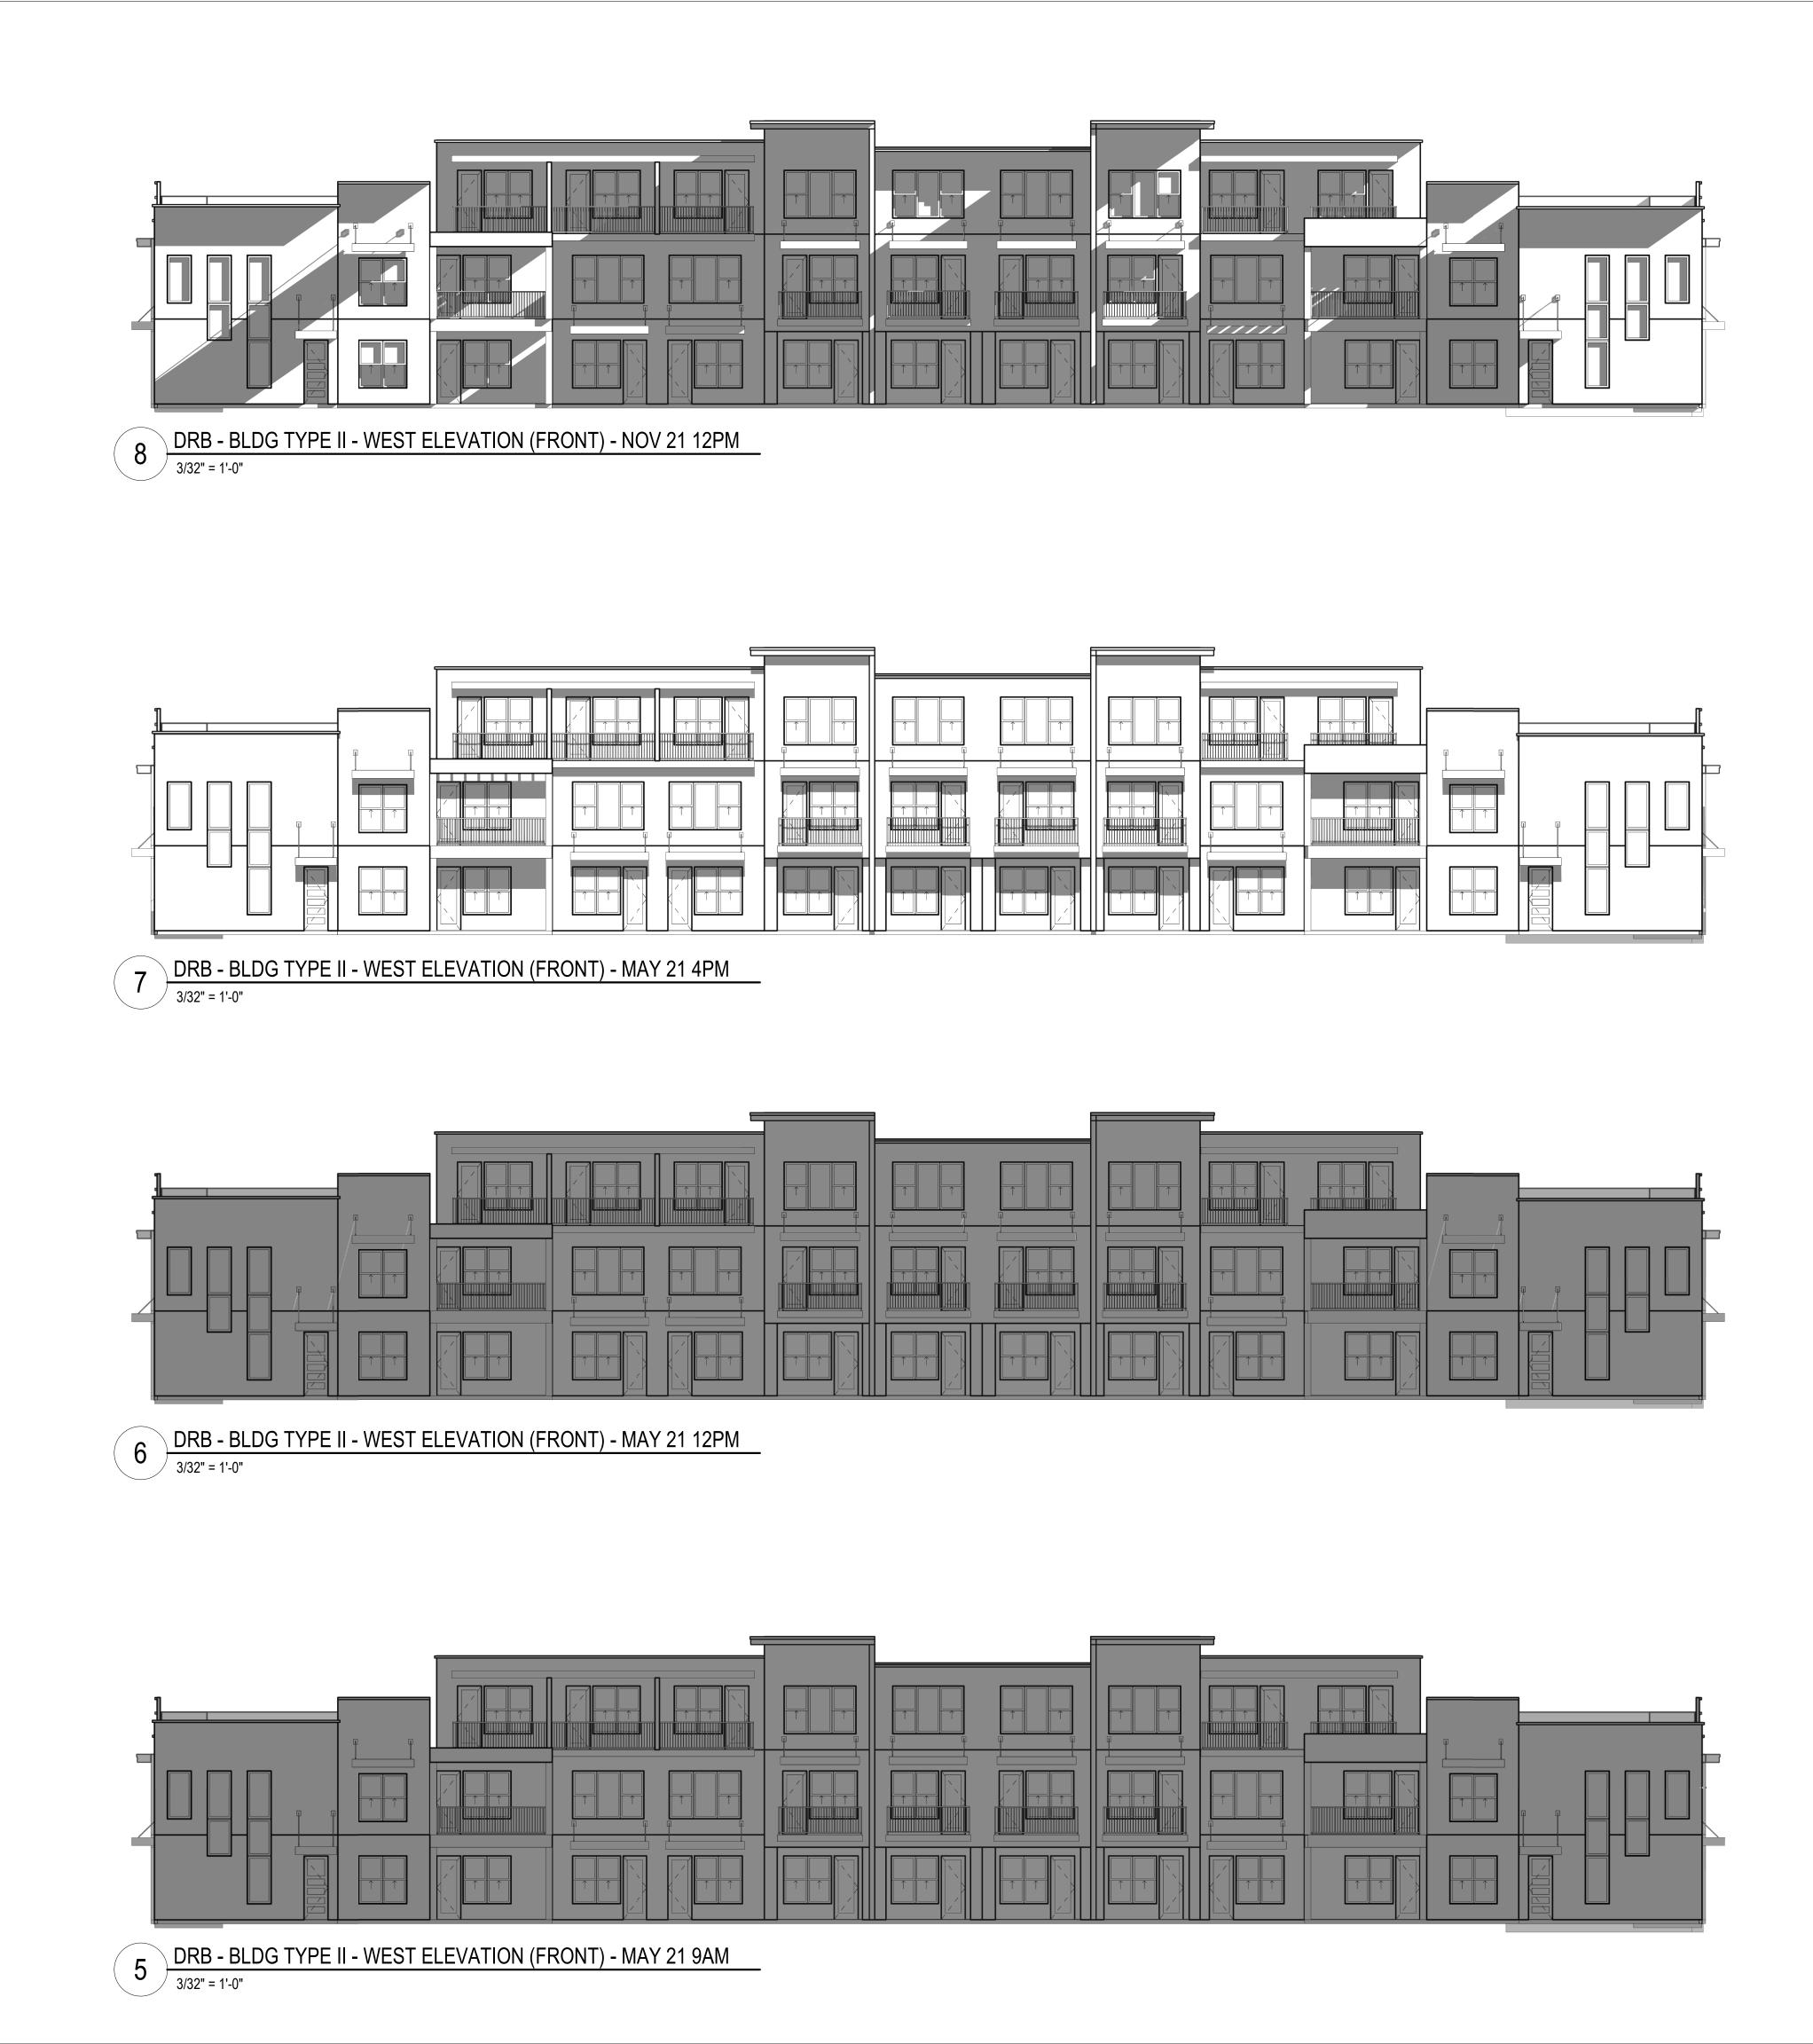




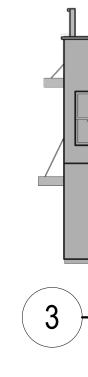





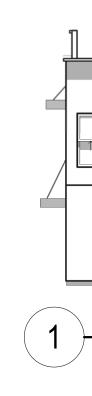




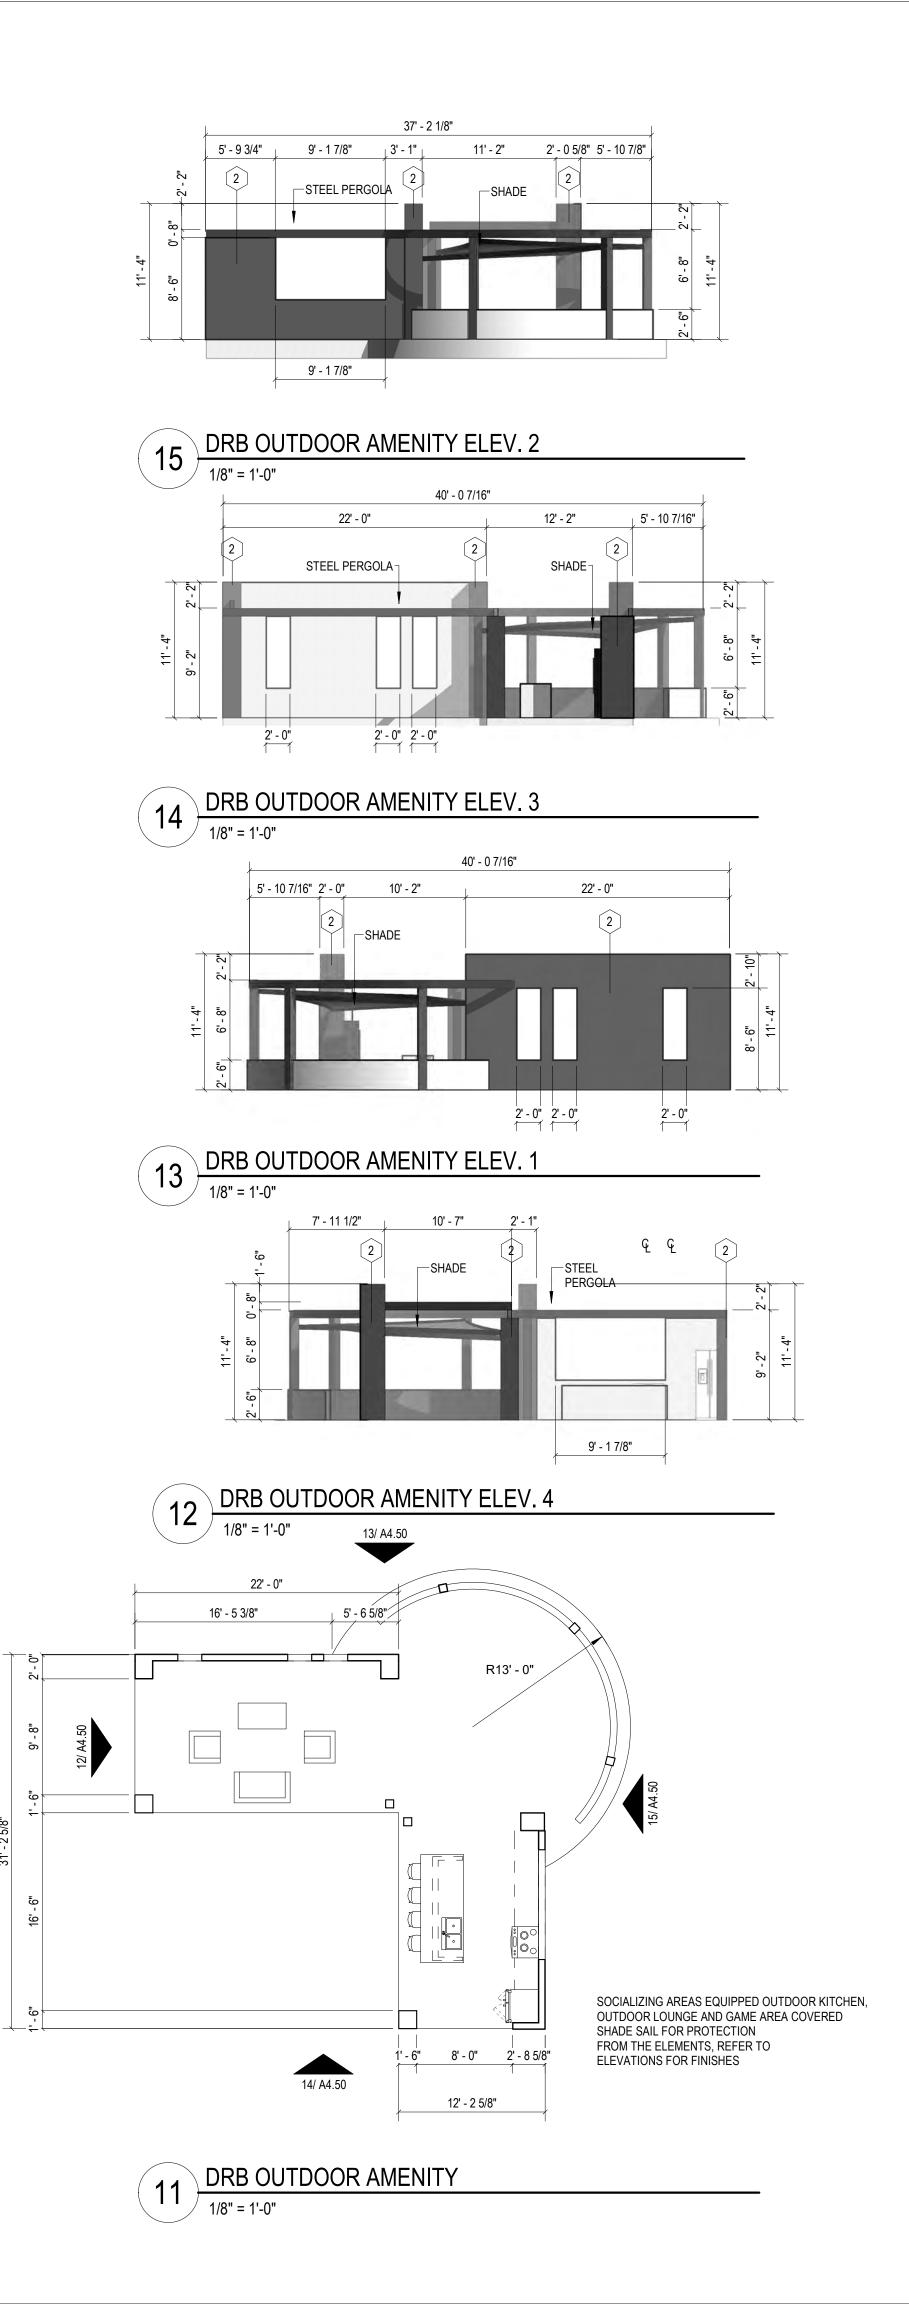


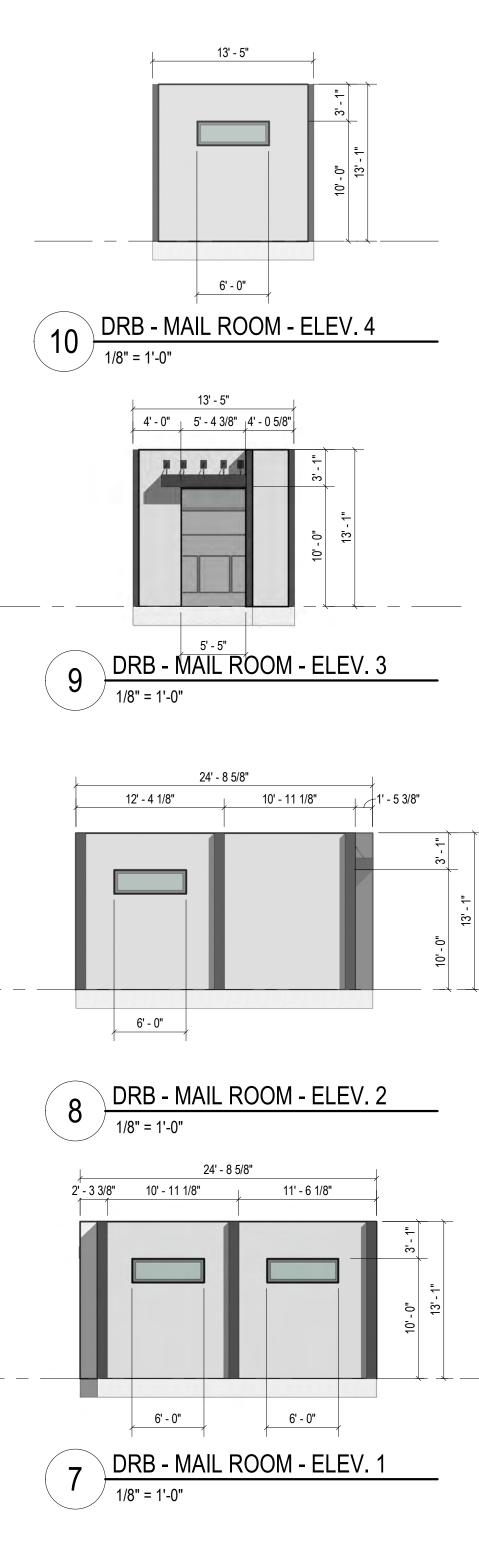


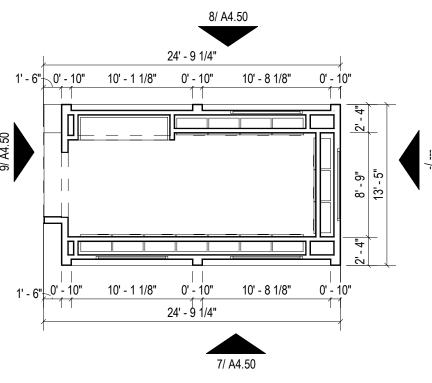



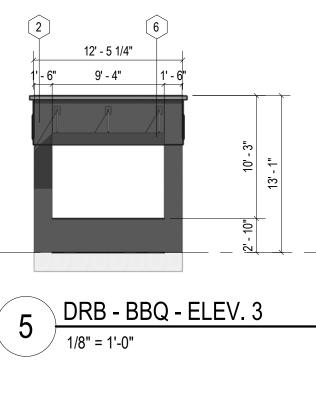


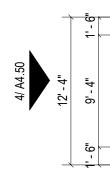


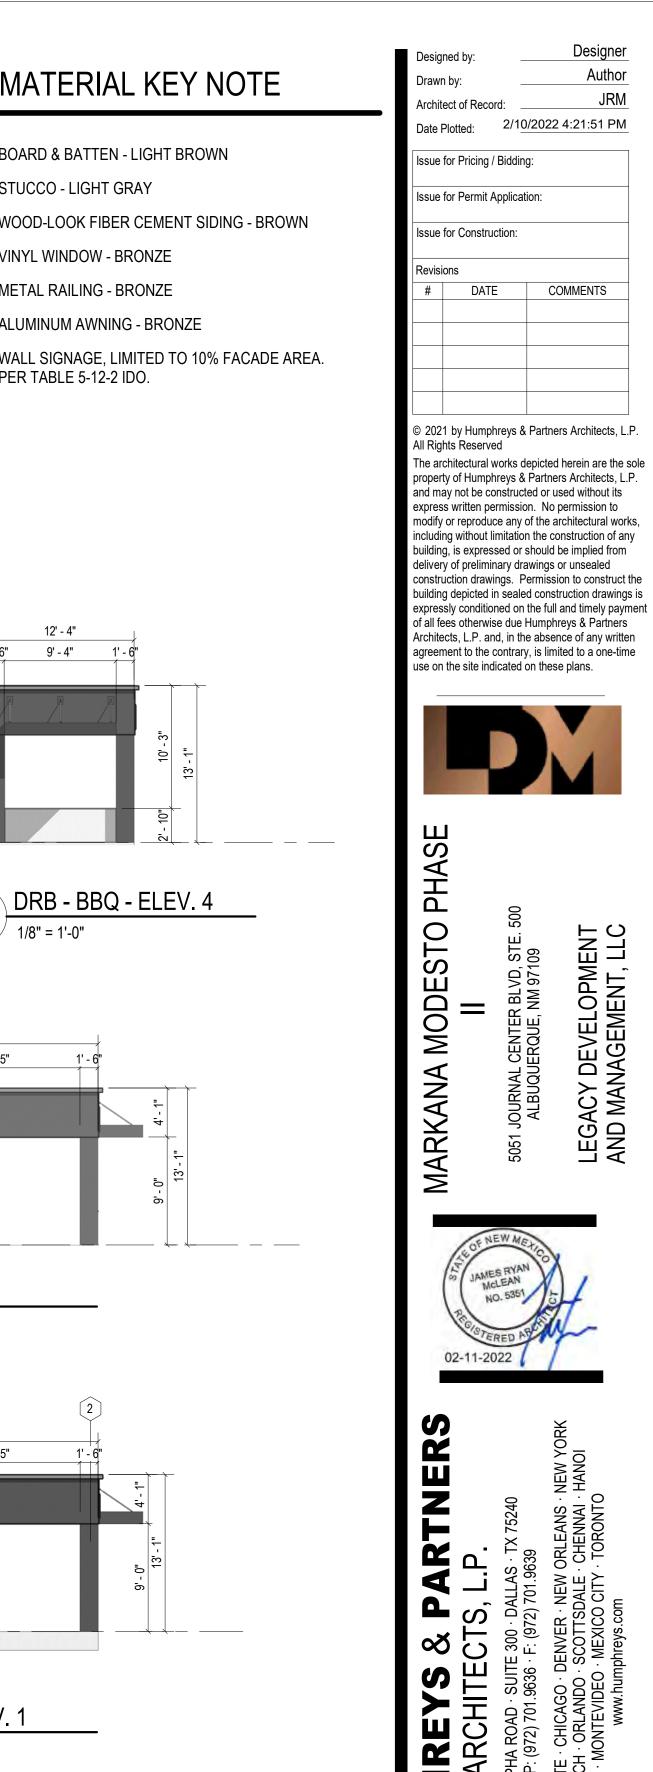

MATERIAL KEY NOTE


- (1)BOARD & BATTEN - LIGHT BROWN
- 2 STUCCO - LIGHT GRAY
- 3 WOOD-LOOK FIBER CEMENT SIDING - BROWN
- 4 VINYL WINDOW - BRONZE
- 5 METAL RAILING - BRONZE
- 6 ALUMINUM AWNING - BRONZE
- WALL SIGNAGE, LIMITED TO 10% FACADE AREA. PER TABLE 5-12-2 IDO. $\widehat{7}$

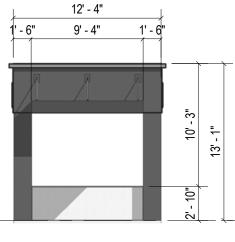


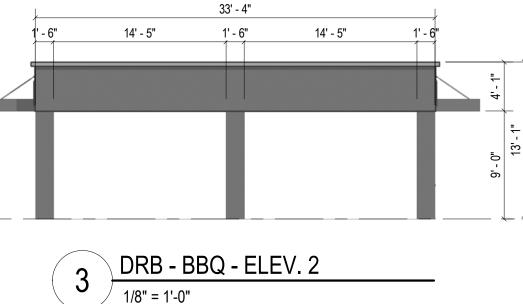

4

/ 1/8" = 1'-0"

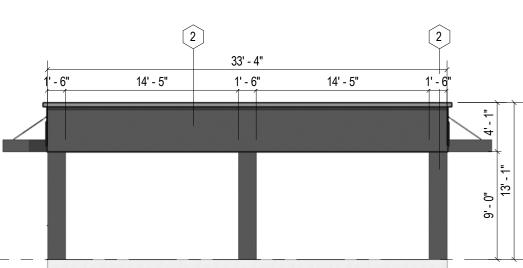

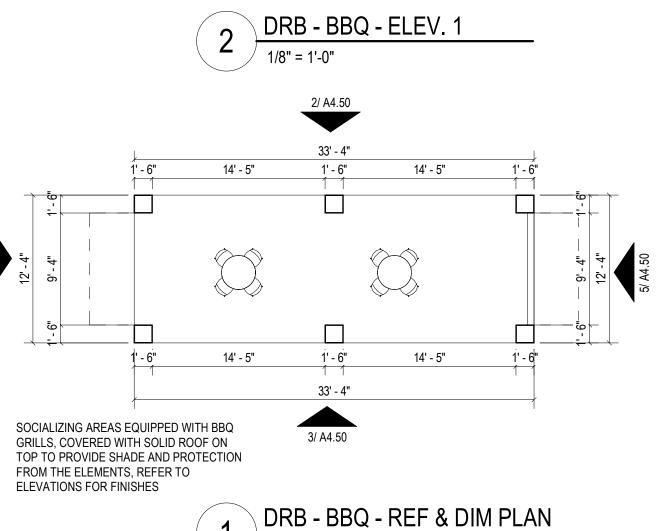

1/8" = 1'-0"

-2022) (02-11 SE⁻ DRB


Σ


A4.50

21219

SHEET NO.


SHEET CONTENTS AMENITIES

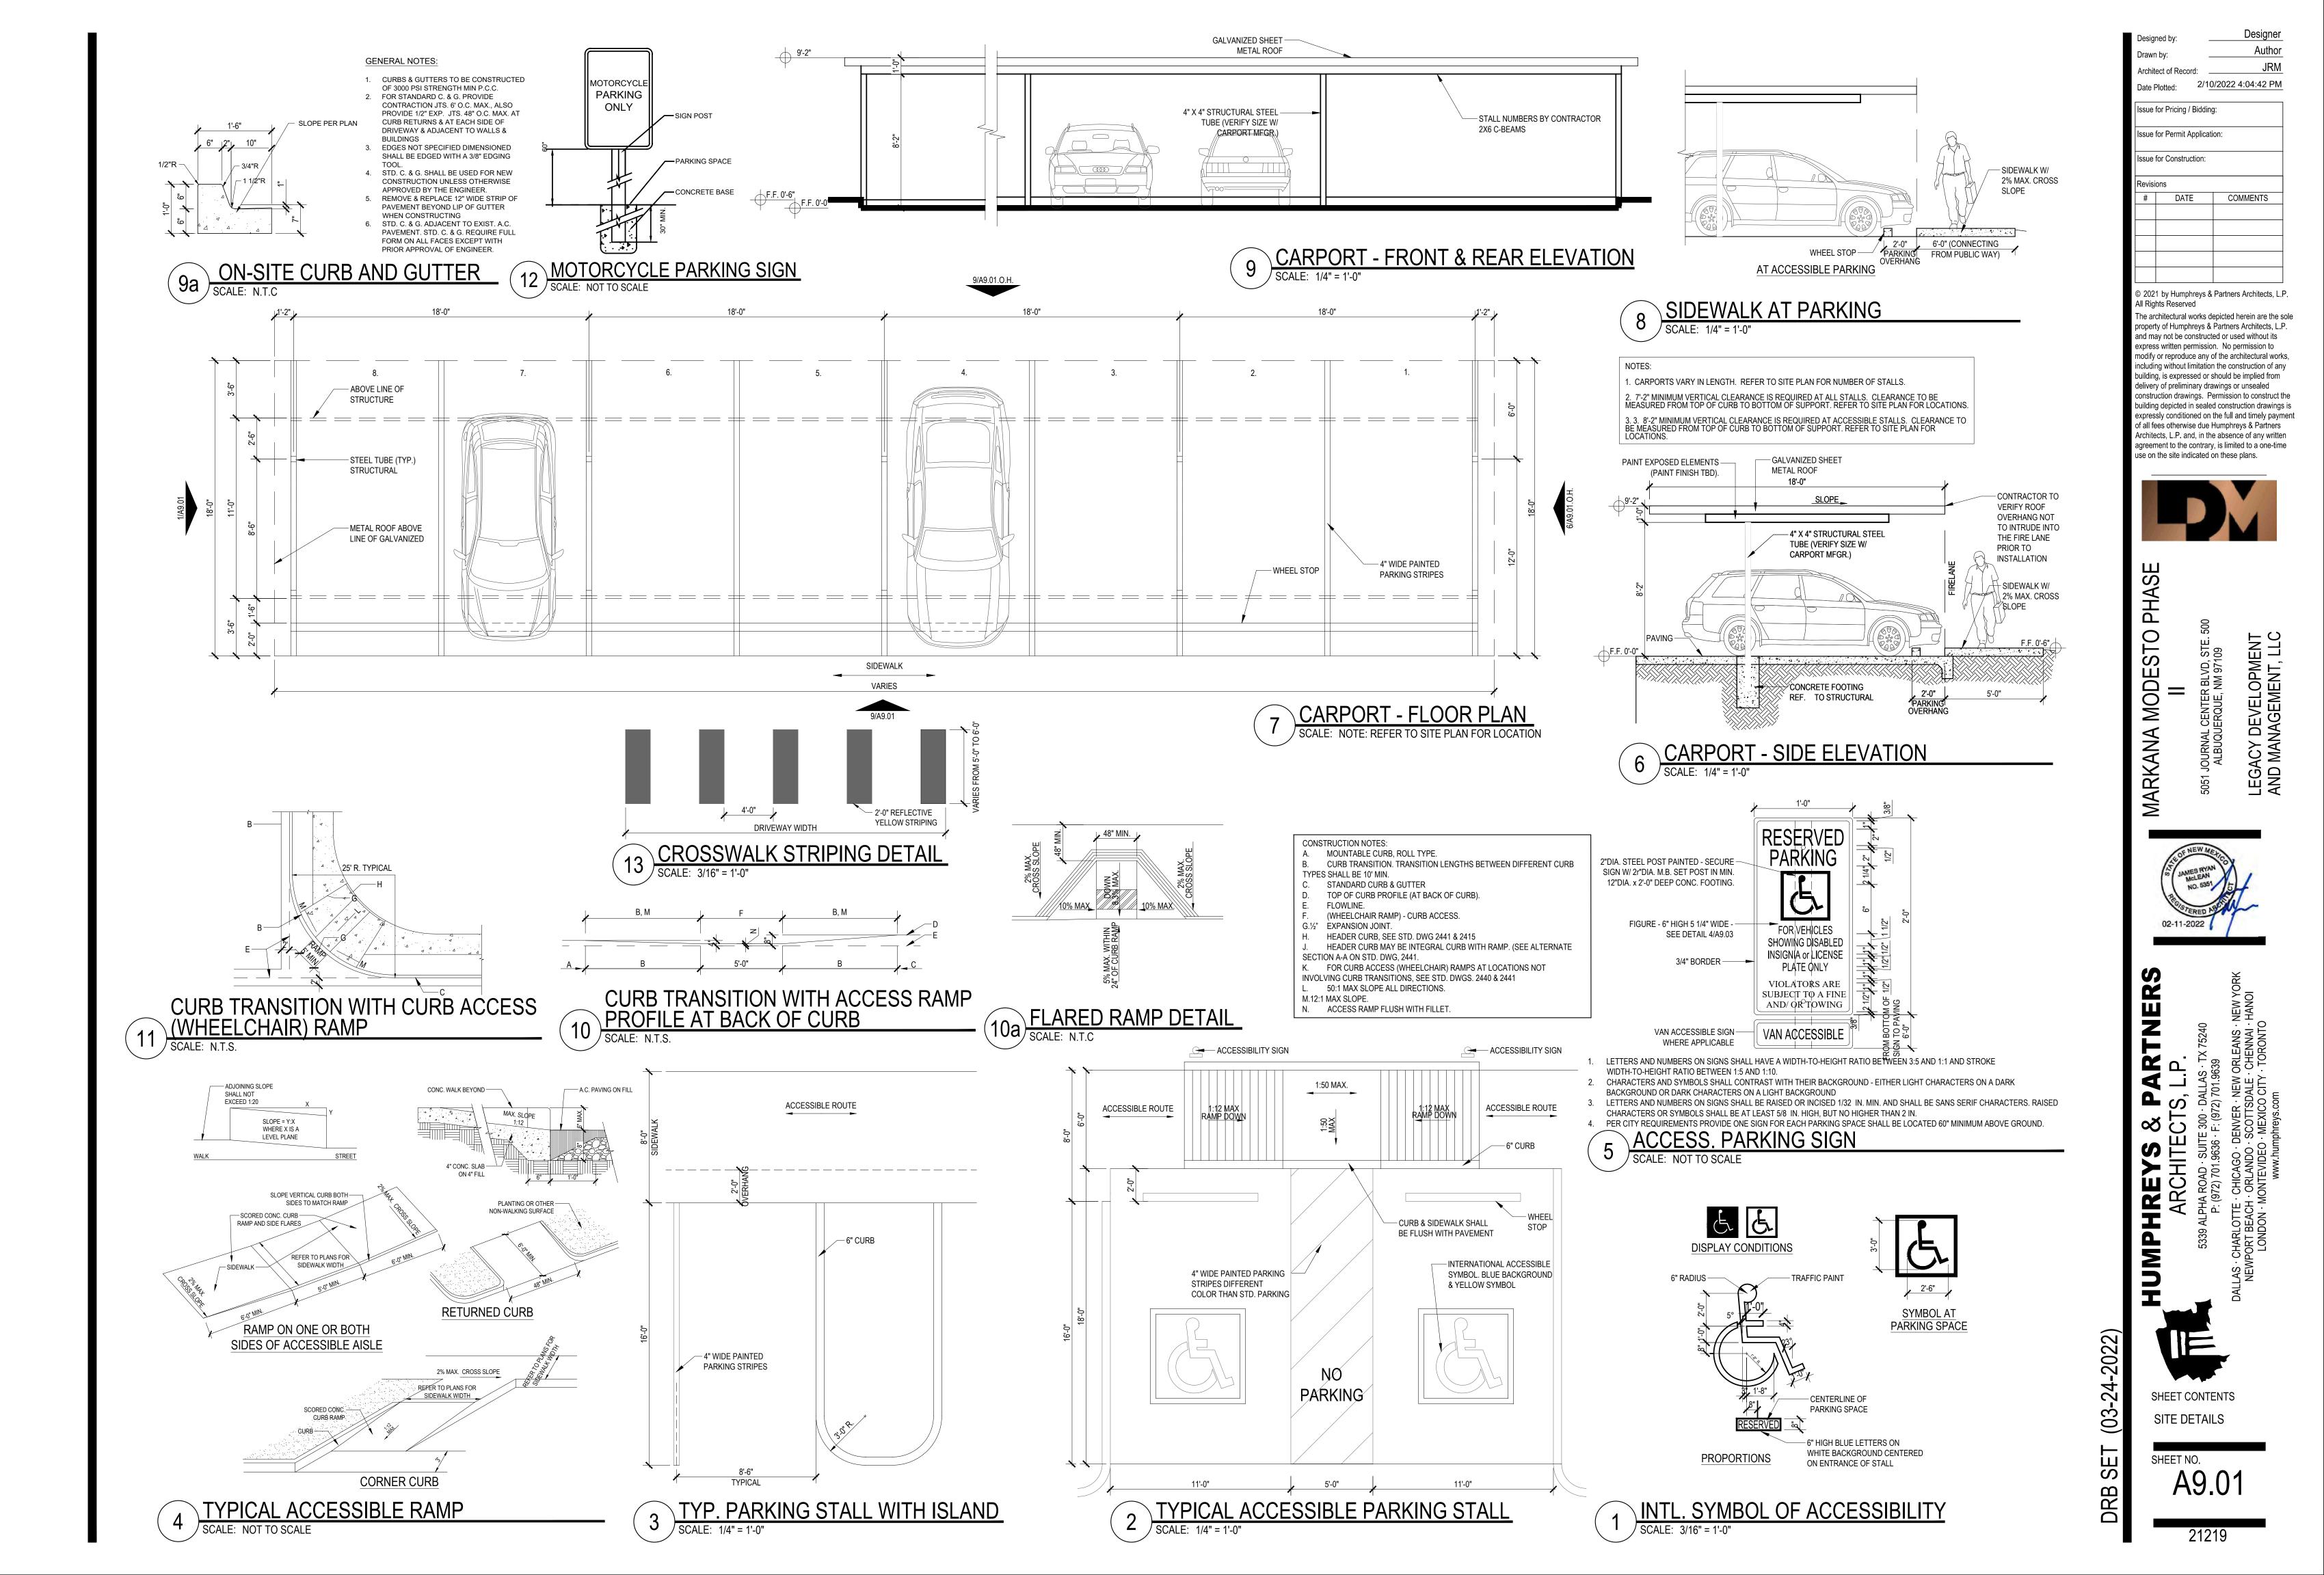

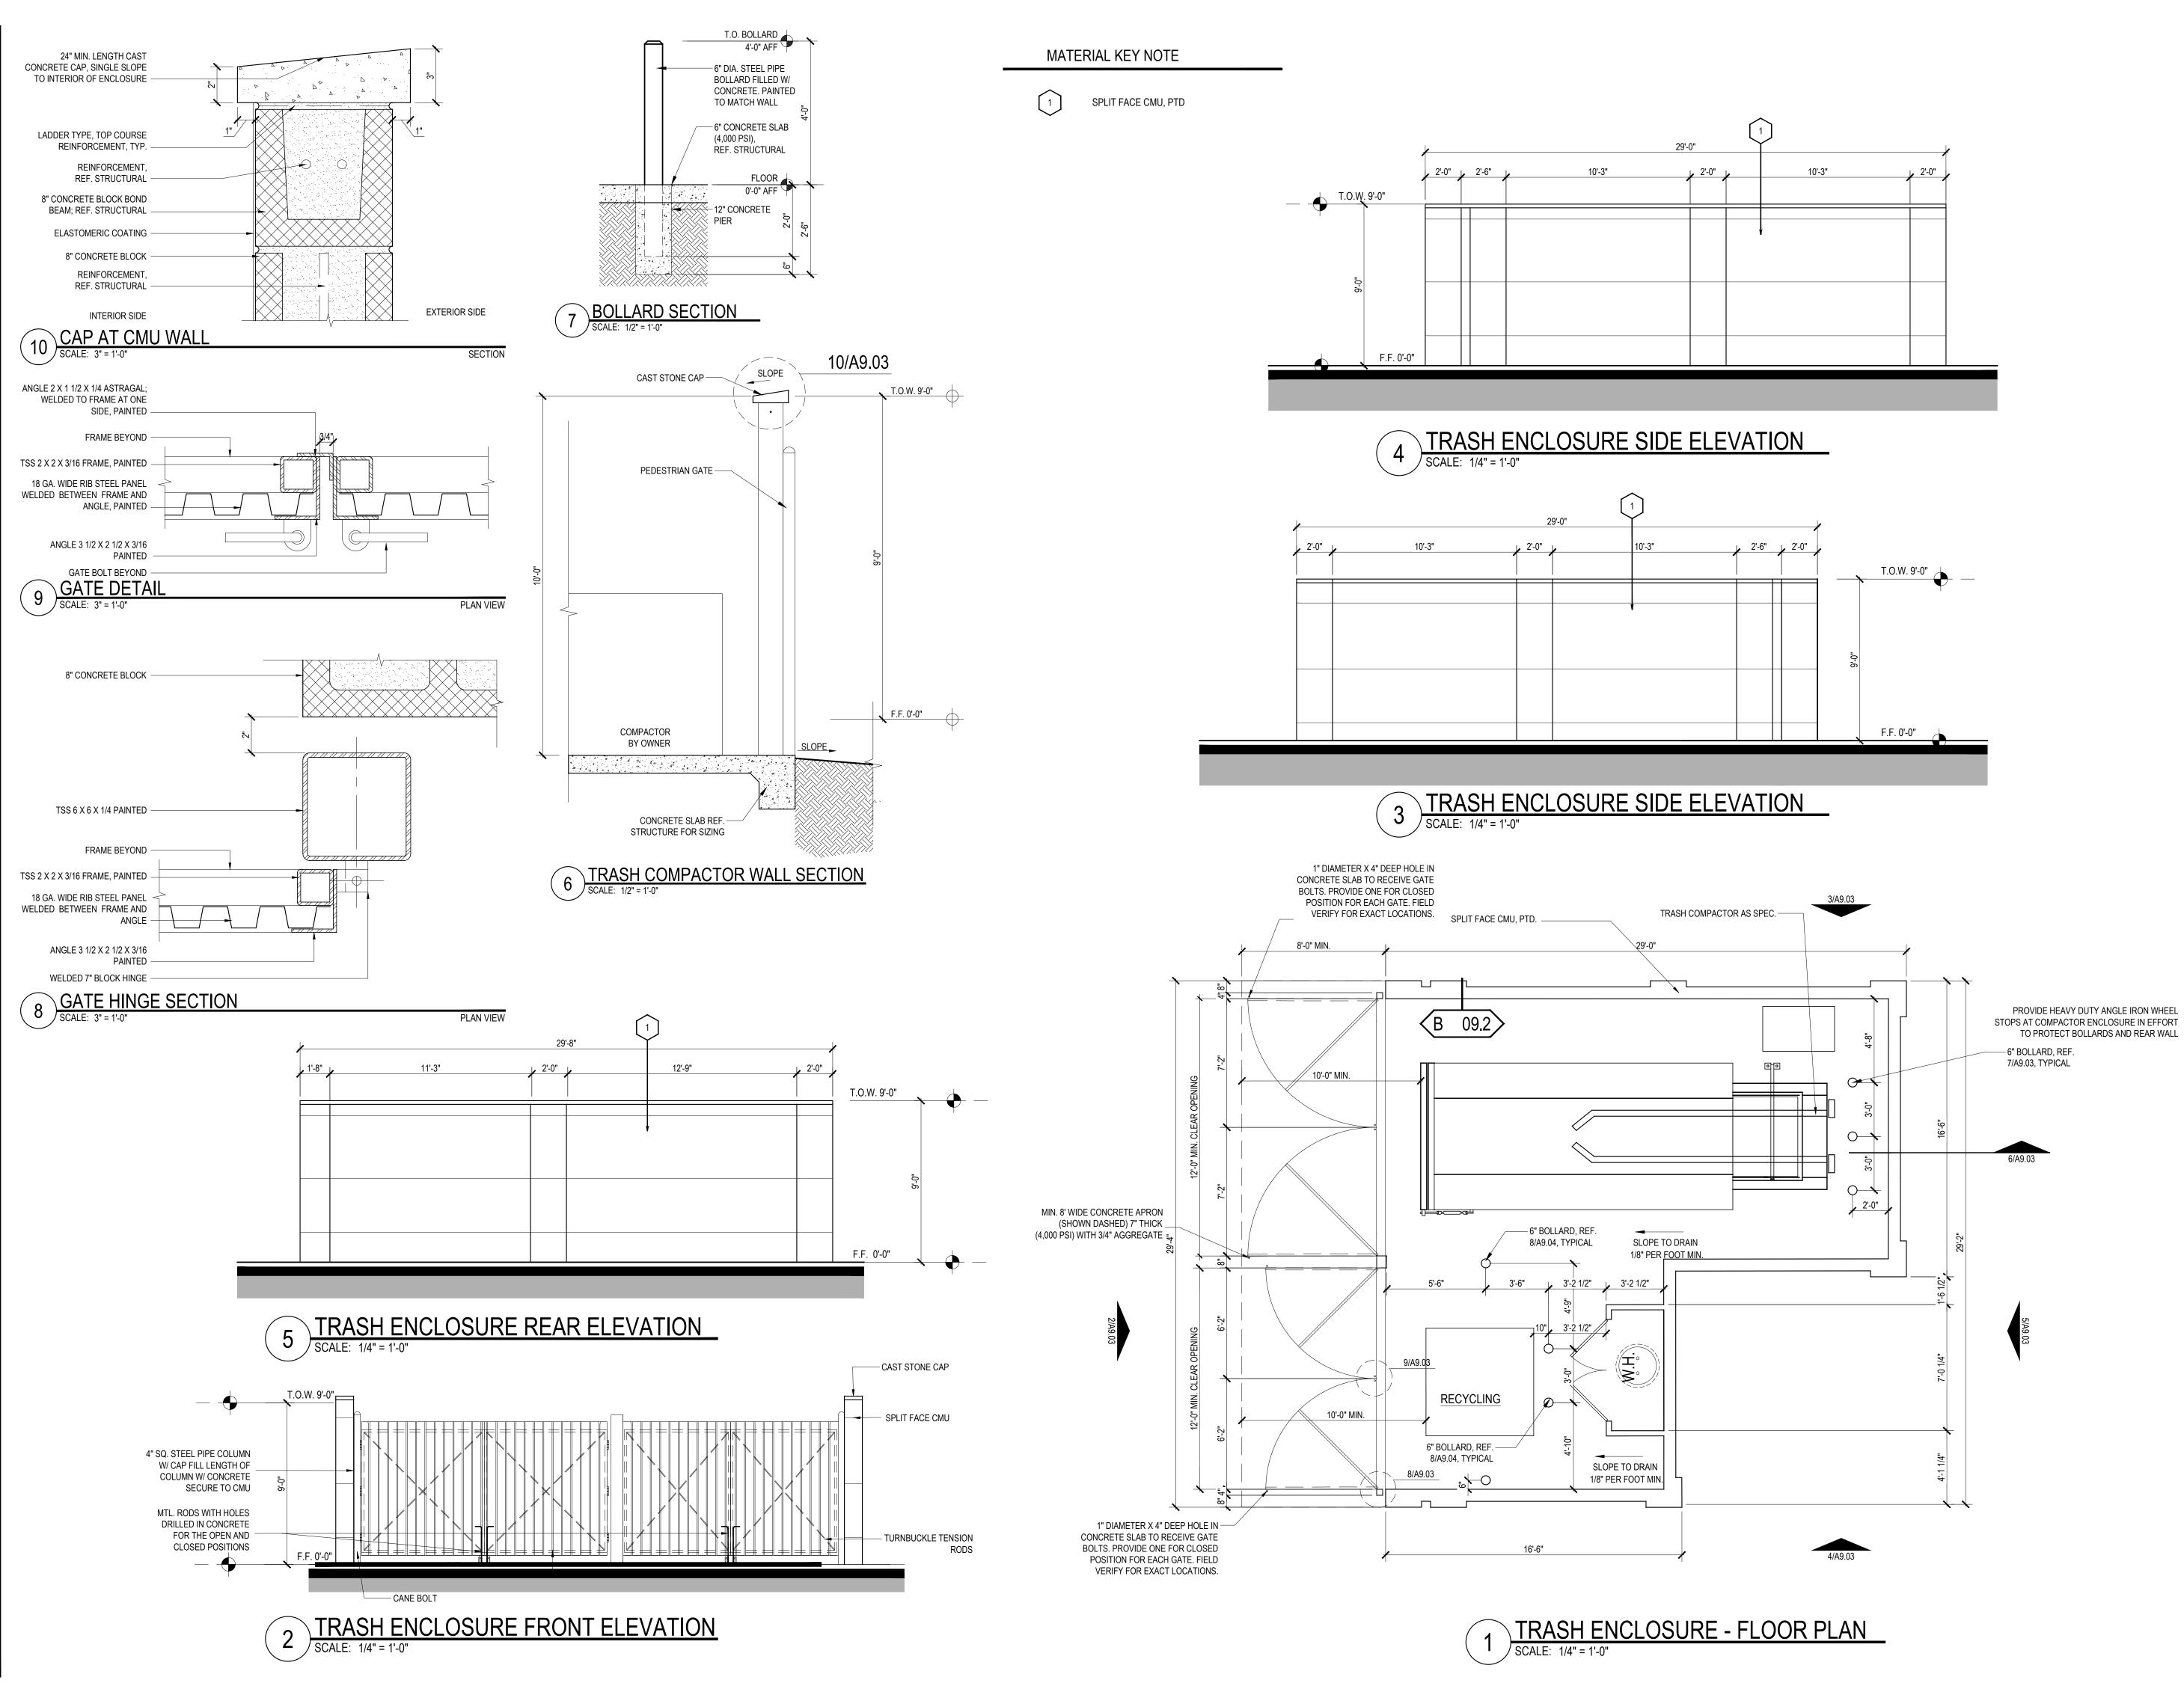

agreement to the contrary, is limited to a one-time use on the site indicated on these plans. S PHA MARKANA MODESTO LEGACY DEVELOPMENT AND MANAGEMENT, LLC NTER BLVD, STE. 2UE, NM 97109 JOURNAL CENT ALBUQUERQL 02-11-2022 G ARTN 0 ∞ చ **YS** ⊢TE(ARCH **MP** -2022) SHEET CONTENTS $\overline{}$ (02-TRASH COMPACTOR / MAINTENANCE BLDGS SHEET NO. SЕ A9.03 DRB 21219

 $\overline{}$

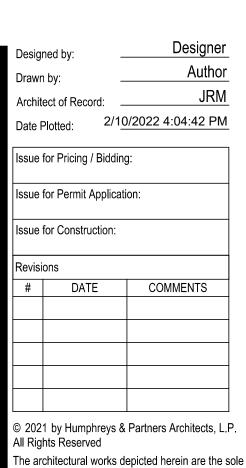

property of Humphreys & Partners Architects, L.P.

modify or reproduce any of the architectural works,

including without limitation the construction of any

building, is expressed or should be implied from

building depicted in sealed construction drawings is

expressly conditioned on the full and timely payment of all fees otherwise due Humphreys & Partners

Architects, L.P. and, in the absence of any written

delivery of preliminary drawings or unsealed construction drawings. Permission to construct the

and may not be constructed or used without its express written permission. No permission to

