




PROPOSED SITE PLAN

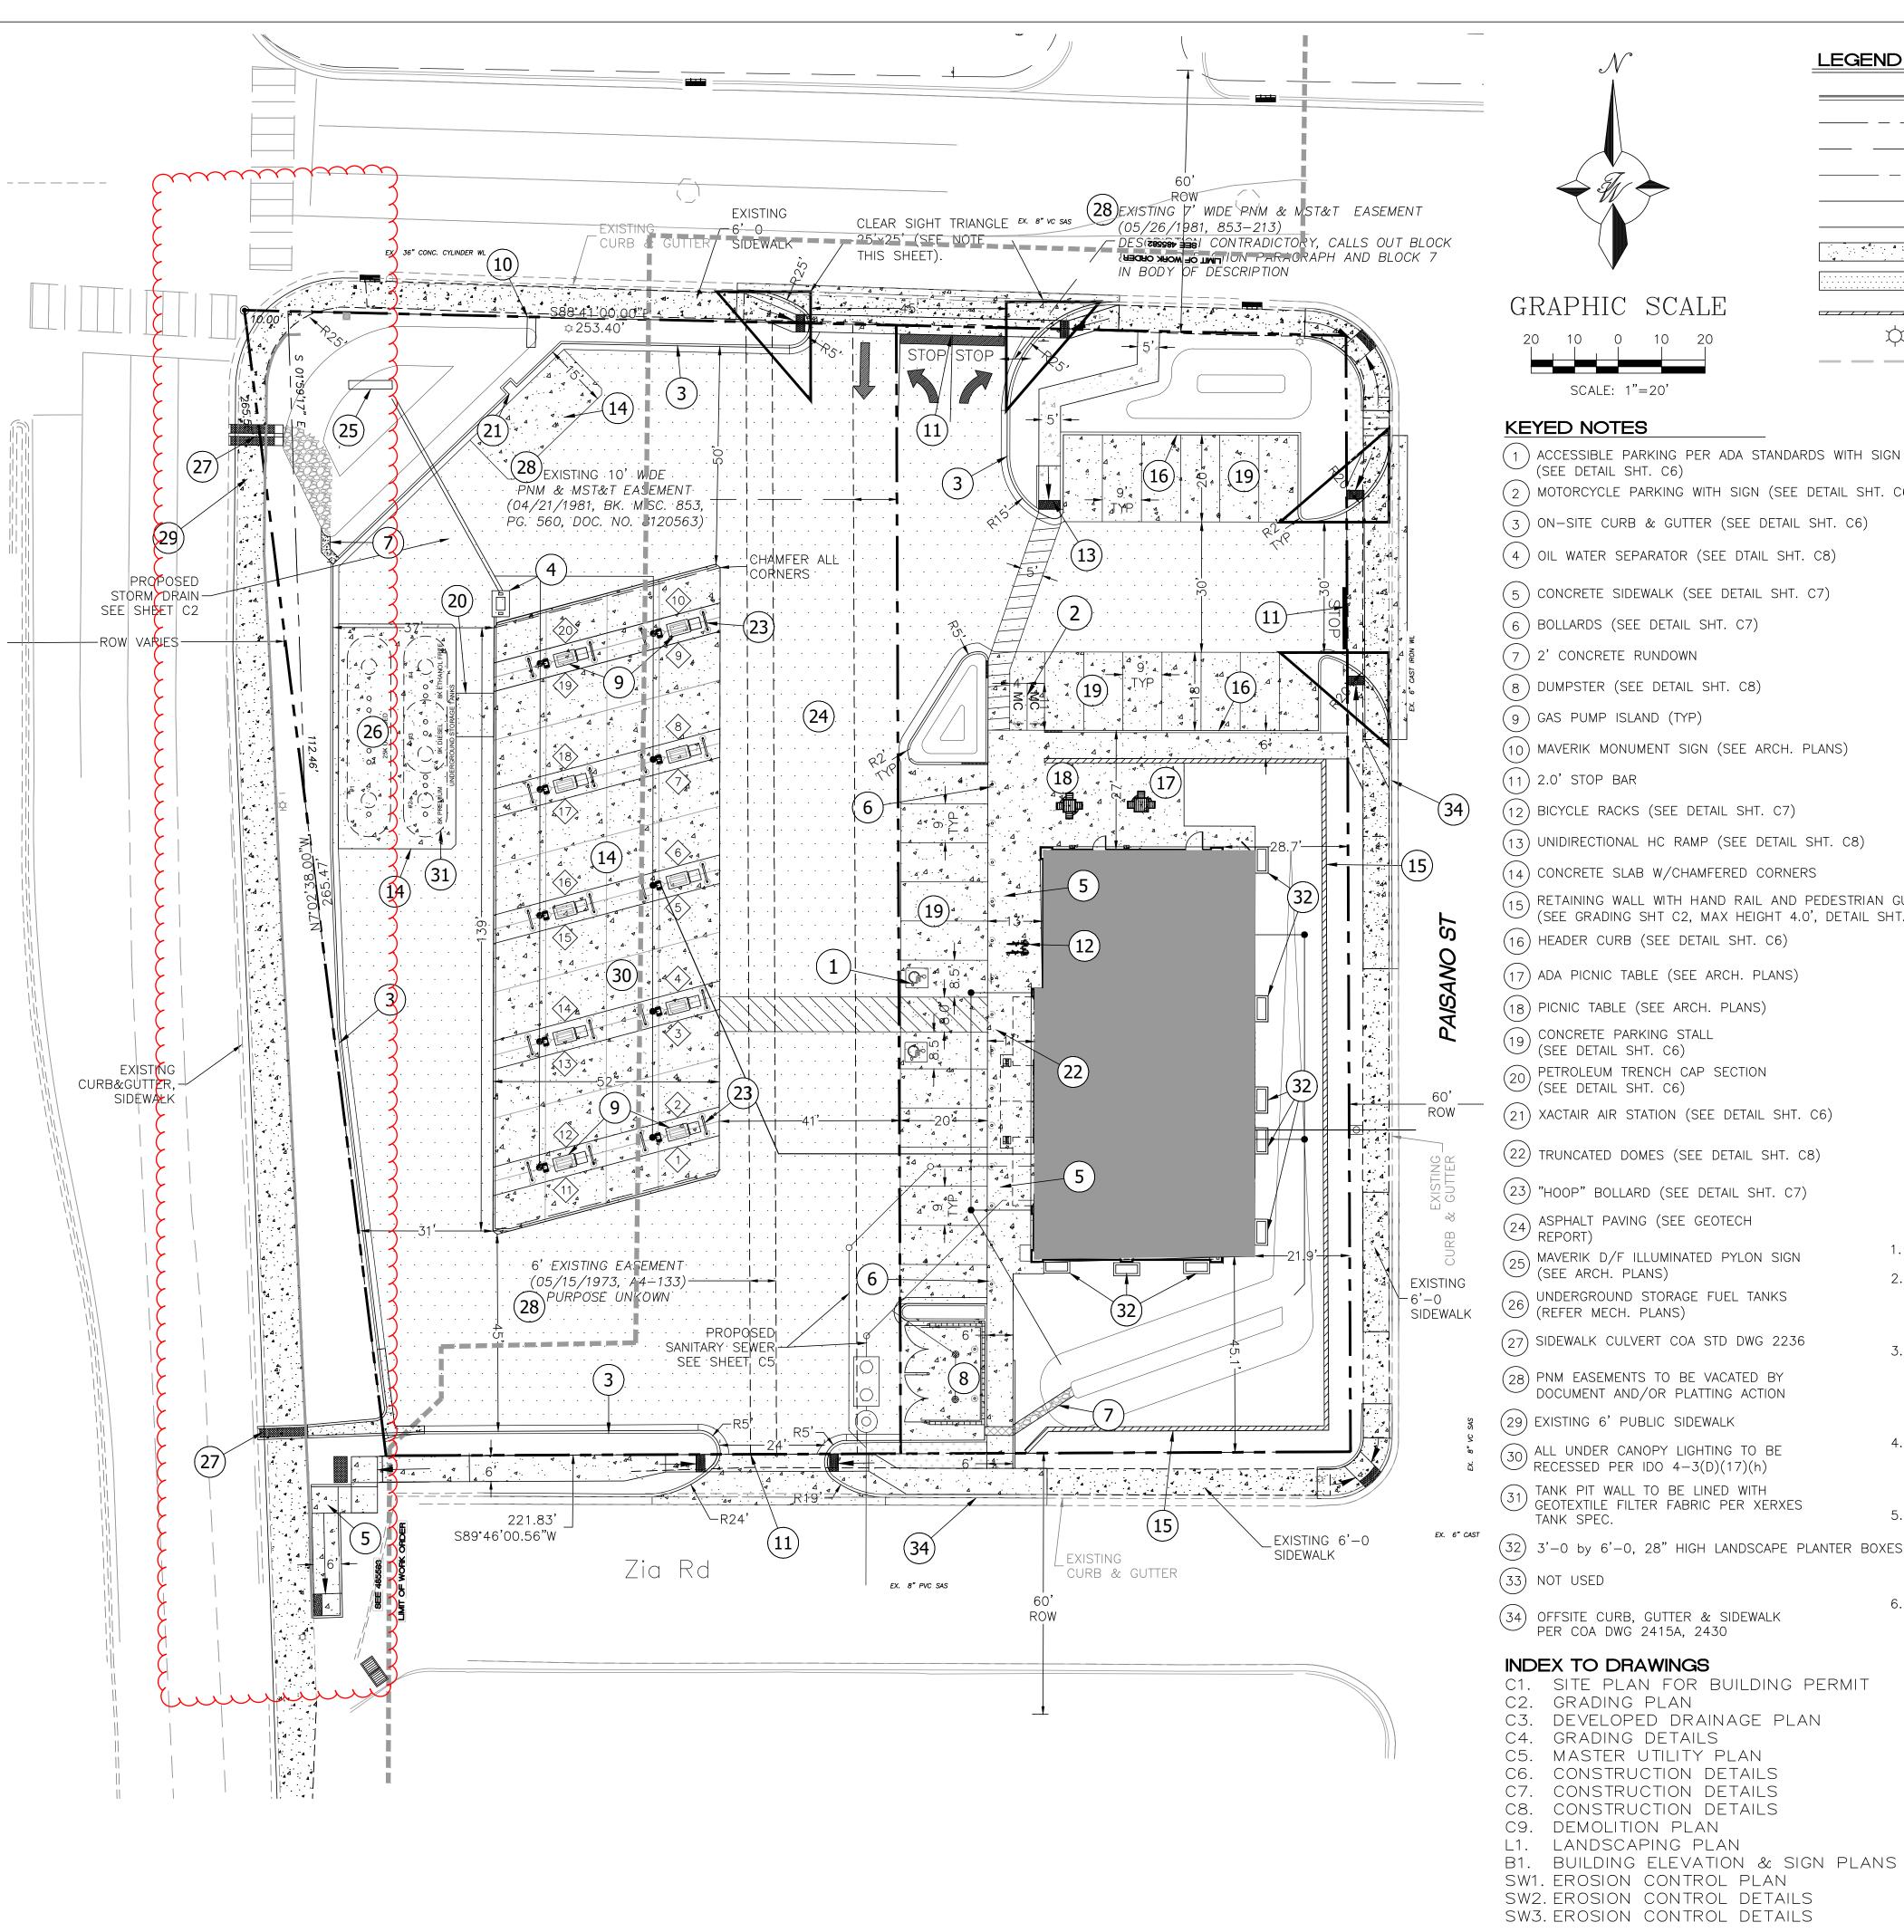

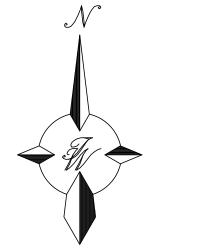

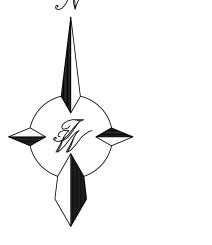

LEGEND CURB & GUTTER — — — BOUNDARY LINE ---- EASEMENT - CENTERLINE - RIGHT-OF-WAY --- BUILDING SIDEWALK/CONCRETE PAVEMENT ASPHALT PAVEMENT RETAINING WALL



SCALE: 1"=20'

- (1) ACCESSIBLE PARKING PER ADA STANDARDS WITH SIGN (SEE DETAIL SHT. C6)
- (2) MOTORCYCLE PARKING WITH SIGN (SEE DETAIL SHT. C6)
- (5) CONCRETE SIDEWALK (SEE DETAIL SHT. C7)
- (6) BOLLARDS (SEE DETAIL SHT. C7)
- (8) DUMPSTER (SEE DETAIL SHT. C8)
- (9) GAS PUMP ISLAND (TYP)
- (10) MAVERIK MONUMENT SIGN (SEE ARCH. PLANS)
- (11) 2.0' STOP BAR
- (12) BICYCLE RACKS (SEE DETAIL SHT. C7)
- (13) UNIDIRECTIONAL HC RAMP (SEE DETAIL SHT. C8)
- (14) CONCRETE SLAB W/CHAMFERED CORNERS
- (15) RETAINING WALL WITH HAND RAIL AND PEDESTRIAN GUARD (SEE GRADING SHT C2, MAX HEIGHT 4.0', DETAIL SHT. 7)
- (16) HEADER CURB (SEE DETAIL SHT. C6)
- (17) ADA PICNIC TABLE (SEE ARCH. PLANS)
- (18) PICNIC TABLE (SEE ARCH. PLANS)
- (19) CONCRETE PARKING STALL (SEE DETAIL SHT. C6)
- (20) PETROLEUM TRENCH CAP SECTION
- (SEE DETAIL SHT. C6) (21) XACTAIR AIR STATION (SEE DETAIL SHT. C6)
- (22) TRUNCATED DOMES (SEE DETAIL SHT. C8)
- (23) "HOOP" BOLLARD (SEE DETAIL SHT. C7)
- ASPHALT PAVING (SEE GEOTECH REPORT)
- (25) MAVERIK D/F ILLUMINATED PYLON SIGN (SEE ARCH. PLANS)
- 26 UNDERGROUND STORAGE FUEL TANKS (REFER MECH. PLANS)
- (28) PNM EASEMENTS TO BE VACATED BY DOCUMENT AND/OR PLATTING ACTION
- (29) EXISTING 6' PUBLIC SIDEWALK
- 30 ALL UNDER CANOPY LIGHTING TO BE RECESSED PER IDO 4-3(D)(17)(h)
- TANK PIT WALL TO BE LINED WITH GEOTEXTILE FILTER FABRIC PER XERXES TANK SPEC.
- (32) 3'-0 by 6'-0, 28" HIGH LANDSCAPE PLANTER BOXES
- (34) OFFSITE CURB, GUTTER & SIDEWALK PER COA DWG 2415A, 2430


INDEX TO DRAWINGS

- C1. SITE PLAN FOR BUILDING PERMIT C2. GRADING PLAN
- C3. DEVELOPED DRAINAGE PLAN
- C4. GRADING DETAILS
- C5. MASTER UTILITY PLAN
- C6. CONSTRUCTION DETAILS
- C7. CONSTRUCTION DETAILS
- C8. CONSTRUCTION DETAILS
- C9. DEMOLITION PLAN L1. LANDSCAPING PLAN
- SW1. EROSION CONTROL PLAN
- SW2. EROSION CONTROL DETAILS SW3. EROSION CONTROL DETAILS

CLEAR SIGHT TRIANGLE NOTE: LANDSCAPING AND SIGNAGE WILL NOT INTERFERE WITH CLEAR SIGHT REQUIREMENTS. THEREFORE, SIGNS, WALLS TREES, AND SHRUBBERY BETWEEN 3 AND 8 FEET TALL (AS MEASURED FROM THE GUTTER PAN) WILL NOT BE ACCEPTABLE IN THE CLEAR SIGHT TRIANGLE.

STREET LIGHTS

— — — EXISTING CURB & GUTTER

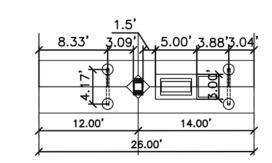



FUEL ISLAND LAYOUT SCALE: NONE

1. ALL IMPROVEMENTS LOCATED IN THE RIGHT OF WAY

REPLACED WITH SIDEWALK AND CURB AND GUTTER, ALL UNUSED CURBS CUTS MUST BE REPLACED WITH

CURB, GUTTER & SIDEWALK; PER COA STD DWG

LIGHT POLE LOCATIONS. ALL LIGHT POLES BASES

SHALL BE STRAIGHT AND PLASTERED SMOOTH. TOP OF LIGHT BASE SHALL BE 2'-6" ABOVE TOP OF CURB/SIDEWALK. BASES PROVIDED BY G.C., TYP.

EQUIPMENT PROVIDED BY OWNER. G.C. TO PROVIDE

ELECTRICAL SERVICE AND INSTALL AIR STATION

5. ALL UTILITY DIGGING OR OTHER EXCAVATION SHALL

TAKE IN CONSIDERATION EXISTING SIDEWALKS,

6. ALL RETAIL PRODUCT AREAS ARE TO BE UNDER

THE BUILDINGS PERMANENT ROOF

CURB & GUTTERS AND OTHER STRUCTURES THAT

MAY NEED TO BE REMOVED AND/OR REPLACED AS

3. SEE ELECTRICAL PLANS FOR ALL LIGHT POLES &

4. XACTAIR STATION ON 30"X36" CONCRETE PAD.

MUST BE INCLUDED IN THE WORK ORDER.

2415A AND 2430.

EQUIPMENT.

PART OF THE G.C. BID.

2. ALL BROKEN OR CRACKED SIDEWALK MUST BE



LEGAL DESCRIPTION

LOT A AND B, BLOCK 8, LA CUESTA SUBDIVISION

SITE DATA

VICINITY MAP

PROPOSED USAGE: GAS CONVENIENCE STORE IDO CLASSIFICATION: LIGHT VEHICLE FUELING STATION

LOT AREA: 61,753.72 SF (1.41 ACRES) BUILDING AREA: 4,300 SF

STACK 2X5 (20 UNITS) ASPHALT AREA:

PARKING REQUIRED: 17 SPACES (4 SPACES PER 1,000 SF) PARKING PROVIDED: 26 SPACES

HC PARKING REQUIRED: 2 SPACES

HC PARKING PROVIDED: 2 SPACES

(1 SPACE VAN ACCESSIBLE)


MC PARKING REQUIRED: 2 SPACES MC PARKING PROVIDED: 2 SPACES

BICYCLE PARKING REQUIRED: 2 SPACES BICYCLE PARKING PROVIDED: 2 SPACES

LANDSCAPE AREA REQUIRED: 8,618 SF LANDSCAPE AREA PROVIDED: 12,125 SF

PROJECT NUMBER: PR-2018-001411 APPLICATION NUMBER: SI-2019-00095 Is an Infrastructure List required? () Yes () No If Yes, then a set of approved DRC plans with a work order is required for any construction within Public Right-of-Way or for construction of public improvements. DRB SITE DEVELOPMENT PLAN APPROVAL: Traffic Engineer, Transportation Division Date Water Utility Development Date Parks & Recreation Department Date City Engineer Date * Environmental Health Department (conditional) Date Solid Waste Management Date DRB Chairperson, Planning Department Date



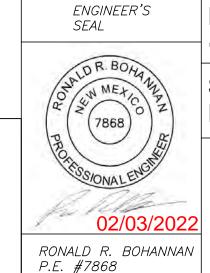

Code Enforcement

* Environmental Health, if necessary


MAVERIK DRAWN BY pm 650 JUAN TABO BLVD. NE DATE 10-29-2021 SITE PLAN FOR DRAWING BUILDING PERMIT 2018046-SP SHEET # TIERRA WEST, LLC 5571 MIDWAY PARK PL NE ALBUQUERQUE, NEW MEXICO 87109 (505) 858-3100 JOB

www.tierrawestllc.com

2019050

Date

K-22-Z

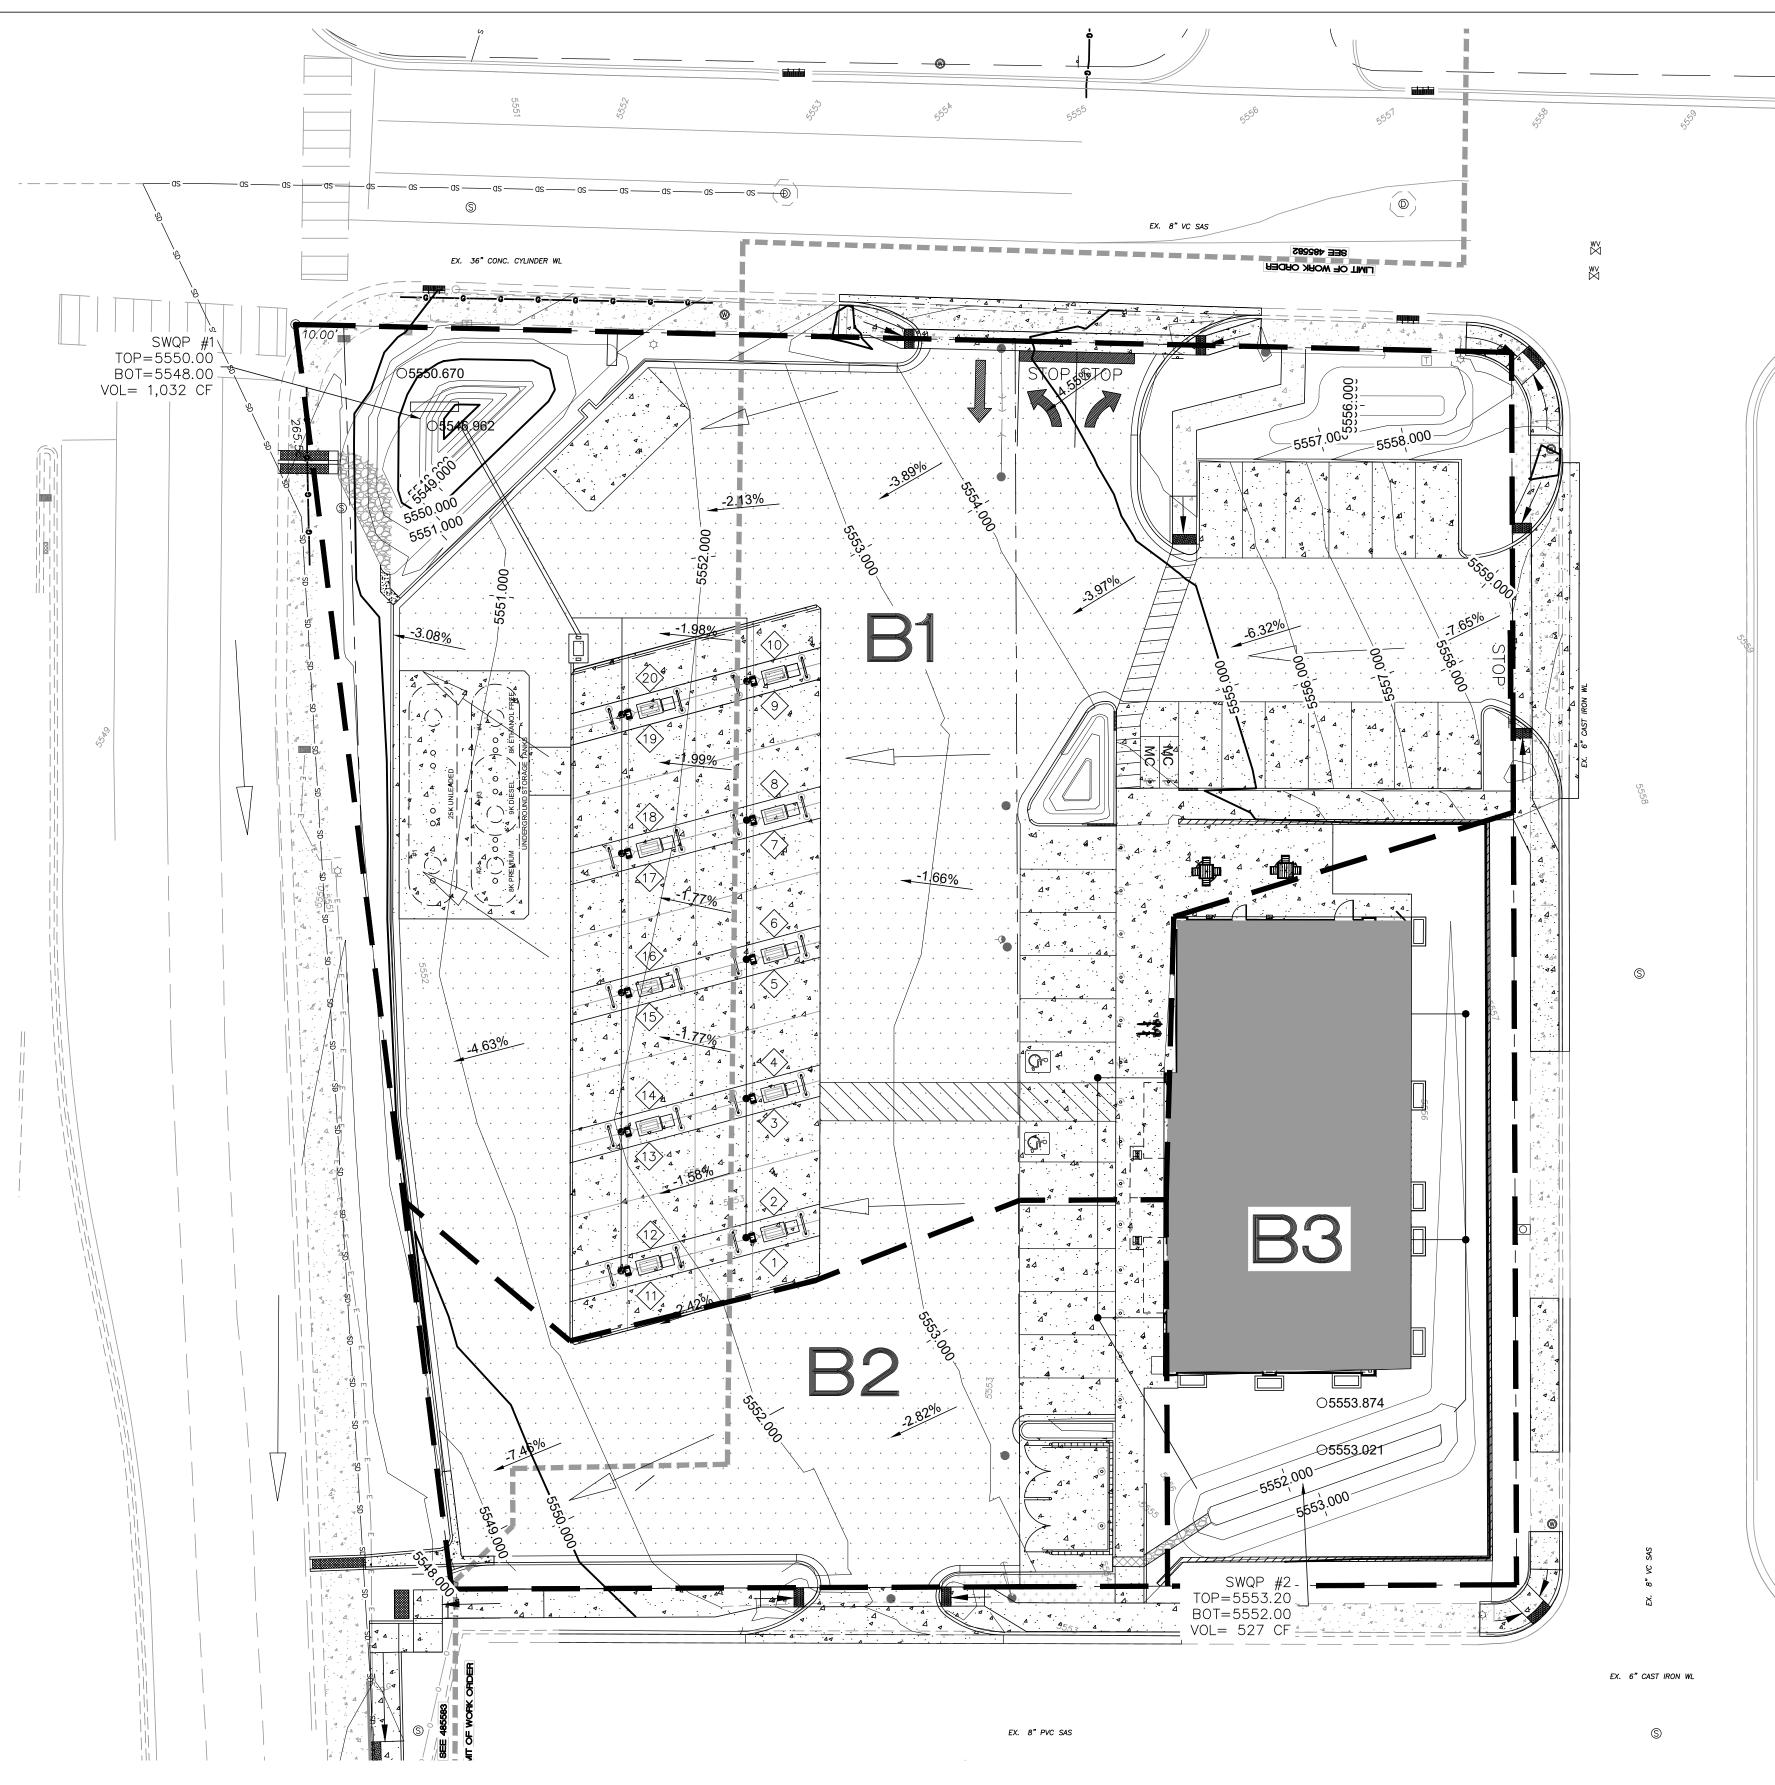

				Bas	sin Descript	tions						10	0-Year, 6-H	r		10-Year, 6-H	lr .	SW	QV
Basin	Area	Area	Area	Treatm	nent A	Treat	ment B	Treat	ment C	Treat	ment D	Weighted E	Volume	Flow	Weighted E	Volume	Flow	Required	Provide
ID	(sf)	(acres)	(sq miles)	%	(acres)	%	(acres)	%	(acres)	%	(acres)	(in)	(ac-ft)	(cfs)	(in)	(ac-ft)	(cfs)	(cf)	(cf)
1	40,521	0.930	0.00145	0%	0.000	10%	0.093	0%	0.000	90%	0.837	2.484	0.193	4.67	1.567	0.121	3.12	790	1,032 (
2	10,390	0.239	0.00037	0%	0.000	0%	0.000	0%	0.000	100%	0.239	2.640	0.052	1.25	1.690	0.034	0.85	225	-
3	10,843	0.249	0.00039	0%	0.000	50%	0.124	0%	0.000	50%	0.124	1.860	0.039	1.02	1.075	0.022	0.62	117	527 (
Total	61,754	1.418	0.00222		0.000		0.217		0.000		1.200		0.284	6.936		0.177	4.600	1,133	1,559

Weighted E = Ea*Aa + Eb*Ab + Ec*Ac + Ed*Ad / (Total Area)Volume = Weighted E * Total Area Flow = Qa*Aa + Qb*Ab + Qc*Ac + Qd*Ad $WQV_{required} = 0.26*A*43560*(1/12)$

Excess Precipitation, E (in.) Zone 4 | 100-Year | 10-Year Ea 0.8 0.28 Eb 1.08 0.46 1.46 0.73 Ec Ed 2.64 1.69

Peak Discharge (cfs/acre) Zone 4 | 100-Year | 10-Year Qa 2.2 0.87 Qb 2.92 1.45 Qc 3.73 2.26 Qd 5.25 3.57

Water Quality Volume - "First Flush Pond" - Redevelopment Site ΣArea in "Treatment D" Total Impervious Area = 0.0233 Retainage depth = 0.28" **=0.0233** x area CF Retention Volume =

GRAPHIC SCALE SCALE: 1"=20'

LEGEND CURB & GUTTER — — BOUNDARY LINE - CENTERLINE — RIGHT—OF—WAY

SIDEWALK RETAINING WALL — — — EXISTING CURB & GUTTER

- BUILDING

---- EXISTING BOUNDARY LINE DRAINAGE BASIN BOUNDARY — FLOW DIRECTION

MAINTENANCE OF BMPS


RESPONSIBLE PARTY: PROPERTY OPERATOR

MAINTENANCE REQUIREMENTS AND FREQUENCY: REFER TABLE THIS PAGE. ACCESS TO BMPS: ACCESS SHALL BE PROVIDED VIA SITE ACCESS DRIVES TO SURFACE SWQV POND. ALL REMOVAL AND DISPOSAL OF LANDSCAPING AND SEDIMENT SHALL BE COMPLETED BY CERTIFIED LANDSCAPE CONTRACTOR IN ACCORDANCE WITH THE LANDSCAPE MAINTENANCE SPECIFICATION. NO DEBRIS SHALL REMAIN ONSITE AFTER TRIMMING. SEDIMENTATION MONITORING SHALL BE COMPLETED BY THE PROPERTY OWNER YEARLY. IF SILT ACCUMULATION EXCEEDS 2 INCHES ON THE SWQV POND GAUGE THEN THE POND BOTTOM

SHALL BE EXCAVATED AND STACKED WITHIN 2-FEET OF THE SWQV POND BERM. VISUAL INSPECT FOLLOWING STORM EVENTS SHALL BE COMPLETED AS REQUIRED TO ENSURE THE INFILTRATION OF THE SWQV IS ACHIEVED AT ACCEPTABLE RATES. THE SWQV, AT THE MAXIMUM 24" DEPTH, SHOULD INFILTRATE WITHIN 24 HOURS.

VECTOR CONTROL NOTES:

ALLOWING CONDITIONS SUCH AS THE ACCUMULATION OF STANDING WATER THAT CAN CONTRIBUTE TO THE BREEDING OF MOSQUITOES IS A VIOLATION OF THE CITY OF ALBUQUERQUE'S INSECT AND RODENT CONTROL ORDINANCE. MAINTENANCE OF THE OIL WATER SEPARATOR AND SWQV PONDS ARE THE RESPONSIBILITY OF THE PROPERTY OPERATOR. IN ORDER TO PREVENT MOSQUITO BREEDING, VEGETATION SHOULD REGULARLY BE CLEARED FROM THE BASIN AND EDGES OF PONDS. THE SITE SHOULD BE MAINTAINED THROUGHOUT THE YEAR IN THIS MANNER. REMOVAL OF VEGETATION CREATES A LESS DESIRABLE SITE FOR MOSQUITO BREEDING. THIS WILL ALSO AID IN THE REDUCTION OF RODENT HARBORAGE. WHEN STANDING WATER DOES EXIST IT SHOULD BE TREATED WITH PUBLICLY AVAILABLE MOSQUITO PRODUCES (E.G. MOSQUITO DUNKS) AT THE TREATMENT RATE DESIGNATED BY THE PRODUCT LABEL. SHOULD A SITE MAINTAIN PERMANENT STANDING WATER, MOSQUITO FISH (GAMBUSIA) CAN BE OBTAINED FROM THE CITY OF ALBUQUERQUE'S ENVIRONMENTAL HEALTH DEPARTMENT FREE OF CHARGE.

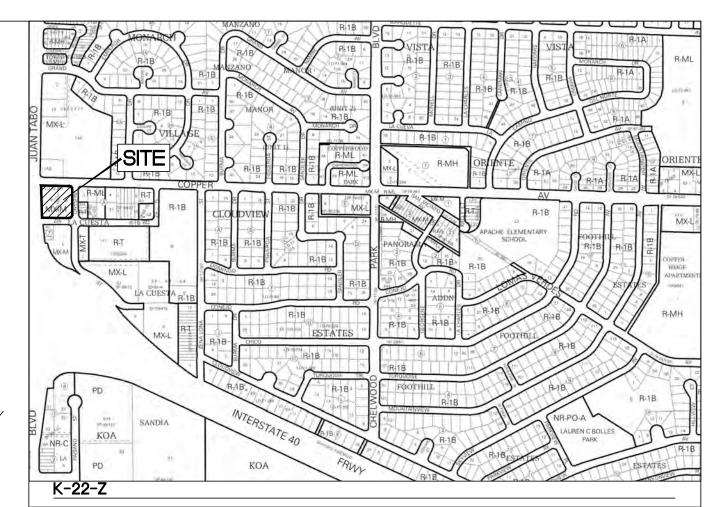



REGULAR MAINTENANCE	FREQUENCY
LITTER MANAGEMENT	
Pick up all litter at site and in Landscape areas and remove from site	Daily
NLETS AND OUTLETS	
Visual inspection for function. Remove silt from slab aprons and debris in pavement areas. Remove all fallen vegetation around	
nlet and outlet structures.	Monthly
HARD SURFACES	
Sweep all paving regularly. Maintain pavement in autumn after leaf fall. Coordinate with Landscape Contractor if additional	
maintenance is required.	As required
OCCASIONAL TASKS	FREQUENCY
INSPECTION AND INLETS, OUTLETS AND CONTROL CHAMBERS	
nspect surface structures removing obstructions and silt as necessary. Check there is no physical damage. For below ground	
control chambers, remove cover and inspect ensuring water is flowing freely and that the exit route for water is unobstructed.	
Remove debris and silt.	Yearly
POND VEGETATION	
Ensure Pond vegetation is maintained by Landscape Contractor. All weeds and all cuttings removed from site.	As required
SILT MANAGEMENT	


area of basin for design function or appearance. REMEDIAL WORK FREQUENCY Inspect storm all water quality structures regularly to check for damage or failure. Undertake remedial work as required.

but outside the design profile where water flows, spread, rake and overseed. Protect surface from siltation and manage main

CAUTION:

ALL EXISTING UTILITIES SHOWN WERE OBTAINED FROM RESEARCH, AS-BUILTS, SURVEYS OR INFORMATION PROVIDED BY OTHERS. IT SHALL BE THE SOLE RESPONSIBILITY OF THE CONTRACTOR TO CONDUCT ALL NECESSARY FIELD INVESTIGATIONS PRIOR TO AND INCLUDING ANY EXCAVATION, TO DETERMINE THE ACTUAL LOCATION OF UTILITIES AND OTHER IMPROVEMENTS, PRIOR TO STARTING THE WORK. ANY CHANGES FROM THIS PLAN SHALL BE COORDINATED WITH AND APPROVED BY THE ENGINEER.



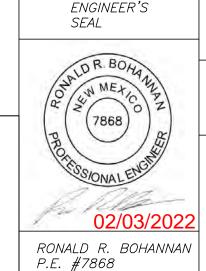

MAVERIK 650 JUAN TABO BLVD. NE DRAINAGE PLAN


TIERRA WEST, LLC 5571 MIDWAY PARK PL NE ALBUQUERQUE, NEW MEXICO 87109 (505) 858-3100

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DATE 10-29-2021 DRAWING 2018046-DR SHEET #


JOB # 2019050

DRAWN BY pm

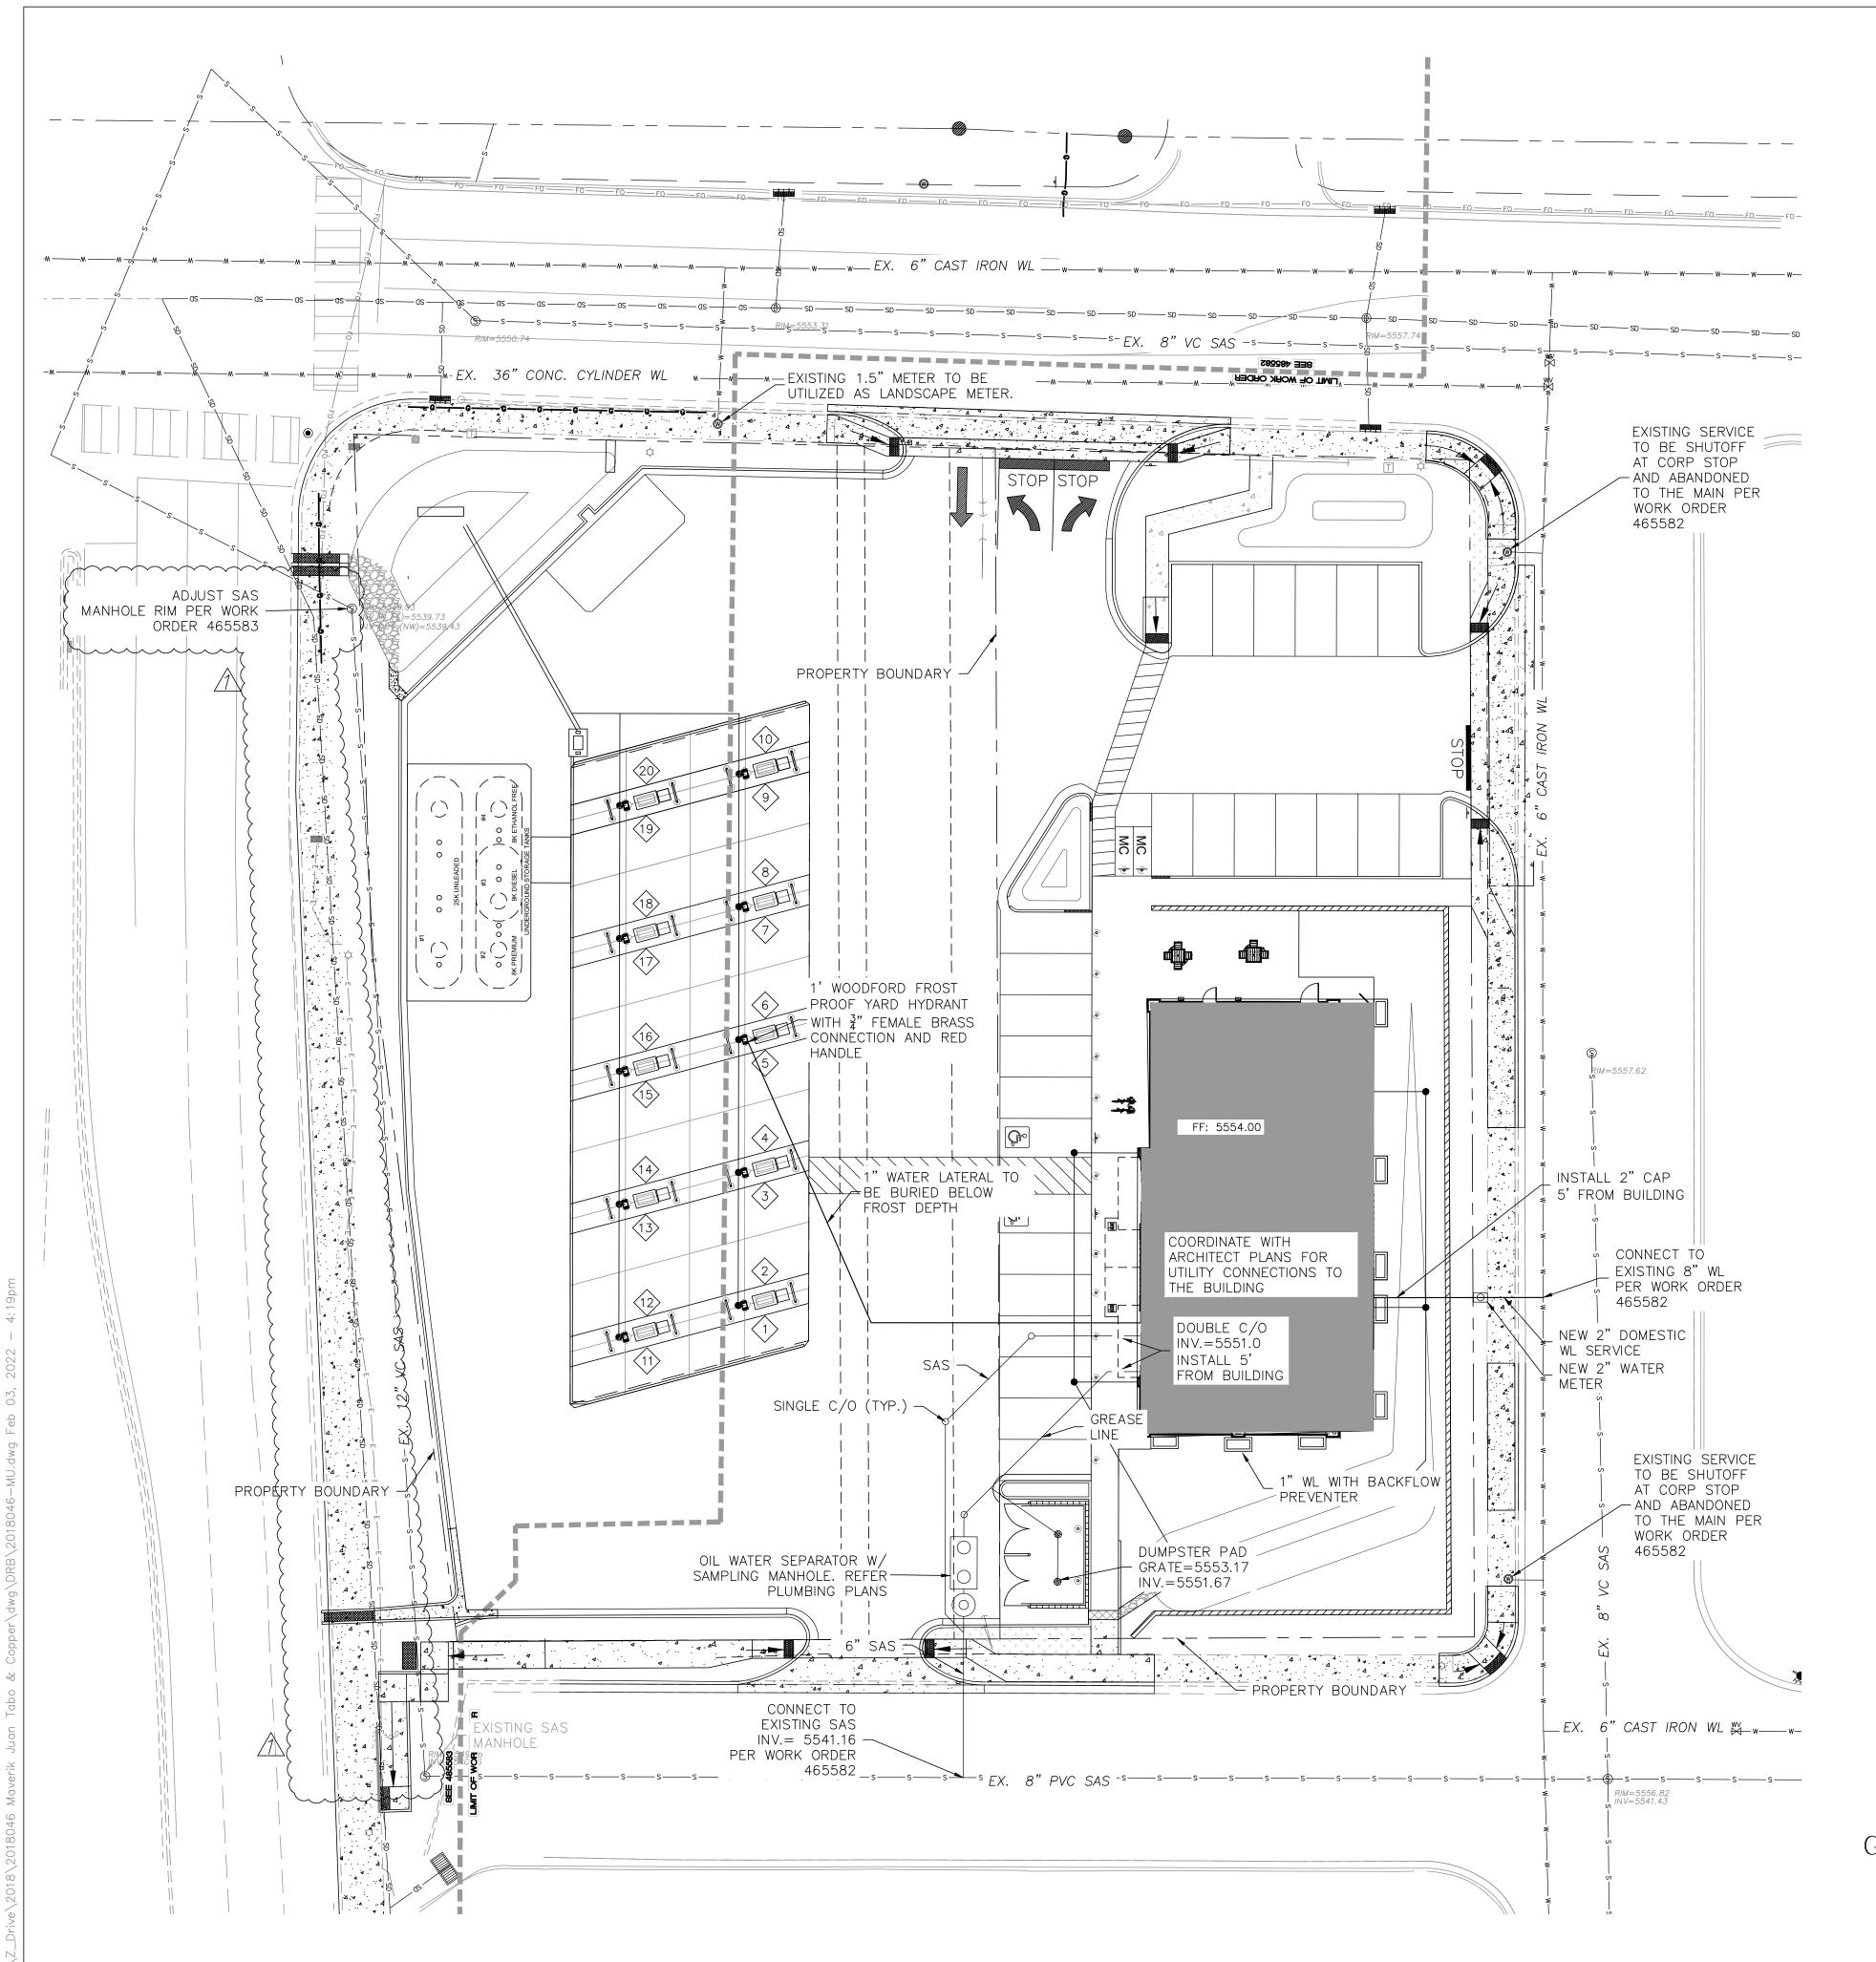

LEGEND

LEGEND	
	EXISTING CURB & GUTTER
	BOUNDARY LINE
	EASEMENT
	EXISTING SIDEWALK
	EXISTING WATER LINE
	EXISTING STORM LINE
	EXISTING STORM MANHOLE
	EXISTING STORM INLET
S	EXISTING SAS LINE
<u>S</u>	EXISTING SAS MANHOLE
——— W ———	EXISTING WATER LINE
\bowtie	EXISTING WATER VALVE
U	EXISTING OVERHEAD POWER L
•	EXISTING POWER POLE
—— Е ———	EXISTING ELECTRIC LINE
	EXISTING WALL
E	EXISTING ELECTRICAL BOX
	EXISTING TRANSFORMER
ф	EXISTING LIGHT STANDARD
T	EXISTING TELEPHONE PEDESTA
	SIDEWALK
	RETAINING WALL
5010	CONTOUR MAJOR
 5011 	CONTOUR MINOR
x 5048.25	SPOT ELEVATION (FLOWLINE)
	EXISTING BOUNDARY LINE
5010	EXISTING CONTOUR MAJOR
	EXISTING CONTOUR MINOR
5040.05	EVICTING COOT ELEVATION

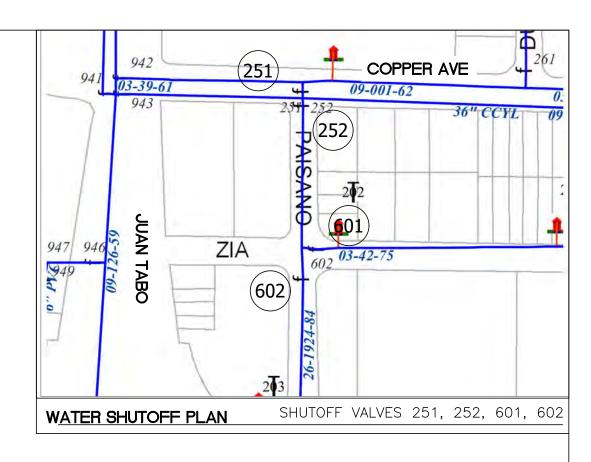

THE CONTRACTOR SHALL COORDINATE WITH THE WATER AUTHORITY SEVEN (7) DAYS IN ADVANCE OF PERFORMING WORK THAT WILL AFFECT THE PUBLIC WATER OR SANITARY SEWER INFRASTRUCTURE. WORK REQUIRING SHUTOFF OF FACILITIES DESIGNATED AS MASTER PLAN FACILITIES MUST BE COORDINATED WITH THE WATER AUTHORITY 14 DAYS IN ADVANCE OF PERFORMING SUCH WORK. ONLY WATER AUTHORITY CREWS ARE AUTHORIZED TO OPERATE PUBLIC VALVES. SHUTOFF REQUESTS MUST BE MADE ONLINE AT

https://www.abcwua.org/Water_Shut_off_and_Turn_on_Procedures.aspx

CAUTION:

ALL EXISTING UTILITIES SHOWN WERE OBTAINED FROM RESEARCH, AS-BUILTS, SURVEYS OR INFORMATION PROVIDED BY OTHERS. IT SHALL BE THE SOLE RESPONSIBILITY OF THE CONTRACTOR TO CONDUCT ALL NECESSARY FIELD INVESTIGATIONS PRIOR TO AND INCLUDING ANY EXCAVATION, TO DETERMINE THE ACTUAL LOCATION OF UTILITIES AND OTHER IMPROVEMENTS, PRIOR TO STARTING THE WORK. ANY CHANGES FROM THIS PLAN SHALL BE COORDINATED WITH AND APPROVED BY THE ENGINEER

GENERAL UTILITY NOTES:


x 5048.25


1. ALL WATER AND SEWER UTILITY WORK TO BE DONE IN ACCORDANCE WITH COA STANDARDS AND SPECIFICATIONS LATEST EDITION.

EXISTING SPOT ELEVATION

- 2. 4' MINIMUM BURY REQUIRED FOR ALL UTILITIES UNLESS OTHERWISE NOTED.
- 3. REFERENCE ARCHITECTURAL PLANS FOR WATER LINE RISER LOCATIONS.
- 4. CLEAN OUTS ARE TO BE BUILT PER UNIFORM PLUMBING CODE STANDARDS.
- 5. ALL PLUMBING PIPE MATERIAL TO BE USED PER UPC.
- 6. FIRE LINE AND DOMESTIC WATERLINE MUST HAVE BACKFLOW PREVENTORS PER UPC. IF BACKFLOW PREVENTOR IS INSTALLED EXTERIOR OF BUILDING A HOT BOX SHALL BE INSTALLED AND USED.
- 7. ALL EX. SD INLETS AND MH SHALL HAVE CONCRETE COLLARS POURED AND BE ADJUSTED TO FINISHED GRADE.
- 8. ALL EXCAVATION, TRENCHING AND SHORING ACTIVITIES MUST BE CARRIED-OUT IN ACCORDANCE WITH OSHA 29 CFR 1926.650 SUBPART P.
- 9. ALL UTILITY DISTANCES SHOWN ARE FOR REFERENCE ONLY.


- 10. PNM HAS NUMEROUS ELECTRIC FACILITIES AT THIS SITE CURRENTLY SERVING EXISTING CUSTOMERS. THE APPLICANT SHALL COORDINATE WITH PNM REGARDING THESE EXISTING FACILITIES. ANY RELOCATION, CHANGES OR REALIGNMENT OF EXISTING ELECTRIC UTILITIES WILL BE THE DEVELOPER EXPENSE. IN SOME CASES, RELOCATION OR CHANGES TO EXISTING FACILITIES MAY NOT BE FEASIBLE DUE TO PHYSICAL, USE OR SAFETY CLEARANCE CONSTRAINTS.
- 11. PNM WILL REVIEW ALL TECHNICAL NEEDS, ISSUES AND SAFETY CLEARANCES FOR ITS ELECTRIC POWER SYSTEMS. ANY EXISTING AND PROPOSED PUBLIC UTILITY EASEMENTS SHALL BE INDICATED ON THE SITE PLAN UTILITY SHEET PRIOR TO DRB REVIEW. PNM'S STANDARD FOR PUBLIC UTILITY EASEMENTS IS 10 FEET IN WIDTH TO ENSURE ADEQUATE, SAFE CLEARANCES.
- 12. SCREENING SHALL BE DESIGNED TO ALLOW FOR ACCESS TO UTILITY FACILITIES. IT IS NECESSARY TO PROVIDE ADEQUATE CLEARANCE OF TEN FEET SURROUNDING ALL GROUND-MOUNTED UTILITIES FOR SAFE OPERATION, MAINTENANCE AND REPAIR PURPOSES.
- 13. ALL BUILDINGS CONSTRUCTION TYPE IS II-B
- 14. CONTRACTOR SHALL CONSULT THE LOCAL BUILDING DEPARTMENT OFFICIALS FOR ANY PLAN REVIEW, PERMITTING REQUIREMENTS OR BUILDING CODE INSPECTIONS THAT MAY BE REQUIRED TO ENFORCE LOCAL, STATE OR NATIONAL BUILDING CODES PRIOR TO CONSTRUCTING IMPROVEMENTS.

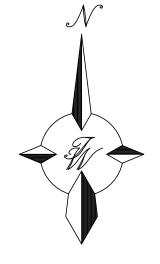

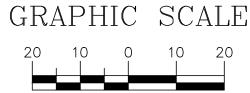

SCALE: 1"=20'



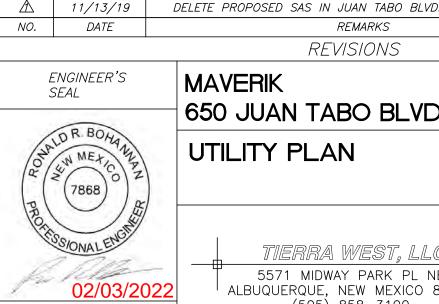

RONALD R. BOHANNAN

P.E. #7868

DELETE PROPOSED SAS IN JUAN TABO BLVD. & UPDATE NOTES RS BYDRAWN BY pm 650 JUAN TABO BLVD. NE DATE 10-29-2021 DRAWING 2018046-MU SHEET # TIERRA WEST, LLC 5571 MIDWAY PARK PL NE ALBUQUERQUE, NEW MEXICO 87109 (505) 858-3100

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JOB # 2019050

Gurrant DRC		
Project Number	465582	and 465583

FIGURE 12

INFRASTRUCTURE LIST

-

EXHIBIT "A"

Date Submitted Daki Site Plan Approved Date Preliminary Plat Approved Date Preliminary Plat Expense DRE Project No. PR-2018-001411 DRB Application No. \$1-2019-00095

TO SUBDIVISION IMPROVEMENTS AGREEMENT

DEVELOPMENT REVIEW BOARD (D.R.B.) REQUIRED INFRASTRUCTURE LIST

Maverik inc. Gas & C-Store Development at 650 Juan Tabo Blvd. - SITE PLAN FOR BUILDING PERMIT PROPOSED NAME OF PLAT AND/OR SITE DEVELOPMENT PLAN

Lot A & B, Block & La Cuesta Subdivision, Albuquerque, Bernatillo County, New Mexico EXISTING LEGAL DESCRIPTION PRIOR TO PLATTING ACTION

Following is a summary of PUBLIC/PRIVATE infrastructure required to bit constructed or financially guaranteed for the above development. This Listing is not necessarily a complete using. During the SIA process and/or in the review of the construction drawings, if the DRC Chair determines that appurent terms and/or unfantscent terms have not been included in this infrastructure listing, the DRC Chair may include those items. to the 3sting and related financial guarantee. Likewise, if the DRC Chair determines that appunding for non-essential ferris can be deleted from the felling, shows them may be deleted as well as the related perfums of the financial quarantees. At such revisions require approval by the DRC Chair, the User Dispertment and agent/awner. If such approvals are obtained, these revisions to the issuing will be incorporated administratively. In addition, any unformance thems which arise during construction which are necessary to complete the project and which remnally are the Suedisduct responsibility will be required as a condition of project acceptance and

Financially	Constructed	Size	Type of Improvement	18-0-01-0			Const	ruction Co	rtification
Guaranteed DRC #	Under DRC#	-	. Aba or militorediesis	Location	From	To	Priva Inspector	P.E.	City Crist Engineer
		11.0	Northbound right turn lane on Juan Table Blvd. at Copper Ave.	650 on Juan Tabo Bive	1.4n Off Rome	Compar Ave.		-1-	
		Right-in Differently	16' wide right-in only driveway on Juan Table Blive	290' south of Juan Toto I		APPROVED 925/19	1	-1-	
		FEE	Rectice each an of Copper Ave. at least Table Block for dual week bound with term sense plus through a post jum face.	2601 slung Copper Area	Copper Jaun Tabo	Rakano St.	1-	1-	
		8:0	350' of PCC Sidowali	Juan Tabu Biyd	Zig Rid	Copper Ave	<u>, , , , , , , , , , , , , , , , , , , </u>	7	
		2:0	2x Sidewell, Guivert COA DWG 2238	on Juan Tabo Bivd., 35' as	outh of Copper Aver ins	ersection	1	1	1
		18,	Storm ellet entocations, extension of RCP pipe to new inlet	on Juan Tabo Blvd , 356's	and 520 south of Copp	er Ave. intersection	1	1	
		6-6	Sidewalk, curb and gutter replacement of existing driveway cuts	Along Paisano St. Copper	Ave., and Zig Rd		- i	1	
		4'-0	Sower MH lid adjustment (new expentive lid for existing MH)	dri Jian Tabo Bird 417 sp	with at Copper Awe into	medicn	1	1	
		6"	Sewer service connection	Zia Rd				1	_ /
				PAGE 1 OF 2				_	

ORIGINAL

	Constructed						Const	truction Cer	ification
Guaranteed	Under	Size	Type of improvement	Location	From	To	Priv	ate	City Crist
DRC#	DRCA						Inspector	P.E.	Engineer
		8	Watering service connection & meter	Paisand St.				i	
		ADA Rampe	New ADA ramps at corners of	Juan Tabo Blvd / Flaisa	und St. / Goppler Ave. / De Rid		10	3.	1
		-	Remove existing water motions and shufulf all pr	orp stop, abandoned to the re	sair)		- 7	1	X
			Engineer's Certification for Grading & Dramage	is required for release of Fin	rontial Guarantno		1.2	7	1
		(a)	Relocate cantary sewer along June Table to be under new eight turn cane 28%, and metall but Type C Mile.	Juan Tabo Bivol.	Zia Ra.	Copper Ave.	7	ij.	1
		E	Shiping modification for left turn sone	Gopper Ave.	180-ft to 235-ft from Jua	Cur	7.	di	Ĭ.
					Approval of Creditable	APPROVED 0/25/14	Approval of	Creditable It	ems.
, _		If the s	ite is located in a floodplain, then the financia Street ligh	NOTES I guarantee will not be rele its per City rquirements.	Impact Fee Admistrato		City User D	ept. Signati	ire Dat
2 -		If the s		I guarantee will not be rele			City User D	ept. Signati	ire Da
2 =	AGENT / OWNER	If the s		I guarantee will not be rele its per City rquirements.		oved by FEMA.	City User D	opt, Signati	irė Da
Line	AGENT / OWNER Richard Stevenson NAME (print) Tierra West LLC FIRM	11 the s	ORB O TRANSPORTATION	I guarantee will not be rele its per City rquirements.	IEW BOARD MEMBER APPR	ROVALS	12.419	opt, Signati	F Da
Line	Richard Streeman NAME (print) Therra West LLC FIRM	It the s	TRANSPORTATION UTILITY DEVI	DEVELOPMENT REV	IEW BOARD MEMBER APPR	AMAFCA - date	12.419	ept. Signatu	F Da