













**CAUTION**  
 ALL EXISTING UTILITIES SHOWN WERE OBTAINED FROM RESEARCH AS-BUILT SURVEYS OR INFORMATION PROVIDED BY THE CONTRACTOR. THE CONTRACTOR SHALL BE RESPONSIBLE FOR VERIFYING THE ACCURACY OF ALL UTILITIES SHOWN. TO DETERMINE THE ACTUAL LOCATION OF UTILITIES AND TO VERIFY THE INFORMATION AND TO MAKE ANY NECESSARY CHANGES FROM THIS PLAN SHALL BE COORDINATED WITH AND APPROVED BY THE ENGINEER.

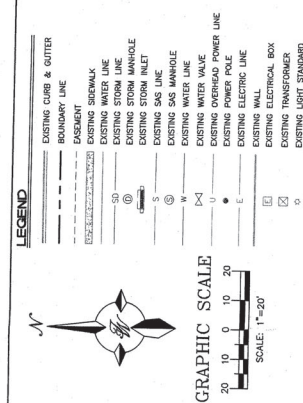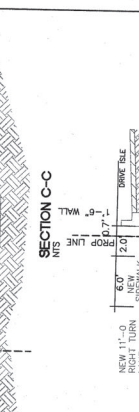

**PRIVATE DRAINAGE FACILITIES WITHIN CITY RIGHT-OF-WAY (SPECIAL ORDER # 302-P)**

- AN EXCAVATION/CONSTRUCTION PERMIT WILL BE REQUIRED BEFORE BEGINNING ANY WORK WITHIN CITY RIGHT-OF-WAY.
- ALL WORK DETAILED ON THESE PLANS TO BE PERFORMED, EXCEPT AS NOTED OTHERWISE, SHALL BE IN ACCORDANCE WITH THE STANDARD SPECIFICATIONS FOR PUBLIC WORKS CONSTRUCTION, 1988.
- TWO WORKING AIDS SHALL BE PROVIDED TO THE CONTRACTOR MUST BE PROVIDED TO THE CONTRACTOR AT THE COMMENCEMENT OF WORK. THE CONTRACTOR SHALL MAINTAIN AND PROTECT ALL EXISTING UTILITIES AND STRUCTURES. THE CONTRACTOR SHALL BE RESPONSIBLE FOR VERIFYING THE INFORMATION AND TO MAKE ANY NECESSARY CHANGES FROM THIS PLAN SHALL BE COORDINATED WITH AND APPROVED BY THE ENGINEER.
- NOTIFY THE ENGINEER SO THAT THE CONTACT CAN BE RESOLVED WITH A CONTRACTOR.
- BACKFILL COMPACTION SHALL BE ACCORDING TO TYPICAL/STREET USE.
- MAINTENANCE OF EXISTING UTILITIES SHALL BE THE RESPONSIBILITY OF THE OWNER OF THE PROPERTY SERVED.
- WORK ON ARTERIAL STREETS SHALL BE PERFORMED ON A 24-HOUR BASIS.
- CONTRACTOR MUST CONTACT DAVID S. HARRISON AT 205-8018 AND HARRISON CONSULTING AT 844-5410 TO SCHEDULE AN INSPECTION.


**EPHON CONTROL NOTES**

- CONTRACTOR IS RESPONSIBLE FOR OBTAINING A TOPSOIL DEFERENCE PERMIT PRIOR TO BEGINNING WORK.
- CONTRACTOR IS RESPONSIBLE FOR MAINTAINING RUN-OFF ON SITE DURING CONSTRUCTION.
- CONTRACTOR IS RESPONSIBLE FOR CLEANING ALL SEDIMENT THAT GETS INTO EXISTING RIGHT-OF-WAY.
- REPAIR OF DAMAGED FACILITIES AND CLEANUP OF SEDIMENT FROM THE CONSTRUCTION SITE IS THE RESPONSIBILITY OF THE CONTRACTOR.
- ALL EXPOSED EARTH SURFACES MUST BE PROTECTED FROM EROSION PRIOR TO FINAL (CITY) ACCEPTANCE OF ANY PROJECT.

**AGRS MONUMENT "2 L22" STANDARD CO.A. BRASS DISC  
 NEW MEXICO STATE PLANE COORDINATES  
 NAD 83  
 NAD 83 ZONE 10N - N.A.D. 1983  
 E=1466,234.48 US SURVEY FEET  
 N=1,000,000.00 US SURVEY FEET  
 GROUND TO GRID FACTOR=0.999999975  
 DELTA ALPHA ANGLE=-0.00832.78"**

**NOTES**

- ALL EXISTING EASEMENTS WILL BE VACATED BY THE CONTRACTOR.
- A DRAINAGE EASEMENT FOR THE SHOW PONDS AND DRAINAGE FACILITIES WILL BE SUBMITTED TO THE COA.
- REFER TO DRAINAGE PLAN SHEET C4 FOR BMP RESPONSIBILITIES.
- ADAPTATIONS AND MODIFICATIONS TO THIS PLAN SHALL BE APPROVED BY THE ENGINEER. ANY CHANGES SHALL BE DETAILED ON A DRS APPROVED BY THE ENGINEER. THE CONTRACTOR SHALL BE RESPONSIBLE FOR OBTAINING NECESSARY PERMITS AND APPROVED WORK ORDER BEFORE BEGINNING ANY CONSTRUCTION. A RIGHT TURN INTO THE SITE FROM JUAN TABO IS PROHIBITED. THE CONTRACTOR SHALL BE RESPONSIBLE FOR OBTAINING NECESSARY PERMITS AND APPROVED WORK ORDER (GRADING PLAN - PHASE 2).

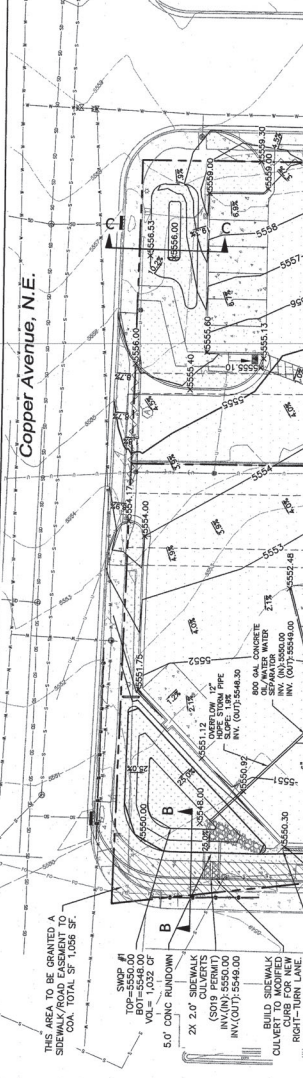

**THE AREA TO BE GRANTED A SIDEWALK SHALL BE 10.0' WIDE. TOTAL SF 1,058 SF.**

**SWMP #1**  
 TOP=5550.00  
 BOT=5540.00  
 VOL=1,032 CF

**5.0' CONC. RAINDOWN**  
 2X 2.0' CONC. SIDEWALK  
 (S019 PERMIT)  
 INV. (0.0)=5540.00  
 INV. (0.0)=5540.00

**BUILD SIDEWALK**  
 CULVERT TO MOVE/RELOCATE  
 RIGHT-TURN LANE  
 1'-6" CONC. WALL  
 TRANSITION END

**3.5' CURB CUT**

**1'-6" CONC. WALL**

**1'-6" CONC. WALL TRANSITION END**

**PROPOSED RIGHT TURN ON COA DRC PLAN SET. NOT PART OF BUILDING PERMIT PLANS.**

**JAUN TABO BOULEVARD, N.E.**

**C-STORE 4,300 SF**

**1'-6" CONC. WALL**

**1'-6" CONC. WALL TRANSITION END**

**COPPER AVENUE, N.E.**

**ZIA ROAD**

**PAISANO STREET, N.E.**

**SECTION A-A**

**SECTION B-B**

**SECTION C-C**

**SECTION D-D**

**MAVERIK**  
**650 JUAN TABO BLVD. NE**  
**GRADING PLAN**

ENGINEER'S SEAL  
  
**RONALD D. SCHWANEN**  
 P.E. #7859

**TERESA WEST, LLC**  
 3574 MAWPA PARK, P.E. NE  
 ALBUQUERQUE, NM 87109  
 www.terestwest.com

DRAWN BY: jpm  
 DATE: 4-18-19  
 DRAWING: 2018046-GR  
 SHEET: C2  
 JOB #: 2018046


**MAVERIK**

2:\2018\2018046\maverik\650 Juan Tabo & Copper\dwg\DWG\2018046-GR.dwg Apr 18, 2019 - 11:14am







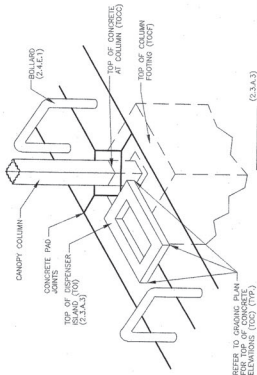




(2.3.3.3)  
 IF RAISED VERTICAL CONCRETE ISLAND WITH RAISED FLOOR 5'-0" OR MORE TO BE USED, THE 5'-0" - 3'-0" OF FUEL ISLAND AREA FROM ISLAND IN ALL (O) PORTS BEING USED TO BE EQUIPPED WITH AN ANTISTATIC DISCHARGER TO BE EQUIPPED WITH AN ANTISTATIC DISCHARGER.

NOTE: TOP OF CONCRETE ISLAND TO BE 5'-0" FROM TOP OF CONCRETE AT COLUMN (T.O.C.) & SPREAD FOOTING. SEPARATION IS 9'-6".

REFER TO GRADING PLAN ELEVATIONS (T.O.C.) (T.O.F.)

Fuel Dispenser Elevations

FUEL DISPENSER	TOP OF T.O.C. @ ISLAND	TOP OF T.O.C. @ COLUMN	TOP OF T.O.C. @ F.P.
1-2	5552.31	5552.33	5552.33
3-4	5553.04	5552.40	5552.40
5-6	5552.30	5552.30	5552.30
7-8	5552.84	5552.26	5552.32
9-10	5552.26	5552.26	5552.26
11-12	5552.61	5552.68	5552.68
13-14	5552.61	5552.03	5552.03
15-16	5552.43	5551.96	5551.96
17-18	5552.43	5551.85	5551.85
19-20	5552.34	5551.76	5551.76

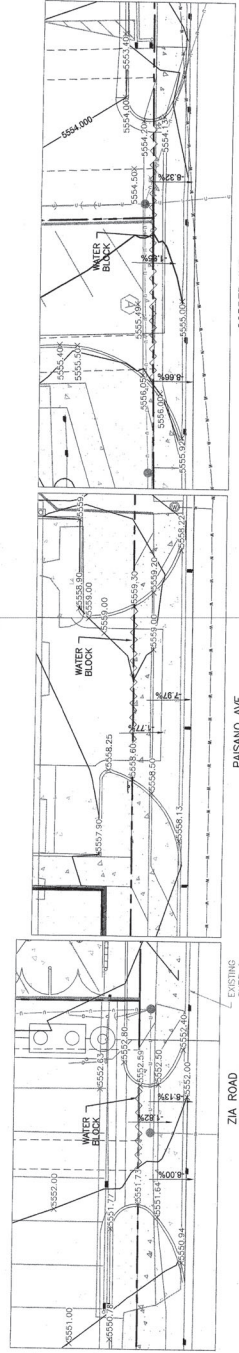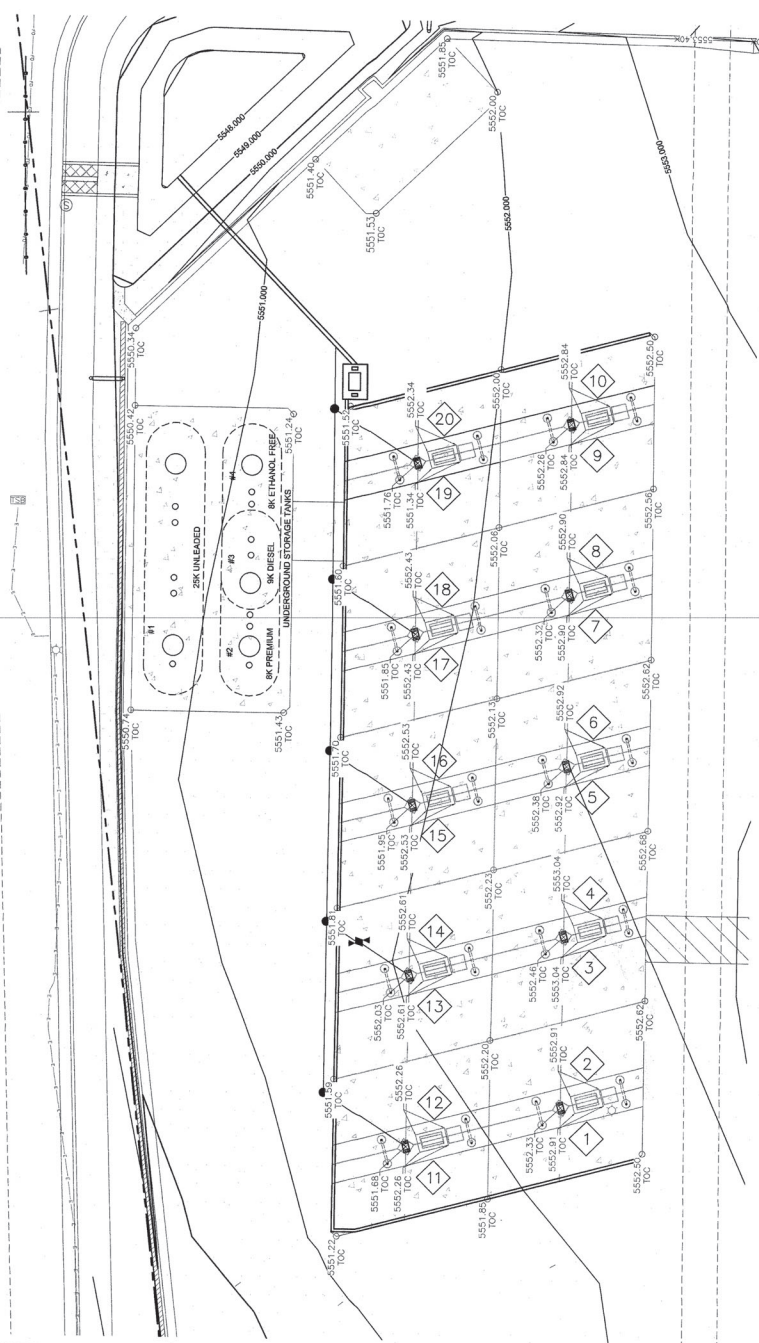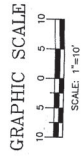

**MAVERIK**  
 650 JUAN TABO BLVD. NE  
 GRADING DETAILS

REGISTERED PROFESSIONAL ENGINEER  
 STATE OF ALABAMA  
 REGISTRATION NO. 17189

FORWARD BY: pm  
 DATE: 4-19-19  
 DRAWING: GRADING  
 201804E-09-CETALS

SHEET # **C4**

**TRISTEVA WISSET, LLC**  
 5571 MENWAY PARK PL. NE  
 ALBUQUERQUE, NEW MEXICO 87109  
 www.tristevawisset.com

FORWARD BY: R. BISHAWAY  
 DATE: 4-19-19









JOB # 201804E









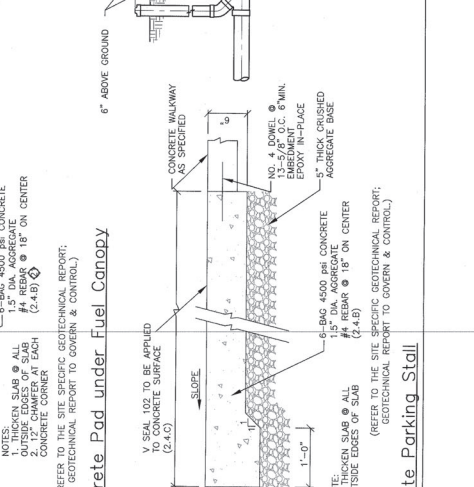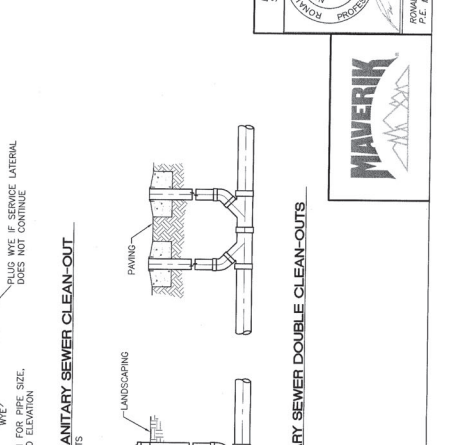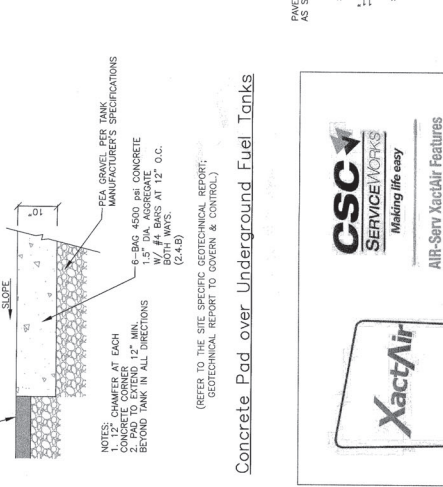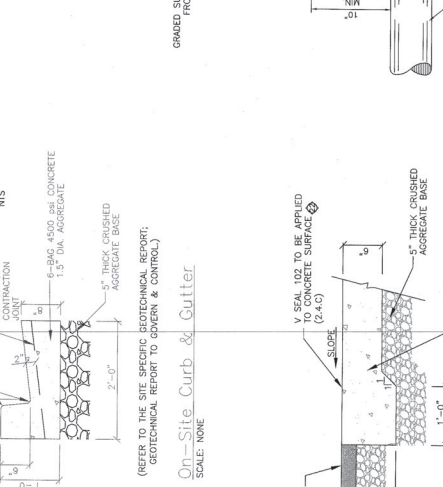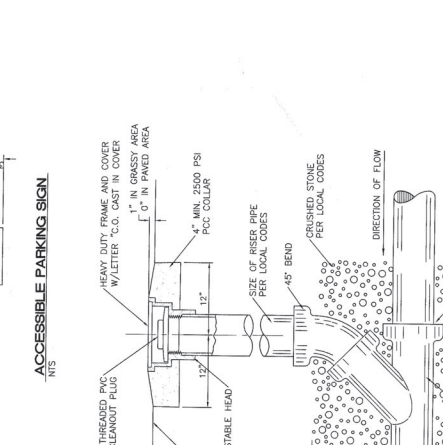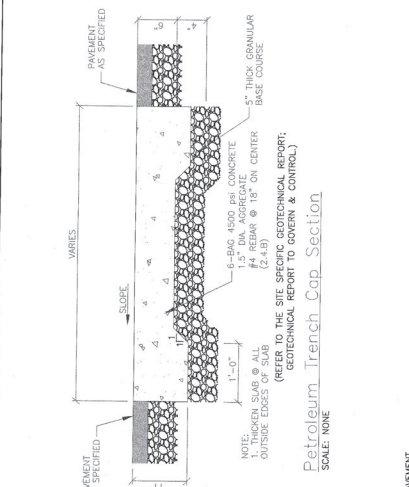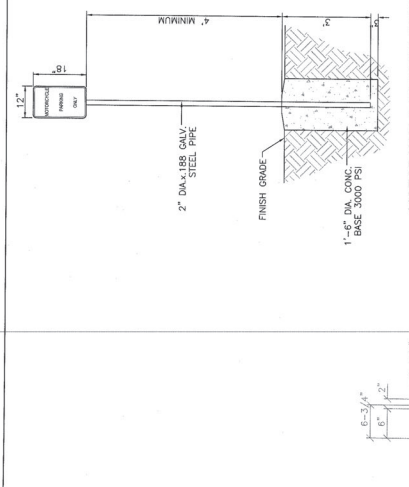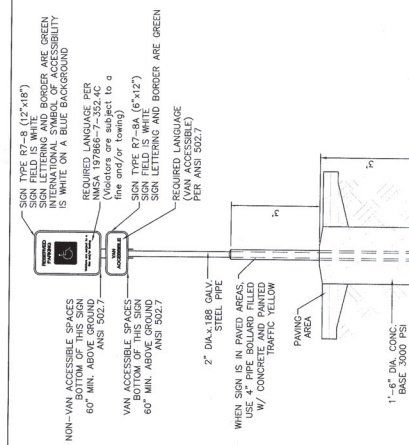

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Heavy Duty Stainless Steel Cabinet  
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24/7 Wireless Monitoring  
Built-In Heater (optional)  
Vacuum Feature Available  
Dissipative Benefits  
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Proven Results  
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Improve Customer Usability  
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**TERRA WEST, LLC**  
5571 MIDWAY PARK, AL, NE  
ALBUQUERQUE, NM 87109  
(205) 858-3100  
www.terrawestllc.com

ENGINEER'S SEAL	MAVERIK	DRAWING BY	05/03/2019
PROJECT NO.	650 JUAN TABO BLVD. NE	DATE	05-03-2019
DRAWING NO.	CONSTRUCTION DETAIL 1	DRAWING	201904-LET
DATE		SHEET #	C6
SCALE		PROJECT	5571 MIDWAY PARK, AL, NE
DESIGNED BY		PROJECT NO.	ALBUQUERQUE, NM 87109
CHECKED BY		DRAWING NO.	(205) 858-3100
DATE		SCALE	
PROJECT		PROJECT	5571 MIDWAY PARK, AL, NE
PROJECT NO.		PROJECT NO.	ALBUQUERQUE, NM 87109
DRAWING NO.		DRAWING NO.	(205) 858-3100
DATE		DATE	
DRAWING BY		DRAWING BY	
DATE		DATE	



**MAVERIK**  
650 JUAN TABO BLVD. NE  
CONSTRUCTION DETAIL 1

**MAVERIK**  
5571 MIDWAY PARK, AL, NE  
ALBUQUERQUE, NM 87109  
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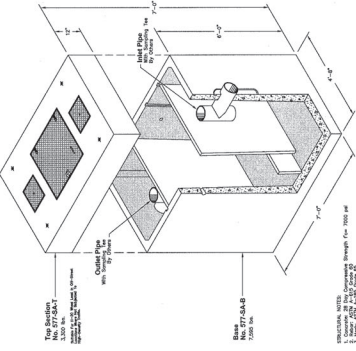
**MAVERIK**  
5571 MIDWAY PARK, AL, NE  
ALBUQUERQUE, NM 87109  
(205) 858-3100  
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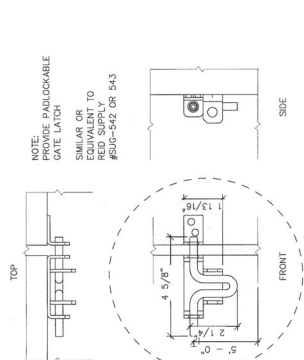
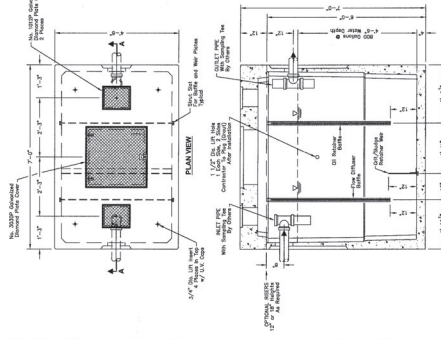


**577-SA OIL WATER SEPARATOR**  
800 Gallon capacity




**STRUCTURAL NOTES:**  
1. See Section 05100 for details of all steel connections.  
2. All steel shall be A36 unless otherwise noted.  
3. All steel shall be galvanized steel.  
4. All steel shall be painted with a minimum of two coats of primer and two coats of finish paint.  
5. All steel shall be protected from corrosion by the application of a corrosion resistant coating.  
6. All steel shall be protected from corrosion by the application of a corrosion resistant coating.  
7. All steel shall be protected from corrosion by the application of a corrosion resistant coating.  
8. All steel shall be protected from corrosion by the application of a corrosion resistant coating.  
9. All steel shall be protected from corrosion by the application of a corrosion resistant coating.  
10. All steel shall be protected from corrosion by the application of a corrosion resistant coating.


577-SA



**Dumpster Enclosure Gate Latch Detail**  
SCALE: NONE

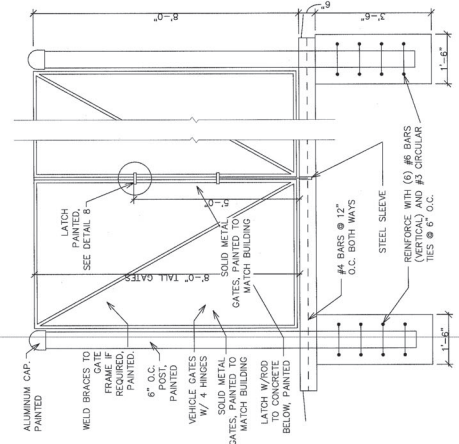


**Dumpster Enclosure Gate Detail**  
SCALE: NONE

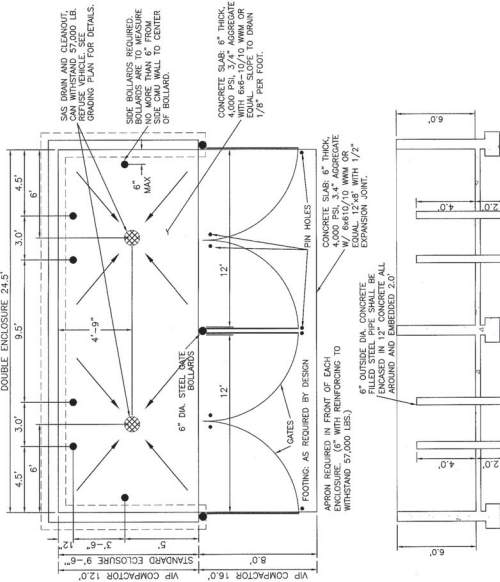


**DUMPSTER W/SAS DRAIN - ENCLOSURE DETAIL**  
N.T.S.


**NOTE:** CHECK FOR THE MINIMUM REQUIREMENTS FOR EACH ENCLOSURE.  
1. ENCLOSURES' DESIGNERS MAY WANT TO THE SELECTED ENCLOSURE.  
2. SOLID WASTE IS TO PROVIDE ALL DIRECTIONS ON THE APPROXIMATE BEAM BOLLARDS, AND FINAL INSPECTION WILL BE CONDUCTED FOR SOLID WASTE SIZE OF 10" DIA. OR LESS.

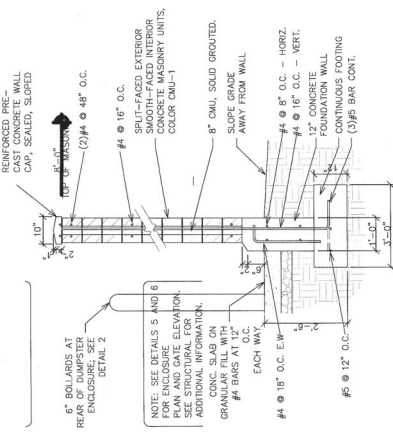

**Dumpster Enclosure Wall Section**  
SCALE: NONE

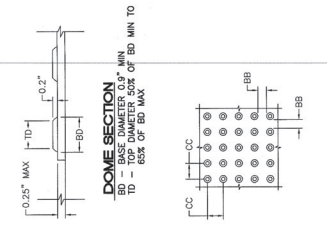

**DOMES SECTION**  
OC - CENTER TO CENTER SPACING 2.35"  
BB - BASE TO BASE SPACING 1.48" MIN

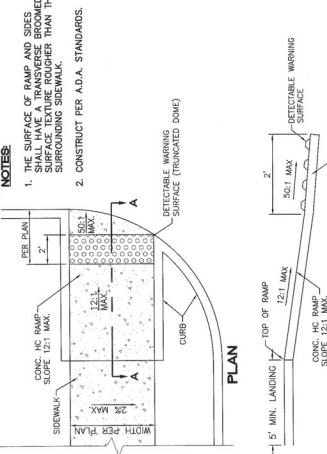

**SECTION A-A**  
**UNIDIRECTIONAL HC RAMP**  
NOT TO SCALE

	<b>MAVERIK</b> 650 JUAN TABO BLVD. NE CONSTRUCTION DETAIL 3	DRAWING BY: [blank] DATE: 05-03-2019 DRAWING: 20180601.DWG SHEET # C8
	TERRA WEST, LLC 5571 MONROE PARK, P.L. NE ALBUQUERQUE, NM 87109 (505) 858-3100 www.terrawestllc.com	P.E. / P.S. BOHANNAN 058 / 2018046






**LEGEND**

---	EXISTING CURB & GUTTER
---	BOUNDARY LINE
---	EASEMENT
---	EXISTING SIDEWALK
---	EXISTING WATER LINE
---	EXISTING STORM LINE
---	EXISTING STORM MANHOLE
---	EXISTING STORM INLET
---	EXISTING GAS LINE
---	EXISTING GAS MANHOLE
---	EXISTING WATER LINE
---	EXISTING WATER VALVE
---	EXISTING OVERHEAD POWER LINE
---	EXISTING POWER POLE
---	EXISTING ELECTRIC LINE
---	EXISTING WALL
---	EXISTING ELECTRICAL BOX
---	EXISTING TRANSFORMER
---	EXISTING LIGHT STANDARD
---	EXISTING TELEPHONE PEDESTAL

**KEYED NOTES**

- 1 REMOVE AND DISPOSE EXISTING BUILDING AND FOUNDATION
- 2 REMOVE AND DISPOSE EXISTING CURB AND GUTTER
- 3 REMOVE AND DISPOSE EXISTING CONCRETE SIDEWALK
- 4 REMOVE AND DISPOSE EXISTING WALL
- 5 REMOVE AND DISPOSE EXISTING ELECTRICAL BOX
- 6 REMOVE EXISTING TRANSFORMER, RETURN TO PHM
- 7 REMOVE AND DISPOSE EXISTING GAS METER (TYP)
- 8 REMOVE AND DISPOSE EXISTING LIGHT STANDARD (BY OTHERS)
- 9 EXISTING POWER LINE AND POLES TO BE RELOCATED
- 10 REMOVE AND DISPOSE ALL EXISTING ASPHALT AND SIDEWALK
- 11 REMOVE AND DISPOSE 86 LF EXISTING CURB AND GUTTER AND SIDEWALK
- 12 REMOVE AND DISPOSE 70 LF EXISTING CURB AND GUTTER AND SIDEWALK
- 13 REMOVE AND DISPOSE 56 LF EXISTING CURB AND GUTTER AND SIDEWALK
- 14 REMOVE AND DISPOSE EXISTING SIGN
- 15 EXISTING WALL TO REMAIN
- 16 EXISTING SIGN TO REMAIN

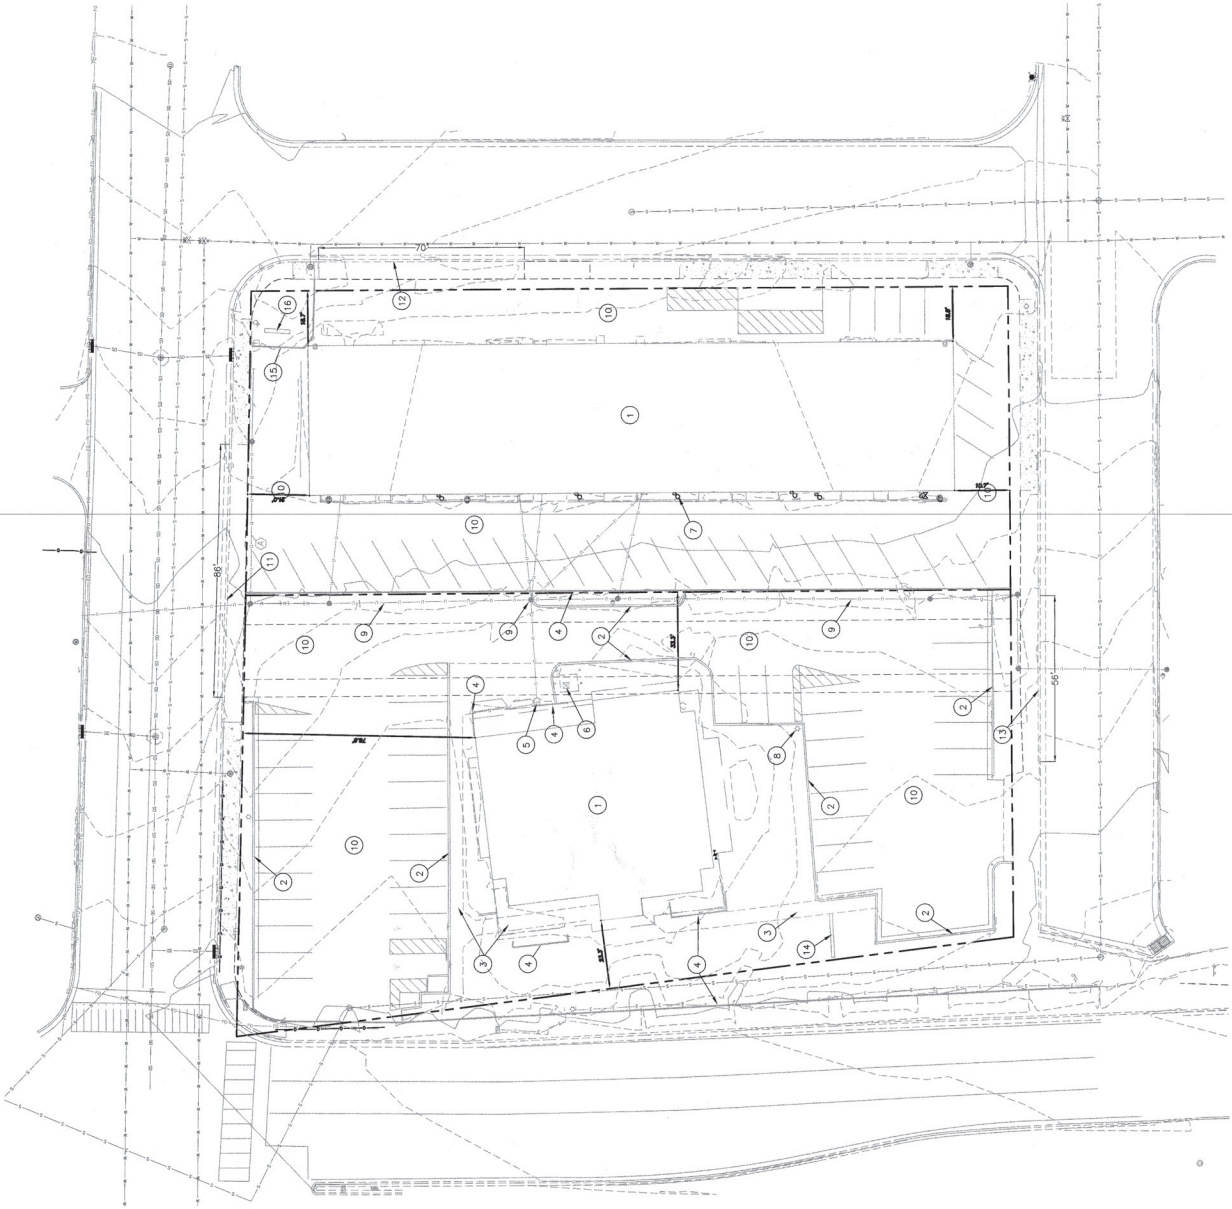

	<b>MAVERIK</b> <b>650 JUAN TABO BLVD. NE</b> <b>DEMOLITION PLAN</b>	DRAWN BY pm DATE 05-03-2019 DRAWING 2018046-1040 SHEET # <b>C9</b> JOB # 2018046
ENGINEER'S SEAL 	<b>TERRA WEST, LLC</b> 5571 MIDWAY PARK PL. NE ALBUQUERQUE, NM 87109 (505) 858-3100 www.terrawestllc.com	RONALD R. BOHNANN P.E. #7469

















DESIGN

1605 South Gramercy Rd.  
Salt Lake City, UT 84104  
801.487.8481

www.yesco.com

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This drawing was created to assist you in visualizing the proposed sign. The drawings herein are the property of YESCO LLC. Permission to copy or revise this drawing can only be obtained through a written agreement with YESCO.

The colors shown are only approximated on any computer monitor, inkjet or laser print. The final product may vary slightly in color from your computer monitor or print.



This sign will be installed in accordance with the requirements of Article 600 of the National Electrical Code and / or other applicable local codes. This includes proper grounding and bonding of the sign.

Revisions

No.	Date / Description
01	03/02/2016
02	03/02/2016
03	03/02/2016
04	03/02/2016
05	03/02/2016
06	03/02/2016
07	03/02/2016
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98	03/02/2016
99	03/02/2016
100	03/02/2016

Approvals

YESCO AE Signature / Date

Client Signature / Date

Landlord Signature / Date

Maverik

Juan Tabo & Copper  
Albuquerque, NM

Acct. Exec: Matt Wren

Designer: Justin Raymond

Date: 04.29.2019

Monument Sign

17594 R2

JO #


scale: as noted

ART 2.0

SCOPE OF WORK

MANUFACTURE & INSTALL ONE (1) MONUMENT SIGN.

AREA: 74.85 SF

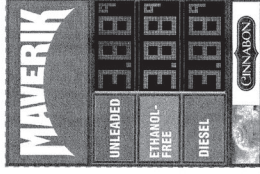

ELECTRICAL


POWER TO DISPLAY LOCATION: BY OTHERS OR EXISTING  
HOOKUP AT DISPLAY: BY YESCO

COLOR KEY - MAVERIK STANDARDS - NEW LOGO

- 1. PAINT SHERWIN WILLIAMS® 7020 "BLACK FOX"  
VINYL 3M 3630-69 DURANODIC
- 2. PMS PANTONE® 786c  
VINYL 3M 3630-33 "RED"
- 3. PAINT MATCH PMS 348c/SW4LV5-5074886-389504-A  
VINYL 3M 3630-26 "GREEN"
- 4. PAINT DUPONT #K 9441  
VINYL 3M 3630-26 "LT EUROPEAN BLUE"

NOTE: UNLESS OTHERWISE NOTED, THE COLORS SHOWN ON THIS DRAWING ARE APPROXIMATIONS. CONTRACTOR TO OBTAIN AND TEST APPROPRIATE VENDOR SPECIFIED SAMPLES FOR APPROVED COLOR SPECIFICATIONS.

REVERSE VIEW

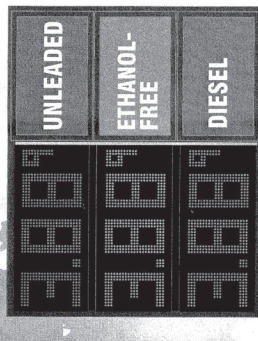

Sign Area: 24.5ft<sup>2</sup>

Internally illuminated aluminum cabinet w/ painted finish (see color key). Retainer size as req. Clear formed face w/ 2st surface decoration (see color key) (only copy is raised). White LED illumination.

Sign Area: 40.2ft<sup>2</sup>

price changer aluminum cabinet w/ painted finish (see color key). Retainer size as req. White polycarbonate faces for products w/ 1st surface vinyl (see color key). White LED illumination.

Sign Area: 8.3ft<sup>2</sup>

Internally illuminated aluminum cabinets w/ painted finish (see color key). 1" 5/8" retainer. White polycarbonate face w/ 1st surface digitally printed graphics (see color key). White LED illumination. Painted aluminum cap.

YESCO to provide duraseck base. Contractor to provide stone veneer.

Concrete mow-pad.



2

D/F ILLUMINATED MONUMENT SIGN

SCALE: 1/2" = 1'-0"

2.1

SIDE VIEW

This design does not constitute production ready artwork and is to be used exclusively for proofing and review purposes only.

DSN: 17594\_Maverik - Albuquerque\_ART 2.0\_Monument Sign.dwg













REFERENCE NOTES

- 03.08 CONCRETE FOOTINGS AND FOUNDATIONS SEE STRUCTURAL DRAWINGS
- 04.01 GUIDELINES FOR FINISHES: INSTALL PER MANUFACTURER'S
- 04.02 MFCI PRE-FINISHED ROOF, 1/2" X 3/4" CAP (89-1)
- 05.05 2X12 RAISED DECKING COLOR COORDINATED WITH EXTERIOR FINISHES
- 05.08 SECURED TO 2X4 GUSSET PRE-FINISHED ROOFING (MATERIAL EASTERN CEDAR) OUTSIDE OF PARAMET. EASTERN CEDAR ROOFING MATERIAL FASTEN INSIDE PARAMET. GUSSET FASTENERS. ALL NEOSPHERE GASKETED FASTENERS. ALL ALLOWED.
- 05.72 PRE-FINISHED METAL COPING, COLOR C-4
- 05.74 FIBER CEMENT BOARD & BATTEN SIDING, STRUCTURAL FINISHES. COLOR PA6. SEE SCHEDULE
- 06.04 FIBER CEMENT BOARD & BATTEN SIDING, STRUCTURAL FINISHES. COLOR PA6. SEE SCHEDULE
- 06.05 FIBER CEMENT BOARD & BATTEN SIDING, STRUCTURAL FINISHES. COLOR PA6. SEE SCHEDULE
- 06.06 ALUMINUM STOREFRONT SYSTEM (AST-1), DOOR. SEE SCHEDULE
- 06.07 WINDOW, VERTICAL LOCATION W/ FIRE PLANTERS. SEE CIVIL DRAWINGS.
- 32.24

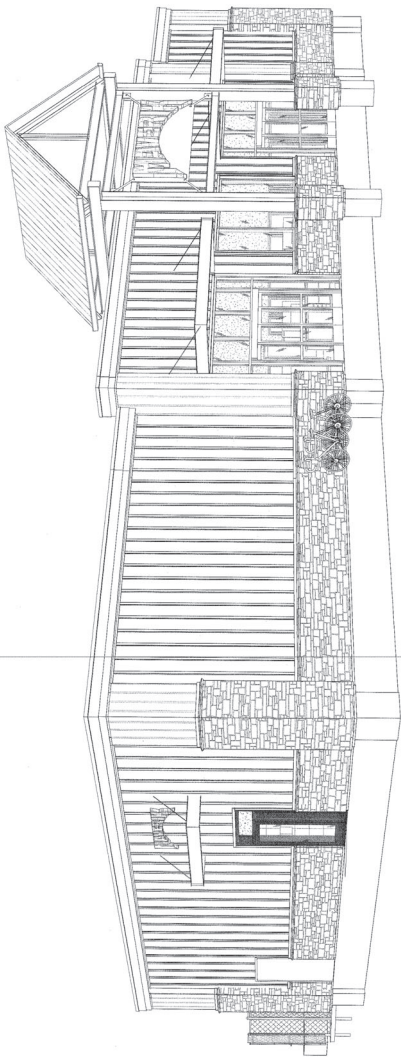

C1 BUILDING PERSPECTIVE  
SCALE:

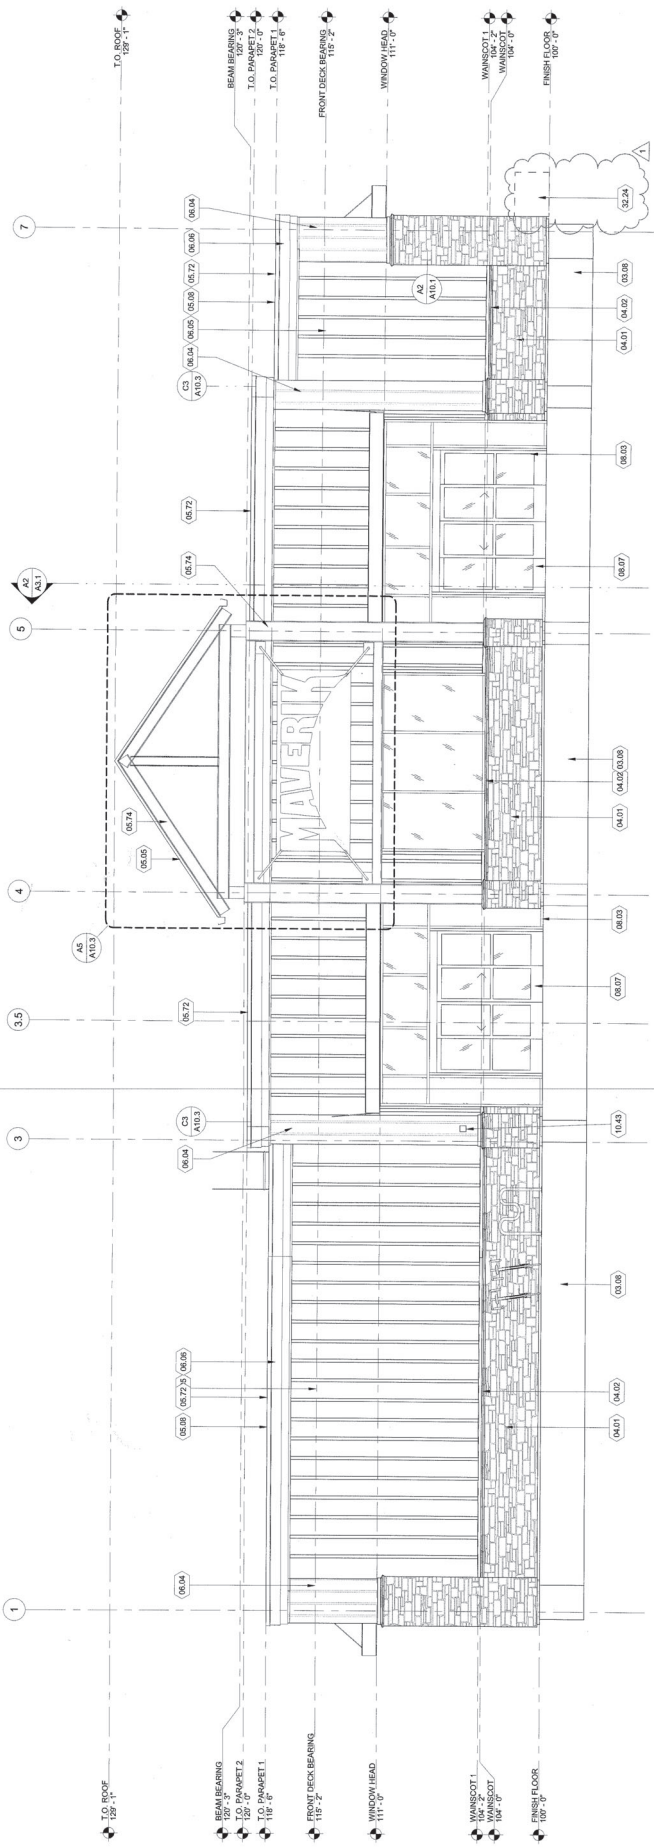

A1 WEST - FRONT ELEVATION  
SCALE: 1/4" = 1'-0"









REFERENCE NOTES

- 03.08 CONCRETE FINISHES AND FOUNDATIONS. SEE STRUCTURAL DRAWINGS.
- 04.01 INSTALL PER MANUFACTURER'S INSTRUCTIONS. SEE SCHEDULES.
- 04.02 STONE VENEER SELL CAP (BB-1)
- 05.05 MFC PRE-FINISHED ROOF, 1/4" 24 GAUGE PRE-FINISHED COPING
- 05.06 24 GAUGE PRE-FINISHED COPING
- 05.08 ROOFING SHALL BE 7/16" O.C. FASTEN INSIDE OUTSIDE OF PARAPET. FASTENERS SHALL BE STANDING SEAM, NO LAPS ALLOWED.
- 05.11 PRE-FINISHED METAL FLASHING BY NEOPRENE GASKETED FASTENERS. ALL ALLOWED.
- 05.72 PRE-FINISHED METAL COPING, COLOR C-4
- 05.74 STRUCTURAL WANSKOT, COLOR P-8. SEE SCHEDULE
- 06.04 FIBER CEMENT BOARD & BATTEN SIDING, SEE SCHEDULE
- 06.05 FIBER CEMENT BOARD & BATTEN SIDING, SEE SCHEDULE
- 06.06 DOOR, SEE SCHEDULE
- 06.07 DOOR, SEE SCHEDULE
- 10.01 8" HIGH CHARALUM TRIM W/ PRIVACY GLASS. COLOR TO MATCH WANSKOT. SEE ELEVATIONS
- 32.12 PLANTERS. SEE CIVIL DRAWINGS.

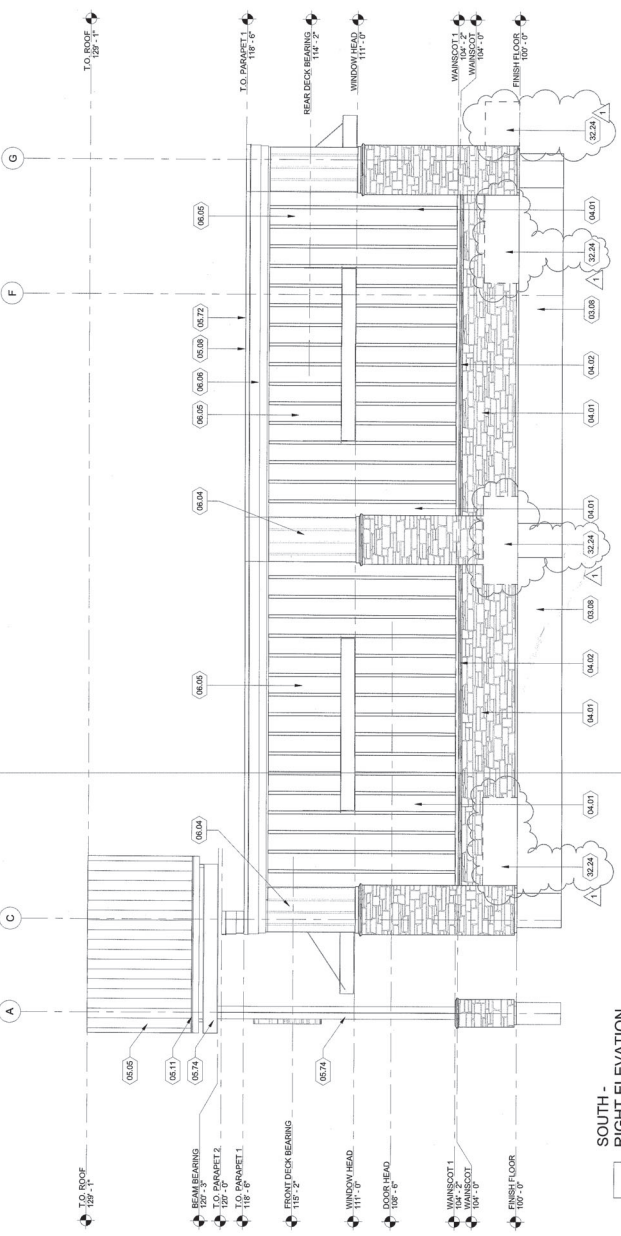

**C2**  
 SOUTH - RIGHT ELEVATION  
 SCALE: 1/4" = 1'-0"

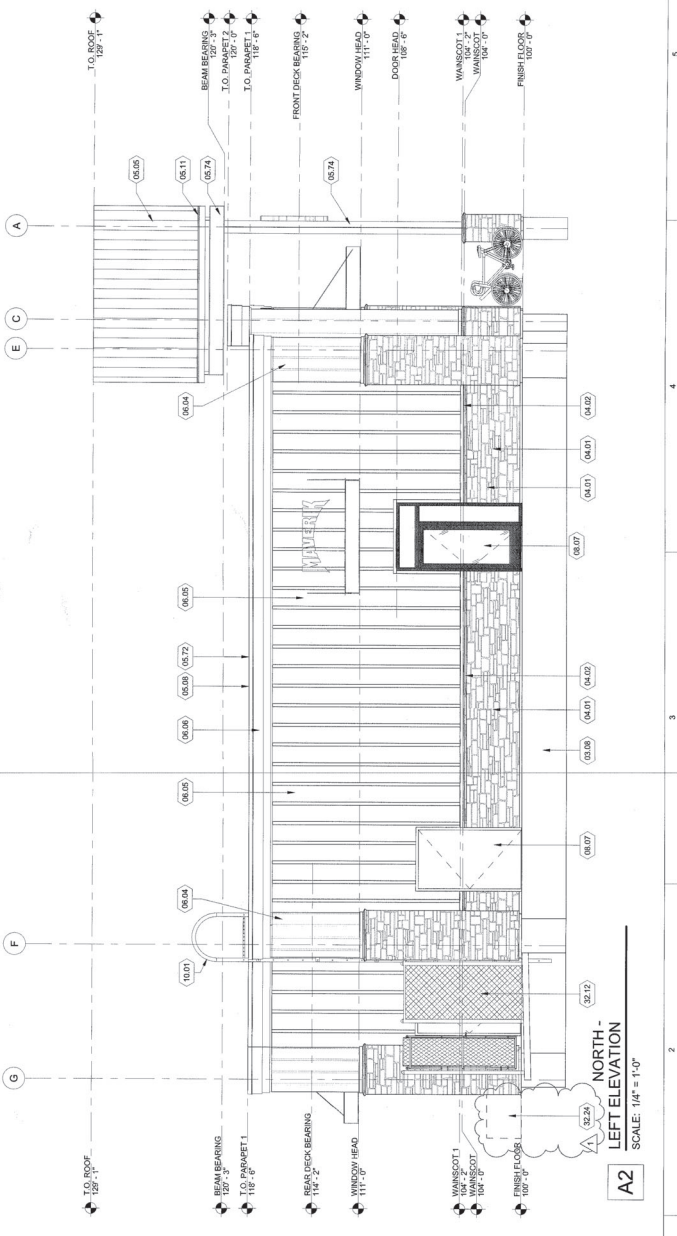

**A2**  
 NORTH - LEFT ELEVATION  
 SCALE: 1/4" = 1'-0"