

O KEYED NOTES

1. 10' PUBLIC UTILITY EASEMENT

2. 50' PUBLIC UTILITY EASEMENT 3. RESTAURANT DRIVE-THRU LANE: DRIVE THROUGH SHALL BE SHADED WITH AN

ARCHITECTURALLY INTEGRATED CANOPY 4. 8" CMU REFUSE ENCLOSURE PER COA SOLID WASTE DEPARTMENT STANDARDS, STUCCOED TO MATCH PRIMARY BUILDING COLOR. REFER DETAIL 3, PAGE 6 5. ACCESSIBLE SIDEWALK RAMP

6. 6" CONCRETE CURB AND DRIVE ENTRY PER COA STANDARDS

7. 6" CONCRETE CURB 8. 10' SET BACK

9. NEW MONUMENT SIGN, REFER DETAIL 5, SHEET A2.1 SIZE SHALL CONFORM TO

THE COORS COORIDOR PLAN: 10. BICYCLE RACK, 5 SPACES, REFER DETAIL 4, PAGE 6

11. LIGHT POLE, REFER DETAIL 2, PAGE 6

13. 4" WIDE PAINTED PARKING STALL STRIPING, WHITE TYPICAL

15. 4' WIDE SIDEWALK 16. TEXTURED CONCRETE PEDESTRIAN CROSSING

17. EXISTING LIGHT POLE 18. LANDSCAPED PARKING ISLAND

20. EXISTING BANK 21. EXISTING RETAIL TIRE STORE

22. EXISTING PARKING AT OFFICE BUILDING

23. CONCRETE WALK, WIDTH AS NOTED ON PLAN 24. EXISTING CURB

25. EXISTING 4' WIDE SIDE WALK 26. EXISTING PROPERTY LINE

29. PLAZA WITH TABLES AND SEATING SHADED WITH SHADE TREES IN TREE GRATES: 250 SF MINIMUM

30. 3' HIGH CMU WALLS TO SCREEN PARKING AREAS FROM THE STREET, STUCCOED TO MATCH PRIMARY BUILDING COLOR

31. 15' LANDSCAPE BUFFER ALONG COORS BLVD.

32. 12' WIDE ROW DEDICATION FOR DECELERATION LANE
33. THE TOP OF ALL ROOFTOP EQUIPMENT SHALL BE BELOW THE TOP OF

PARAPET AND SCREENED FROM VIEW FROM THE PROPERTY LINES OF THE SITE. ALTERNATIVELY, ROOFTOP EQUIPMENT SHALL BE SCREENED BY ROOFTOP WALLS THAT ARE PAINTED TO MATCH THE ROOF COLOR OR THE PREDOMINANT BUILDING COLOR. ALL GROUND MOUNTED EQUIPMENT SHALL BE SCREENED BY SCREEN WALLS WITH TOP OF EQUIPMENT BELOW THE TOP OF THE SCREEN

34. ANY ATM'S SHALL BE ARCHITECTURALLY INTEGRATED WITH BUILDING DESIGN 35. DRAIN TO SANITARY SEWER, THIS REFUSE ENCLOSURE ONLY

36. BROOMED CONCRETE

37. 16' LIGHT FIXTURE (WITHIN 100' OF RESIDENTIAL)

○ RADIUS INFORMATION:

1 RADIUS = 2'-0" (7) RADIUS = 25'-0" (8) RADIUS = 30'-0" 2 RADIUS = 3'-0" 9 RADIUS = 40'-0" 3 RADIUS = 5'-0" (4) RADIUS = 10'-0"

(10) RADIUS = 50'-0" (11) RADIUS = 60'-0" (5) RADIUS = 15'-0"

(12) RADIUS = 48'-0" (6) RADIUS = 20'-0"

PROJECT NUMBER: 1002405

APPLICATION NUMBER: 04-DRB-01797 This plan is consistent with the specific Site Development Plan approved by the Environmental Planning Commission (EPC) on and that the findings and conditions in the Official Notice; Notification of Decision have been compiled with:

Is an Infrastructure List required? () YES () NO

If yes, then a set of approved DRC plans with a work order is required for any construction within Public Right- of- Way or for construction of public

SITE DEVELOPMENT PLAN

Date Environmental Health Department *(conditional 11-23-09


5-21-04 SCALE:


AS NOTED

τ. 80 × F ARCHITECT.

E. SUITE 2-E
EW MEXICO 87

ERMIT

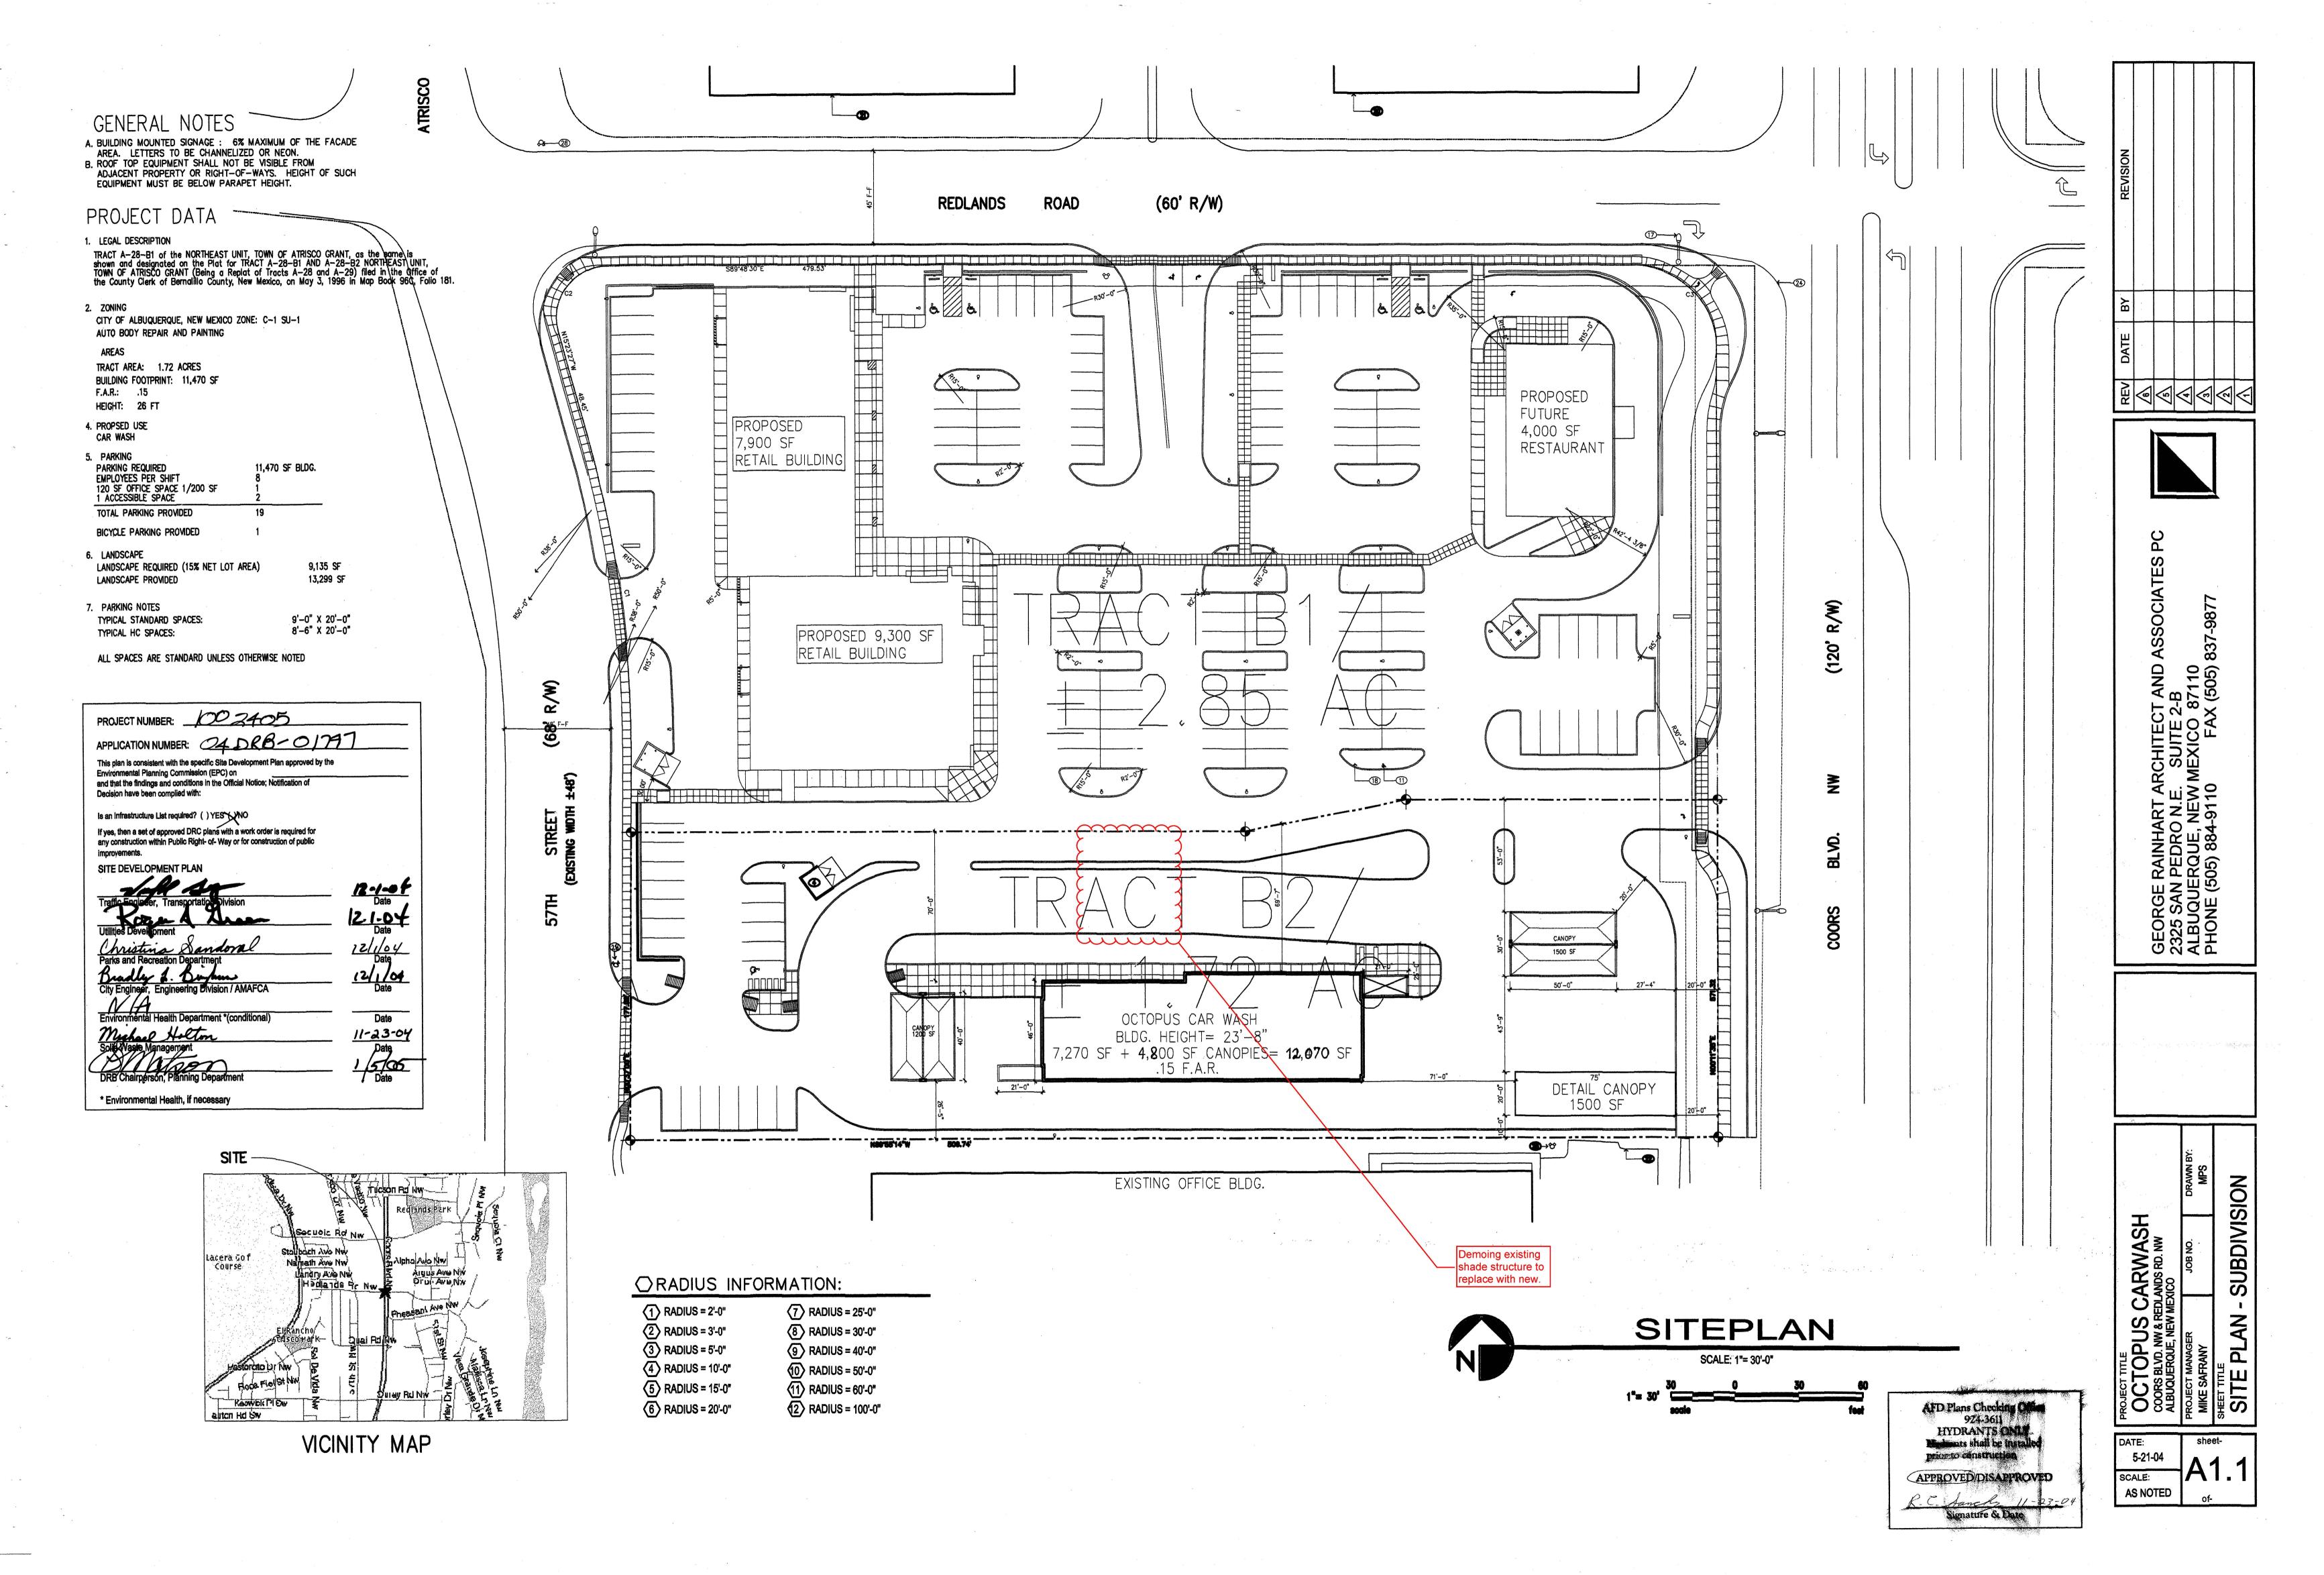

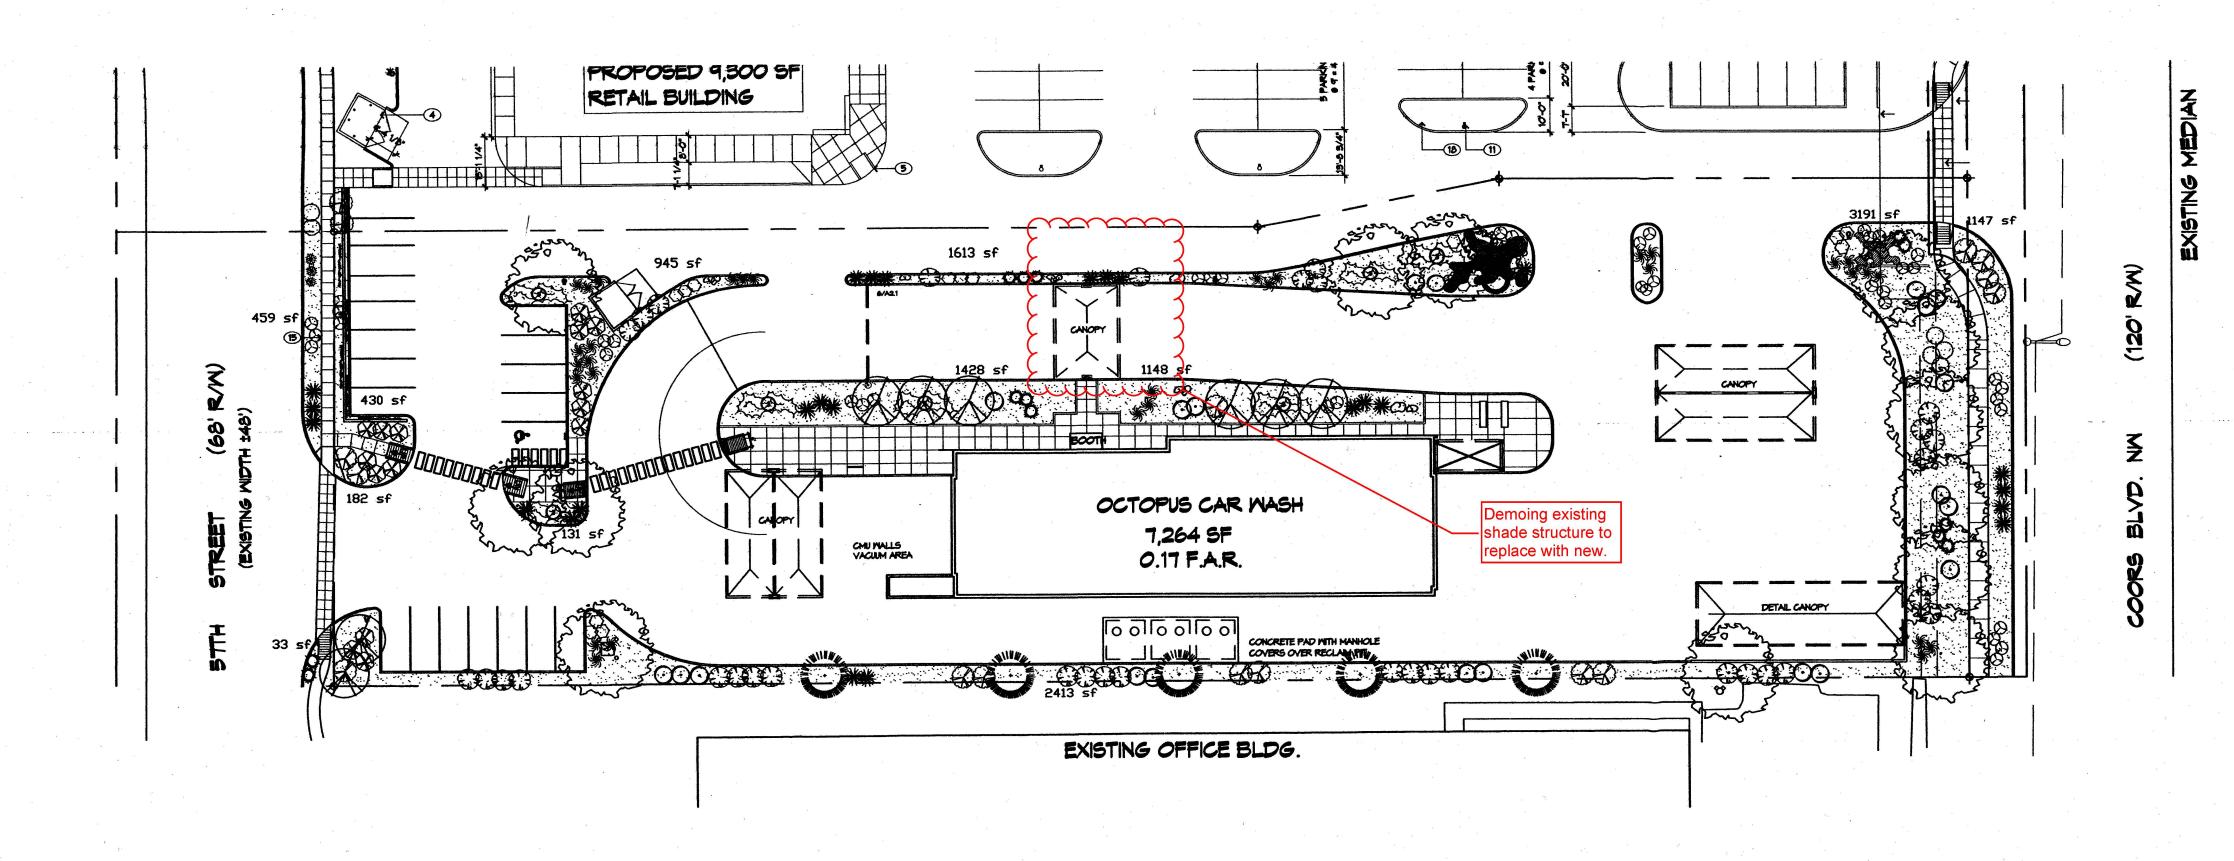

STREET TREE REQUIREMENTS

Street trees required under the City Of Albuquerque Street Tree Ordinance are as follows:

Coors Blvd. Required 5

Provided 6

FINAL LANDSCAPING LAYOUT AND DESIGN TO BE DETERMINED UPON RECEIPT OF FINAL GRADING PLAN. LANDSCAPE NOTES: Landscape maintenance shall be the responsibility of the Property Owner.

It is the intent of this plan to comply with the City Of Albuquerque Water Conservation Landscaping and Water Waste Ordinance planting restriction approach.

Approval of this plan does not constitute or imply exemption from water waste provisions of the Water Conservation Landscaping and Water Waste Ordinance. Water management is the sole responsibility of the Property Owner.

All landscaping will be in conformance with the City of Albuquerque Zoning Code, Street Tree Ordinance, Pollen Ordinance, and Water Conservation Landscaping and Water Waste Ordinance. In general, water conservative, environmentally sound landscape principles will be followed in design and installation.

Plant beds shall achieve 75% live ground cover at maturity.

SFB Gravel over Filter Fabric shall be placed in all landscape areas which are not designated to receive native seed.

IRRIGATION NOTES: Irrigation shall be a complete underground system with Trees to receive (5) 1.0 GPH Drip Emitters and Shrubs to receive (2) 1.0 GPH Drip Emitters. Drip and Bubbler systems to be tied to 1/2" polypipe with flush caps

Run time per each drip valve will be approximately 15 minutes per day, to be adjusted according to the season.

at each end.

Point of connection for irrigation system is unknown at current time and will be coordinated in the field.

Irrigation will be operated by automatic controller. Location of controller to be field determined and power source for controller to be provided by others.

Irrigation maintenance shall be the responsibility of the Property Owner.

LANDSCAPE CALCULATIONS

NET LANDSCAPE AREA

N Company of the Comp			
TOTAL LOT AREA	75156	square	fee
TOTAL BUILDINGS AREA	12618	square	fee
OFFSITE AREA	1639	square	fee
NET LOT AREA	60899	square	fee
LANDSCAPE REQUIREMENT	15%		
TOTAL LANDSCAPE REQUIREMENT	9135	square	fee
TOTAL LANDSCAPE PROVIDED	13120	square	fee
TOTAL GROUNDCOVER REQUIREMENT	9840	square	fee
TOTAL GROUNDCOVER PROVIDED	10165	square	fee
TOTAL BED PROVIDED	13120	square	fee
TOTAL SOD PROVIDED	0	square	fee
TOTAL NATIVE SEED PROVIDED	0	square	fee

PLANT LEGEND



ASH (H) AND HONEY LOCUST (H) 13 Fraxinus pennsylvanica Gleditsia triacanthos 2" Cal.

AUSTRIAN PINE (M) 5

Pinus nigra 6-8' FLOWERING PEAR (H) 8

Pyrus calleryana 2" Cal.

MUGO PINE (M) 1

WASHINGTON HAWTHORN (H) 2 Crataegus phaenopyrum 15 Gal.

APACHE PLUME (L) 6

BLUE MIST SPIREA (M) 3 Caryopteris clandonensis 5 Gal.

LANAS/SCOTCH BROOM (M) 13 Cytisus scoparius/ Genista hispanica 5 Gal.

RED YUCCA (L) 25 Hesperaloe parviflora 5 Gal.

MAIDENGRASS (M) 32 Miscanthus sinensis 5 Gal. 16sf

INDIAN HAWTHORN (M) 15 Raphiolepis indica

RUSSIAN SAGE (M) 21 Perovskia atriplicifolia 5 Gal.

AUTUMN SAGE (M) 18 Salvia greggii 2 Gal. 9sf

HONEYSUCKLE (M) 16 Lonicera sempervirens 1 Gal. 200sf Unstaked—Groundcover

CHAMISA (L) 35 Chrysothamnus nauseosus 1 Gal. 25sf

WILDFLOWER 42 1 Gal.

CREEPING ROSEMARY (M) 21 Rosmarinus officianalis 2 Gal. 36sf Symbol indicated 3 plants

VINE 1 Gal. 200sf



OVERSIZED GRAVEL & 18 BOULDERS

SANTA FE BROWN WITH FILTER FABRIC




Cont. Lic. #26458 7909 Edith" N.E. Albuquerque, NM 87184 Ph. (505) 898-9690 Fax (505) 898-7737 cmd@hilltoplandscaping.com

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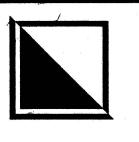


LANDSCAPE PLAN


SCALE: 1"= 30'-0"

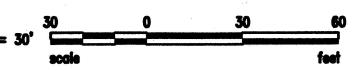

REV DATE BY REVISION 6 4 4 11-10-04 DRR REVISED SITE PLAN				,			
DATE BY	REVISION		4				
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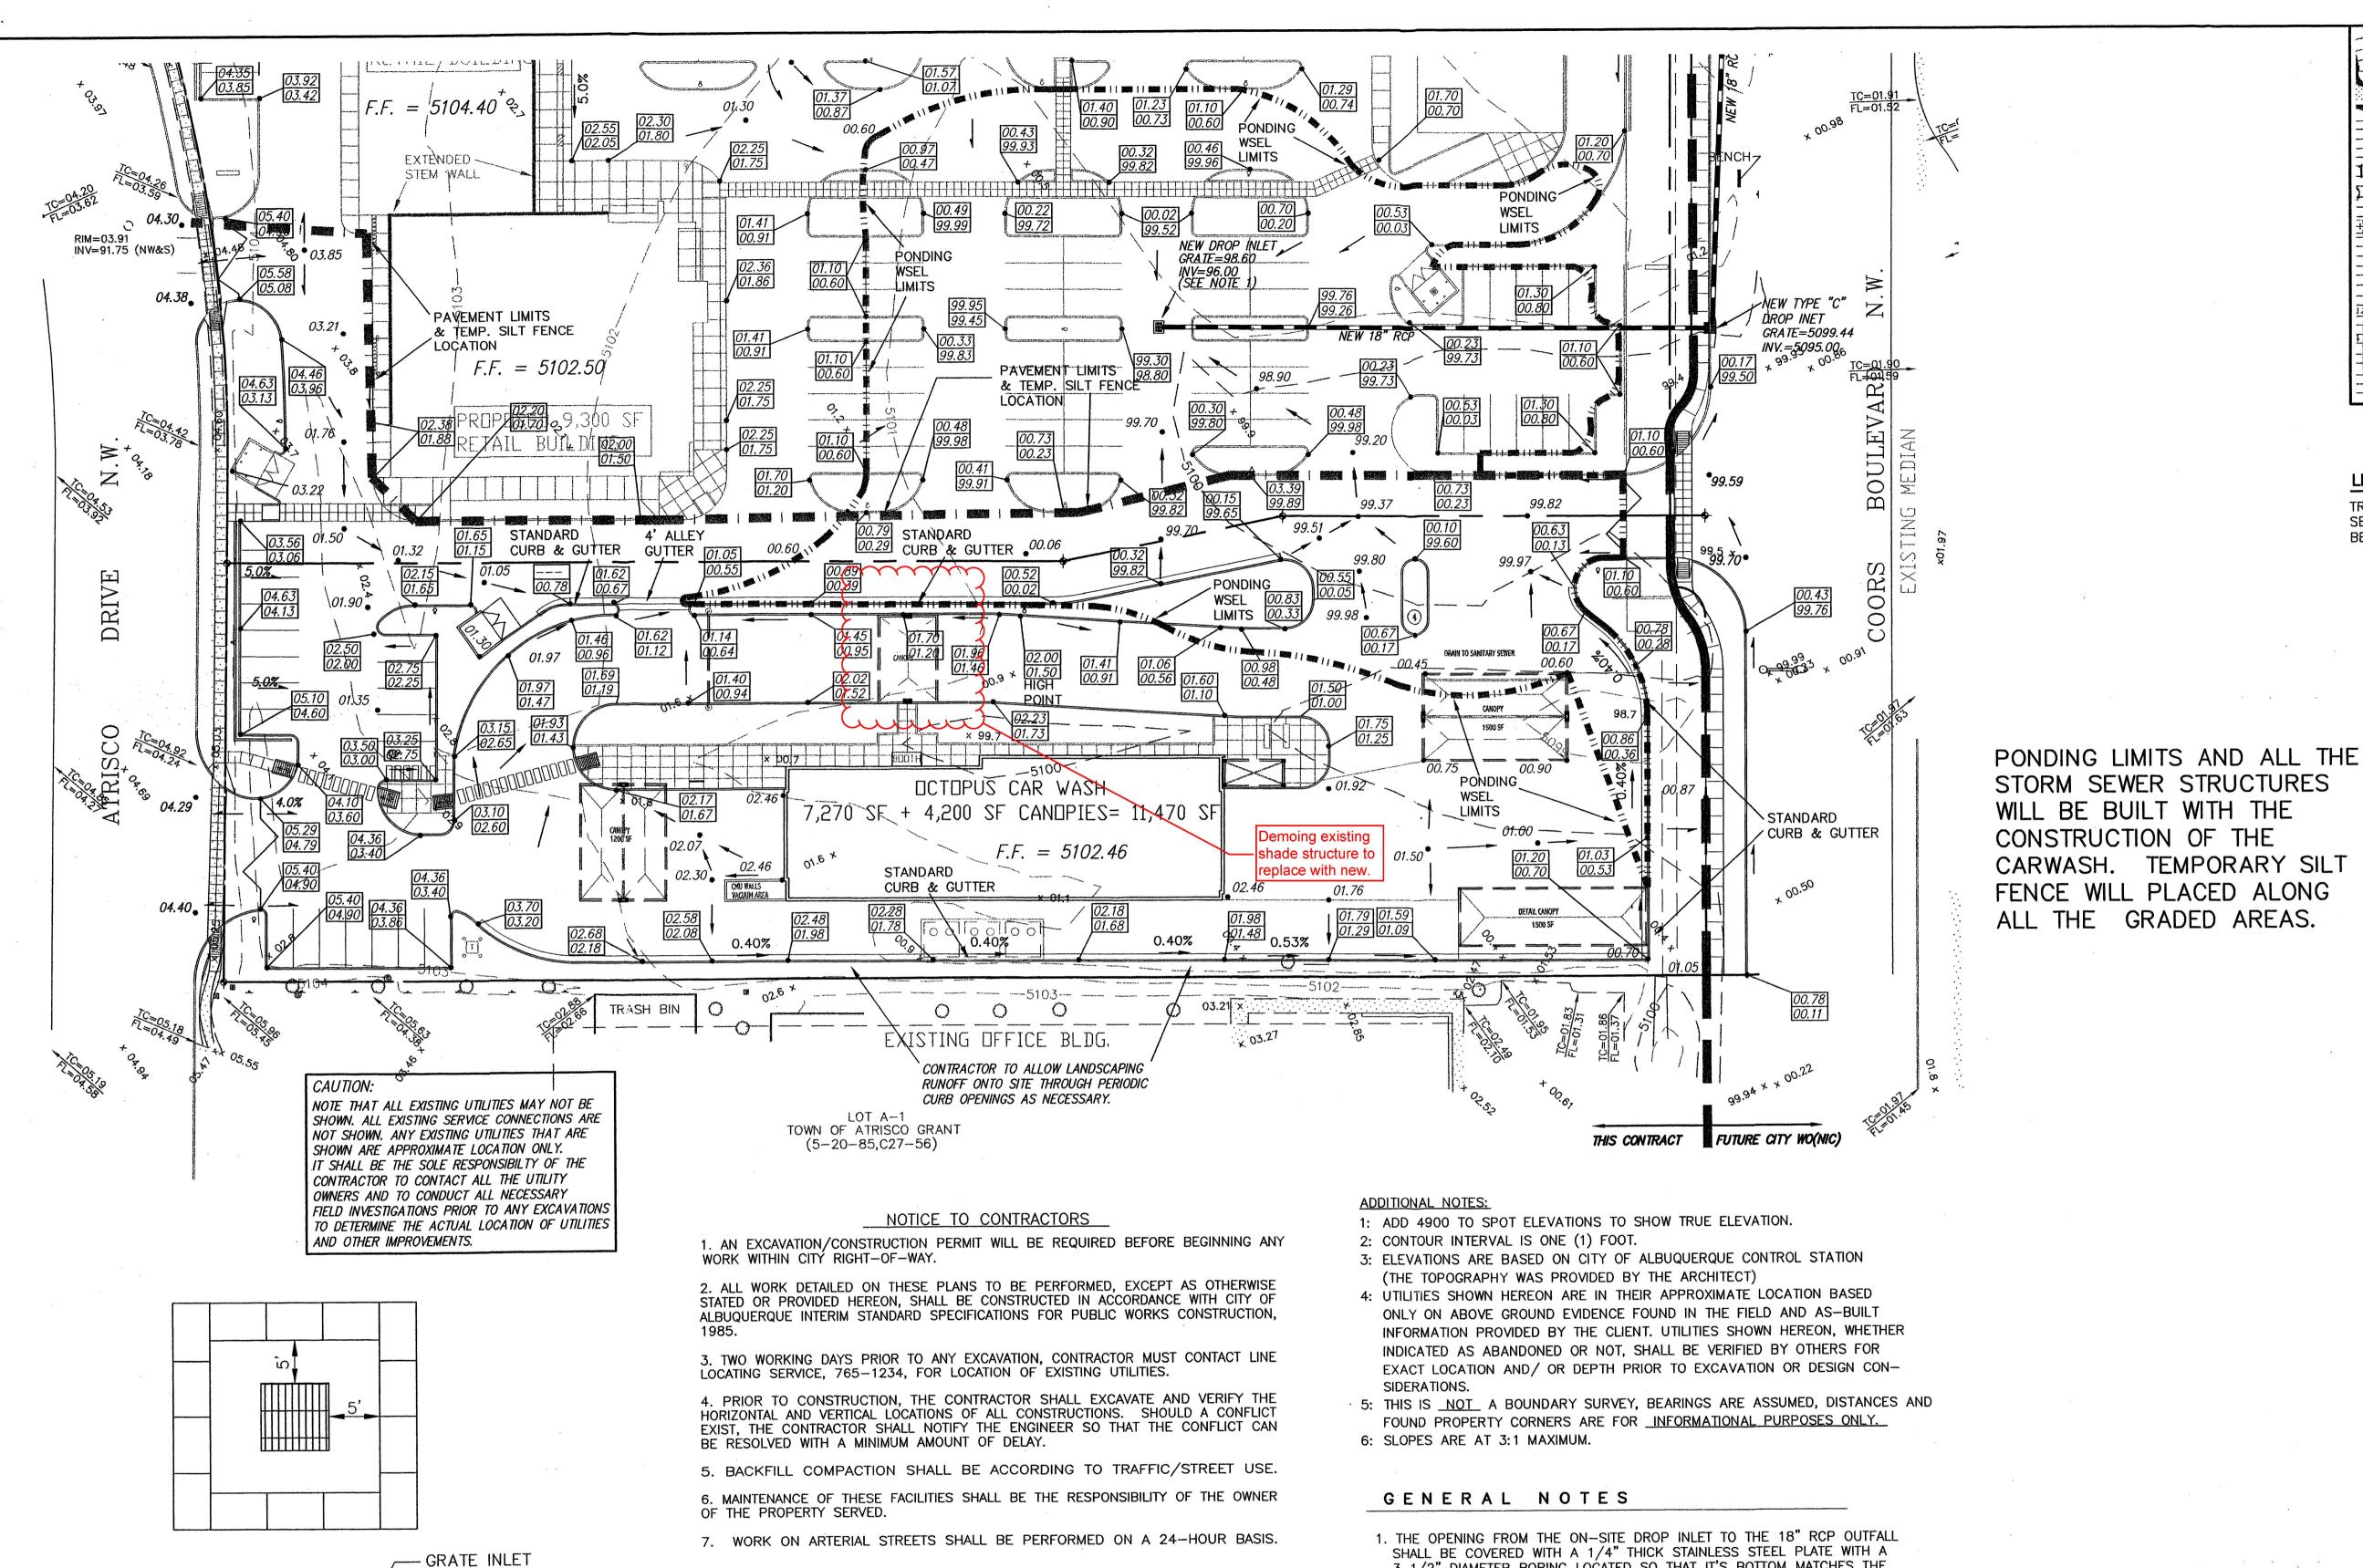


GEORGE RAINHART A 2325 SAN PEDRO N.E. ALBUQUERQUE, NEW PHONE (505) 884-9110

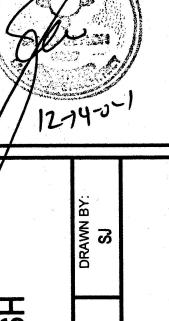

OCTOPUS CARWASH COORS BLVD. NW & REDLANDS RD. NW LBUQUERQUE, NEW MEXICO	ARWASH INDS RD. NW	
OJECT MANAGER IIKE SAFRANY	JOB NO.	DRAV
ANDSCAPE PLAN	PLAN	,

5-26-04 SCALE: **AS NOTED**



EROSION CONTROL PLAN

OF EXISTING RIGHT-OF-WAY.

RUNOFF ON SITE.

PROJECT.

AND POLLUTION PREVENTION NOTES

1. CONTRACTOR IS RESPONSIBLE FOR OBTAINING A TOPSOIL DISTURBANCE PERMIT PRIOR TO BEGINNING WORK.

3. CONTRACTOR IS RESPONSIBLE FOR MAINTAINING ALL STORM

4. REPAIR OF DAMAGED FACILITIES AND CLEAN-UP OF SEDIMENT

FACILITIES IS THE RESPONSIBILITY OF THE CONTRACTOR.

6. ALL THE DISTURBED AREAS MUST BE REVEGETATED.

ACCUMULATION ON ADJACENT PROPERTIES AND IN PUBLIC

5. ALL EXPOSED EARTH SURFACES MUST BE PROTECTED FROM WIND


AND WATER EROSION PRIOR TO FINAL ACCEPTANCE OF ANY

2. CONTRACTOR IS RESPONSIBLE FOR CLEANING ALL SEDIMENT OUT

GRAVEL BAGS

GRAVEL BAG DETAIL


- 3 1/2" DIAMETER BORING LOCATED SO THAT IT'S BOTTOM MATCHES THE FLOWLINE OF THE RCP.
- 2. THIS PROPERTY IS NOT LOCATED IN A FEMA FLOODPLAIN PER FIRM NO. 35001C0327.
- 3. THERE ARE NO SIGNIFICANT OFFSITE FLOWS ENTERING THIS SITE. EXISTING MINOR OFF-SITE FLOWS FROM THE SOUTH WILL BE ROUTED THROUGH THE SITE.
- 4. PROPERTY OWNER IS RESPONSIBLE FOR MAINTAINING DRAINAGE IMPROVEMENTS ON THE PROPERTY SO THAT THEY CONTINUE TO FUNCTION PROPERLY YEAR AFTER YEAR.
- 5. ELEVATIONS SHOWN HEREON ARE INTENDED TO BE FINAL GRADES. OWNER, ROUGH GRADING CONTRACTOR AND LANDSCAPE CONTRACTOR ARE RESPONSIBLE FOR ASSURING THAT AFTER ALL WORK IS COMPLETE, SITE'S FINAL SURFACE GRADES ARE AS SHOWN HEREON.
- 6. EARTHWORK CONTRACTOR IS RESPONSIBLE FOR OBTAINING AND FOLLOWING REQUIREMENTS OF THE SURFACE DISTURBANCE PERMIT FROM THE CITY ENVIRONMENTAL HEALTH DEPARTMENT.
- 7. OWNER AND ALL ASSOCIATED CONTRACTORS WHO ENGAGE IN ALTERATION OF SITE SURFACES, SHALL FILE A NOTICE OF INTENT WITH EPA AND FOLLOW STORM WATER POLLUTION PREVENTION PLAN REQUIREMENTS.
- 8. EXCEPT ALONG COORS BOULEVARD (CITY WO LATER), ALL NEW DRIVEWAYS SHALL BE CONSTRUCTED IN ACCORDANCE WITH CITY STANDARD DETAILS.

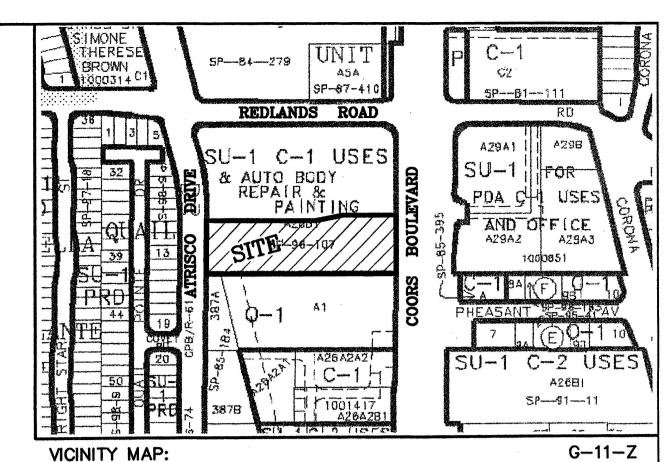


LEGAL DESCRIPTION:

TRACT 4-28-B1 AND A-28-B2. NORTHEAST UNIT. TOWN OF ATRISCO GRANT, SECTION 2 TOWNSHIP 10 NORTH. RANGE 2 EAST, NMPM CITY OF ALBUQUERQUE BERNALILLO COUNTY, NEW MEXICO.


LEGEND EXISTING SAS MANHOLE EXISTING METER EXISTING VALVE W/BOX EXISTING FIRE HYDRANT EXISTING AIR RELEASE VALVE EXISTING REDUCER ----EX. 8" SAS--- EXISTING SANITARY SEWER LINE ----EX. 16" WL--- EXISTING WATER LINE ETTTTT EXISTING CURB & GUTTER -5100---- EXISTING CONTOUR (MAJOR) 02--- EXISTING CONTOUR (MINOR) --- -- EASEMENT LIMITS OF TOP OF EXISTING SLOPE PROPOSED SIDEWALK PROPOSED GRADE PROPOSED SPOT ELEVATION X 70.28 EXISTING GRADE × 5265.16 --- - EXISTING POWER LINES ————X ————X EXISTING FENCE ----- 100YR-WSEL ----- 100-YEAR WSEL (FROM HEC-RAS OUTPUT) ------ EXISTING FENCE FEMA - FEMA - FLOODPLAIN LIMITS FROM FEMA MAP EXISTING GARDEN WALL PROPOSED RETAINING WALL PROPOSED EXTENDED STEM WALL TOP OF RETAINING WALL TOP OF FOOTING TOP OF EXTENDED STEM WALL TOP OF FOOTING PAVEMENT LIMITS & TEMP. SILT FENCE LOCATION

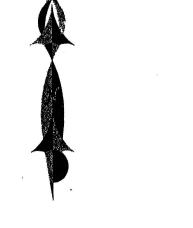

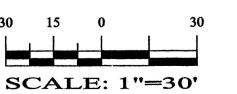

LAST REVISION: 11-12-2004



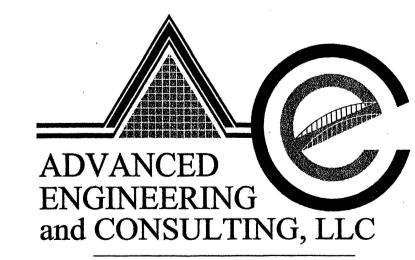

SHAHAB BIAZAR P.E. #13479

200426-GR.DWG

4416 ANAHEIM AVE., NE ALBUQUERQUE, NEW MEXICO 87113

OCTOPUS CAR WASH GRADING AND DRAINAGE PLAN DRAWING: DRAWN BY: DATE: SHEET#

04-28-2004

PONDING WSEL LIMITS

GRAPHIC SCALE 30 15 0

STORM SEWER STRUCTURES

CARWASH. TEMPORARY SILT


FENCE WILL PLACED ALONG


ALL THE GRADED AREAS.


WILL BE BUILT WITH THE

CONSTRUCTION OF THE

ROUGH GRADING APPROVAL DATE

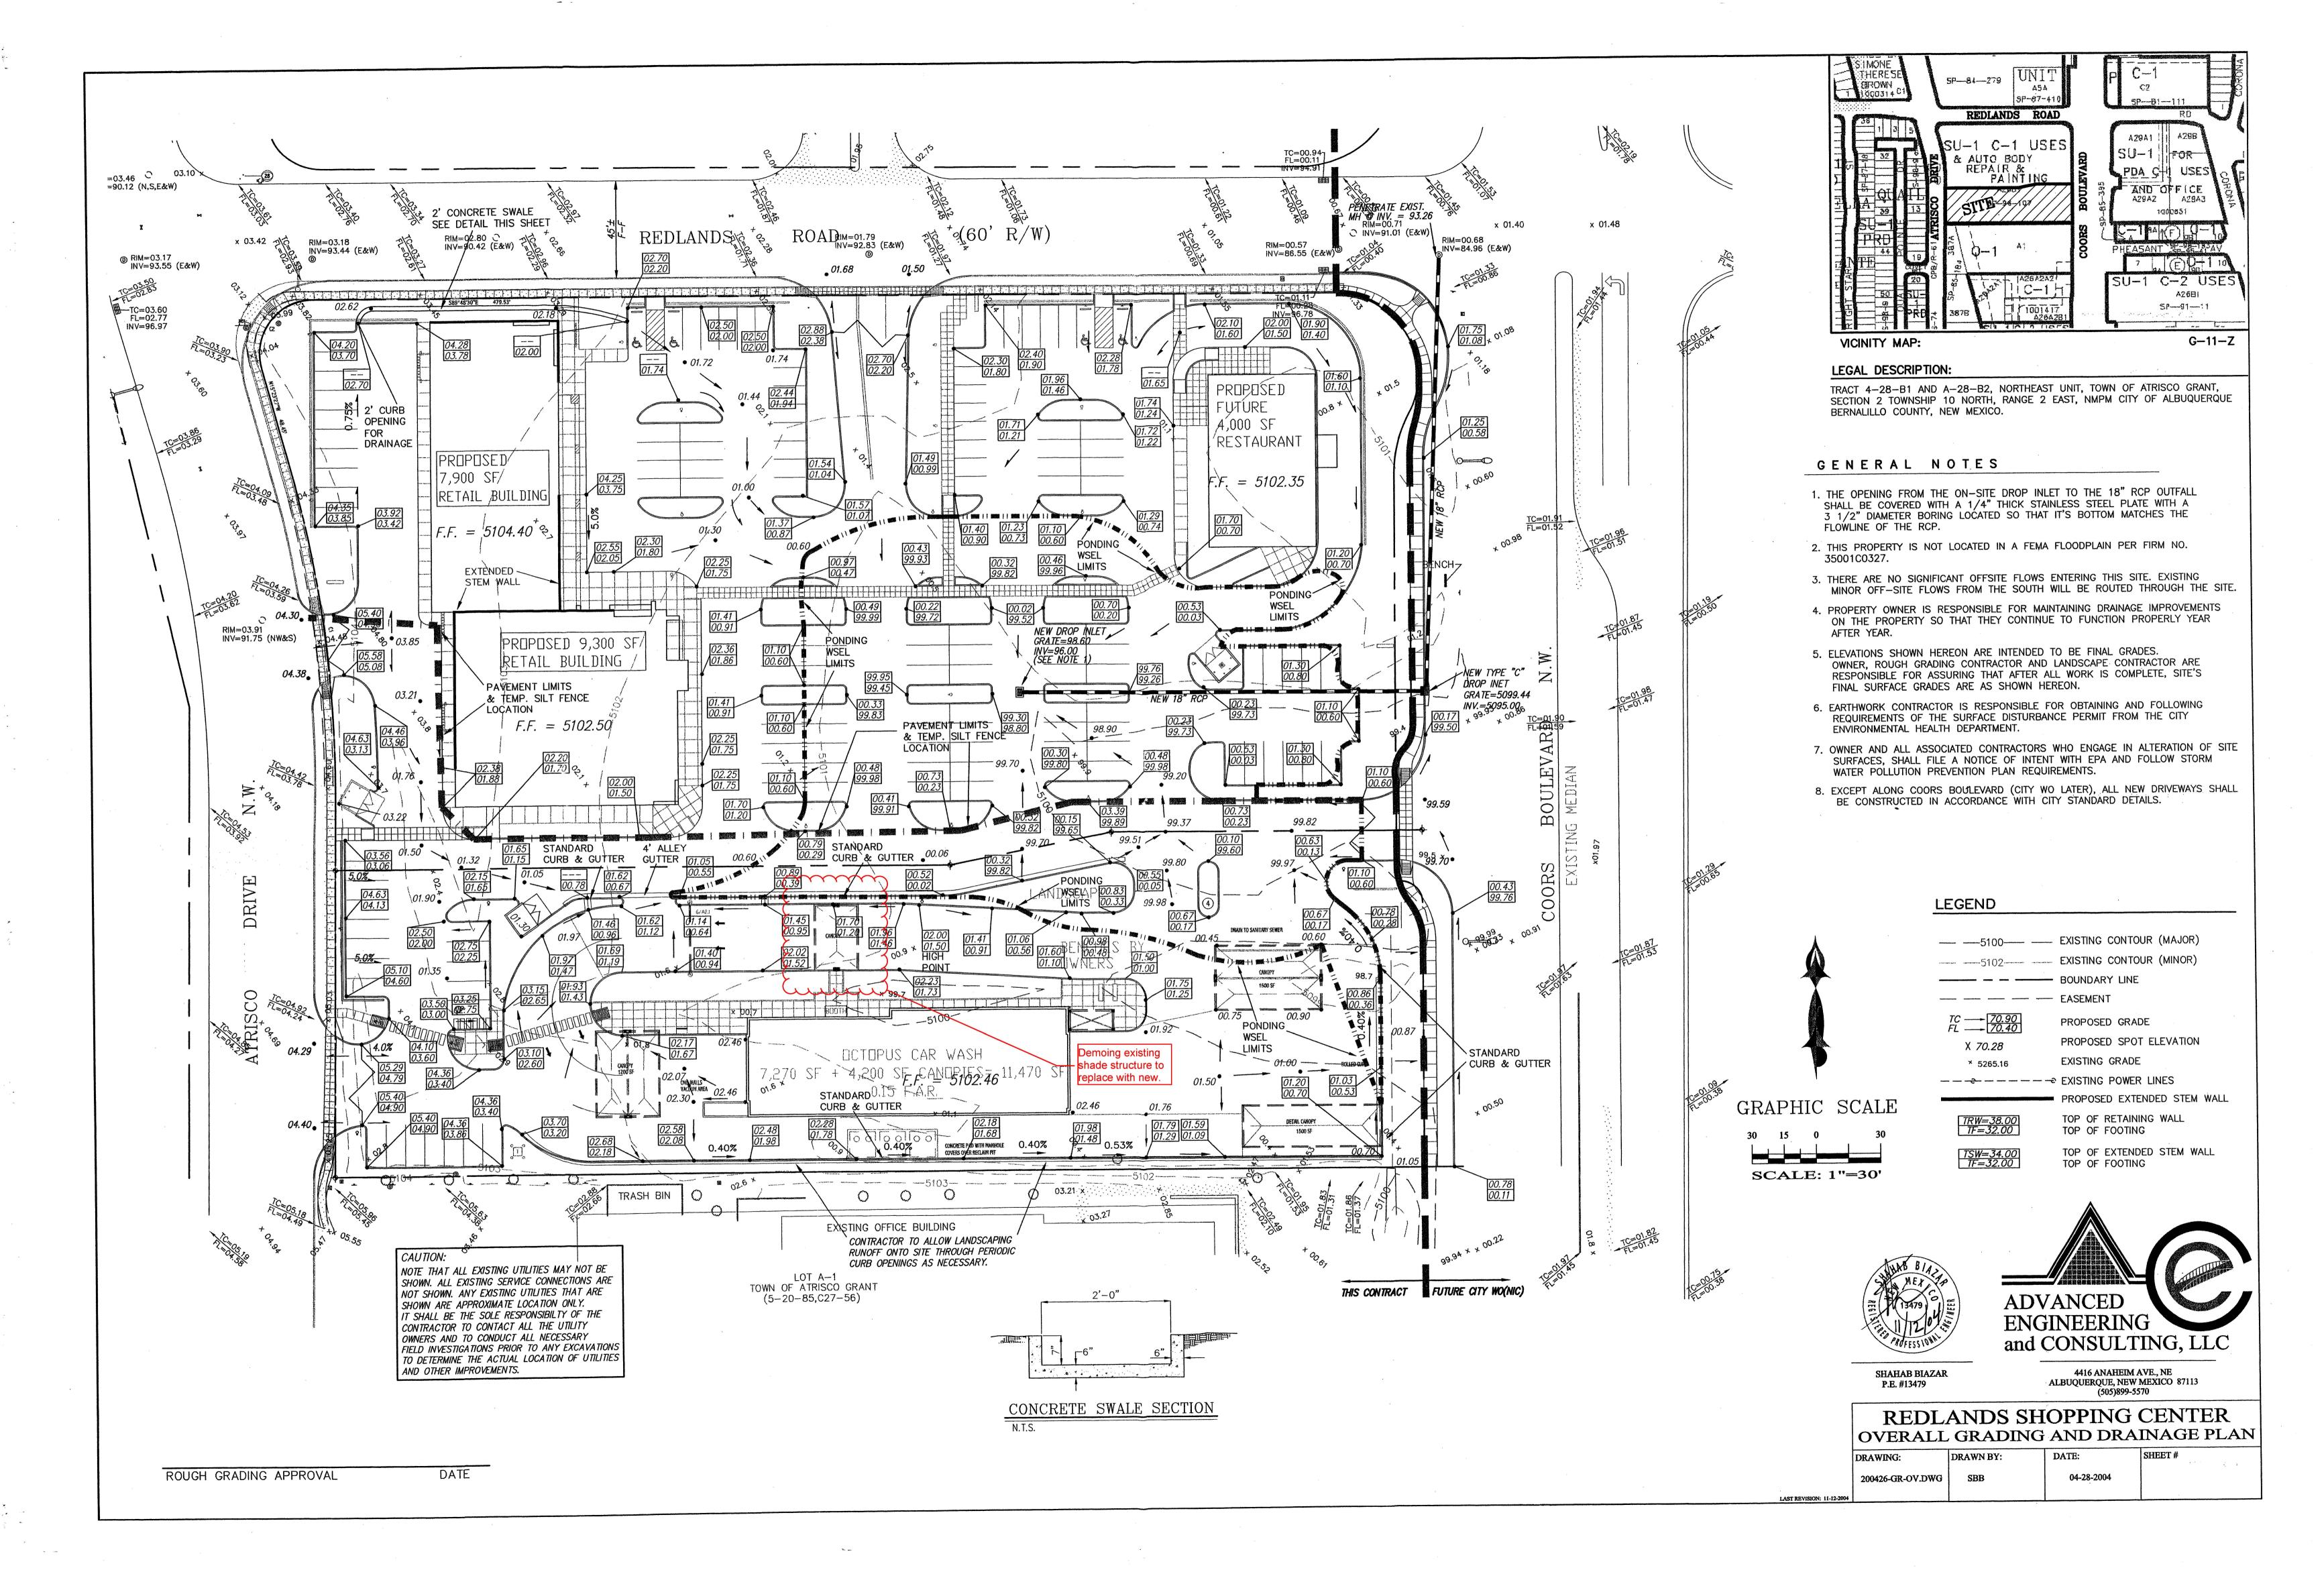

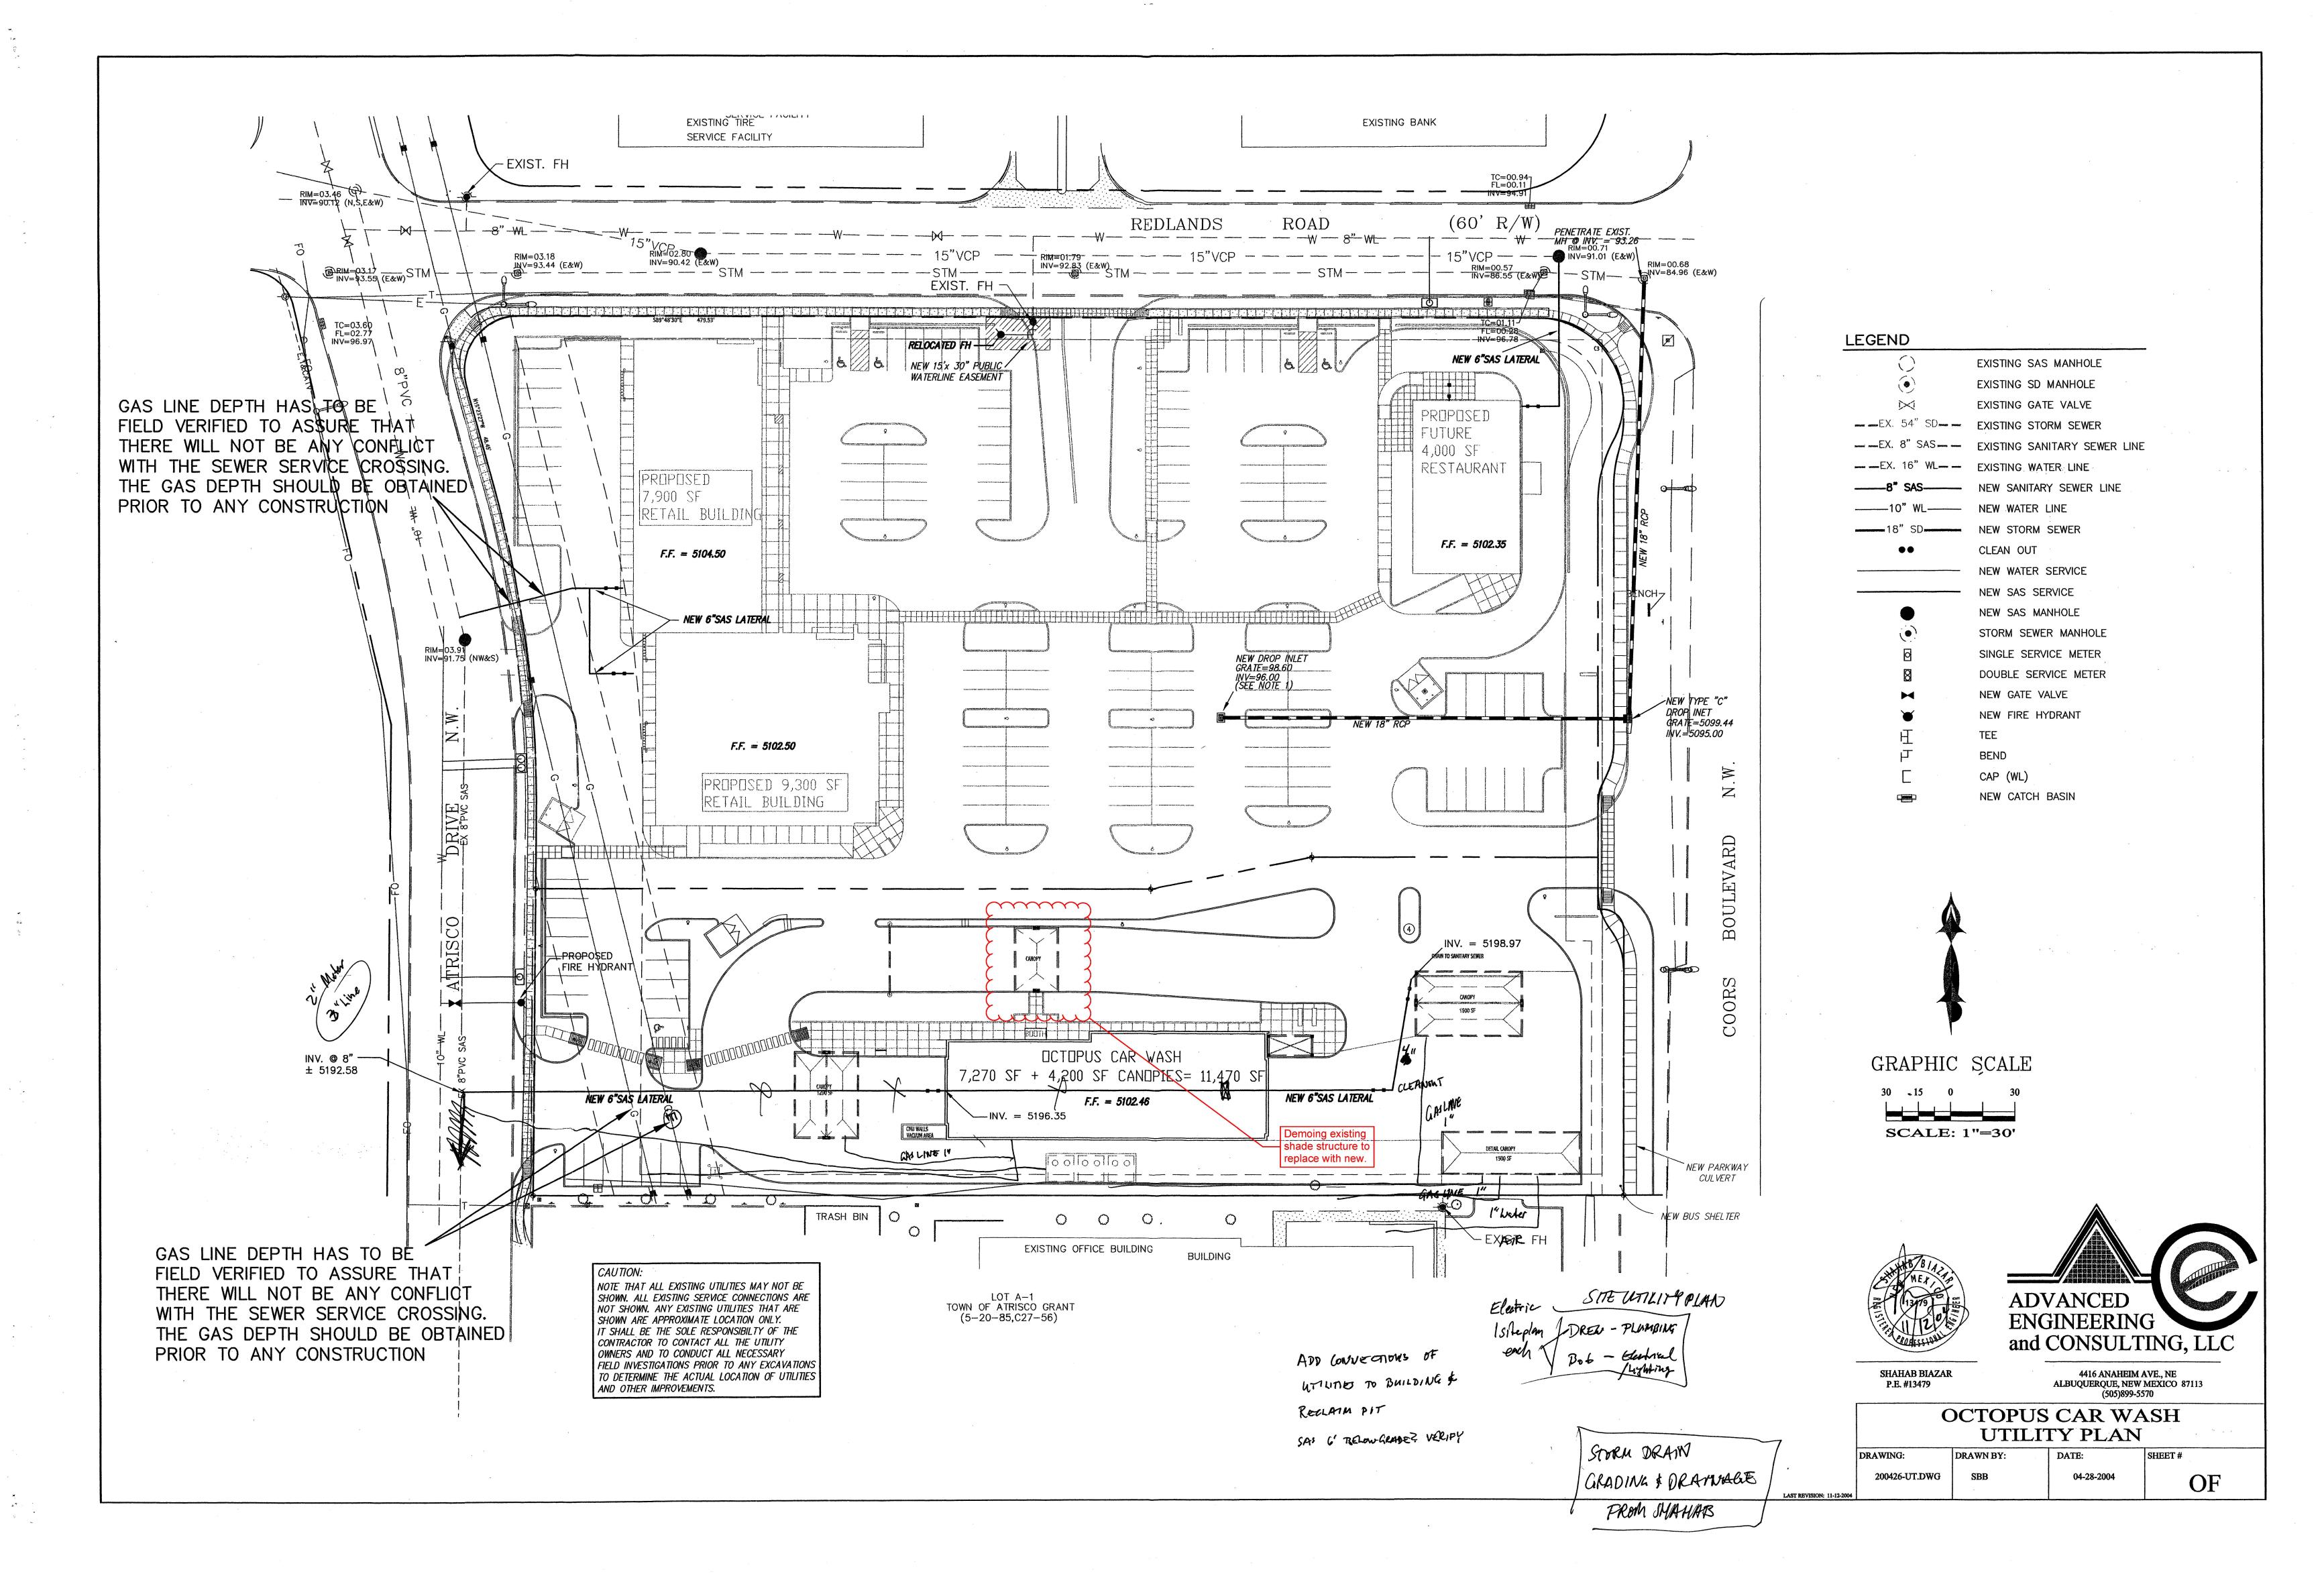

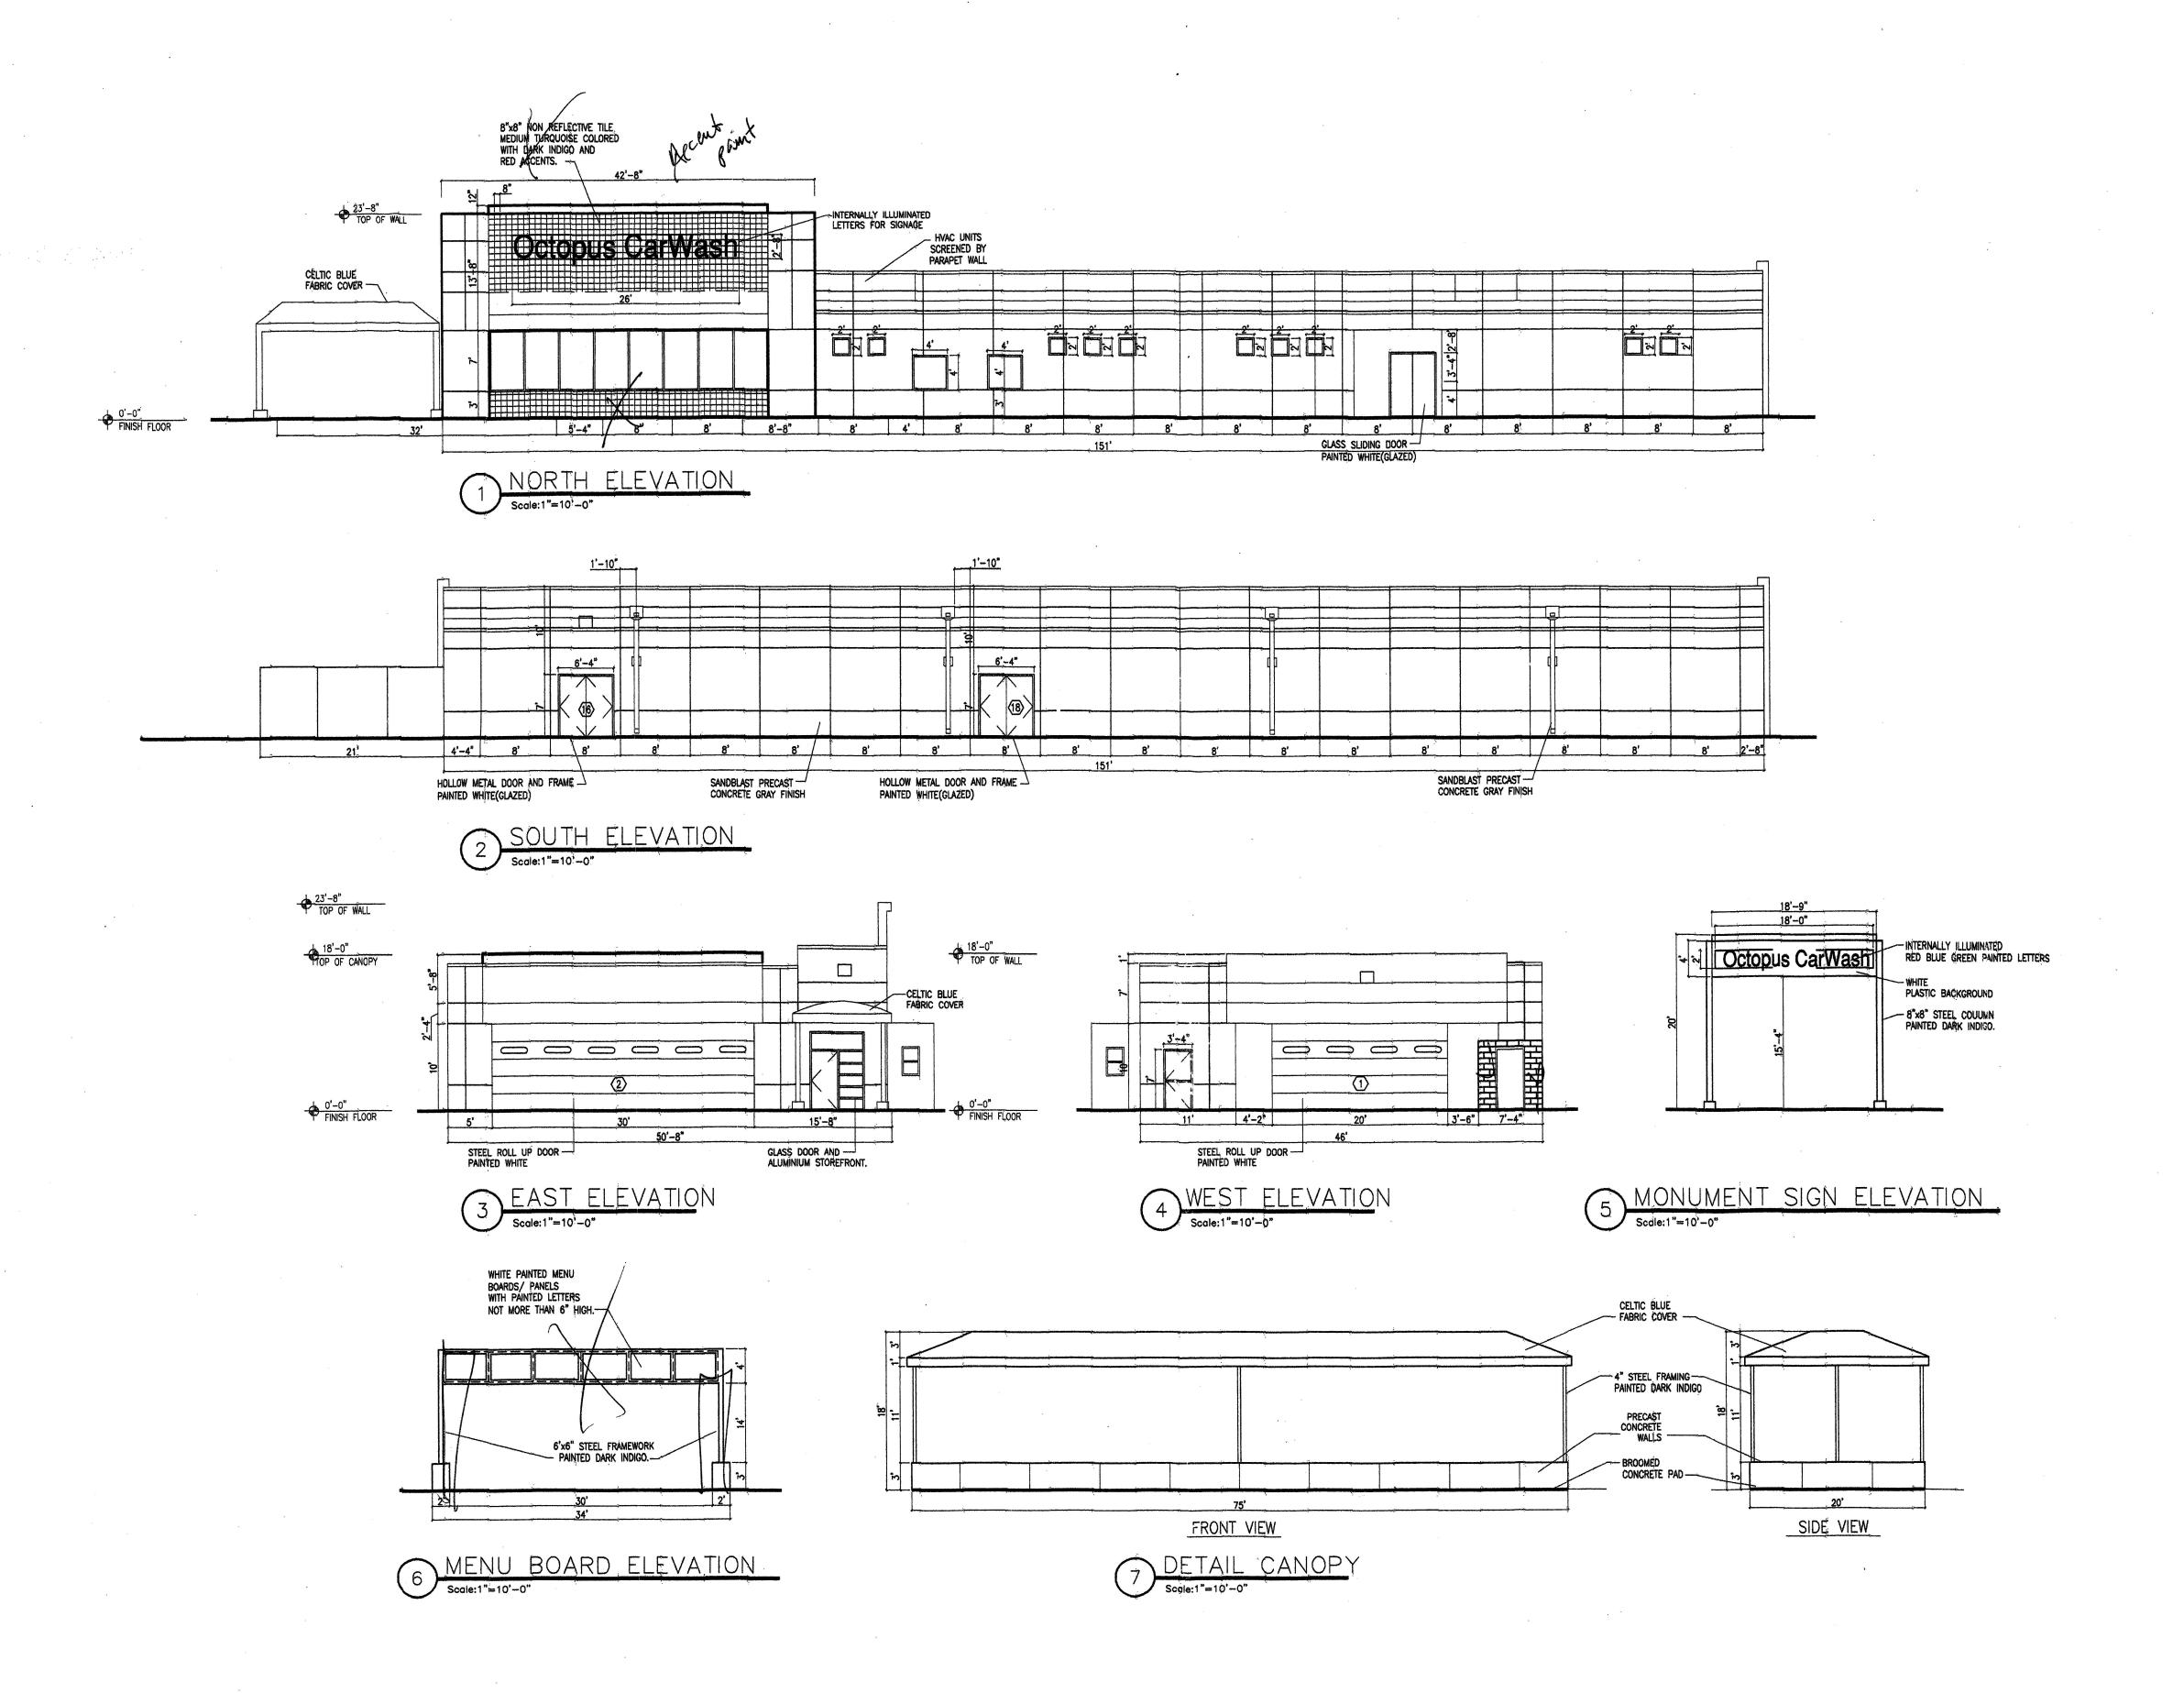





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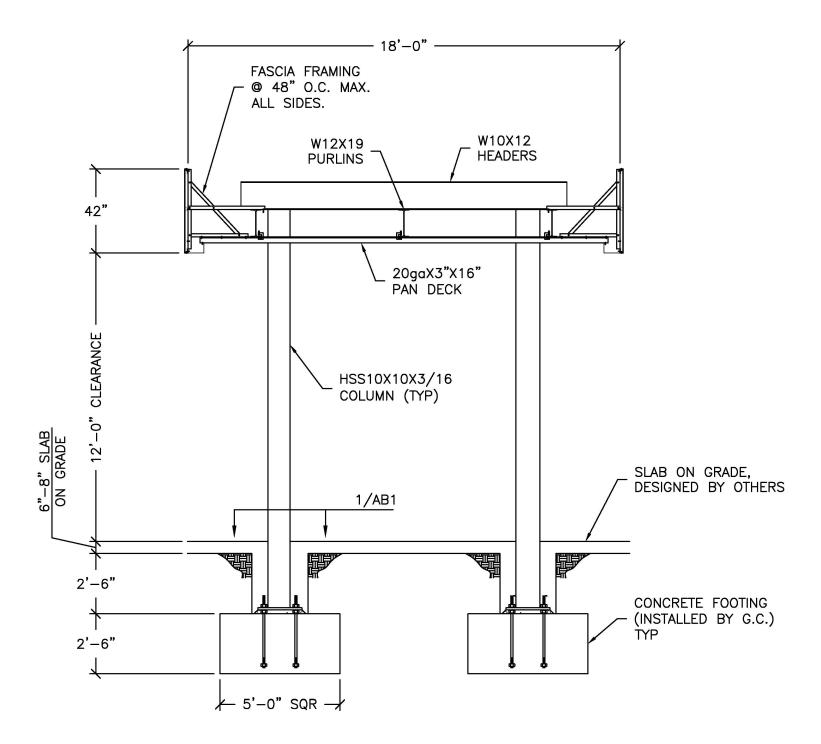
HART ARCHITECT AND ASSOCIATES PO	SUITE 2-B	8711	FAX (505) 837+0877	
GEORGE RAINHART ARCHITE	1 2325 SAN PEDRO N.E. S	ALBUQUERQUE, NEW MEXICO	HPHONE (505) 884-9110	

<u></u>	DRAWN BY: MPS	
CARWASH REDLANDS RD. NW MEXICO	JOB NO. 0418	(0
PROJECT TITLE OCTOPUS CARWASH COORS BLVD. NW & REDLANDS RD. NW ALBUQUERQUE, NEW MEXICO	PROJECT MANAGER MIKE SAFRANY	SHEET TITLE ELEVATIONS
DATE: 5-21-04	she	et- 1
SCALÉ: AS NOTED	/─\ . of	_ ,



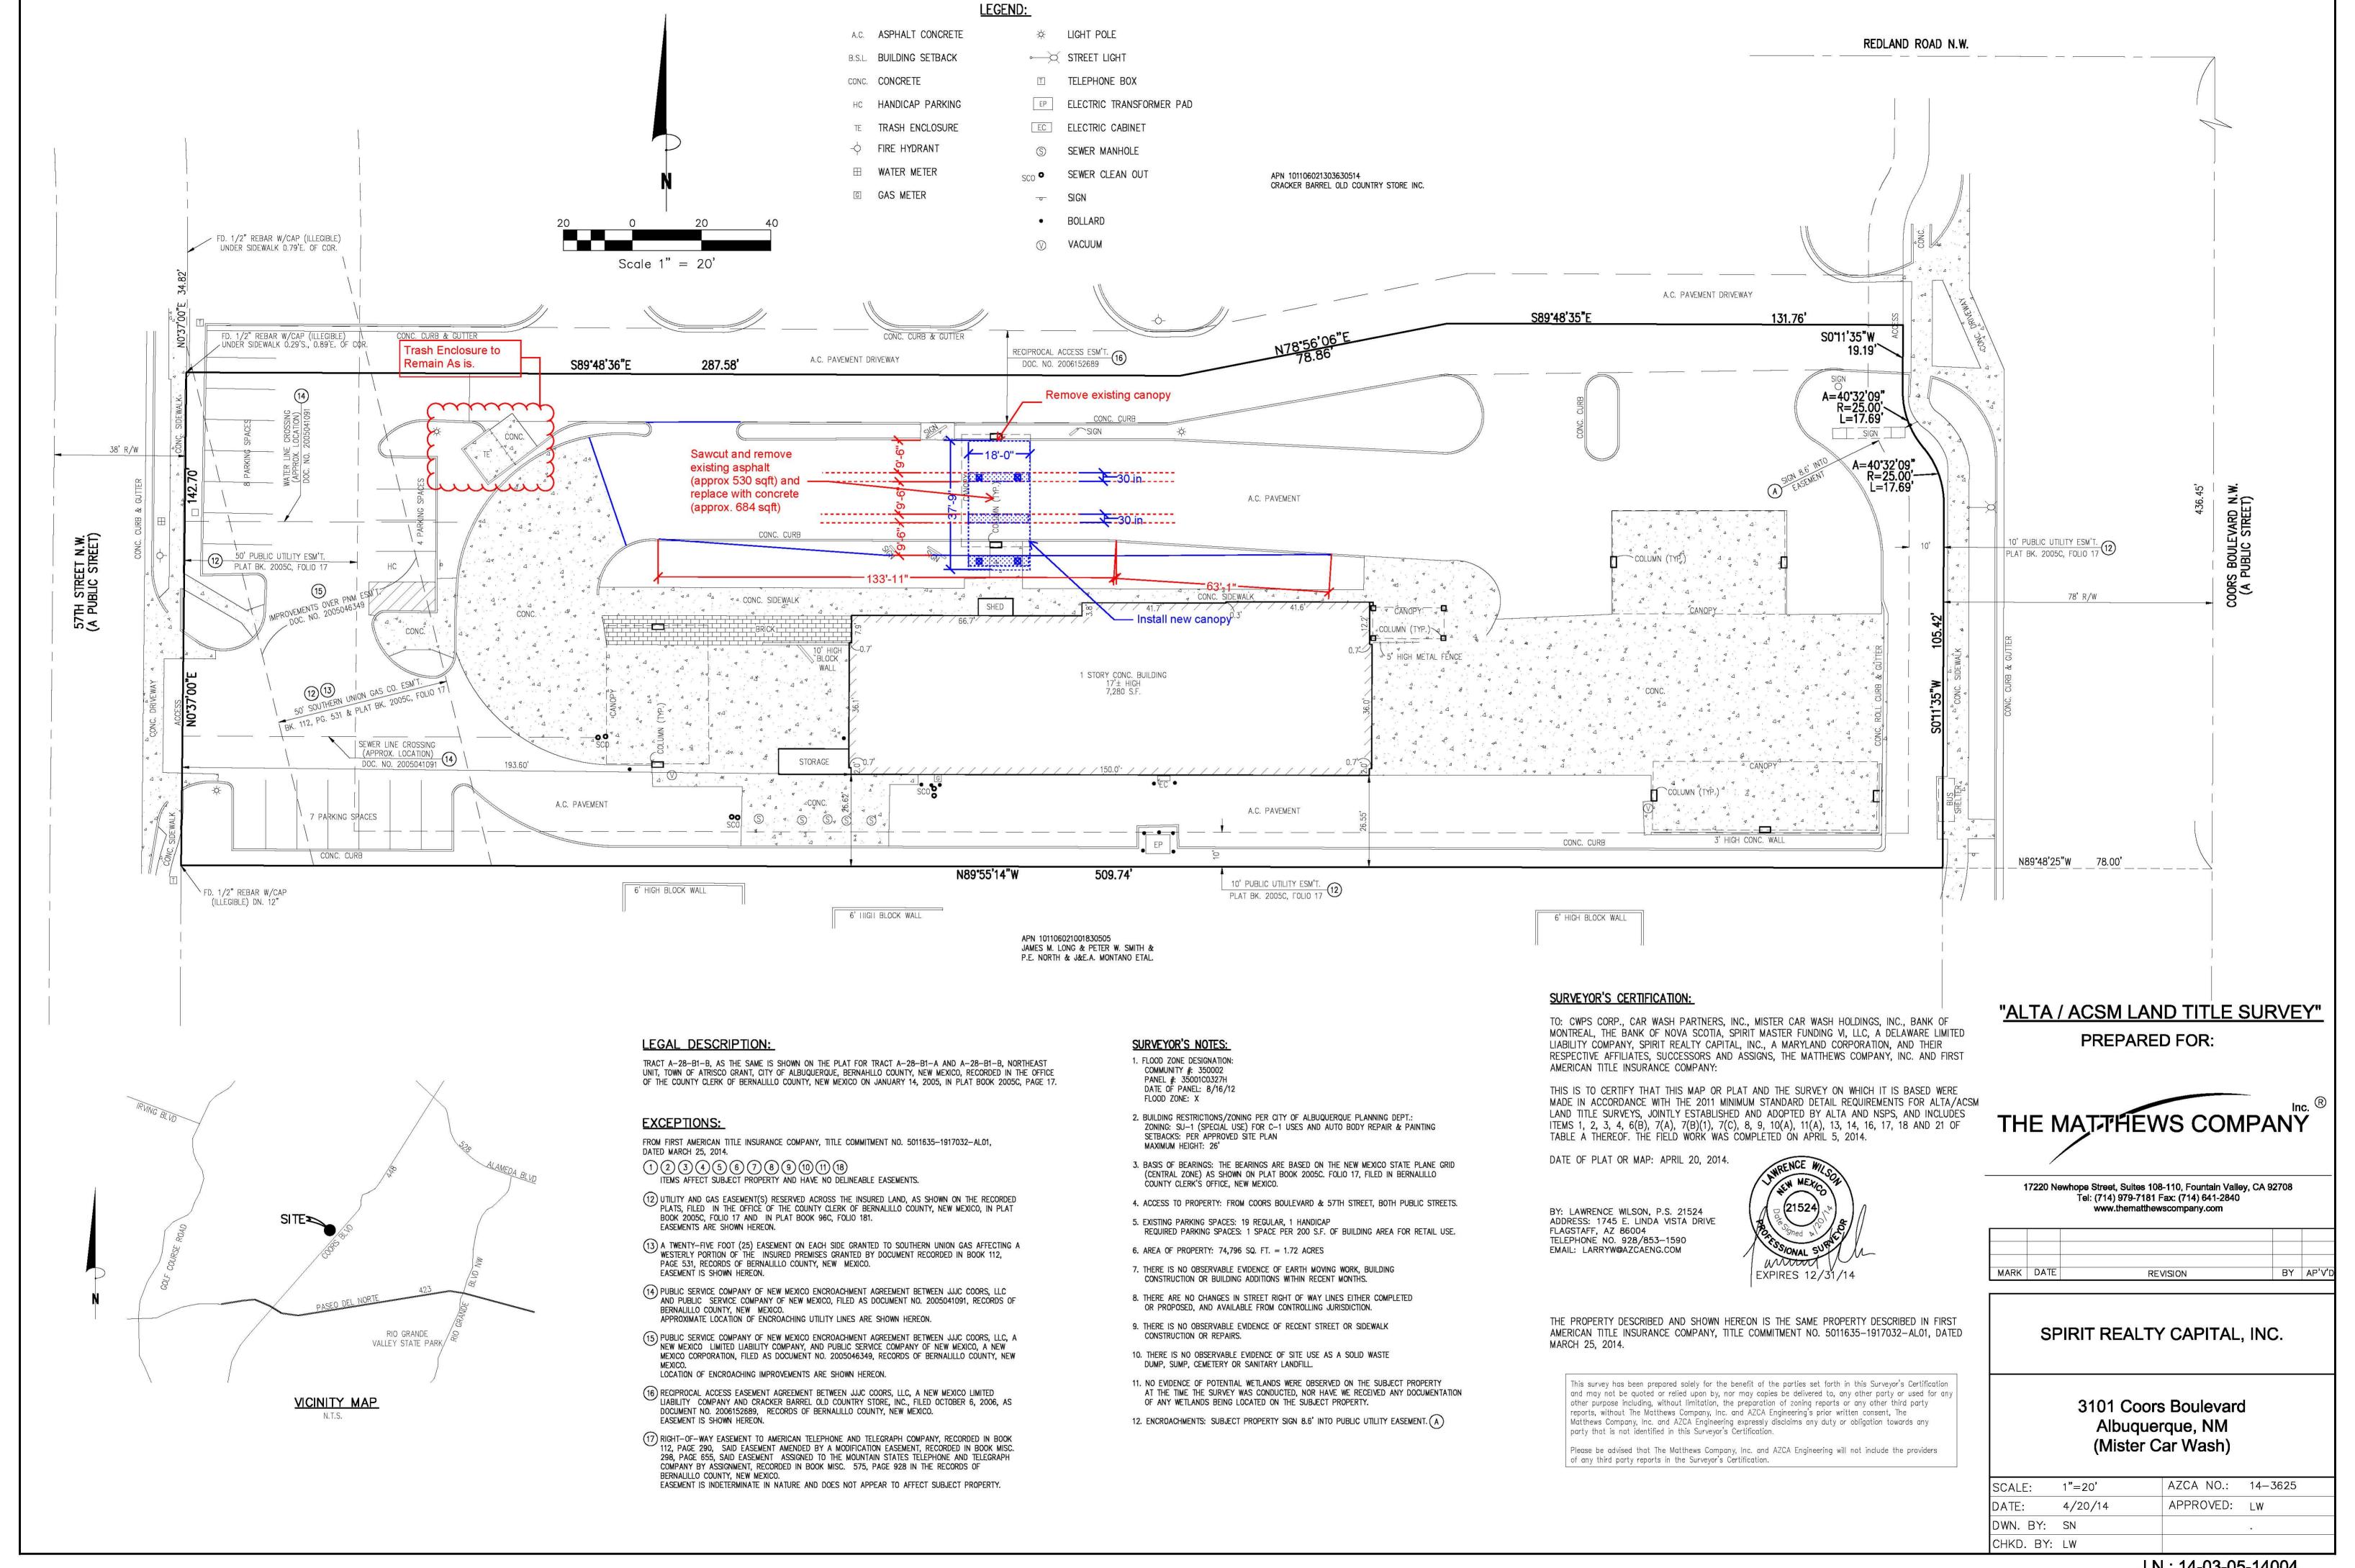

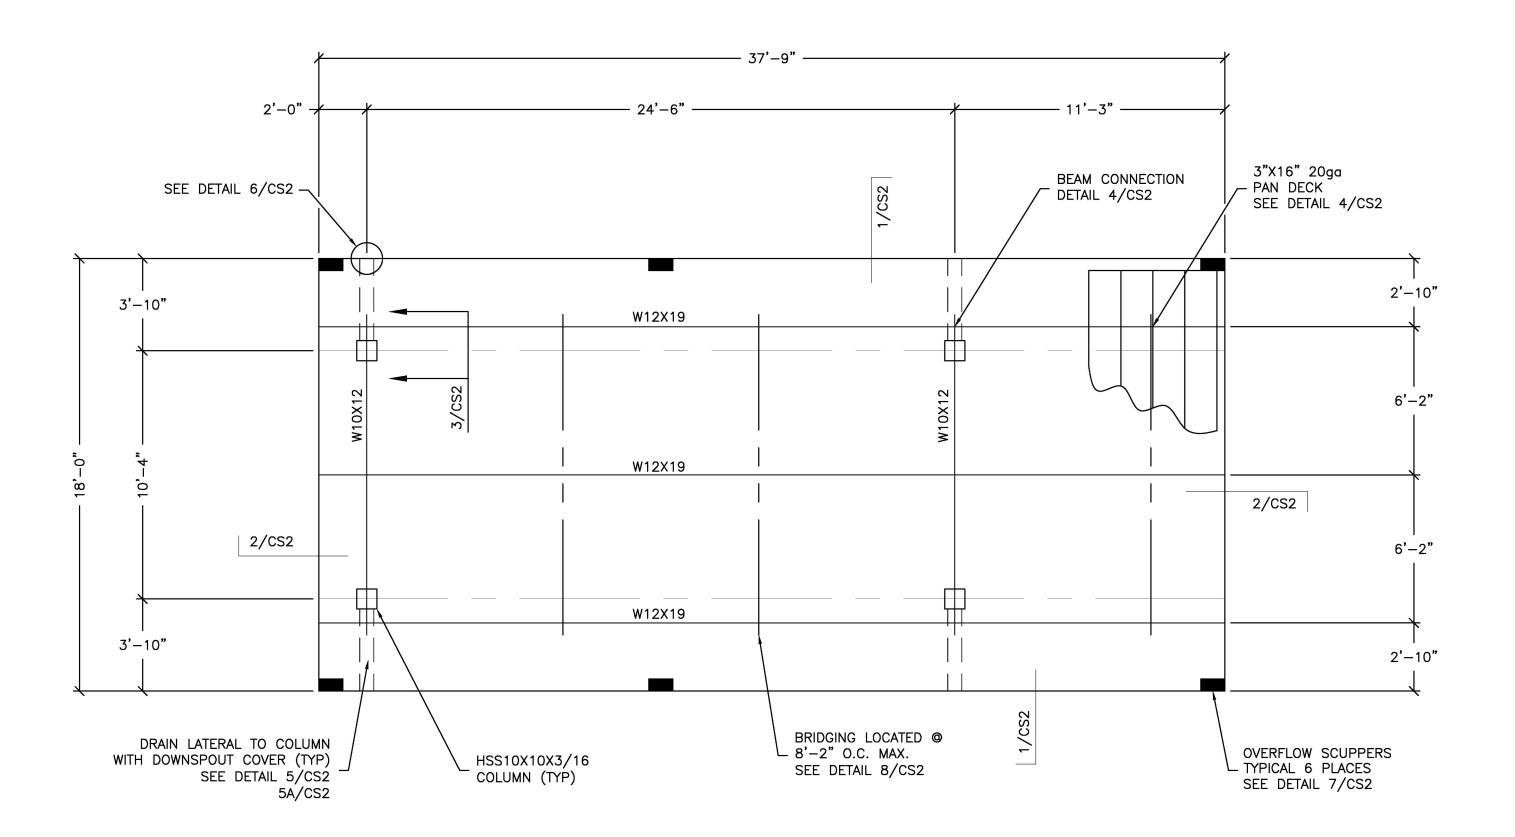FRAMING PLAN SCALE: 1/4"=1'-0"



SECTION/ELEVATION SCALE: 1/4"=1'-0"

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CANOPY NOTES GENERAL NOTES: A. THE CONTRACTOR SHALL VERIFY ALL CONDITIONS AND DIMENSIONS AT THE SITE. B. OBSERVATION VISITS TO THE SITE BY THE DESIGN ENGINEER SHALL NEITHER BE CONSTRUED AS INSPECTION NOR APPROVAL OF CONSTRUCTION. C. DURING AND AFTER CONSTRUCTION, BUILDER AND/OR OWNER SHALL KEEP LOADS ON THE STRUCTURE WITHIN LIMITS OF DESIGN LOADS. . TYPICAL DETAILS AND SECTIONS SHALL APPLY WHERE SPECIFIC DETAILS ARE NOT . BUILDING CODE: 2015 INTERNATIONAL BUILDING CODE . USE GROUP: M, CONSTRUCTION TYPE - IIB 3. DESIGN LOADS: A. ROOF LIVE LOAD: 20 PSF (REDUCIBLE) B. CANOPY DEAD LOAD: 10.79 PSF C. GROUND SNOW LOAD Pg: 10 PSF FLAT ROOF SNOW LOAD Pf: 8.4 PSF RAIN ON SNOW SURCHARGE: 5 PSF IF Pg<20 EXPOSURE FACTOR Ce: IMPORTANCE FACTOR Is: THERMAL FACTOR Ct: D. ULTIMATE DESIGN WIND SPEED Vult 115 MPH BUILDING RISK CATEGORY: **EXPOSURE:** ASCE 7-10 CHAPTER 30 COMPONENT & CLADDING: E. EARTHQUAKE DESIGN: IMPORTANCE FACTOR: Ss-0.463g Sds-0.441g S1-0.139g SITE CLASS: Sd1-0.208g SEISMIC DESIGN CATEGORY: SEISMIC FORCE RESISTING SYSTEM: G.2 STEEL ORDINARY CANTILEVERED COLUMN SYSTEM DESIGN BASE SHEAR: SEISMIC RESPONSE COEFFICIENT: Cs = 0.35 RESPONSE MODIFICATION FACTOR: R=1.25 SEISMIC ANALYSIS PROCEDURE: EQUIVALENT LATERAL FORCE

1. FOUNDATION DESIGN: ALLOWABLE BEARING PRESSURE: 1500 PSF LATERAL PRESSURE: 100 PSF/FT OF DEPTH NOTE GEOTECH INVESTIGATION NOT PROVIDED. VALUES ARE PRESUMPTIVE

FROM THE BUILDING CODE.

5. CONCRETE AND REINFORCEMENT:

A. CONCRETE FOOTINGS (EXPOSURE CLASSES FO, SO, WO, CO) TYPE II CEMENT COMPRESSIVE STRENGTH OF f'c = 3000 p.s.i. B. SLAB ON GRADE (BY OTHERS)

C. CONCRETE DESIGNED USING f'c =2500 p.s.i. OR ABOVE SHALL HAVE SPECIAL INSPECTIONS PERFORMED, UNLESS ISOLATED SPREAD FOOTINGS ARE UTILIZED. SEE SPECIAL INSPECTIONS FOR THE CANOPY CONCRETE D. REBAR: ASTM A615 GRADE 60

E. STIRRUPS AND TIES SHALL HAVE MINIMUM 4" HOOKS. F. MINIMUM CONCRETE PROTECTION FOR REINFORCEMENT: CONCRETE EXPOSED TO GROUND----3" FORMED CONCRETE EXPOSED TO GROUND---2"

FORMED CONCRETE NOT EXPOSED TO GROUND-1 1/2" G. GROUT UNDER COLUMN BASE PLATES SHALL BE NON-SHRINK GROUT COMPLYING WITH ASTM C1107, f'c=5000p.s.i. AND INSTALLED PER MANUFACTURERS RECOMMENDATIONS.

H. GENERAL CONTRACTOR IS RESPONSIBLE FOR LOCATING TOP OF FOOTING ELEVATIONS AS REQUIRED FOR UNDERGROUND PLUMBING AND ELECTRICAL.

6. STRUCTURAL STEEL: A. ALL STRUCTURAL STEEL SHALL COMPLY WITH AISC "SPECIFICATION FOR FOR THE DESIGN OF STRUCTURAL STEEL FOR BUILDINGS" 15TH EDITION.

B. AISC "CODE OF STANDARD PRACTICE" EXCLUDING THE FOLLOWING SECTIONS: 4.4, 4.4.1, 4.4.2, AND 7.15. C. AISC "SPECIFICATIONS FOR THE DESIGN OF COLD FORMED STRUCTURAL MEMBERS".

D. STRUCTURAL STEEL GRADES: STEEL BEAMS ASTM A992 GRADE 50 HSS SQUARE & RECTANGLES ASTM500 GRADE C Fy = 50,000 psi $F_{V} = 46,000 \text{ psi}$ HSS ROUND COLUMNS: PIPE ASTM A53 GRADE B Fy = 35,000 psiBASE PLATES, CAP PLATES AND CAP PLATE STIFFENERS ASTM A572 GRADE 50 Fy = 50,000 psi $F_V = 36,000 \text{ psi}$ ANGLES ASTM A36

E. ALL BOLTED CONNECTIONS SHALL BE ASTM A307 BOLTS UNLESS OTHERWISE SPECIFIED (NO SPECIAL INSPECTION REQUIRED). F. ALL BOLTED CONNECTIONS SHALL BE "SNUG-TIGHT", UNLESS NOTED OTHERWISE IN ACCORDANCE WITH RCSC.

SPECIAL INSPECTIONS FOR THE CANOPY

IN ADDITION TO THE REGULAR INSPECTIONS, THE FOLLOWING ITEMS, IF APPLICABLE, WILL REQUIRE SPECIAL INSPECTION IN ACCORDANCE WITH THE BUILDING CODE. JIMCO SALES AND MANUFACTURING IS AN AISC APPROVED FABRICATOR (218031061-10INIT).

G. METAL PAN DECK SHALL BE 20ga ASTM A653 GRADE 40.

 STRUCTURAL STEEL - SPECIAL INSPECTION REQUIRED IN ACCORDANCE WITH THE QUALITY ASSURANCE INSPECTION REQUIREMENTS OF AISC 360 (IBC 1705.2.1).

- WELDING - SPECIAL INSPECTION IS NOT REQUIRED WHERE WELDING IS PERFORMED IN AN APPROVED FABRICATOR

SHOP AS PER IBC 1704.2.5.1 - CONCRETE - SPECIAL INSPECTION IS NOT REQURIED FOR ISOLATED SPREAD CONCRETE FOOTINGS PER IBC 1705.3

- ANCHOR BOLTS - PERIODIC SPECIAL INSPECTION OF ANCHOR BOLT INSTALLATION REQUIRED PER IBC TABLE 1705.3.

- HIGH STRENGTH BOLTS - IF REQUIRED A325 BOLTS SHALL BE PRETENSIONED USING AN ACCEPTABLE METHOD SUCH AS "TURN OF NUT" AS PER RCSC SPECIFICATION SECTION 8.2. PERIODIC SPECIAL INSPECTION REQUIRED.


SEISMIC FORCE RESISTING SYSTEM (SFRS)

- A. REFER TO AISC 341-10 SECTION A4 AND ASCE 7-10. B. DESIGNATION OF SFRS: G.2. STEEL ORDINARY CANTILEVER COLUMN SYSTEMS
- (ASCE 7-10 TABLE 12.2-1) SEE AISC 341-10 SECTION E5 (OCCS). C. R = 1.25, CS = 0.35
- D. ANALYSIS PROCEDURE = EQUIVALENT LATERAL FORCE E. MEMBERS AND CONNECTIONS THAT ARE PART OF THE SFRS: COLUMNS
 - 2. COLUMN BASE CONNECTION FOOTINGS

F. PROTECTED ZONES: N/A

- G. SEE DETAILS AND NOTE FOR CONNECTION CONFIGURATIONS, MATERIALS SPECIFICATIONS AND SIZES.
- H. WELD FILLER MATERIALS FOR WELDS PART OF THE SFRS: 1. YEILD STRENGTH - 58 KSI MIN
- 2. TENSILE STRENGTH 70 KSI MIN 3. ELONGATION – 22% MIN
- 4. CVN TOUGHNESS 20 FT-LB MIN @ 0° F SEE DETAILS AND NOTES FOR OTHER WELDING REQUIREMENTS
- J. DEMAND CRITICAL WELDS N/A K. LOWEST ANTICIPATED SERVICE TEMPERATURE - 0° F

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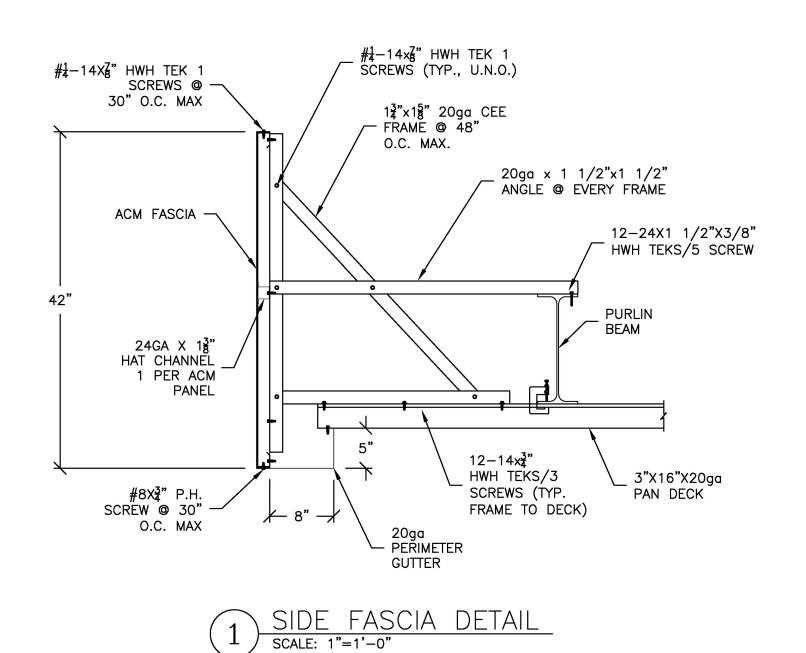


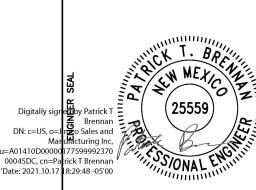
D. CYPHERS	CUSTOMER	MISTER CAR WASH		
DRAWN BY:		REVISIONS		
	NO. DESCRIPTION:		DATE:	BY:
P. BRENNAN				
CHECKED BY:				
10-14-2021				
DATE:				


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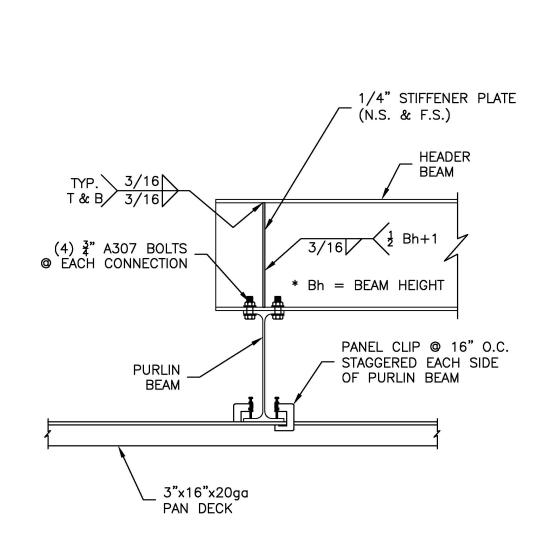
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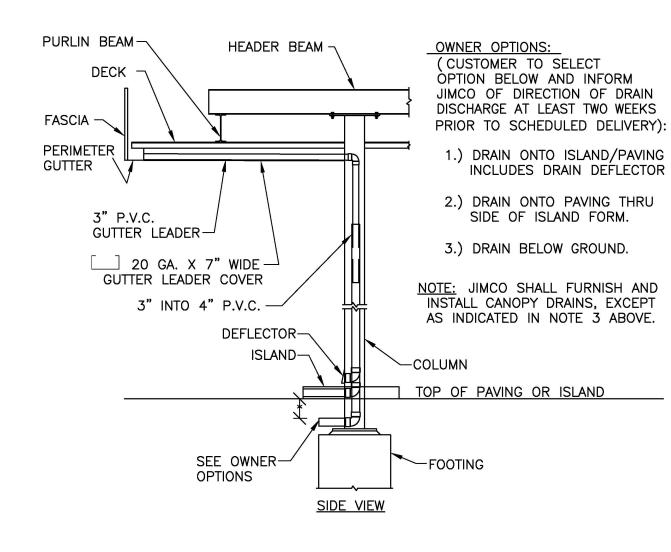
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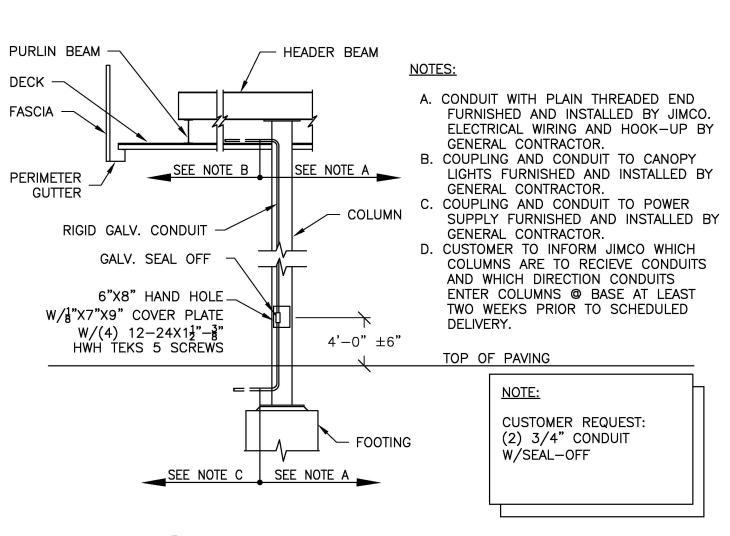








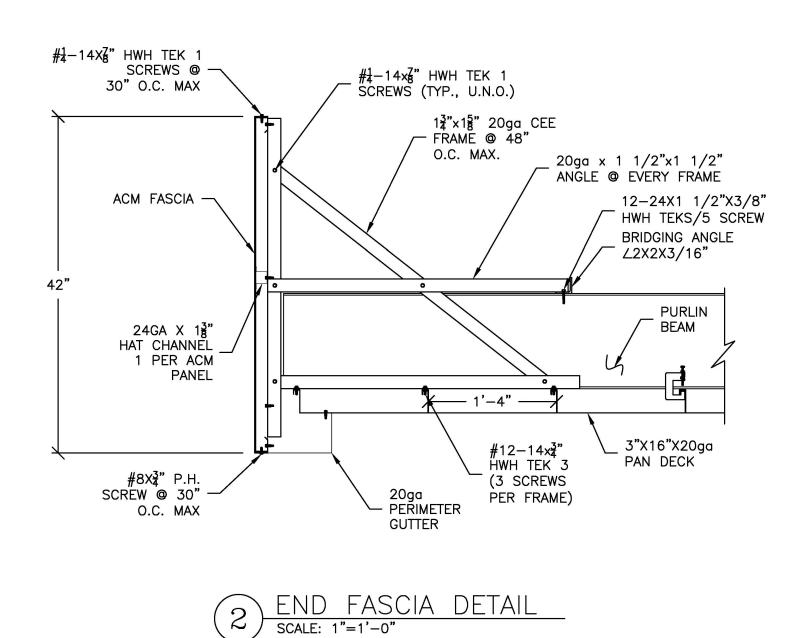

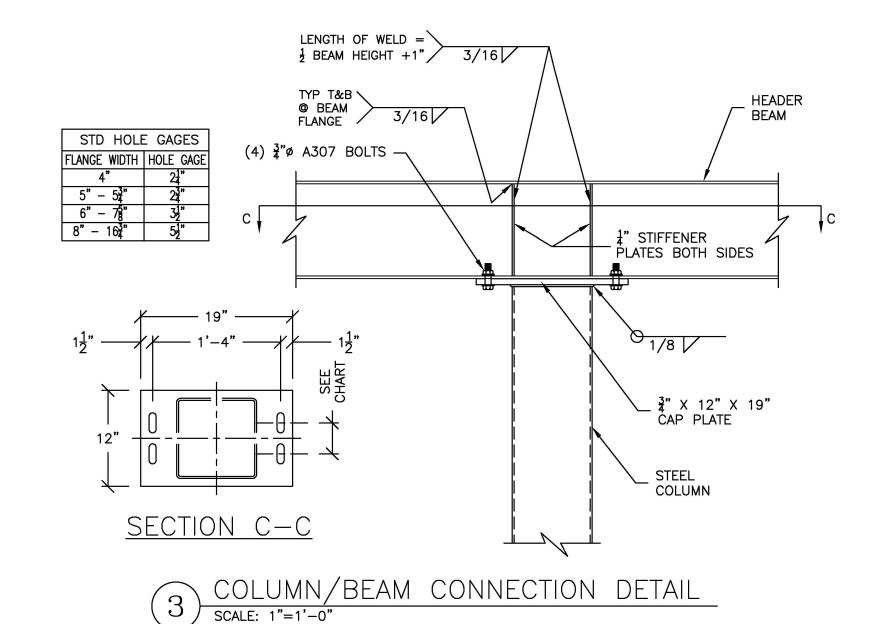








5A INTERNAL CONDUIT DETAIL

SCALE: 3"=1'-0"

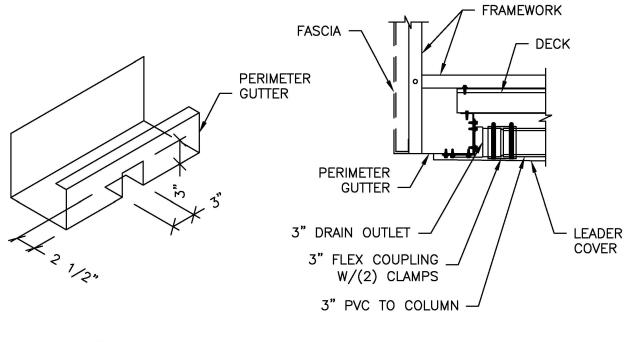

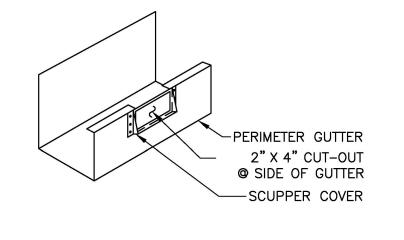

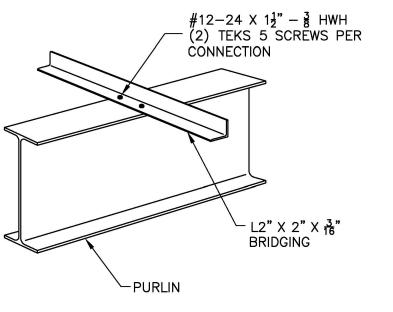

6) LEADER CONNECTION DETAIL SCALE: 1"=1'-0"

7 OVERFLOW SCUPPER DETAIL
SCALE: 1"=1'-0"

8 PURLIN BRIDGING DETAIL SCALE: 1"=1'-0"

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JOB NO.
21-2965R0

DWG. NO.

CS2


OF 3 SHEETS

ISTER 3101 ALBUC


000045DC, cn=Patrick T

'Date: 2021.10.17 18:29:5

MISTER

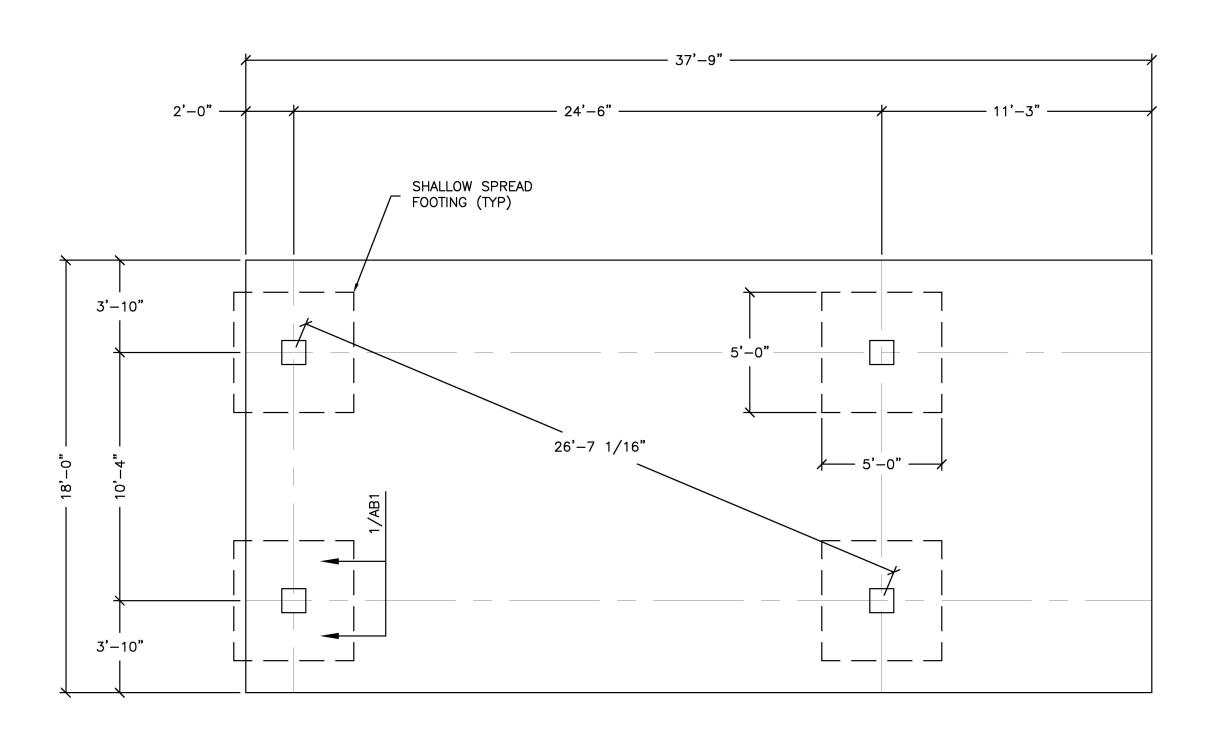

FOUNDATION PLAN SCALE: 1/4"=1'-0"

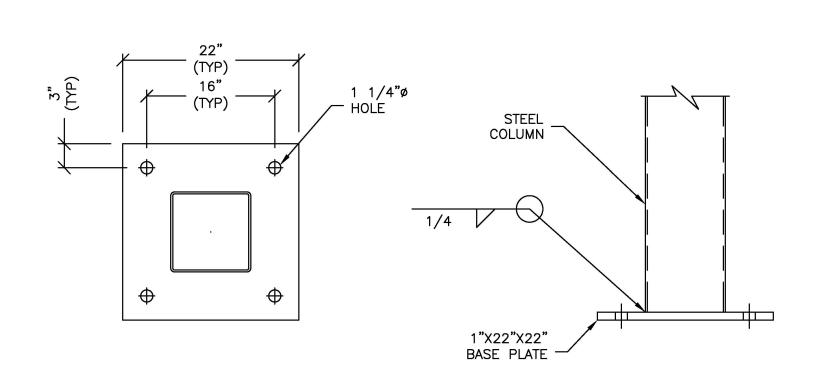


BASE PLATE DETAIL

NOTE:


A) FOOTINGS INCLUDING CONCRETE, REBAR, FORMWORK AND ASSOCIATED EARTHWORK SHALL BE FURNISHED AND INSTALLED BY GENERAL CONTRACTOR EXCEPT ANCHOR BOLTS SHALL BE FURNISHED BY JIMCO AND INSTALLED BY GENERAL CONTRACTOR.

B) SEE FOUNDATION, CONCRETE NOTES ON DWG CS1.

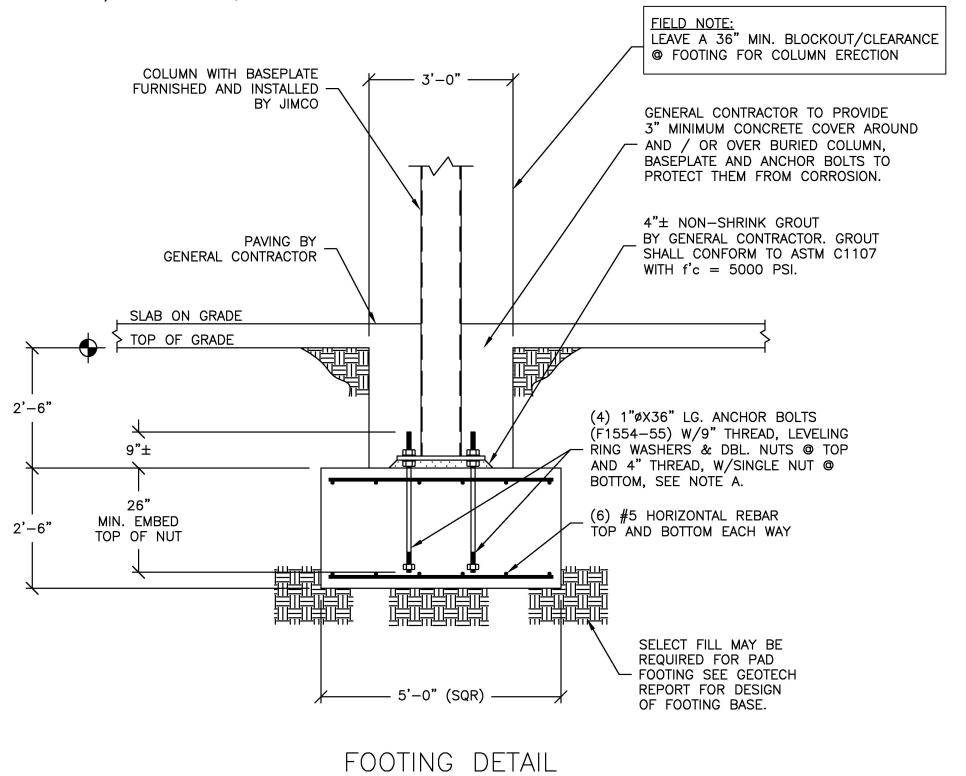

SCALE: 1/2"=1'-0"

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JOB LOCATION

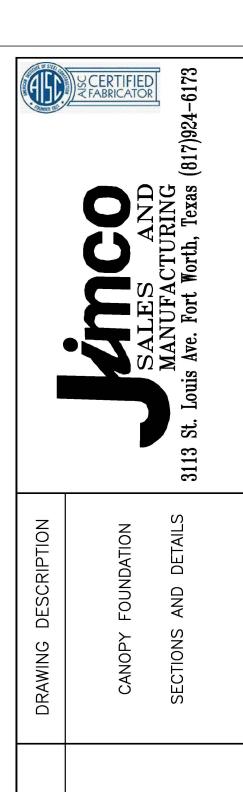MISTER CARWASH #392
3101 COORS BLVD
ALBUQUERQUE, NM

Digitally signed by Patrick T Benan DN: c=US, o=Jimco Sagand Manufacturing Inc, ou=A01410D0000017759999237000
045DC, cn=Patrick T Brennan 'Date: 2021.10.17 18:30:14 -05'00

 D. CYPHERS
 CUSTOMER
 MISTER CAR WASH

 DRAWN BY:
 NO. DESCRIPTION:
 REVISIONS

 P. BRENNAN
 Ano. DESCRIPTION:
 DATE:

 CHECKED BY:
 10-14-2021

 DATE:
 DATE:

21-2965R0

DWG. NO.

OF 3 SHEETS