

PROJECT NUMBER:	
Application Number:	
Is an Infrastructure List required? () Yes ()No If yes, then DRC plans with a work order is required for any construction wit for construction of public improvements. DFT SITE DEVELOPMENT PLAN APPROVAL:	a set of approved hin Public Right-of-Way
Traffic Engineering, Transportation Division	 Date
ABCWUA	
Parks and Recreation Department	 Date
Hydrology	 Date
Code Enforcement	 Date
* Environmental Health Department (conditional)	 Date
Solid Waste Management	 Date
Planning Department	 Date

UPTOWN CONNECT

D.F.T. SITE DEVELOPMENT PLAN SUBMITTAL

11.10.2025

	DFT SHEET LIST	
Sheet Number	Sheet Name	
SDP 1.1	SITE DEVELOPMENT PLAN	
SDP 1.2 ENLARGED SITE PLAN		
SDP 1.3	SITE DETAILS	
SDP 4.1	BLDG #2 - EXTERIOR ELEVATIONS	
SDP 4.2	BLDG #2 - EXTERIOR ELEVATIONS	
SDP 4.3	BLDG #3 - EXTERIOR ELEVATIONS	
SDP 4.4	BLDG #3 - EXTERIOR ELEVATIONS	
SDP 4.5	BLDG #4 - EXTERIOR ELEVATIONS	

OWNER AND OWNER'S CONSULTANTS

OWNER

PALINDROME COMMUNITIES 412 NW 5TH AVE, SUITE 200 PORTLAND, OR 97209 (480) 687-8966

GENERAL CONTRACTOR PACIFICAP CONSTRUCTION 615 S. FARMER AVE. SUITE 1003 TEMPE, AZ 85281 (480) 687-8966

CIVIL ENGINEER ISAACSON & ARFMAN, INC. 128 MONROE STREET NE ALBUQUERQUE, NM 87108 (505) 268-8828

MECHANICAL ENGINEER TESTUDO ENGINEERING 7007 WYOMING BLVD NE STE E1 ALBUQUERQUE, NM 87109 (505) 554-1282

MECH. SUB-CONTRACTOR INSTALLATION SERVICE HEATING & COOLING (ISHC) 7500 SECOND STREET NW ALBUQUERQUE, NM 87107 505-792-5103

ELECTRICAL ENGINEER CMTA 1331 TYLER ST NE, SUITE 201 MINNEAPOLIS, MN 55413 (612) 249-5600

> ELEC. SUB-CONTRACTOR MAGNUM ELECTRIC, INC. 471 CHRISTIANSON DR. W WEST FARGO, NC 58078 (701) 551-3240

PLUMBING ENGINEER

PLUMBING SUB-CONTRACTOR RODGERS PLUMBING & HEATING CO., INC 5105 WILLIAM ST SE. ALBUQUERQUE, NM 87105 (505) 243-9703

ARCHITECT & ARCHITECT'S CONSULTANTS

ARCHITECT DEKKER

(317) 735-3349

7601 JEFFERSON NE, SUITE 100 ALBUQUERQUE, NM 87109

(505) 761-9700 PARKING CONSULTANT

8910 PURDUE RD, SUITE 210 INDIANAPOLIS, IN 46268

LANDSCAPE ARCHITECT DEKKER 7601 JEFFERSON NE, SUITE 100 ALBUQUERQUE, NM 87109 (505) 761-9700

AQUATICS ENGINEER CONSULTANTS

POOL CONSULTANT

PO BOX 10836

(710) 730-6370

FARGO, ND 58106

STRUCTURAL ENGINEER DEKKER 7601 JEFFERSON NE, SUITE 100


ALBUQUERQUE, NM 87109 (505) 761-9700


PROJECT NO: 20-0010 ISSUE PURPOSE DFT SITE DEVELOPMENT

11/10/2025


DATE:

PLAN

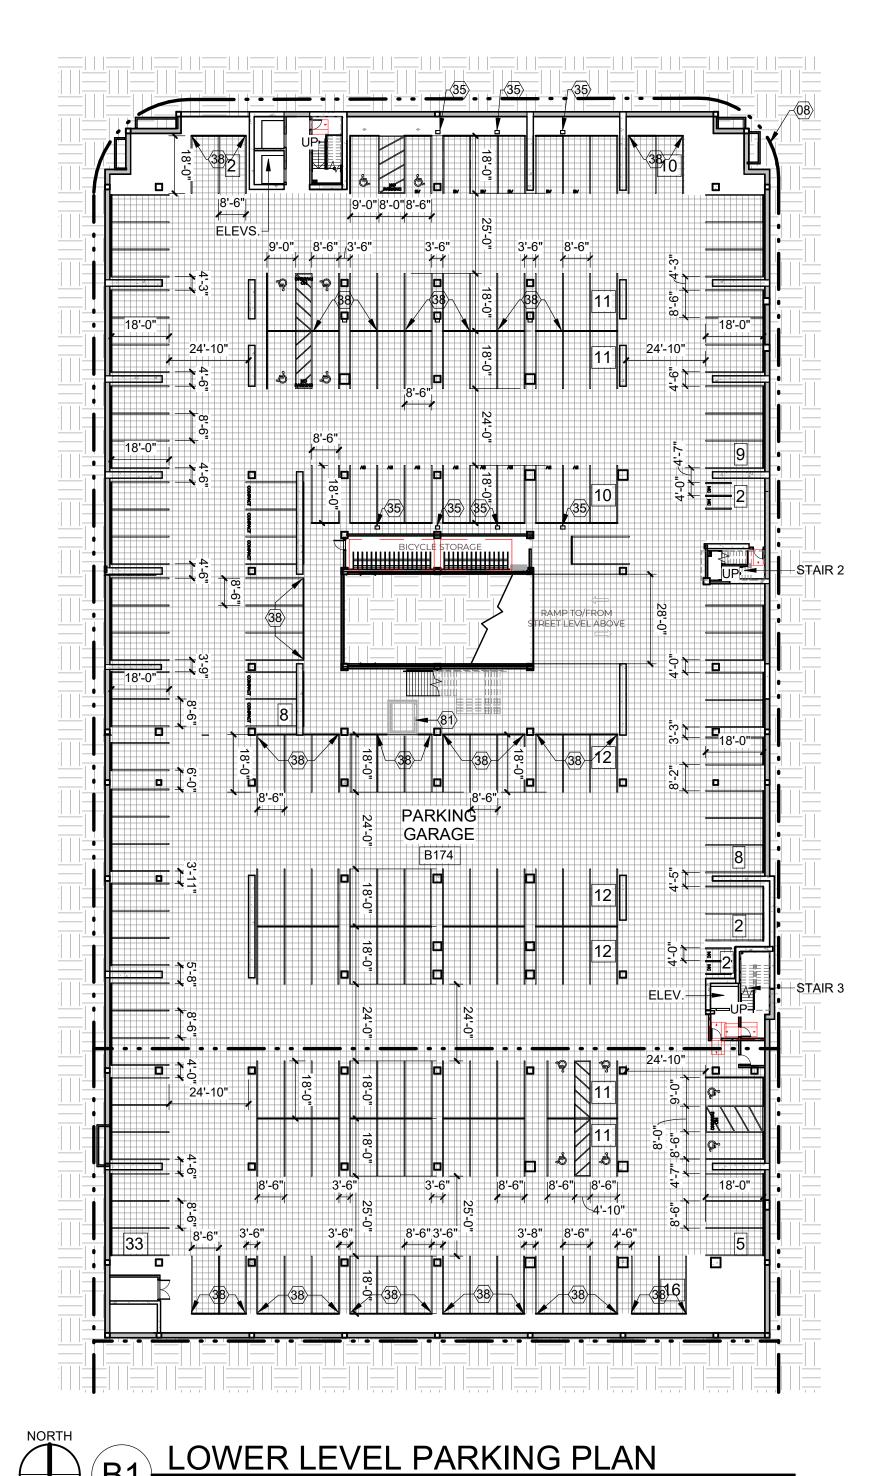

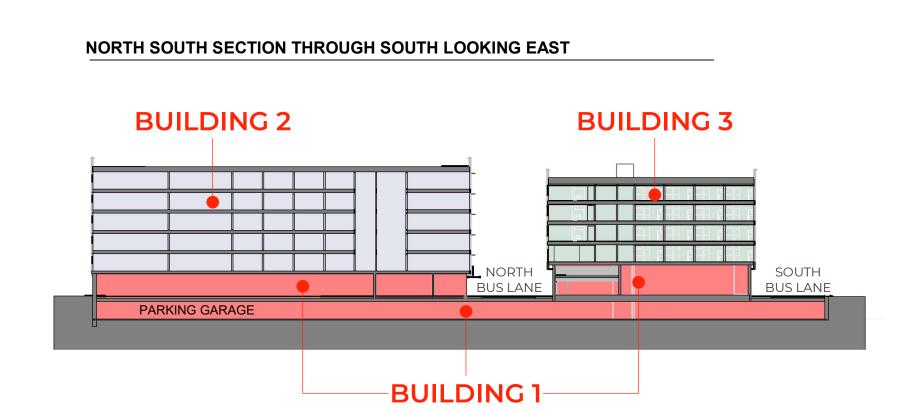

A1) BUILDING NUMBERING SCHEME - BLDGS 1-3

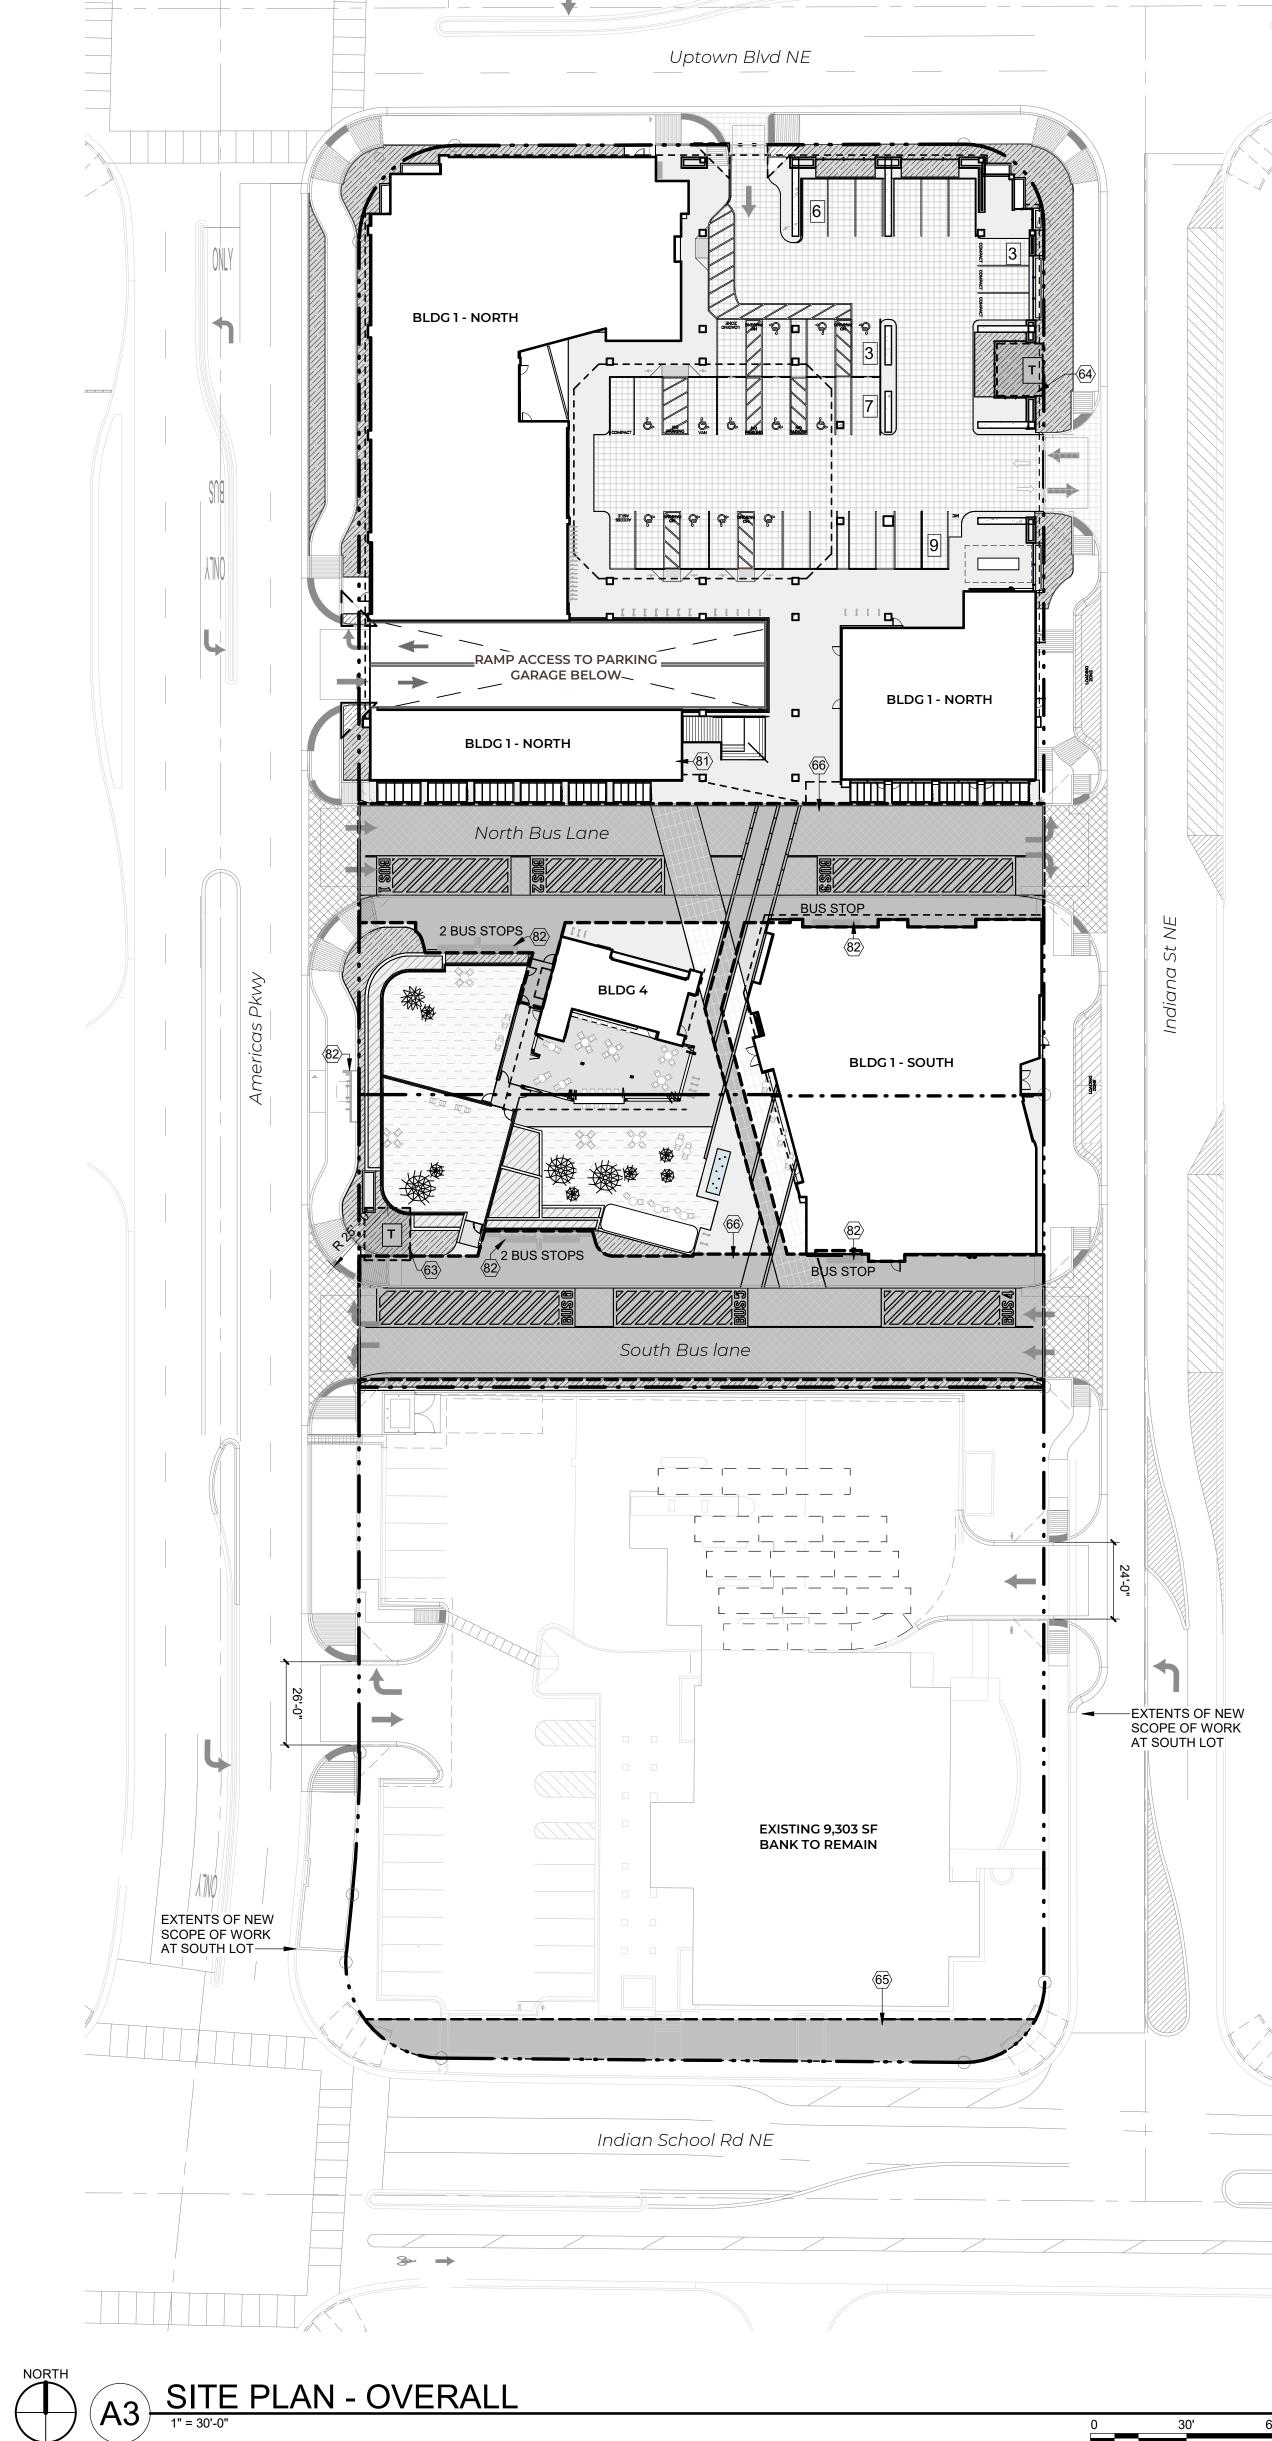

PROJECT DATA

LEGAL DESCRIPTION:
TR E-2A1 PLAT OF TRS E-2A1 & E-2A2JEANNEDALE ADDN CONT 1.4507 AC M/L AND TR E-2A2 PLAT OF TRS E-2A1 & E-2A2JEANNEDALE ADDN CONT 1.4802 AC M/L

ZONE ATLAS PAGE:

MIXED USE - HIGH INTENSITY ZONE DISTRICT (MX-H)

<u>LAND USE:</u>
MIXED USE: MULTIFAMILY RESIDENTIAL, RETAIL, OFFICE, RESTAURANT, PARKING,

ABC COMPREHENSIVE PLAN DESIGNATIONS:
UPTOWN URBAN CENTER (UC), PREMIUM TRANSIT STATION AREA (PT), MAJOR

TRANSIT CORRIDOR AREA (MT)

STREET SIDE -0' MIN / 15' MAX - 0' MIN / N.A. MAX REAR -0' MIN / N.A. MAX

MAX ALLOWED: 75'-0" PER I.D.O. TABLE 2-4-7 UC-MS-PT + 24' BLDG HEIGHT BONUS FOR STRUCTURED PARKING = 99'-0" MAX ALLOWED HEIGHT

LEVEL B1 (BLDG 1) = GROUP S-2

LEVELS 3- 5 (BLDG 3) = GROUP R-2

LEVEL 1 (BLDG 1) = GROUP A-2, B

LEVEL 2 (BLDG 3) =GROUP A-3, R-2

MAX PROVIDED: 80'-0" **BUILDING OCCUPANCY:**

BLDG 4 (DOG PARK) = GROUP B

LEVELS 2-6 (BLDG 2) = GROUP R-2

LEVEL B1 (BLDG 1) = GROUP S-2

LEVEL 1 (BLDG 1) = GROUP S-2 & B

CONSTRUCTION TYPE: (SECTION 602.2)				
BUILDING 1 :	LOWER LEVEL AND FIRST FLOOR:	TYPE 1A		
BUILDING 2 :	2ND THROUGH 6TH FLOORS:	TYPE VA		
BUILDING 3:	2ND THROUGH 5TH FLOORS:	TYPE VA		
BUILDING 4 :	1ST LEVEL	TYPE VE		

BUILDING (NORTH A	REA)	(SOUTH A	<u>IREA)</u>	<u>BLDG 4 (D</u>	OG PARK)
LEVEL B1	= 77,390 SF				
LEVEL 1	= 13,851 SF	LEVEL 1	= 7,969 SF	LEVEL 1	= 820 SF
LEVEL 2	= 39,687 SF	LEVEL 2	= 4,527 SF		
LEVEL 3	= 39,687 SF	LEVEL 3	= 4,369 SF		
LEVEL 4	= 39,600 SF	LEVEL 4	= 4,369SF		
LEVEL 5	= 39,600 SF	LEVEL 5	= 4,369 SF		
LEVEL 6	= 39,600 SF		,		
TOTAL	= 289,415 SF	TOTAL	= 25,603 SF		

FIRE FLOW: 2750 GPM REQUIRED & ACHIEVED

<u>HYDRANTS REQUIRED:</u>
3 HYDRANTS REQUIRED; 5 EXISTING AVAILABLE, 2 NEW PROPOSED W/ PROJECT

SOLID WASTE NARRATIVE: TRASH SHALL BE MANAGED ON SITE WITH AN INTERNAL MINI-MAC COMPACTOR AND

TRASH CHUTE SERVING THE RESIDENTS IN THE NORTH TOWER. THE INTERNAL COMPACTOR SHALL BE SERVED WITH A TOTAL OF 16 ROLLING 2-YARD CARTS. AT THE SOUTH TOWER, VALET TRASH REMOVAL WILL BE PROVIDED TO RESIDENTS, WITH BUILDING MAINTENANCE STAFF DEPOSITING COLLECTED TRASH AT A GROUND-LEVEL TRASH ROOM SERVED BY 6 ROLLING 2-YARD CARTS. TRASH WILL BE WHEELED OUT TO THE COLLECTION AREA ALONG INDIANA STREET BY SOLID WASTE PERSONNEL AND BUILDING MAINTENANCE STAFF ON SERVICE DAYS.

AT THE NORTH BUILDING, RECYCLING SHALL BE MANAGED ON EACH LEVEL BY TWO MANAGEMENT AND PLACED AT THE STREET COLLECTION ZONE ON COLLECTION DAYS. AT THE SOUTH TOWER RECYCLING TO BE COLLECTED IN RECEPTACLES LOCATED THROUGHOUT THE PUBLIC AREAS, AND VIA VALET COLLECTION AT THE RESIDENTIAL UNITS.

UNIT DATA

UNIT TYPE	DESCRIPTION	GSF	#UNITS	TOTAL
S1	STUDIO	432	69	29,808
S2	STUDIO	513	35	17,955
S3	not used			
S4	STUDIO	485	16	7,760
A1	1-BEDROOM	617	15	9,255
A2	1-BEDROOM	793	40	31,720
A3	1-BEDROOM	497	6	2,982
B1	2-BEDROOM	810	38	30,780
<u>C1</u>	3-BEDROOM	1,057	20	21,140
(*27 ARE ACCESS	IBLE UNITS)	TOTAL:	239*	151,400

PARKING CALCULATIONS

TABLE 5-5-1, UC-MS-PT	
REQUIRED PARKING SPACES:	
MULTIFAMILY: 1 SPACE / DU: 239 x 1 =	239.0 SPACES
CO-WORK: 3 SPACES / 1,000 SF: 7.573 X 3 =	20.2 SPACES
RETAIL: 3 SPACES / 1,000 SF: 2.667 X 3 =	5.4 SPACES
AMENITY SPACE: 3 SPACES / 1,000 SF: 10.333 X 3	17.6 SPACES
RESTAURANT & TAP ROOM: 5.6 SPACES / 1,000 SF: 2.679 X 5.6 =	29.0 SPACES
TOTAL REQUIRED:	311.2 SPACES
PARKING REDUCTIONS & CREDITS:	
30% PROXIMITY TO TRANSIT: 311.2 X .30 =	93.4 SPACES
5% TRANSIT SHELTER: 311.2 X .05 =	15.6 SPACES
MULTI-USE MULTIPLIER REDUCTION: (239 + 29) - ((239 + 29)/1.1) =	
2 PER EV CHARGER CREDIT = +1 EXTRA SPACE PER EV SPACE	12.0 SPACES
TOTAL REDUCTION =	145 SPACES
TOTAL REQUIRED PARKING:	166 SPACES
(5%, OR 11 SPACES, RQD TO BE EV SPACES ; 25%, OR 42,TO BE I	
(24 RQD ACCESSIBLE SPACES - 1 PER AFFORDABLE ACCESSIBLI	E DWELLING UNIT
TOTAL PROVIDED PARKING:	211 SPACES
	(GARAGE: 183)
	`(QUIDEA QE QQ\

MOTORCYCLE PARKING CALCULATION: PROVIDED SPACES (INCLUDED IN THE 218 PROVIDED ABV.) 5 SPACES

REQUIRED SPACES: 0.5 / UNIT (239 X 0.5) = 120 BICYCLE PARKING SPACES) PROVIDED SPACES: 120 TOTAL SPACES PROVIDED (24 SECURED SPACES REQ'D & PROVIDED)

BANK PARKING CALCULATIONS-FOR REFERENCE ONLY

TABLE 5-5-1, UC-MS-PT REQUIRED PARKING SPACES: BANK: 2 SPACES / 1,000 SF: 9.303 X 2 =	18 SPACE
PARKING REDUCTIONS & CREDITS:	
30% PROXIMITY TO TRANSIT: 18 X .30 =	- 6 SPAC
TOTAL REQUIRED PARKING:	12 SPAC
TOTAL PROVIDED PARKING:	23 SPAC
MOTORCYCLE PARKING CALCULATION TABLE 5-5-4:	
REQUIRED SPACES:	1 SPACE
PROVIDED SPACES	1 SPACE
BICYCLE PARKING TABLE 5-5-5	
REQUIRED SPACES: 3 SPACES	

PROVIDED SPACES: 3 TOTAL SPACES PROVIDED

GENERAL SHEET NOTES

A. SITE PLAN DIMENSIONS ARE IN FEET AND INCHES. DIMENSIONS ARE TO FACE OF CURB, OR WALL, OR EDGE OF PAVEMENT UNLESS OTHERWISE NOTED. B. SITE PLAN SHALL COMPLY WITH LOCAL, FEDERAL AND ACCESSIBILITY STANDARDS & GUIDELINES, INCLUDING THE 2021 INTERNATIONAL FIRE CODE (IFC). C. VERIFY EXISTING UTILITY LOCATIONS BEFORE EXCAVATION.

D. UTILITIES AND ASSOCIATED EQUIPMENT SHOWN FOR REFERENCE ONLY. COORDINATE LOCATION AND INSTALLATION. SEE CIVIL E. ALL CURBS AND ACCESSIBLE RAMPS WILL BE DESIGNED AND BUILT ACCORDING

TO THE CITY OF ALBUQUERQUE STANDARDS. . AN ACCESSIBLE ROUTE, IN COMPLIANCE WITH ACCESSIBILITY STANDARDS OF THE PROJECT, CONNECTS FROM THE BUILDING TO ACCESSIBLE PARKING SPACES AND TO ALL SITE AMENITIES AS REQUIRED G. ALL LIGHT FIXTURES AND LIGHTING DESIGN SHALL COMPLY WITH THE CITY OF ALBUQUERQUE INTEGRATED DEVELOPMENT ORDINANCE (IDO): SECTION 14-16-5-8

OUTDOOR LIGHTING. H. REFER TO CIVIL FOR PAVING PLAN AND PAVING DETAILS. STREETS, PARKING SPACES, AND ASSOCIATED DRIVES TO BE ASPHALT UNLESS

NOTED OTHERWISE. BUS LANES TO BE CONCRETE. SIDEWALK JOINTS SHALL FOLLOW PATTERN AS SHOWN ON SITE PLAN. K. PROVIDE POURABLE SEALANT AT ALL EXPANSION JOINTS IN CONCRETE SIDEWALK, WHERE EXPANSION JOINT MATERIAL IS PROVIDED BETWEEN WALLS AND SIDEWALKS AND BETWEEN ASPHALT AND CONCRETE JOINTS.

PROVIDE AIR ENTRAINED CONCRETE WITH MEDIUM BROOM FINISH AT ALL SITE CONCRETE. SLOPE ALL CONCRETE SIDEWALKS TO DRAIN, TYP. RE: CIVIL FOR SPOT ELEVATIONS, AND GRADING AND DRAINAGE REQUIREMENTS. M. EXISTING LANDSCAPE AREAS ADJACENT TO THE PROJECT SITE ARE TO BE PROTECTED DURING DEMOLITION AND CONSTRUCTION.

N. LANDSCAPE AND SIGNAGE WILL NOT INTERFERE WITH CLEAR SIGHT REQUIREMENTS. THEREFORE SIGNS, WALLS AND PLANTING BETWEEN 3 FEET AND 8 FEET TALL (AS MEASURED FROM THE GUTTER PAN) WILL NOT BE PERMITTED IN THE CLEAR SIGHT TRIANGLE. O. ALL RAMPS, SIDEWALKS, CURBS AND GUTTERS IN THE R.O.W. SHALL BE INSTALLED

PER CITY OF ALBUQUERUQE STANDARD DRAWINGS. P. WORK WITHIN THE PUBLIC RIGHT OF WAY REQUIRES A WORK ORDER WITH APPROVED PLANS PER CITY OF ALBUQUERQUE. Q. ALL IMPROVEMENTS LOCATED IN THE RIGHT OF WAY MUST BE INCLUDED ON THE R. ALL BROKEN OR CRACKED SIDEWALK MUST BE REPLACED WITH SIDEWALK AND CURB & GUTTER.

SHEET KEYNOTES

- 08 PROPERTY LINE 35 ELECTRIC VEHICLE CHARGING STATION
- 38 EV CAPABLE PARKING SPACE 63 PUBLIC SERVICE COMPANY OF NEW MEXICO 16' X 17' ELECTRIC
- TRANSFORMER EASEMENT 64 PUBLIC SERVICE COMPANY OF NEW MEXICO 15' X 17' ELECTRIC
- TRANSFORMER EASEMENT 65 CITY OF ALBUQUERQUE 13.5' PUBLIC DRAINAGE EASEMENT
- 66 CITY OF ALBUQUERQUE ABQ RIDE TRANSIT EASEMENT 81 LOCATION FOR POSSIBLE 2-STOP ELEVATOR
- PLACE-HOLDER BUS STOP, DESIGN PENDING COORDINATION WITH

SITE LEGEND

LANDSCAPED AREA
EXTRA HEAVY DUTY CONCRETE (RATED FOR UP TO 75,000 LBS)
HEAVY DUTY CONCRETE (<75,000 LBS)
COLORED, STAMPED CONCRETE
NEW EASEMENTS
 PROPERTY LINE
 SETBACK (SEE DIMENSION FOR ADDITIONAL DETAILS)
 LINE OF BUILDING ABOVE
 ACCESSIBLE ROUTE

FIRE LANE STRIPING MARKING FIRE ACCESS LANE

REFUSE TRUCK ROUTE

EXISTING FIRE HYDRANT LOCATION FIRE HYDRANT LOCATION, RE: CIVIL

FIRE DEPARTMENT CONNECTION (FDC) WALL MOUNTED TRANSFORMER, RE: ELECTRICAL

PROPOSED 20' LIGHT POLE BIKE RACKS

ZONE ATLAS

Map amended through: May 16, 2018

The Zone Districts and various Overlays shown on these pages are no longer in effect as of May 17, 2018. Refer to the


Integrated Development Ordinance (IDO)

for current Zoning information.

Note: Grey Shading Represents Area Outside of the City Limits

(SURFACE: 28)

5 SPACES

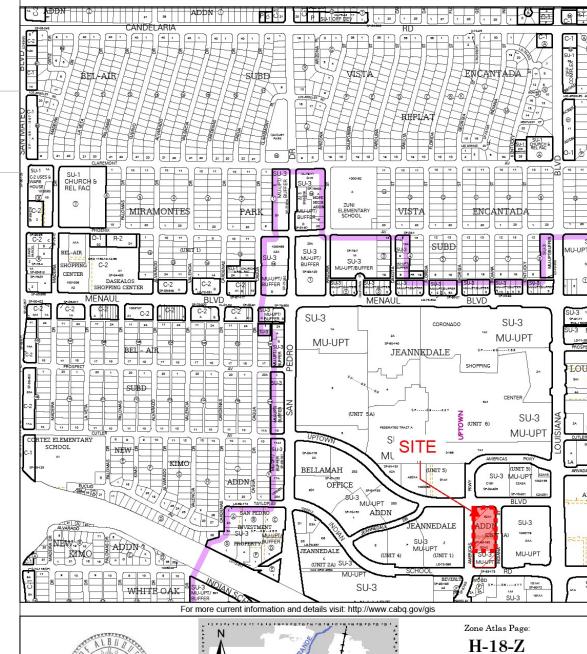

DRAWN BY REVIEWED BY DATE PROJECT NO

SECTOR PLANS Escarpment

Design Overlay Zones 2 Mile Airport Zone

City Historic Zones

H-1 Buffer Zone

Airport Noise Contours

Wall Overlay Zone

Petroglyph Mon.

0 750

DRAWING NAME SITE

DEVELOPMENT PLAN

11/10/2025

20-0010

DFT SITE

DEVELOPMENT

FAVATA

NO. 6686

PROJECT

SHEET NO SDP 1.1

PROJECT DATA

LEGAL DESCRIPTION:
TR E-2A1 PLAT OF TRS E-2A1 & E-2A2JEANNEDALE ADDN CONT 1.4507 AC M/L AND TR E-2A2 PLAT OF TRS E-2A1 & E-2A2JEANNEDALE ADDN CONT 1.4802 AC M/L

SITE AREA: 2.93 ACRES

ZONE ATLAS PAGE: H-18-Z

ZONING:MIXED USE - HIGH INTENSITY ZONE DISTRICT (MX-H)

<u>LAND USE:</u>
MIXED USE: MULTIFAMILY RESIDENTIAL, RETAIL, OFFICE, RESTAURANT, PARKING,

ABC COMPREHENSIVE PLAN DESIGNATIONS: UPTOWN URBAN CENTER (UC), PREMIUM TRANSIT STATION AREA (PT), MAJOR TRANSIT CORRIDOR AREA (MT)

- 0' MIN / N.A. MAX

STREET SIDE -0' MIN / 15' MAX REAR -0' MIN / N.A. MAX

TYPE 1A

LEVEL 1 = 820 SF

BUILDING HEIGHT:
MAX ALLOWED: 75'-0" PER I.D.O. TABLE 2-4-7 UC-MS-PT + 24' BLDG HEIGHT BONUS FOR STRUCTURED PARKING = 99'-0" MAX ALLOWED HEIGHT

MAX PROVIDED: 80'-0"

BUILDING OCCUPANCY:

LEVEL B1 (BLDG 1) = GROUP S-2 LEVEL B1 (BLDG 1) = GROUP S-2 LEVEL 1 (BLDG 1) = GROUP S-2 & B LEVEL 1 (BLDG 1) = GROUP A-2, B LEVELS 2-6 (BLDG 2) = GROUP R-2 LEVEL 2 (BLDG 3) =GROUP A-3, R-2 LEVELS 3- 5 (BLDG 3) = GROUP R-2

BLDG 4 (DOG PARK) LEVEL 1 = GROUP B

CONSTRUCTION TYPE: (SECTION 602.2)				
BUILDING 1:	LOWER LEVEL AND FIRST FLOOR:			
BUILDING 2:	2ND THROUGH 6TH FLOORS:			
BUILDING 3:	2ND THROUGH 5TH FLOORS:			

_OORS: **TYPE VA** _OORS: TYPE VA BUILDING 4: 1ST LEVEL TYPE VB RIIII DING AREAS: **BLDG 4 (DOG PARK)**

ILDING AREAS:						
ORTH AREA)			(SOUTH A	(SOUTH AREA)		
VEL B1	=	77,390 SF				
VEL 1	=	13,851 SF	LEVEL 1	= 7,969 SF		
VEL 2	=	39,687 SF	LEVEL 2	= 4,527 SF		
VEL 3	=	39,687 SF	LEVEL 3	= 4,369 SF		
VEL 4	=	39.600 SF	LEVEL 4	= 4.369SF		

FIRE FLOW: 2750 GPM REQUIRED & ACHIEVED

LEVEL 5 = 39,600 SF

<u>HYDRANTS REQUIRED:</u>
3 HYDRANTS REQUIRED; 5 EXISTING AVAILABLE, 2 NEW PROPOSED W/ PROJECT

LEVEL 5 = 4,369 SF

TOTAL = 25,603 SF

SOLID WASTE NARRATIVE: TRASH SHALL BE MANAGED ON SITE WITH AN INTERNAL MINI-MAC COMPACTOR AND

TRASH CHUTE SERVING THE RESIDENTS IN THE NORTH TOWER. THE INTERNAL COMPACTOR SHALL BE SERVED WITH A TOTAL OF 16 ROLLING 2-YARD CARTS. AT THE SOUTH TOWER, VALET TRASH REMOVAL WILL BE PROVIDED TO RESIDENTS, WITH BUILDING MAINTENANCE STAFF DEPOSITING COLLECTED TRASH AT A GROUND-LEVEL TRASH ROOM SERVED BY 6 ROLLING 2-YARD CARTS. TRASH WILL BE WHEELED OUT TO THE COLLECTION AREA ALONG INDIANA STREET BY SOLID WASTE PERSONNEL AND BUILDING MAINTENANCE STAFF ON SERVICE DAYS.

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UNIT DATA

UNIT TYPE	DESCRIPTION	GSF	#UNITS	TOTAL
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S2	STUDIO	513	35	17,955
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S4	STUDIO	485	16	7,760
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<u>C1</u>	3-BEDROOM	1,057	20	21,140
(*27 ARE ACCESS	IBLE UNITS)	TOTAL:	239*	151,400

PARKING CALCULATIONS

(24 RQD ACCESSIBLE SPACES - 1 PER AFFORDABLE ACCESSIBLE DWELLING UNIT)

BICYCLE PARKING (PER HOUSING NEW MEXICO/MFA 2025 DESIGN STANDARDS)
REQUIRED SPACES: 0.5 / UNIT (239 X 0.5) = 120 BICYCLE PARKING SPACES)

MOTORCYCLE PARKING CALCULATION: 5 SPACES PROVIDED SPACES (INCLUDED IN THE 218 PROVIDED ABV.) 5 SPACES

(12 EV SPACES, 42 EV CAPABLE SPACES PROVIDED)

PROVIDED SPACES: 120 TOTAL SPACES PROVIDED (24 SECURED SPACES REQ'D & PROVIDED)

BANK PARKING CALCULATIONS-

FOR REFERENCE ONLY

18 SPACES
- 6 SPACES
23 SPACES
1 SPACES

BICYCLE PARKING TABLE 5-5-5 REQUIRED SPACES: 3 SPACES

TOTAL PROVIDED PARKING:

PROVIDED SPACES: 3 TOTAL SPACES PROVIDED

GENERAL SHEET NOTES

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- C. VERIFY EXISTING UTILITY LOCATIONS BEFORE EXCAVATION. D. UTILITIES AND ASSOCIATED EQUIPMENT SHOWN FOR REFERENCE ONLY. COORDINATE LOCATION AND INSTALLATION. SEE CIVIL
- E. ALL CURBS AND ACCESSIBLE RAMPS WILL BE DESIGNED AND BUILT ACCORDING TO THE CITY OF ALBUQUERQUE STANDARDS. . AN ACCESSIBLE ROUTE, IN COMPLIANCE WITH ACCESSIBILITY STANDARDS OF THE PROJECT, CONNECTS FROM THE BUILDING TO ACCESSIBLE PARKING SPACES AND TO ALL SITE AMENITIES AS REQUIRED
- G. ALL LIGHT FIXTURES AND LIGHTING DESIGN SHALL COMPLY WITH THE CITY OF ALBUQUERQUE INTEGRATED DEVELOPMENT ORDINANCE (IDO): SECTION 14-16-5-8 OUTDOOR LIGHTING
- H. REFER TO CIVIL FOR PAVING PLAN AND PAVING DETAILS. STREETS, PARKING SPACES, AND ASSOCIATED DRIVES TO BE ASPHALT UNLESS NOTED OTHERWISE. BUS LANES TO BE CONCRETE.
- SIDEWALK JOINTS SHALL FOLLOW PATTERN AS SHOWN ON SITE PLAN. K. PROVIDE POURABLE SEALANT AT ALL EXPANSION JOINTS IN CONCRETE SIDEWALK, WHERE EXPANSION JOINT MATERIAL IS PROVIDED BETWEEN WALLS AND SIDEWALKS AND BETWEEN ASPHALT AND CONCRETE JOINTS. PROVIDE AIR ENTRAINED CONCRETE WITH MEDIUM BROOM FINISH AT ALL SITE
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- O. ALL RAMPS, SIDEWALKS, CURBS AND GUTTERS IN THE R.O.W. SHALL BE INSTALLED PER CITY OF ALBUQUERUQE STANDARD DRAWINGS. P. WORK WITHIN THE PUBLIC RIGHT OF WAY REQUIRES A WORK ORDER WITH APPROVED PLANS PER CITY OF ALBUQUERQUE. Q. ALL IMPROVEMENTS LOCATED IN THE RIGHT OF WAY MUST BE INCLUDED ON THE
- R. ALL BROKEN OR CRACKED SIDEWALK MUST BE REPLACED WITH SIDEWALK AND CURB & GUTTER.

SHEET KEYNOTES

10 RAISED PLANTING AREA 15 ACCESSIBLE ROUTE 17 CLEAR SITE TRIANGLE 20 NEW WATER METER BOX 21 ELECTRIC METERS

24 BIKE RACKS

- RELOCATED, PER DHO PLAT 25 WATER FEATURE - SPLASH PAD APPLICATION PLT-2025-00059 26 LINE OF ROOF ABOVE 67 REFUSE ROOM 29 GATE 30 NO PARKING - FIRE LANE CURB PAINT 80
 - FREE-STANDING STEEL OVERHEAD SHADE STRUCTURE 81 LOCATION FOR POSSIBLE 2-STOP **ELEVATOR**

32 ACCESSIBLE PEDESTRIAN RAMP

62 EXISTING PROPERTY LINE TO BE

31 6" CONCRETE CURB

59 ONE-WAY SIGNAGE

60 DO NOT ENTER SIGNAGE

37 GAS METER

FAVATA

NO. 6686

PROJECT

82 PLACE-HOLDER BUS STOP, DESIGN PENDING COORDINATION WITH ABQ

SITE LEGEND

01.1 = ==0	
	LANDSCAPED AREA
	EXTRA HEAVY DUTY CONCRETE (RATED FOR UP TO 75,000 LBS)
	HEAVY DUTY CONCRETE (<75,000 LBS)
	COLORED, STAMPED CONCRETE
	NEW EASEMENTS
	PROPERTY LINE
	SETBACK (SEE DIMENSION FOR ADDITIONAL DETAILS)
	LINE OF BUILDING ABOVE
	ACCESSIBLE ROUTE
	FIRE LANE STRIPING MARKING FIRE ACCESS LANE

REFUSE TRUCK ROUTE EXISTING FIRE HYDRANT LOCATION

FIRE HYDRANT LOCATION, RE: CIVIL FIRE DEPARTMENT CONNECTION (FDC) WALL MOUNTED

TRANSFORMER, RE: ELECTRICAL PROPOSED 20' LIGHT POLE


BIKE RACKS

ZONE ATLAS

211 SPACES

(GARAGE: 183)

(SURFACE: 28)

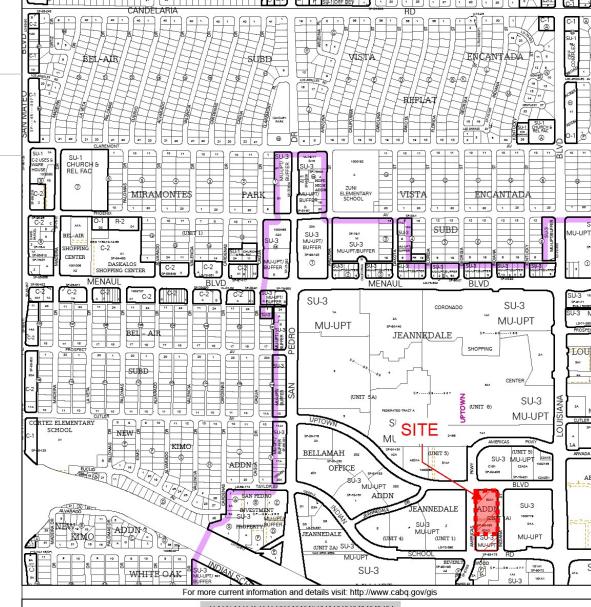

Map amended through: May 16, 2018 The Zone Districts and various Overlays shown on these pages are no longer in effect as of May 17, 2018. Refer to the Integrated Development Ordinance (IDO) for current Zoning information.

H-18-Z SECTOR PLANS

Design Overlay Zones

City Historic Zones

H-1 Buffer Zone

Wall Overlay Zone Petroglyph Mon.

0 750 1,500

PLAN

ENLARGED SITE

11/10/2025

DRAWN BY

DATE

REVIEWED BY

PROJECT NO


DRAWING NAME

DFT SITE

DEVELOPMENT

PLAN

SHEET NO SDP 1.2

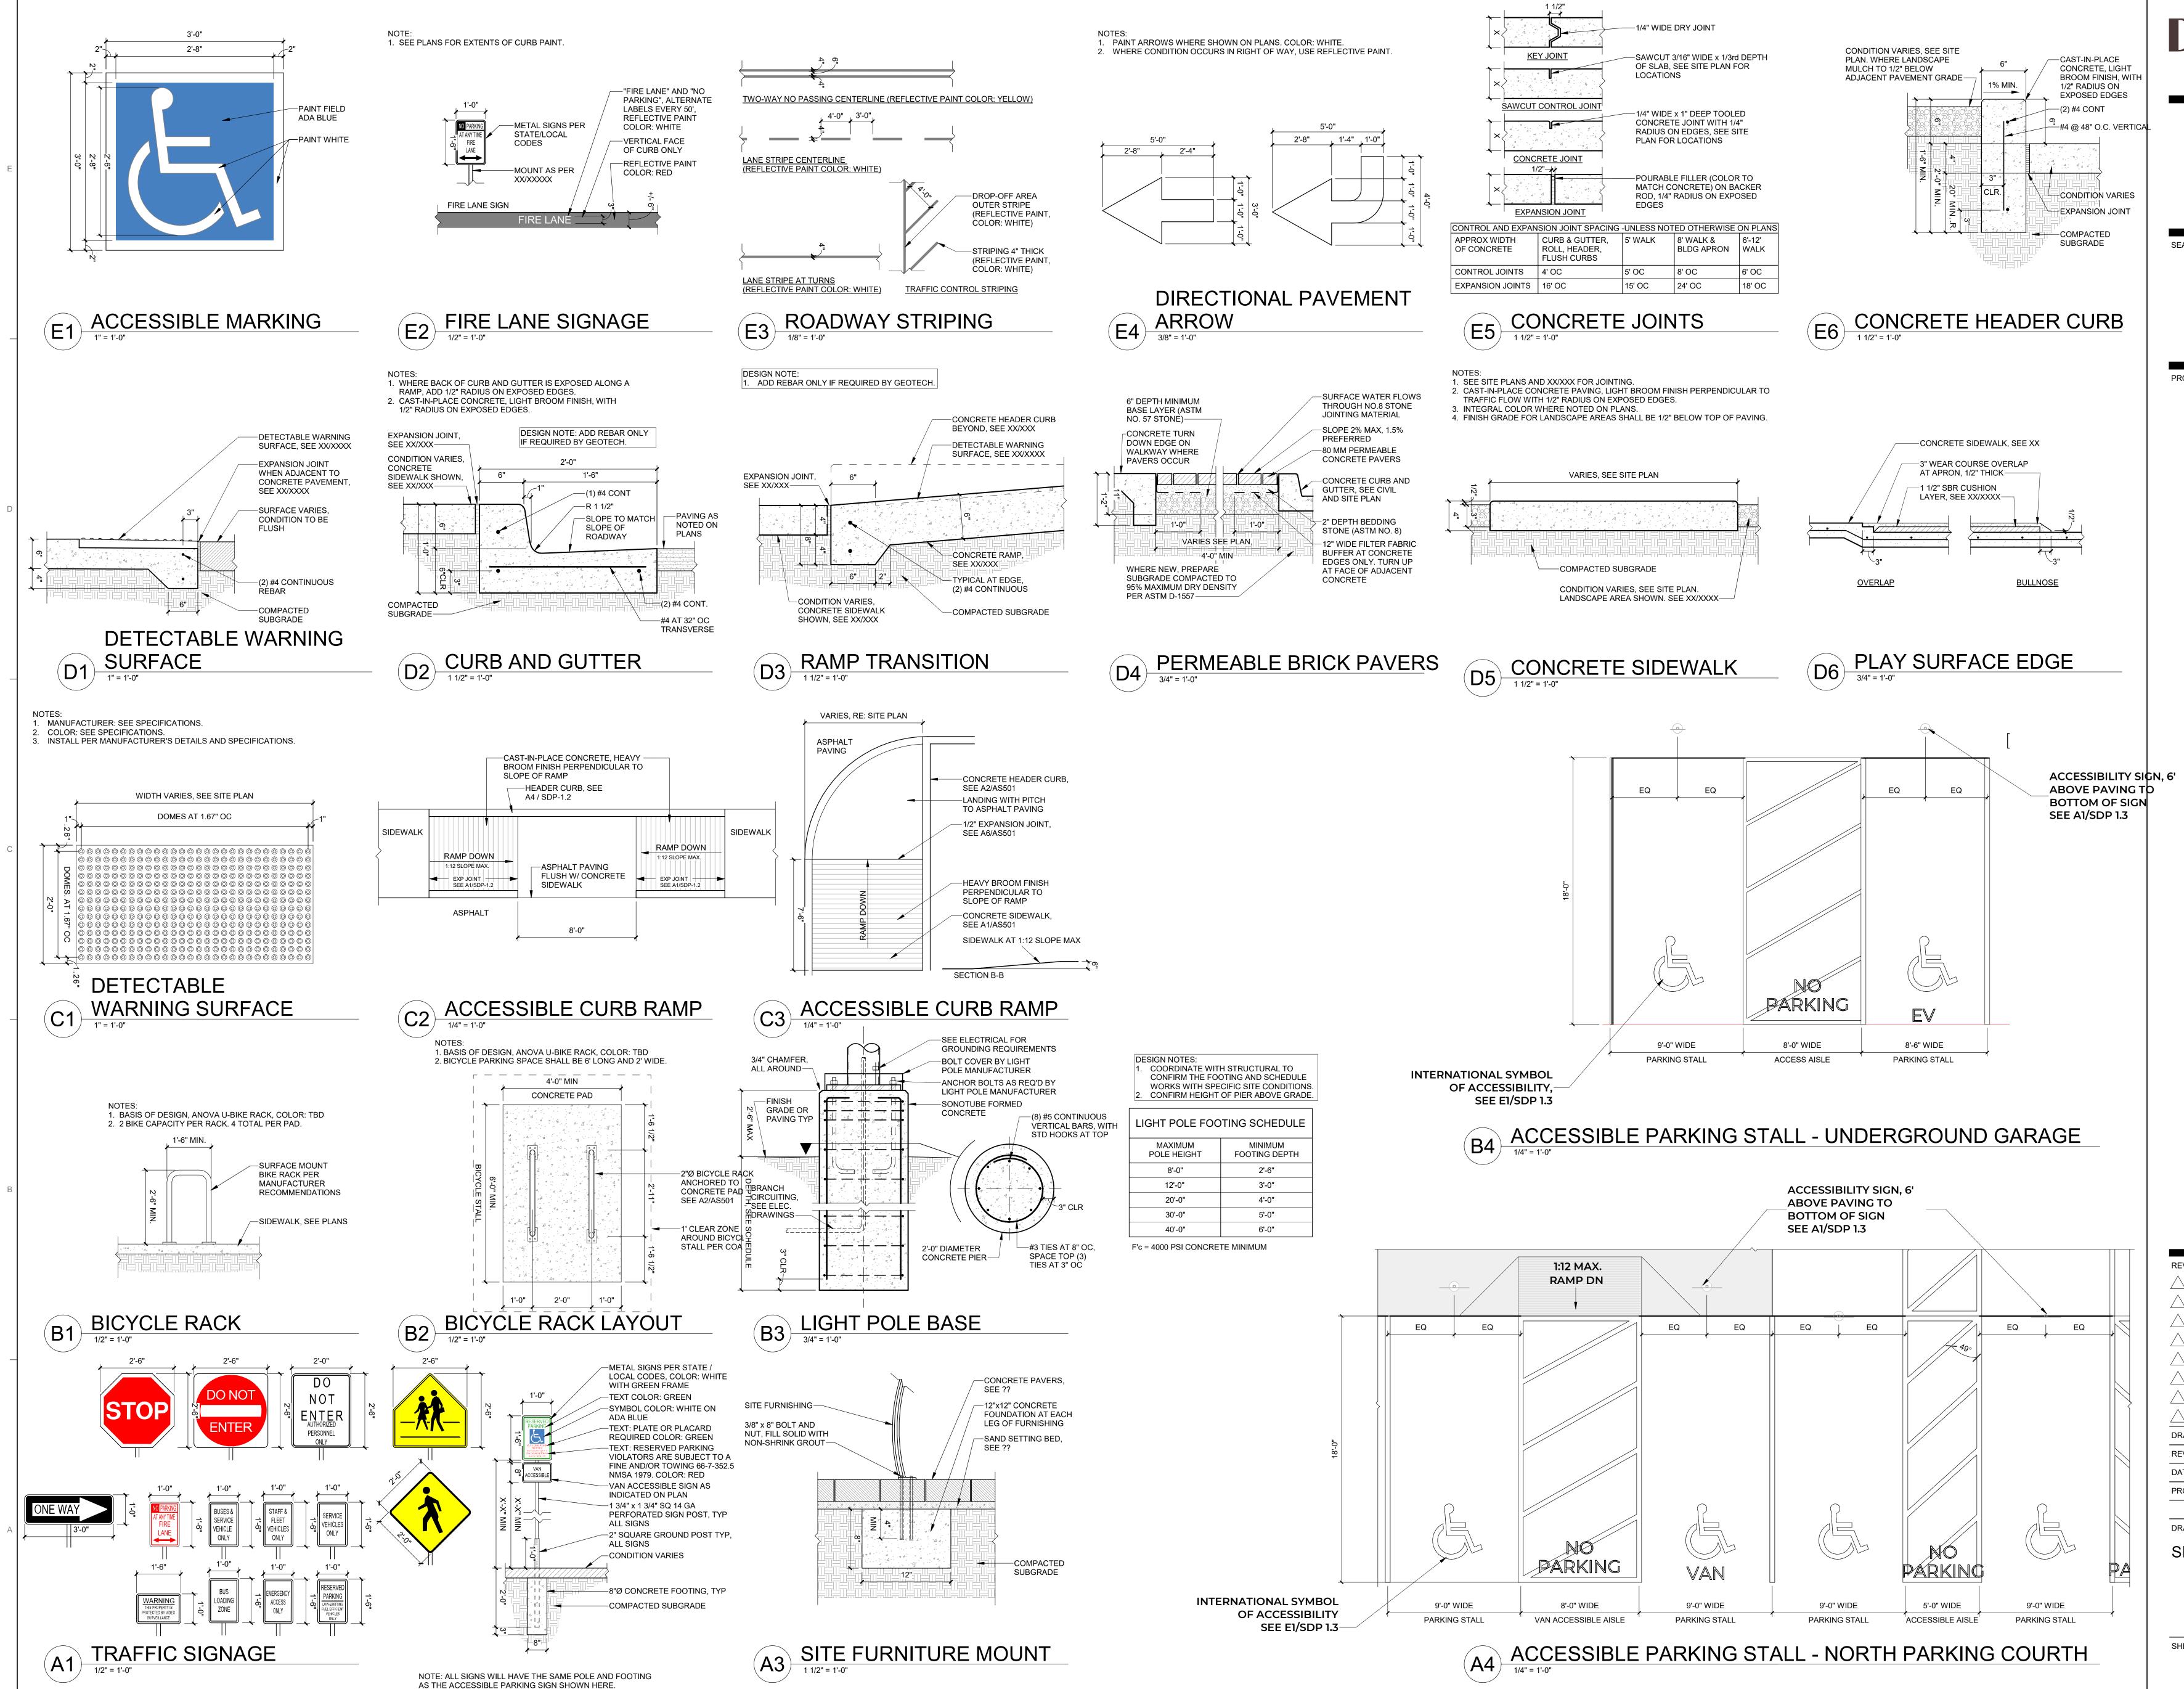

FAVATA NO. 6686

PROJECT

DFT SITE DEVELOPMENT

REVISIONS DRAWN BY **REVIEWED BY** DATE 11/10/2025 PROJECT NO 20-0010

DRAWING NAME

SITE DETAILS


SHEET NO SDP 1.3



Dekker

FAVATA NO. 6686

PROJECT

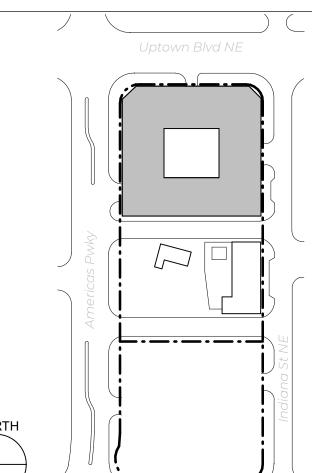

DRAWN BY REVIEWED BY 11/10/2025 DATE PROJECT NO

DFT SITE

DEVELOPMENT

PLAN

REVISIONS

DRAWING NAME

BLDG #2 -EXTERIOR ELEVATIONS

SHEET NO

SDP 4.1



FAVATA NO. 6686

PROJECT

DFT SITE DEVELOPMENT PLAN

REVISIONS DRAWN BY REVIEWED BY

11/10/2025 PROJECT NO

DRAWING NAME

BLDG #2 -EXTERIOR ELEVATIONS

SHEET NO

SDP 4.2

C3 PLAZA BUILDING - EAST ELEVATION



A3 PLAZA BUILDING - SOUTH ELEVATION




FAVATA

NO. 6686

GENERAL SHEET NOTES

- A. BUILDINGS SHALL HAVE HIGHLY VISIBLE SIGNAGE WITH CONTRASTING COLORS, LIT FROM DUSK UNTIL DAWN. B. ROOF GUTTERS AND DOWNSPOUTS DIRECT DRAINAGE AWAY FROM BUILDING TO USE IN LANDSCAPE AREAS. C. WATER IS DIVERTED AWAY FROM BUILDING WALLS AND FOUNDATIONS BY
- SLOPING THE EXTERIOR GRADE AWAY FROM THE BUILDING. RE: CIVIL PLANS D. REFER TO FLOOR PLANS FOR WINDOW AND DOOR TYPES AND LOCATIONS.E. ALL CHANGE IN COLOR PLANE SHALL HAPPEN AT INSIDE CORNERS, UNLESS
- NOTED OTHERWISE. F. FINISH FLOOR INDICATED AS 100'-0". RE: CIVIL FOR FINISH GRADES. ALL VERTICAL
- DIMENSIONS ARE FROM 100'-0" G. ALL STEEL ELEMENTS ARE TO BE PRIMED AND PAINTED, UNLESS NOTED
- OTHERWISE H. PAINT WALL AND ROOF MOUNTED EQUIPMENT ITEMS THAT ARE NOT PRE-
- FINISHED TO MATCH COLOR OF ADJACENT SURFACE, UNLESS NOTED OTHERWISE. REFER TO REFLECTED CEILING PLANS FOR EXTERIOR SOFFIT HEIGHTS.
- J. LOCATE HORIZONTAL CONTROL JOINTS AT FLOOR DECK AT LEVELS 2, 3, 4, 5, & 6; LOCATE VERTICAL CONTROL JOINTS AT WINDOW AND DOOR EDGES. K. SEE REFLECTED CEILING PLANS FOR EXTERIOR SOFFIT HEIGHTS.

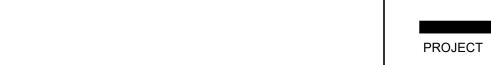

SHEET KEYNOTES

- **ELECTRIC METERS** ABQ RIDE BUS STOP
- GAS METER
- WOOD-LOOK 1.5" X 3.5" COMPOSITE BATTENS GLASS GUARDRAIL
- POSSIBLE LOCATION FOR BUILDING-MOUNTED SIGNAGE


BUILDING ELEVATION LEGEND

3-COAT PORTLAND CEMENT	OPEN JOINT FIBER CEMENT
STUCCO - COLOR: S1	BOARD - COLOR: FC3
3-COAT PORTLAND CEMENT	OPEN JOINT FIBER CEMENT
STUCCO - COLOR: S2	BOARD - COLOR: FC4
3-COAT PORTLAND CEMENT	OPEN JOINT FIBER CEMENT
STUCCO - COLOR: S3	BOARD - COLOR: FC5
3-COAT PORTLAND CEMENT	BOX CORRUGATED METAL
STUCCO - COLOR: S4	PANEL - COLOR: MP1
3-COAT PORTLAND CEMENT	COMPOSITE METAL PANEL -
STUCCO - COLOR: S5	COLOR: MP2

COMPOSITE METAL PANEL -COLOR: MP3 BRICK VENEER - COLOR: B1 COMPOSITE METAL PANEL -COLOR: MP4 OPEN JOINT FIBER CEMENT BOARD - COLOR: FC1

KEY PLAN

OPEN JOINT FIBER CEMENT BOARD - COLOR: FC2

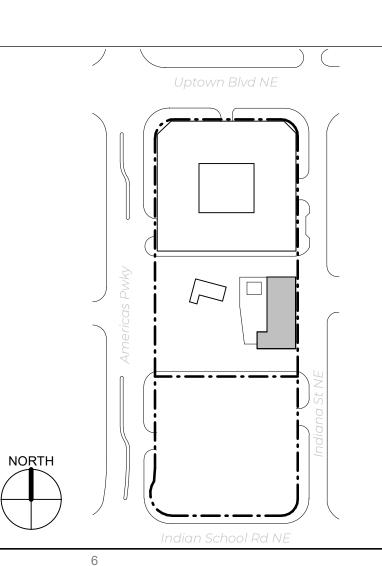

COMPOSITE METAL PANEL -COLOR: MP5

DFT SITE DEVELOPMENT PLAN

REVISIONS

DRAWN BY REVIEWED BY 11/10/2025 PROJECT NO

DRAWING NAME

BLDG #3 -EXTERIOR ELEVATIONS

SHEET NO SDP 4.3





A1 PLAZA BUILDING - NORTH ELEVATION

FAVATA

6501 INDIAN SERQUE NM 871

NO. 6686

PROJECT

GENERAL SHEET NOTES

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- G. ALL STEEL ELEMENTS ARE TO BE PRIMED AND PAINTED, UNLESS NOTED OTHERWISE
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- J. LOCATE HORIZONTAL CONTROL JOINTS AT FLOOR DECK AT LEVELS 2, 3, 4, 5, & 6; LOCATE VERTICAL CONTROL JOINTS AT WINDOW AND DOOR EDGES.
- K. SEE REFLECTED CEILING PLANS FOR EXTERIOR SOFFIT HEIGHTS.

SHEET KEYNOTES

- ABQ RIDE DIGITAL DISPLAY BOARD ABQ RIDE BUS STOP METAL SHADE CANOPY
- OVERHEAD COILING DOOR
- WOOD-LOOK 1.5" X 3.5" COMPOSITE BATTENS GLASS GUARDRAIL
- 18" DEEP PERFORATED METAL SHADE FINS POSSIBLE LOCATION FOR BUILDING-MOUNTED SIGNAGE


BUILDING ELEVATION LEGEND

OPEN JOINT FIBER CEMENT BOARD - COLOR: FC3 3-COAT PORTLAND CEMENT STUCCO - COLOR: S1 3-COAT PORTLAND CEMENT STUCCO - COLOR: S2 OPEN JOINT FIBER CEMENT BOARD - COLOR: FC4 3-COAT PORTLAND CEMENT STUCCO - COLOR: S3 OPEN JOINT FIBER CEMENT BOARD - COLOR: FC5 BOX CORRUGATED METAL 3-COAT PORTLAND CEMENT PANEL - COLOR: MP1 STUCCO - COLOR: S4 COMPOSITE METAL PANEL -COLOR: MP2 3-COAT PORTLAND CEMENT STUCCO - COLOR: S5

COMPOSITE METAL PANEL -BRICK VENEER - COLOR: B1 COLOR: MP3 OPEN JOINT FIBER CEMENT BOARD - COLOR: FC1 COMPOSITE METAL PANEL -COLOR: MP4

COMPOSITE METAL PANEL -OPEN JOINT FIBER CEMENT COLOR: MP5 BOARD - COLOR: FC2

KEY PLAN

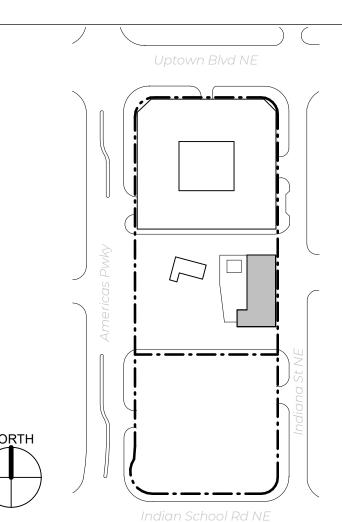

 \triangle DRAWN BY REVIEWED BY 11/10/2025 DATE

REVISIONS

DFT SITE

DEVELOPMENT

PLAN


DRAWING NAME

PROJECT NO


BLDG #3 -EXTERIOR ELEVATIONS

SHEET NO SDP 4.4


D3 BUILDING 3 - EAST ELEVATION

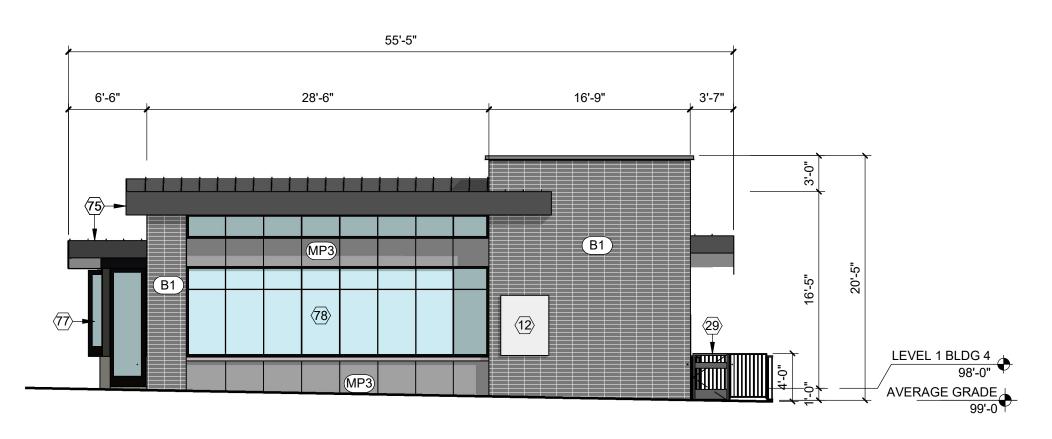

BUILDING 3 - NORTH ELEVATION Output 1/8" = 1'-0"

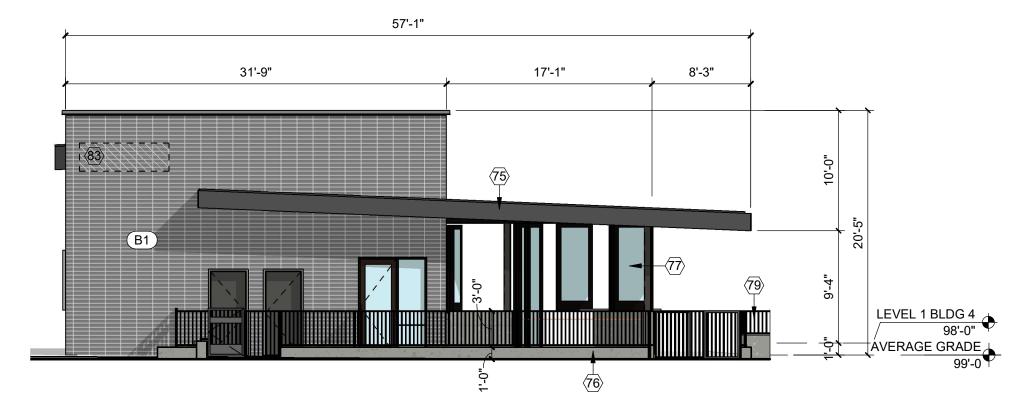

BUILDING 3 - WEST ELEVATION 1/8" = 1'-0"

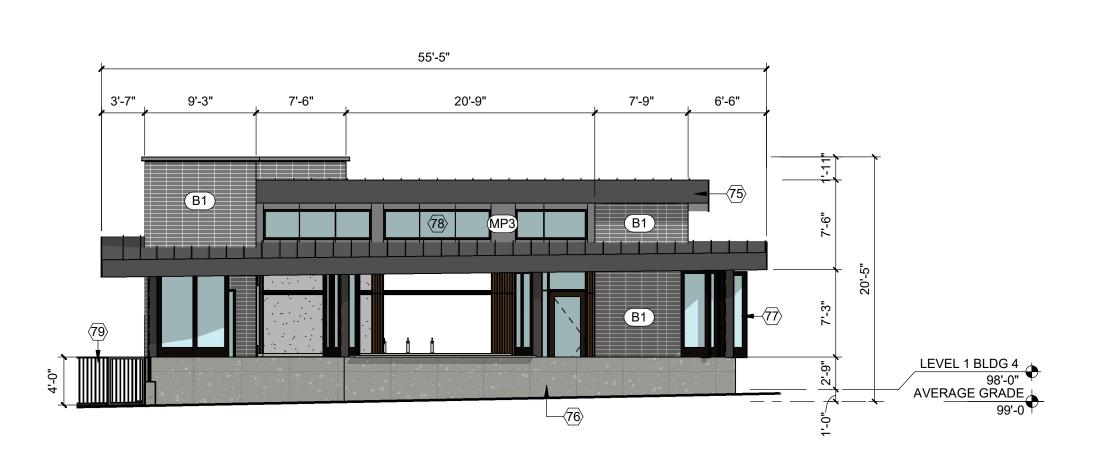

BUILDING 3 - SOUTH ELEVATION

Outside 1/8" = 1'-0"

FAVATA

NO. 6686

PROJECT

GENERAL SHEET NOTES

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- K. SEE REFLECTED CEILING PLANS FOR EXTERIOR SOFFIT HEIGHTS.

SHEET KEYNOTES

- ABQ RIDE DIGITAL DISPLAY BOARD
- GATE METAL ROOF FASCIA
- CAST CONCRETE SITE WALL OPERABLE GLAZED WALL SHUTTERS
- ALUMINUM STOREFRONT W/ CLEAR GLAZING METAL GUARDRAIL

POSSIBLE LOCATION FOR BUILDING-MOUNTED SIGNAGE


BUILDING ELEVATION LEGEND

OPEN JOINT FIBER CEMENT BOARD - COLOR: FC1

OPEN JOINT FIBER CEMENT BOARD - COLOR: FC2

	3-COAT PORTLAND CEMENT STUCCO - COLOR: S1	OPEN JOINT FIBER CEMENT BOARD - COLOR: FC3
	3-COAT PORTLAND CEMENT STUCCO - COLOR: S2	OPEN JOINT FIBER CEMENT BOARD - COLOR: FC4
	3-COAT PORTLAND CEMENT STUCCO - COLOR: S3	OPEN JOINT FIBER CEMENT BOARD - COLOR: FC5
	3-COAT PORTLAND CEMENT STUCCO - COLOR: S4	BOX CORRUGATED METAL PANEL - COLOR: MP1
	3-COAT PORTLAND CEMENT STUCCO - COLOR: S5	COMPOSITE METAL PANEL - COLOR: MP2
	BRICK VENEER - COLOR: B1	COMPOSITE METAL PANEL - COLOR: MP3

KEY PLAN

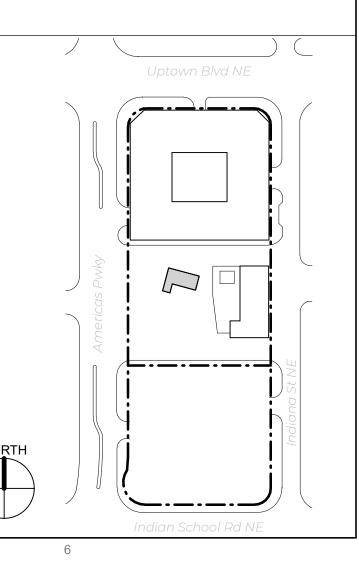

COMPOSITE METAL PANEL -COLOR: MP4

COMPOSITE METAL PANEL -COLOR: MP5

DFT SITE DEVELOPMENT PLAN

REVISIONS

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DRAWN BY	Dek
REVIEWED BY	Dek
DATE	11/10/20
PROJECT NO	20-00

DRAWING NAME

BLDG #4 -EXTERIOR ELEVATIONS

SHEET NO SDP 4.5