

M-14


RMG

BY

PM

DATE

JOB #

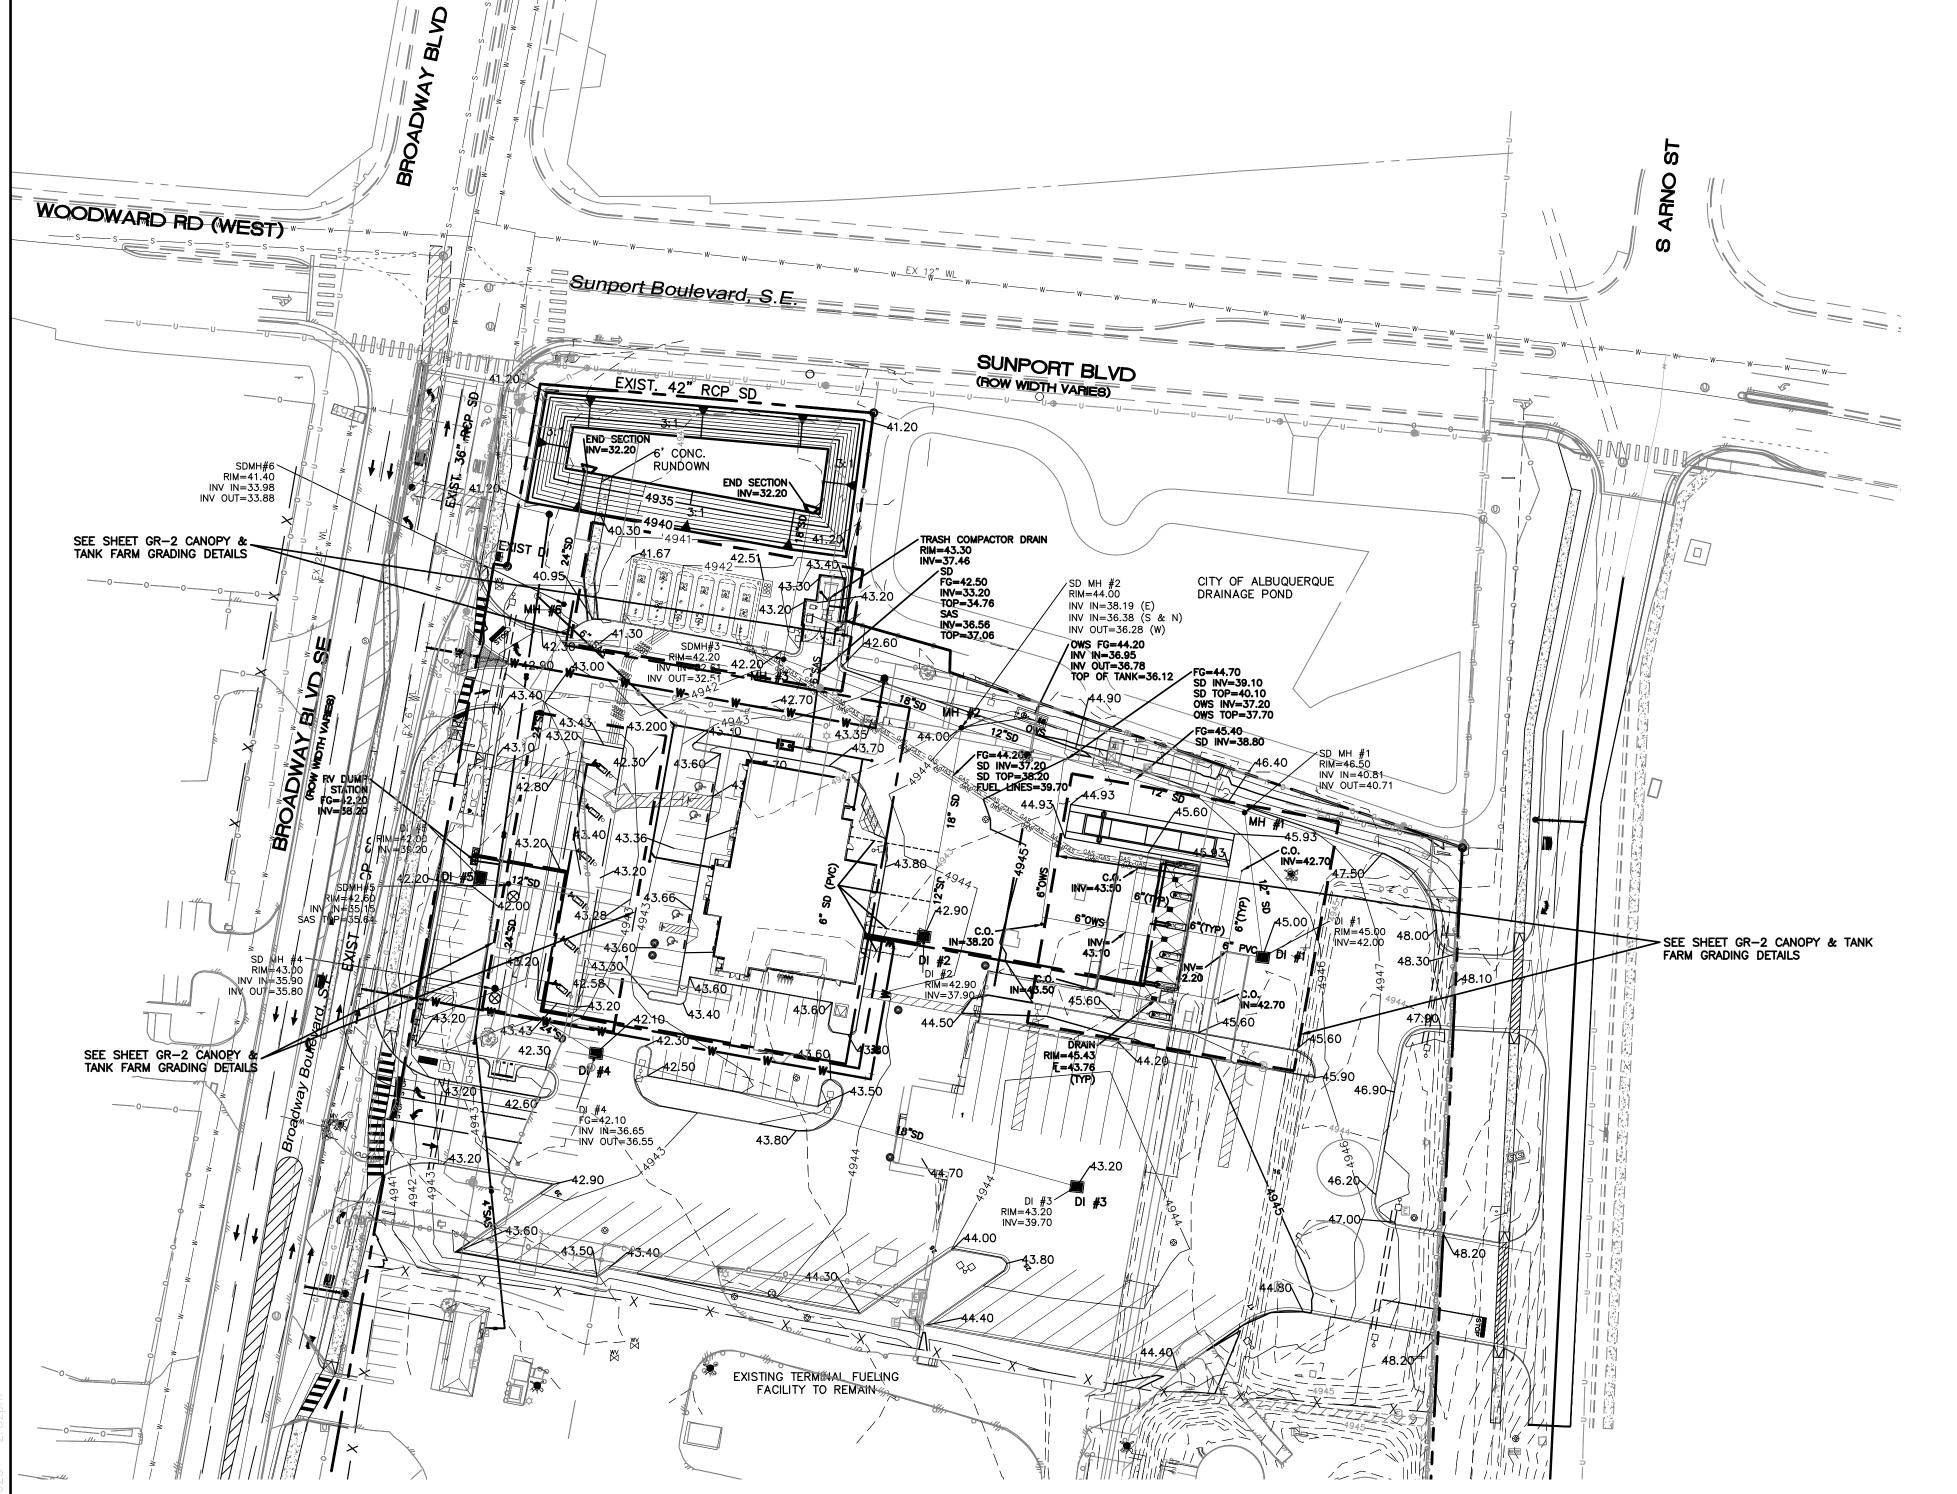


NOTICE TO CONTRACTORS

- 1. AN EXCAVATION/CONSTRUCTION PERMIT WILL BE REQUIRED BEFORE BEGINNING ANY WORK WITHIN CITY RIGHT-OF-WAY.
- 2. ALL WORK DETAILED ON THESE PLANS TO BE PERFORMED, EXCEPT AS OTHERWISE STATED OR PROVIDED HERON, SHALL BE CONSTRUCTED IN ACCORDANCE WITH CITY OF ALBUQUERQUE INTERIM STANDARD SPECIFICATIONS FOR PUBLIC WORKS CONSTRUCTION, 1985.
- 3. TWO WORKING DAYS PRIOR TO ANY EXCAVATION, CONTRACTOR MUST CONTACT LINE LOCATING SERVICE, 765-1234, FOR LOCATION OF EXISTING UTILITIES.
- 4. PRIOR TO CONSTRUCTION, THE CONTRACTOR SHALL EXCAVATE AND VERIFY THE HORIZONTAL AND VERTICAL LOCATIONS OF ALL CONNECTIONS. SHOULD A CONFLICT EXIST, THE CONTRACTOR SHALL NOTIFY THE ENGINEER SO THAT THE CONFLICT CAN BE RESOLVED WITH A MINIMUM AMOUNT OF DELAY.
- 5. BACKFILL COMPACTION SHALL BE ACCORDING TO TRAFFIC/STREET USE.
- MAINTENANCE OF THESE FACILITIES SHALL BE THE RESPONSIBILITY OF THE OWNER OF THE PROPERTY SERVED.
- 7. WORK ON ARTERIAL STREETS SHALL BE PERFORMED ON A 24-HOUR BASIS.

EROSION CONTROL NOTES:

- 1. CONTRACTOR IS RESPONSIBLE FOR OBTAINING A TOPSOIL DISTURBANCE PERMIT PRIOR TO BEGINNING WORK.
- 2. CONTRACTOR IS RESPONSIBLE FOR MAINTAINING RUN-OFF ON SITE DURING CONSTRUCTION.
- 3. CONTRACTOR IS RESPONSIBLE FOR CLEANING ALL SEDIMENT THAT GETS INTO EXISTING RIGHT-OF-WAY.
- 4. REPAIR OF DAMAGED FACILITIES AND CLEANUP OF SEDIMENT ACCUMULATIONS ON ADJACENT PROPERTIES AND IN PUBLIC FACILITIES IS THE RESPONSIBILITY OF THE CONTRACTOR.
- 5. ALL EXPOSED EARTH SURFACES MUST BE PROTECTED FROM WIND AND WATER EROSION PRIOR TO FINAL (CITY) ACCEPTANCE OF ANY PROJECT.
- 6. ALL SLOPES NOT STABILIZED AT THE END OF THE PROJECT SHALL BE STABILIZED IN ACCORDANCE WITH COA SPECS OR ₹ GRAVEL

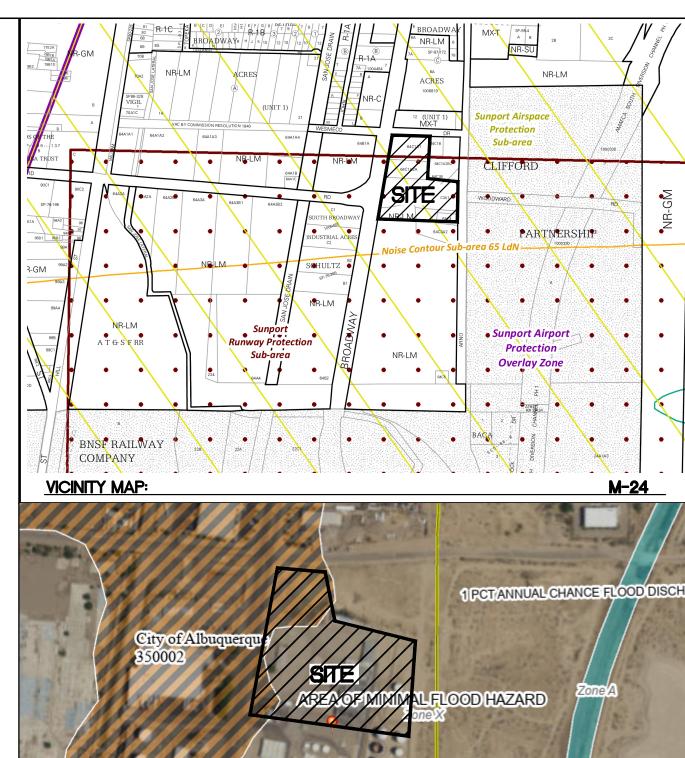

STRUCT	STRUCTURE TABLE						
STRUCTURE	SIZE/TYPE	RIM	INVERT				
MH#1	6' DIA	4946.50	4940.81 (IN)				
			44940.71 (OUT)				
MH#2	4' DIA	4944.00	4938.19 (EAST)				
			4936.38 (SOUTH &NORTH) 4936.28 (WEST)				
MH#3	4' DIA	4942.20	4932.61 (IN) 4932.51 (OUT)				
MH#4	4' DIA	4943.00	4935.90 (IN) 4935.80 (OUT)				
MH#5	4' DIA	4942.60	4935.15 (IN) 4935.64 (SAS TOP)				
MH#6	4' DIA	4941.40	4933.98 (IN) 4933.88 (OUT)				
DI #1	TYPE D	4945.00	4942.00				
DI #2	TYPE D	4942.90	4937.90				
DI #3	TYPE D	4943.20	4939.70				
DI #4	TYPE D	4942.10	4936.65 (IN) 4936.55 (OUT)				
DI #5	TYPE D	4942.00	4939.20				

LEGEND

	-
	CURB & GUTTER
	BOUNDARY LINE
	RIGHT-OF-WAY
	BUILDING
	SIDEWALK
5010	CONTOUR MAJOR
5011—	CONTOUR MINOR
x 5048.25	SPOT ELEVATION
-	FLOW ARROW
	EXISTING CURB & GUTTER
	EXISTING BOUNDARY LINE
5010	EXISTING CONTOUR MAJOR
	EXISTING CONTOUR MINOR

PARKING LOT LIGHT FIXTURE

35001C0342G

Weighted E Method

Zone 2 Developed B	Cone 2 Developed Basins													
Basin Area				Treatments					100-Year					
Basin	Area	Area	Area	Treatr	ment A	Treatr	ment B	Treatr	ment C	Treati	ment D	Weighted E	Volume	Flow
	(sf)	(acres)	(sq miles)	%	(acres)	%	(acres)	%	(acres)	%	(acres)	(ac-ft)	(ac-ft)	cfs
Loves	292,169.0	6.71	0.010	0%	0.00	25%	1.68	0%	0.00	75%	5.03	1.948	1.089	25.79
Total	292,169.0	6.707	0.01048		0.00		1.677		0.000		5.030		1.089	25.79

Equations:

Weighted E = Ea*Aa + Eb*Ab + Ec*Ac + Ed*Ad / (Total Area)
Volume = Weighted D * Total Area
Flow = Qa * Aa + Qb * Ab + Qc * Ac + Qd * Ad


 $V_{10-DAY} = V_{6HR} + A_D(P_{10DAYS} - P_{6HR})/12$ IN/FT $P_{10DAYS} = 3.67$ IN $P_{6HR} = 2.20$ IN


LOVE'S POND 100YR,24HR 47,417 CU.FT. 100YR, 10DAY 74,260 CU.FT.

DRAINAGE NARRATIVE:


THE PROPOSED LOVE'S TRAVEL CENTER IS TO BE CONSTRUCTED ON THE NORTHERN 6.71 ACRES OF THE EXISTING TERMINAL FUELING FACILITY. THE SITE IS CURRENTLY DEVELOPED WITH EXISTING BUILDINGS, PAVING AND ABOVE GROUND FUEL STORAGE TANKS. THE SITE CURRENTLY GENERALLY DRAINS FROM EAST TO WEST WITH SOME ONSITE PONDING AND SOME RUNOFF ENTERING THE BROADWAY BOULEVARD RIGHT OF WAY. THE EXISTING FACILITIES WITHIN THE NORTHERN 6.71 ACRES WILL BE REMOVED AND THE NEW LOVE'S CONSTRUCTED WITH AUTO AND TRUCK FUELING AREAS, A C-STORE, A CAT SCALE, AND ASSOCIATED PARKING FIELDS. DRAINAGE FROM THE PROPOSED DEVELOPMENT WILL BE CONVEYED TO A PROPOSED RETENTION POND LOCATED IN THE NORTHWEST CORNER OF THE SITE. THE POND WILL HAVE THE CAPACITY TO RETAIN THE 100-YEAR, 10-DAY STORM VOLUME.

DRAINAGE ON THE EXISTING TERMINAL FUELING FACILITY SOUTH OF THE LOVE'S TRAVEL CENTER DEVELOPMENT WILL REMAIN AS IT CURRENTLY EXISTS.

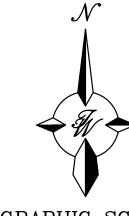

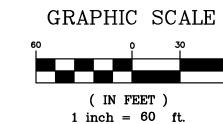

REV.				
1	05-13-2024	BUILDING PERMIT COMMENTS		RMG
NO.	DATE	REMARKS		BY
_	•	REVISIONS		
	ENGINEER'S SEAL	LOVE'S BROADWAY/ SUNPORT BLVD	DF	<i>RAWN BY</i> sb
		SONI ONI BLVD	<i>DATE</i> 3–27–25	
	CENT P. CAG	GRADING PLAN		
THE METERS		A LAIN		
CELEGI	16212		S	SHEET #
	3-27.2	5571 MIDWAY PARK PL NE ALBUQUERQUE, NEW MEXICO 87109		GR-1
	ENT P. CARRICA #16212	(505) 858-3100		<i>JOB #</i> 022031

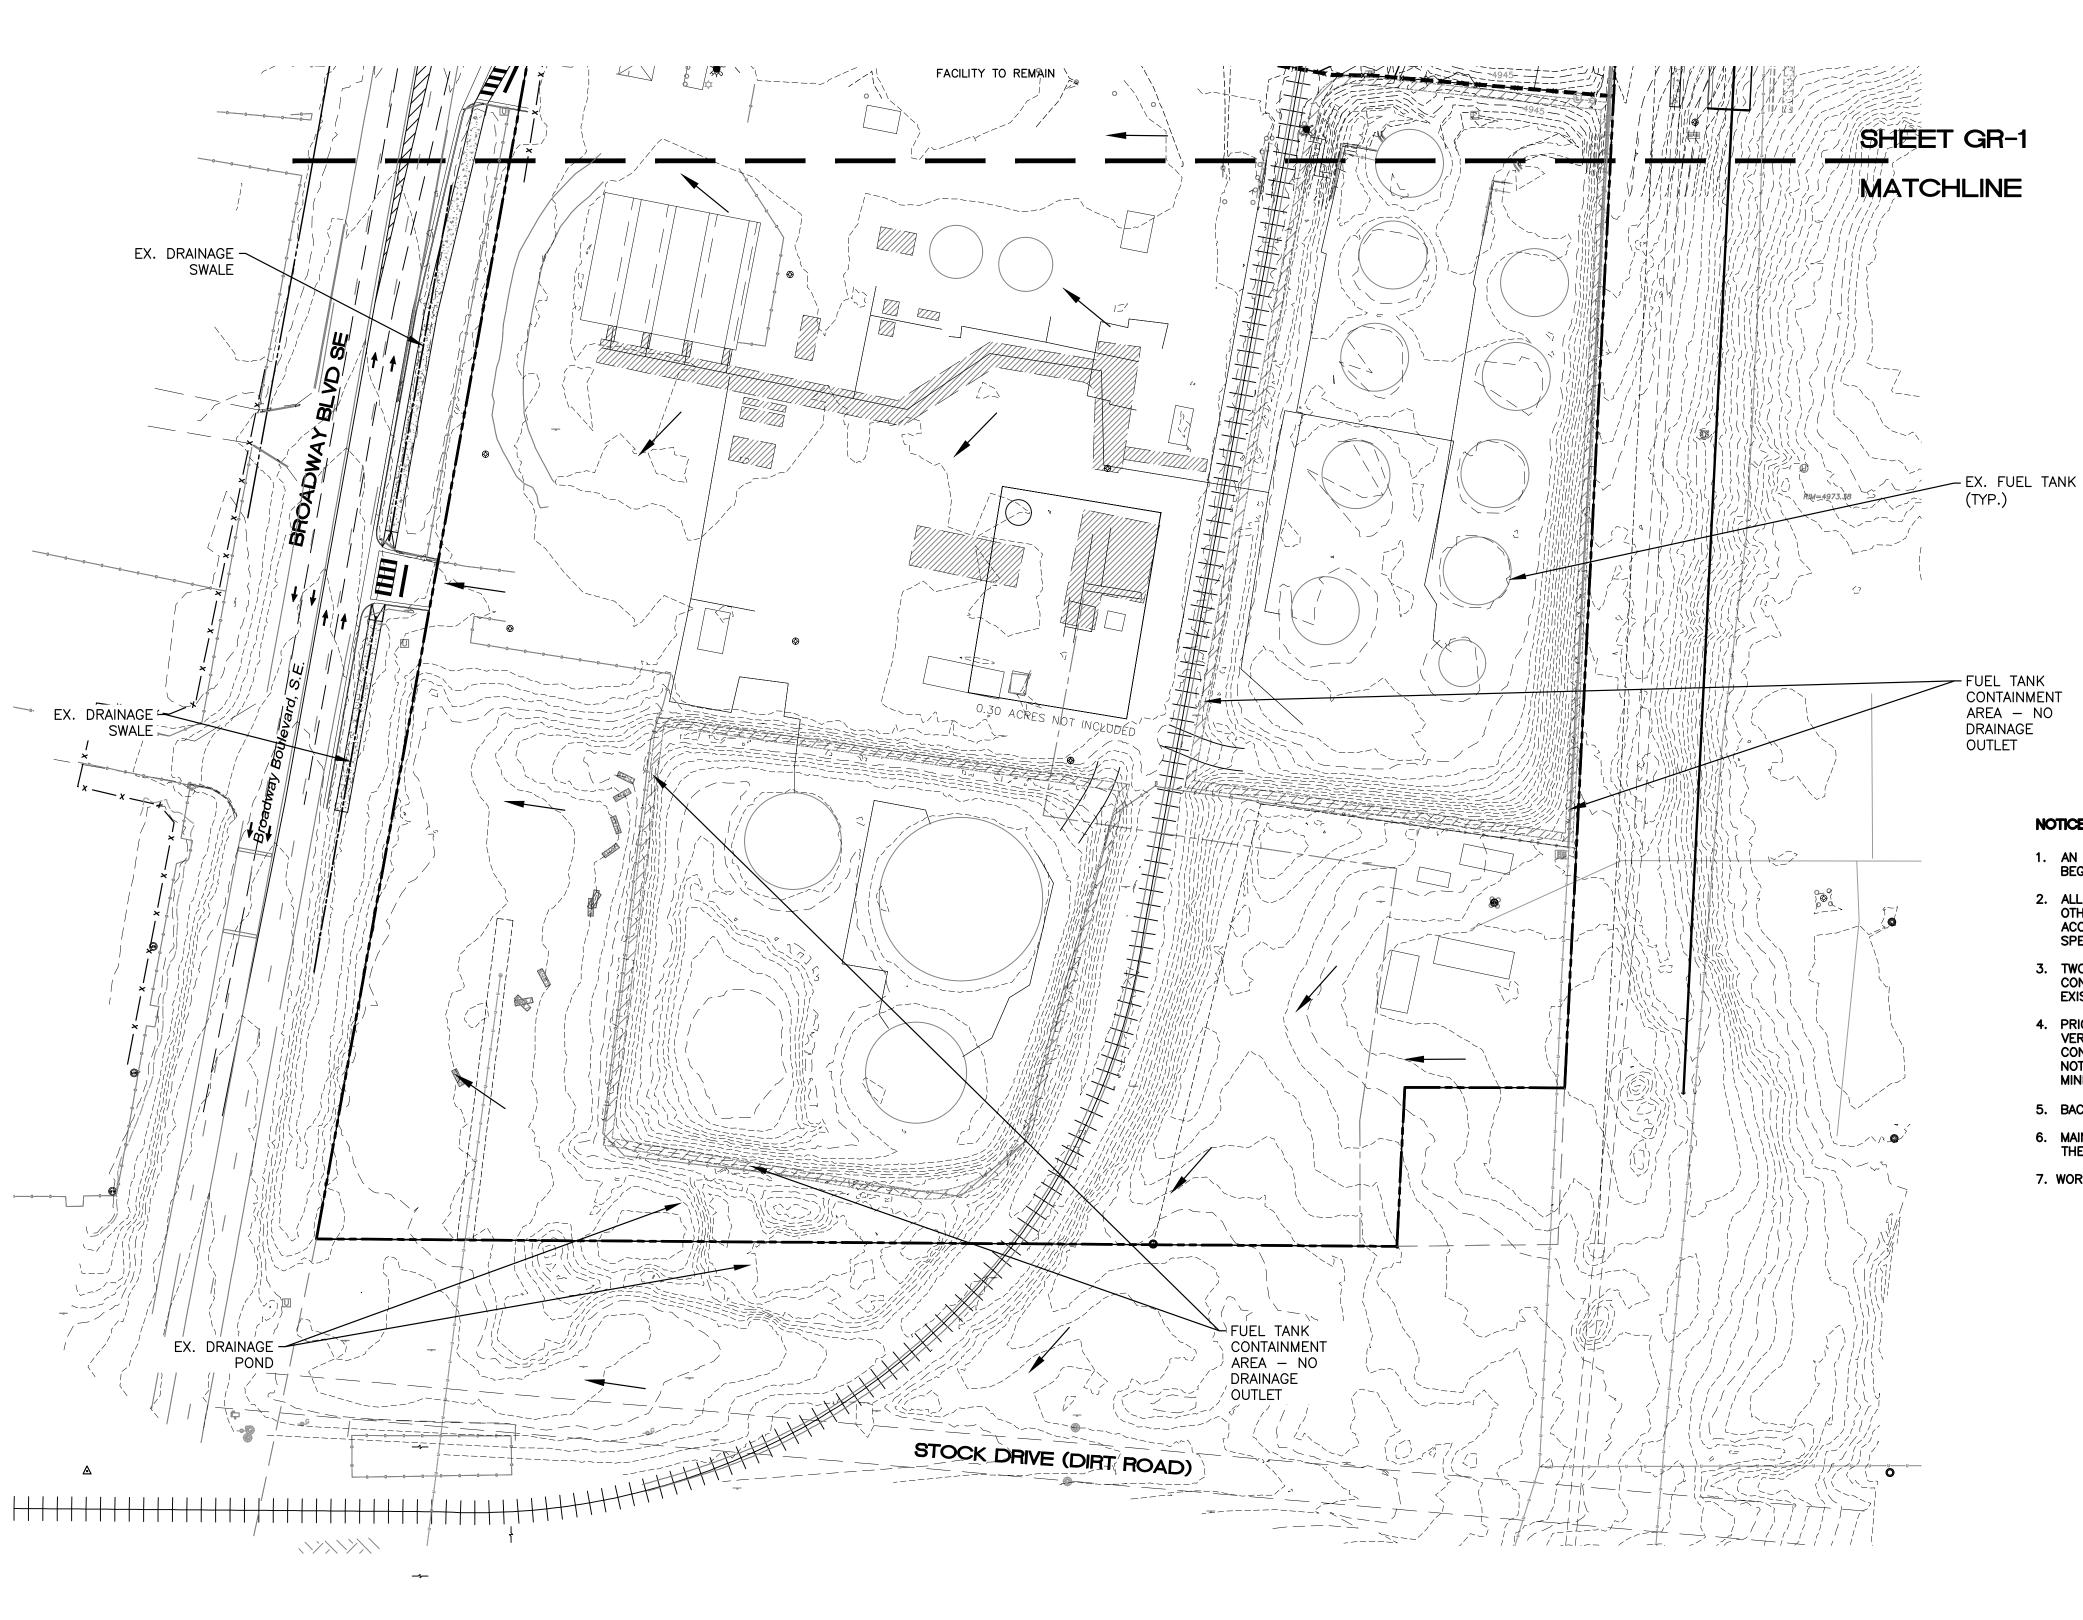

LEGEND CURB & GUTTER BOUNDARY LINE — RIGHT—OF—WAY — BUILDING SIDEWALK 5010——— CONTOUR MAJOR 5011—CONTOUR MINOR SPOT ELEVATION x 5048.25 FLOW ARROW ======= EXISTING CURB & GUTTER EXISTING BOUNDARY LINE EXISTING CONTOUR MAJOR

EXISTING CONTOUR MINOR

NOTE: THE EXISTING FUELING DEPOT ON THE SOUTHERN 15 ACRE (±) PORTION OF THE SITE IS TO REMAIN AS DEVELOPÉD AND IS INCLUDED AS AN AS-BUILT FOR CLARITY AND COMPLIANCE MOVING FORWARD

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SPECIFICATIONS FOR PUBLIC WORKS CONSTRUCTION, 1985.

- 4. PRIOR TO CONSTRUCTION, THE CONTRACTOR SHALL EXCAVATE AND VERIFY THE HORIZONTAL AND VERTICAL LOCATIONS OF ALL CONNECTIONS. SHOULD A CONFLICT EXIST, THE CONTRACTOR SHALL NOTIFY THE ENGINEER SO THAT THE CONFLICT CAN BE RESOLVED WITH A MINIMUM AMOUNT OF DELAY.
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GRAPHIC SCALE

(IN FEET) 1 inch = 60 ft.

3–27–25

ENGINEER'S

BROADWAY/SUNPORT BLVD GRADING AND DRAINAGE PLAN

TIERRA WEST, LLC 5571 MIDWAY PARK PLACE NE ALBUQUERQUE, NM 87109 (505) 858-3100

www.tierrawestllc.com

GR-2 JOB # 2022031

DRAWN BY

PM


DATE 3-27-25


2022031_GR PLAN

SHEET #

CAUTION

ALL EXISTING UTILITIES SHOWN WERE OBTAINED FROM RESEARCH, AS-BUILTS, SURVEYS OR INFORMATION PROVIDED BY OTHERS. IT SHALL BE THE SOLE RESPONSIBILITY OF THE CONTRACTOR TO CONDUCT ALL NECESSARY FIELD INVESTIGATIONS PRIOR TO AND INCLUDING ANY EXCAVATION, TO DETERMINE THE ACTUAL LOCATION OF UTILITIES AND OTHER IMPROVEMENTS, PRIOR TO STARTING THE WORK. ANY CHANGES FROM THIS PLAN SHALL BE COORDINATED WITH AND APPROVED BY THE ENGINEER.

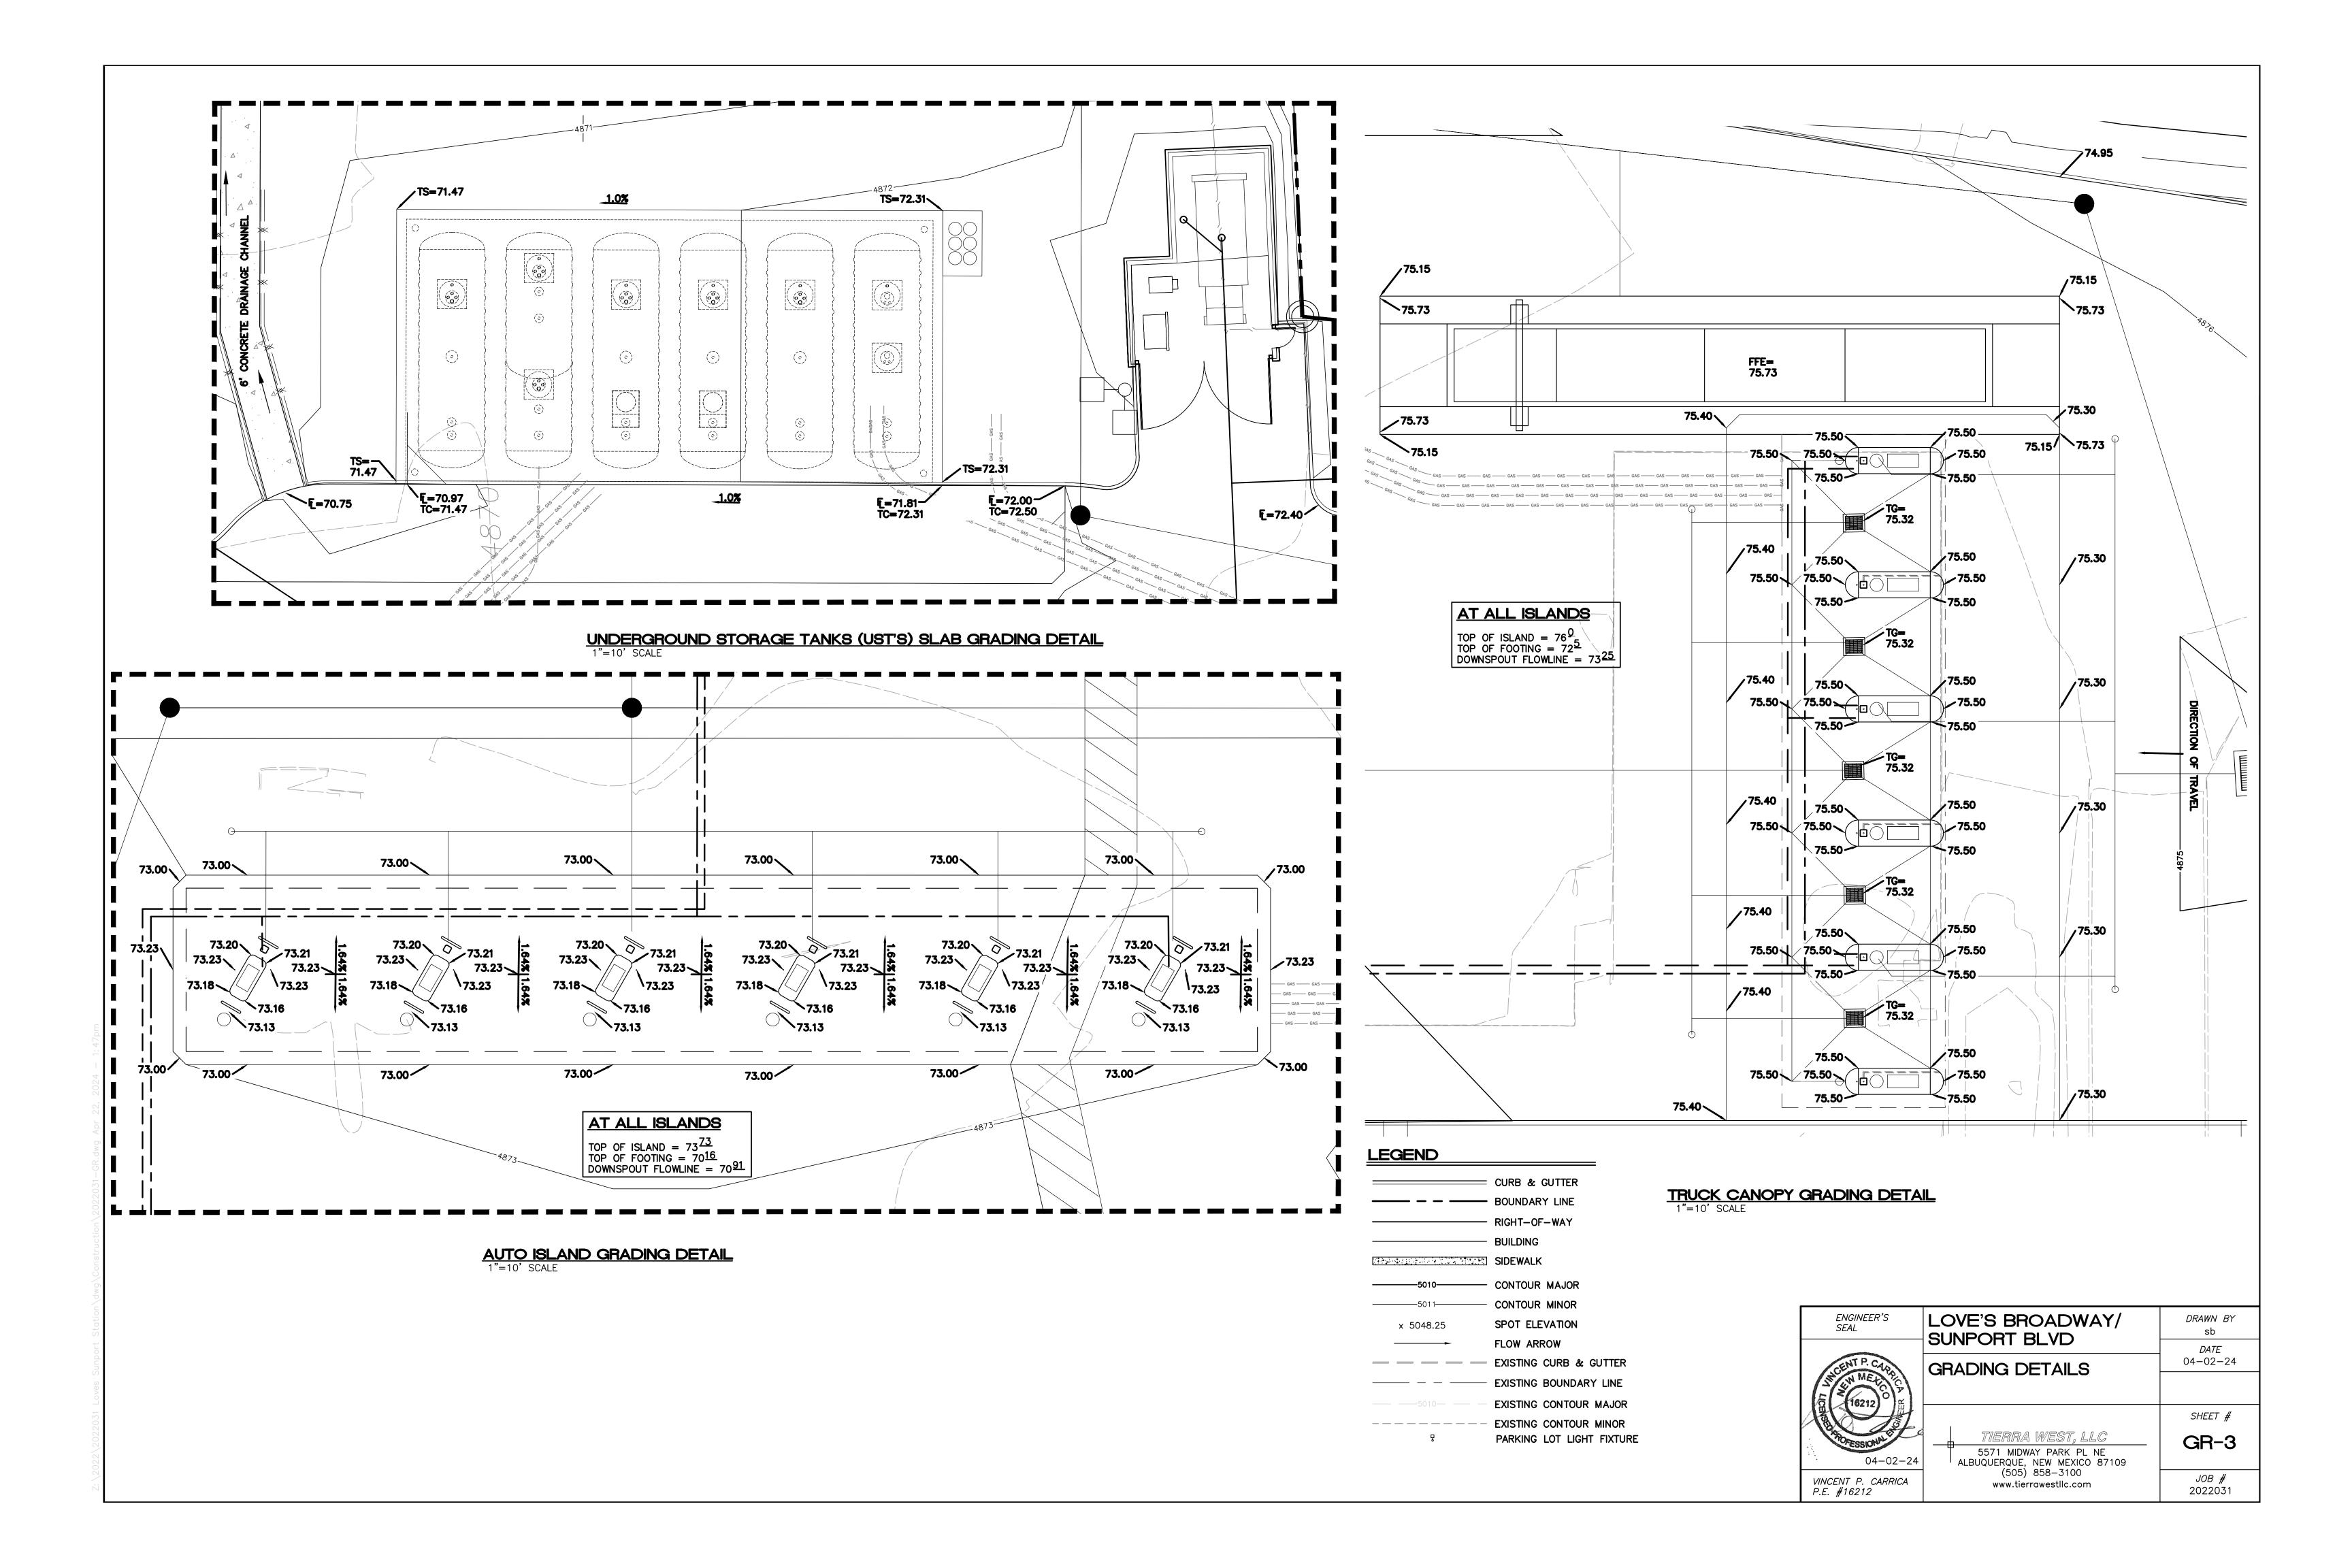

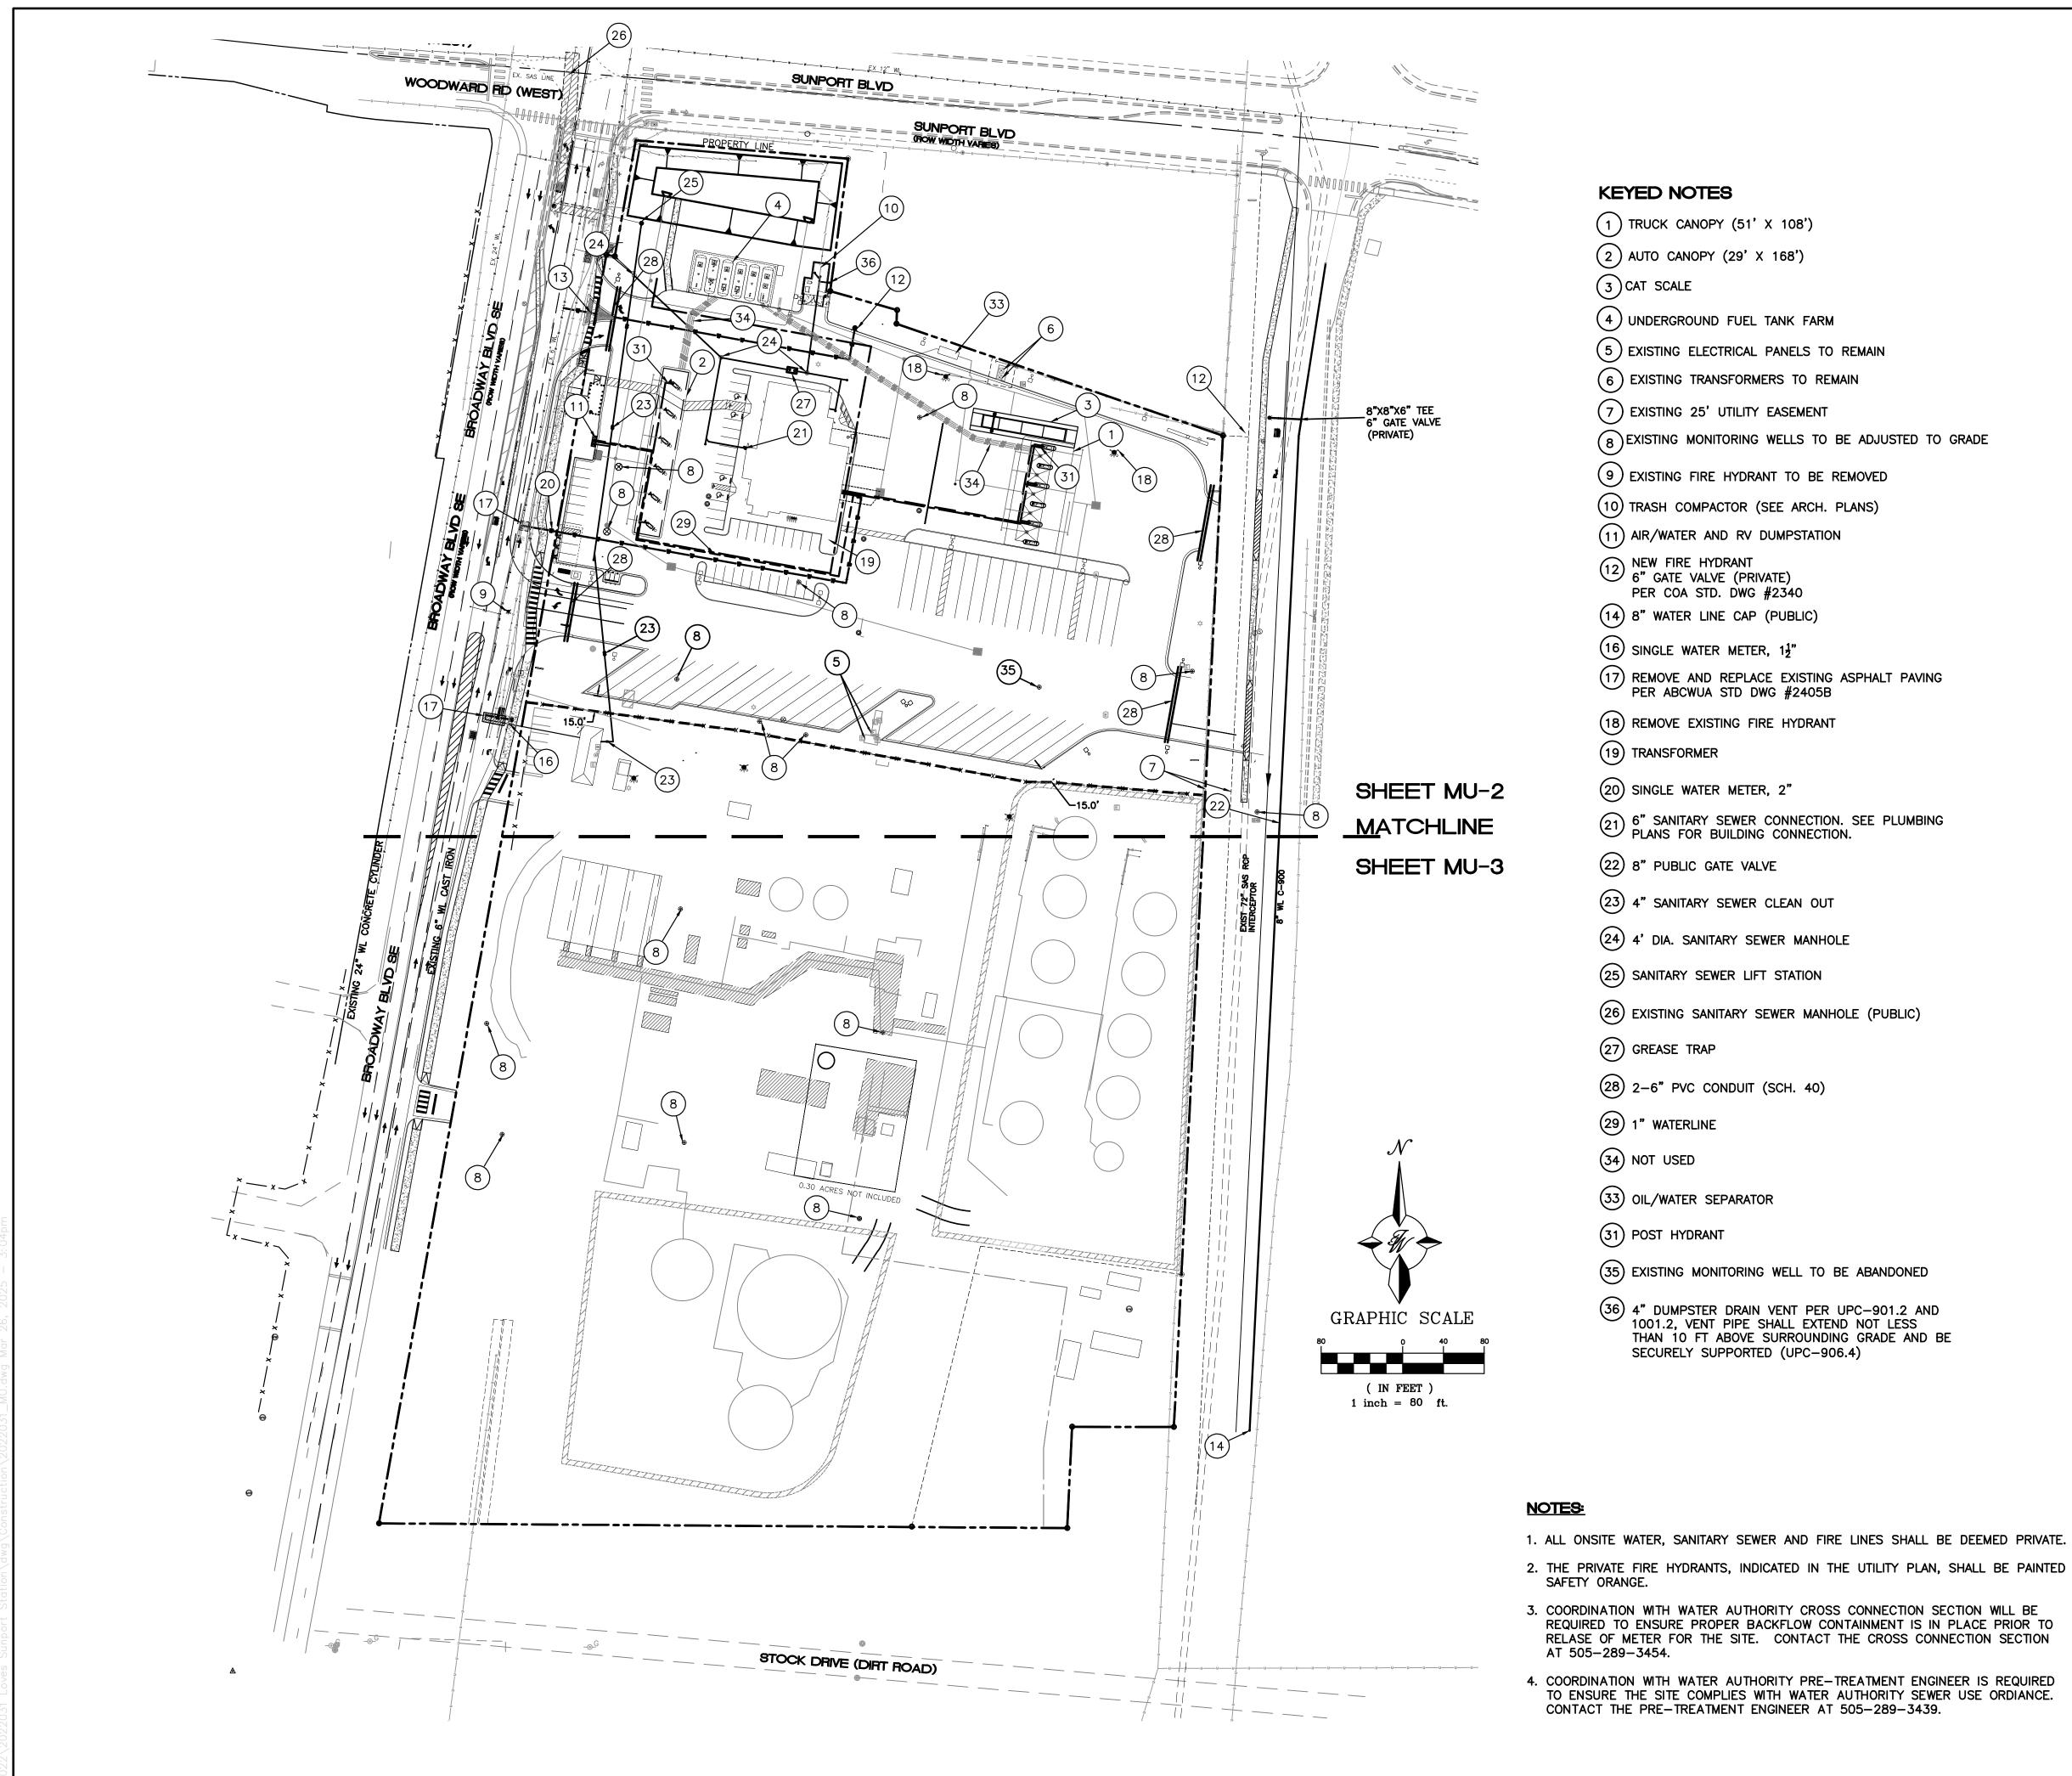

KEYED NOTES

- (1) TRUCK CANOPY (51' X 108')
- (2) AUTO CANOPY (29' X 168')
- 3 CAT SCALE
- (4) UNDERGROUND FUEL TANK FARM
- (5) EXISTING ELECTRICAL PANELS TO REMAIN
- (6) EXISTING TRANSFORMERS TO REMAIN
- 7 EXISTING 25' UTILITY EASEMENT
- 8 EXISTING MONITORING WELLS TO BE ADJUSTED TO GRADE
- (9) EXISTING FIRE HYDRANT TO BE REMOVED
- (10) TRASH COMPACTOR (SEE ARCH. PLANS)
- (11) AIR/WATER AND RV DUMPSTATION
- NEW FIRE HYDRANT
 6" GATE VALVE (PRIVATE) PER COA STD. DWG #2340
- (14) 8" WATER LINE CAP (PUBLIC)
- 16) SINGLE WATER METER, 1½"
- 17) REMOVE AND REPLACE EXISTING ASPHALT PAVING PER ABCWUA STD DWG #2405B
- (18) REMOVE EXISTING FIRE HYDRANT
- (19) TRANSFORMER
- 20) SINGLE WATER METER, 2"
- 6" SANITARY SEWER CONNECTION. SEE PLUMBING PLANS FOR BUILDING CONNECTION.
- 22) 8" PUBLIC GATE VALVE
- (23) 4" SANITARY SEWER CLEAN OUT
- (24) 4' DIA. SANITARY SEWER MANHOLE
- (25) SANITARY SEWER LIFT STATION
- (26) EXISTING SANITARY SEWER MANHOLE (PUBLIC)
- 27) GREASE TRAP
- 28) 2-6" PVC CONDUIT (SCH. 40)
- 29) 1" WATERLINE
- 34) NOT USED
- (33) OIL/WATER SEPARATOR
- (31) POST HYDRANT
- (35) EXISTING MONITORING WELL TO BE ABANDONED
- 36 4" DUMPSTER DRAIN VENT PER UPC-901.2 AND 1001.2, VENT PIPE SHALL EXTEND NOT LESS THAN 10 FT ABOVE SURROUNDING GRADE AND BE SECURELY SUPPORTED (UPC-906.4)

VICINITY MAP: MAP44 TR 64C2 EXC 03.0 ACX ALL TR 64C3A2 CONT 31.43 AC UPC 101405533908840121

NOTES

1. COORDINATION WITH WATER AUTHORITY CROSS CONNECTION SECTION WILL BE REQUIRED TO ENSURE PROPERT BACKFLOW CONTAINMENT IS IN PLACE PRIOR TO RELEASE OF METER FOR THE SITE. CONTACT THE CROSS CONNETION SECTION AT 505-289-3454. 2. COORDINATION OWITH THE WATER AUTHORITY PRE-TREATMENT ENGINEER IS REQUIRED TO ENSURE THE SITE COMPLIES WITH WATER AUTHORITY SEWER USE ORDINANCE. CONTACT THE PRE-TREATMENT ENGINEER AT

PARTMERSHIP

M-14

LEGEND

505-289-3439.

CURB & GUTTER ---- BOUNDARY LINE EASEMENT BUILDING SIDEWALK EXISTING CURB & GUTTER 36" SD——— STORM SEWER LINE PROPOSED SANITARY SEWER LINE ——w——w—— PROPOSED WATERLINE --- EX. 8" SAS--- EXISTING SANITARY SEWER LINE PROPOSED HYDRANT PARKING LOT LIGHT FIXTURE


CAUTION


---- SAWCUT


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ENGINEER'S SEAL RONALD R. BOHA P.E. #7868

S	BROADWAY/SUNPORT	DRAWN BY PM
	BLVD OVERALL	<i>DATE</i> 3–27–25
	UTILITY PLAN	2022031_MU
		SHEET #
-25	TIERRA WEST, LLC 5571 MIDWAY PARK PLACE NE ALBUQUERQUE, NM 87109	MU-1
HANNAN	(505) 858-3100 www.tierrawestllc.com	Јов # 2022031



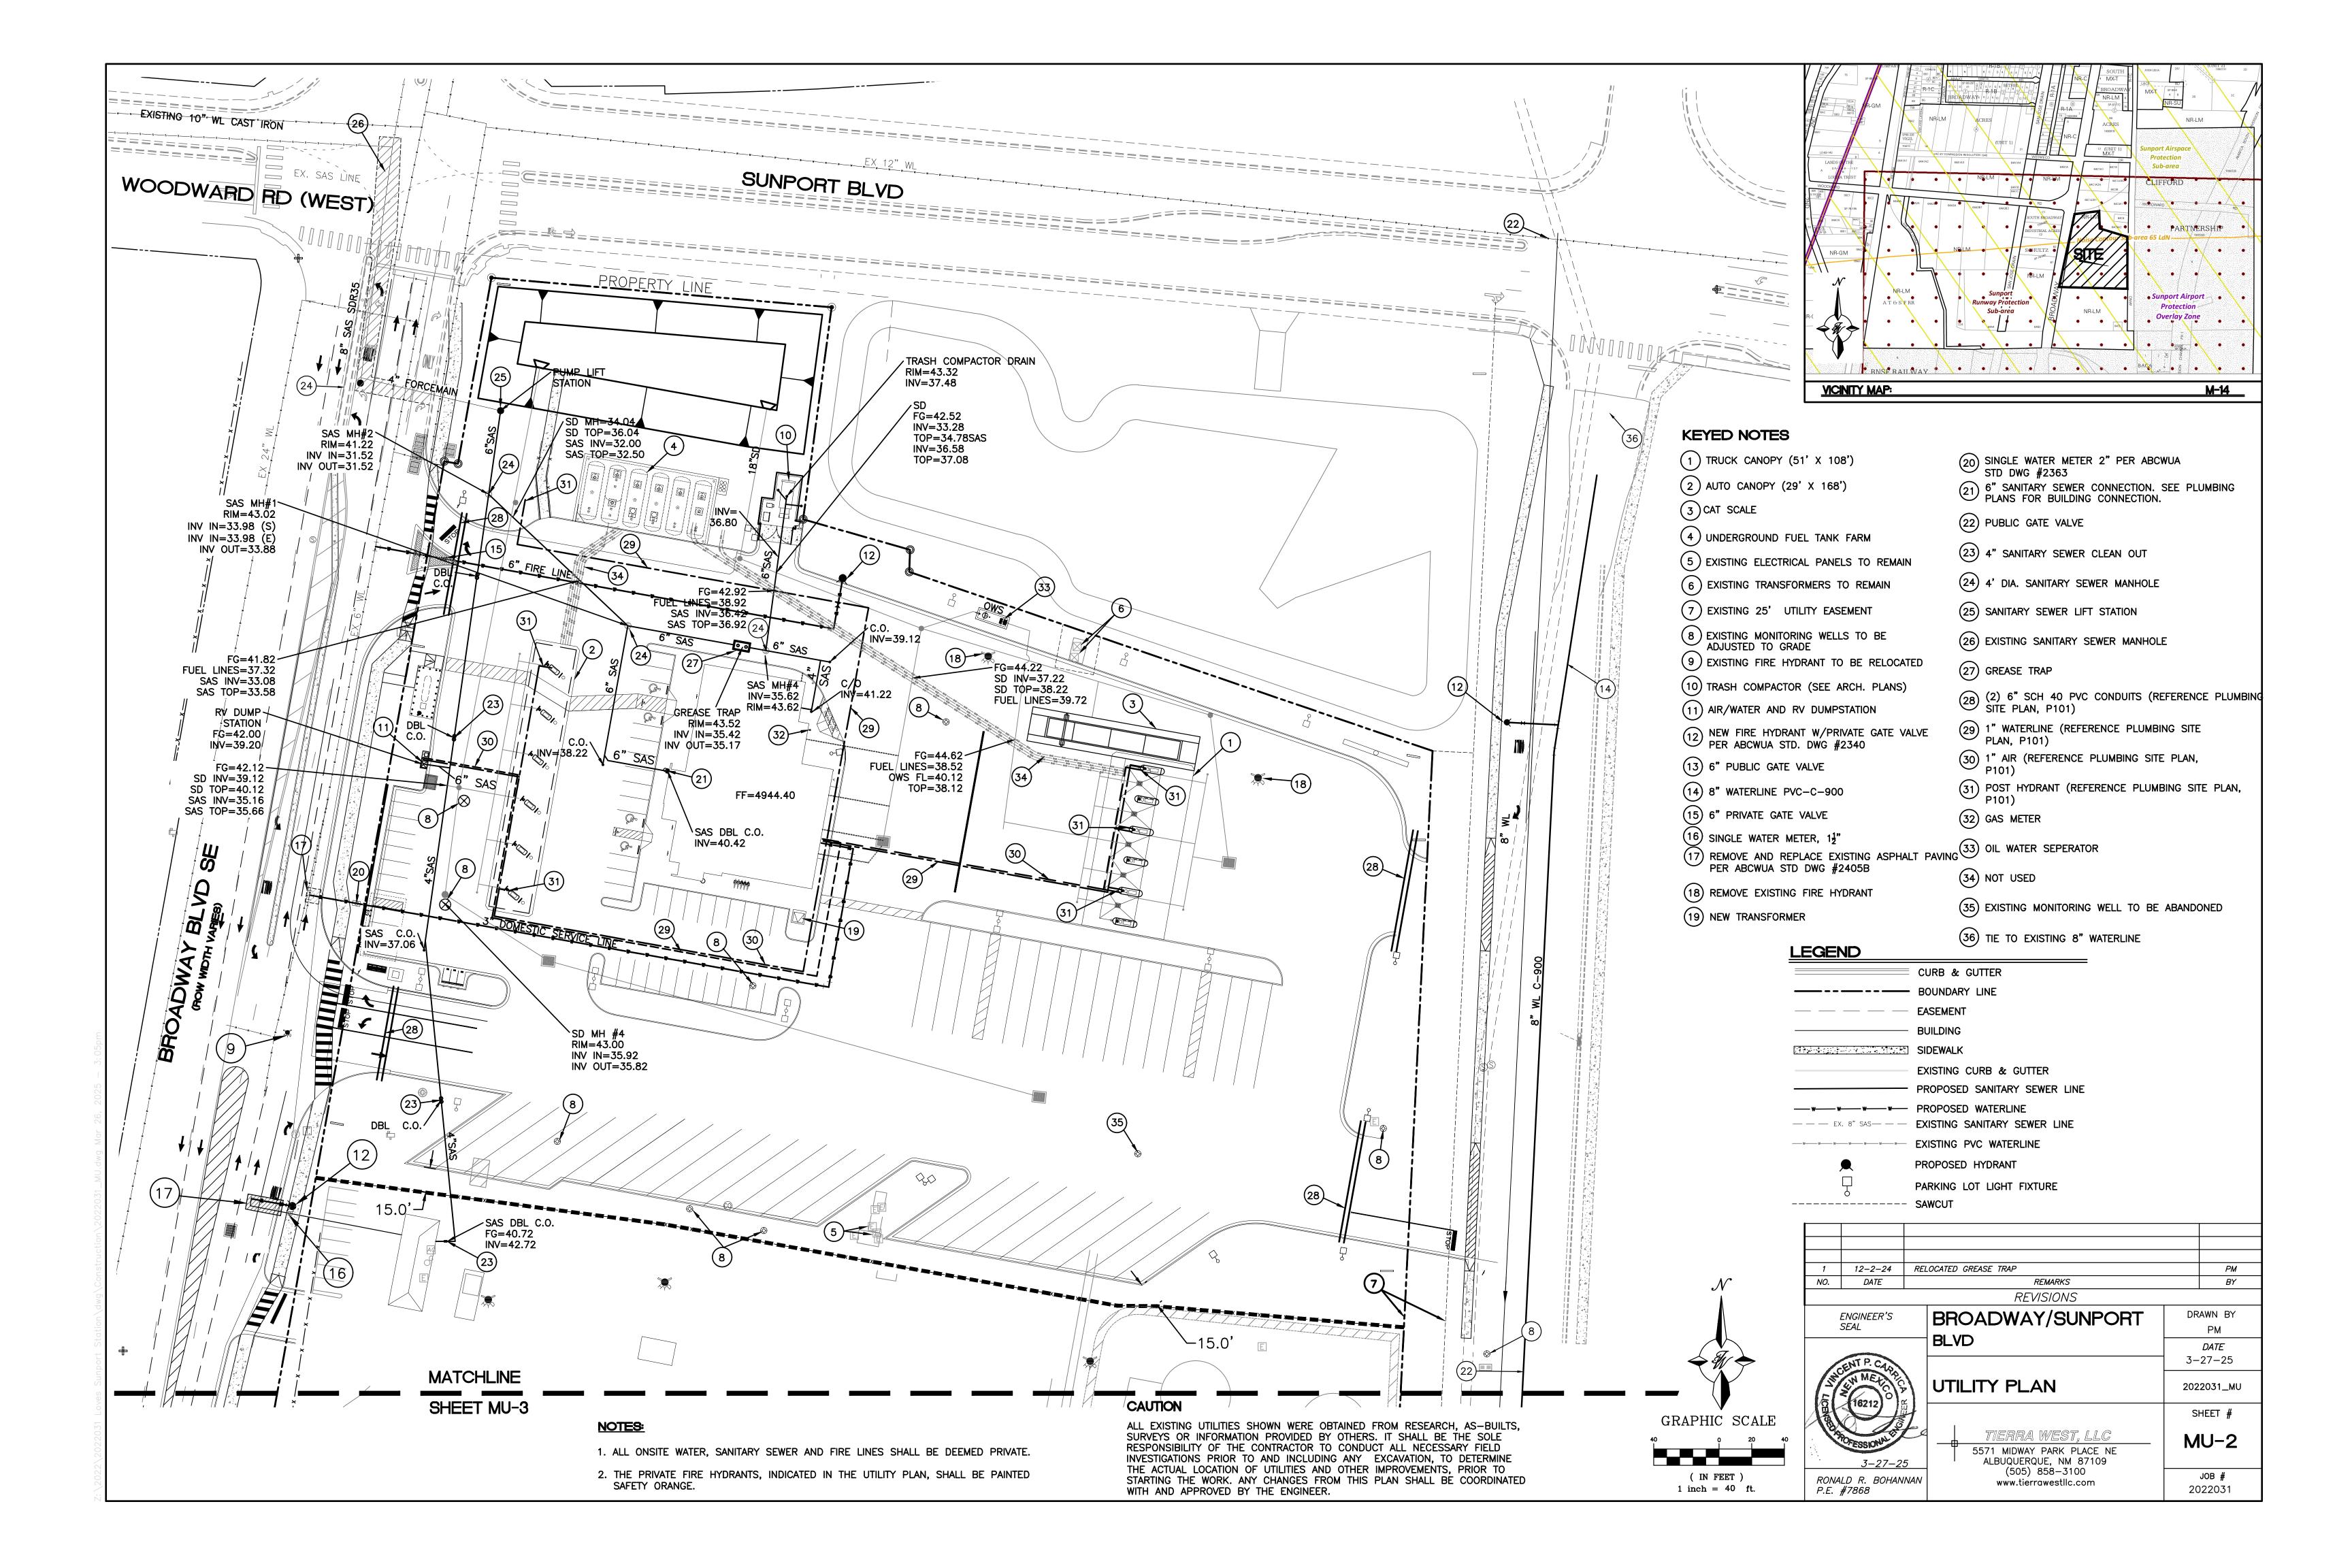

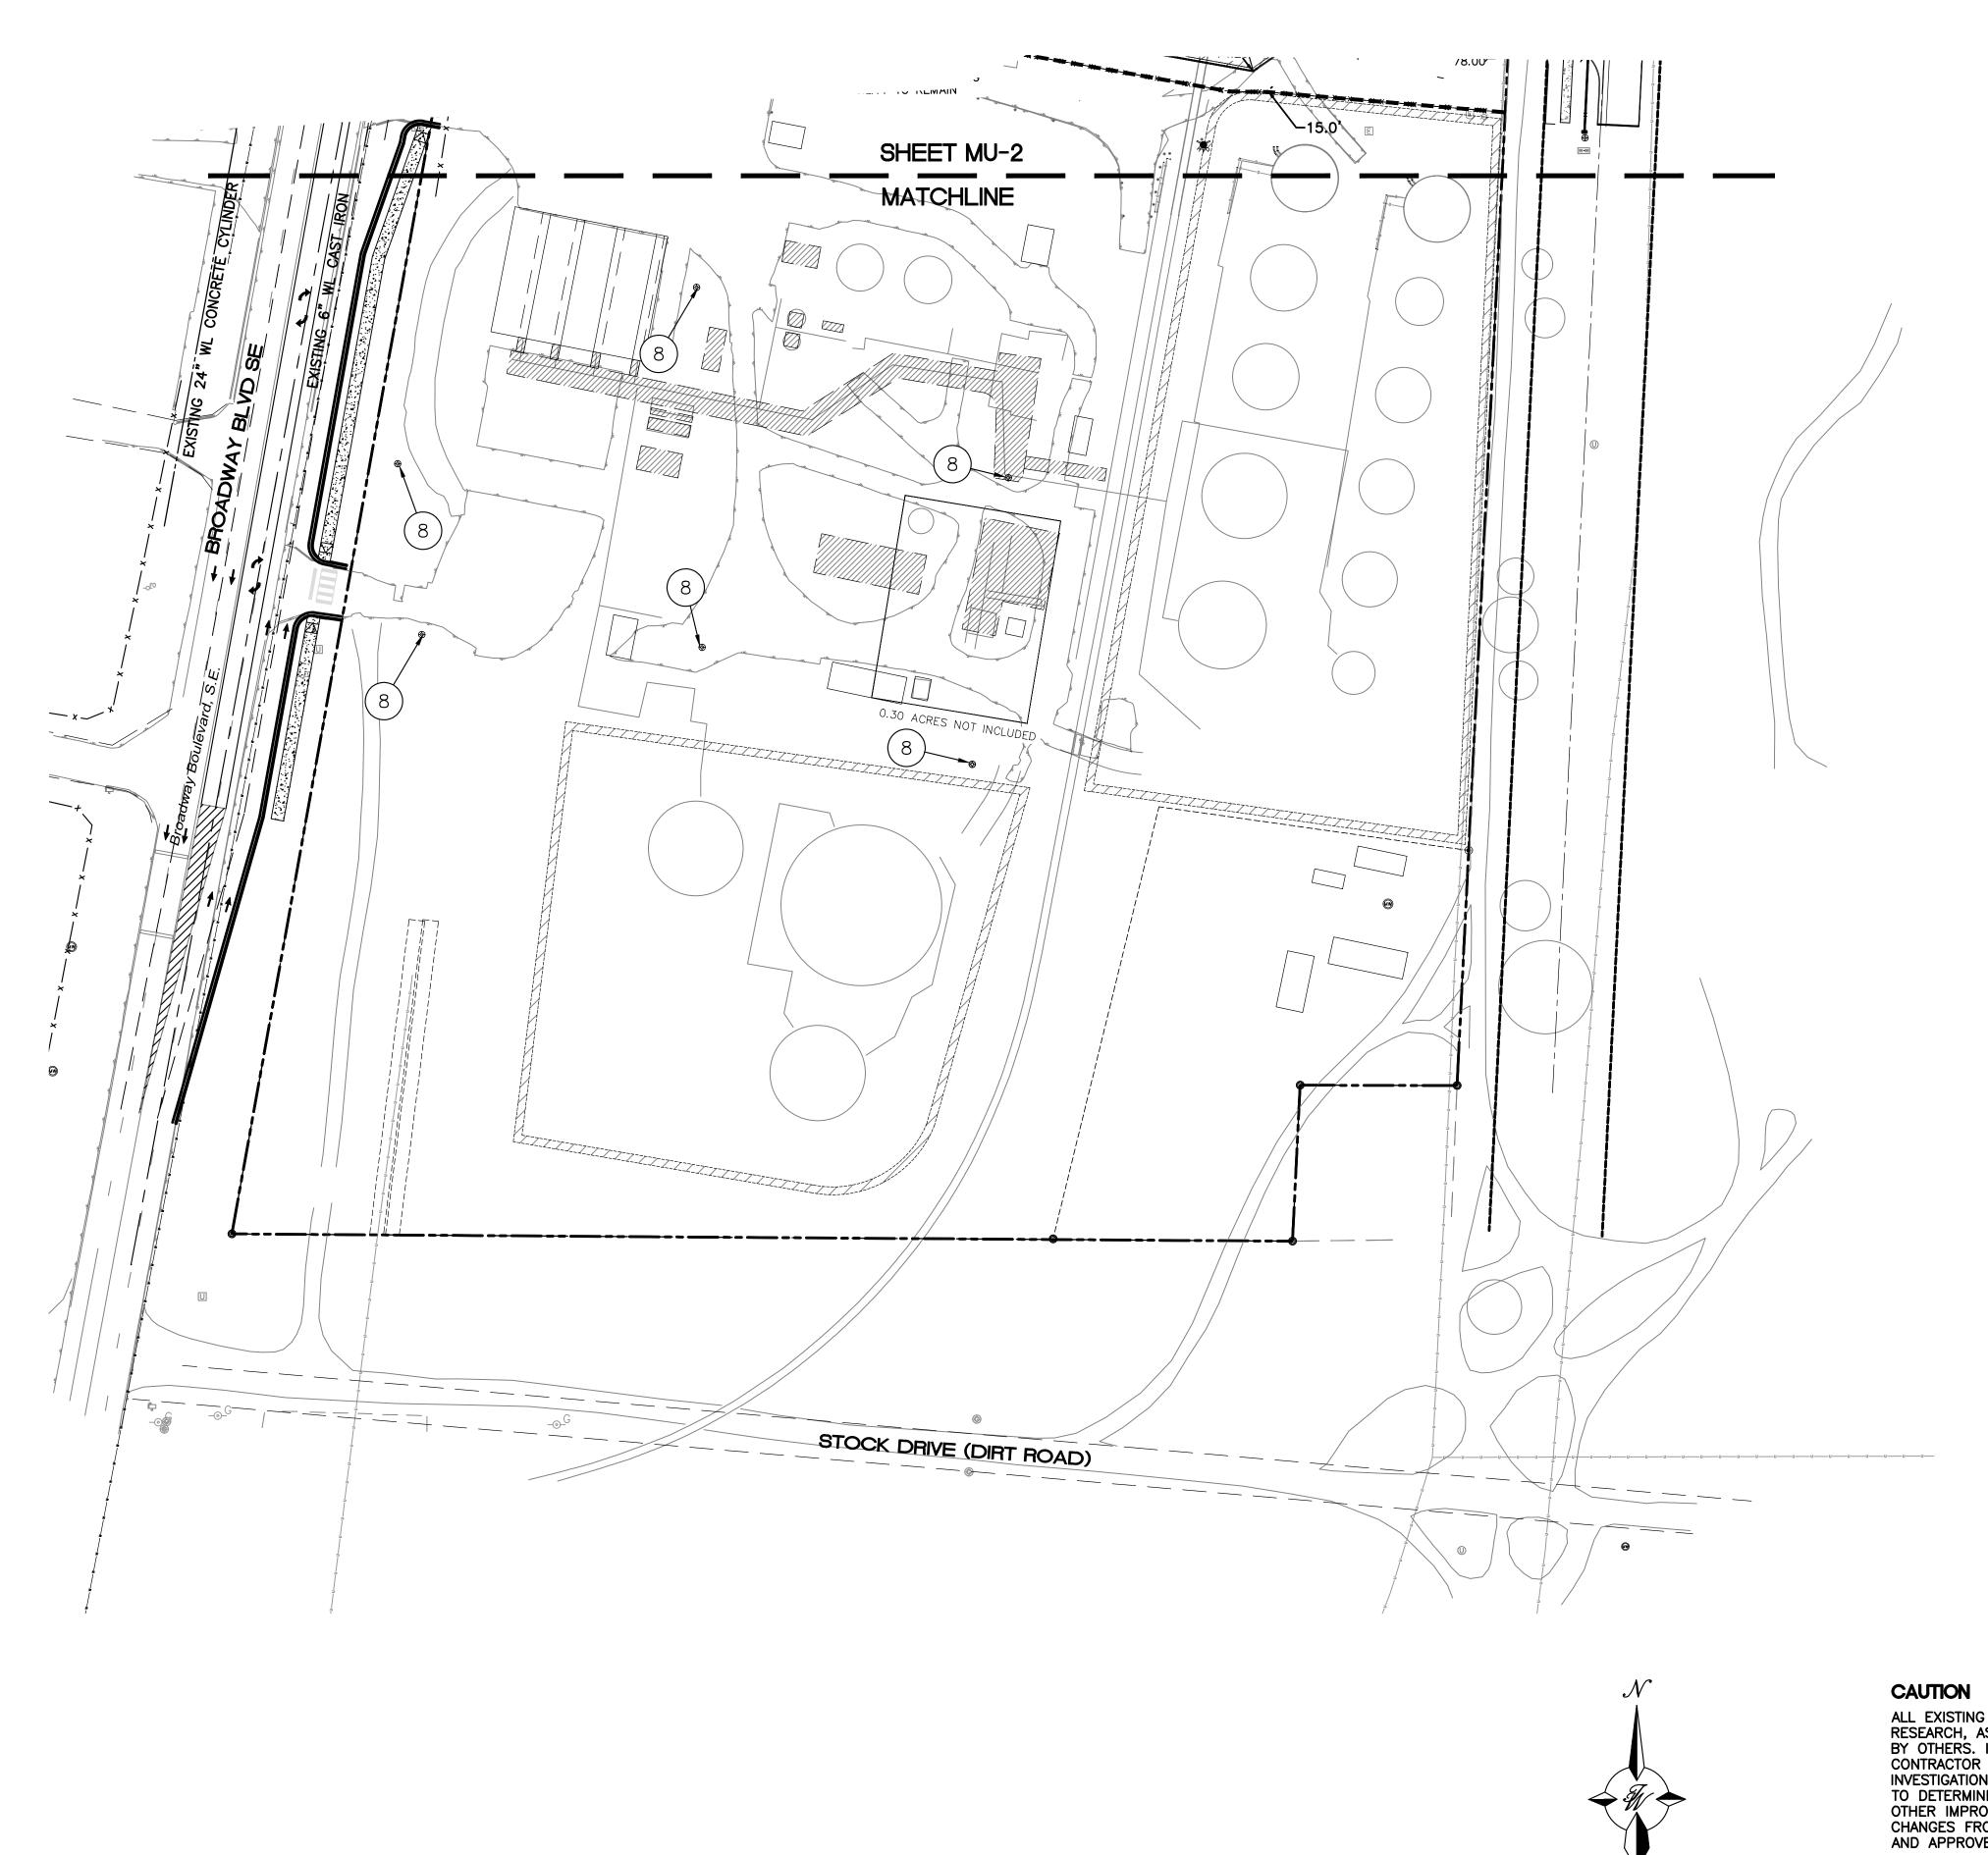

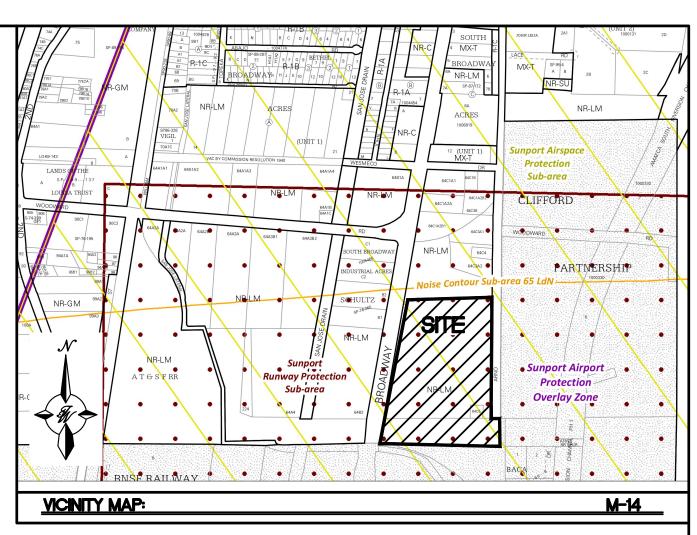MAP44 TR 64C2 EXC 03.0 ACX ALL TR 64C3A2 CONT 31.43 AC UPC 101405533908840121

KEYED NOTES

8 EXISTING MONITORING WELLS TO REMAIN

NOTE: THE EXISTING FUELING DEPOT ON THE SOUTHERN 15 ACRE (±) PORTION OF THE SITE IS TO REMAIN AS DEVELOPED AND IS INCLUDED AS AN AS-BUILT FOR CLARITY AND COMPLIANCE MOVING FORWARD

LEGEND

CURB & GUTTER ---- BOUNDARY LINE — — — EASEMENT BUILDING SIDEWALK EXISTING CURB & GUTTER PROPOSED SANITARY SEWER LINE — w— w— w— PROPOSED WATERLINE ——— EX. 8" SAS——— **EXISTING SANITARY SEWER LINE** PROPOSED HYDRANT

ENGINEER'S SEAL

VIRIOFINITO PR. CABRIGIANAN P.E.E.##9868 www.tierrawestllc.com

LOVE'S BROADWAY DRAWN BY SB /SUNPORT BLVD DATE 04/02/24 FUELING DEPOT EXISTING UTILITY ASBUILT PLAN 2022031_MU SHEET # TIERRA WEST, LLC MU-35571 MIDWAY PARK PLACE NE ALBUQUERQUE, NM 87109 (505) 858-3100 JOB #

2022031

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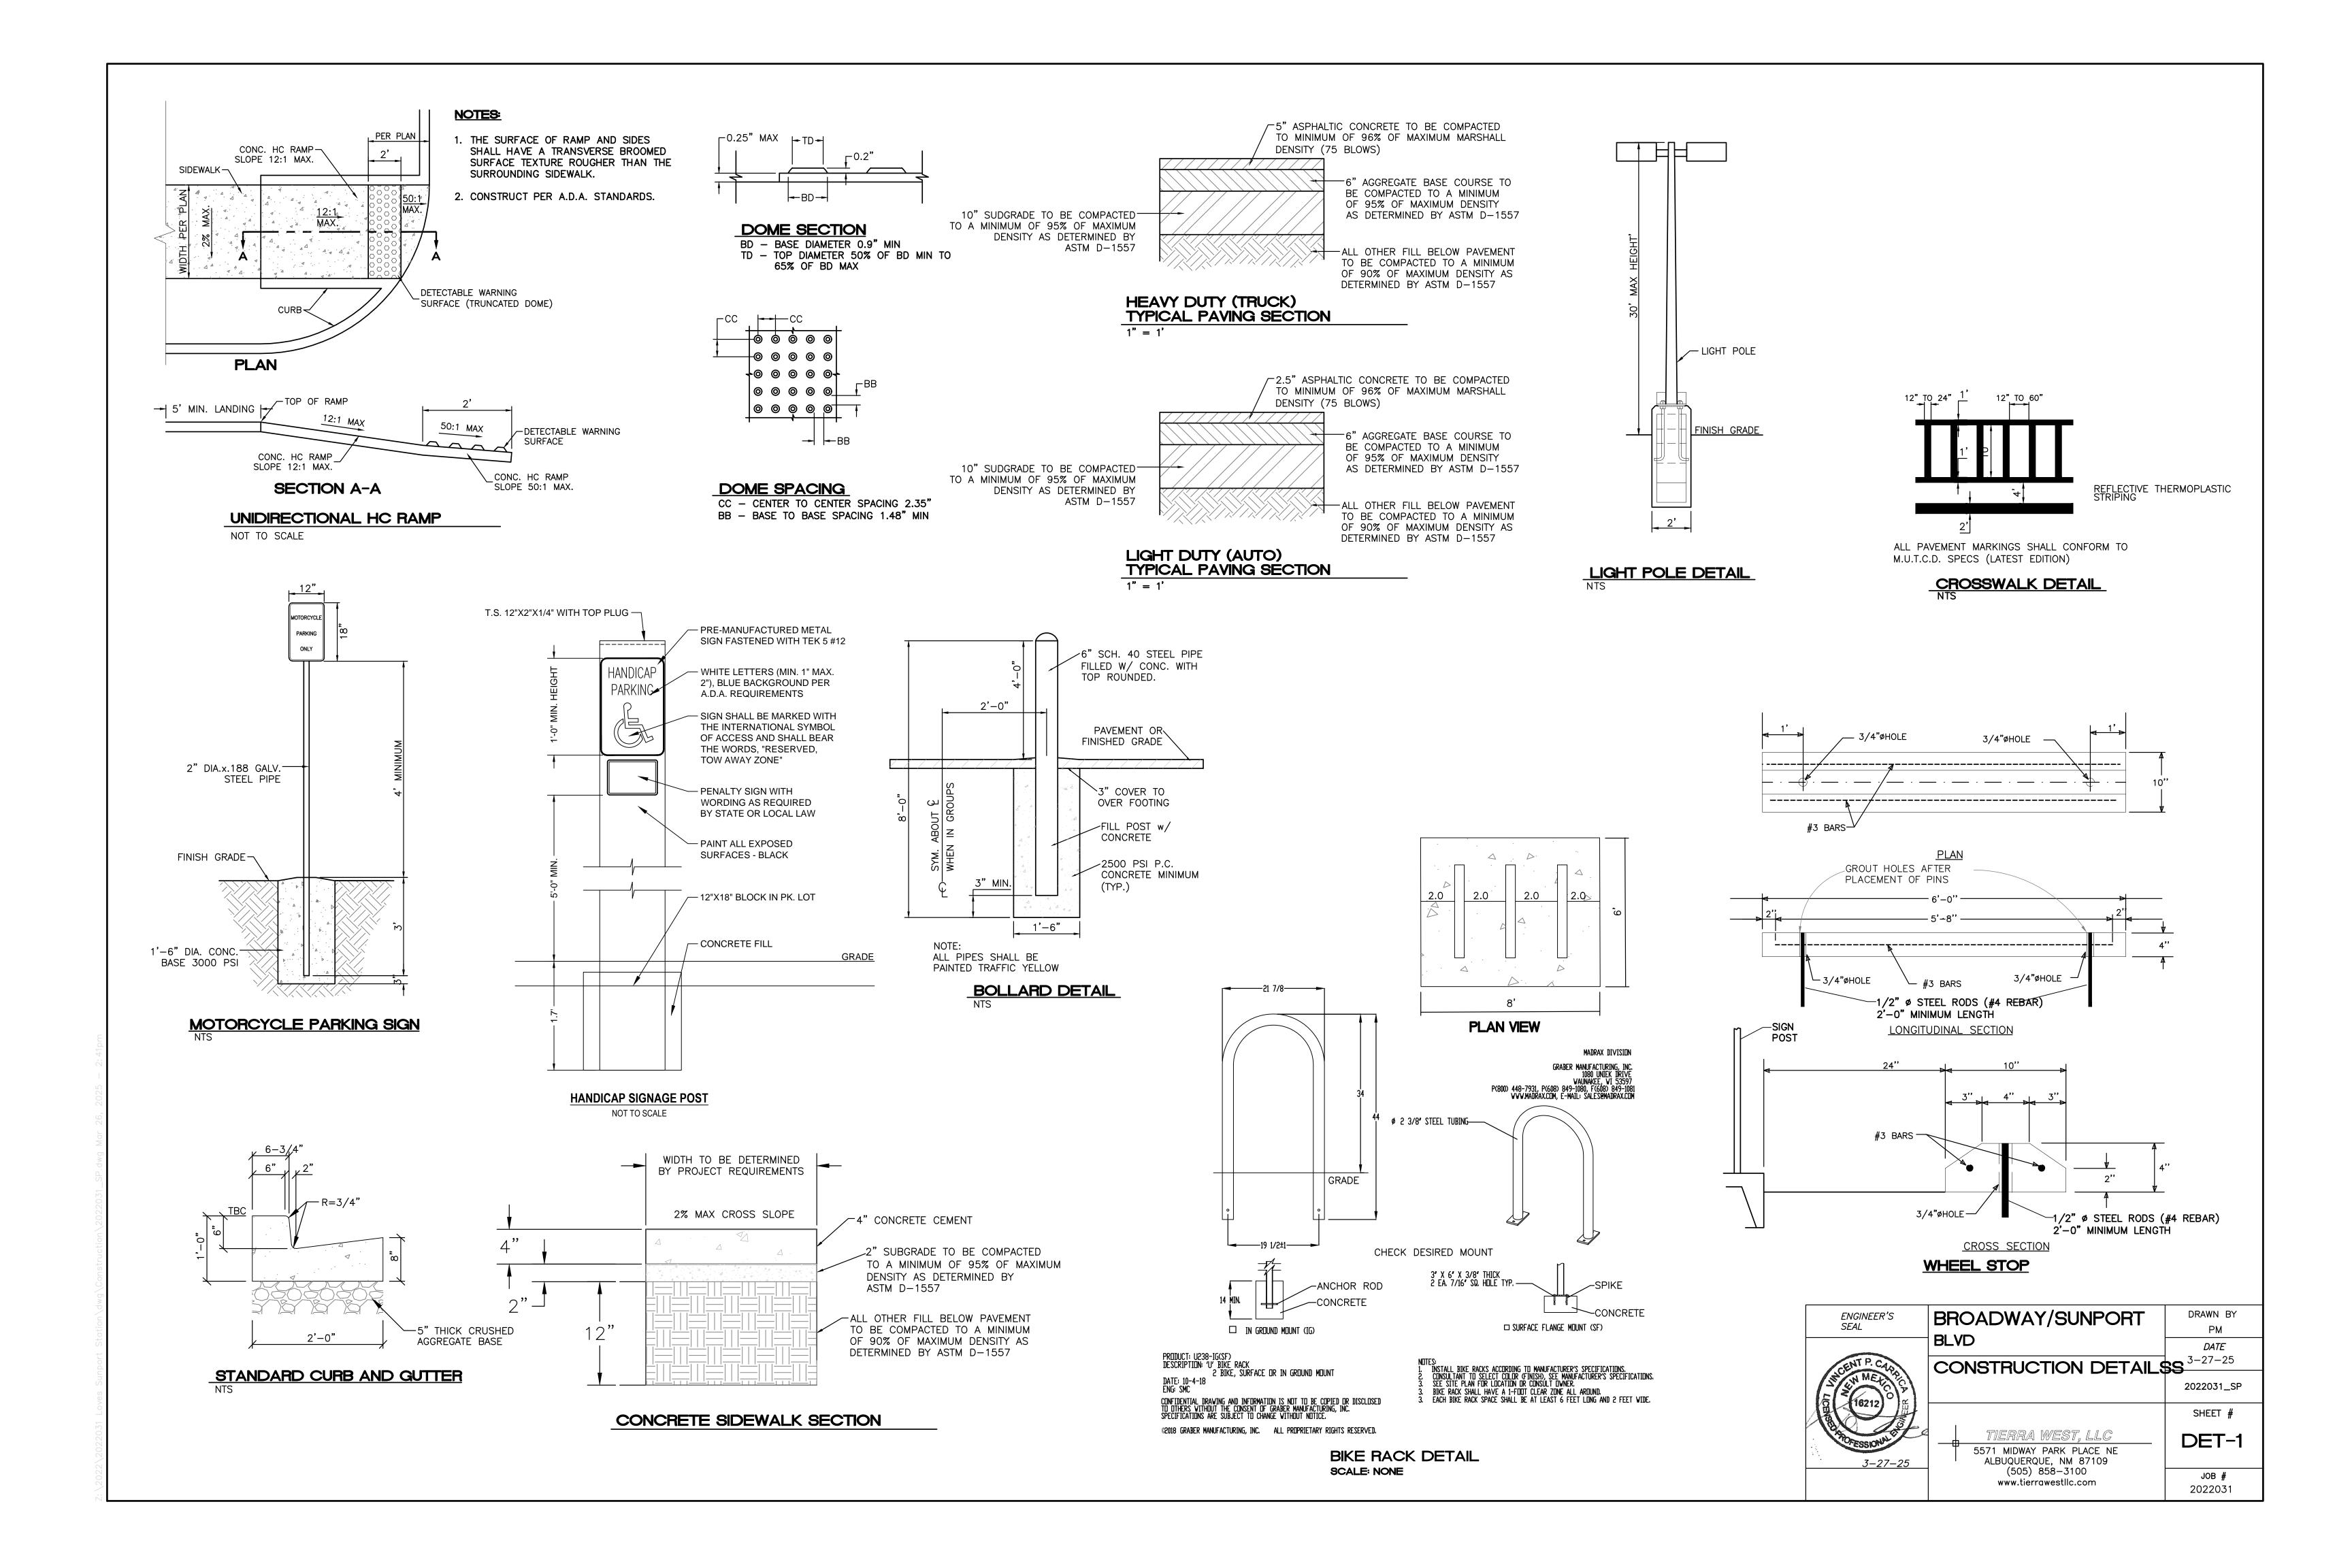
GRAPHIC SCALE


(IN FEET)

1 inch = 60 ft.


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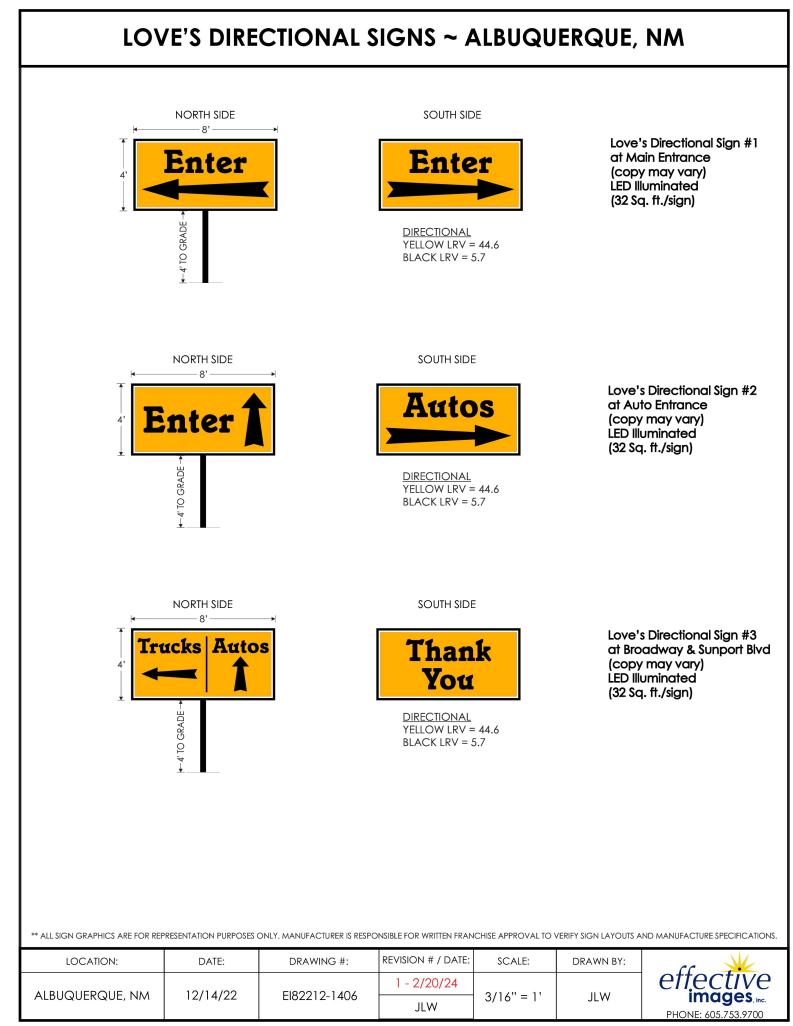
- 1. ALL ONSITE WATER, SANITARY SEWER AND FIRE LINES SHALL BE DEEMED PRIVATE.
- 2. THE PRIVATE FIRE HYDRANTS, INDICATED IN THE UTILITY PLAN, SHALL BE PAINTED SAFETY ORANGE.







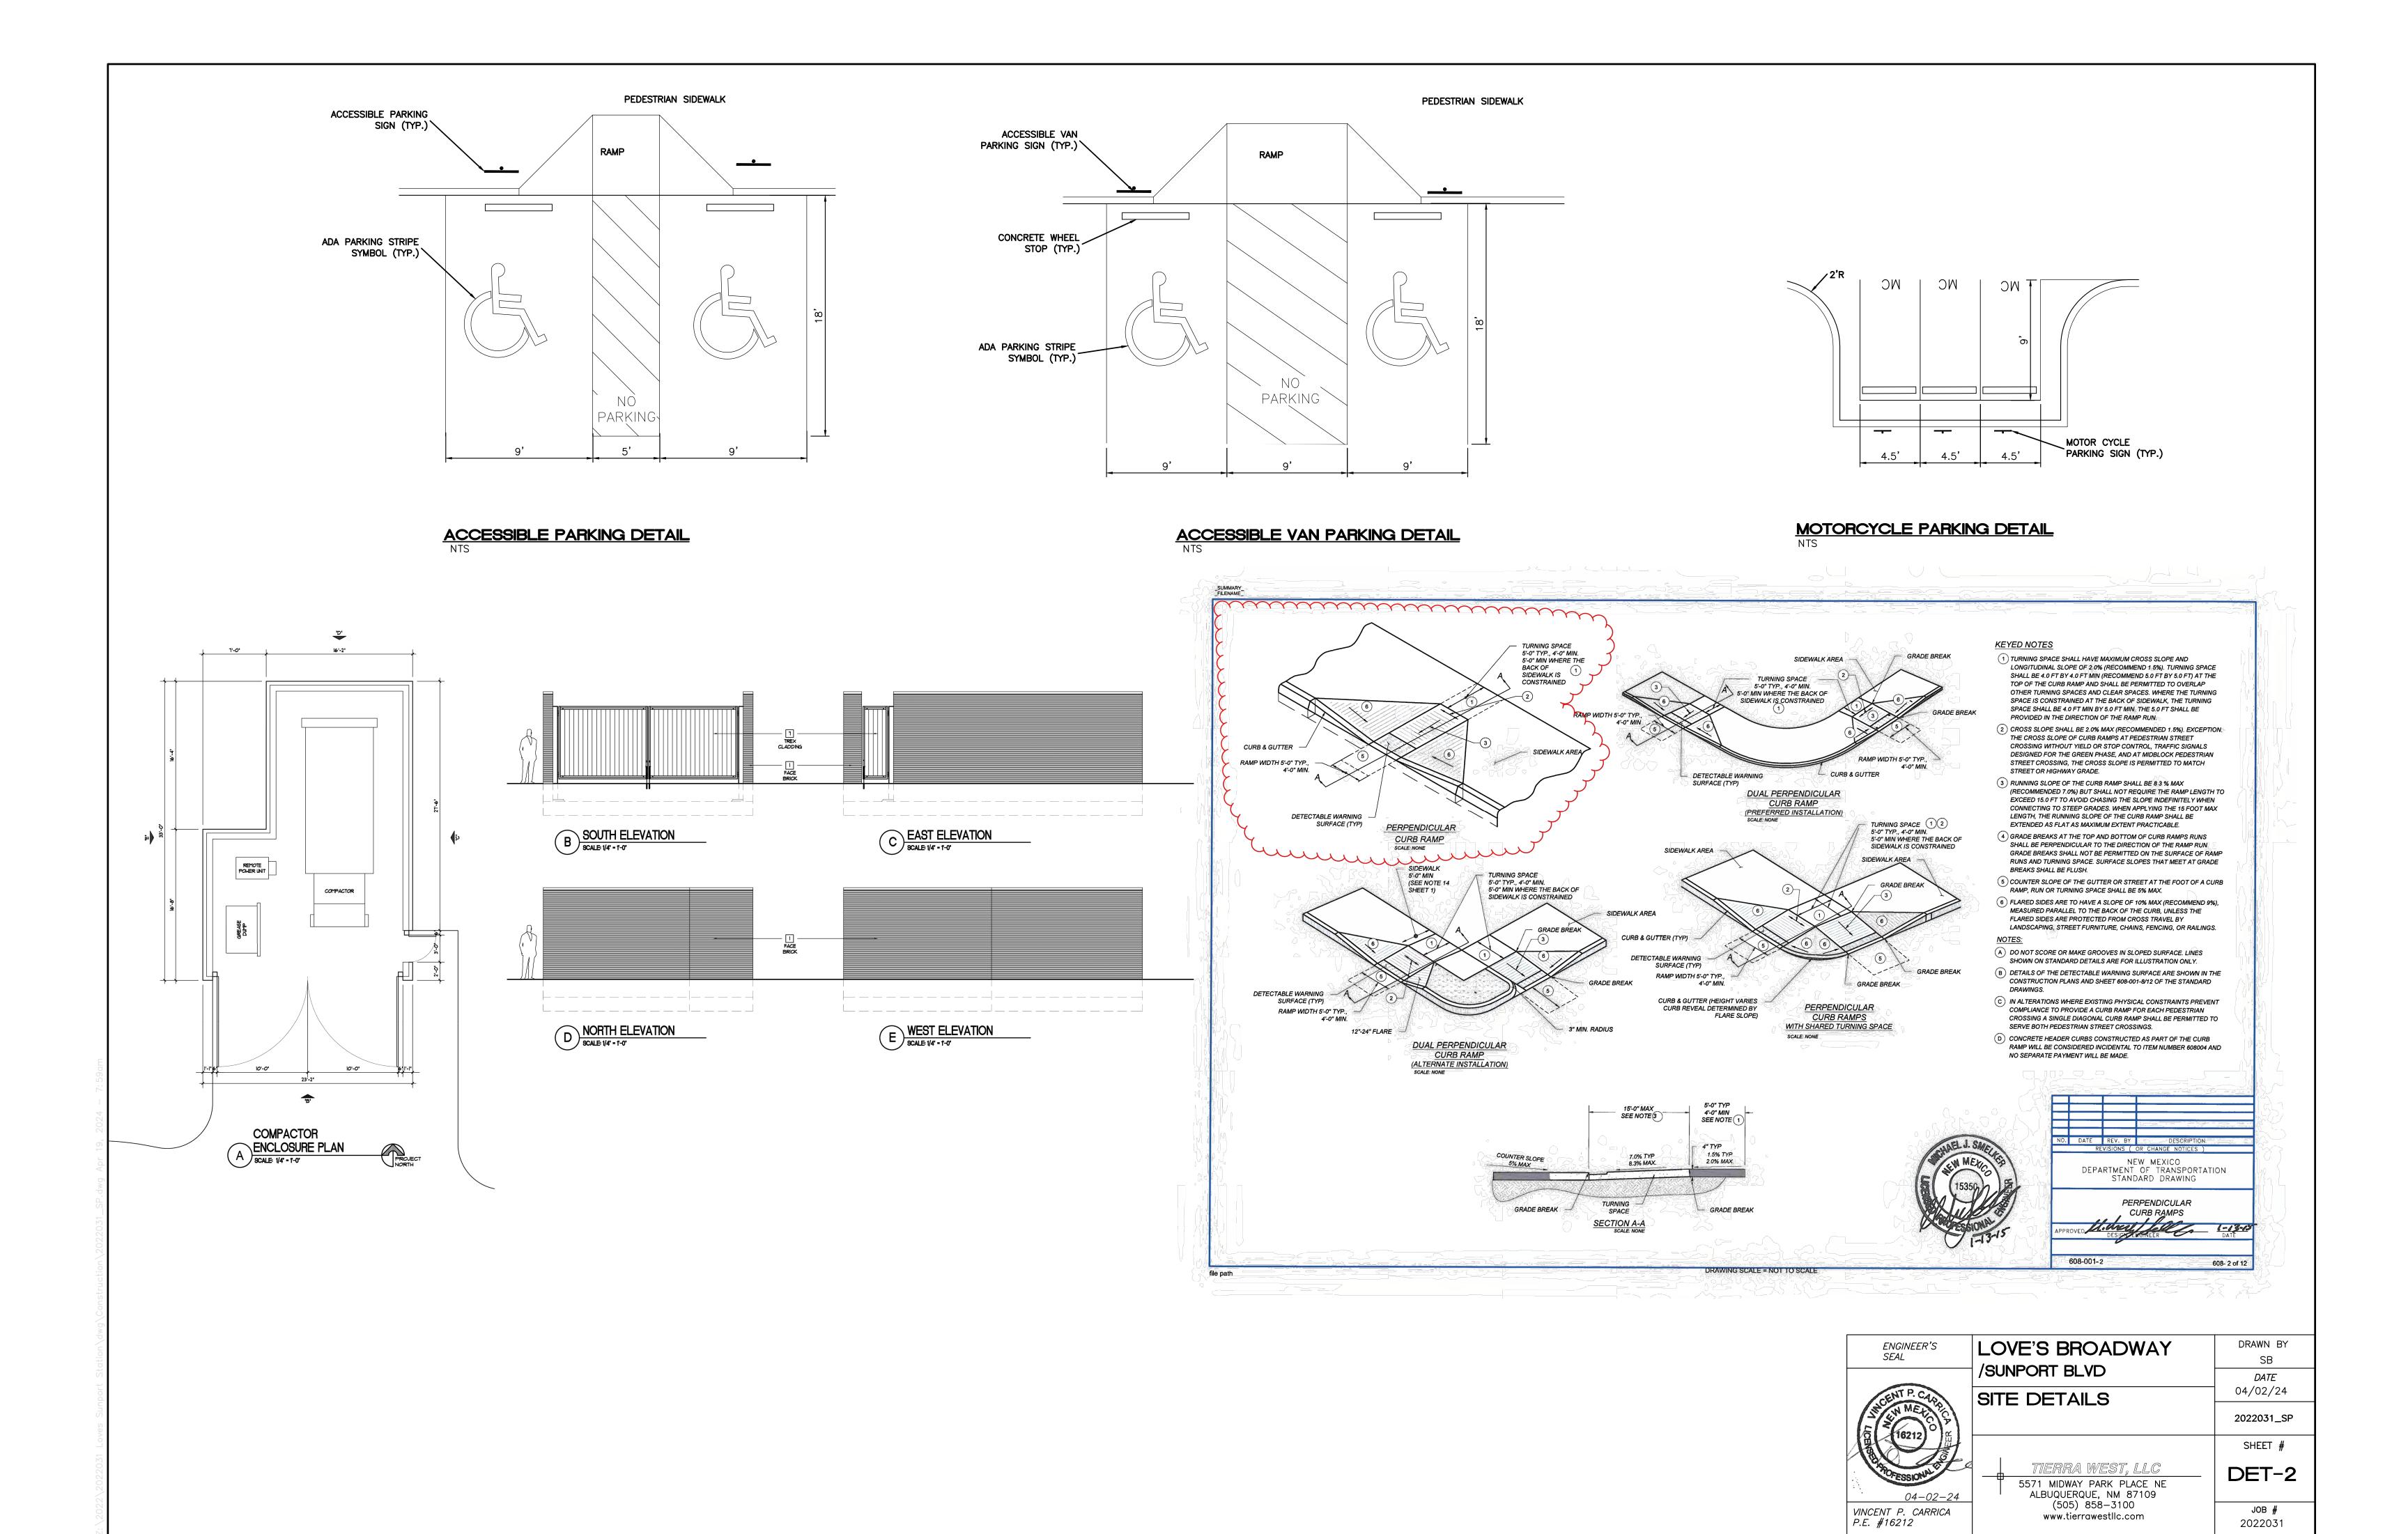



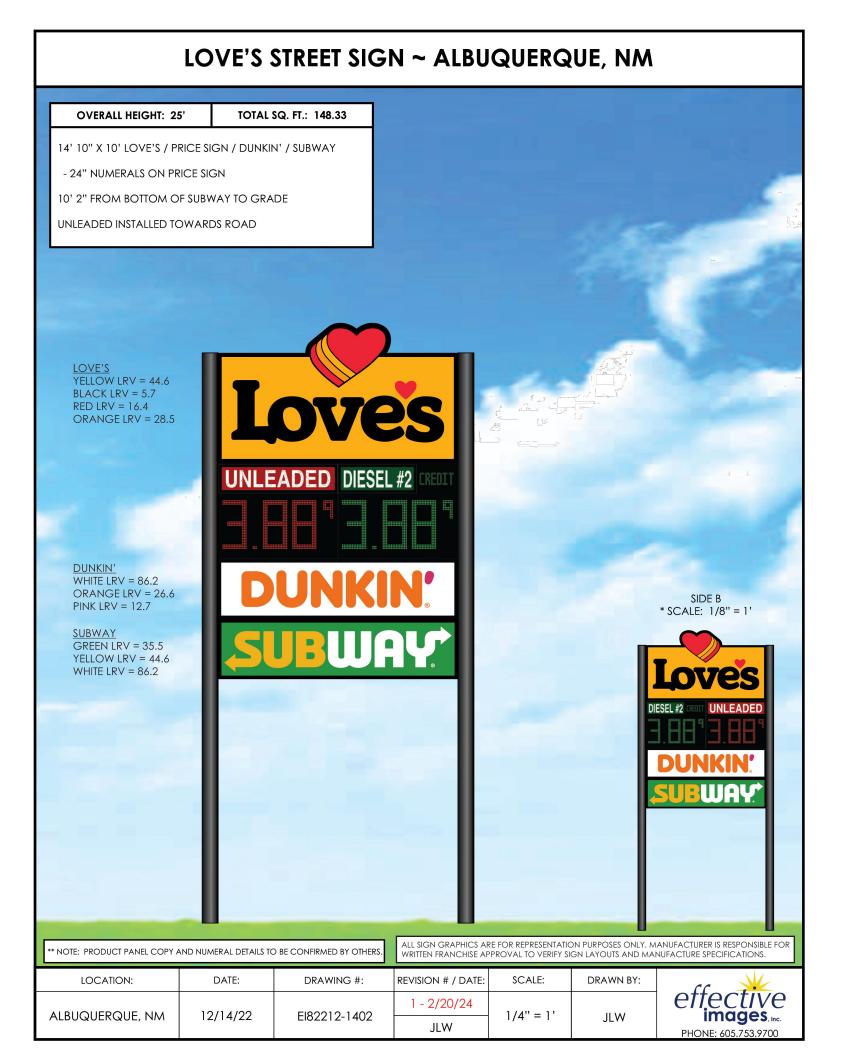


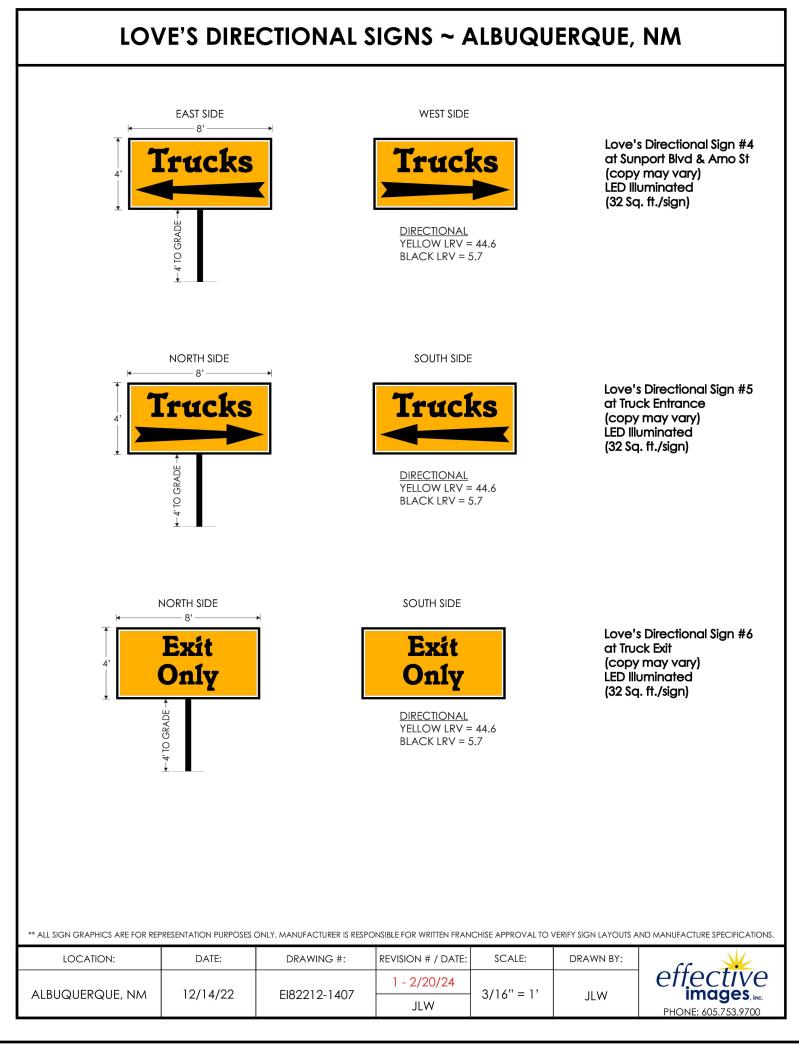


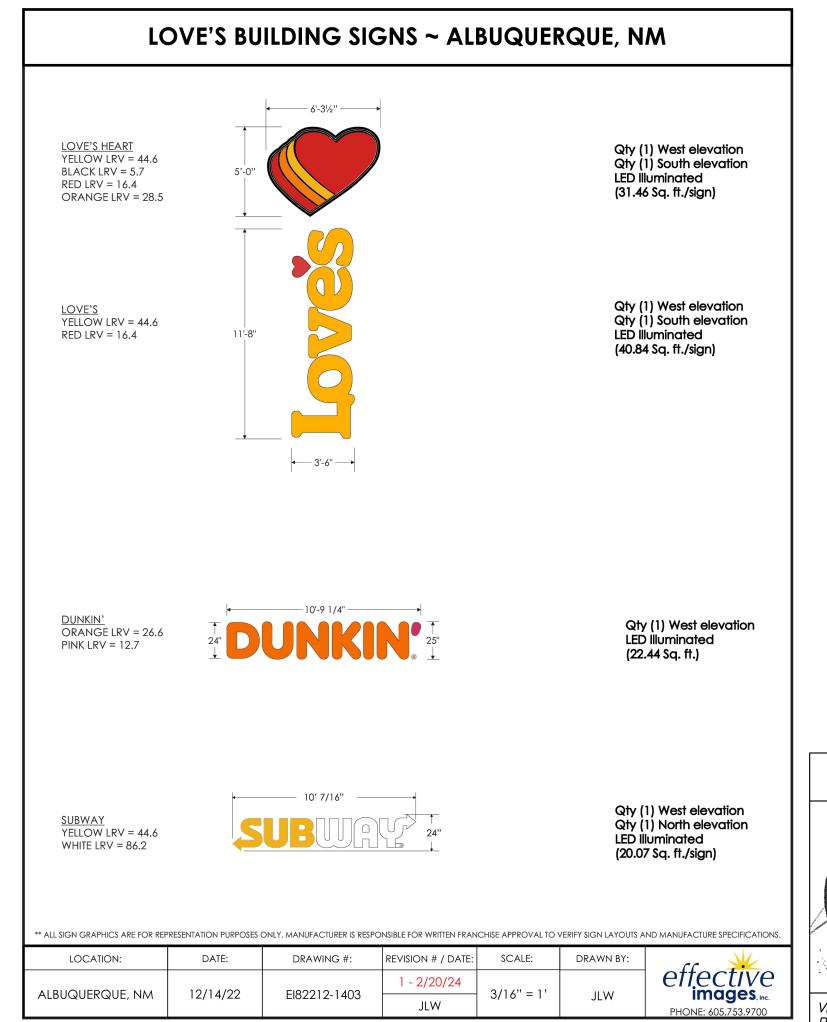


LOVE'S SITE DETAILS

ENGINEER'S	LOVE'S BROADWAY	DRAWN BY	
SEAL		SB	
	/SUNPORT BLVD	DATE	
WENT P. CAR	DETAILS	04/02/24	
THE WHENCE TO THE STATE OF THE	DE TAILS	2022031_SP	
		SHEET #	
04-02-24	TIERRA WEST, LLC 5571 MIDWAY PARK PLACE NE ALBUQUERQUE, NM 87109	DET-3	
VINCENT P. CARRICA P.E. #16212	(505) 858-3100 www.tierrawestllc.com	ЈОВ # 2022031	

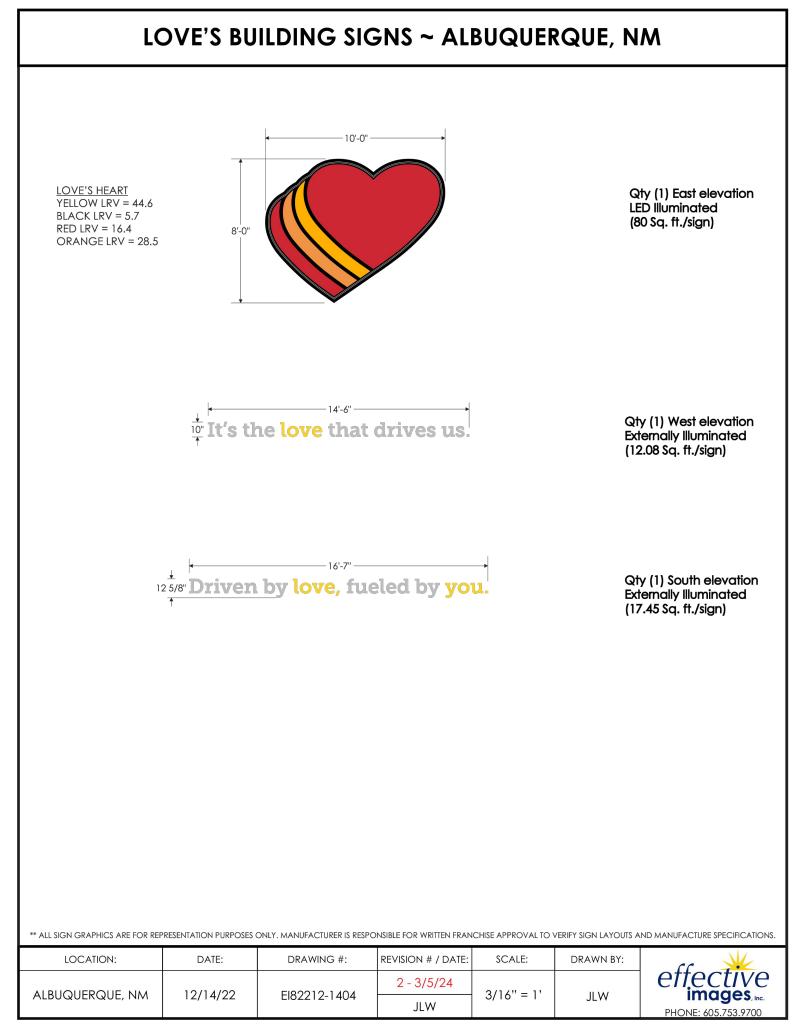

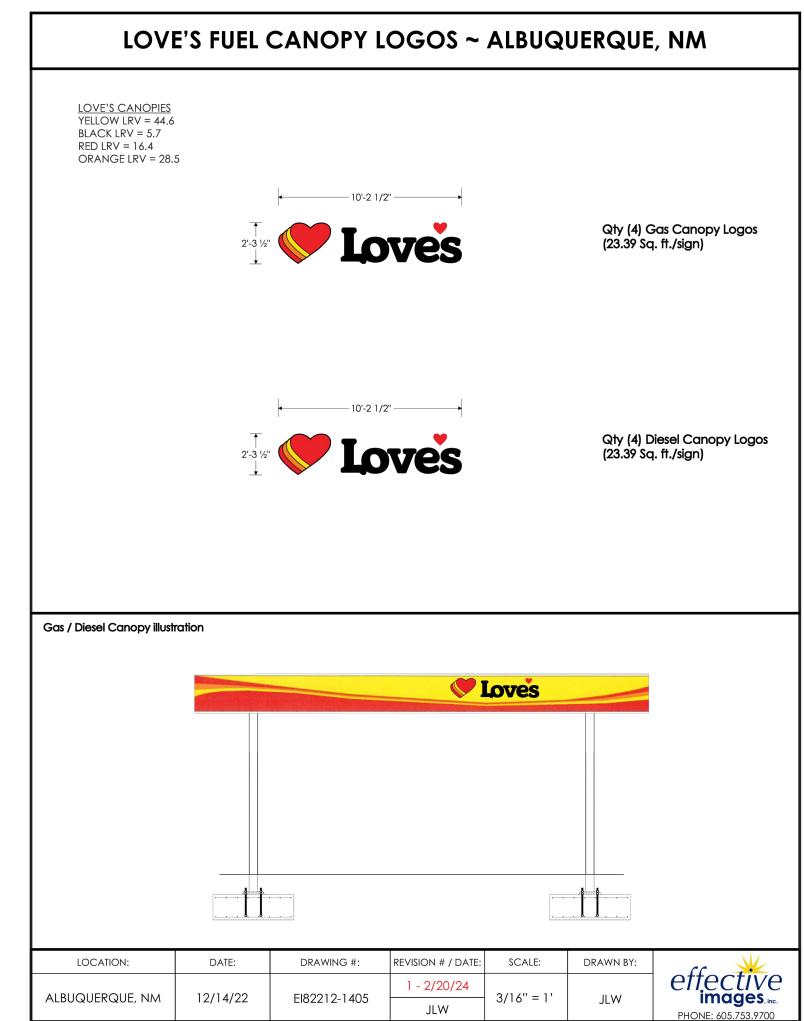

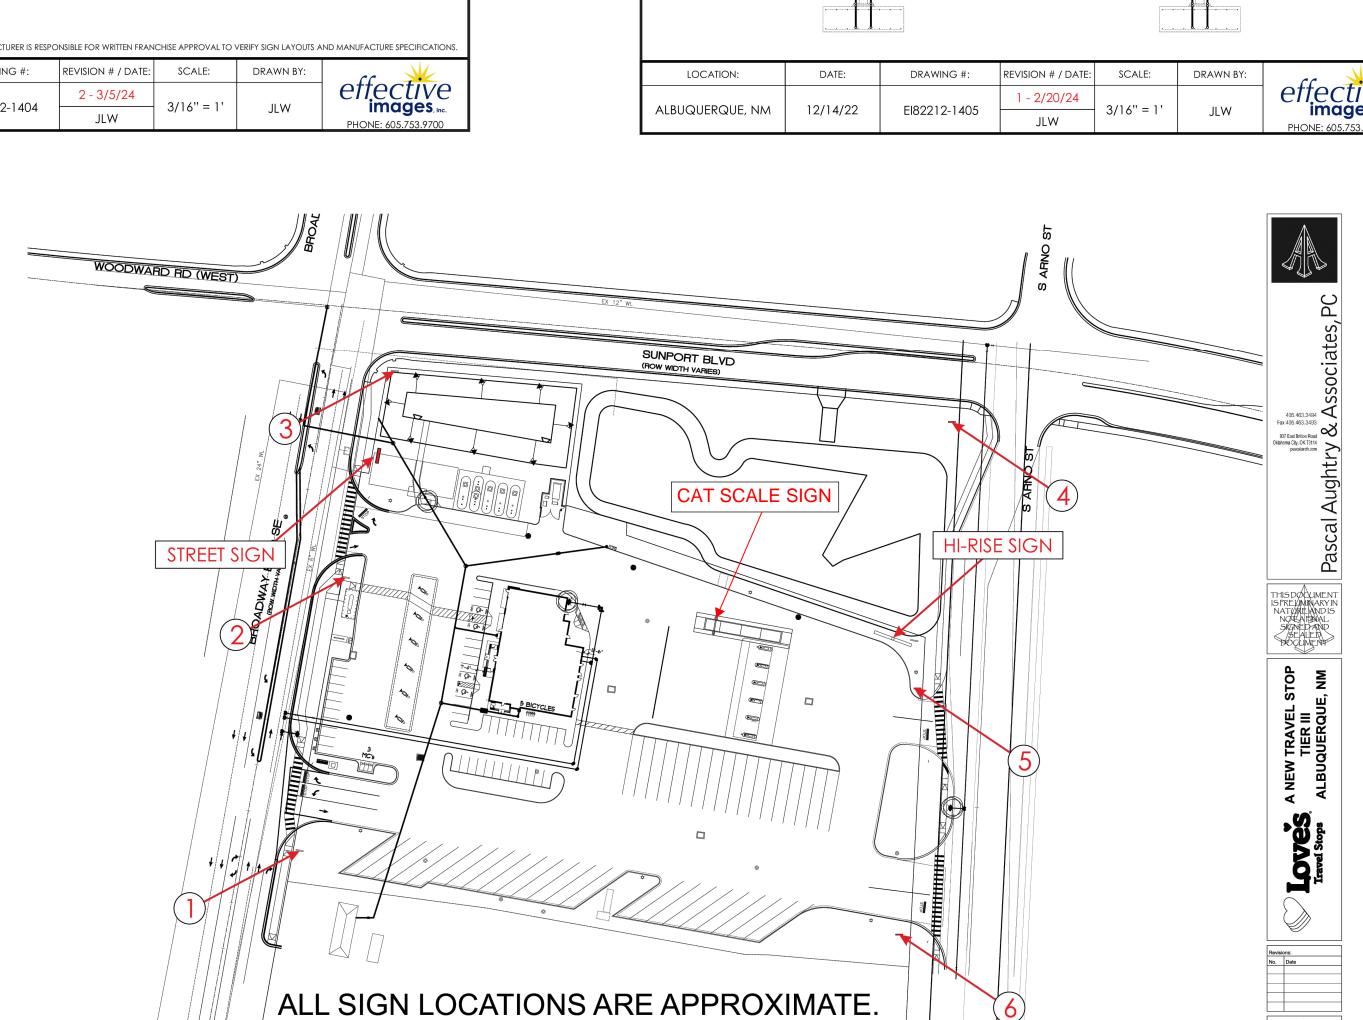


TO BE VERIFIED BY THE ARCHITECT AND


SIGNS SHALL BE PERMITTED UNDER SEPERATE

LOVE'S REPRESENTATIVE.


APPLICATION

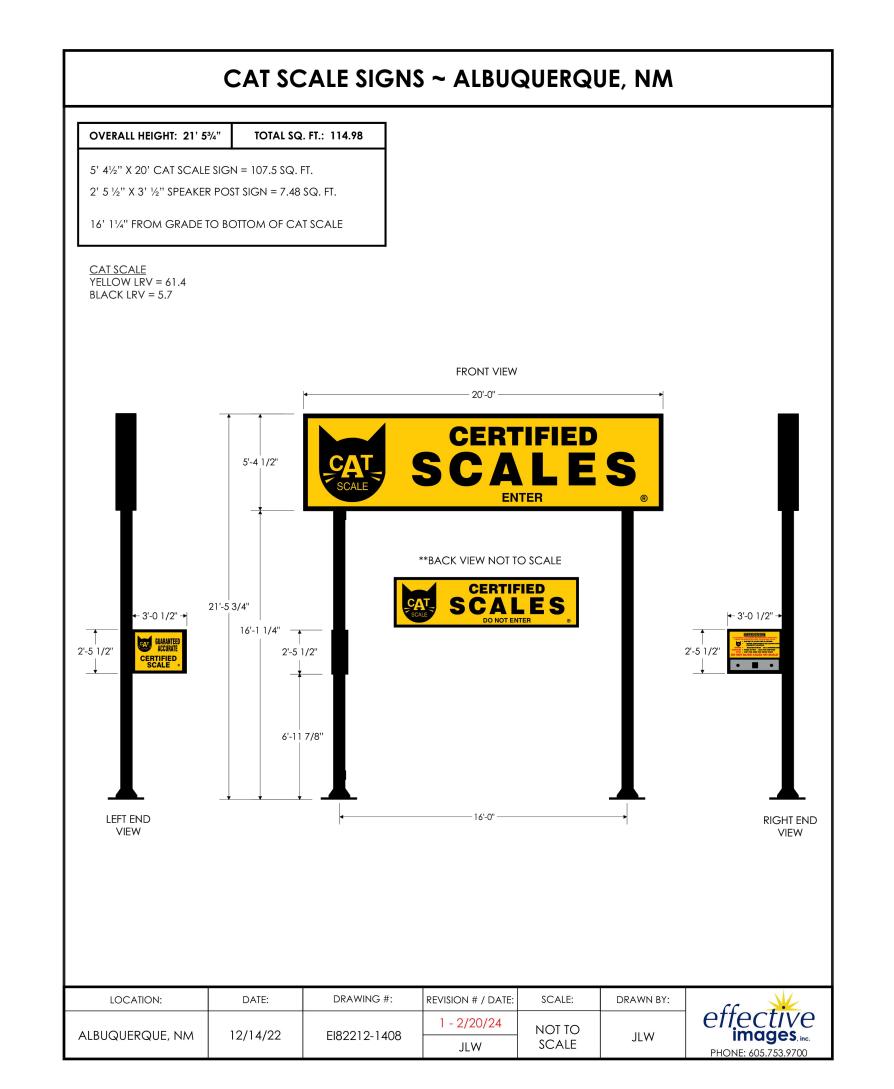


LOVE'S SITE DETAILS

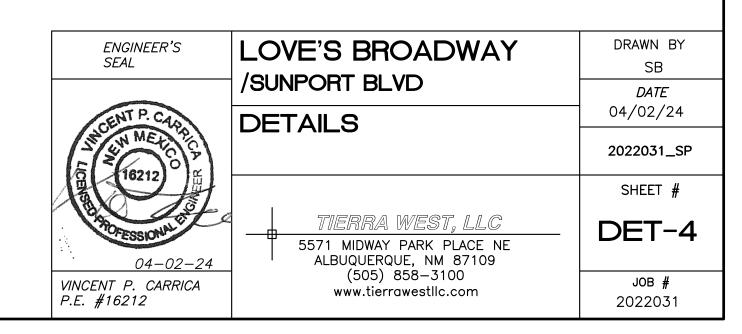


Z:\2022\2022031 Loves Sunport Station\dwg\

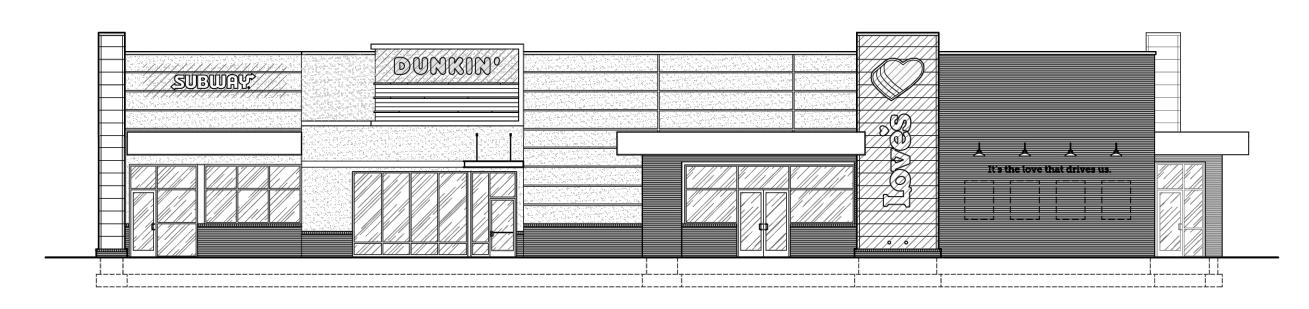


WEST ELEVATION Scale: 1/8" - 1'-0"

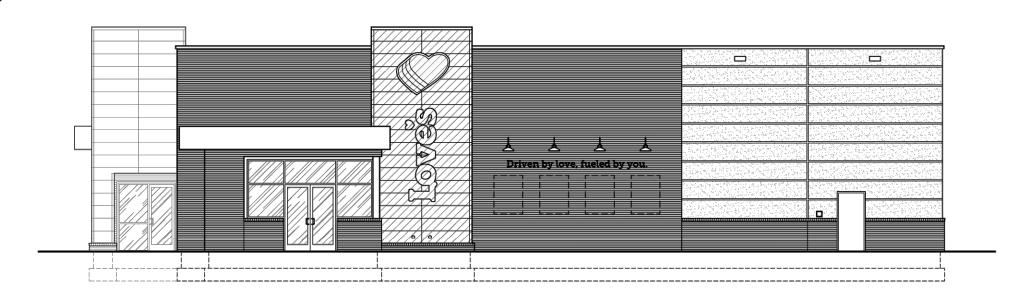

SOUTH ELEVATION Scale: 1/8" - 1'-0"

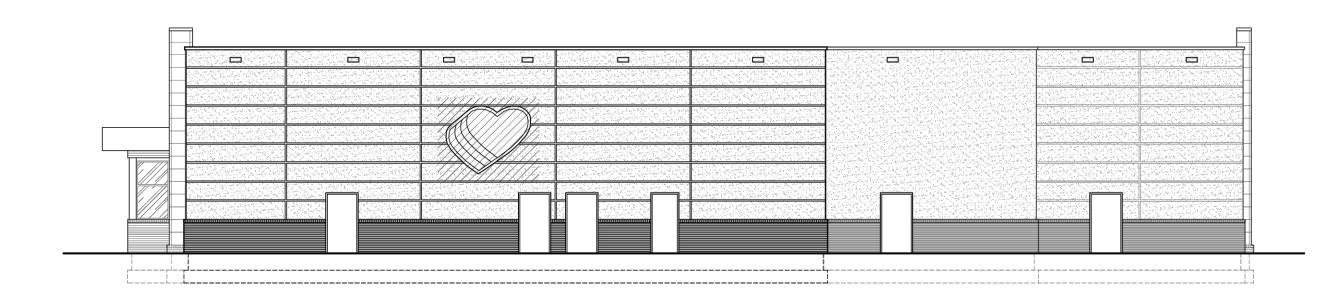

C EAST ELEVATION Scale: 1/8" - 1'-0"

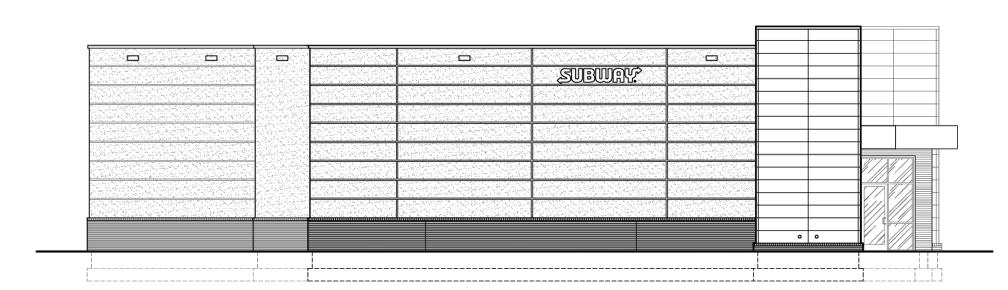






Pascal Aughtry & Associates, PC



A NEW TRAVEL STOP STORE NO. 963 ALBUQUERQUE, NM



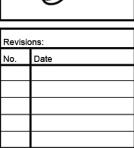



Project No.: LVS---Date: 12/21/22
Sheet No.:


A-X


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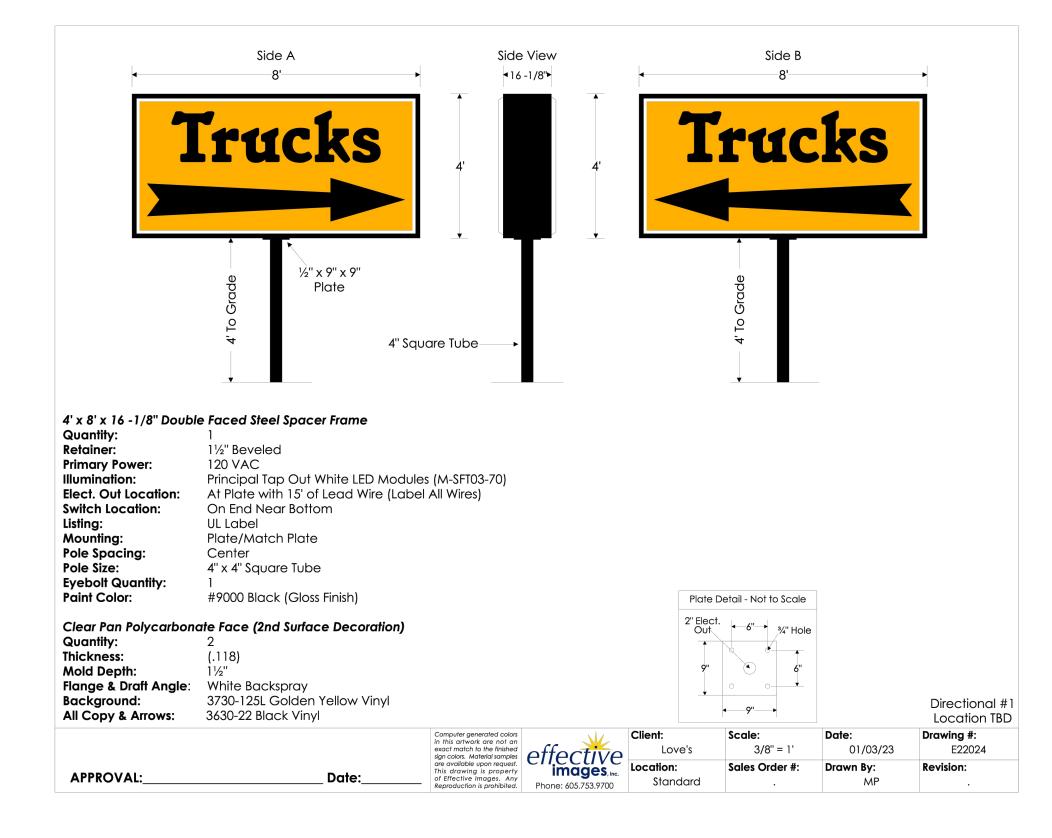
ENGINEER'S SEAL	LOVE'S BROADWAY	DRAWN BY SB
	/SUNPORT BLVD	DATE
CENT P. CAR	DETAILS	04/02/24
Z W MET OF		2022031_SP
		SHEET #
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VINCENT P. CARRICA P.E. #16212	(505) 858-3100 www.tierrawestllc.com	JOB # 2022031




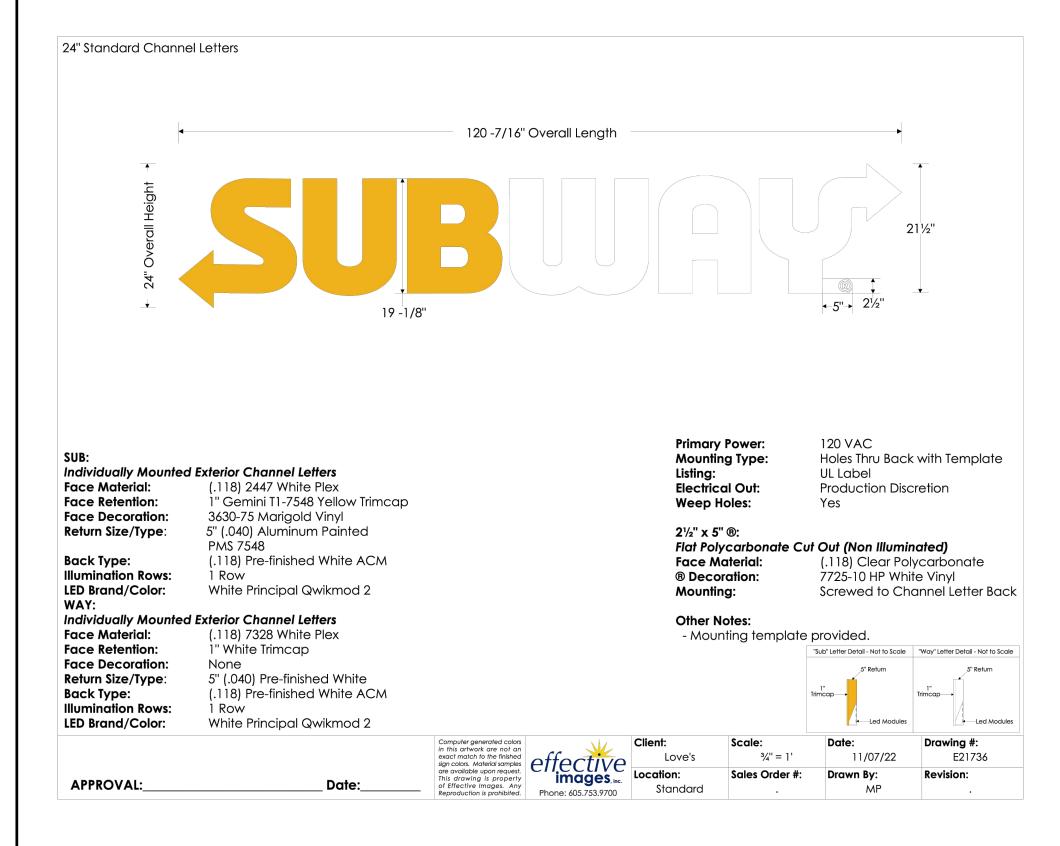

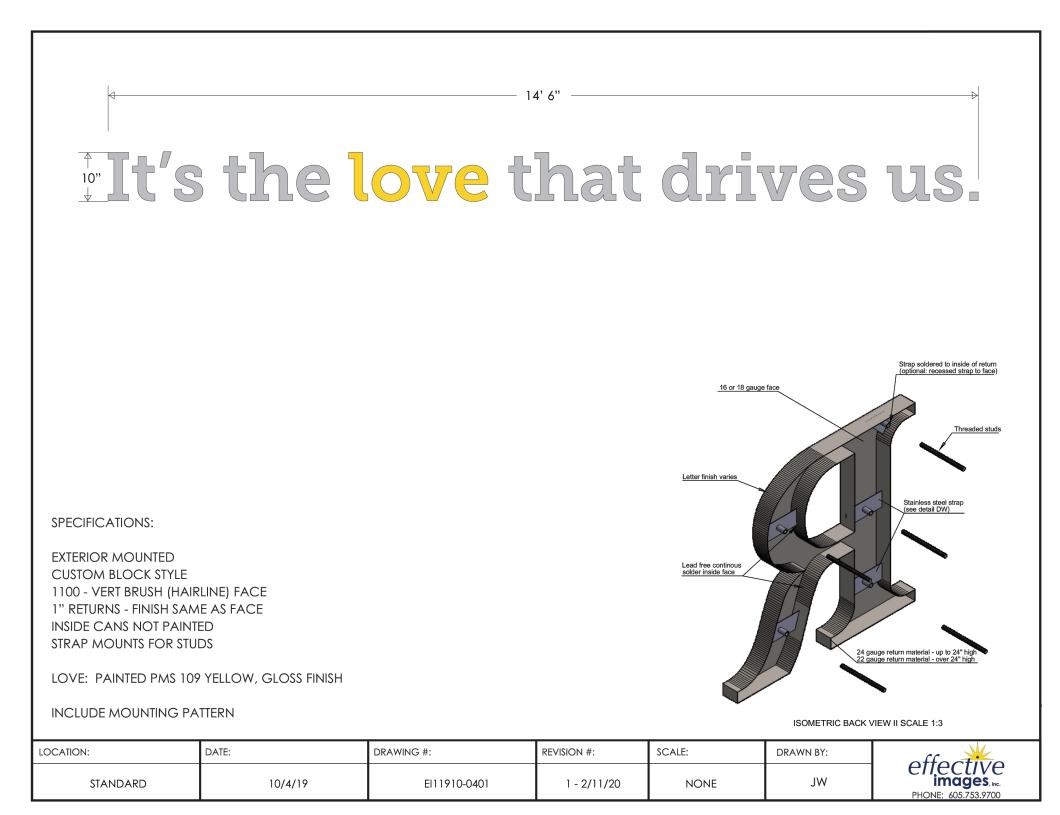


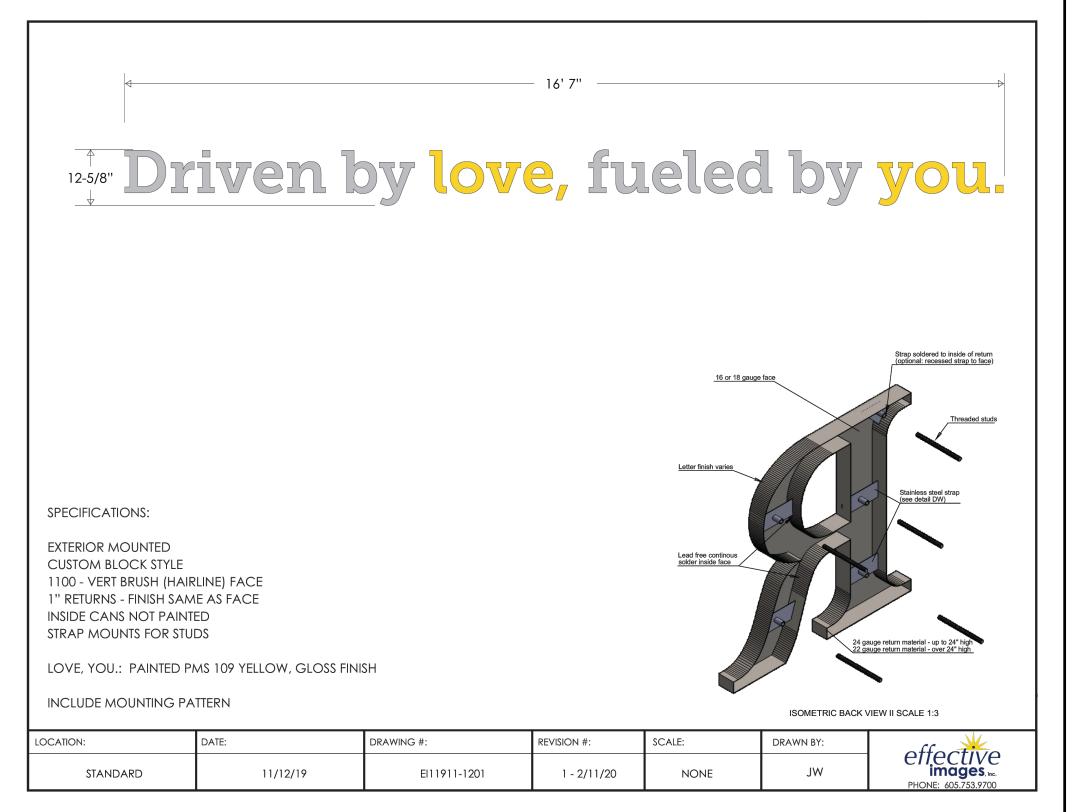

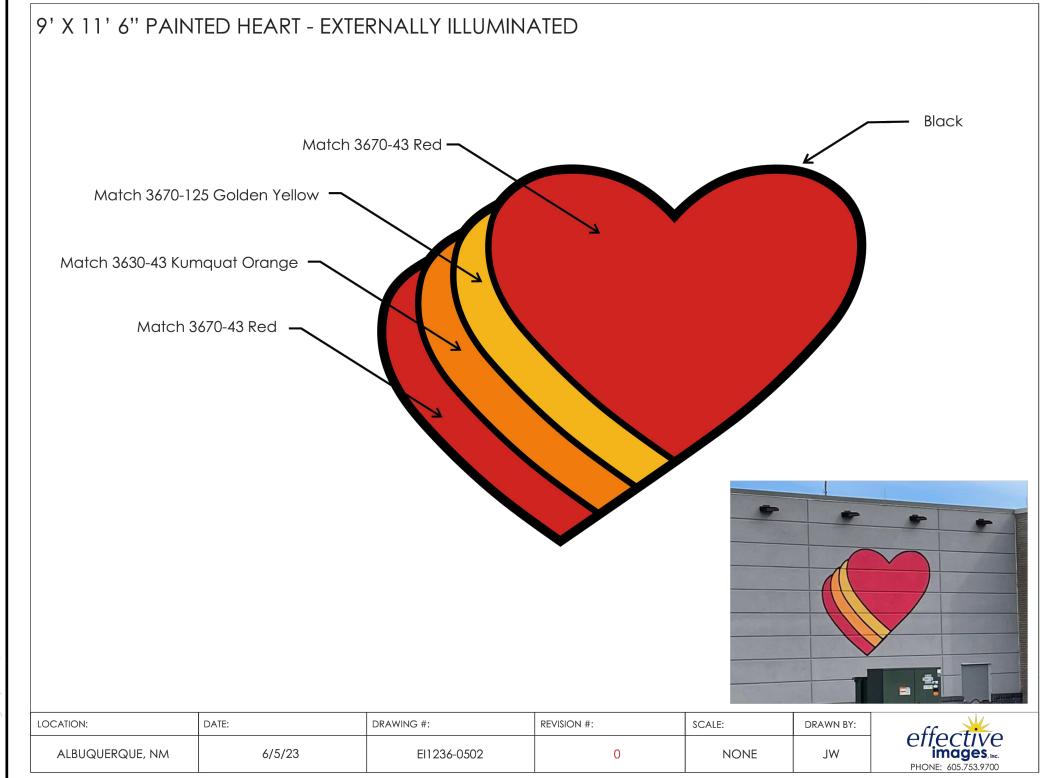


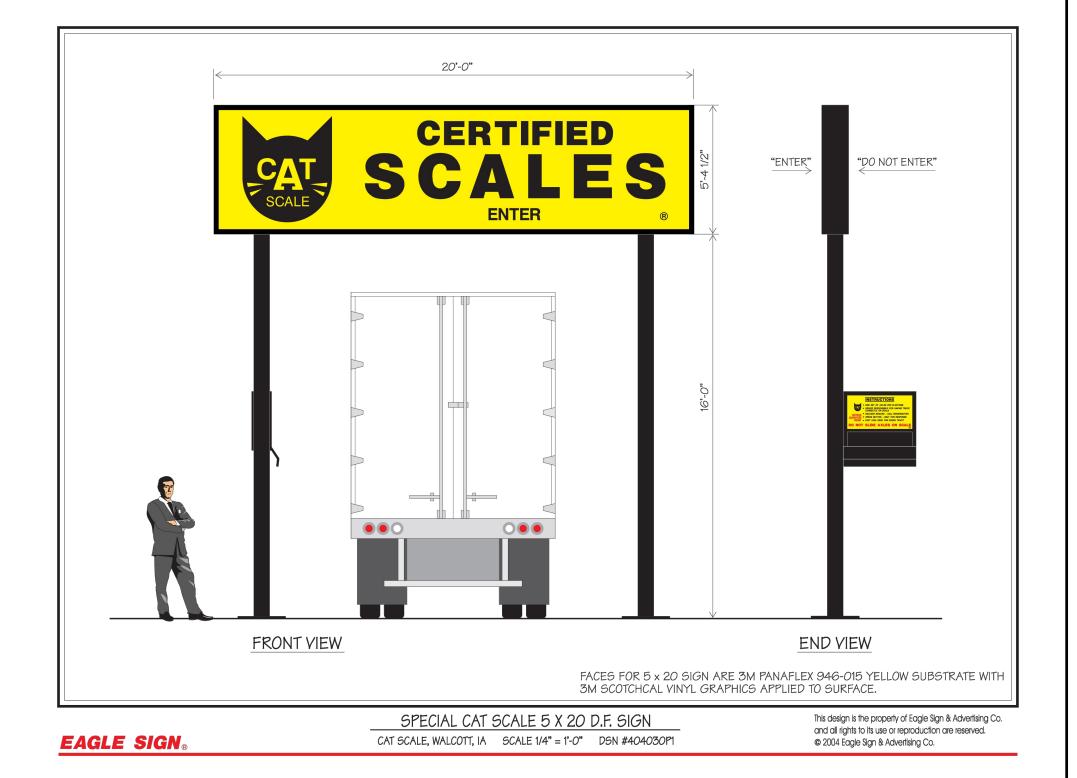


LOVE'S SITE DETAILS

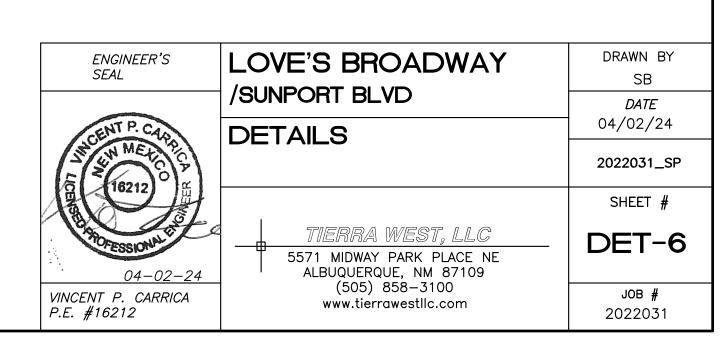

TRAVEL CENTER EXHIBIT AIR SPACE PROTECTION HORIZONTAL SURFACE (3-3(B)(1))PROPOSED STRUCTURE HEIGHTS/ELEVATIONS FALL BELOW THE AIR SPACE PROTECTION HORIZONTAL SURFACE ELEVATION OF 5504.90

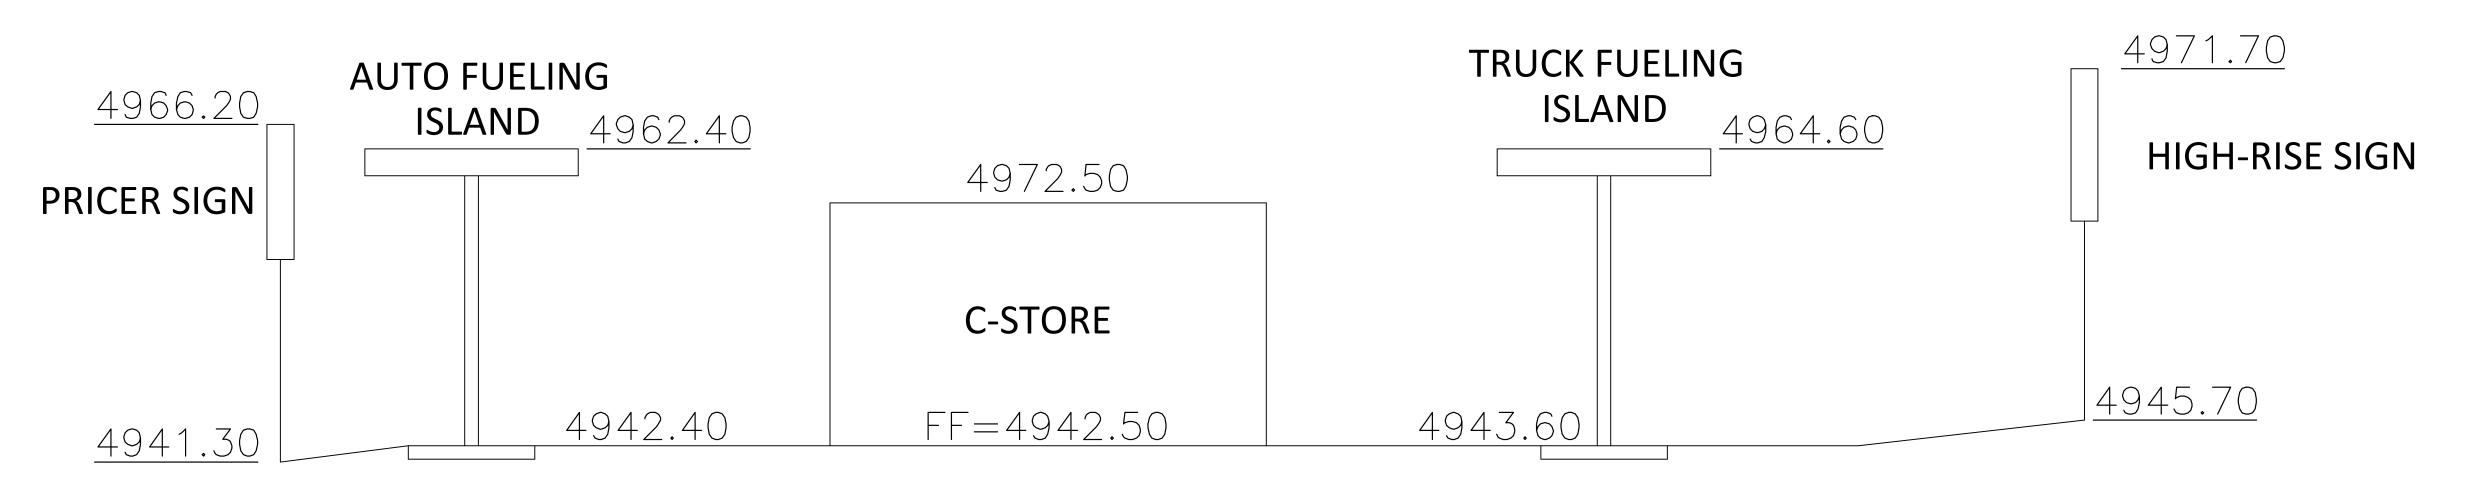

ENGINEER'S SEAL	BROADWAY/SUNPORT	DRAWN BY PM
CENT P. CAO	SITE DETAILS	<i>DATE</i> 3–27–25
METER PER PER PER PER PER PER PER PER PER P	OHE DETAILO	2022031 TCL
(16212) High		SHEET #
3-27-25	TIERRA WEST, LLC 5571 MIDWAY PARK PLACE NE ALBUQUERQUE, NM 87109	DET-6A
VINCENT P. CARRICA P.E. #16212	(505) 858-3100 www.tierrawestllc.com	ЈОВ # 2022031

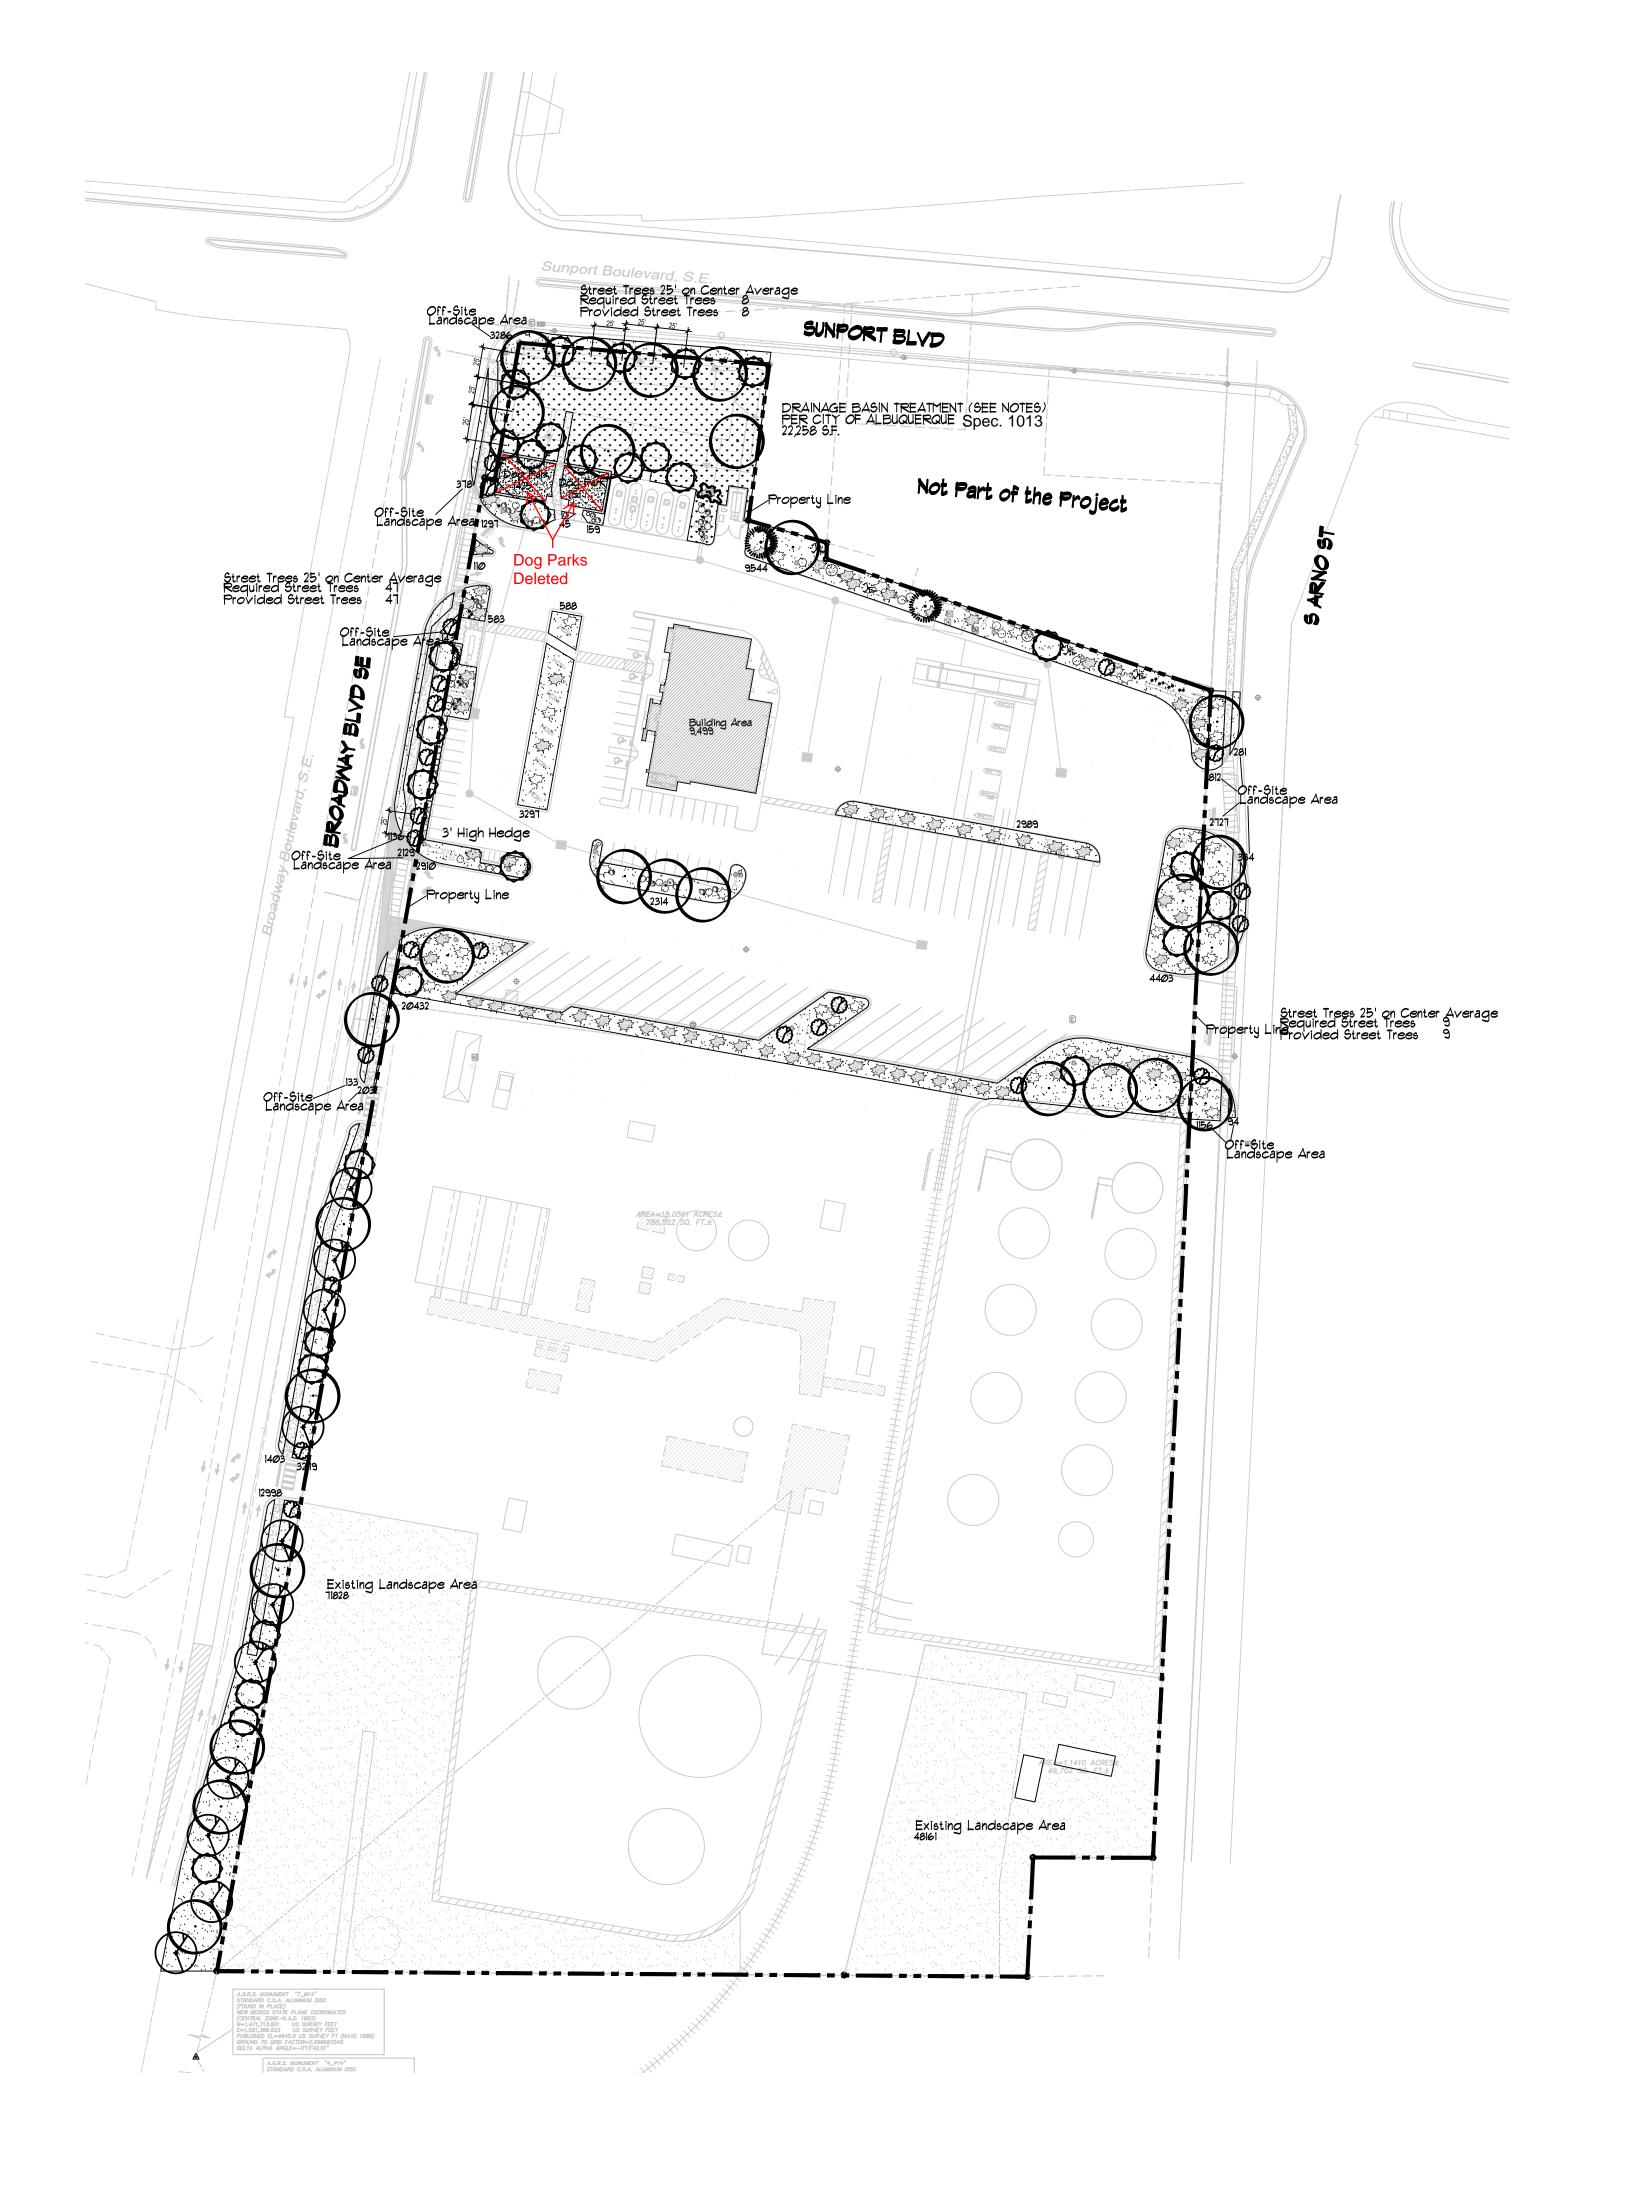


LANDSCAPE LEGEND

	QTY	SIZE	CØMMON/BOTANIC	AL		H20 U	3E
	Tre	?es					
\bigcirc	11	2" cal	Chinese Pistache Pistacia chiner		961.62	10577.82	M
$\overline{}$	27	2" cal	Hackberry Celtis Occidentalis	50x45	1589.62	42919.74	М
A STATE OF THE PARTY OF THE PAR	2	6 - 8'	Austrian Pine Pinus nigra	35x25	490.62	981.24	М
£3	1	6-8' Multi Ste	Crape Myrtle m Lagerstroemia	15x2Ø indica	314	314	М
0	3Ø	6-8' Multi Ste	D esert Willow m Chilopsis linea	20x25 ris	490.62	14718.6	М
Ø	24	15 Gal.	Pink Pom Poms Redbud	15×12	113.04	2712.96	М
	Γe	Total Tre	es Total Tre	ee Covera	ge	72224.36	
	Shi	rubs &	Groundcov	ers			
	2	5 Gal	Existing Shrubs	10×10	78.5	157	М
٥.	4	5 Gal	Spanish Broom Caryopteris x	l ØxlØ clandone	185 ensis	314	M
T _i	4	5 Gal	Bird of Paradise Caesalpinia gill		78.5	314	L
9	2Ø	5 Gal	India Hawthorne Raphiolepis inc	3x5 dica	19.62	392.4	M
	33	5 Gal	Winter Jasmine Jasminum nud	4xl2 iflorum	113.04	373 <i>Ø.</i> 32	М
\sim	75	5 Gal	Buffalo Juniper Juniperus sabii	lx 2 na 'Buffo	113. 04 alo'	8478	Μ
0	2	5 Gal	Cherry Sage Salvia greggii	2×3	7.06	14.12	Μ
0	11	5 Gal	Blue Mist Caryopteris x	3x3 clandone	1.06 ensis	77.66	М
0	41	5 Gal	Fern Bush Chamaebatiaria	5x6 millefor	28.26 lium	1158.66	L
\odot	4	5 Gal	Apache Plume Fallugia parad	6x7	38.46	153.86	L
\odot	2	5 Gal	Chamisa	5x7	38.46	76.92	L
•	25	5 Gal	Chrysothamnus Feather Reed Gras Calamogrostis	ss 2.5×2	3.14	78.5	М
	223	Total Shr		rub Cover		14945.44	
96	23	2-3cf	Boulders To be placed	at con	tractor	discretior	ר
10 1 1 1 1 1 1 1 1 1 1 1 1 1 1 1 1 1 1	79163		Landscape Gravel 3/4" Crushe		abric		
* * * * * *	22258		Drainage Basin Tro	eatment, (9	iee Notes	3)	
	2576 0		Natīve Seeding Per COA Landscape Crushe Amaretto, or	r Fines / F Equal,	ilter Fabr	ic	
	eseeli		3" Depth, m Existing Landscap Natural Land	e Area			
	223986		Total Landscape f	⁻ rovided			
	LA	NDSCA	APE CALCUL	ATIO	NS		

TOTAL LOT AREA (6f)	786,522
TOTAL BUILDING AREA (sf)	9,499
TOTAL NET LOT AREA (sf)	-777@23
LANDSCAPE REQUIREMENT	× .15
TOTAL LANDSCAPE REQUIRED	116,553
TOTAL ON-SITE LANDSCAPE PROVIDED	145333
TOTAL LIVE PLANT COVER REQUIRED	108999
TOTAL LIVE PLANT COVER PROVIDED	109427.80
TOTAL GROUNDCOVER REQUIRED	36333
DRAINAGE BASIN, NATIVE SEED (SEE NOTES)	22258

TOTAL GROUNDCOVER PROVIDED

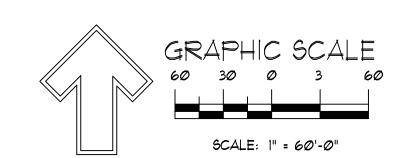

372Ø3.44

LANDSCAPE NOTES:

Landscape maintenance shall be the responsibility of the Property Owner. The Property Owner shall maintain street trees in a living, healthy, and attractive condition.

It is the intent of this plan to comply with the City Of Albuquerque Water Conservation Landscaping and Water Waste Ordinance planting restriction approach. Approval of this plan does not constitute or imply exemption from water waste provisions of the Water Conservation Landscaping and Water Waste Ordinance.

It is the intent of this plan to comply with the City of Albuquerque Landscape Regulations Applicable to Apartments and Nonresidential Development, Revised 6/24.

Water management is the sole responsibility of the Property Owner. All landscaping will be in conformance with the City of Albuquerque Zoning Code, Street Tree Ordinance, Pollen Ordinance, and Water Conservation Landscaping and Water Waste Ordinance. In general, water conservative, environmentally sound landscape principles will be followed in design and installation.

Landscape areas in excess of 36 square feet shall be planted so as to achieve 75% Live Ground Cover at maturity.

Landscape Gravel over Filter Fabric to a minimum depth of 3" shall be placed in all landscape areas which are not designated to receive native seed, or other treatment.

Landscape shall be watered by a complete underground irrigation system operated by automatic timer. Trees shall have bubblers and shrubs shall have a minimum of 2 emitters per shrub. Trees and shrubs shall be zoned separately. Point of connection for irrigation system is unknown at current and shall be coordinate Landscaping shall be installed according to the approved plan: Installation shall be completed within 60 days of the related building's occupancy.

Approval of this plan does not constitute or imply exemption from water waste provisions of the water conservation landscaping and water waste ordinance. Water management is the sole responsibility of the property owner. needed. d between the Landscape Contractor and the General Contractor of the project prior to construction.

No substitutions, or alterations shall be made to this plan without the express written authorization of the Landscape Architect, and changes approved by the City of Albuquerque.

Clear Site Triangle Note:

Street Tree Notes:

Landscaping and signage will not interfere with clear site requirements. Signs, walls, trees and shrubbery between 3 and 8 feet tall, (as measured from the gutter pan) are no included within the clear site triangle.

Street trees will be planted within the required frontage per IDO 14-16-5-6(D)

Per Section 5-6(D)(1)(a) Required Street Trees. Trees are <u>GENERALLY</u> required along street frontages every 25 feet on center unless otherwise specified in Pa 6-2-Ž of ROA 1994 (Street Trees)

Section 6-6-2-5 Street Trees

Size of the trees at maturity should be in proportion to the planting space provided for them. Smaller species of trees will require close

spacing, and larger trees will require greater spacing, . Spacing shall be approved as part of the plan approval process.

2. On sites where evenly spaced street trees are not possible, or do not conform to the overall design objectives of the site, provided that the number of trees equals or exceeds the number that would be required if the trees were evenly spaced

Drainage Basin Treatments Per City of Albuquerque

Drainage Basin Treatments The bottom and sides must be seeded with a native mix

per City Standard specification 1013 depending on so type for that City area. Please reference this native sec selection and the section on plan sheet.


For pond bottoms: Gravel ¾to 1 inch mulch. One layer thick, not stacked

Native grass establishment must be achieved by the contractor within a 3 year time frame. Temporary irrigatic or water trucks must be used when rain is lacking. Seeds must germinate in one year or reseeding will likely be

Maintenance will be per City of Albuquerque Specification 10/2.3.9.1 and 10/2.3.9.2.

Contractor must weed the basin during/after the first growing season.

Needs city inspection. Stormwater Quality Ordinance-fina stabilization must be accepted by the City.

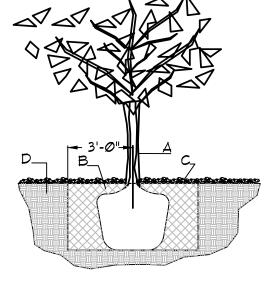

TREE PLANTING DETAIL

GENERAL NOTES:


1. ROOTBALL SHALL BE PLACED ON UNDISTURBED SOIL TO PREVENT TREE FROM SETTLING.

2. TOP OF ROOTCOLLAR INDICATED LEVEL AT WHICH TREE WAS GROWN AND DUG! THIS REPRESENTS THE LEVEL AT WHICH THE TREE SHOULD BE INSTALLED: THAT LEVEL MAY BE EXCEEDED BY ONLY A ONE INCH LAYER OF SOIL. 3. PRIOR TO BACKFILLLING TREE, ALL WIRE, ROPE AND SYNTHETIC MATERIALS SHALL BE REMOVED FROM THE TREE AND THE PLANTING PIT.

4. PRIOR TO BACKFILLING ALL BURLAP SHALL BE CUT AWAY EXCEPT FROM BOTTOM OF THE ROOTBALL. CONSTRUCTION NOTES: A. TREE

B. BACKFILL WITH EXISTING SOIL. C. 3" DEPTH OF GRAVEL MULCH. D. UNDISTRUBED SOIL.

danny@mitchellassociatesinc.com

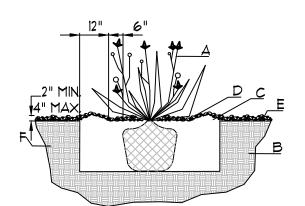

SHRUB PLANTING DETAIL

GENERAL NOTES:

1. THE OUTSIDE DIAMETER OF THE WATER RETENTICE SHALL BE TWICE THE DIAMETER OF THE SHRUB PL

CONSTRUCTION NOTES: A. SHRUB.

B. BACKFILL WITH EXISTING SOIL. C. EARTH BERM AROUND WATER RETENTION BASIN

D. 3" DEPTH OF GRAVEL MULCH. E. FINISH GRADE. F. UNDISTURBED SOIL.



Landscape Architecture Danny Mitchell

505.639.9583 RONALD R. BOHANNAN

ENGINEER'S SEAL Landscape Architect DANNY D. MITCHELL 239 February 27, 2024

P.E. #7868

LOVES TRAVEL CENTER 3200 BroadwayBlvd. S.E.

TIERRA WEST, LLC 5571 MIDWAY PARK PL NE

www.tierrawestllc.com

LS-101 ALBUQUERQUE, NEW MEXICO 87109 (505) 858-3100

JOB # 2022031

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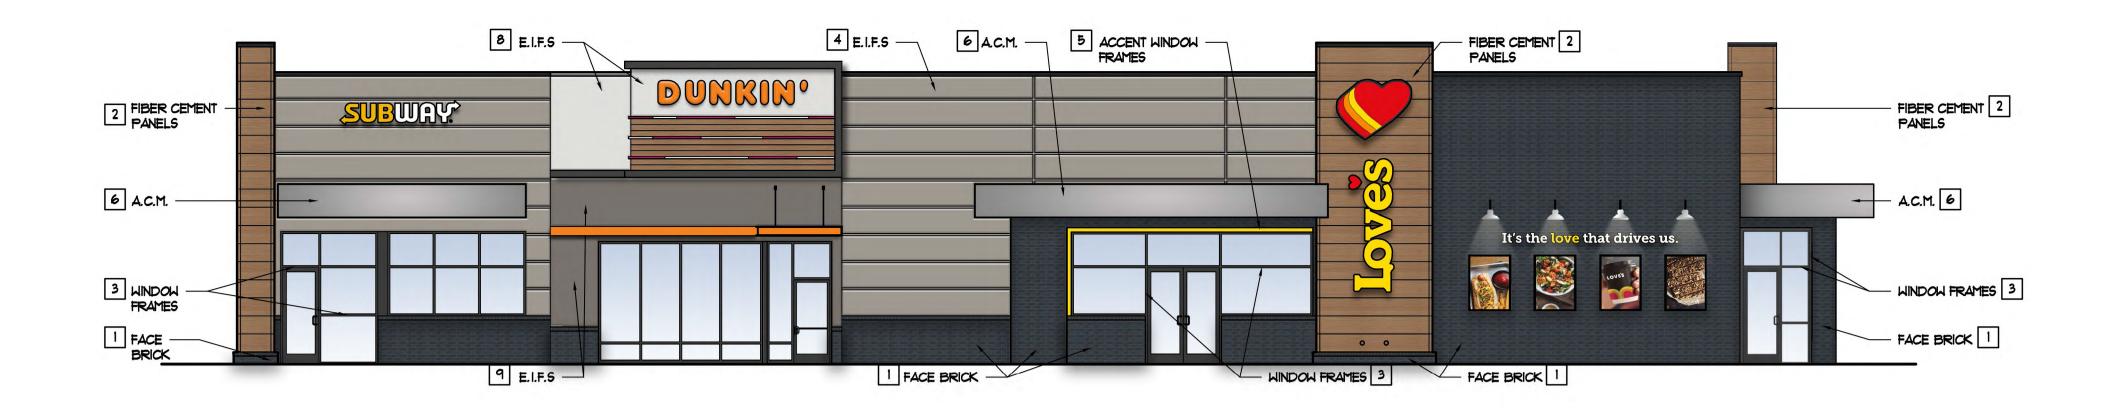
DATE

06-02-23


SHEET #

NOTES BUILDING HEIGHT IS PURSUANT TO APO-3.3 THE FACADE DESIGN IS PURSUANT TO APO-3.3 (DX2)

		EX	KTERIOR FINISH SCHEDULE			
			DES	SCRIPTION	APPROXIMATE LIGHT REFLECTIVE VALUE (L	
CODE	MATERIAL	MANUFACTURER	PRODUCT	FINISH/COLOR		
1	BRICK	ENDICOTT	MODULAR SIZE FACE BRICK	COLOR: MANGANESE IRONSPOT TEXTURE: SMOOTH	0.15	
2	FIBER CEMENT PANELS	NICHIHA	VINTAGEHOOD	SPRICE	14.15	
3	WINDOW FRAMES & EXTERIOR DOORS	TUBELITE	CONTINUOUS INSULATION SYSTEMS	BLACK		
4	EXTERIOR INSULATION FINISHING SYSTEM	DRYVIT	CONTINUOUS INSULATION SYSTEMS	COLOR: TO MATCH SHERWIN WILLIAMS SW 9170 ACIER FINISH: LYMESTONE DPR	32	
5	ACCENT HINDOH FRAMES	TIGER DRYLAC	EXTERIOR/INTERIOR GRADE PONDERCOAT	COLOR: TO MATCH FMS 109 C FINISH: HIGH GLOSS	69	
6	ALUMINUM COMPOSITE MATERIAL	ALPOLIC	4MM DM HLZ ALUMINUM	HLZ HAIRLINE ALUMINUM	32	
7	TREX FENCING	TREX	SECLUSION PRIVACY FENCING	SADDLE		
8	EXTERIOR INSULATION FINISHING SYSTEM	DRYVIT	OFF WHITE PATTERN	"WHITE" EIFS: DRYVIT DUDO 40 2736 ST: MATCH SW 7063 "NEBULOUS WHITE: SANDPEBBLE FINE	74	
9	EXTERIOR INSULATION FINISHING SYSTEM	DRYVIT	GRAY PATTERN	'GRAY' EIFS: DRYVIT \$HDP - DUDO 38 2736 ST: MATCH SH 7019 'GAUNTLET GRAY: SANDPERBI E FINE	п	




WEST ELEVATION (A) SCALE: 1/8" - 1'-0"

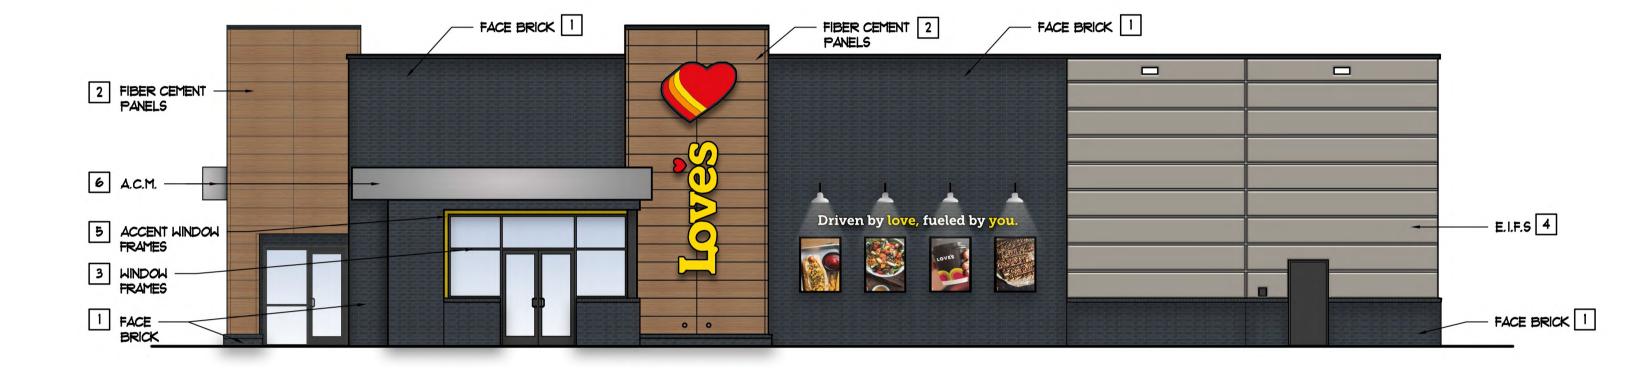


SOUTH ELEVATION SCALE: 1/8" = 1'-0"




C EAST ELEVATION SCALE: 1/8" - 1'-0"

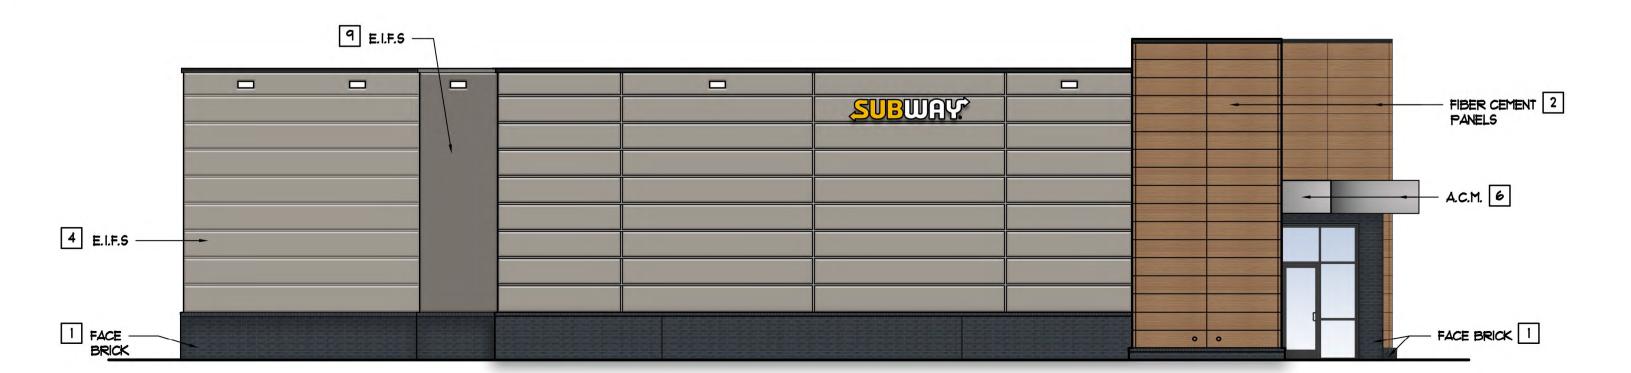


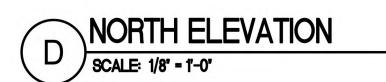



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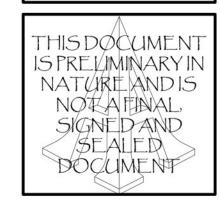


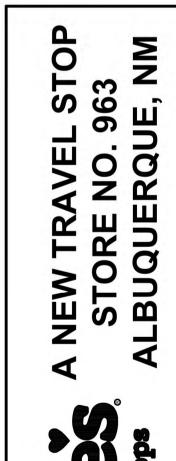

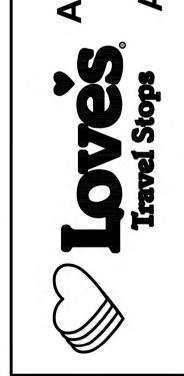BUILDING FINISHES		Iravel
	Revisi	ons:
5	No.	Date
B		
<u></u>		
RIOR		
匣	Projec	t No.: LVS
b	Date:	12/21/22
Ш	Sheet	No.:

12/21/22 **A-1**






Fax 405.463.3493


937 East Britton Road Oklahoma City, OK 73114

pascalarch.com

ssociates,

NEW TRAVEL STOP TIER III ALBUQUERQUE, NM

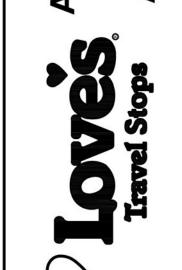

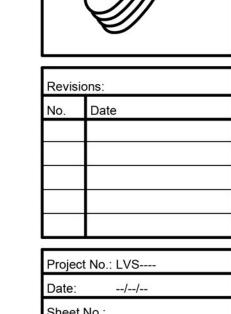





- 1. EXTERIOR BRICK
- 2. TOWER ELEMENT
- 3. WINDOW FRAMES & EXTERIOR DOORS
- 4. EIFs
- 5. ACCENT WINDOW FRAMES & SOFFIT
- 6. FASCIAS AT ENTRY
- 7. TREX FENCING



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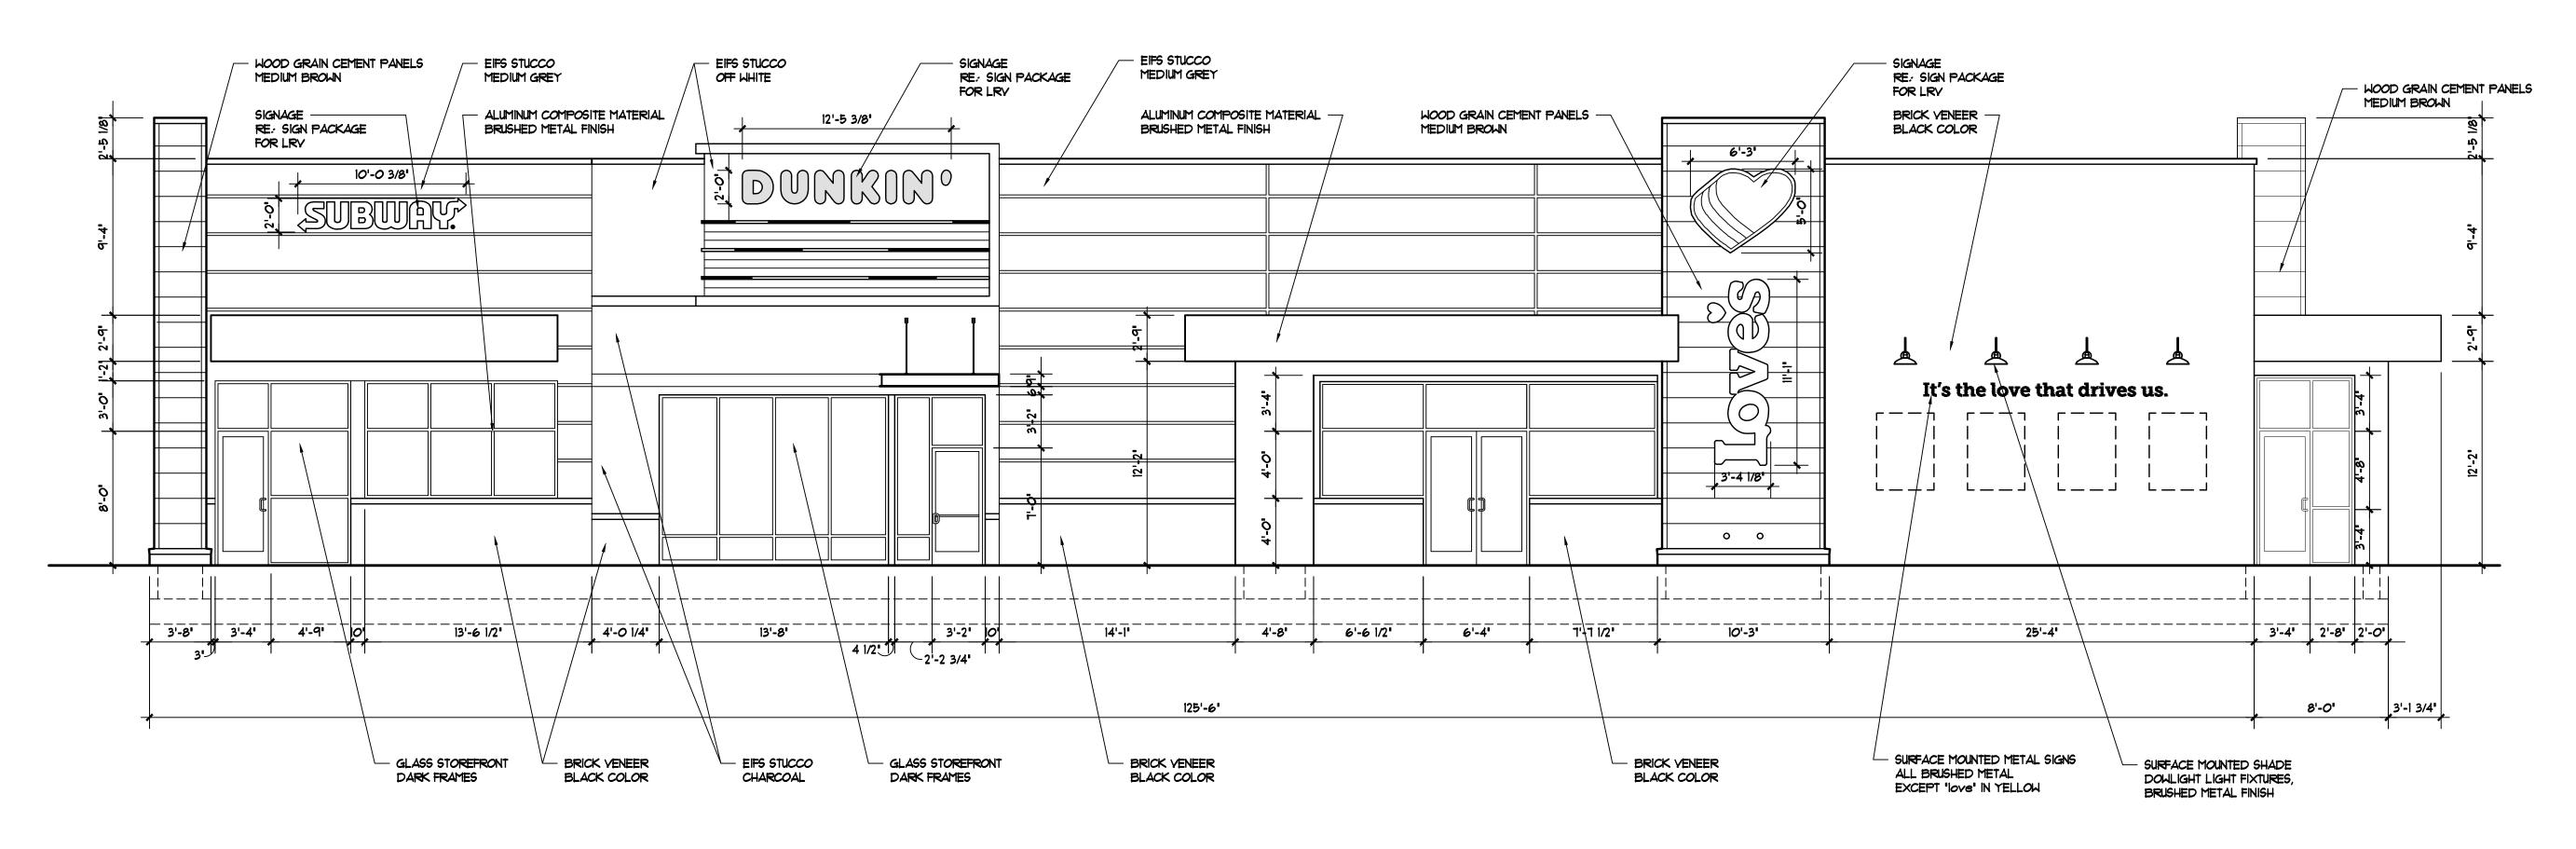
L STOP 963


ELEVATIONS

EXTERIOR **DIMENSIONA**

roject No.: LVS----

12/21/22 OF: XX



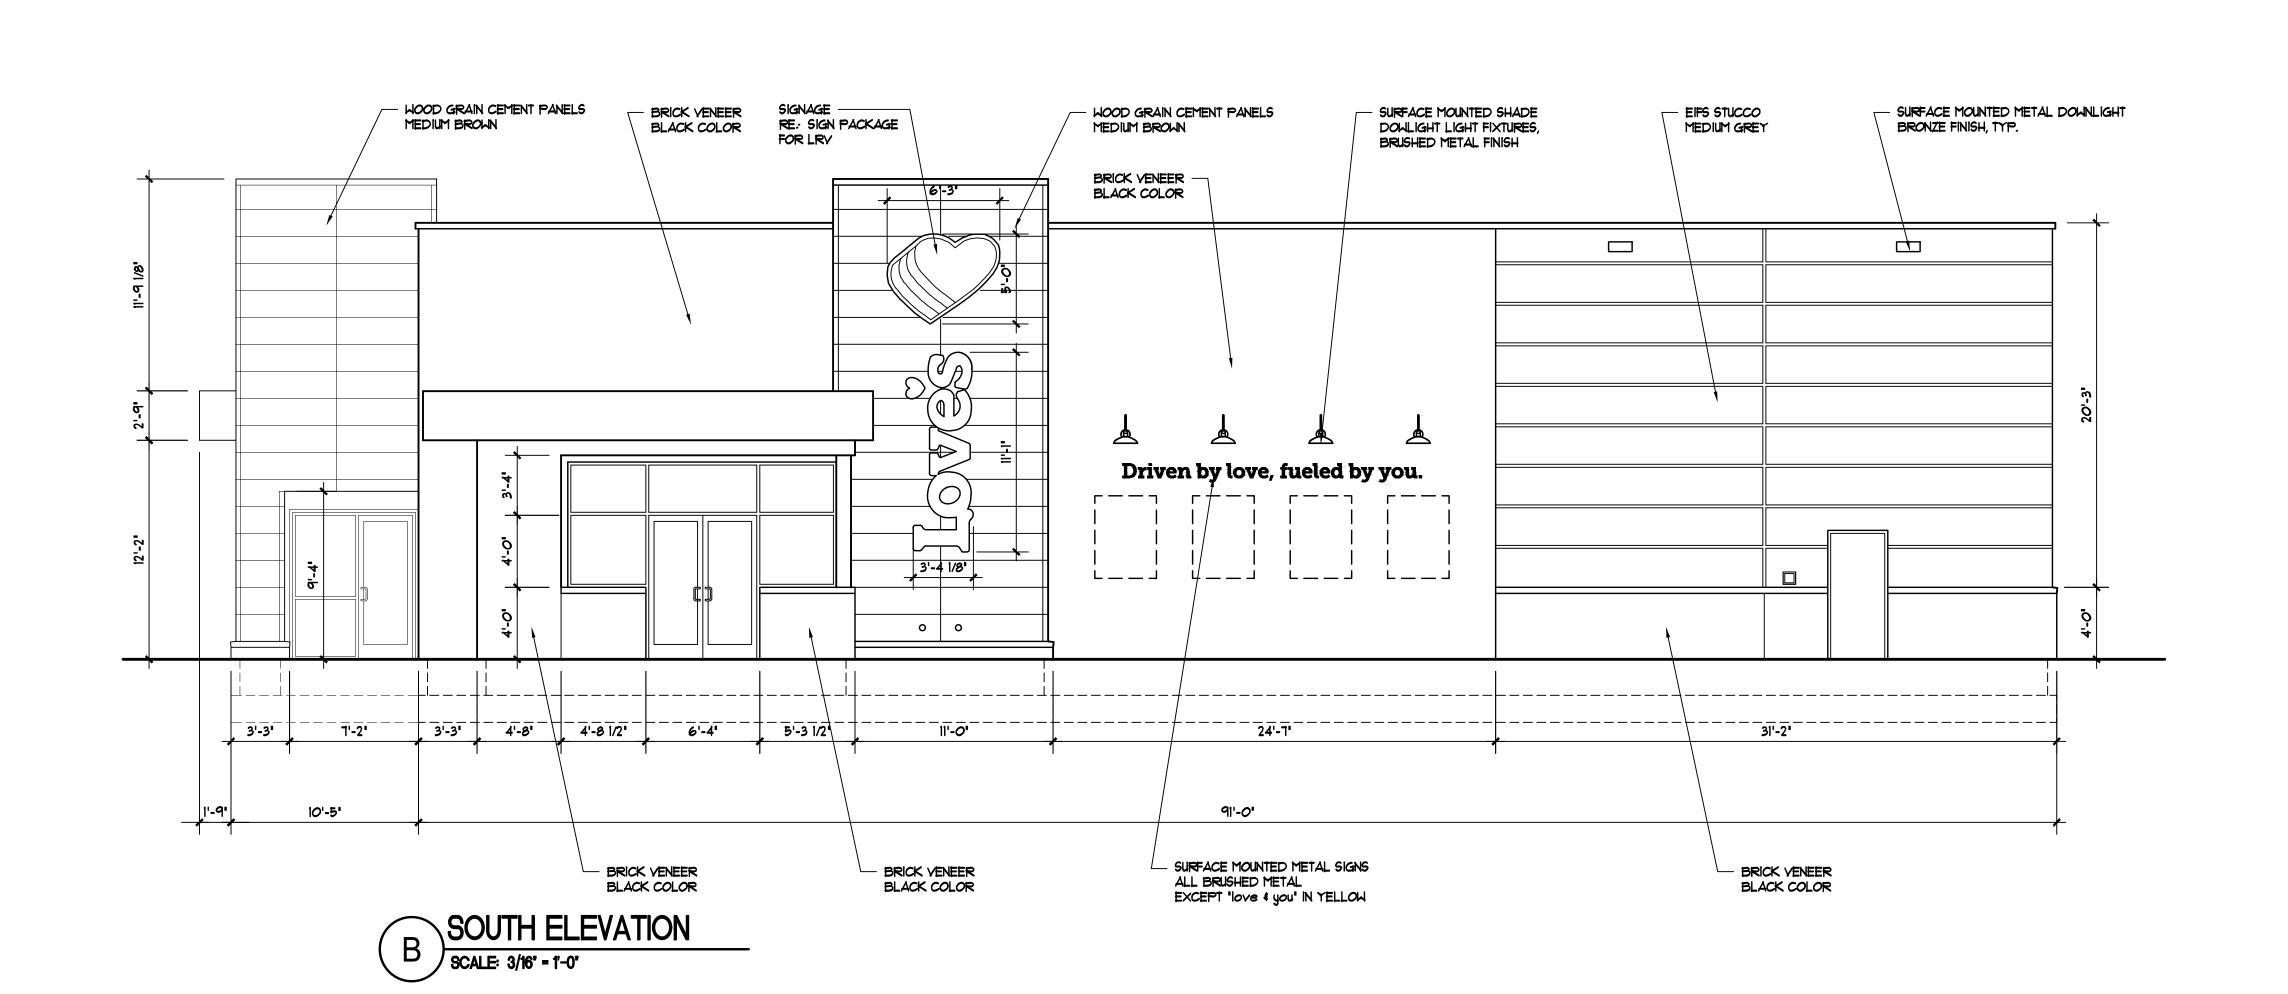



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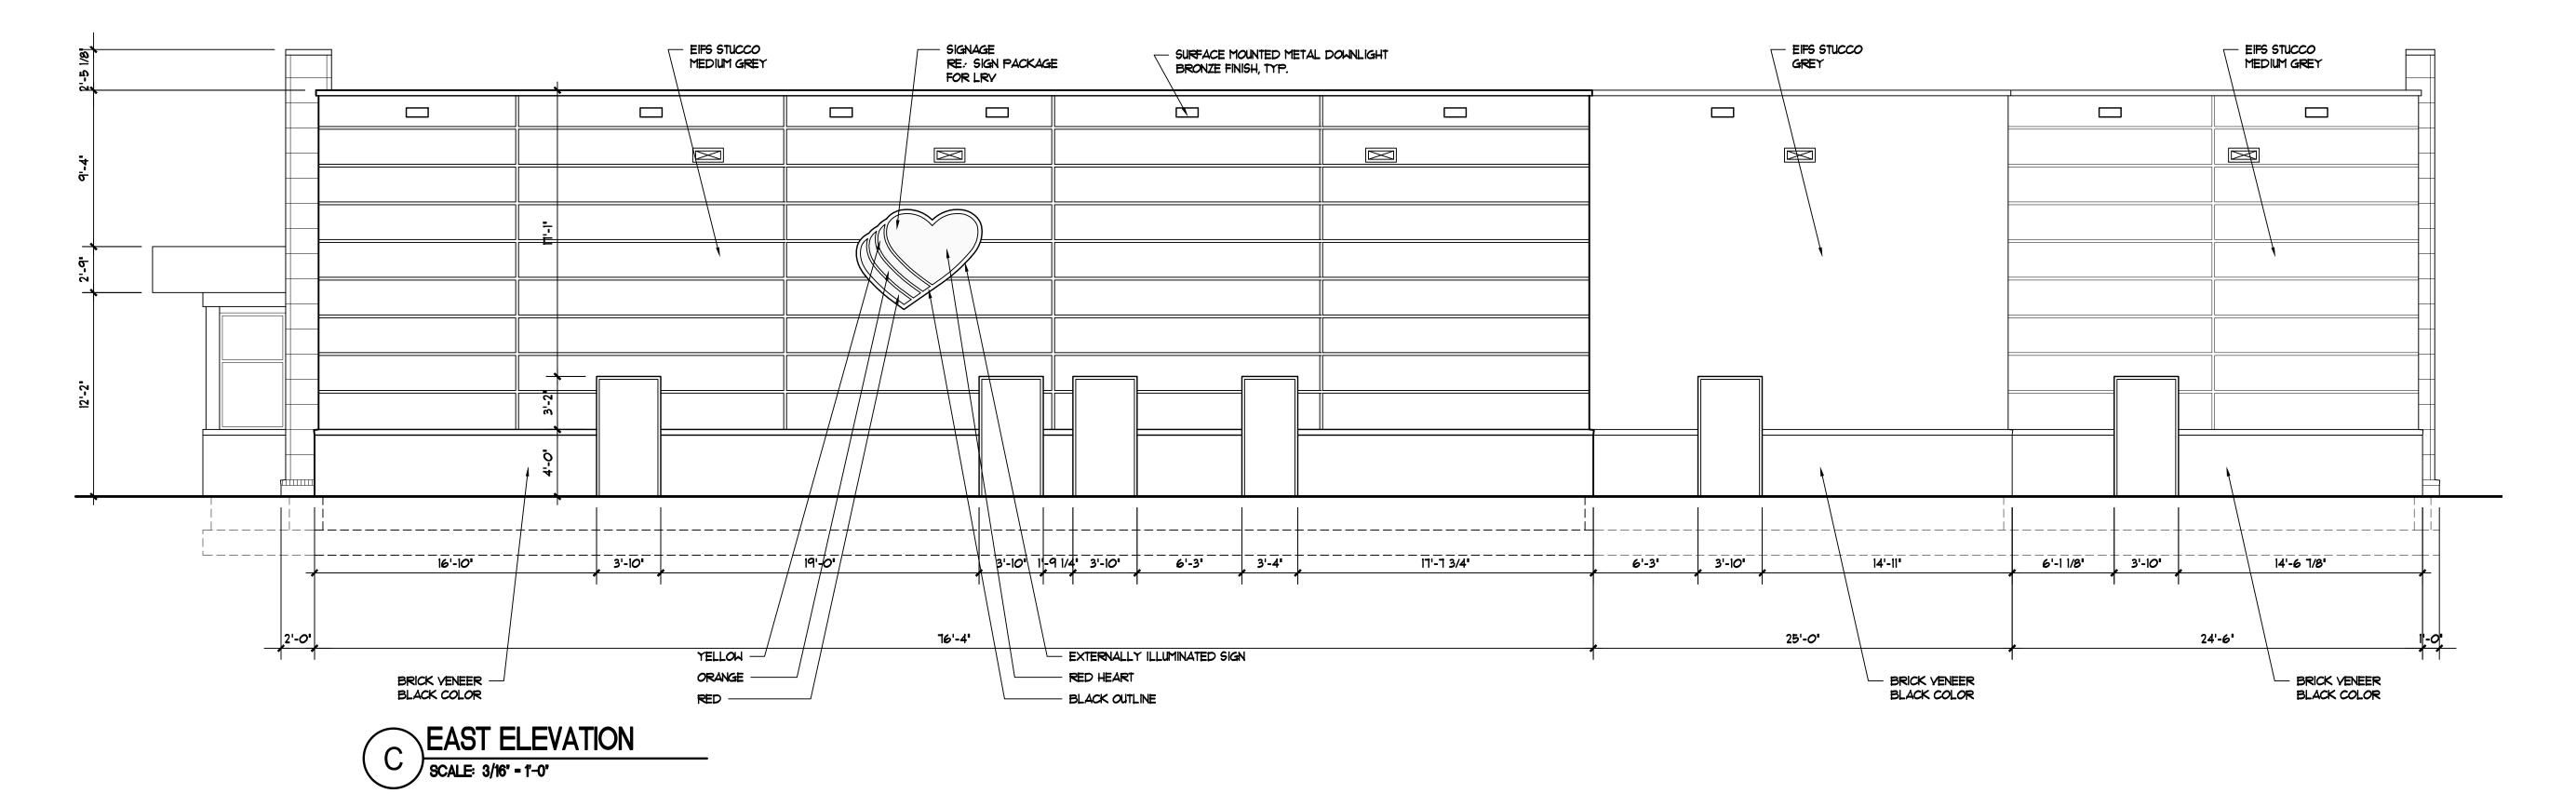
L STOP . 963


EXTERIOR ELEVATIONS

DIMENSIONAL

OF: XX


roject No.: LVS----12/21/22




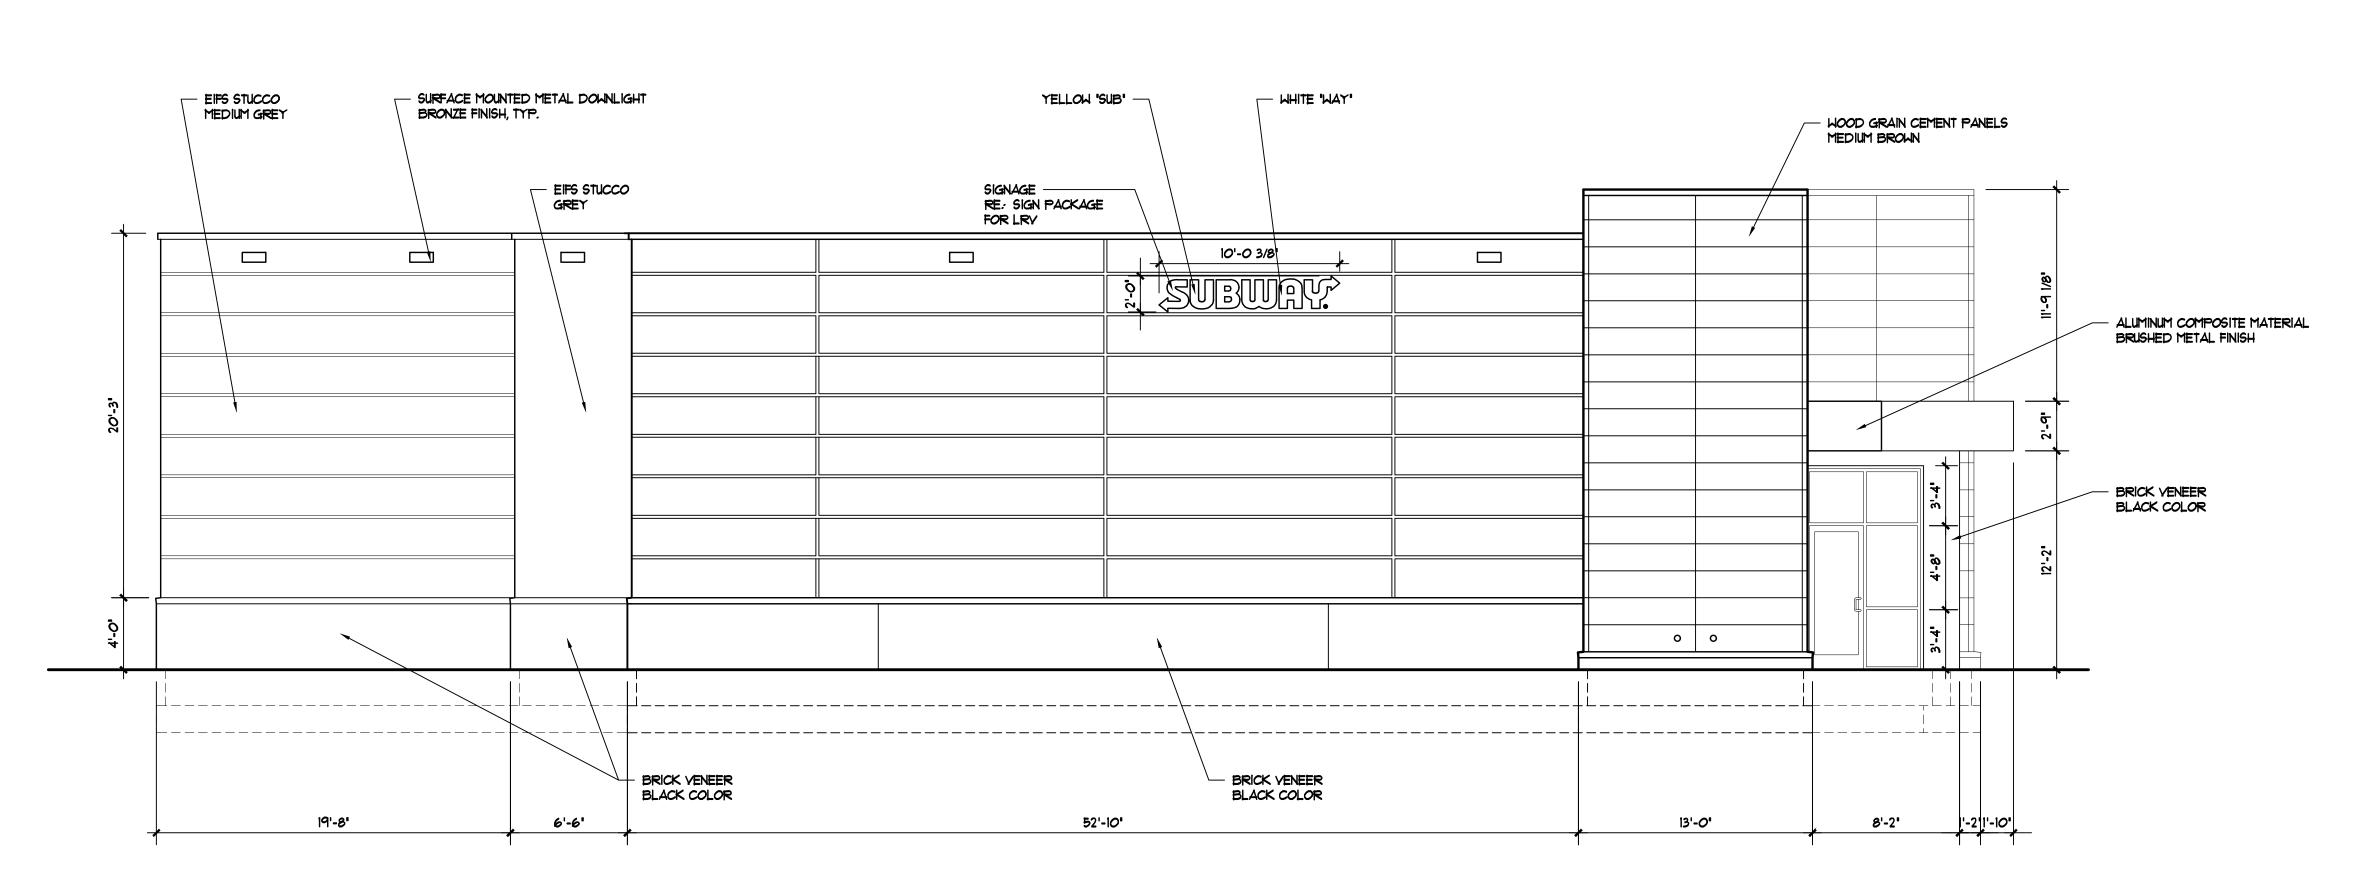

COMPACTOR

A ENCLOSURE PLAN SCALE: 1/4" = 1'-0"

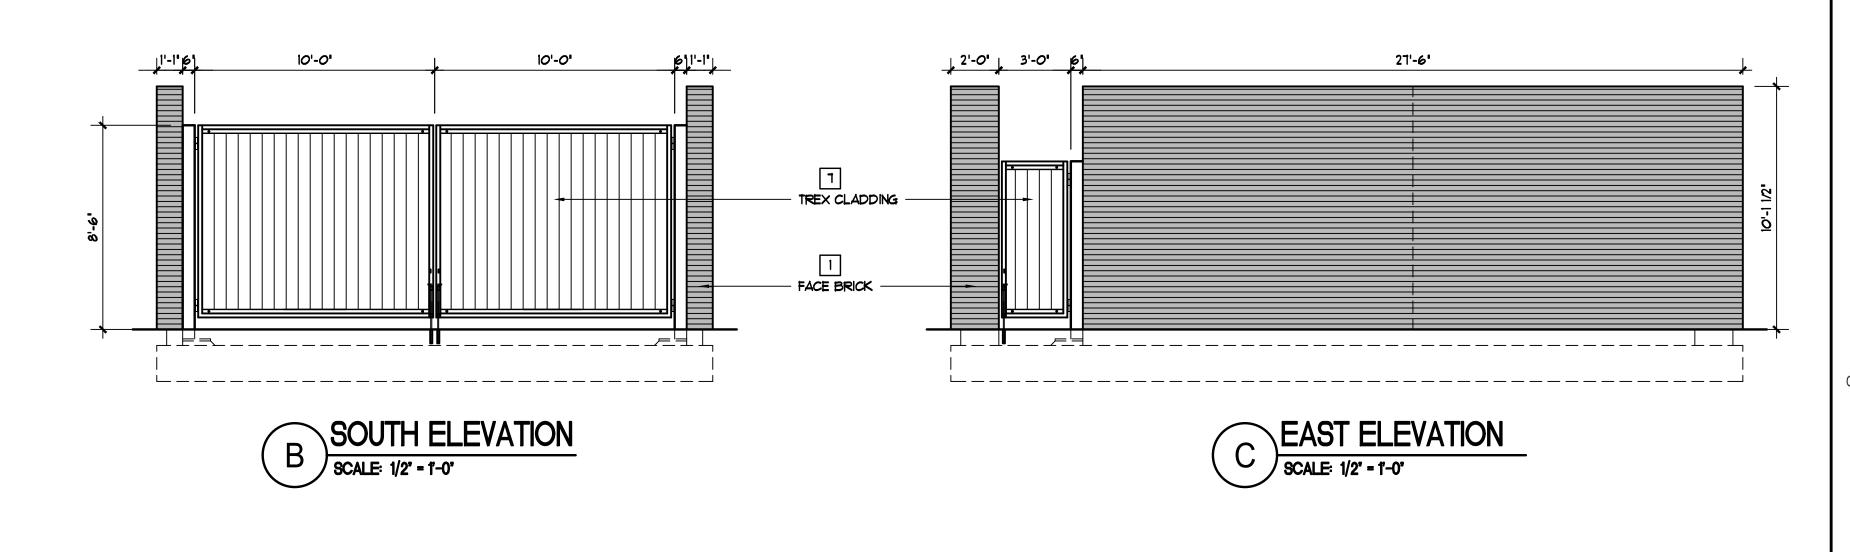

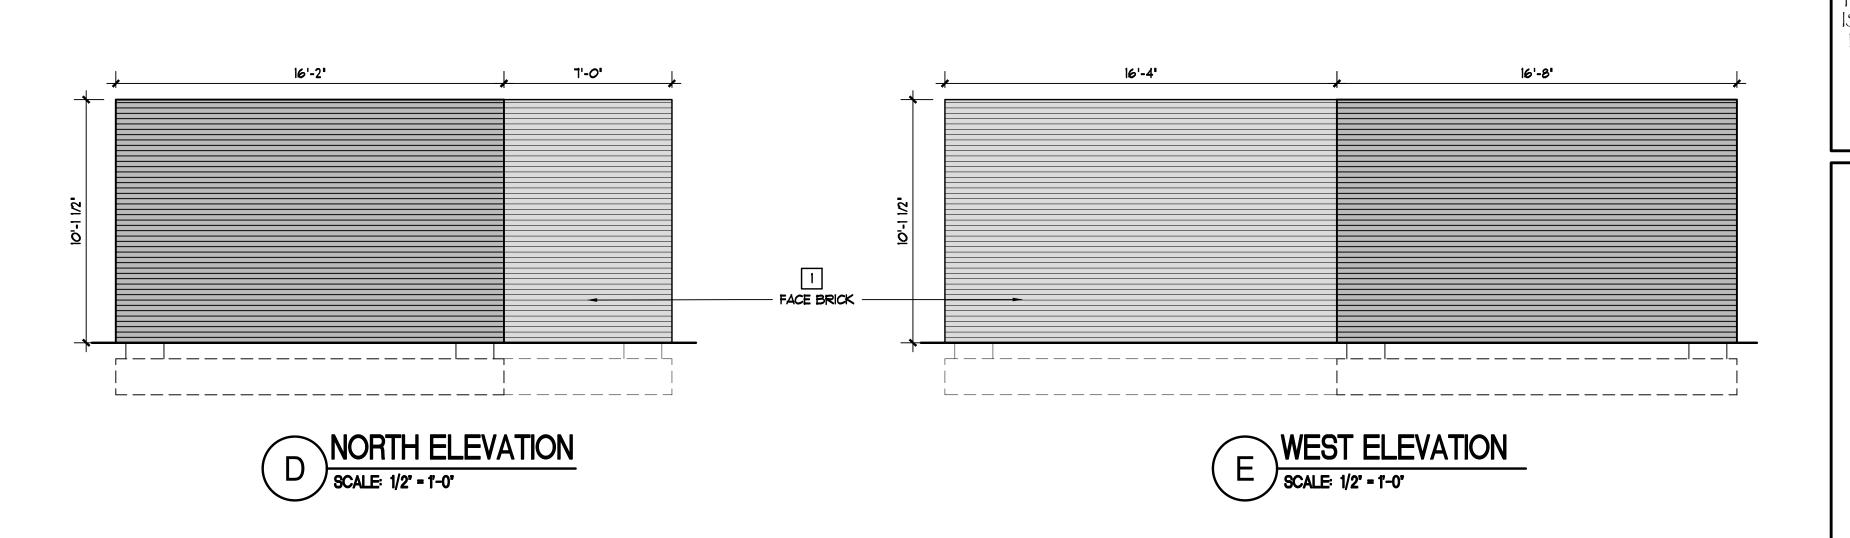



405.463.3494 ax 405.463.3493 d37 East Britton Road noma City, OK 73114

Fax 405.463.3494
Fax 405.463.3493


937 East Britton Road
Oklahoma City, OK 73114
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> A NEW TRAVEL STOF STORE NO. 963 ALBUQUERQUE, NM

LOVES.

Travel Stops




Project No.: LVS---Date: 12/21/22
Sheet No.:

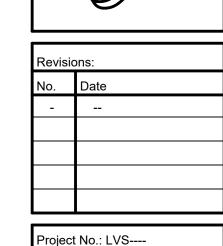
Project No.: LVS---
Date: 12/21/22

Sheet No.: **A-6**

CANOPY

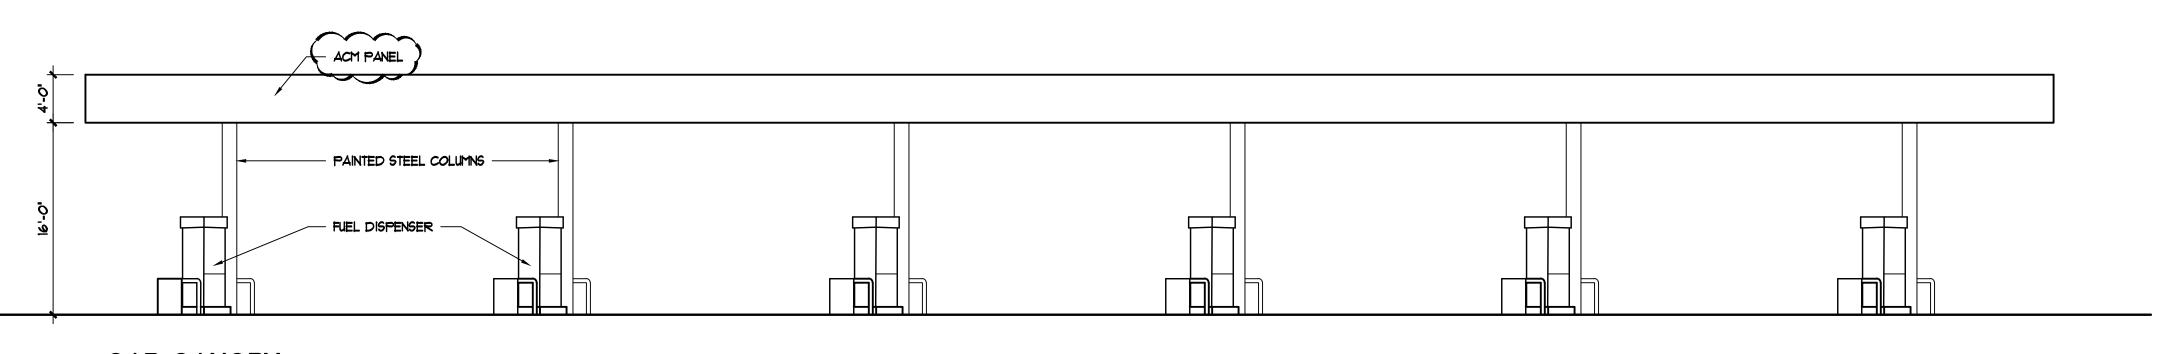




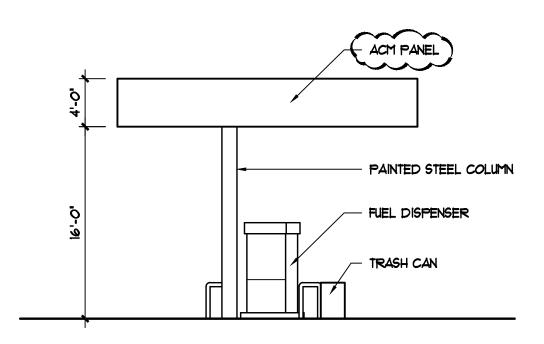


CAR CANOPY
SOUTH ELEVATION
SCALE: 1/8' - 1'-0'

NOTE:

- PER EPC NOTICE OF DECISION, LIGHTING IN THE CANOIES WILL MEET REQUIREMENTS OF IDO 4-3(D)(17)(d).

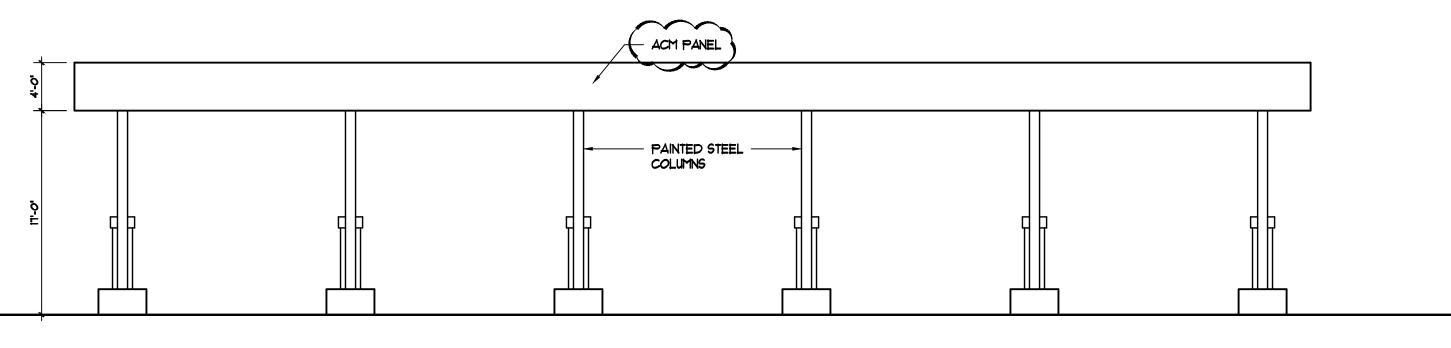



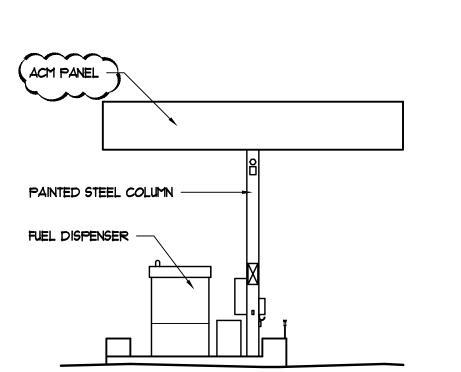

TRUCK CANOPY
NORTH ELEVATION
SCALE: 1/8' - 1'-0'