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	LEGAL DES		
		LANDS OF STEWART WALKER & TRACT 238C1A2/ MAP NO. 38	2
	m.n.o.o.u.		
	EXEMPTION CONSERVATI WASTE MAN OWNER.	L OF THIS PLAN DOES NOT CONSTITUTE OR IMP FROM WATER WASTE PROVISIONS OF THE WATEI ON LANDSCAPING AND WATER WASTE ORDINANC AGEMENT IS THE SOLE RESPONSIBILITY OF THE	R XE WATER PROPERTY
		PE MAINTENANCE SHALL BE THE RESPONSIBILIT	Y OF THE
PACES ACE/UNITX107UNI PACES	OFF LIGHT WITH FULL TS) LIGHT SHAL FIXTURES S	DLES SHALL BE A MAXIMUM OF 20' FEET WIT FIXTURES. LIGHT FIXTURES SHALL BE A MAXI CUT OFF SHIELDS ON FIXTURES SO THAT NO L ESCAPE BEYOND THE PROPERTY LINE. THE HALL BE FULLY SHIELDED WITH HORIZONTAL QUIPMENT SHALL BE BELOW PARAPET HEIGHT	MUM OF 20' FUGITIVE LIGHT LAMPS.
SPACES/GFAX5,43 PACES SPACES/GFAX14,4	SCREENED	FROM VIEW. ALL GROUND MOUNTED EQUIPMENT	IT SHALL BE
PACES		DOWNLENTS WITHIN THE OTY DIGUT OF WAY	LIST DE
A NOLD		ROVEMENTS WITHIN THE CITY RIGHT OF WAY	MUSI BE
WHICH PROVIDE	S A 2 2430.	MBER: PR-2022-007153	IGS 2413A &
	Is an infrastructure of approved DRC plans Public Right-of-Way or DFT SITE DEVELO Ernest anyo TRAFFIC ENGINE	List required? (>) Yes () No If Yes, then a with a work order is required for any construction with for construction of public improvements. DPMENT PLAN APPROVAL ERING, TRANSPORTATION DIVISION	04/25/2024 Date
	ale Gue		05/24/2024
	ABCWUA		Date
		CREATION DEPARTMENT	04/25/2024
	Lieghe	Charlen DEPARTMENT	04/25/2024
	HYDROLOGY		Date
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	. ENVIRONMENT	AL HEALTH DEPARTMENT (CONDITIONAL)	Date
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and the second second	SOLID, WASTE M	ANAGEMENT	Date
	770		05/30/2024
	PLANNING DEPA	RTMENT	Date
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E	ENGINEER'S SEAL	1904 BELLAMAH AVE NW ALBUQUERQUE, NM	DRAWN BY SB
	DR. BOHANNAN MEXICO		DATE 05-11-23
	MEXICO H	TRAFFIC CIRCULATION	
	(((7868))))	LAYOUT	DRAWING

ONAL


RONALD R. BOHANNAN

P.E. #7868

02-15-24

LAYOUT TIERRA WEST, LLC 5571 MIDWAY PARK PL NE ALBUQUERQUE, NEW MEXICO 87109 (505) 858-3100 www.tierrawestlic.com

DRAWING SHEET # SP-1 JOB // 2022045

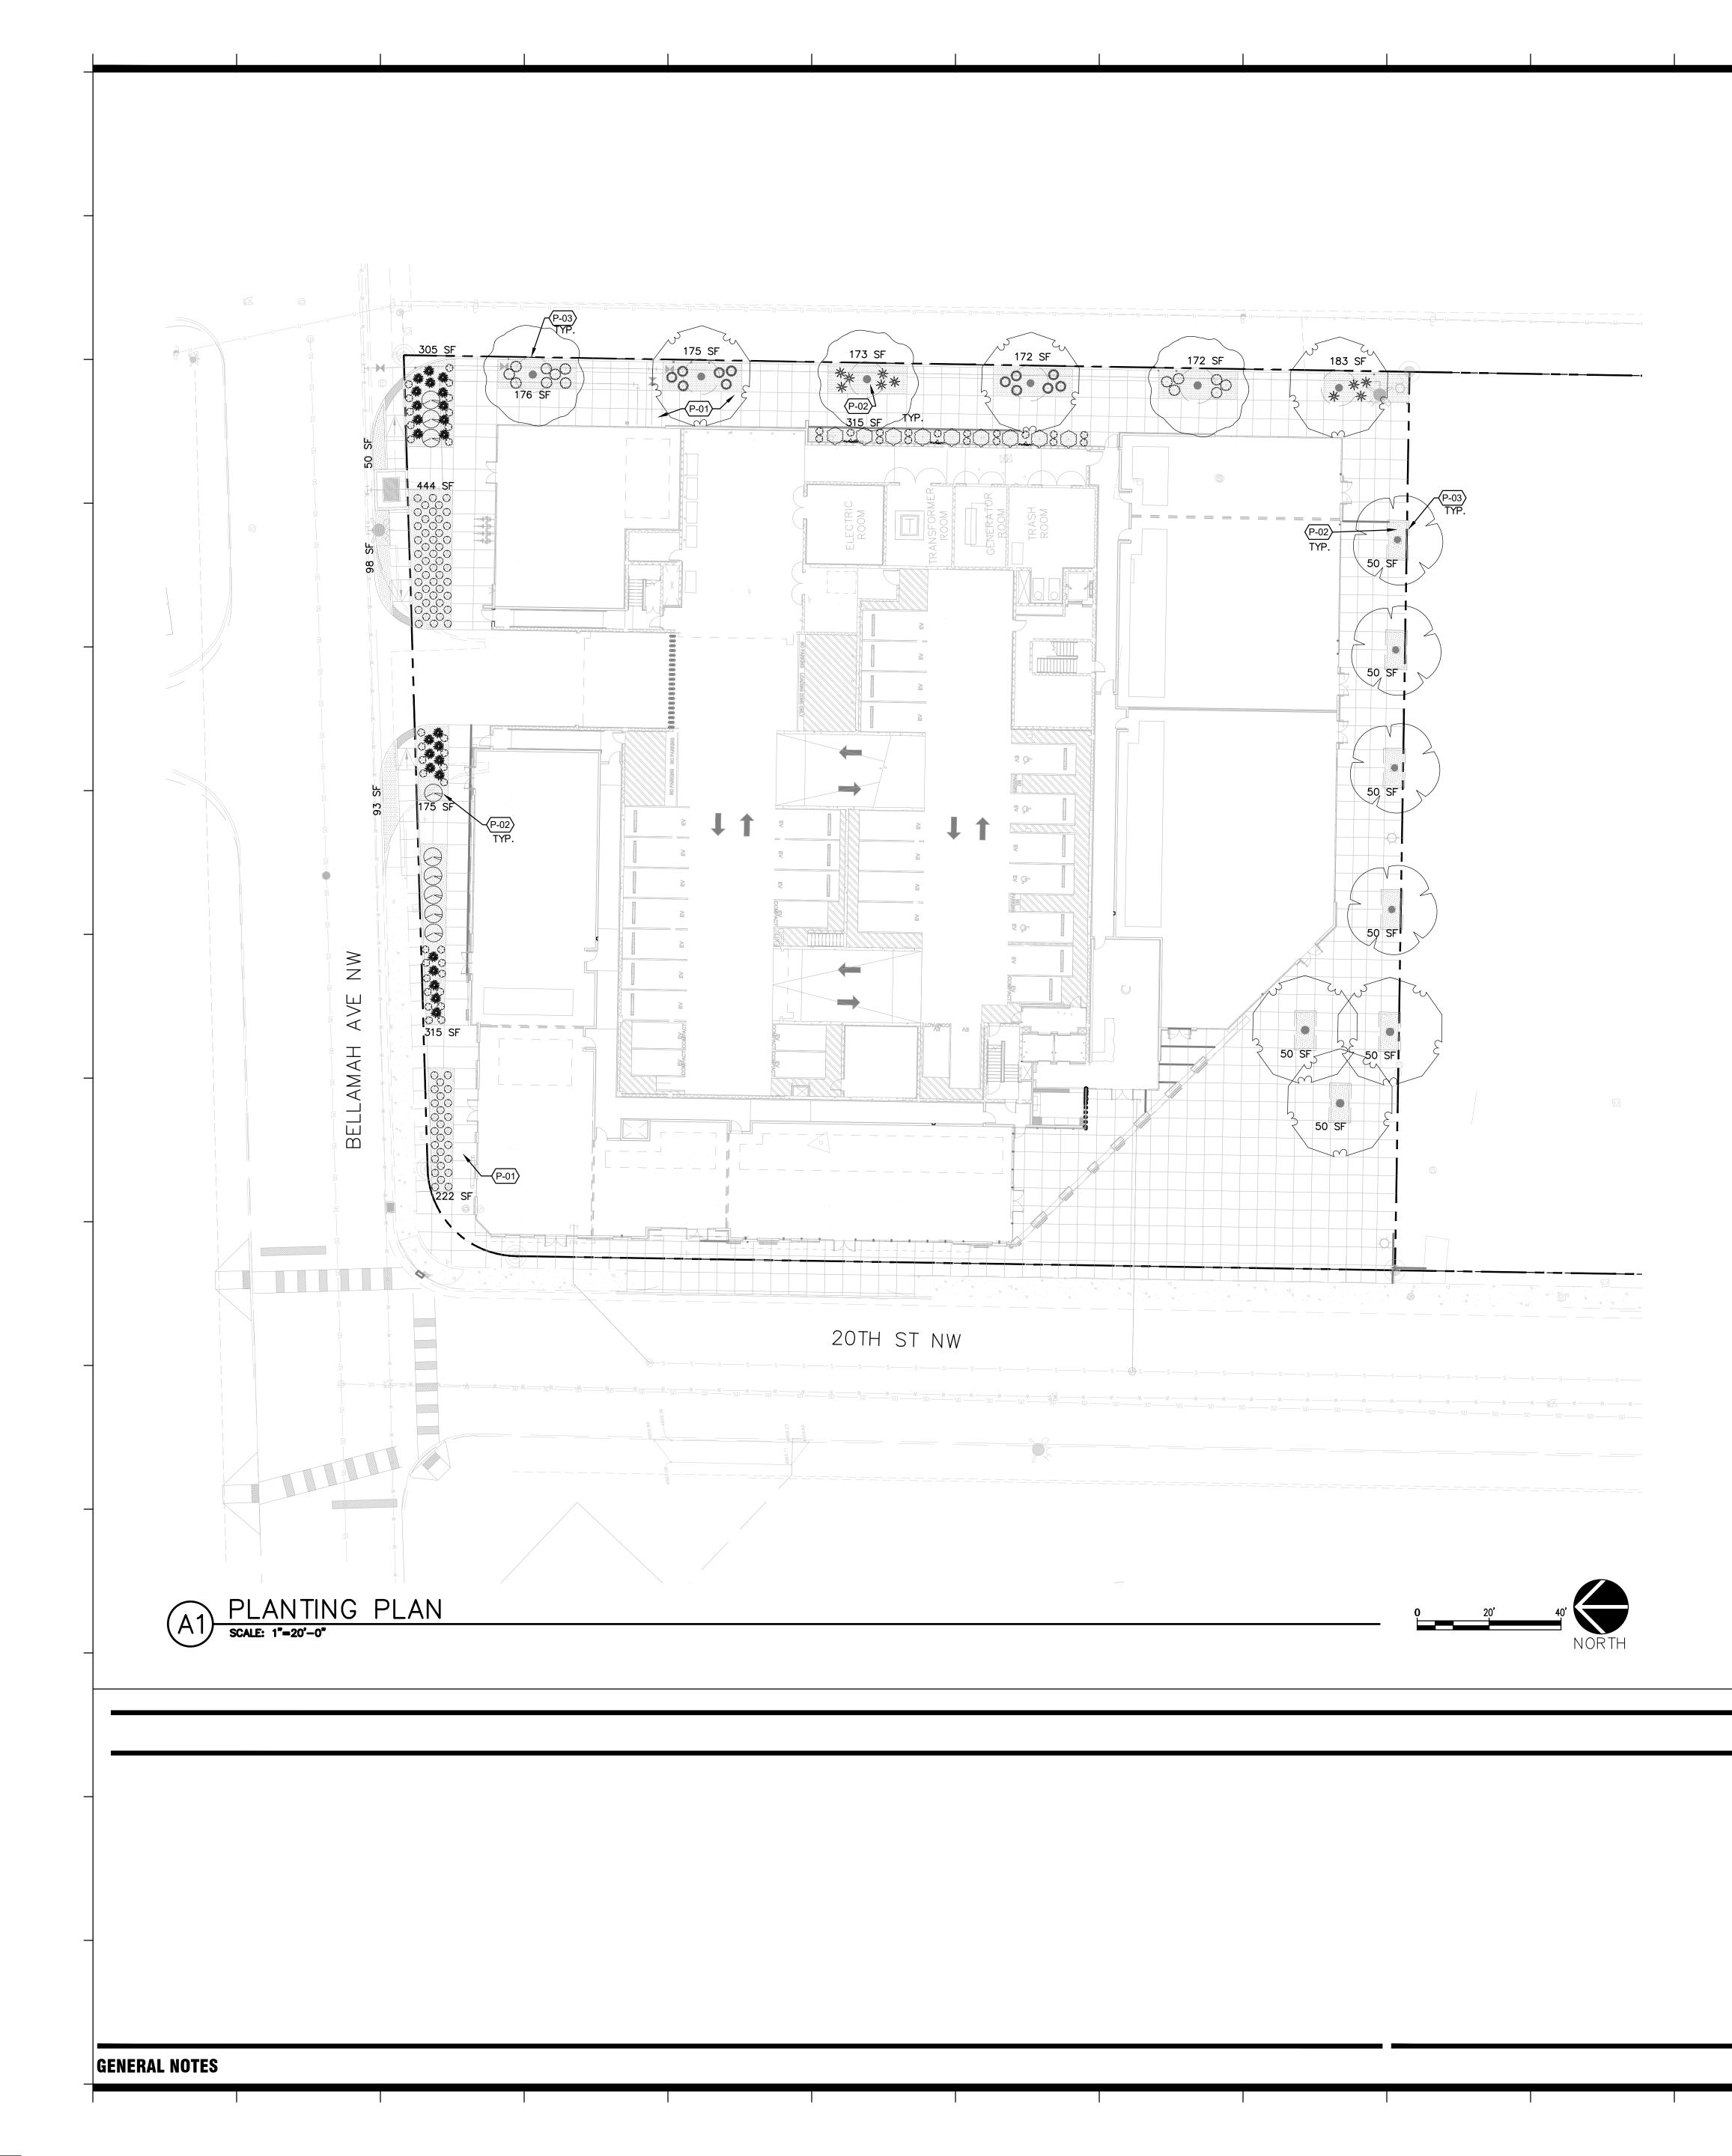

genef	RAL PLANTING NOTES SCHEDULE
CODE	DESCRIPTION
GP-01	IN CASE OF DISCREPANCY IN PLANT QUANTITIES SHOWN ON THE PLANT LEGEND AND THOSE SHOWN ON THE PLANTING PLAN, THE QUANTITIES SHOWN ON THE PLAN SHALL GOVERN. CONTRACTOR SHALL VERIFY ALL QUANTITIES PRIOR TO BID AND INSTALLATION. NO ADDITIONAL PAYMENT WILL BE MADE FOR ANY DISCREPANCIES IN QUANTITIES BETWEEN THE PLANTING PLAN AND THE PLANT LIST.
GP-02	IF THERE IS A DISCREPANCY IN THE FIELD OR NURSERY BETWEEN THE CONTAINER SIZE CALLED OUT UNDER "REMARKS" AND HEIGHT & SPREAD CALLED OUT UNDER "INSTALLED SIZE", THE SPECIFIED PLANT MUST MEET HEIGHT & SPREAD REQUIREMENTS SPECIFIED UNDER "INSTALLED SIZE", EVEN IF A LARGER CONTAINER SIZE IS REQUIRED TO MEET THESE SPECIFICATIONS, AT NO ADDITIONAL COST TO THE OWNER.
GP-03	FILTER FABRIC SHALL BE MIN. 4 OZ. NON—WOVEN NEEDLE—PUNCHED POLYPROPYLENE (MIRAFI OR EQUIVALENT). OVERLAP ENDS 3" AND TURN DOWN EDGES 6".
GP-04	THE TOP OF MULCH SHALL BE 1" BELOW TOP OF ADJACENT CONCRETE SURFACES.
GP-05	THE CONTRACTOR SHALL PRUNE LOWER BRANCHES OF DECIDUOUS TREES AS DIRECTED BY LANDSCAPE ARCHITECT IN THE FIELD.
GP-08	THE CONTRACTOR SHALL INSTALL TREES PER DETAIL A1/LP501.
GP-09	THE CONTRACTOR SHALL INSTALL SHRUBS PER DETAIL A2/LP501.
GP-10	AN AUTOMATIC IRRIGATION SYSTEM WILL BE INSTALLED FOR ALL PLANT MATERIAL. THE SYSTEM WILL BE CONTROLLED BY AN AUTOMATIC CONTROLLER. PLANTS WILL BE IRRIGATED BY LOW WATER USE BUBBLERS. A REDUCED PRESSURE BACKFLOW PREVENTER WILL BE INSTALLED IN A HEATED ENCLOSURE TO PROTECT THE DOMESTIC WATER SUPPLY FROM CROSS-CONTAMINATION.
GP-11	THE OWNER WILL ASSUME RESPONSIBILITY FOR THE MAINTENANCE OF THE LANDSCAPE.
GP-12	VISIBILITY, LANDSCAPING, FENCING, AND SIGNS SHALL NOT INTERFERE WITH CLEAR SIGHT REQUIREMENTS. THEREFORE, SIGNS, WALLS, TREES AND SHRUBS BETWEEN 3 AND 8 FEET IN HEIGHT ( AS MEASURED FROM THE GUTTER PAN ) WILL NOT BE LOCATED IN THE CLEAR SIGHT TRIANGLE.
GP-13	GROUND -MOUNTED EQUIPMENT SCREENING WILL BE DESIGNED TO ALLOW FOR ACCESS

TO UTILITY FACILITIES. ALL SCREENING AND VEGETATION SURROUNDING GROUND-MOUNTED TRANSFORMERS AND UTILITY PADS ARE TO ALLOW 10 FEET OF CLEARANCE IN FRONT OF THE EQUIPMENT DOOR AND 5–6 FEET OF CLEARANCE ON THE REMAINING THREE SIDES FOR SAFE OPERATION, MAINTENANCE, AND REPAIR PURPOSES.

## PLANTING NOTES SCHEDULE

<u>CODE</u>	DESCRIPTION
P-01	CONCRETE SIDEWALK, SEE SITE PLAN
<u>CODE</u>	DESCRIPTION
P-02	GROUNDCOVER MULCH (SHALL BE A COMBINATION OF CRUSHED GRAVEL AND ORGANIC MULCH).
P-03	5' RADIUS AROUND TREE SHALL HAVE ORGANIC MULCH IN LANDSCAPE AREA AROUND TREE

P-03 5' RADIUS AROUND TREE SHALL HAVE ORGANIC MULCH IN LANDSCAPE AREA AROUND TREE WITH NO FILTER FABRIC, SEE DETAIL A1 & A3/LP501

## PLANT SCHEDULE

SYMBOL	QT	<u>Y</u>	COMMON NAME	BOTANICAL NAME	REMARKS	<u>HT.</u>	<u>SPD.</u>
TREES							
n E	3	*	ALLEE LACEBARK ELM	ULMUS PARVIFOLIA 'ALLEE' TM	2" CAL.	60'	35'
	4	*	EMERALD SUNSHINE ELM	ULMUS PROPINQUA 'JFS-BIEBERICH' TM	2" CAL.	20'	20'
A B	3	*	FRONTIER ELM	ULMUS X 'FRONTIER'	2" CAL.	30'	30'
•	3	*	SHUMARD OAK	QUERCUS SHUMARDII	2" CAL.	40'	30'
SHRUBS							
	14	*	DESERT MOUNTAIN TURPENTINE BUSH	ERICAMERIA LARCIFOLIA 'DESERT MOUNTAIN'	5 GAL.	3'	3'
	9	*	STARN THOMPSON BROOM	BACCHARIS X 'STARN'	5 GAL.	4'	6'
DESERT A	CCE	NT	S & GRASSES				
	12	*	BLONDE AMBITION BLUE GRAMA	BOUTELOUA GRACILIS 'BLONDE AMBITION	3 GAL.	3'	3'
	74		KARL FOERSTER FEATHER REED GRASS	CALAMAGROSTIS X ACUTIFLORA 'KARL FOERSTER'	5 GAL.	4'	2'
	24	*	PALE LEAF YUCCA	YUCCA PALLIDA	5 GAL.	4'	3'
	9	*	SPINELESS PRICKLY PEAR	OPUNTIA ELLISIANA	5 GAL.	4'	6'
×	10	*	YELLOW HESPERALOE	HESPERALOE PARVIFLORA 'YELLOW'	3 GAL.	4'	4 <b>'</b>
VINES							
. ratification	3		BOSTON IVY	PARTHENOCISSUS TRICUSPIDATA	1 GAL.	15'	15'
GROUNDO	COVE	ERS	3				
	48		CREEPING GERMANDER	TEUCRIUM AROANIUM	1 GAL.	3"	2'

\* NOTE: PLANTS WITH AN ASTERISK NEXT TO THEM ARE LISTED IN THE APPROVED PLANT LIST FROM CITY OF ALBUQUERQUES LOW WATER USE, DROUGHT TOLERANT, OR XERIC SPECIES.


LANDSCAPE CALCULATIONS		
<u>GENERAL LANDSCAPE REQUIREMENTS:</u> GROSS LOT AREA: BUILDING COVERAGE: NET LOT AREA:	68,714 SF 49,426 SF 19,270 SF	
REQUIRED LANDSCAPE IS 15% OF NET LOT AREA TOTAL LANDSCAPE AREA REQUIRED: LANDSCAPE AREA PROVIDED:	2,893 SF 3,418 SF	
REQUIRED VEGETATIVE COVERAGE (75% OF THE REQUIRED LANDSCAPE AREA): VEGETATIVE COVER REQUIRED: VEGETATIVE COVER PROVIDED:	2,170 SF 9,970 SF	
REQUIRED GROUND LEVEL VEGETATIVE COVERAGE (25% OF THE REQUIRED LAND VEGETATIVE GROUNDCOVER REQUIRED: VEGETATIVE GROUNDCOVER PROVIDED:	<u>SCAPE AREA):</u> 723 SF 1,731 SF	
REQUIRED GROUNDCOVER MULCH (CRUSHED GRAVEL NOT TO EXCEEED 75%) : ORGANIC MULCH REQUIRED (MIN. 15% REQUIRED LANDCAPE AREA): ORGANIC MULCH PROVIDED:	724 SF 935 SF	




OFFICEUNTITLED ARCHITECT 4200 SEPULVEDA BLVD, STE 104, CULVER CITY, CA 90230 P.310.730.6698

## SAWMILL (LOT A)

1904 BELLAMAH AVE NW, ALBUQUERQUE, NM 87104

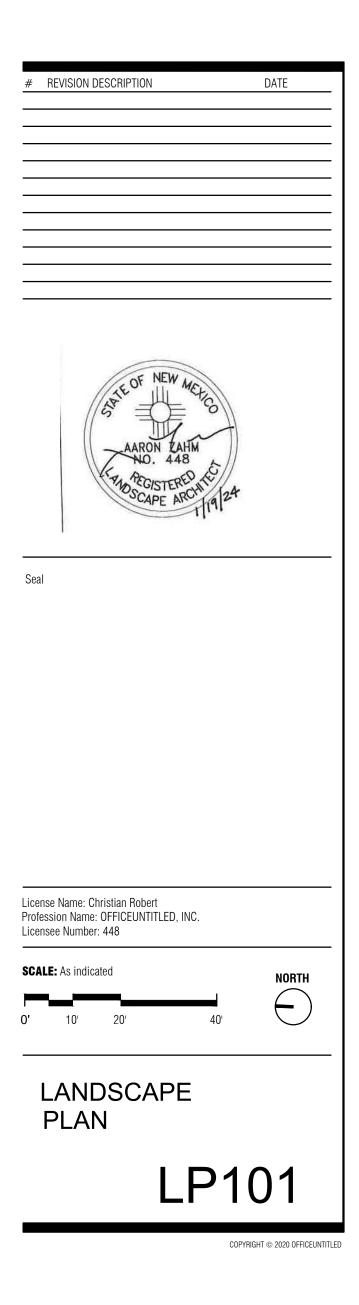

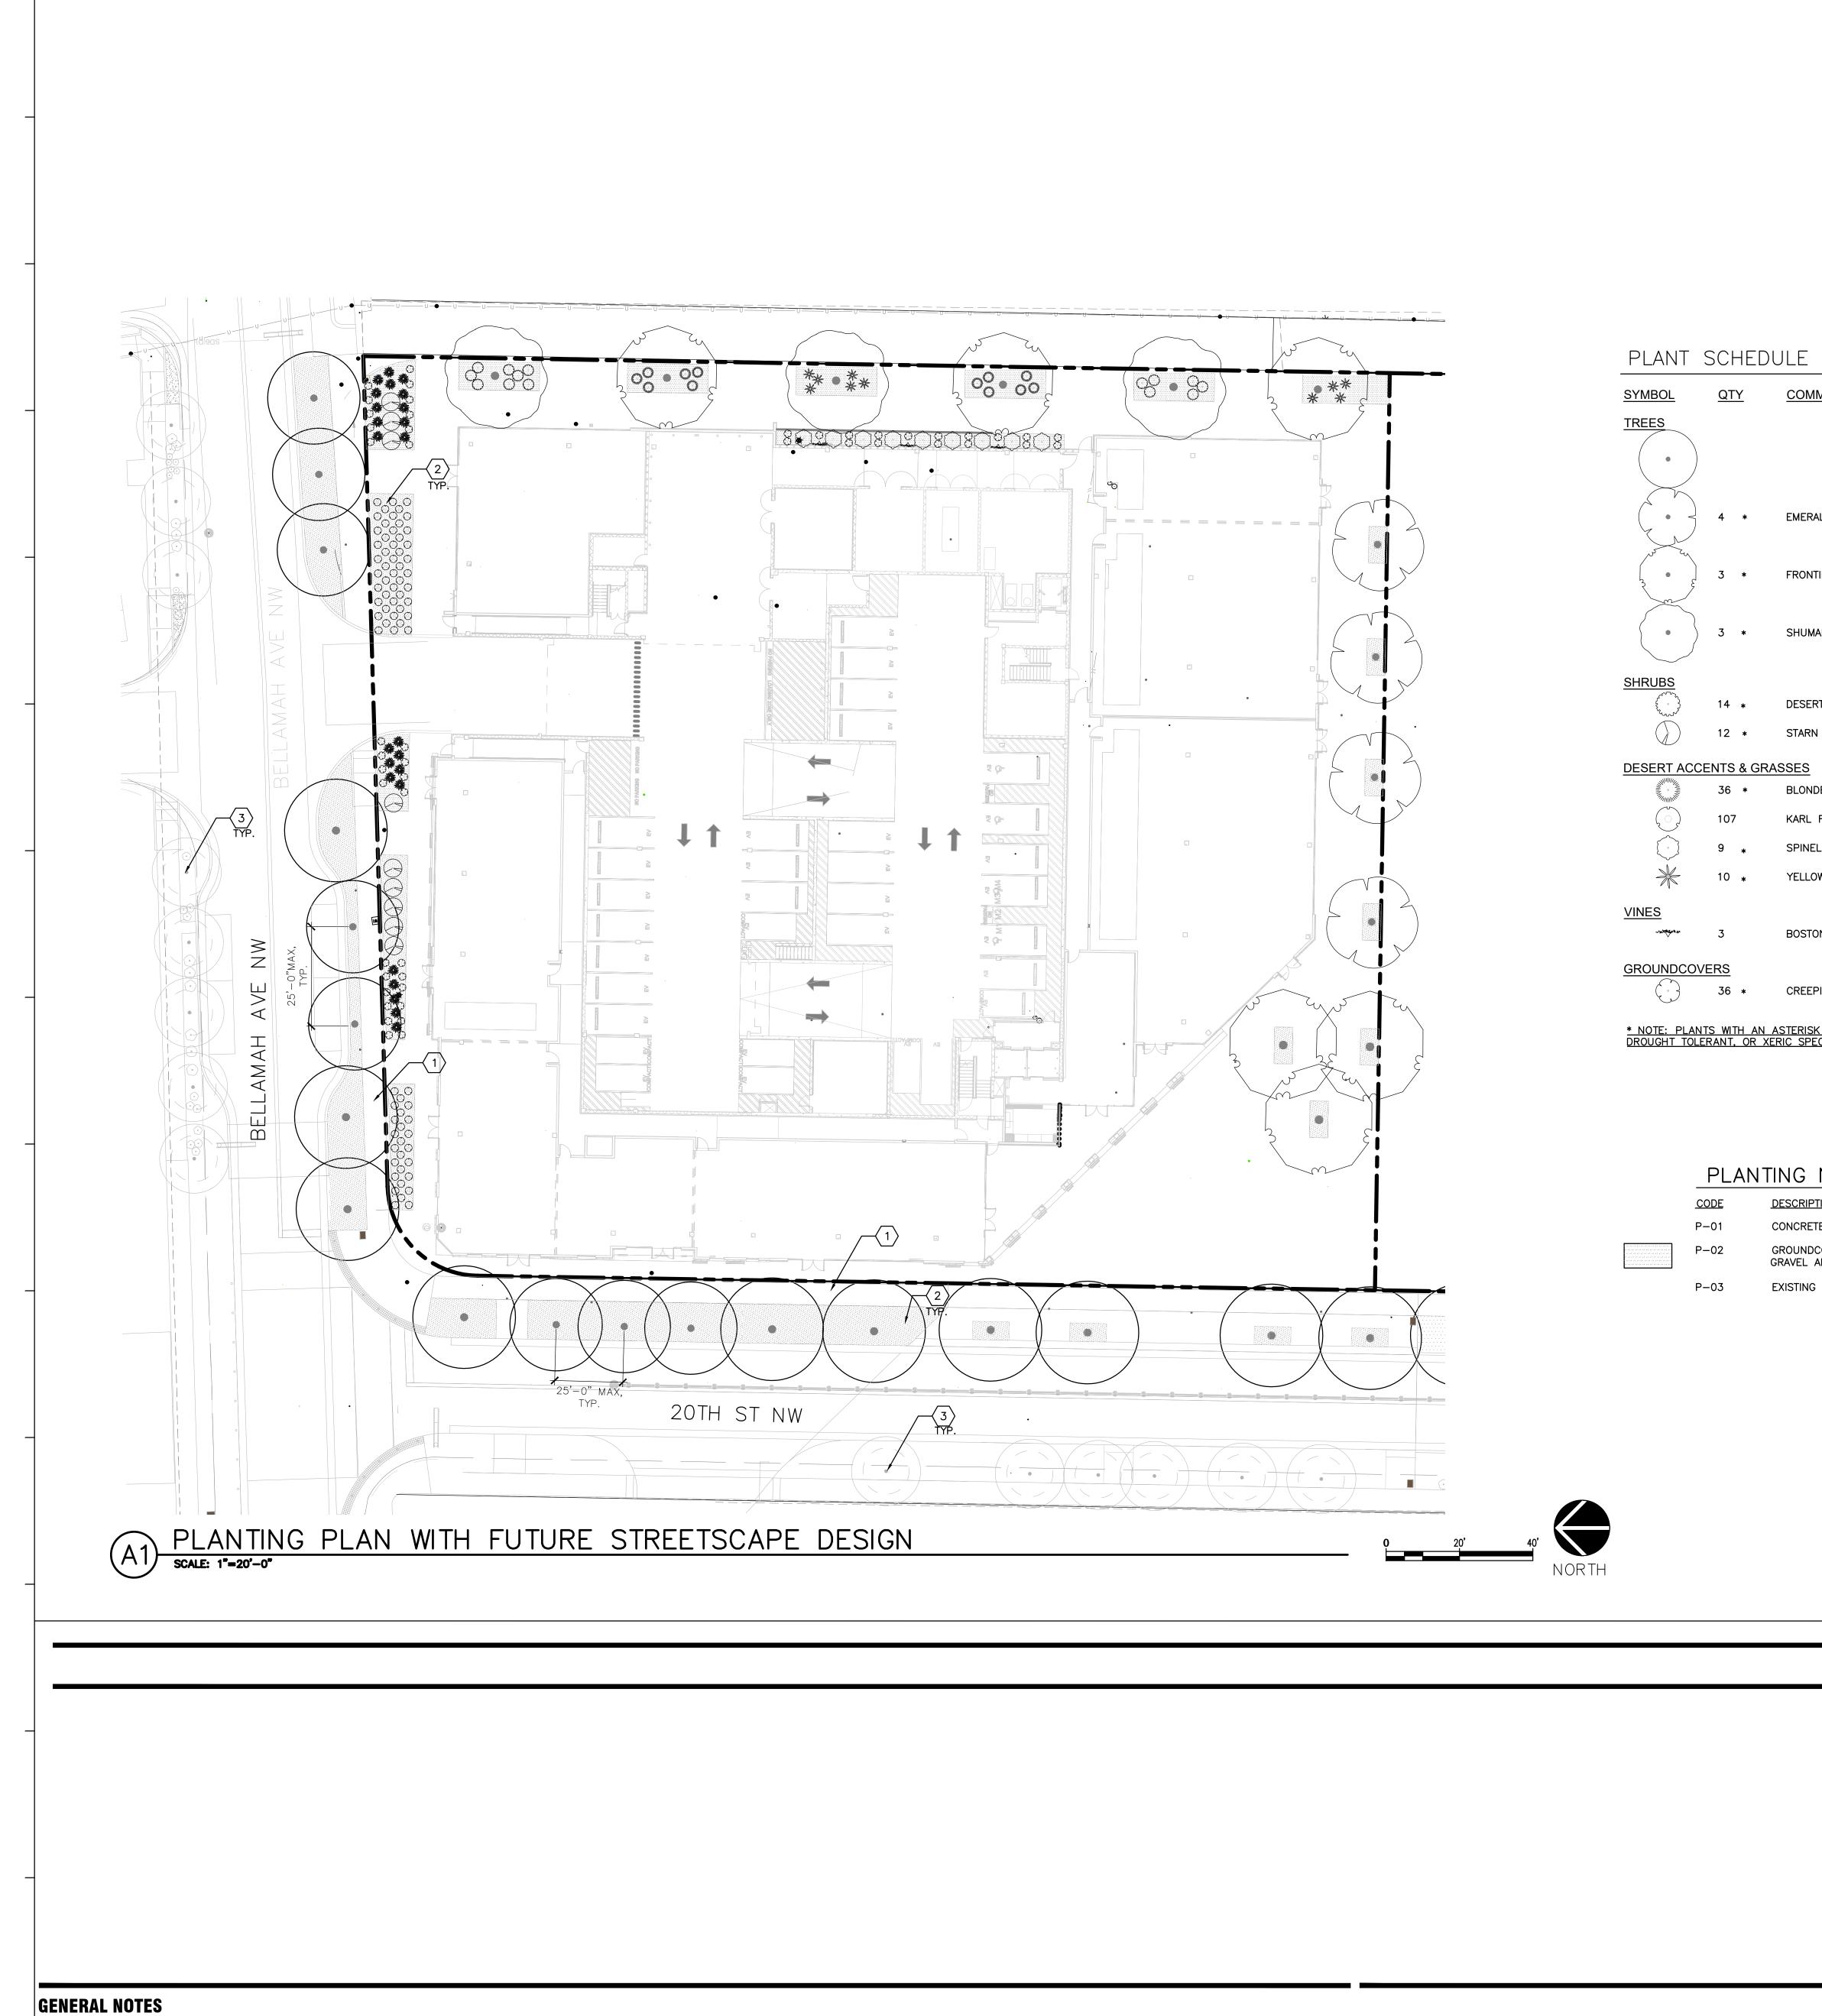

	COMMON NAME	BOTANICAL NAME	REMARKS	<u>HT.</u>	<u>SPD.</u>
		ROW IMPROVEMENTS STREET TREE. PLEASE REFERENCE COA STREETSCAPE PROJECT# 617579			
	EMERALD SUNSHINE ELM	ULMUS PROPINQUA 'JFS-BIEBERICH' TM	2" CAL.	20'	20'
	FRONTIER ELM	ULMUS X 'FRONTIER'	2" CAL.	30'	30ʻ
	SHUMARD OAK	QUERCUS SHUMARDII	2" CAL.	40 <b>ʻ</b>	30'
	DESERT MOUNTAIN TURPENTINE BUSH	ERICAMERIA LARCIFOLIA 'DESERT MOUNTAIN'	5 GAL.	3'	3՝
	STARN THOMPSON BROOM	BACCHARIS X 'STARN'	5 GAL.	4'	6'
GRA	SSES				
	BLONDE AMBITION BLUE GRAMA	BOUTELOUA GRACILIS 'BLONDE AMBITION	3 GAL.	3'	3'
	KARL FOERSTER FEATHER REED GRASS	CALAMAGROSTIS X ACUTIFLORA 'KARL FOERSTER'	5 GAL.	4'	2'
	SPINELESS PRICKLY PEAR	OPUNTIA ELLISIANA	5 GAL.	4'	6'
	YELLOW HESPERALOE	HESPERALOE PARVIFLORA 'YELLOW'	3 GAL.	4'	4'
	BOSTON IVY	PARTHENOCISSUS TRICUSPIDATA	1 GAL.	15'	15'
	CREEPING GERMANDER	TEUCRIUM AROANIUM	1 GAL.	3"	2'

\* NOTE: PLANTS WITH AN ASTERISK NEXT TO THEM ARE LISTED IN THE APPROVED PLANT LIST FROM CITY OF ALBUQUERQUES LOW WATER USE. DROUGHT TOLERANT, OR XERIC SPECIES.

## PLANTING NOTES SCHEDULE

DESCRIPTION CONCRETE SIDEWALK, SEE SITE PLAN GROUNDCOVER MULCH (SHALL BE A COMBINATION OF CRUSHED GRAVEL AND ORGANIC MULCH).


EXISTING TREE TO REMAIN




OFFICEUNTITLED ARCHITECT 4200 SEPULVEDA BLVD, STE 104, CULVER CITY, CA 90230 P.310.730.6698

## SAWMILL (LOT A)

1904 BELLAMAH AVE NW, ALBUQUERQUE, NM 87104

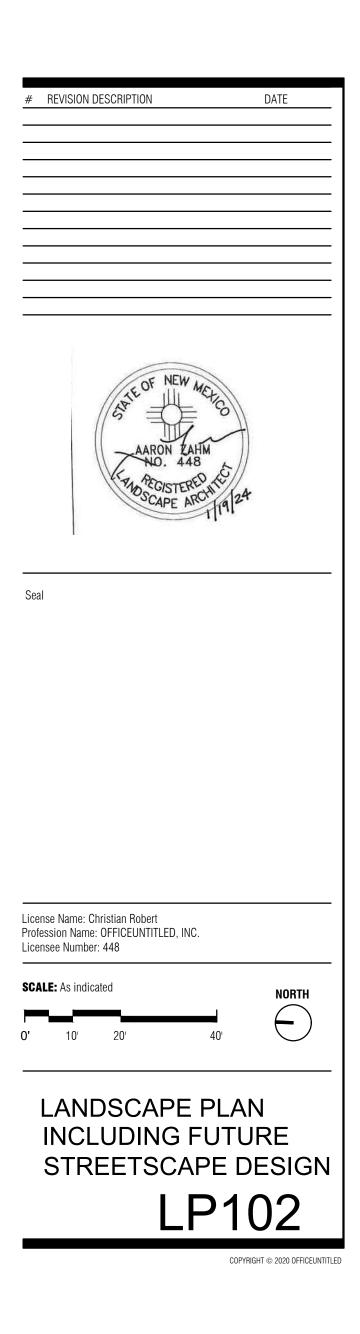

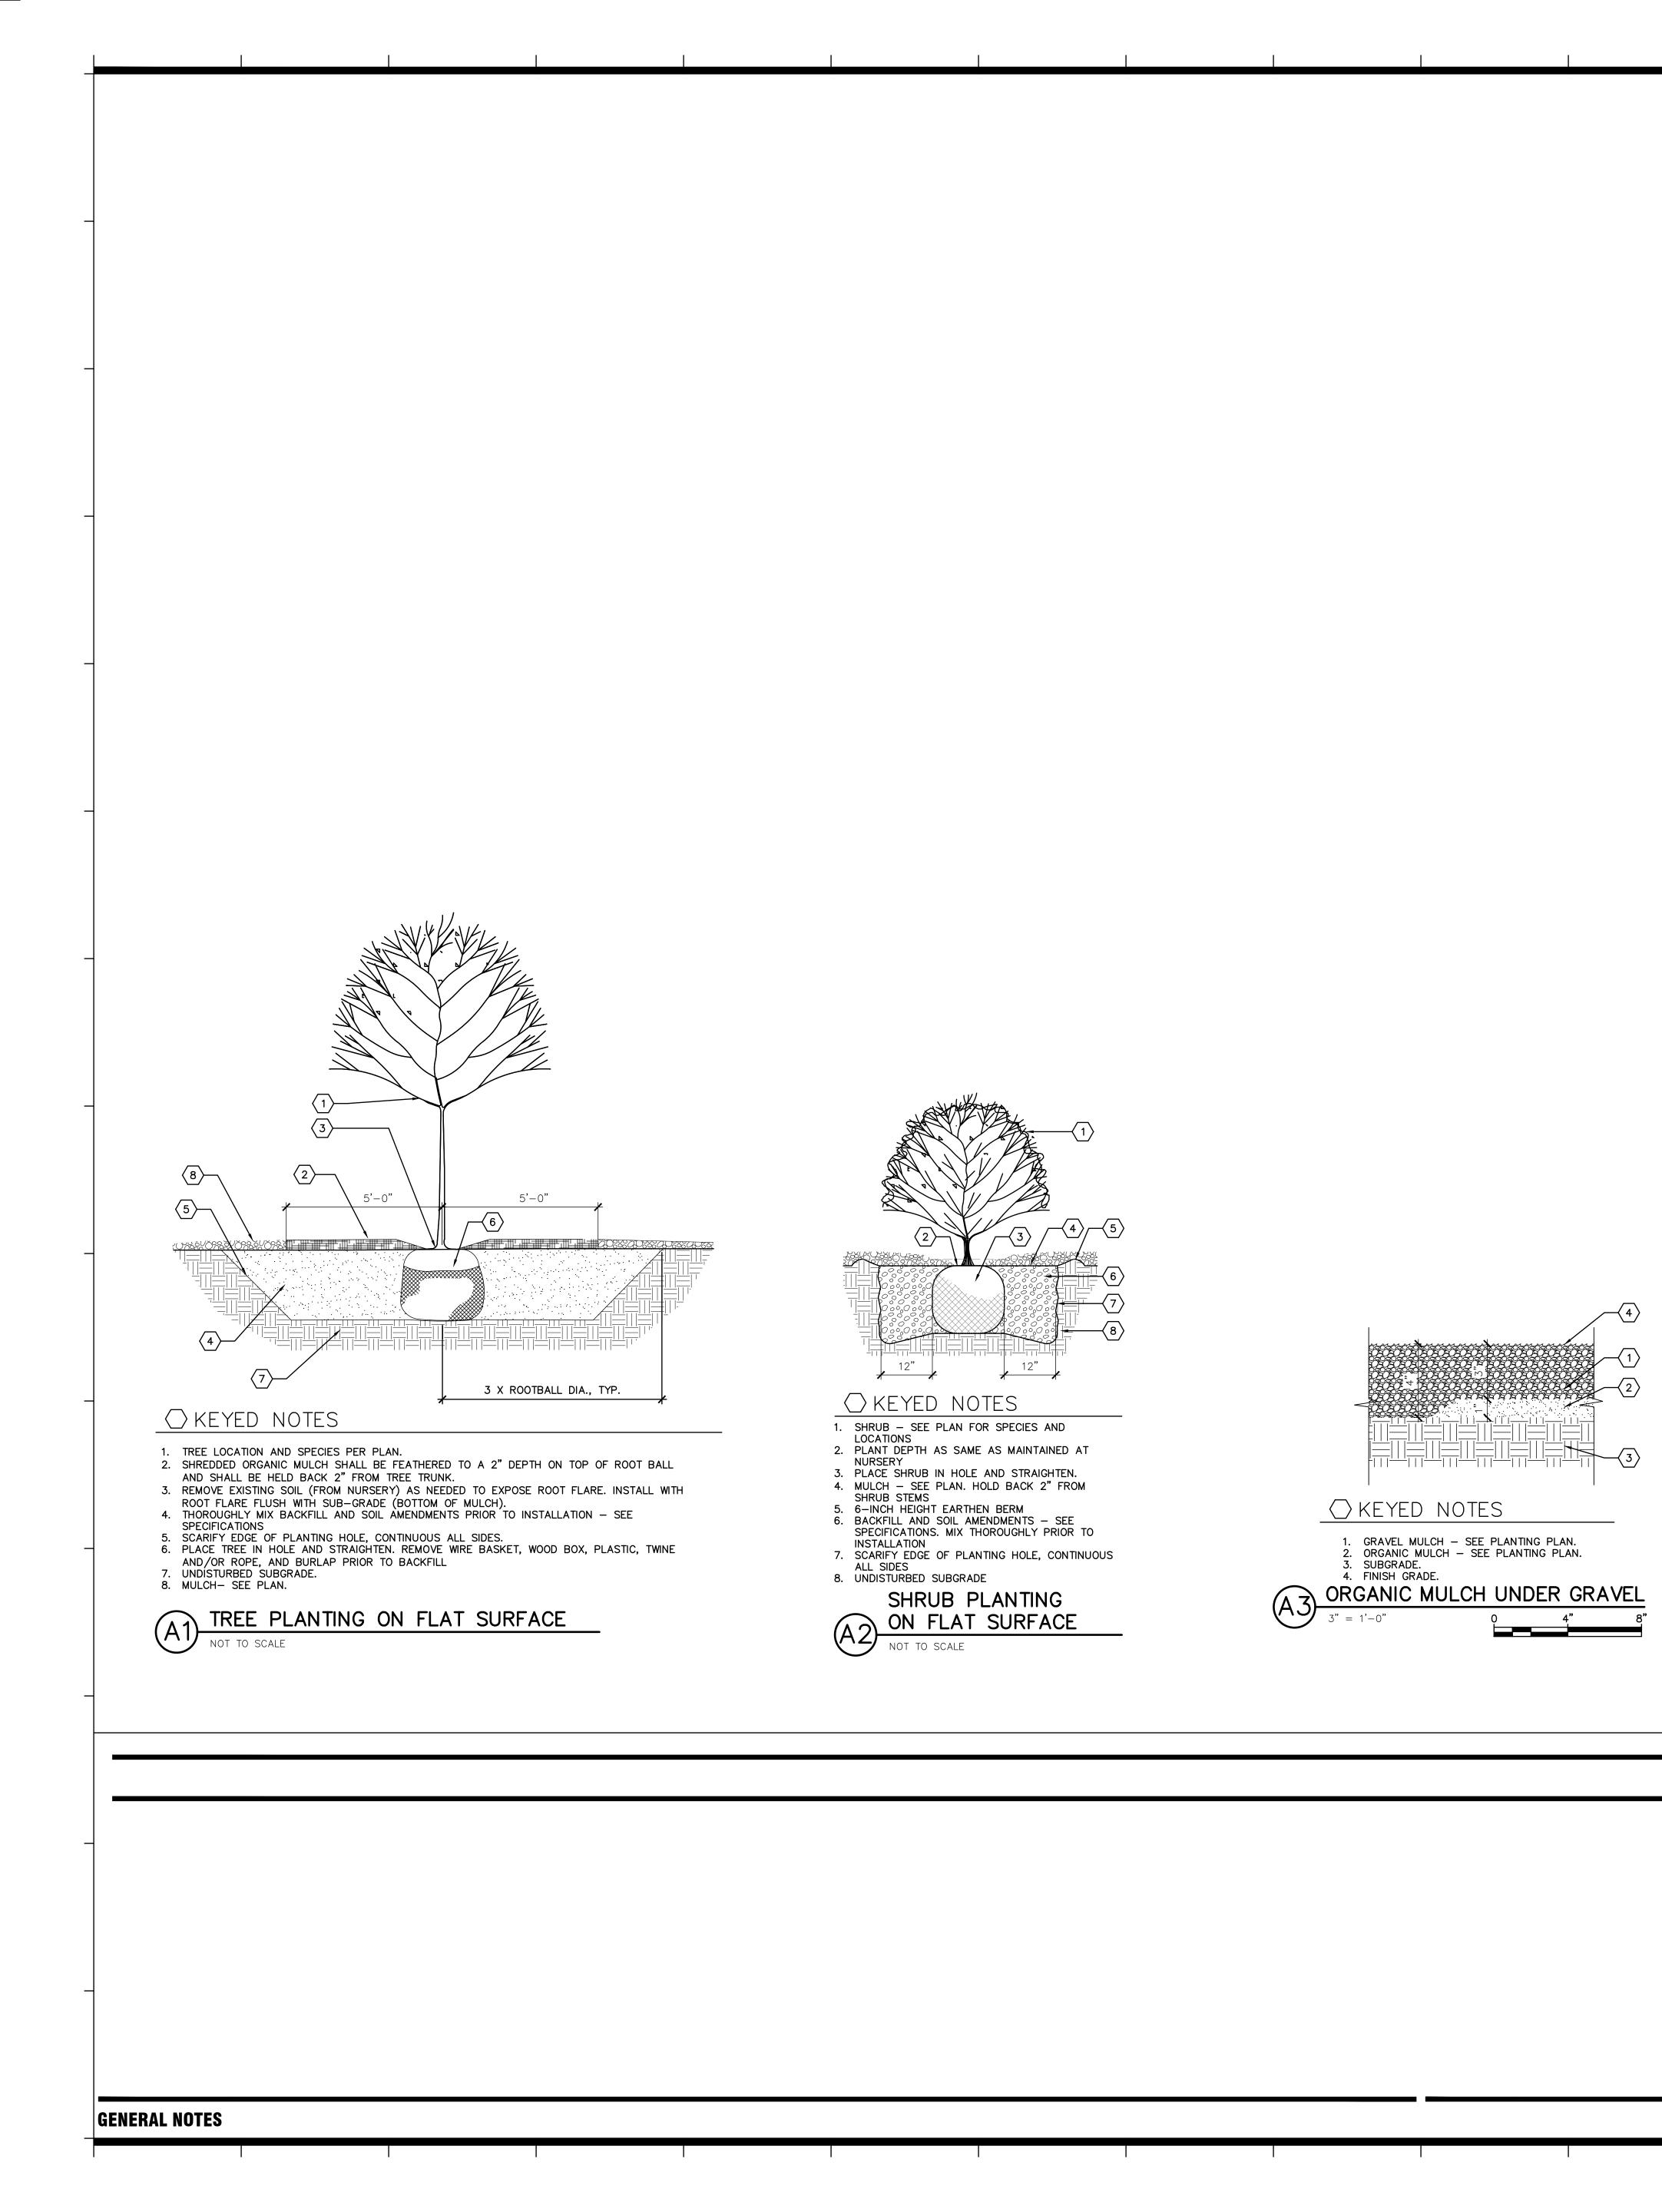




OFFICEUNTITLED ARCHITECT 4200 SEPULVEDA BLVD, STE 104, CULVER CITY, CA 90230 P.310.730.6698

## SAWMILL (LOT A)


1904 BELLAMAH AVE NW, ALBUQUERQUE, NM 87104

# REVISION DESCRIPTION	DATE
Seal	
icense Name: Christian Robert Profession Name: OFFICEUNTITLED, INC.	
icensee Number: 448	
SCALE: As indicated	NORTH
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<b>'</b> 10' 20' 40'	$\bigcirc$
PLANTING	
DETAILS	
	•
LP5	()1
CODY	RIGHT © 2020 OFFICEUNTITLED

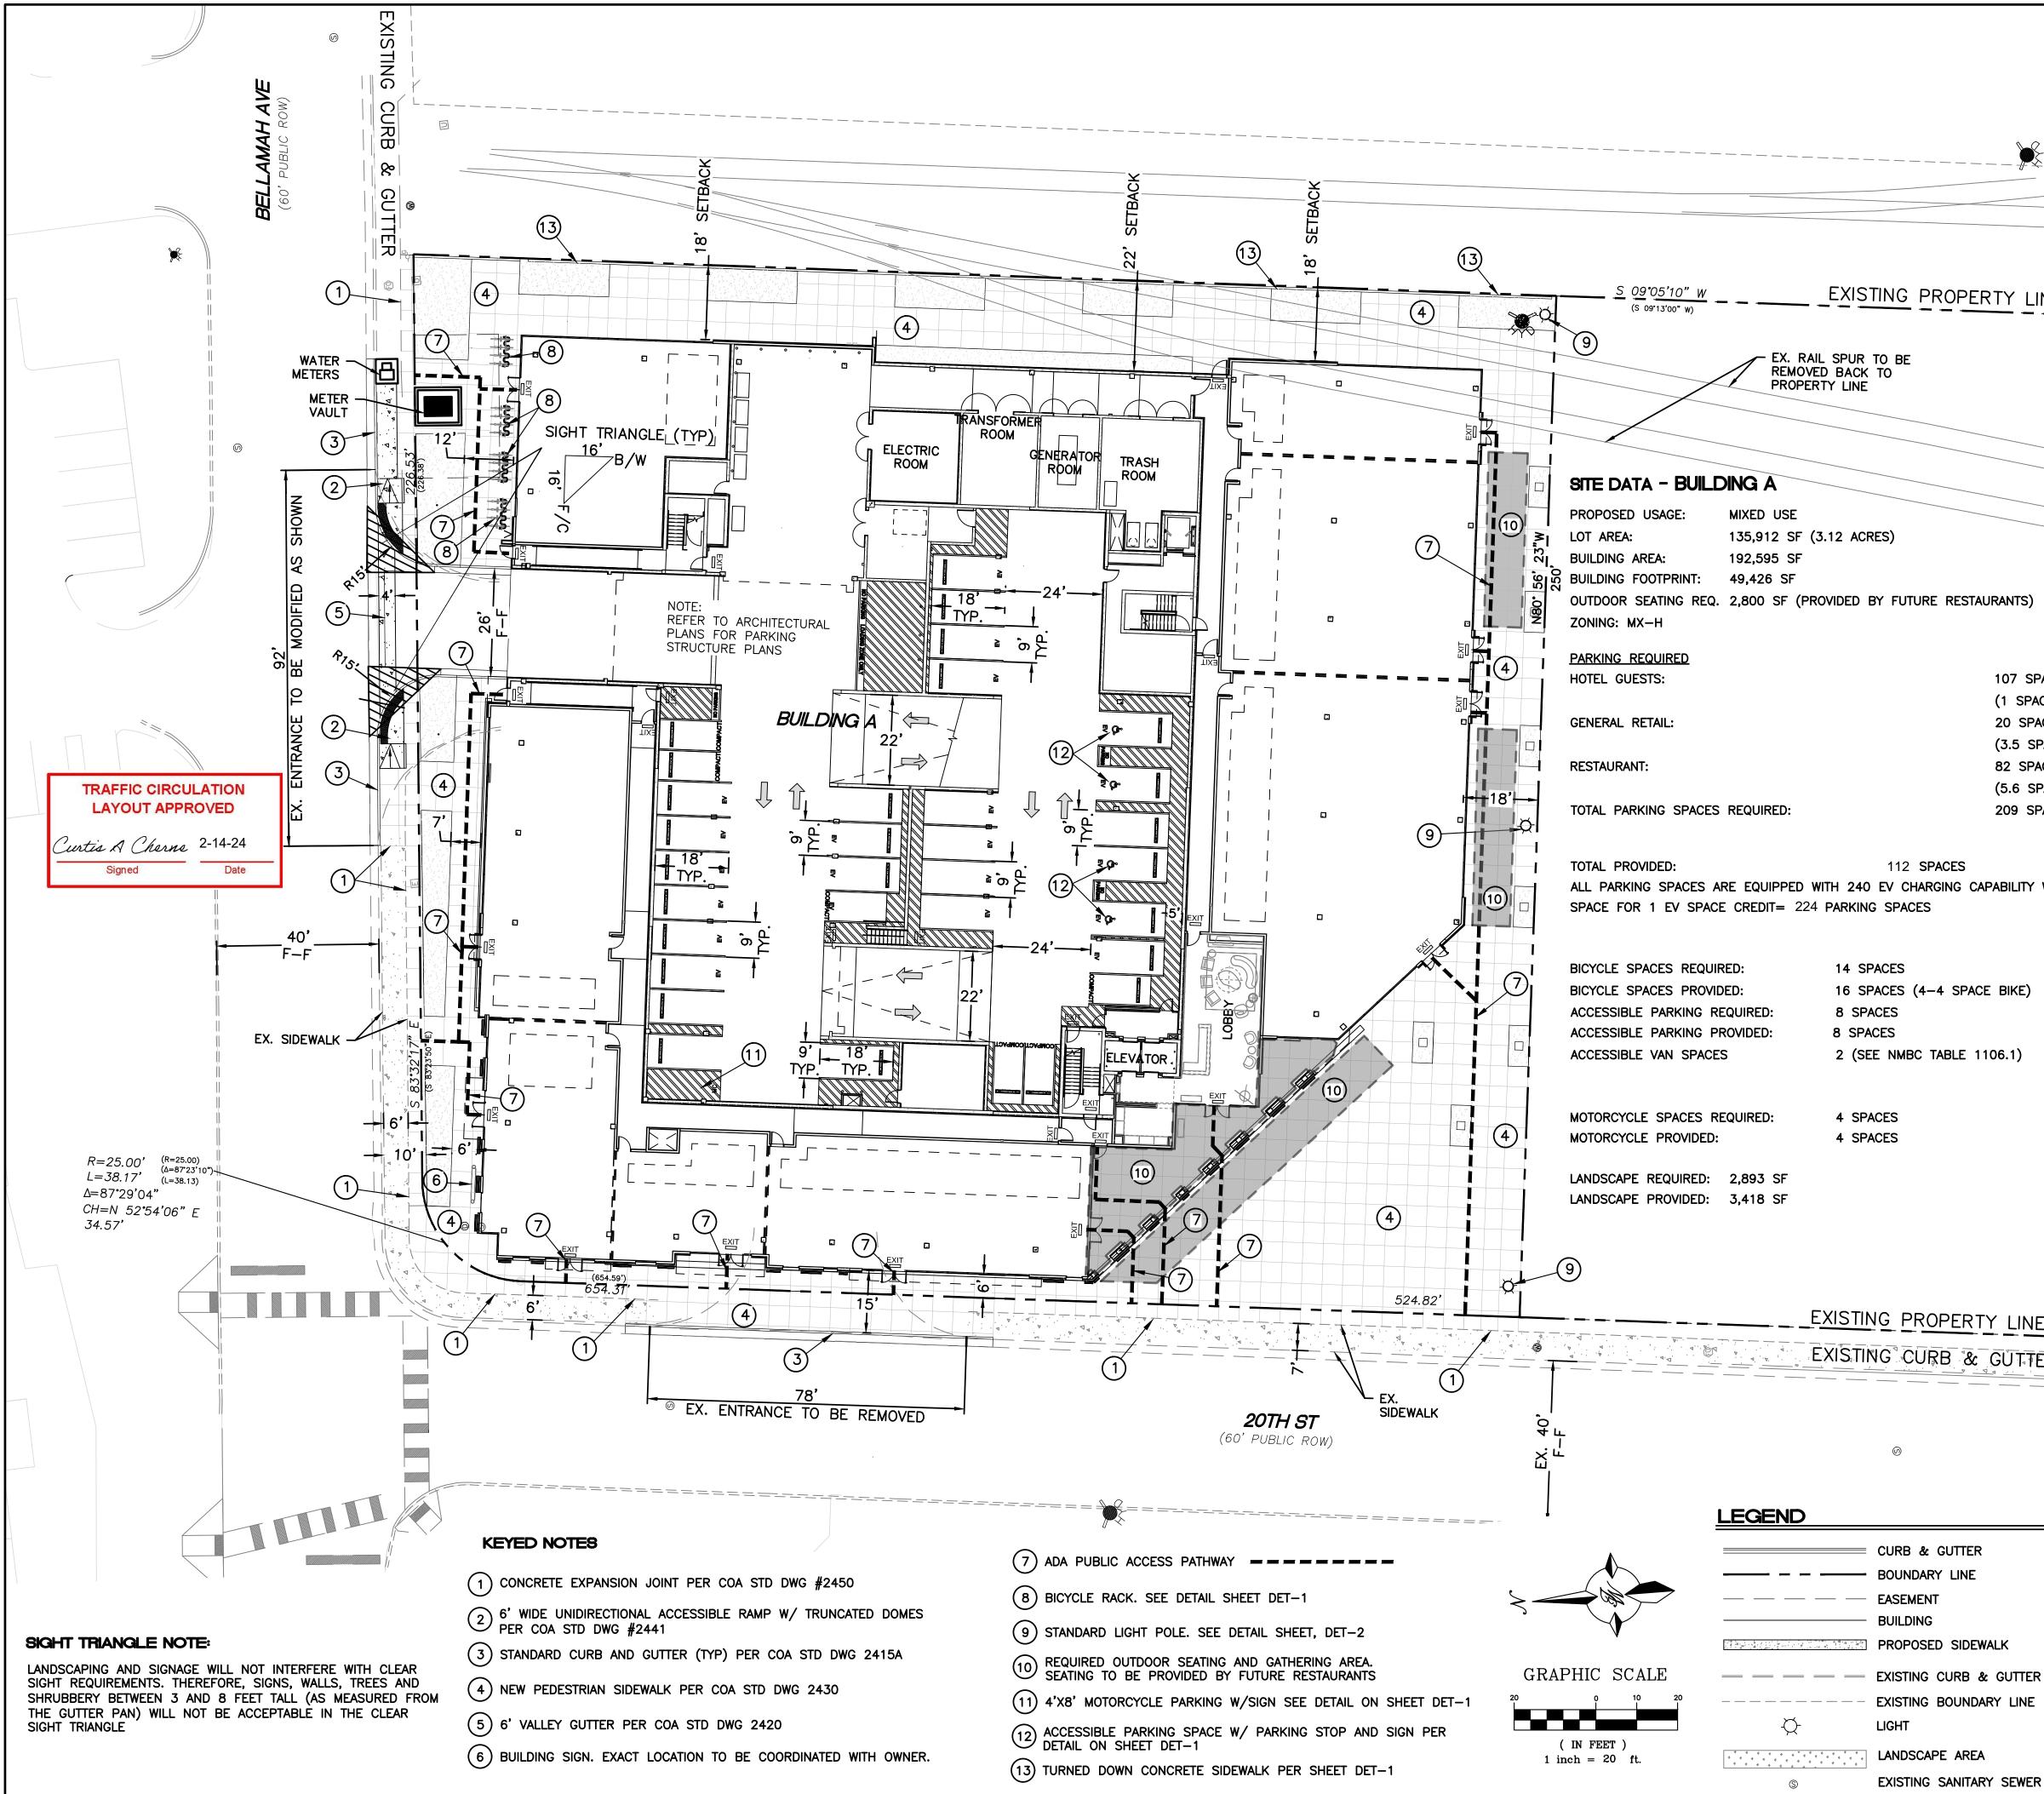

ERTY LINE	Image: State Stat	A A HALLEN R. 1
	VICINITY MAP J-13Z	
	LEGAL DESCRIPTION: TRACTS A LANDS OF STEWART WALKER & TRACT 238C1A2A2 M.R.G.C.D. MAP NO. 38	2
	NOTES: 1. APPROVAL OF THIS PLAN DOES NOT CONSTITUTE OR IMPL EXEMPTION FROM WATER WASTE PROVISIONS OF THE WATER CONSERVATION LANDSCAPING AND WATER WASTE ORDINANCE WASTE MANAGEMENT IS THE SOLE RESPONSIBILITY OF THE P	WATER
TAURANTS)	OWNER. 2. LANDSCAPE MAINTENANCE SHALL BE THE RESPONSIBILITY OWNER.	OF THE
107 SPACES (1 SPACE/UNITX107UI 20 SPACES	FIXTURES SHALL BE FULLY SHIELDED WITH HORIZONTAL L	um of 20' Fugitive Light Amps. Dr
(3.5 SPACES/GFAX5,4 82 SPACES	SCREENED FROM VIEW. ALL GROUND MOUNTED EQUIPMENT SCREENED BY SCREEN WALLS WITH TOP OF EQUIPMENT B	
	SCREENED FROM VIEW. ALL GROUND MOUNTED EQUIPMENT SCREENED BY SCREEN WALLS WITH TOP OF EQUIPMENT B	ELOW TOP
82 SPACES (5.6 SPACES/GFAX14, 209 SPACES	SCREENED FROM VIEW. ALL GROUND MOUNTED EQUIPMENT SCREENED BY SCREEN WALLS WITH TOP OF EQUIPMENT B 0F SCREEN WALL. 5. ALL IMPROVEMENTS WITHIN THE CITY RIGHT OF WAY M INCLUDED ON THE WORK ORDER. 6. ALL BROKEN OR CRACKED SIDEWALK MUST BE REPLAC SIDEWALK CURB & GUTTER PER CITY STANDARD DRAWING	ELOW TOP UST BE ED WITH
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82 SPACES (5.6 SPACES/GFAX14, 209 SPACES	SCREENED FROM VIEW. ALL GROUND MOUNTED EQUIPMENT SCREENED BY SCREEN WALLS WITH TOP OF EQUIPMENT B 465 GFA) OF SCREEN WALL. 5. ALL IMPROVEMENTS WITHIN THE CITY RIGHT OF WAY M INCLUDED ON THE WORK ORDER. 6. ALL BROKEN OR CRACKED SIDEWALK MUST BE REPLAC SIDEWALK CURB & GUTTER PER CITY STANDARD DRAWING ES A 2 2430. PROJECT NUMBER: <u>PR-2022-007153</u> APPLICATION NUMBER:	ELOW TOP UST BE ED WITH S 2415A &
82 SPACES (5.6 SPACES/GFAX14, 209 SPACES CAPABILITY WHICH PROVID	SCREENED FROM VIEW. ALL GROUND MOUNTED EQUIPMENT SCREENED BY SCREEN WALLS WITH TOP OF EQUIPMENT B 465 GFA) OF SCREEN WALL. 5. ALL IMPROVEMENTS WITHIN THE CITY RIGHT OF WAY M INCLUDED ON THE WORK ORDER. 6. ALL BROKEN OR CRACKED SIDEWALK MUST BE REPLAC SIDEWALK CURB & GUTTER PER CITY STANDARD DRAWING ES A 2 2430.	ELOW TOP UST BE ED WITH S 2415A &
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EXISTING SANITARY SEWER MAN HOLE

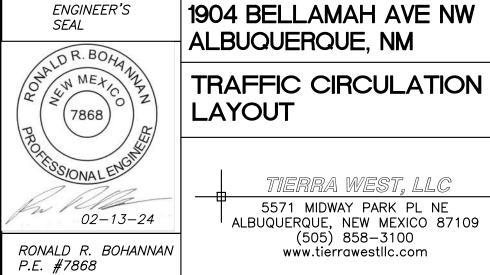


TIERRA WEST, LLC 5571 MIDWAY PARK PL NE ALBUQUERQUE, NEW MEXICO 87109 (505) 858–3100 www.tiérrawestllc.com

DRAWN BY SB DATE 05-11-23 DRAWING


SHEET # SP-1

JOB #

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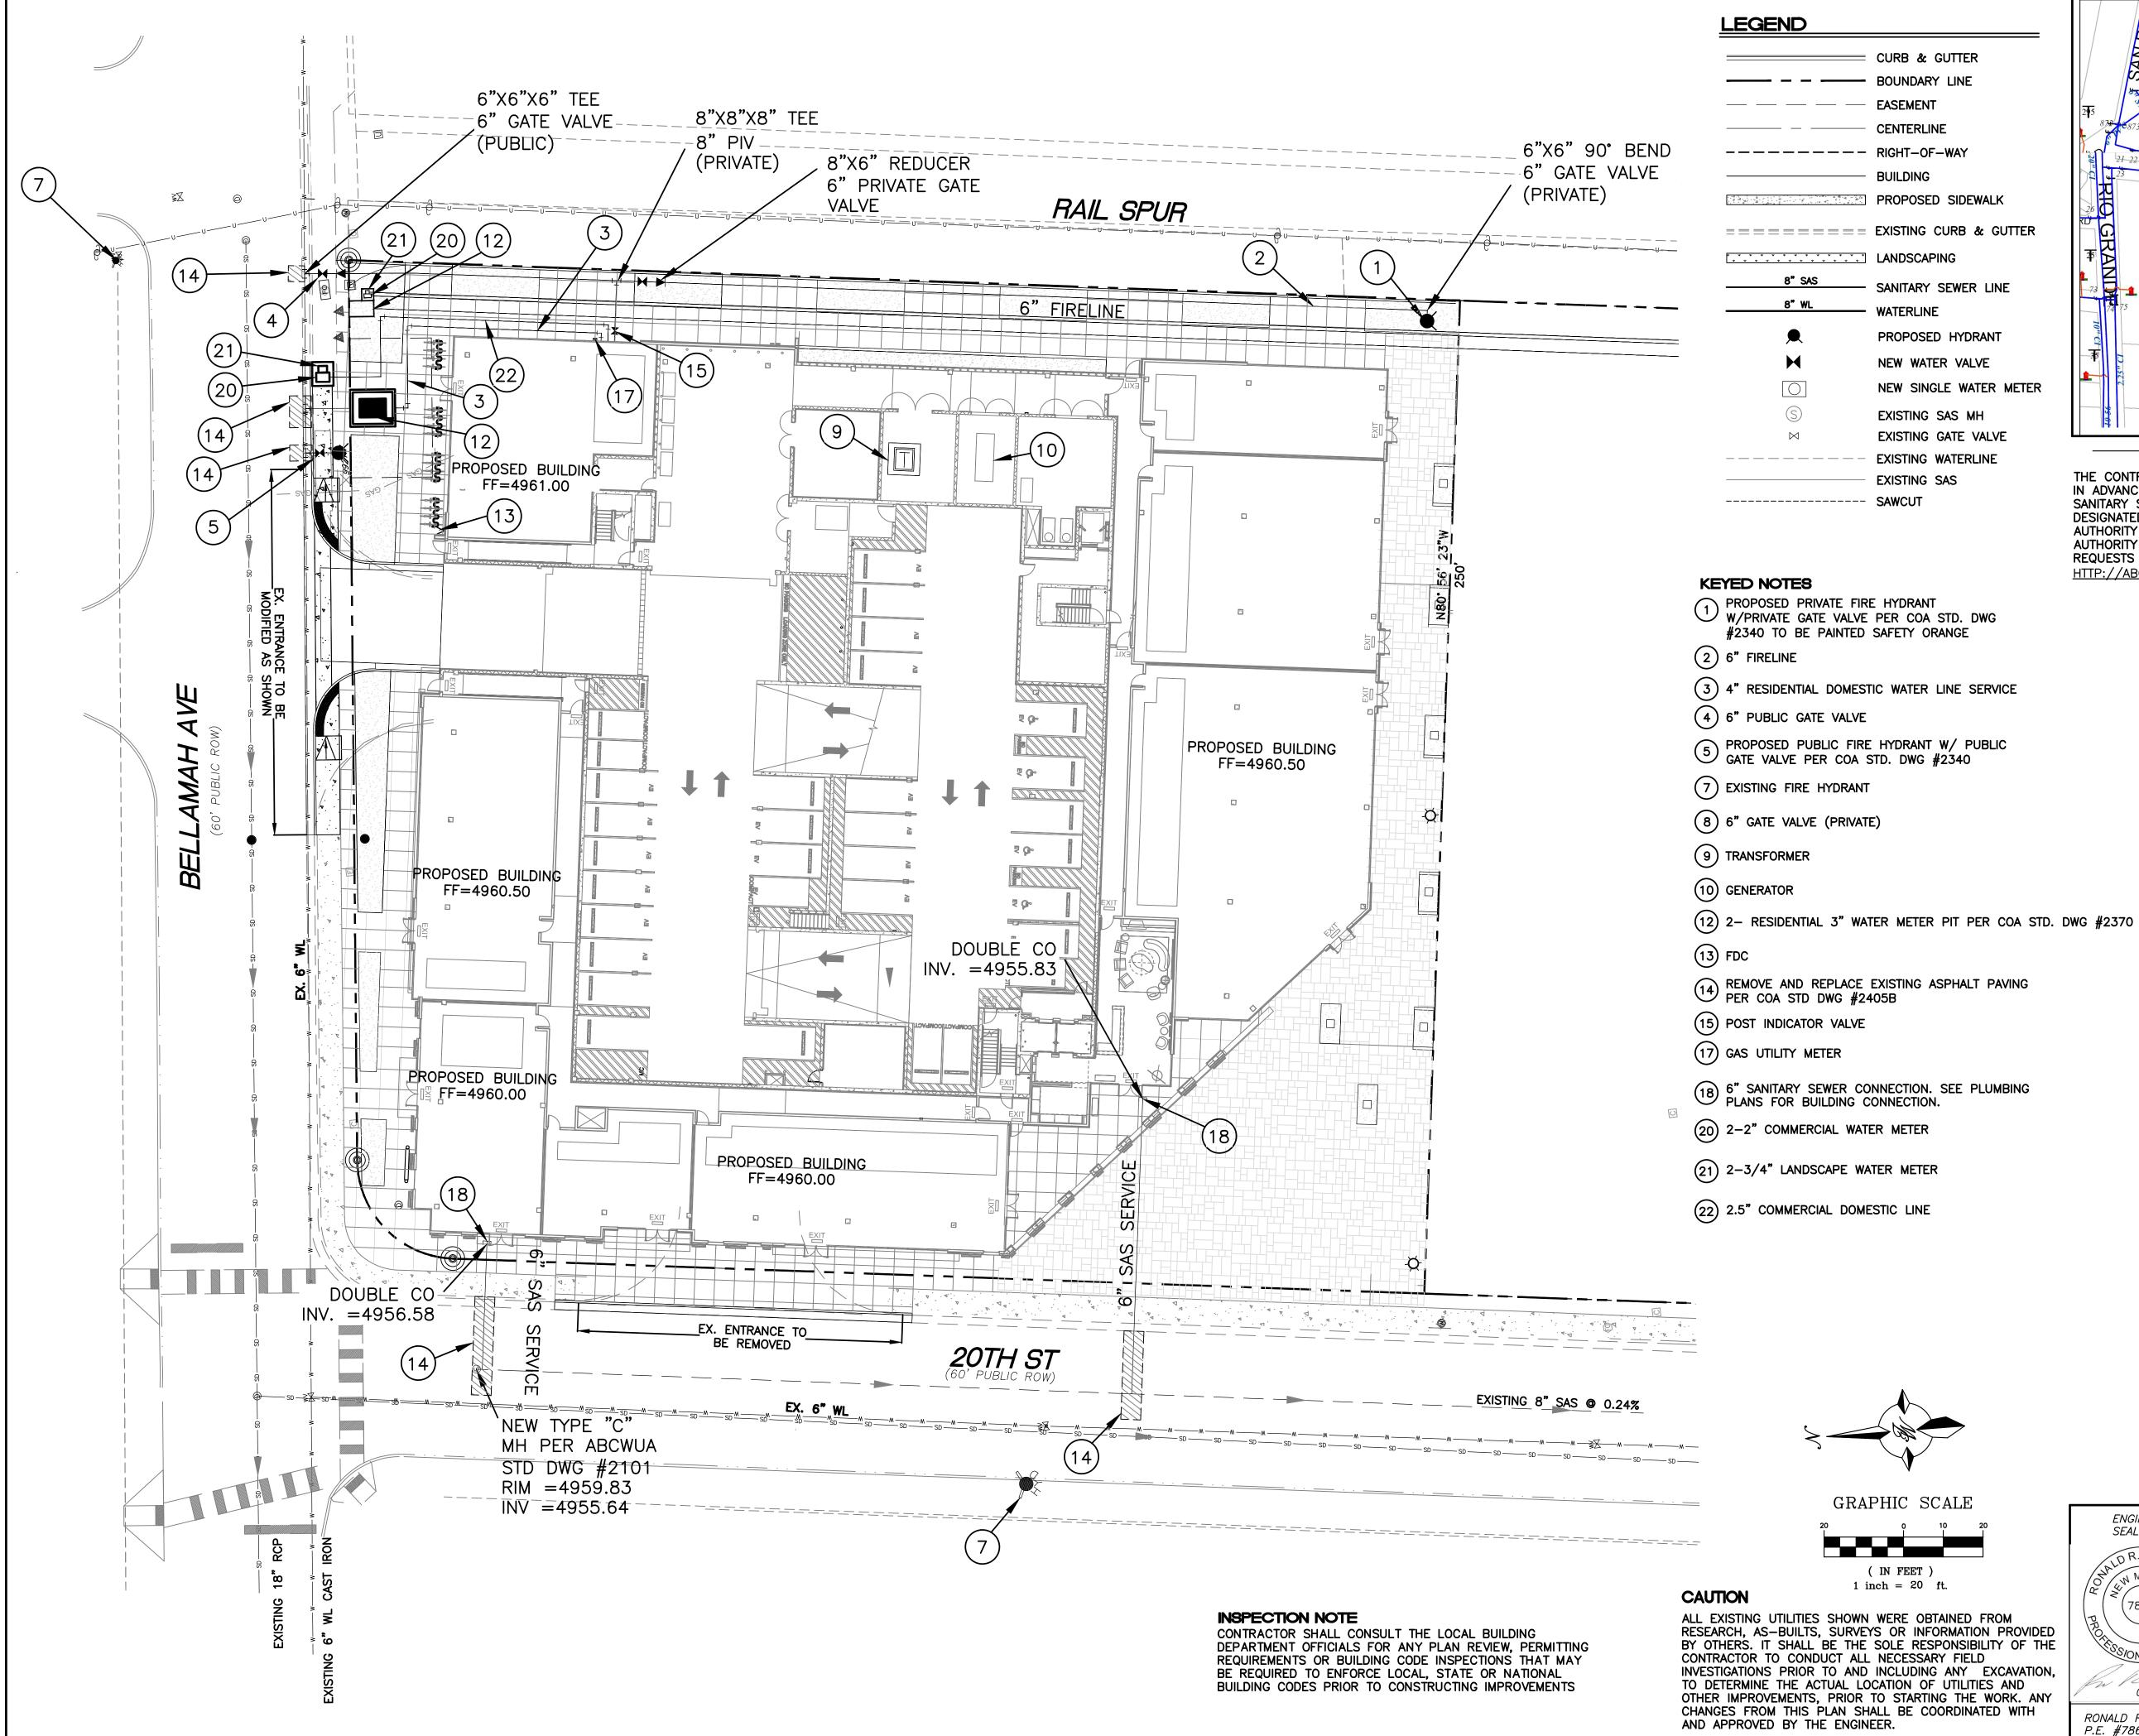
	ENGINEER'S SEAL	1904 BELLAMAH AVE NW ALBUQUERQUE, NM	<i>DRAWN BY</i> SB
	ALD R. BOAR		DATE
$\overline{}$	N METICO Z	GRADING	05-11-23
$\gamma$	$\begin{pmatrix} \mathcal{L} \\ \mathcal{L} $	PLAN	DRAWING
PHIC SCALE	PROFILESSIONALENGINE		SHEET #
0 10 20	ONALL	TIERRA WEST, LLC	GR-1
	01-15-2024	T 5571 MIDWAY PARK PL NE ALBUQUERQUE, NEW MEXICO 87109	
( IN FEET $)inch = 20 ft.$	RONALD R. BOHANNAN P.E. #7868	(505) 858—3100 www.tierrawestllc.com	<i>JOB                                    </i>

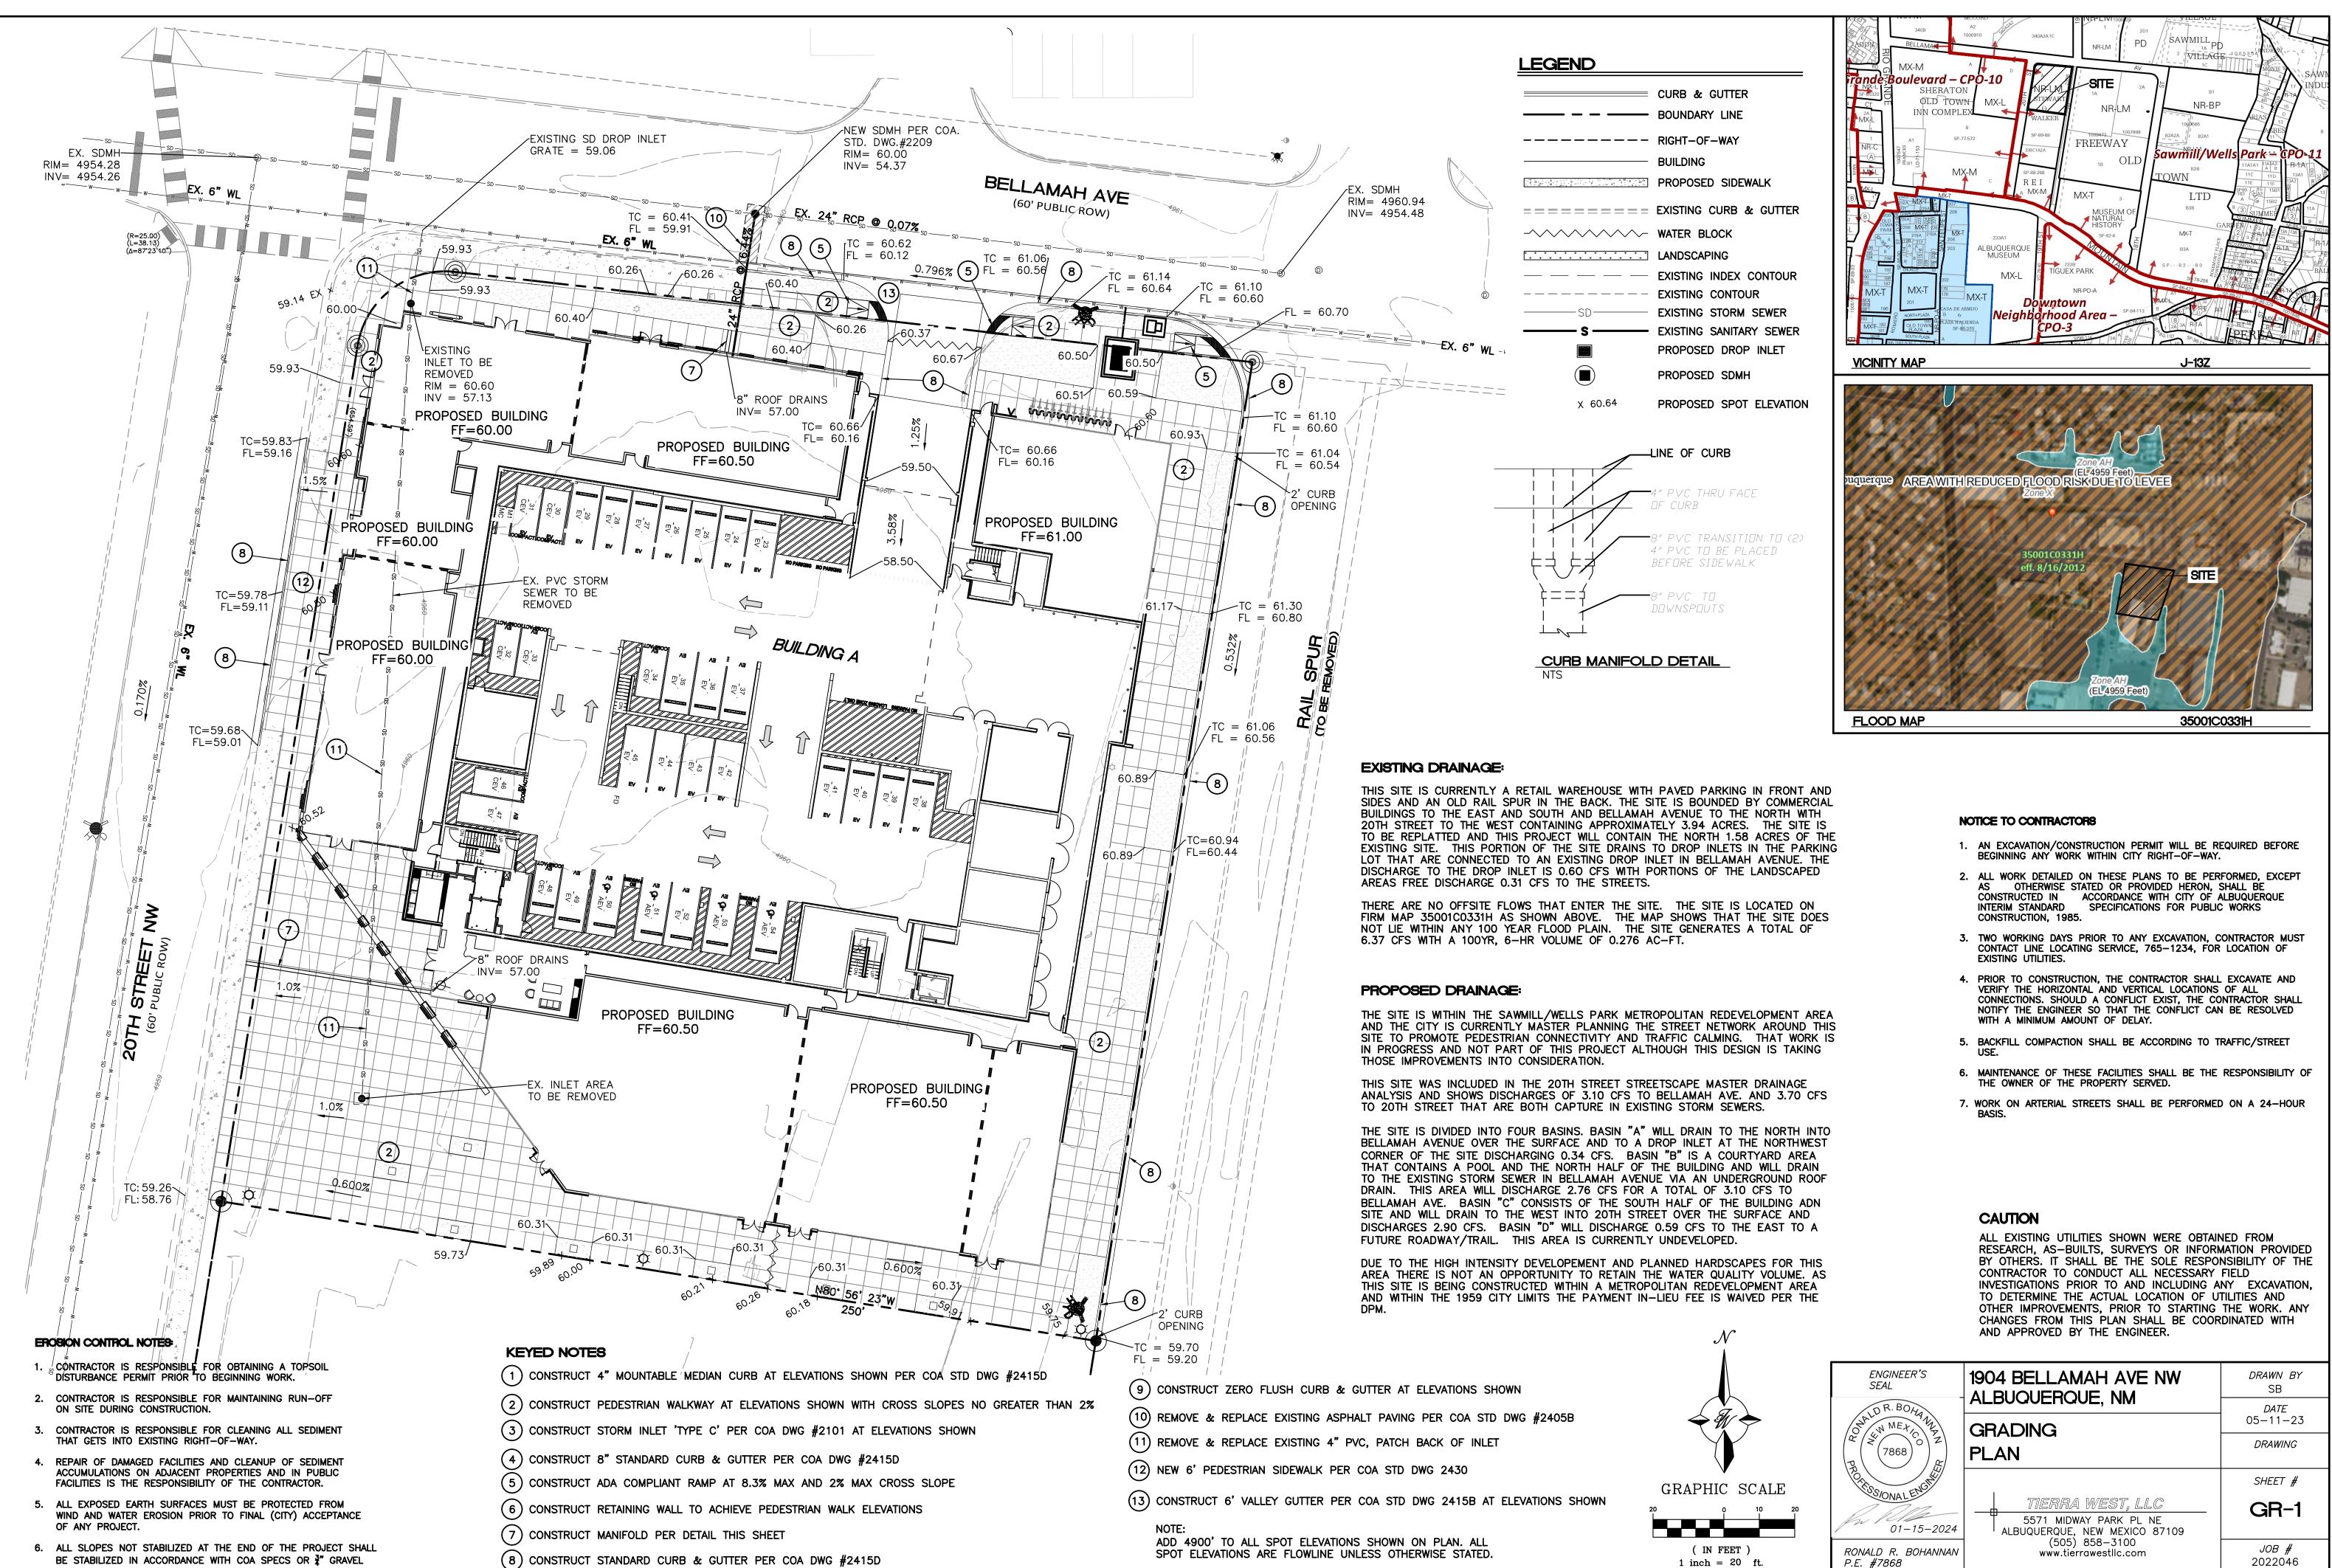

Basins Area (sf)	Area														
Area	Area														
	Area										100-Year			10-Year	
		Trea	tment A	Trea	tment B	Treat	nent C	Treat	ment D	Weighted E	Volume	Flow	Weighted E	Volume	Flow
	(acres)	%	(acres)	%	(acres)	%	(acres)	%	(acres)	(in)	(ac-ft)	cfs	(in)	(ac-ft)	cfs
68,658	1.58	0%	0	15%	0.24	0%	0.00	85%	1.34	2.101	0.276	6.37	1.329	0.174	3.86
5,639	0.13	0%	0	100%	0.13	0%	0.00	0%	0.00	0.800	0.009	0.31	0.300	0.003	0.12
											0.276	6.37			
d Basins															
											100-Year			10-Year	
Area	Area	Trea	tment A	Trea	tment B	Treat	ment C		ment D	Weighted E	Volume	Flow	Weighted E	Volume	Flow
(sf)	(acres)	%	(acres)	%	(acres)	%	(acres)	%	(acres)	(in)	(ac-ft)	cfs	(in)	(ac-ft)	cfs
4,246	0.10	0%	0	41%	0.04	0%	0.00	59%	0.06	1.703	0.014	0.34	1.014	0.008	0.19
27,782	0.64	0%	0	1%	0.01	0%	0.00	99%	0.63	2.315	0.123	2.76	1.498	0.080	1.72
			0												1.35
,			0												0.49
6,447	0.15	0%	0	17%	0.03	0%	0.00	83%		2.070	0.026		1.304	0.016	0.36
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E = Ea*Aa +	Eb*Ab + E	c*Ac + E	d*Ad / (Tota	al Area)											
					Ea	0.62	0.15		Qa	1.71	0.41				
Weighted D	* Total Area	ľ			Eb	0.8	0.3		Qb	2.36	0.95				
					Ec	1.03	0.48		Q <sub>c</sub>	3.05	1.59				
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ality Calcula	ation: 0.26	" x 1 49	ac = 1.406	cubic fe	et (0.032 ac.	-ff)									
unty Juliun		A 1170	uo 1, <b>100</b>												
	5,639 <i>d Basins</i> Area (sf) 4,246 27,782 21,788 8,054 6,447 S: E = Ea*Aa + Weighted D a * Aa + Qb *	5,639       0.13         od Basins	5,639       0.13       0%         od Basins	5,639       0.13       0%       0         ad Basins	5,639       0.13       0%       0       100%         d Basins	5,639       0.13       0%       0       100%       0.13         d Basins       Area       Treatment A       Treatment B         (sf)       (acres)       %       (acres)       %       (acres)         4,246       0.10       0%       0       41%       0.04         27,782       0.64       0%       0       1%       0.01         21,788       0.50       0%       0       1%       0.01         3,054       0.18       0%       0       2%       0.00         6,447       0.15       0%       0       17%       0.03         s:       E       E       Ea       E       <	5,639       0.13       0%       0       100%       0.13       0%         d Basins <t< td=""><td>5,639       0.13       0%       0       100%       0.13       0%       0.00         d Basins       Area       Treatment A       Treatment B       Treatment C       (acres)       %       0.00       0.00       0.00       0.00       0.00       0.00       %       0.00       0.00       %       0.00       0.00       %       0.00       0.00       %       0.00       %       0.00</td><td>5,639       0.13       0%       0       100%       0.13       0%       0.00       0%         d Basins       Area       Area       Treatment A       Treatment B       Treatment C       Treatment C         Area       Area       Mea       Mea</td><td>5,639       0.13       0%       0       100%       0.13       0%       0.00       0%       0.00         d Basins      </td><td>5,639       0.13       0%       0       100%       0.13       0%       0.00       0%       0.00       0.800         d Basins      </td><td>5,639       0.13       0%       0       100%       0.13       0%       0.00       0%       0.00       0.800       0.009         d Basins             0%       0.00       0%       0.00       0.800       0.009         d Basins              0.276         d Basins              0.276         d Basins              0.276         d Basins               0.276         d Gares)       %       (acres)       (acres)       (acres)</td><td>5,639       0.13       0%       0       100%       0.13       0%       0.00       0.800       0.009       0.31         d Basins       0       0.13       0%       0.00       0%       0.00       0.800       0.009       0.31         d Basins       0       100%       0.13       0%       0.00       0%       0.00       0.800       0.009       0.31         Area       Treatment A       Treatment B       Treatment C       Treatment C       Treatment M       (acres)       %       (acres)<!--</td--><td>5,639       0.13       0%       0       100%       0.13       0%       0.00       0.00       0.000       0.009       0.31       0.300         d Basins       Image: constraint of the second sec</td><td>5,639         0.13         0%         0         100%         0.13         0%         0.00         0%         0.00         0.800         0.009         0.31         0.300         0.003           d Basins         Image: Constraint of the stress of the str</td></td></t<>	5,639       0.13       0%       0       100%       0.13       0%       0.00         d Basins       Area       Treatment A       Treatment B       Treatment C       (acres)       %       0.00       0.00       0.00       0.00       0.00       0.00       %       0.00       0.00       %       0.00       0.00       %       0.00       0.00       %       0.00       %       0.00	5,639       0.13       0%       0       100%       0.13       0%       0.00       0%         d Basins       Area       Area       Treatment A       Treatment B       Treatment C       Treatment C         Area       Area       Mea       Mea	5,639       0.13       0%       0       100%       0.13       0%       0.00       0%       0.00         d Basins	5,639       0.13       0%       0       100%       0.13       0%       0.00       0%       0.00       0.800         d Basins	5,639       0.13       0%       0       100%       0.13       0%       0.00       0%       0.00       0.800       0.009         d Basins             0%       0.00       0%       0.00       0.800       0.009         d Basins              0.276         d Basins              0.276         d Basins              0.276         d Basins               0.276         d Gares)       %       (acres)       (acres)       (acres)	5,639       0.13       0%       0       100%       0.13       0%       0.00       0.800       0.009       0.31         d Basins       0       0.13       0%       0.00       0%       0.00       0.800       0.009       0.31         d Basins       0       100%       0.13       0%       0.00       0%       0.00       0.800       0.009       0.31         Area       Treatment A       Treatment B       Treatment C       Treatment C       Treatment M       (acres)       %       (acres) </td <td>5,639       0.13       0%       0       100%       0.13       0%       0.00       0.00       0.000       0.009       0.31       0.300         d Basins       Image: constraint of the second sec</td> <td>5,639         0.13         0%         0         100%         0.13         0%         0.00         0%         0.00         0.800         0.009         0.31         0.300         0.003           d Basins         Image: Constraint of the stress of the str</td>	5,639       0.13       0%       0       100%       0.13       0%       0.00       0.00       0.000       0.009       0.31       0.300         d Basins       Image: constraint of the second sec	5,639         0.13         0%         0         100%         0.13         0%         0.00         0%         0.00         0.800         0.009         0.31         0.300         0.003           d Basins         Image: Constraint of the stress of the str

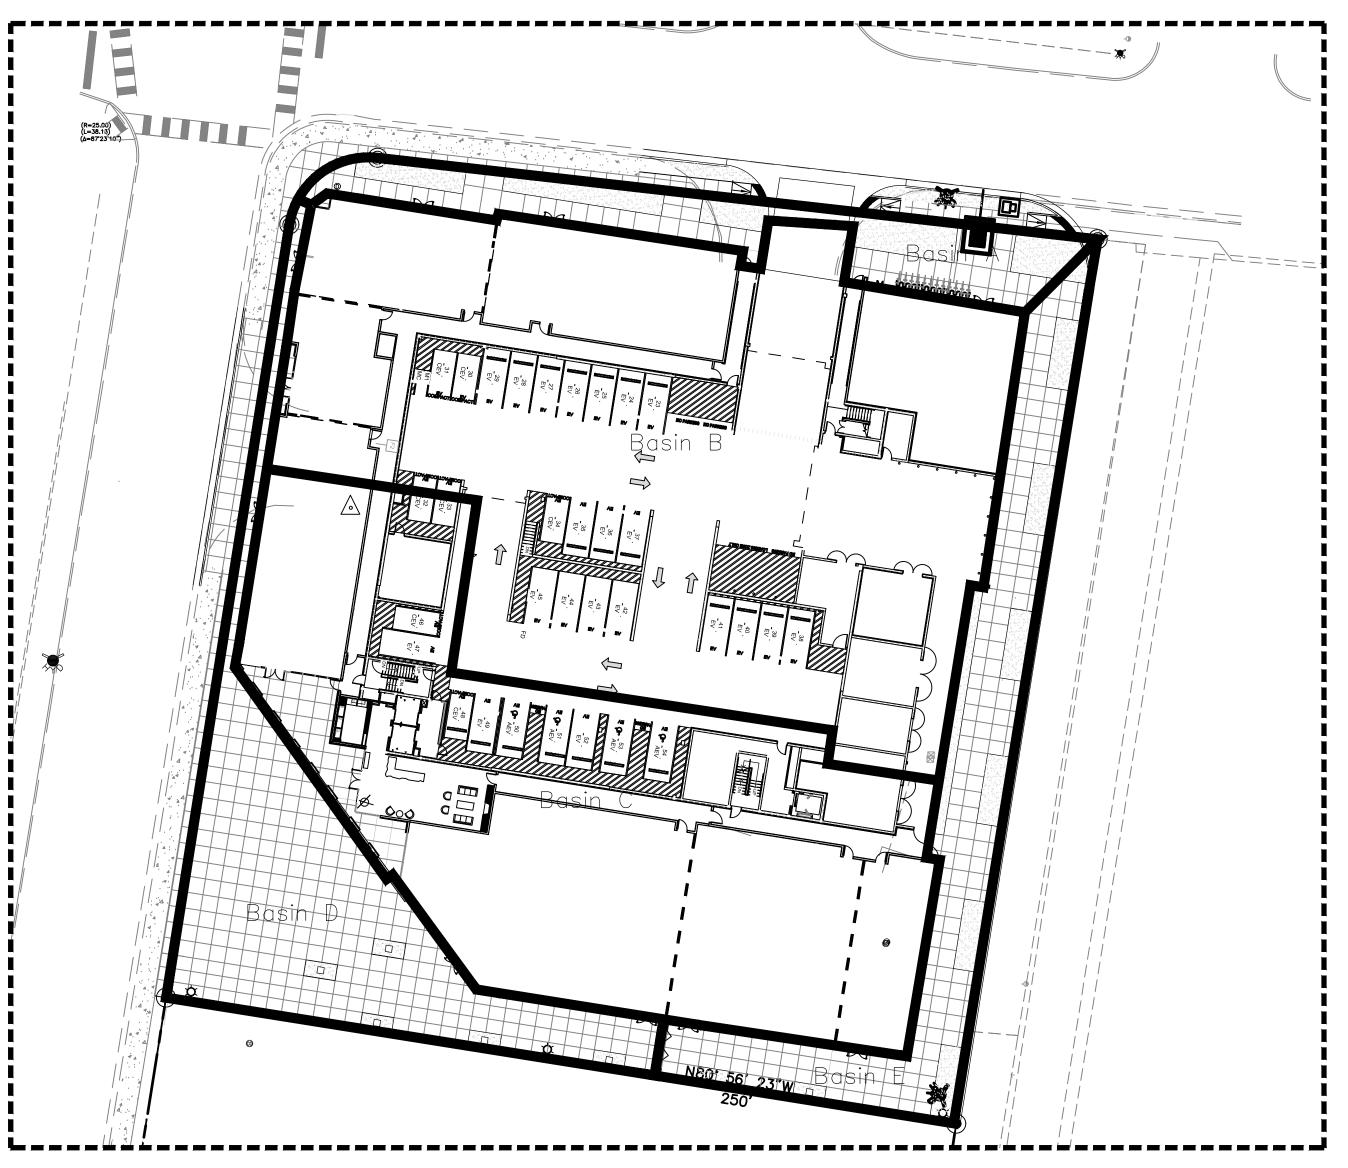
PROPOSED BASINS

ENGINEER'S SEAL	1904 BELLAMAH AVE NW ALBUQUERQUE, NM	<i>DRAWN BY</i> SB
LD R. BOHA		DATE
ONALD R. BOHY	BASIN MAP	05-11-23
		DRAWING
PR LI		
PROFILESSIONAL ENGINE		SHEET #
SIONALEL		GR-2
01-15-2024	T 5571 MIDWAY PARK PL NE ALBUQUERQUE, NEW MEXICO 87109	
RONALD R. BOHANNAN	(505) 858-3100 www.tierrawestllc.com	JOB #
P.E. #7868		2022046



ALL EXISTING UTILITIES SHOWN WERE OBTAINED FROM RESEARCH, AS-BUILTS, SURVEYS OR INFORMATION PROVIDED BY OTHERS. IT SHALL BE THE SOLE RESPONSIBILITY OF THE CONTRACTOR TO CONDUCT ALL NECESSARY FIELD INVESTIGATIONS PRIOR TO AND INCLUDING ANY EXCAVATION, TO DETERMINE THE ACTUAL LOCATION OF UTILITIES AND OTHER IMPROVEMENTS, PRIOR TO STARTING THE WORK. ANY CHANGES FROM THIS PLAN SHALL BE COORDINATED WITH

- PROPOSED HYDRANT
- NEW WATER VALVE
- NEW SINGLE WATER METER
- EXISTING SAS MH EXISTING GATE VALVE EXISTING WATERLINE

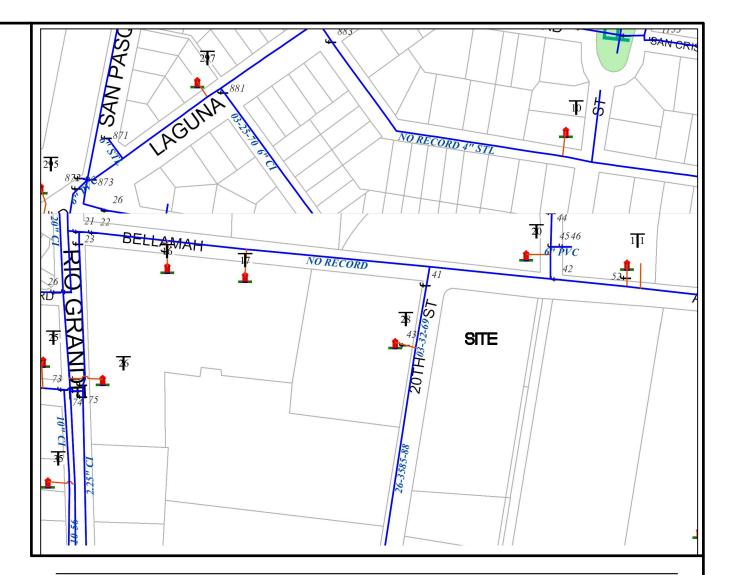


THE CONTRACTOR SHALL COORDINATE WITH THE WATER AUTHORITY SEVEN (7) DAYS IN ADVANCE OF PERFORMING WORK THAT WILL AFFECT THE PUBLIC WATER OR SANITARY SEWER INFRASTRUCTURE. WORK REQUIRING SHUTOFF OF FACILITIES DESIGNATED AS MASTER PLAN FACILITIES MUST BE COORDINATED WITH THE WATER AUTHORITY 14 DAYS IN ADVANCE OF PERFORMING SUCH WORK. ONLY WATER AUTHORITY CREWS ARE AUTHORIZED TO OPERATE PUBLIC VALVES. SHUTOFF REQUESTS MUST BE MADE ONLINE AT HTTP://ABCWUA.ORG/CONTENT/VIEW/463/729/

### **GENERAL UTILITY NOTES:**

- 1. ALL WATER AND SEWER UTILITY WORK TO BE DONE IN ACCORDANCE WITH COA STANDARDS AND SPECIFICATIONS LATEST EDITION.
- 2. 4' MINIMUM BURY REQUIRED FOR ALL UTILITIES UNLESS OTHERWISE NOTED.
- 3. REFERENCE ARCHITECTURAL PLANS FOR WATER LINE RISER LOCATIONS.
- 4. CLEAN OUTS ARE TO BE BUILT PER UNIFORM PLUMBING CODE STANDARDS.
- 5. ALL PLUMBING PIPE MATERIAL TO BE USED PER UPC.
- 6. FIRE LINE AND DOMESTIC WATERLINE MUST HAVE BACKFLOW PREVENTORS PER UPC. IF BACKFLOW PREVENTOR IS INSTALLED EXTERIOR OF BUILDING A HOT BOX SHALL BE INSTALLED AND USED.
- 7. ALL EX. SD INLETS AND MH SHALL HAVE CONCRETE COLLARS POURED AND BE ADJUSTED TO FINISHED GRADE.
- 8. ALL EXCAVATION, TRENCHING AND SHORING ACTIVITIES MUST BE CARRIED-OUT IN ACCORDANCE WITH OSHA 29 CFR 1926.650 SUBPART P.
- 9. ALL UTILITY DISTANCES SHOWN ARE FOR REFERENCE ONLY.
- 10. PNM HAS NUMEROUS ELECTRIC FACILITIES AT THIS SITE CURRENTLY SERVING EXISTING CUSTOMERS. THE APPLICANT SHALL COORDINATE WITH PNM REGARDING THESE EXISTING FACILITIES. ANY RELOCATION, CHANGES OR REALIGNMENT OF EXISTING ELECTRIC UTILITIES WILL BE THE DEVELOPER EXPENSE. IN SOME CASES, RELOCATION OR CHANGES TO EXISTING FACILITIES MAY NOT BE FEASIBLE DUE TO PHYSICAL, USE OR SAFETY CLEARANCE CONSTRAINTS.
- 11. PNM WILL REVIEW ALL TECHNICAL NEEDS, ISSUES AND SAFETY CLEARANCES FOR ITS ELECTRIC POWER SYSTEMS. ANY EXISTING AND PROPOSED PUBLIC UTILITY EASEMENTS SHALL BE INDICATED ON THE SITE PLAN UTILITY SHEET PRIOR TO DRB REVIEW. PNM'S STANDARD FOR PUBLIC UTILITY EASEMENTS IS 10 FEET IN WIDTH TO ENSURE ADEQUATE, SAFE CLEARANCES.
- 12. SCREENING SHALL BE DESIGNED TO ALLOW FOR ACCESS TO UTILITY FACILITIES. IT IS NECESSARY TO PROVIDE ADEQUATE CLEARANCE OF TEN FEET SURROUNDING ALL GROUND-MOUNTED UTILITIES FOR SAFE OPERATION, MAINTENANCE AND REPAIR PURPOSES.
- 13. COORDINATION WITH WATER AUTHORITY CROSS CONNECTION SECTION WILL BE REQUIRED TO ENSURE PROPER BACKFLOW CONTAINMENT IS IN PLACE PRIOR TO RELEASE OF METER FOR THE SITE. CONTACT THE CROSS CONNECTION SECTION AT 505-289-3454.
- 14. COORDINATION WITH THE WATER AUTHORITY PRE-TREATMENT ENGINEER IS REQUIRED TO ENSURE THE SITE COMPLIES WITH WATER AUTHORITY SEWER USE ORDINANCE. CONTACT THE PRE-TREATMENT ENGINEER AT 505-289-3439.


	ENGINEER'S SEAL	508 MURRAY RD NW ALBUQUERQUE, NM	<i>DRAWN BY</i> RMG
	NALD R. BOHAN	MASTER UTILITY	<i>DATE</i> 03–05–2024
		PLAN	DRAWING
) E	PROFILESSIONALENGIN		SHEET #
<b>,</b> ,	03-05-24	5571 MIDWAY PARK PL NE ALBUQUERQUE, NEW MEXICO 87109	MU-1
	RONALD R. BOHANNAN P.E. #7868	(505) 858-3100 www.tierrawestllc.com	<i>JOB                                    </i>

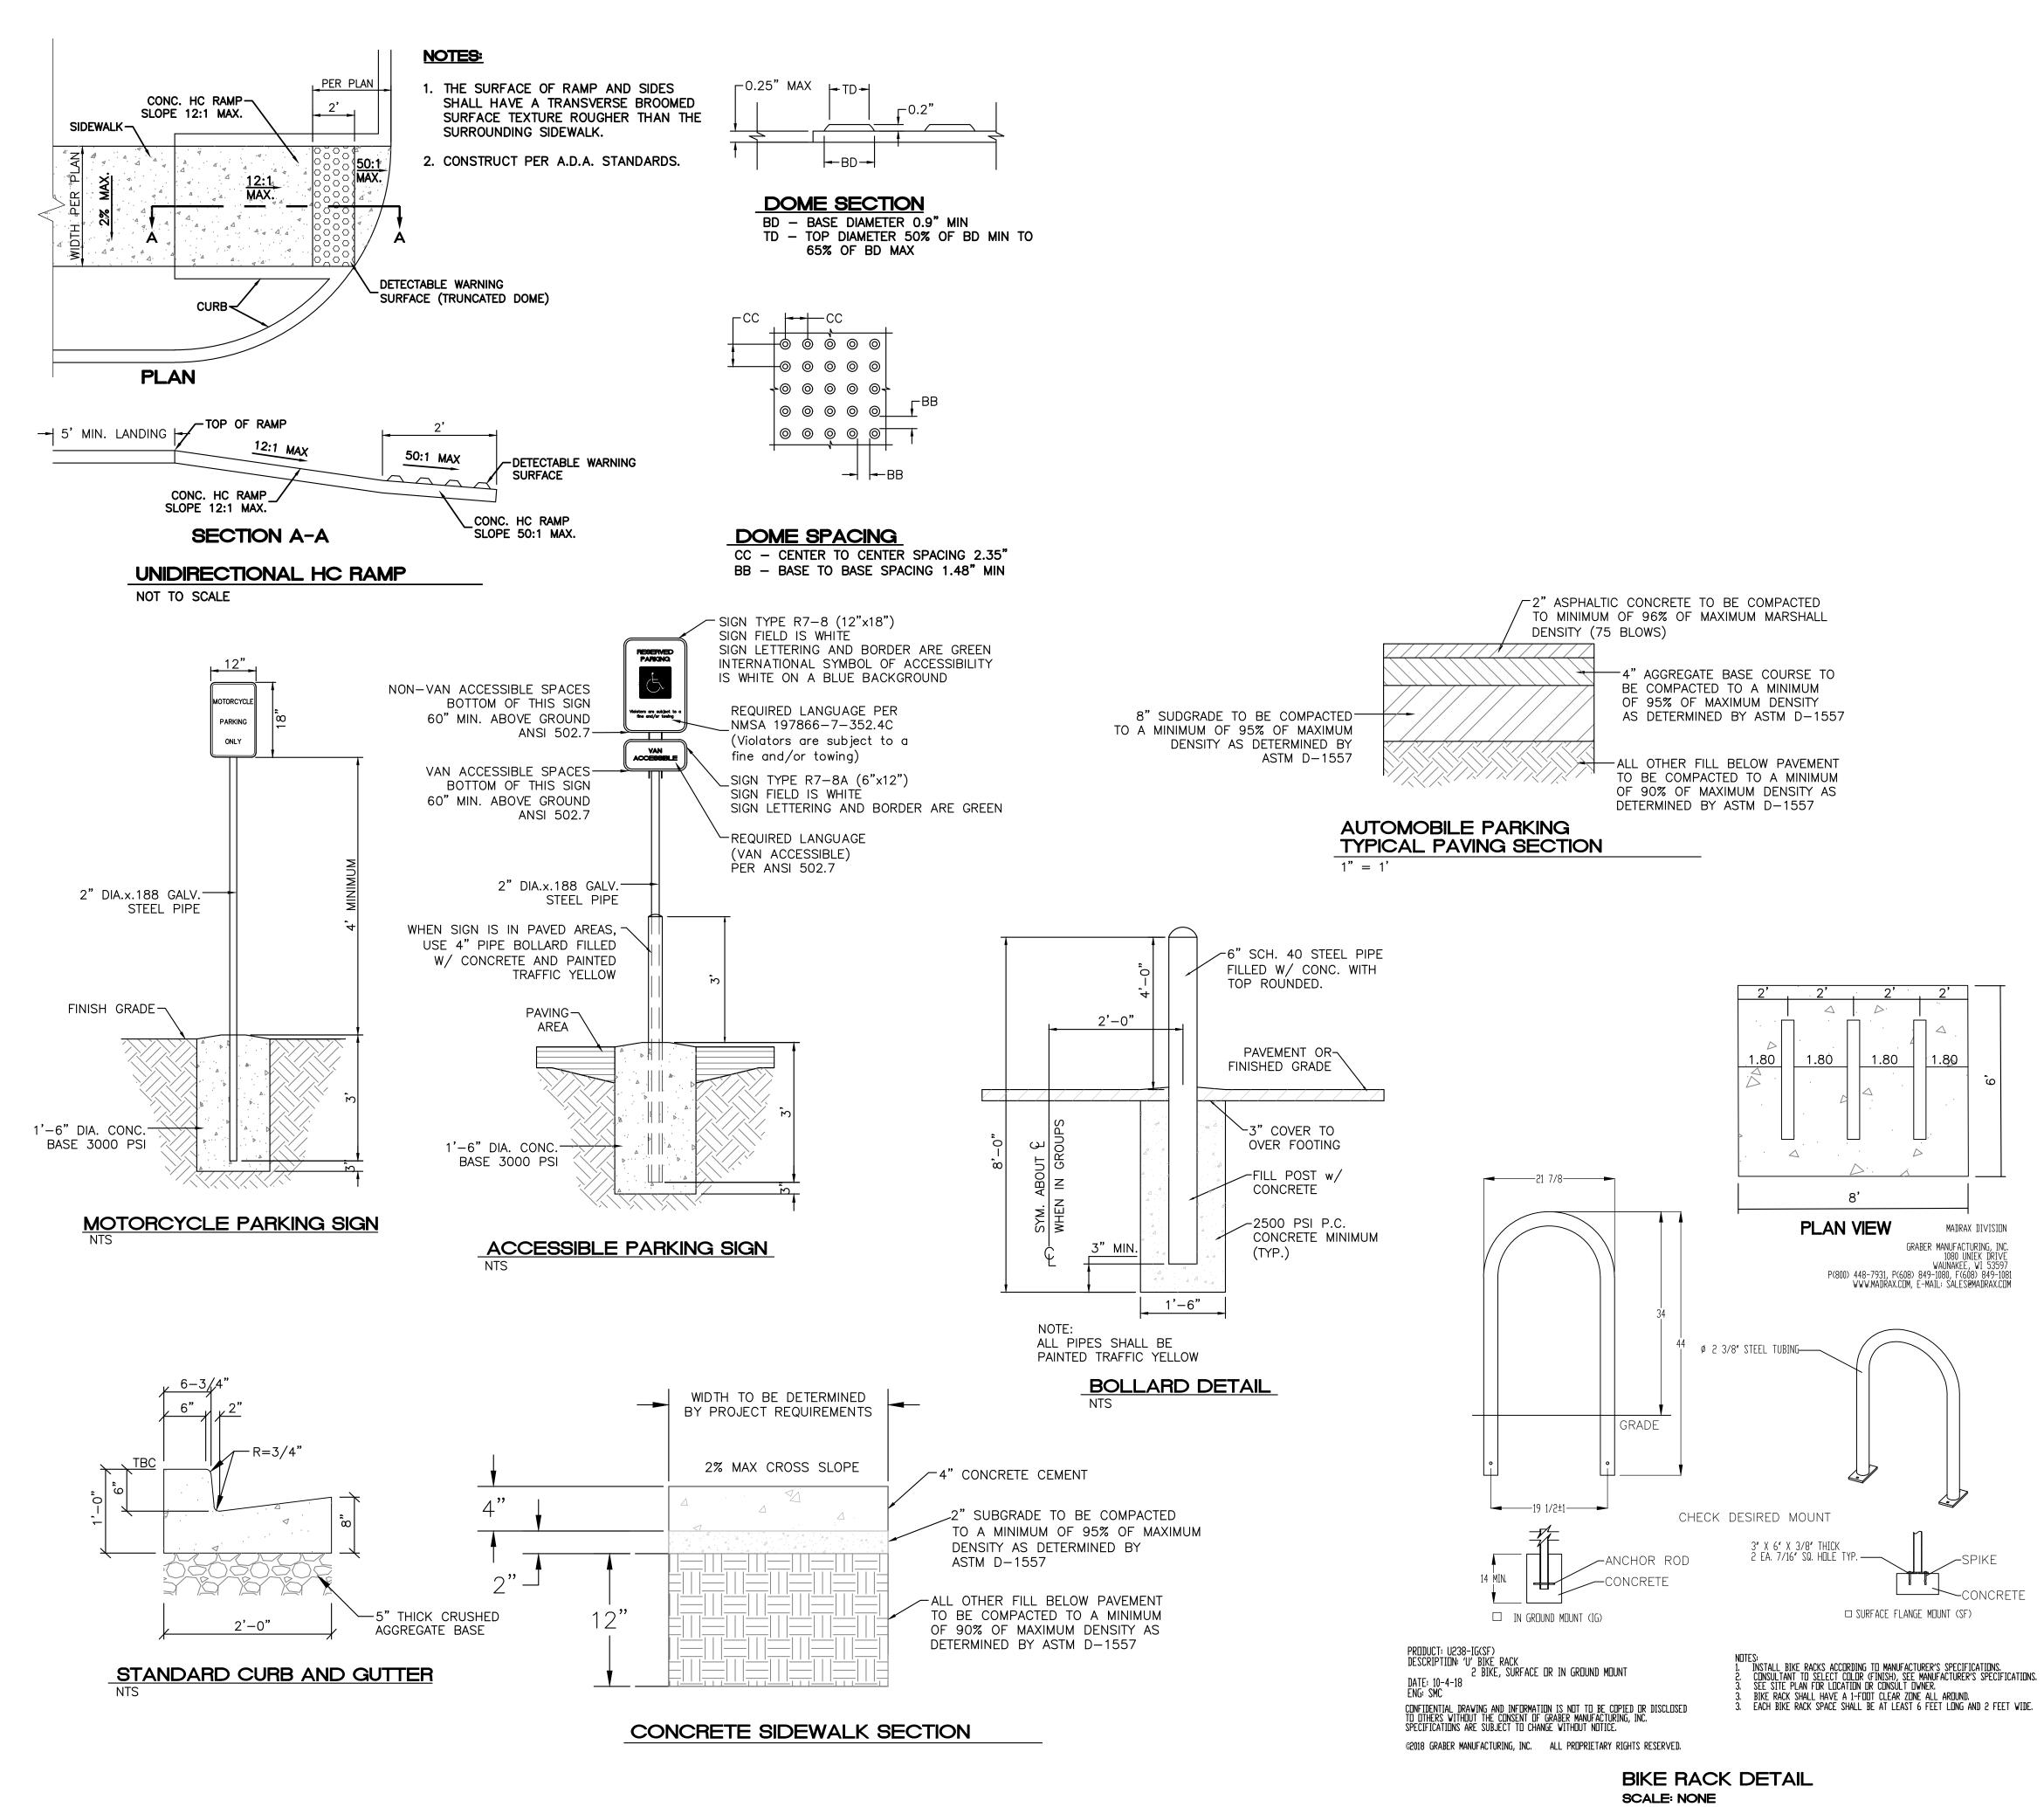

 $\bigtriangleup$ 

 $\triangleright$ 

1.80

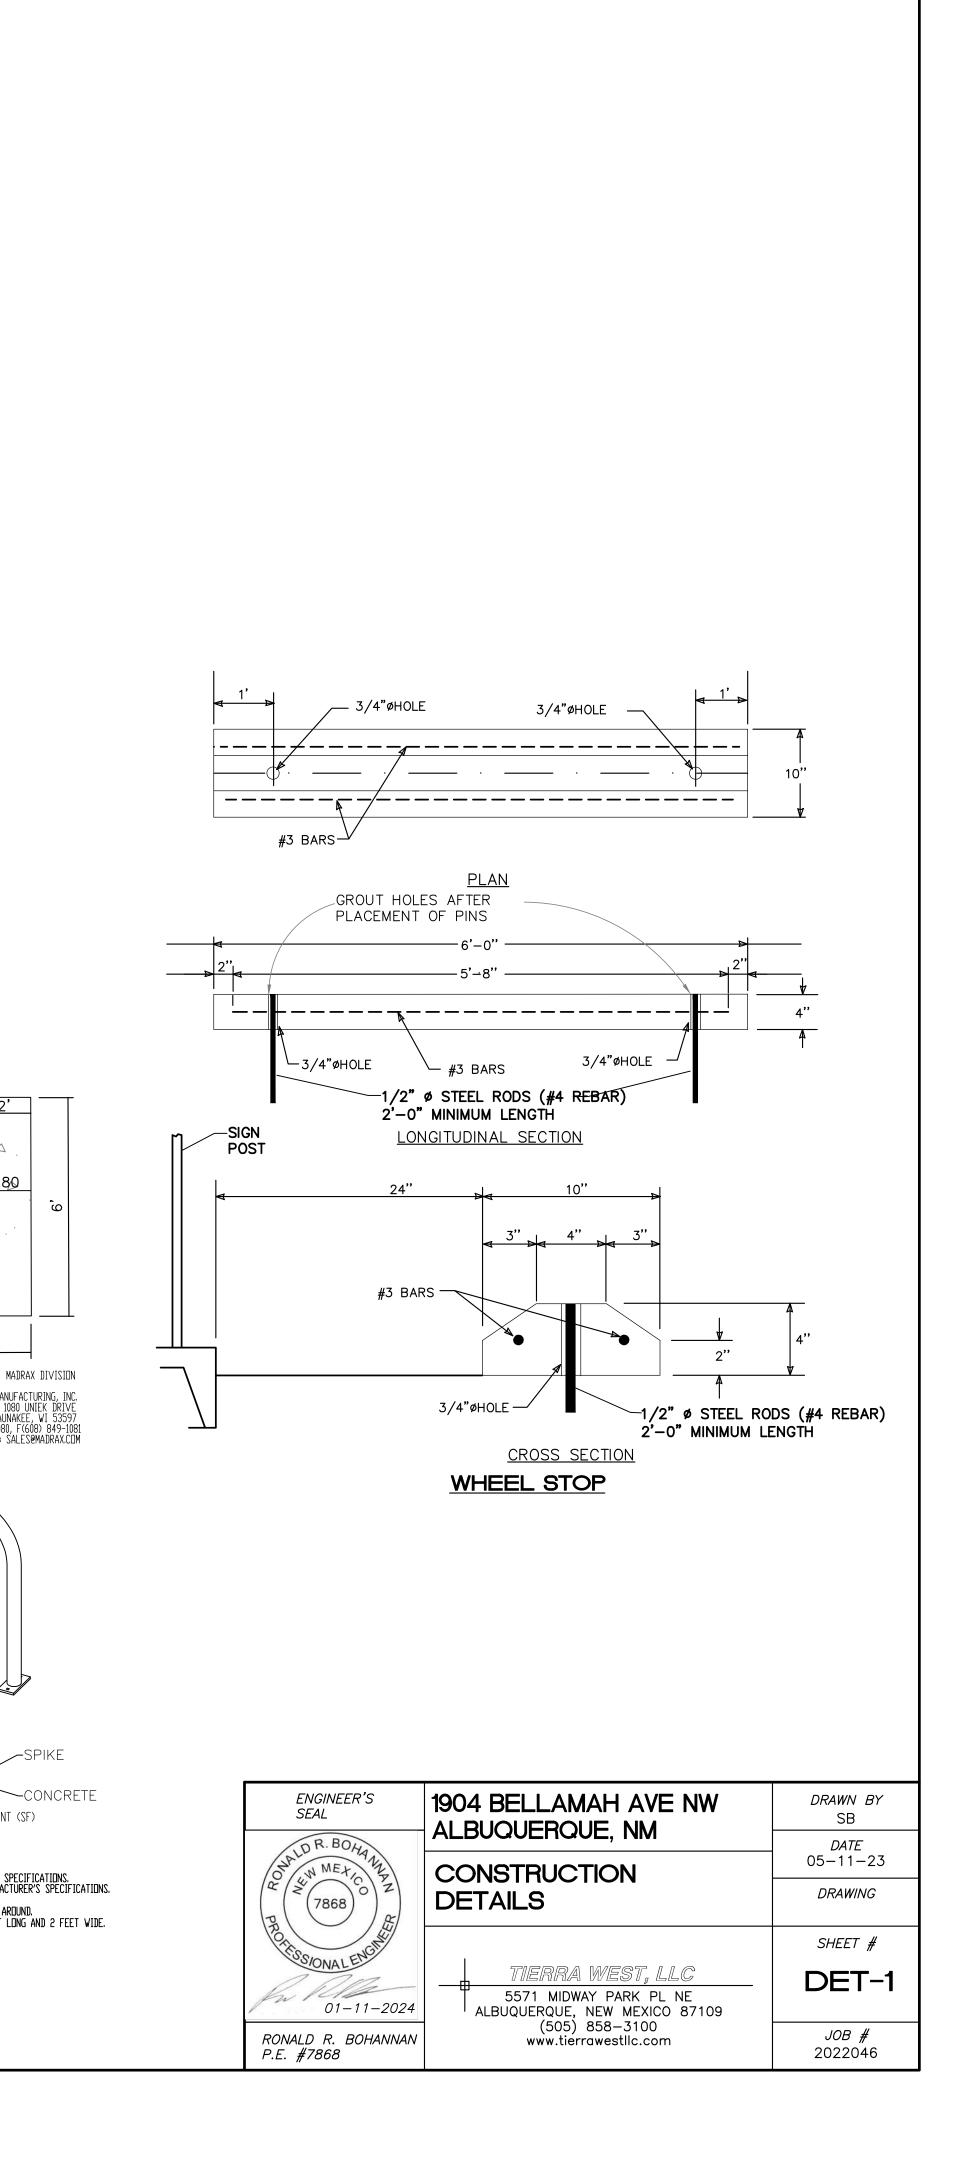


## DIMENSIONS (in/ft)


	Height	Н	13.1'	16.4'	19.7'
Overhang L 31.5" - 47.2" - 59.0"	Overhang	L		31	.5" - 47.2" -
Overhang L 31.5" - 47.2" - 59.0"					
	DOMITIENNE V2	Wall & a	gainst a pole	mounting	
Weight (lbs) 24.2- 37.5 41.9	Overhang	L	31.5" <b>-</b> 47	.2" - 59.0"	
	Weight (lbs)		24.2- 3	37.5 41.9	
	Weight (lbs)		24.2- 3	37. <b>5</b> 41.9	
13.2 1.96	11 9"		12	2	1.00
	11.8"			<u> </u>	1.96"

**Base plate:** 15.7" x 15.7" • **Center to center:** 11.8" x 11.8" 4 anchor bolts (not supplied) Section : 9.8" x 5.9"





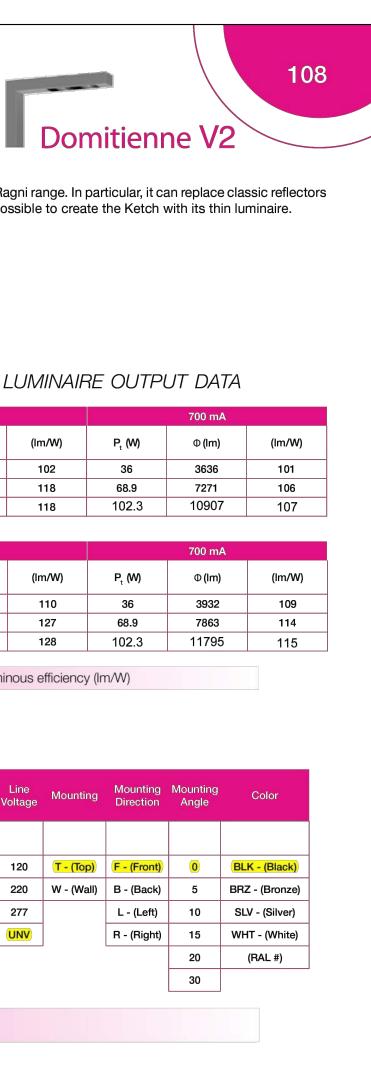

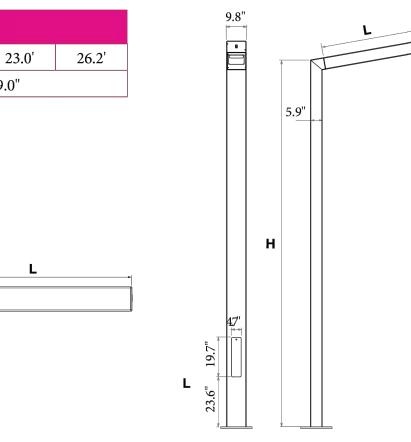



The EVO2 is very compact so that it can be incorporated into numerous luminaires in the Ragni range. In particular, it can replace classic reflectors (high-pressure sodium lamps, metal halide lamps...), and its compactness has made it possible to create the Ketch with its thin luminaire.



LED manufacturer: CREE
LED life-cycle: up to 100,000 hours
Color temperatures: 3000K ou 4000K.
CRI above 70

POWER AND LUMINOUS INTENSITIES PER MODULE - LUMINAIRE OUTPUT DATA

	3000 K		350 mA		-	500 mA		
	Number of LED	P, (W)	Ф (lm)	(Im/W)	P, (W)	Ф (lm)	(Im/W)	P, (W)
	16	21.4	1988	93	28.2	2867	102	36
	32	34.4	3976	116	48.8	5734	118	68.9
	48	51	5964	117	72.6	8601	118	102.3
1								

4000 K		350 mA			500 mA		
Number of LED	P <sub>t</sub> (W)	Φ (lm)	(Im/W)	P, (W)	Φ (lm)	(Im/W)	P, (W)
16	21.4	2147	100	28.2	3097	110	36
32	34.4	4294	125	48.8	6193	127	68.9
48	51	6441	126	72.6	9290	128	102.3

 $P_t$  (W) = Total power consumption including driver consumption •  $\Phi$  Nominal flux (Im) • Luminous efficiency (Im/W)

### ORDERING INFORMATION


	Model	Pole Height (mm)	Head Length	# LED	CCT (K)	Drive Current	Distribution	Line Voltage	Mounting	Mounting Direction
	DOMV									
-		4000	800	16	3 - ( <mark>3000K)</mark>	35 - (350 mA)	T2	120	T - (Top)	F - (Front)
		5000	1200	24	4 - (4000K)	50 - (500 mA)	<b>T3</b>	220	W - (Wall)	B - (Back)
		6000	1500	32		70 - (700 mA)	T4	277		L - (Left)
		7000		48		CUSTOM	T5	UNV		R - (Right)
		8000								
		CUSTOM								


www.ragni-lighting.com 🔼

### NOTES

- 1. LIGHT FIXTURES SHALL BE SHIELDED USING FULL CUTOFF LIGHT FIXTURES (I.E. A LIGHT FIXTURE WITH ZERO INTENSITY AT OR ABOVE 90 DEGREES ABOVE NADIR AND LIMITED TO A VALUE NOT EXCEEDING 10% OF LAMP LUMENS AT OR ABOVE 80°).
- 2. LIGHTING SHALL BE POSITIONED SO THAT LIGHT SPILLOVER ONTO THE AREA 10' BEYOND THE PROPERTY LINE SHALL NOT EXCEED 200' LAMBERTS AS MEASURED FROM THE PROPERTY LINE FACING THE LIGHT SOURCE.
- 3. OUTDOOR LIGHT FIXTURES SHALL HAVE A MINIMUM LIGHT INTENSITY OF 1 LUMEN PER SQUARE FOOT AND A MAXIMUM INTENSITY OF 2 LUMENS PER SQUARE FOOT.



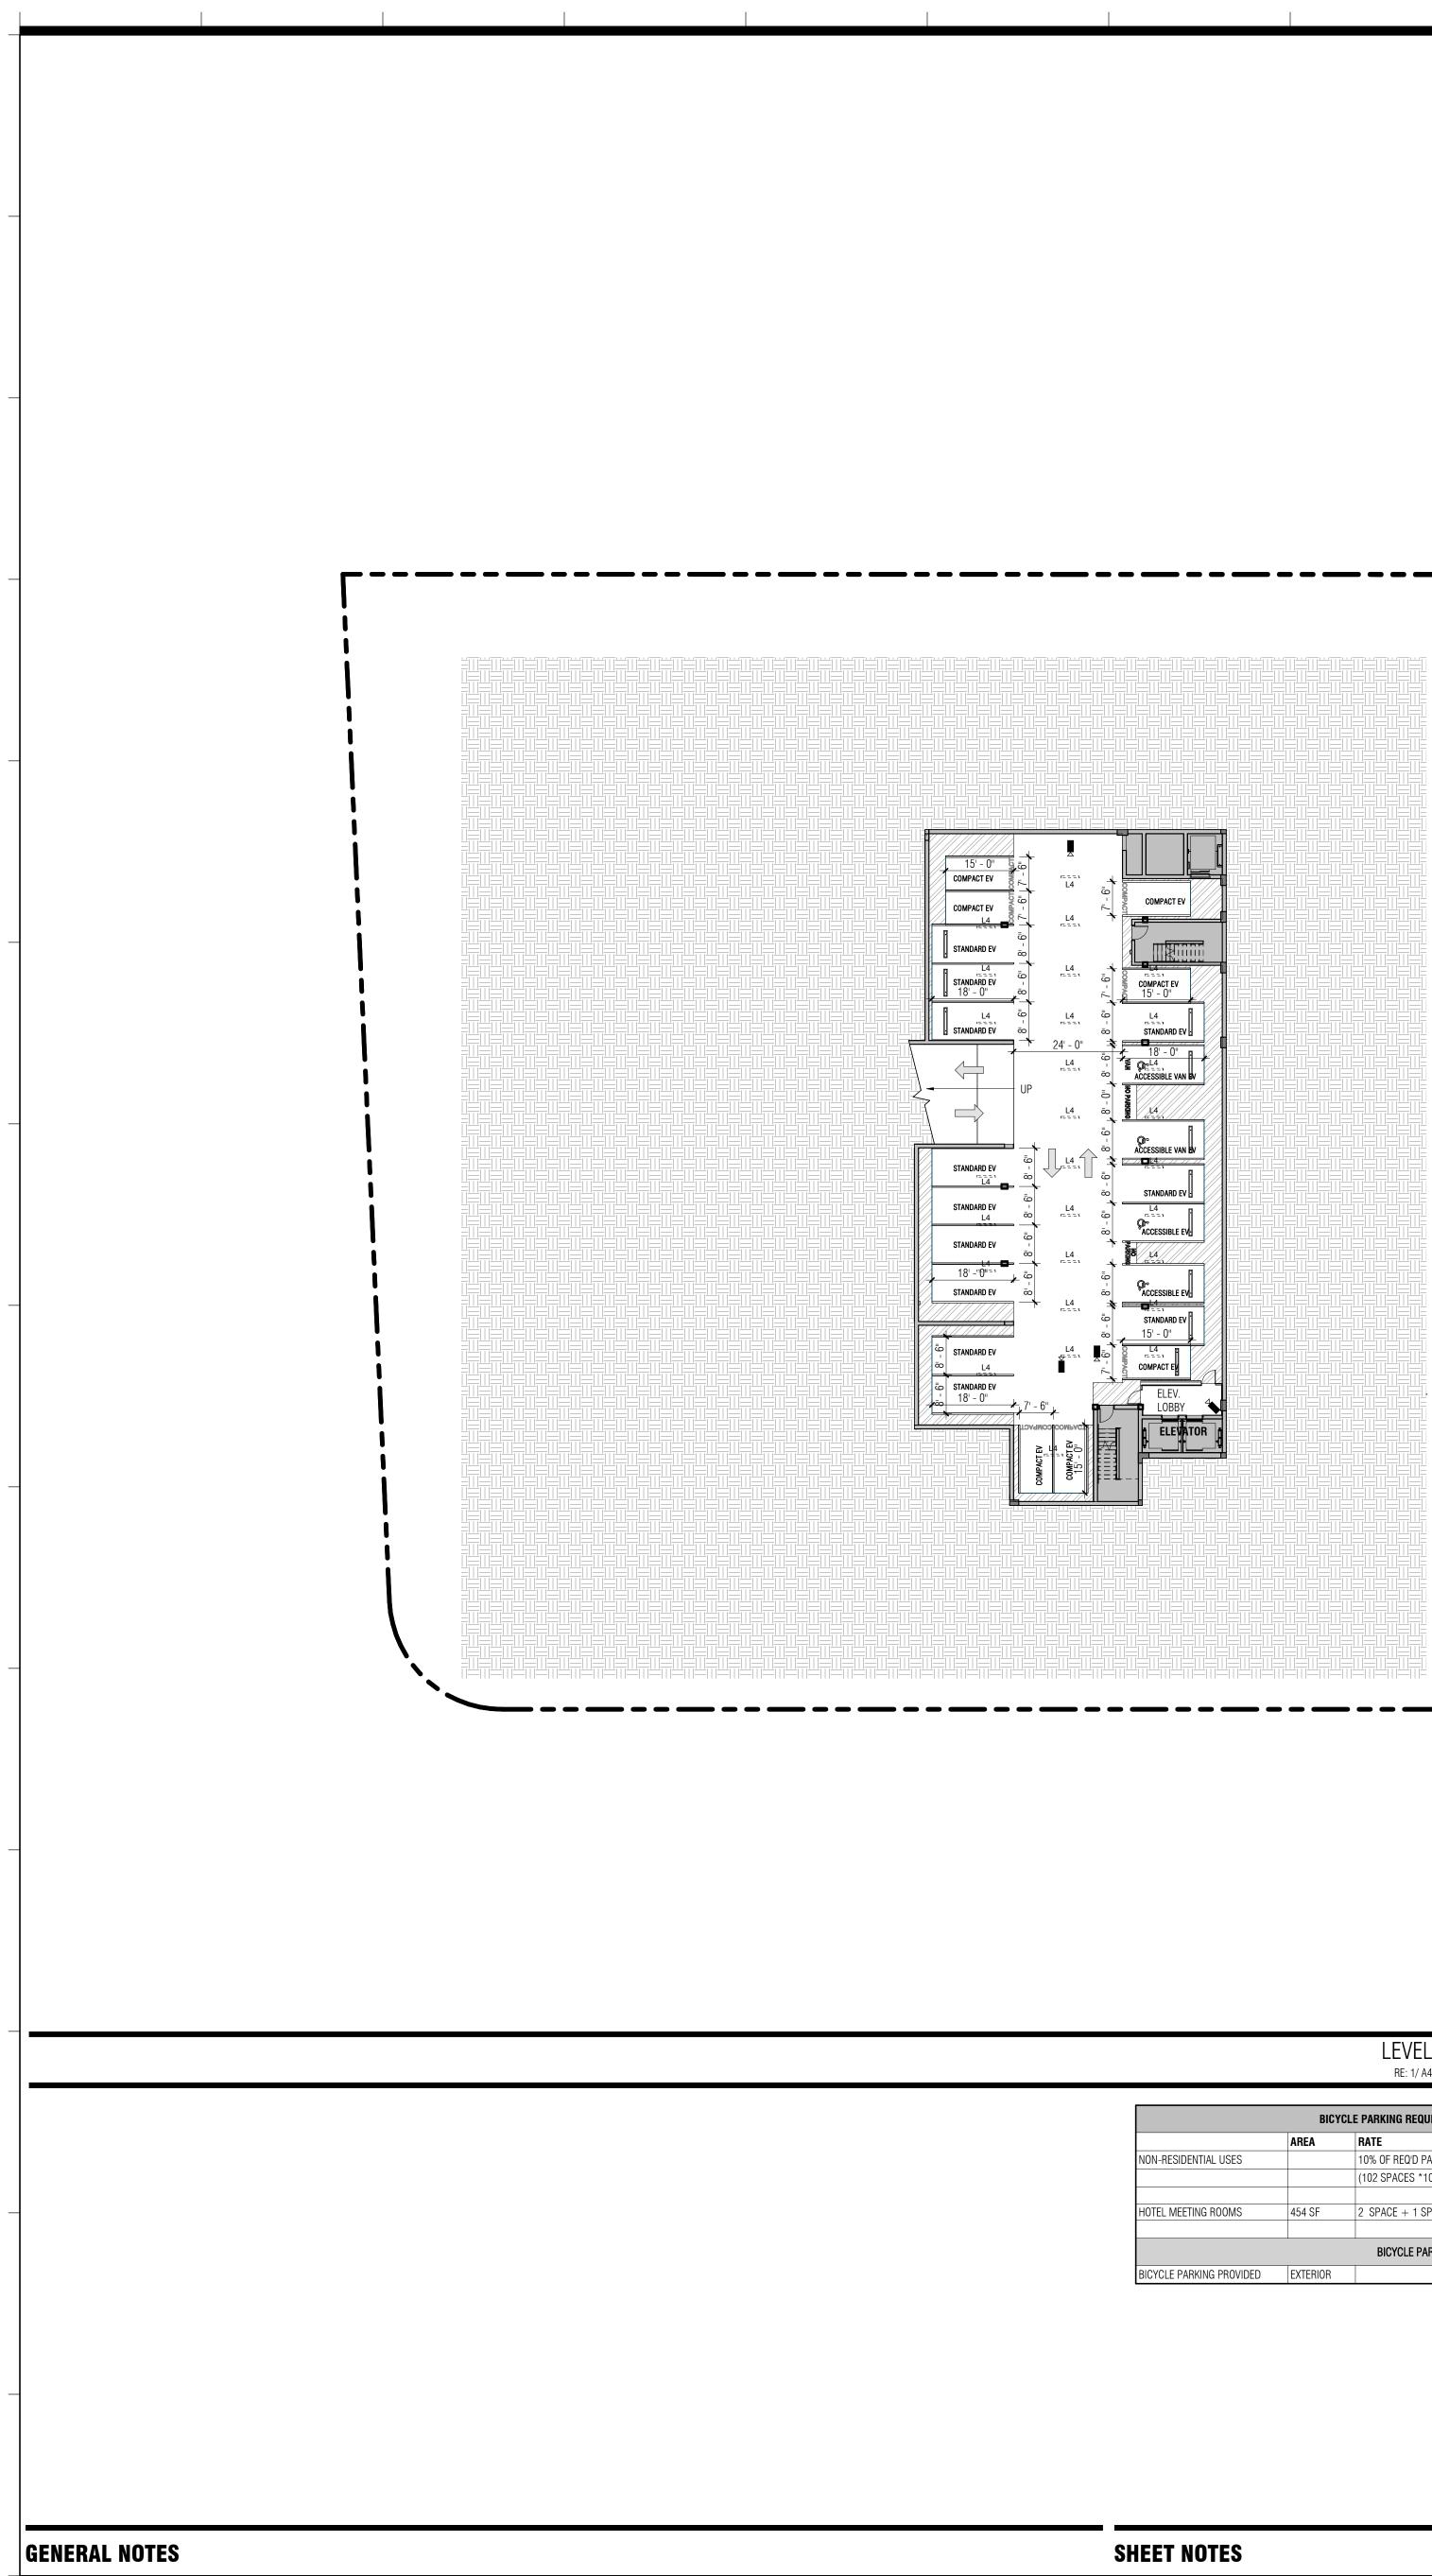

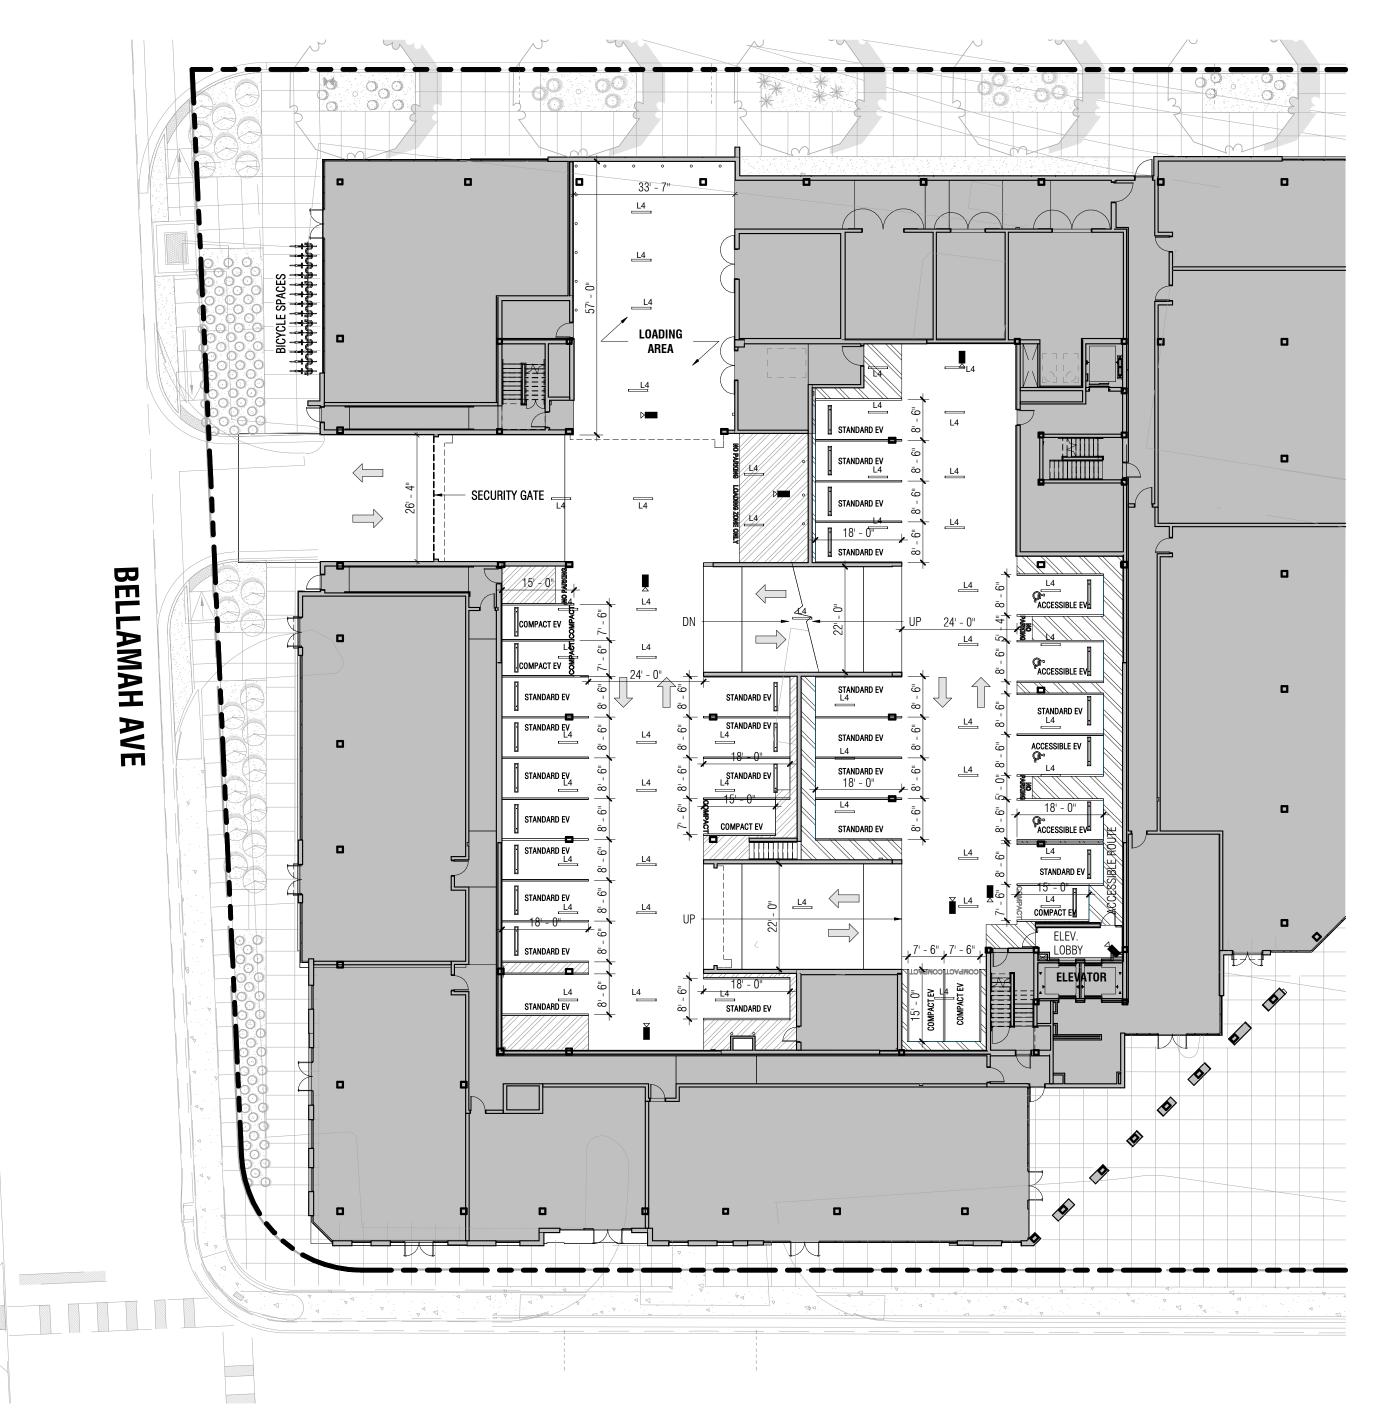

LEVEL P1 -	FLOOR PLAN
RE: 1/ A40.01	SCALE: 1" = 20'-0"

	AREA	BATE	STALLS
NON-RESIDENTIAL USES		10% OF REQ'D PARKING SPACES	11 SPACES
		(102 SPACES *10%)	
HOTEL MEETING ROOMS	454 SF	2 SPACE + 1 SPACE / 6,000 GSF	3 SPACES
		BICYCLE PARKING PROVIDED	
BICYCLE PARKING PROVIDED	EXTERIOR		14 SPACES

ТҮРЕ	PARKING SPACE
EVEL 1	
ACCESSIBLE EV	4
COMPACT EV	6
STANDARD EV	22
EVEL 1.7	
COMPACT EV	10
MOTORCYCLE	1
STANDARD EV	27
EVEL 2	
COMPACT EV	5
MOTORCYCLE	3
STANDARD EV	15
EVEL P1	
ACCESSIBLE EV	2
ACCESSIBLE VAN EV	2
COMPACT EV	7
STANDARD EV	12
TOTAL: 116	

CAR/VAN PARKING PROVIDED SPACES TYPE CCESSIBLE EV CCESSIBLE VAN EV OMPACT EV STANDARD EV TOTAL: 112 76 \*EV SPACES ARE NOT DEDICATED EV STALLS AND NOT MARKED AS EV MOTOCYCLE PARKING PROVIDED PARKING SPACES MOTORCYCLE TOTAL: 4

20TH ST

	PARKING REQUIREN	IENTS & COMPLIANCE	
PROGRAM	AREA/UNITS	PARKING LOAD	REQ D SPACES
GUEST	107	1 SPACE/GUEST RM	107
GENERAL RETAIL	5,430 SF	3.5 SPACES/1,000 SF GFA	20
RESTAURANT	14,465 SF	5.6 SPACES/1,000 SF GFA	82
PARKING SPACES REQUIRED (NO REDUC	CTION)		209
TOTAL SPACE PROVIDED (REAL PHYSIC)	AL SPACES)		112
SPACES WITH EV CHARGERS			112
TOTAL SPACES TO MEET REQUIREMENT	W/ EV CREDIT		224
SPACES SURPLUS/ DEFICIT			15 SPACES SUR
		COMMENT	REQ T SPACES
ACCESSIBLE PARKING SPACES		SEE NMBC TABLE 1106.1	8 SPACES
ACCESSIBLE VAN SPACES		SEE NMBC TABLE 1106.1	2 SPACES
		SEE IDO TABLE 5-5-4	4 SPACES

### LEVEL 01 - FLOOR PLAN RE: 1/ A31.01 SCALE: 1" = 20'-0"

LEGEND	
∑ ∎	CCTV SECURITY CAMERA

L4 OVERHEAD LIGHTING 


ACCESSIBLE STALL





OFFICEUNTITLED DESIGN ARCHITECT 4200 SEPULVEDA BLVD, STE 104, CULVER CITY, CA 90230 P.310.730.6698

# SAWMILL (LOT A)

1904 BELLAMAH AVE NW ALBUQUERQUE NM 87104

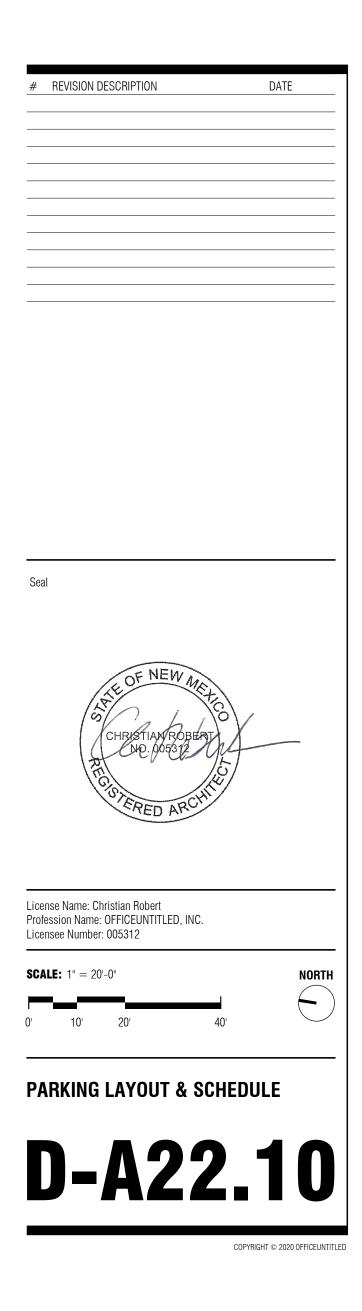

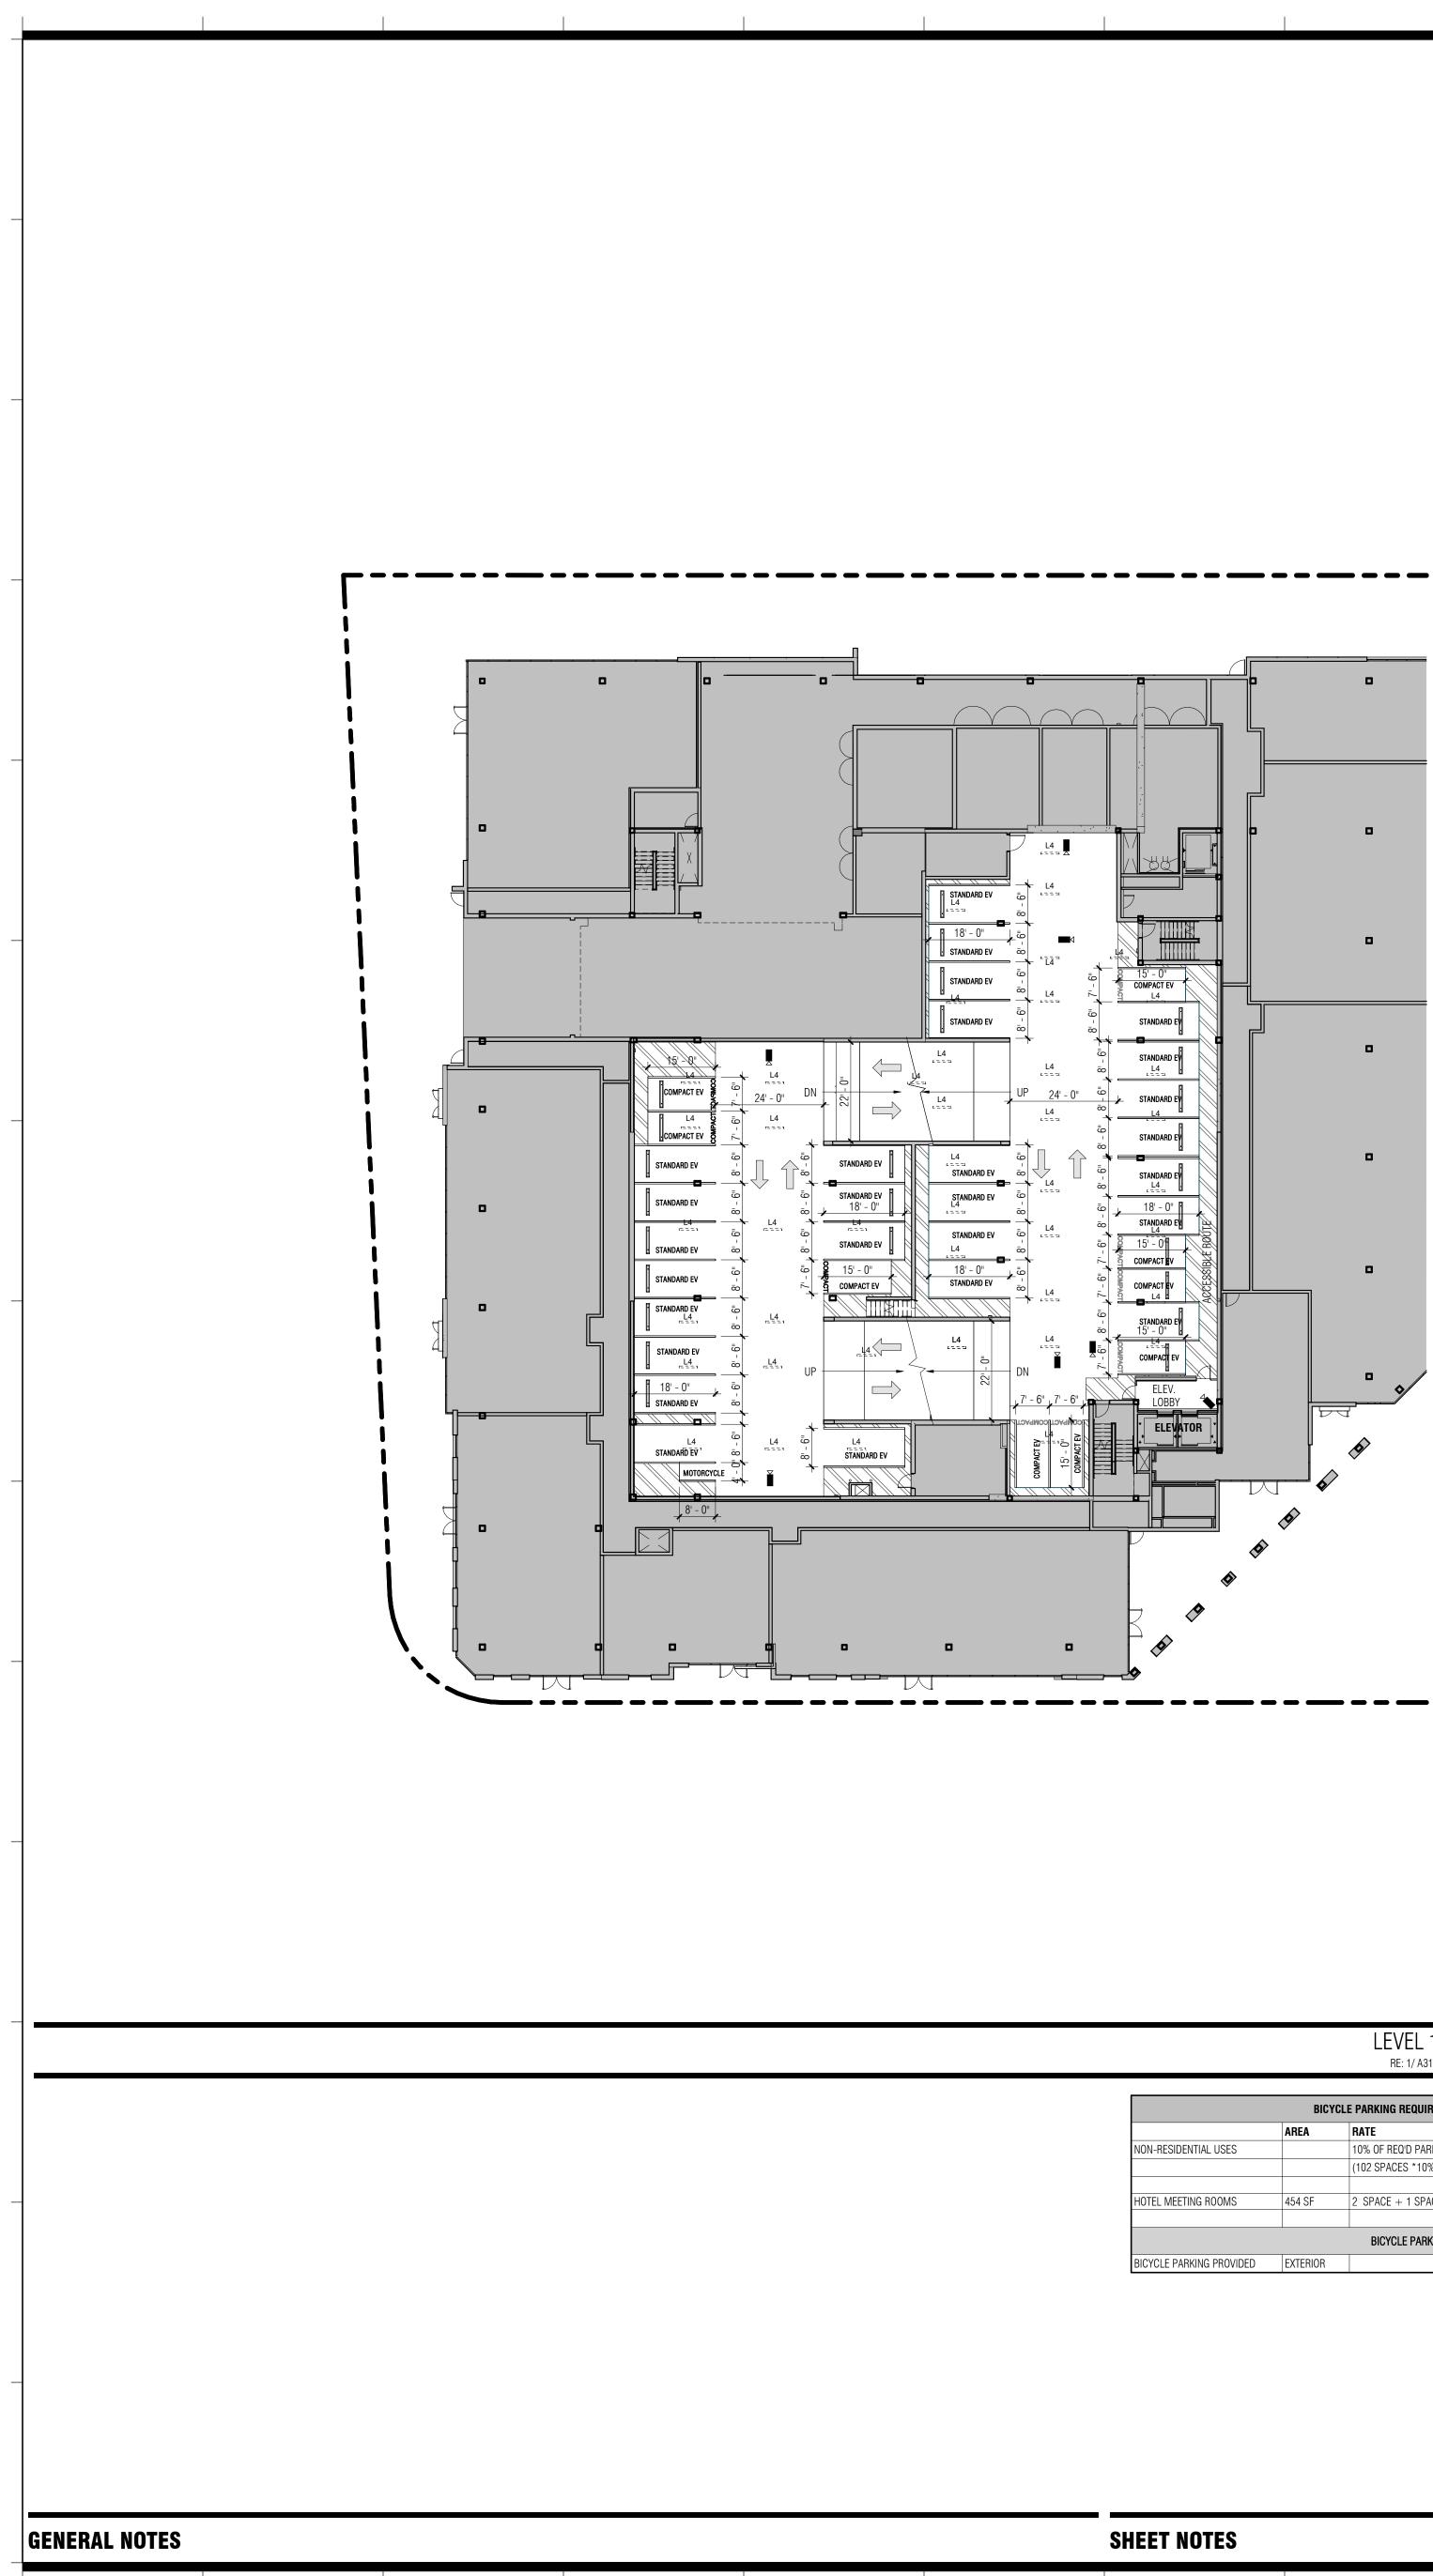

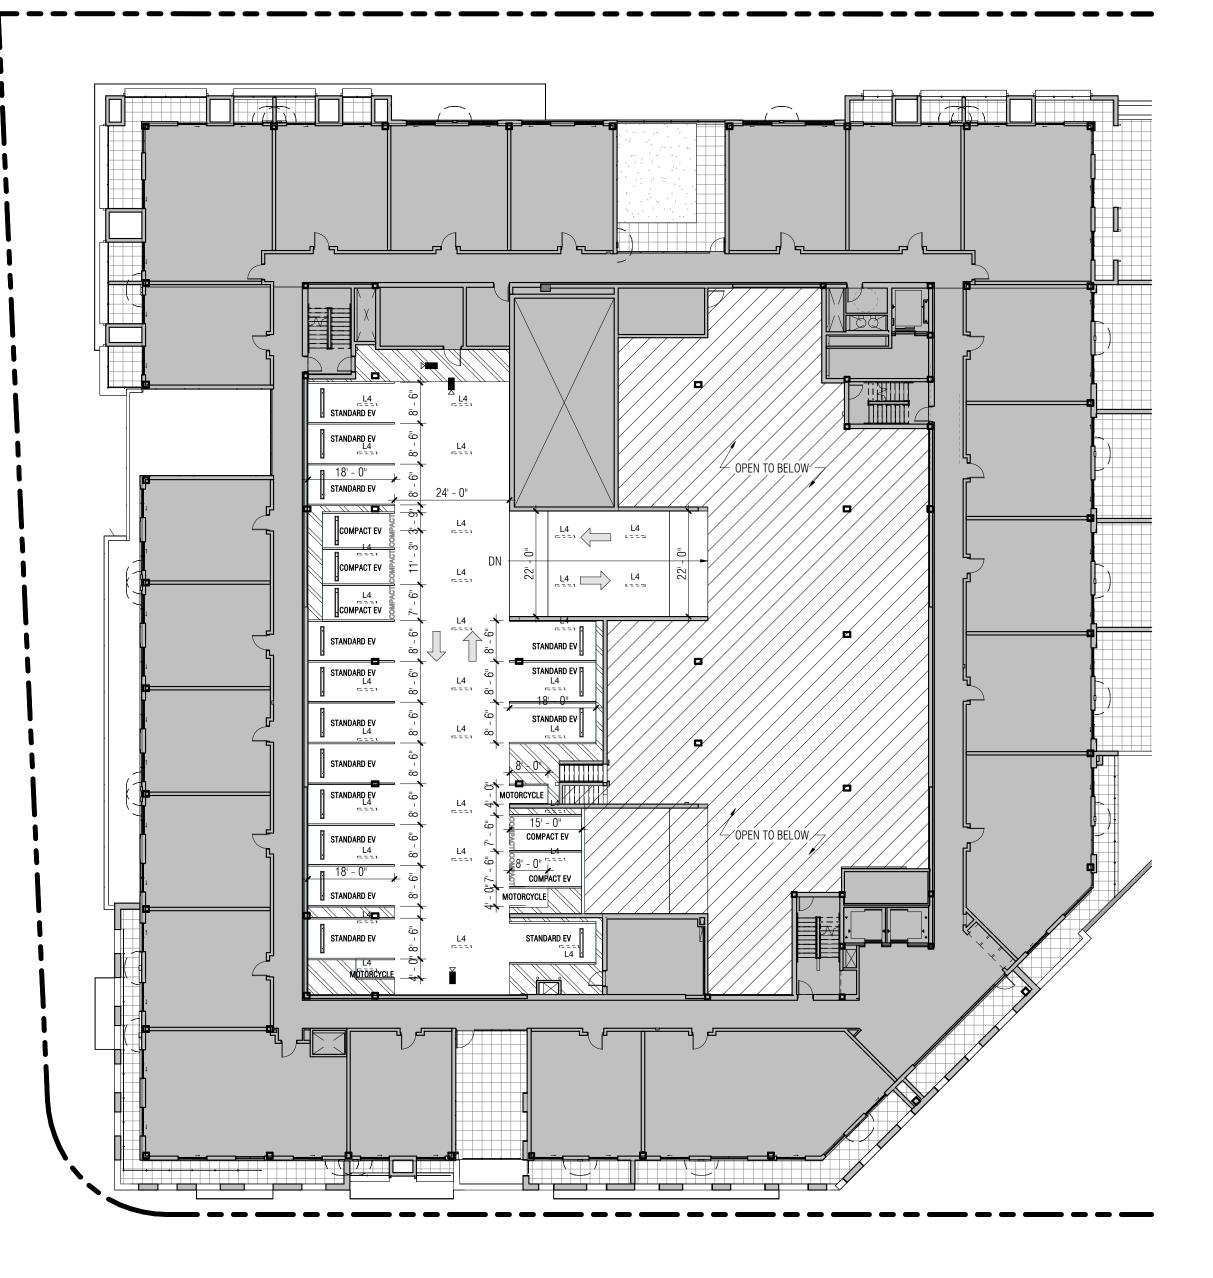

LEVEL 1.7	- FLOOR PLAN
RE: 1/ A31.01	SCALE: 1" = 20'-0"

	BICYCLE PARKING REQUIRED (PER IDO TABLE 5-5-5)						
	AREA	RATE	STALLS				
NON-RESIDENTIAL USES		10% OF REQ'D PARKING SPACES	11 SPACES				
		(102 SPACES *10%)					
HOTEL MEETING ROOMS	454 SF	2 SPACE + 1 SPACE / 6,000 GSF	3 SPACES				
		BICYCLE PARKING PROVIDED					
BICYCLE PARKING PROVIDED	EXTERIOR		14 SPACES				

PARKING PROV	IDED (PER LEVEL)	CAR/VAN PARKING	PROVIDE
ТҮРЕ	PARKING SPACES		
EVEL 1		ТҮРЕ	
CESSIBLE EV	4	ACCESSIBLE EV	6
PACT EV	6	ACCESSIBLE VAN EV	2
DARD EV	22	COMPACT EV	2
		STANDARD EV	7
EL 1.7		TOTAL: 112	
MPACT EV	10	*EV SPACES ARE NOT DEDIC	ATED EV S
TORCYCLE	1	NOT MARKED AS EV	-
NDARD EV	27		
EL 2		MOTOCYCLE PARKIN	IG PROVI
VPACT EV	5		
RCYCLE	3	ТҮРЕ	
IDARD EV	15	MOTORCYCLE	4
		TOTAL: 4	
/EL P1			
CESSIBLE EV	2		
CESSIBLE VAN EV	2		
MPACT EV	7		
	10		
ANDARD EV	12		

### LEVEL 02 - FLOOR PLAN RE: 1/ A31.01 SCALE: 1" = 20'-0"

VIDED		PARKING REQUIREN	MENTS & COMPLIANCE	
PARKING	PROGRAM	AREA/UNITS	PARKING LOAD	REQ D SPACES
SPACES	GUEST	107	1 SPACE/GUEST RM	107
6	GENERAL RETAIL	5,430 SF	3.5 SPACES/1,000 SF GFA	20
2	RESTAURANT	14,465 SF	5.6 SPACES/1,000 SF GFA	82
28		I	l	I
76	PARKING SPACES REQUIRED (NO REDU	CTION)		209
EV STALLS AND	TOTAL SPACE PROVIDED (REAL PHYSIC	TOTAL SPACE PROVIDED (REAL PHYSICAL SPACES)		
	SPACES WITH EV CHARGERS			112
	TOTAL SPACES TO MEET REQUIREMENT	W/ EV CREDIT		224
ROVIDED	SPACES SURPLUS/ DEFICIT			15 SPACES SURPLUS
PARKING				
SPACES			COMMENT	REQ D SPACES
4	ACCESSIBLE PARKING SPACES		SEE NMBC TABLE 1106.1	8 SPACES
	ACCESSIBLE VAN SPACES		SEE NMBC TABLE 1106.1	2 SPACES
<b>_</b>	MOTORCYCLE PARKING		SEE IDO TABLE 5-5-4	4 SPACES

# LEGEND

- CCTV SECURITY CAMERA
- L4 OVERHEAD LIGHTING


## ACCESSIBLE STALL



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# SAWMILL (LOT A)

1904 BELLAMAH AVE NW ALBUQUERQUE NM 87104



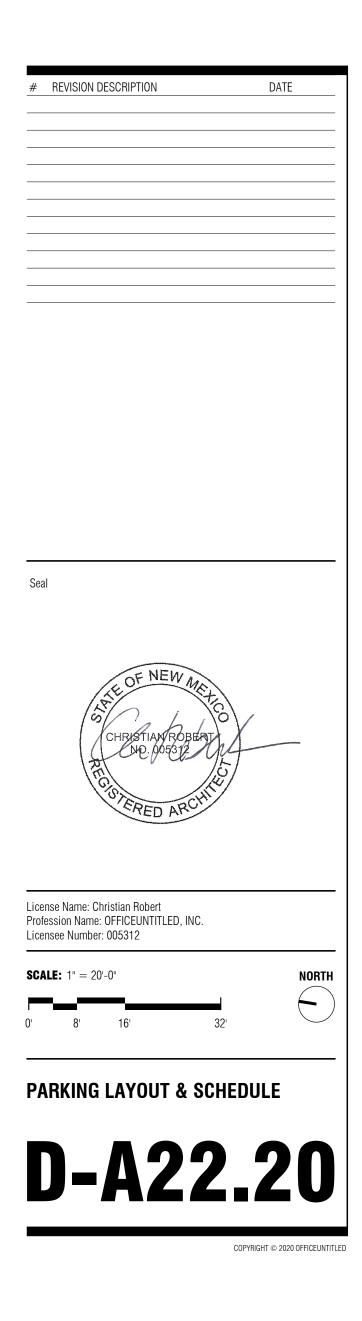



OFFICEUNTITLED DESIGN ARCHITECT 4200 SEPULVEDA BLVD, STE 104, CULVER CITY, CA 90230 P.310.730.6698

# SAWMILL (LOT A)

1904 BELLAMAH AVE NW ALBUQUERQUE NM 87104

#	REVISION DESCRIPTION	DATE
Sea		
	THE OF NEW METCO	
	CHRISTIAN ROBERT	4
	AFEC	
	REGISTERED ARCHIV	
Licer	nse Name: Christian Robert	<u>_</u>
Profe	ession Name: OFFICEUNTITLED, INC.	
SCA	<b>LE:</b> 3/32" = 1'-0"	
	0' 4' 8' 16'	
ΕX	TERIOR BUILDING ELE	VATION
	)-A30	Π1
	J-HJU	
		COPYRIGHT © 2020 OFFICEUNTITLED




	SHEET NOTES			LEGEND
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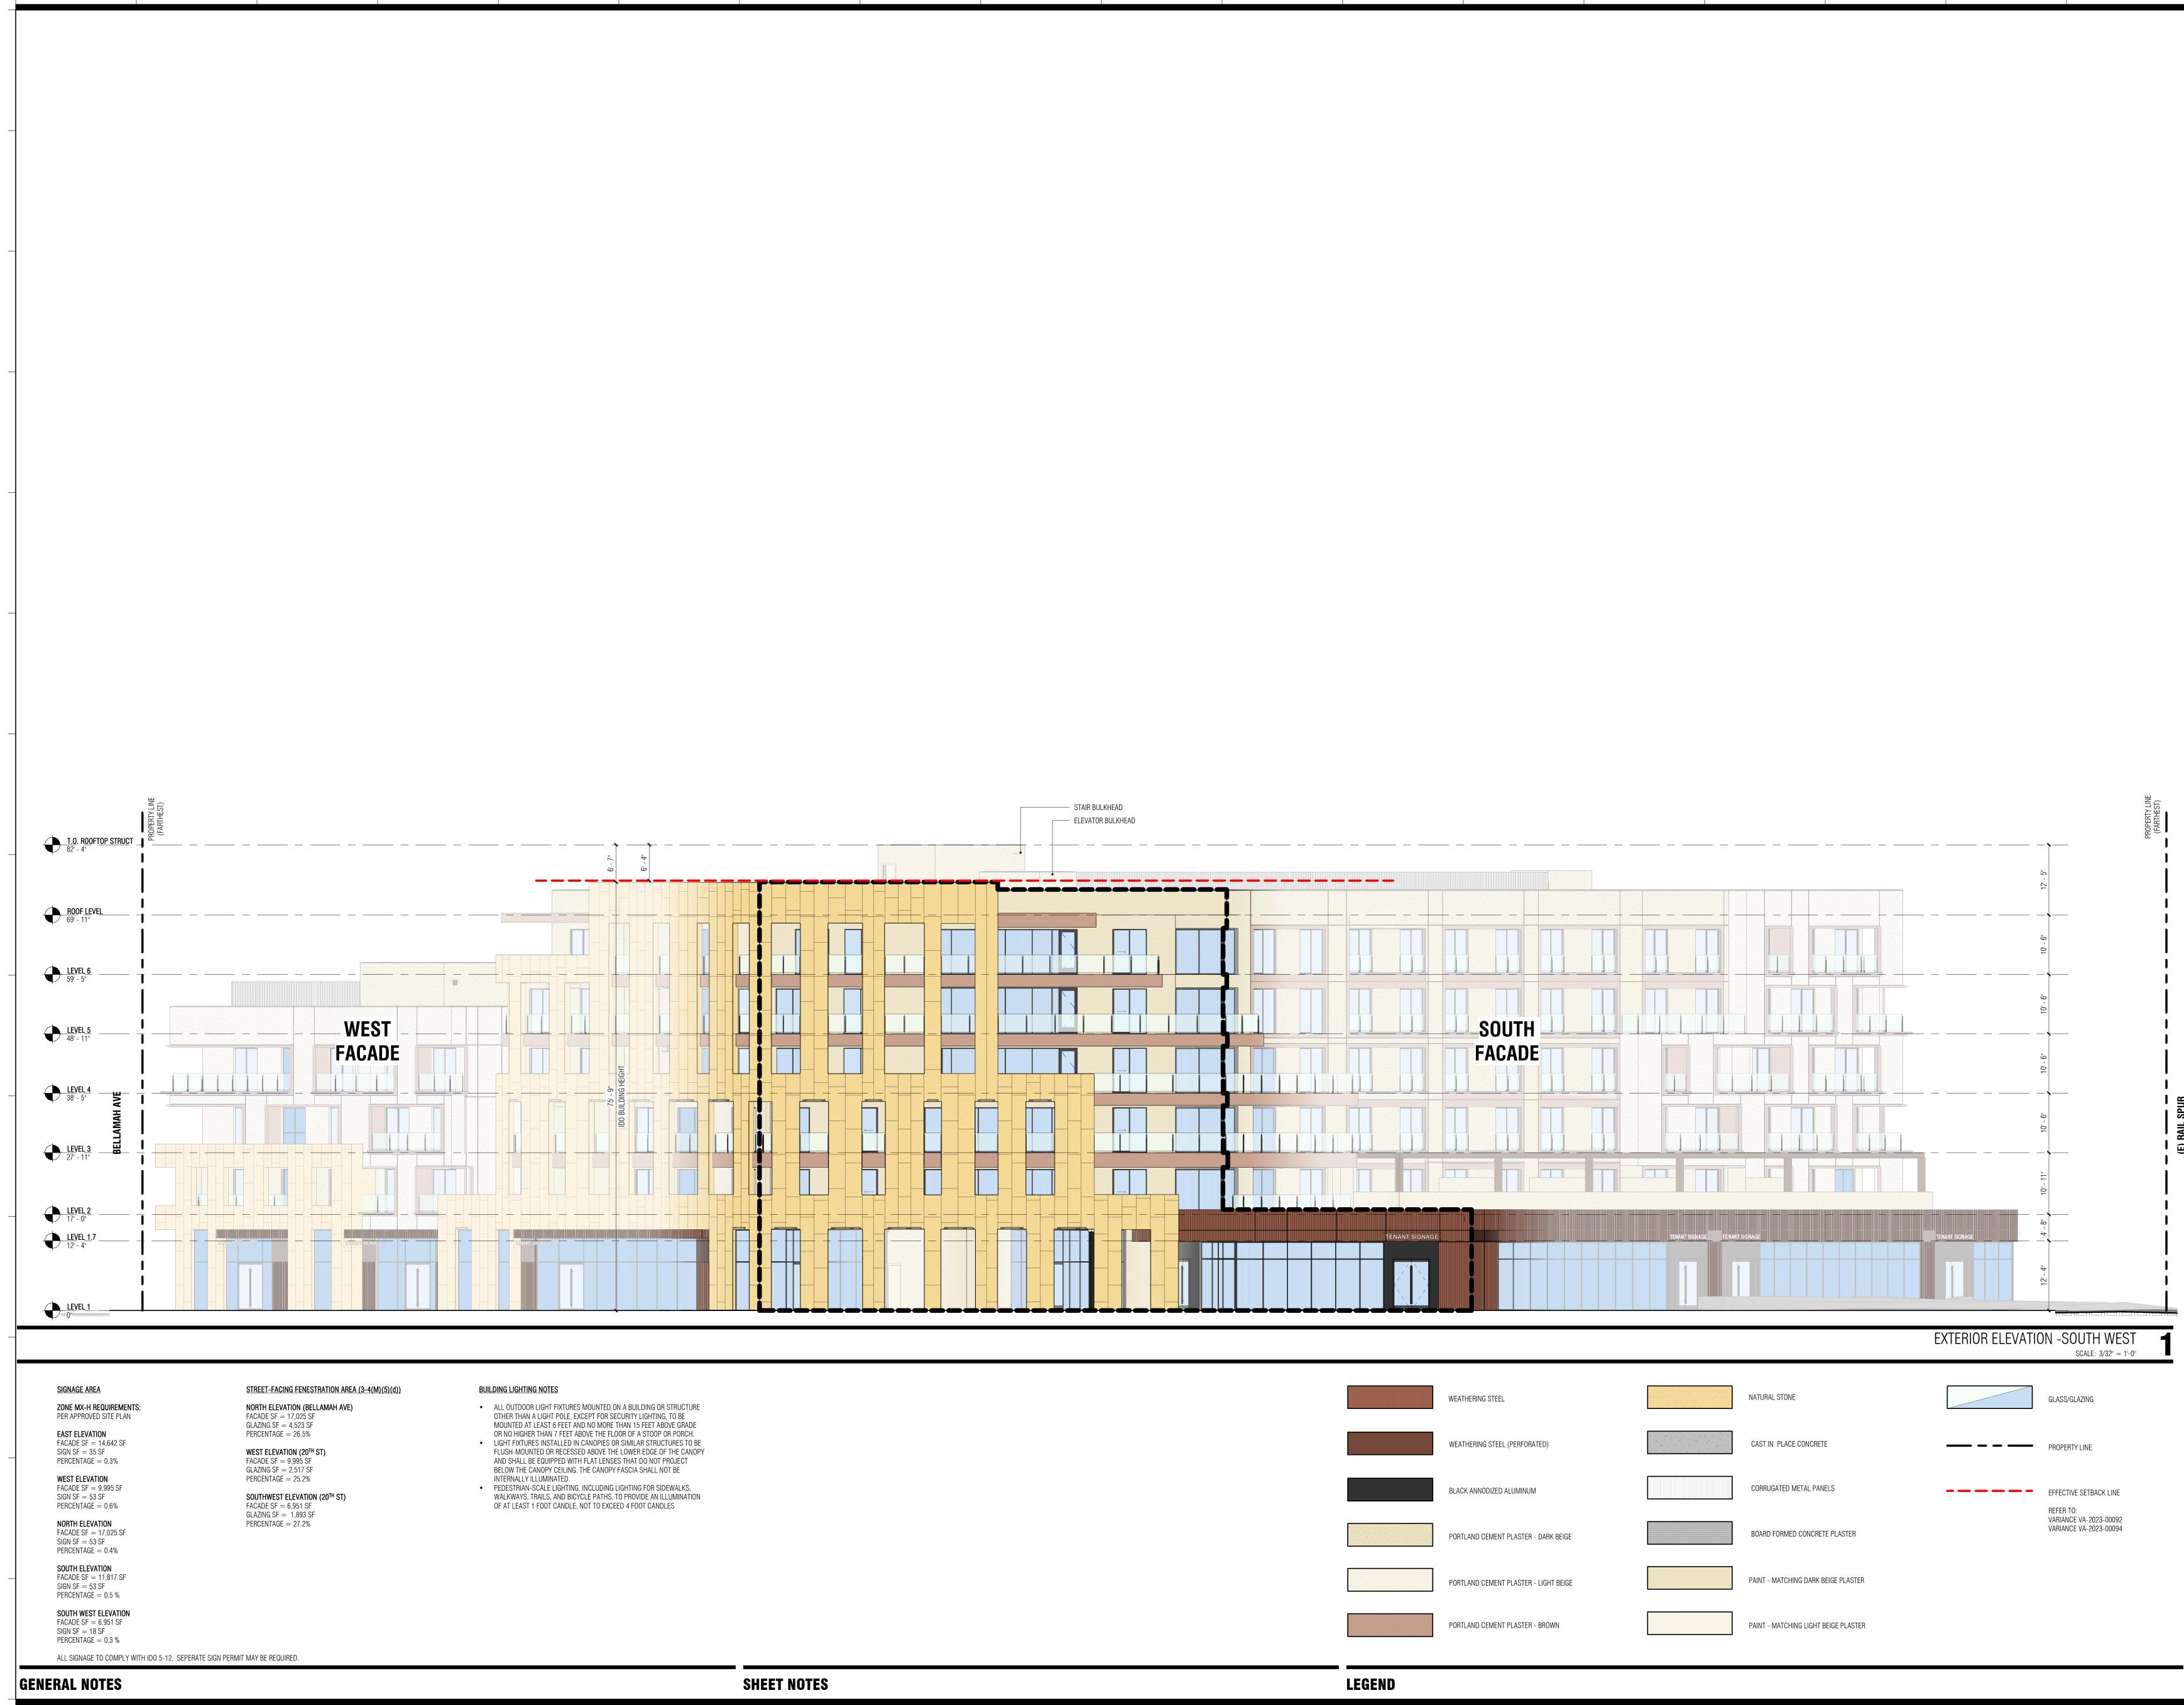


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# SAWMILL (LOT A)

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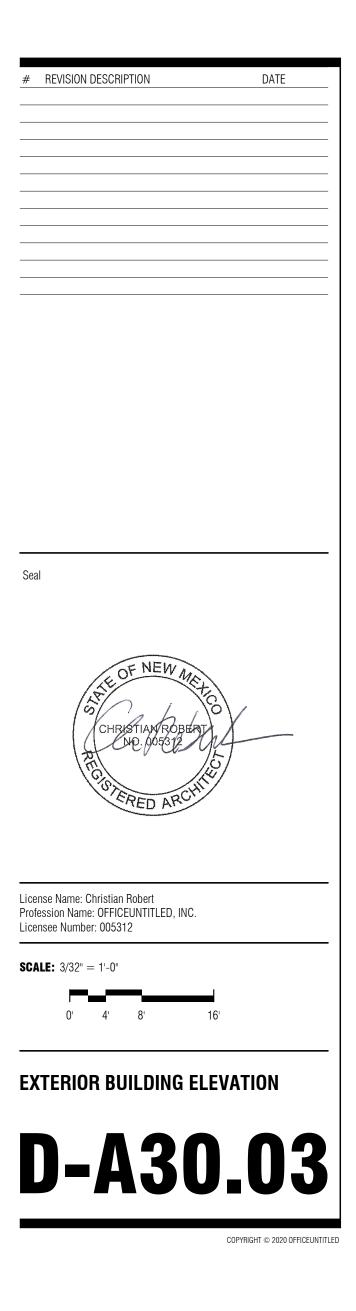
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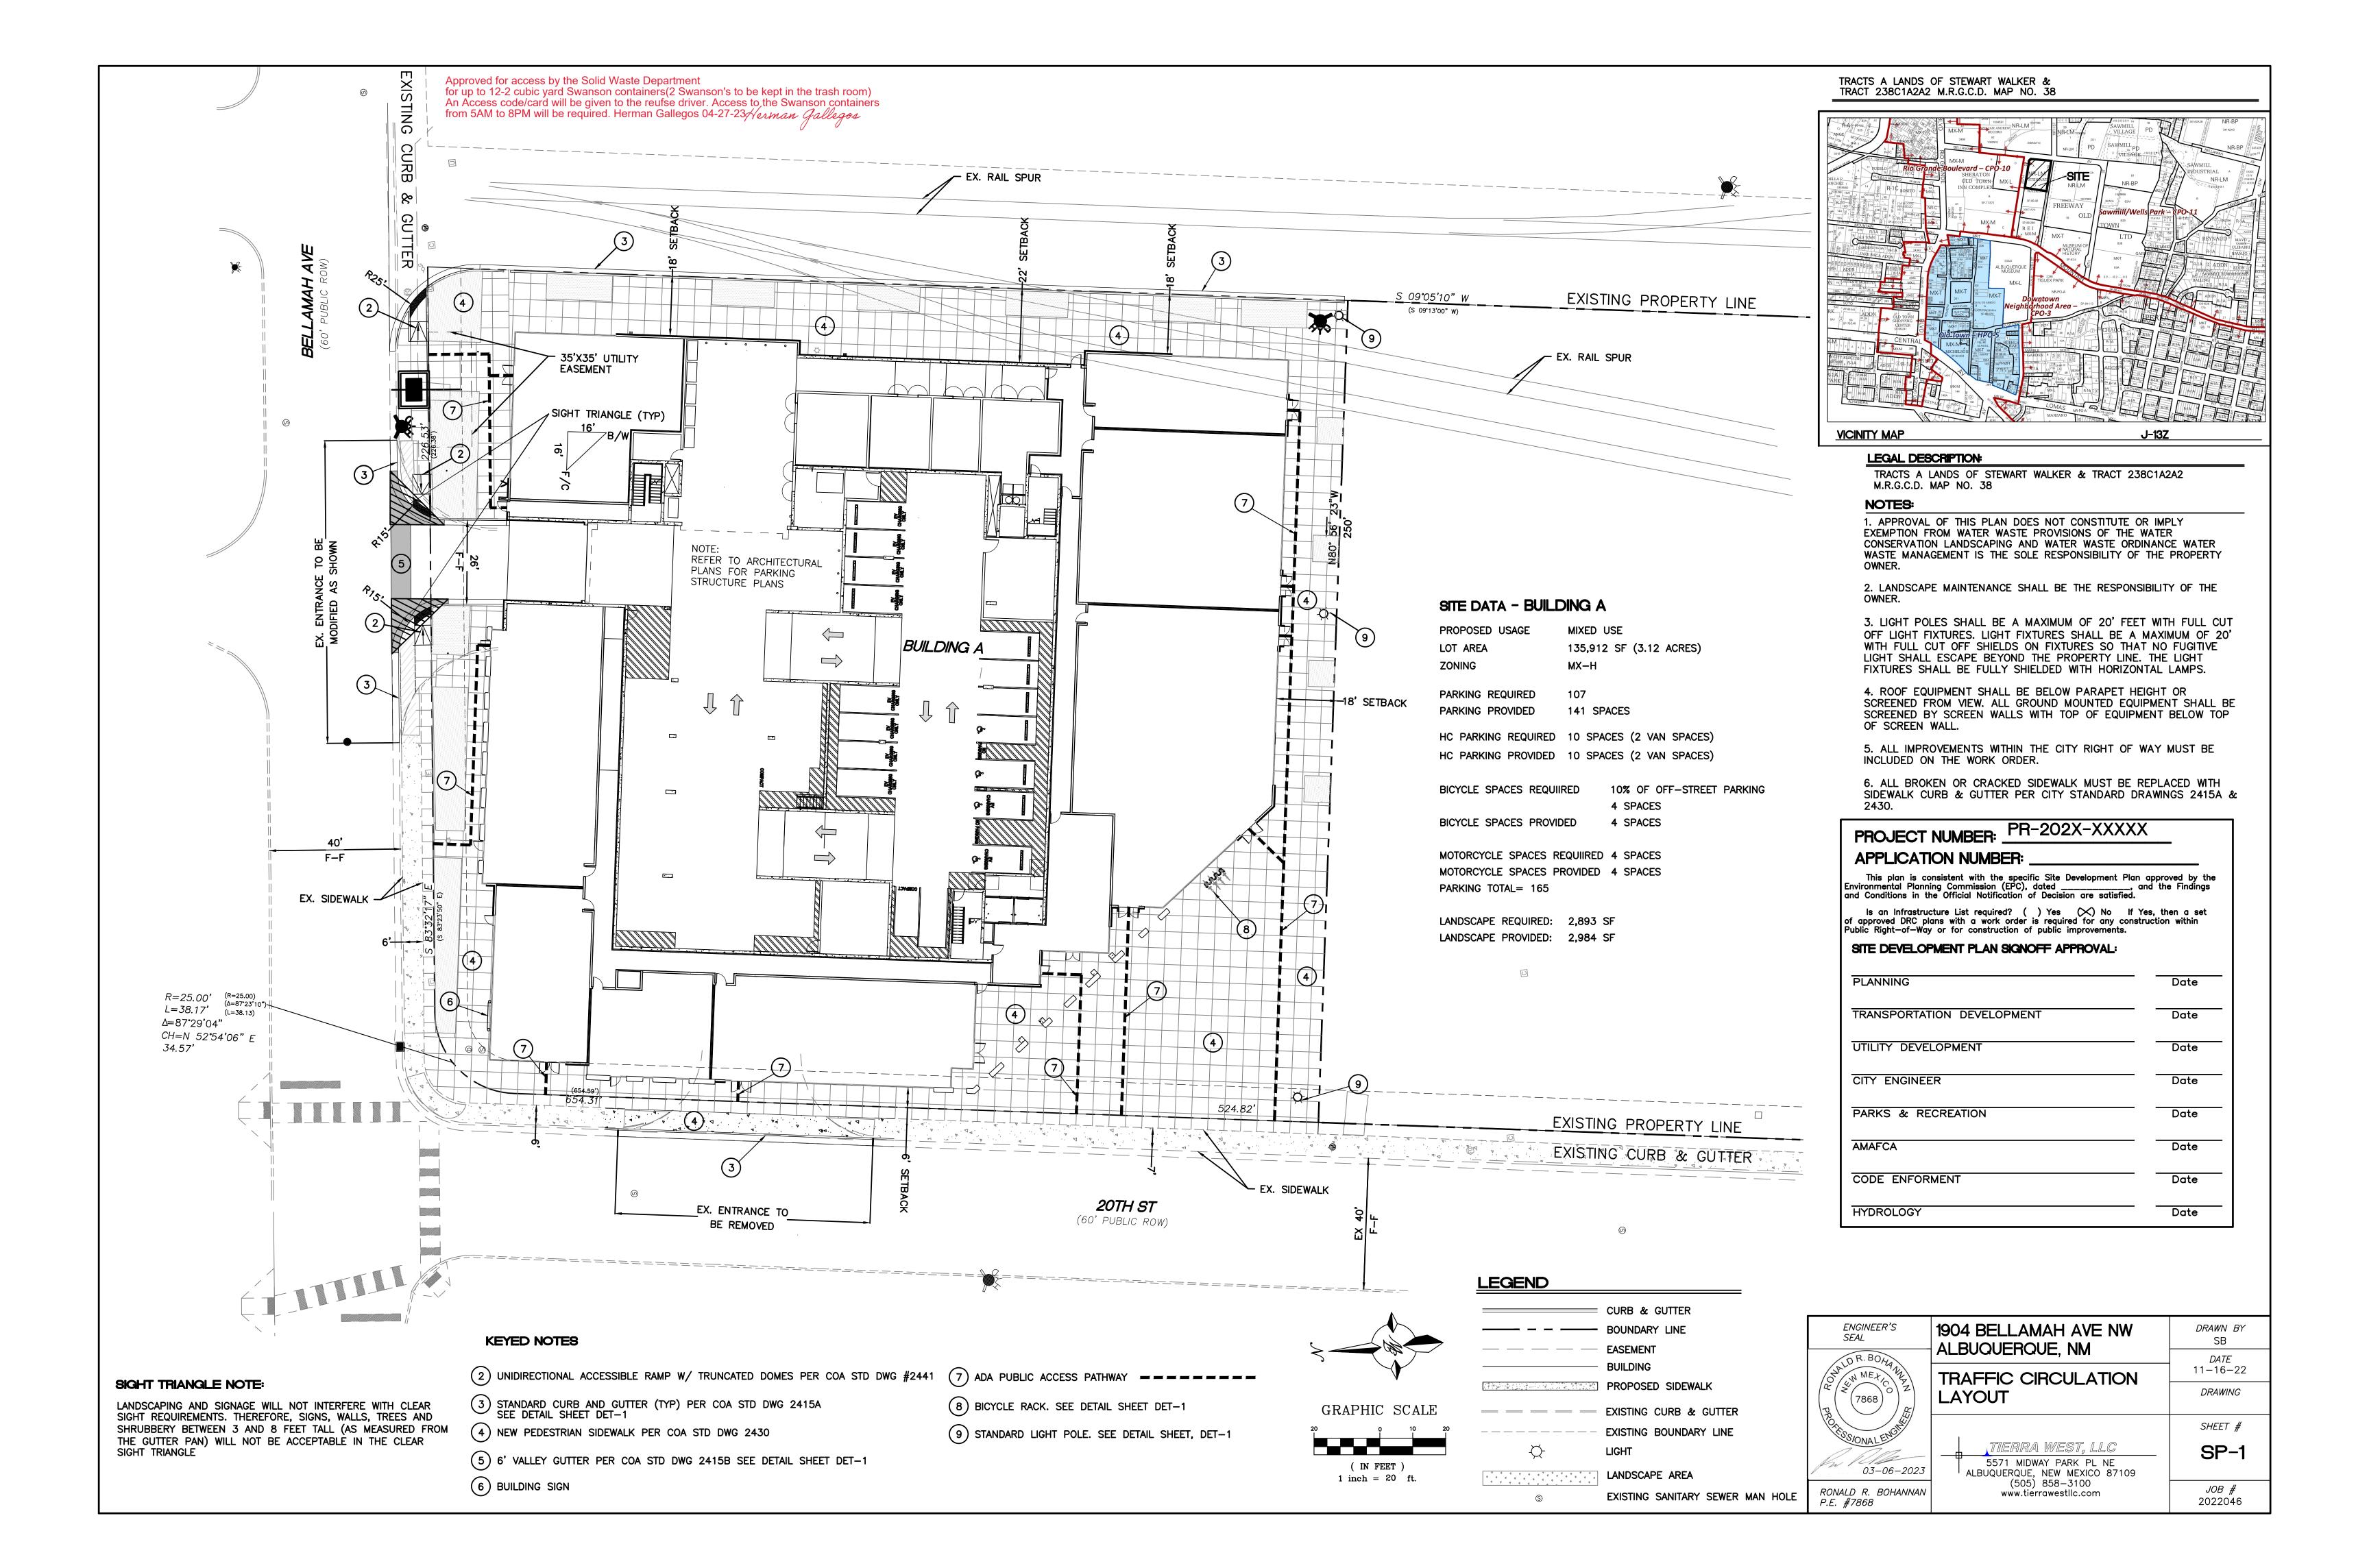



DESIGN ARCHITECT OFFICEUNTITLED 4200 SEPULVEDA BLVD, STE 104, CULVER CITY, CA 90230 P.310.730.6698

# SAWMILL (LOT A)

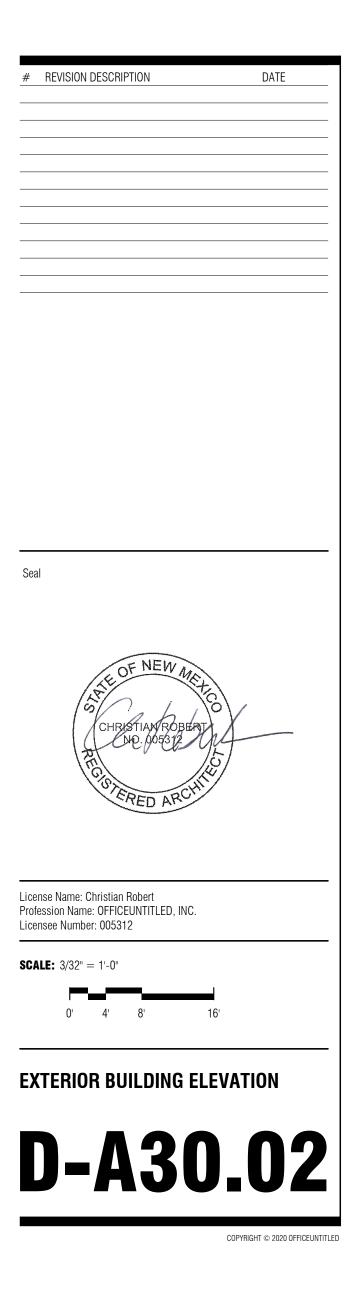1904 BELLAMAH AVE NW ALBUQUERQUE NM 87104





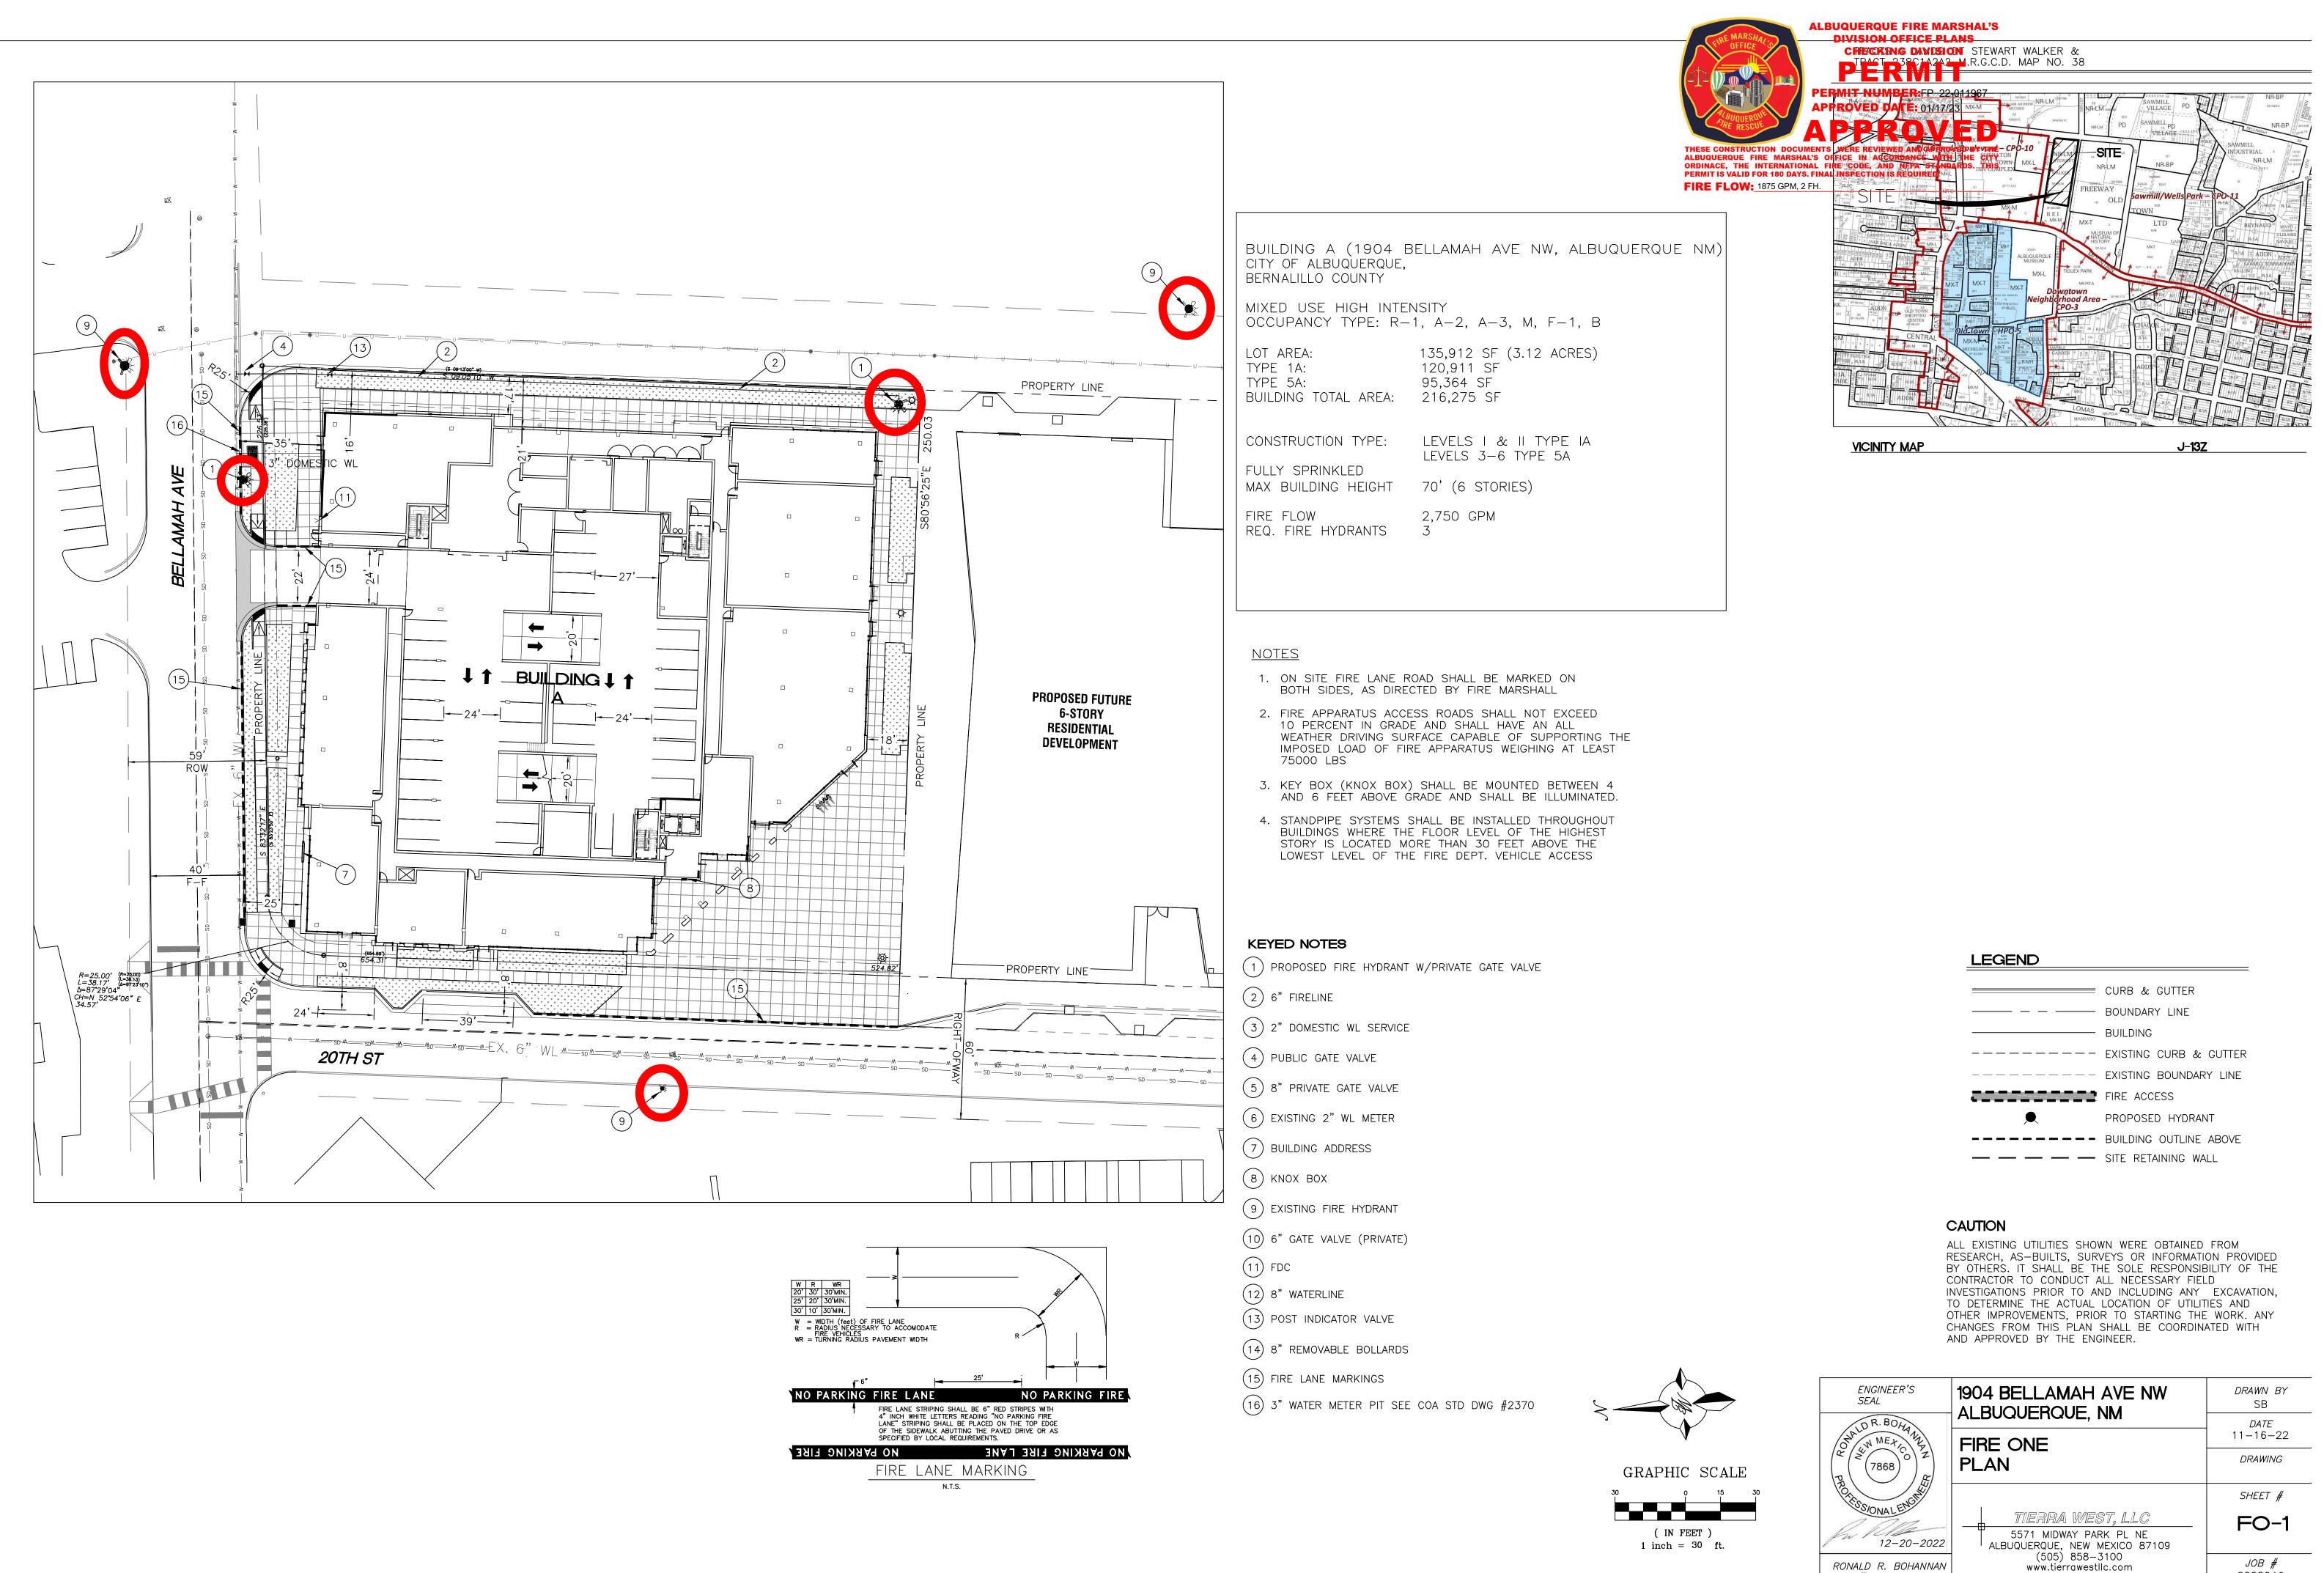

	CURB & GUTTER
	BOUNDARY LINE
	BUILDING
	EXISTING CURB & GUTTER
	EXISTING BOUNDARY LINE
	FIRE ACCESS
<b>A</b>	PROPOSED HYDRANT
	BUILDING OUTLINE ABOVE
	SITE RETAINING WALL

	ENGINEER'S SEAL	1904 BELLAMAH AVE NW ALBUQUERQUE, NM	DRAWN BY SB
· · · · · · · · · · · · · · · · · · ·	NALD R. BOHA		<i>DATE</i> 1116_22
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	RONALD R. BOHANNAN P.E. #7868	(505) 858-3100 www.tierrawestllc.com	<i>JOB #</i> 2022046

## PR-2022-007153\_SI-2023-01646\_Site\_Plan\_Ap proved\_4-11-24\_Sheet\_1

**Final Audit Report** 

2024-05-30

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