

The Zone Districts and Overlay Zones
are established by the
Integrated Development Ordinance (IDO).

Gray Shading
Represents Area Outside
of the City Limits

Petroglyph National Monument

Airport Protection Overlay (APO) Zone Character Protection Overlay (CPO) Zone Historic Protection Overlay (HPO) Zone

> View Protection Overlay (VPO) Zone Feet 0 250 500 1,000

Areas Outside of City Limits



SAWMILL (LOT H)
1921 Bellamah Ave NW, Albuquerque, NM 87104

ZONING CODE INFORMATION PROJECT INFO PROJECT ADDRESS 1921 BELLAMAH AVE NW, ALBURQUERQUE, NM 87104 LEGAL DESCRIPTION TR A-2 PLAT OF TRACTS A-1, A-2 AND A-3 LANDS OF WILLIAMANDREW MCCORD CONT 2.0290 AC 101305817952322307 ZONE ATLAS PAGE H13, J13 CURRENT IDO ZONING NR-LM (LIGHT MANUFACTURING) MX-H (MIXED USE HIGH INTENSITY) NEW IDO ZONING 2.029 ACRES / 88,383 S.F. OWNERSHIP TYPE PROPOSED BUILDING AREA 134,709 GSF (BC), 120,709 GSF(IDO) SETBACKS 5' MINIMUM 0' MINIMUM (INTERIOR) 15' MINIMUM *IDO TABLE 2-4-7 ALLOWABLE HEIGHT MAXIMUM HEIGHT PROPOSED HEIGHT 68'-0" UNLIMITED >100' FROM ALL LOT LINES
*IDO TABLE 2-4-7

ISSUE FOR:

DEVELOPMENT REVIEW BOARD SUBMITTAL

PROJECT TEAM

10.730.6698

SAWMILL BELLAMAH PROPERTIES, LCC. 201 THIRD STREET NW, SUITE 1150 ALBUQUERQUE, NM 87102 ARCHITECT: OU DESIGN + ARCHITECTURE, INC. 4200 SEPULVEDA BOULEVARD, SUITE 104 CULVER CITY, CA 90230

STRUCTURAL ENGINEER: KURT FISCHER STRUCTURAL ENGINEERING 17547 VENTURA BLVD. SUITE 302 ENCINO, CA, 91316 818.874.1445

MEP ENGINEER: 2901 CLINT MOORE ROAD #114 BOCA RATON, FL 33496 888.901.8008 CIVIL ENGINEER: TIERRA WEST 5771 MIDWAY PARK PL NE

ALBUQUERQUE, NM 87109 505.858.3100 LANDSCAPE ARCHITECT: 1102 MOUNTAIN ROAD NW, STE 201 ALBUQUERQUE, NM 87102

505.268.2266

PROJECT SUMMARY

THE PROPOSED PROJECT INVOLVES THE REMOVAL OF THE EXISTING BUILDING AND RELATED STRUCTURES ON SITE FOR THE CONSTRUCTION OF A NEW 5-STORY HOSPITALITY PROJECT AT 1921 BELLAMAH AVE IN ALBUQUERQUE. THE NEW BUILDING INCLUDES 115 GUEST ROOMS, LEASEABLE COMMERCIAL RETAIL SPACE, FUTURE GROUND FLOOR RESTAURANT WITH OPEN KITCHEN LAYOUT, MEETING ROOM, AND A ROOFTOP BAR/LOUNGE WITH OUTDOOR TERRACE.



SAWMILL (LOT H)

OU PROJECT NO: 21.002.000

1921 Bellamah Ave NW, Albuquerque, NM


OFFICEUNTITLED AR 4200 SEPULVEDA BLVD, STE 104, CULVER CITY, CA 90230 P.310.730.6698


REVISION DESCRIPTION

License Name: Christian Robert Profession Name: OFFICEUNTITLED, INC. Licensee Number: LOT H DRB

COVER SHEET

D-A.00.00

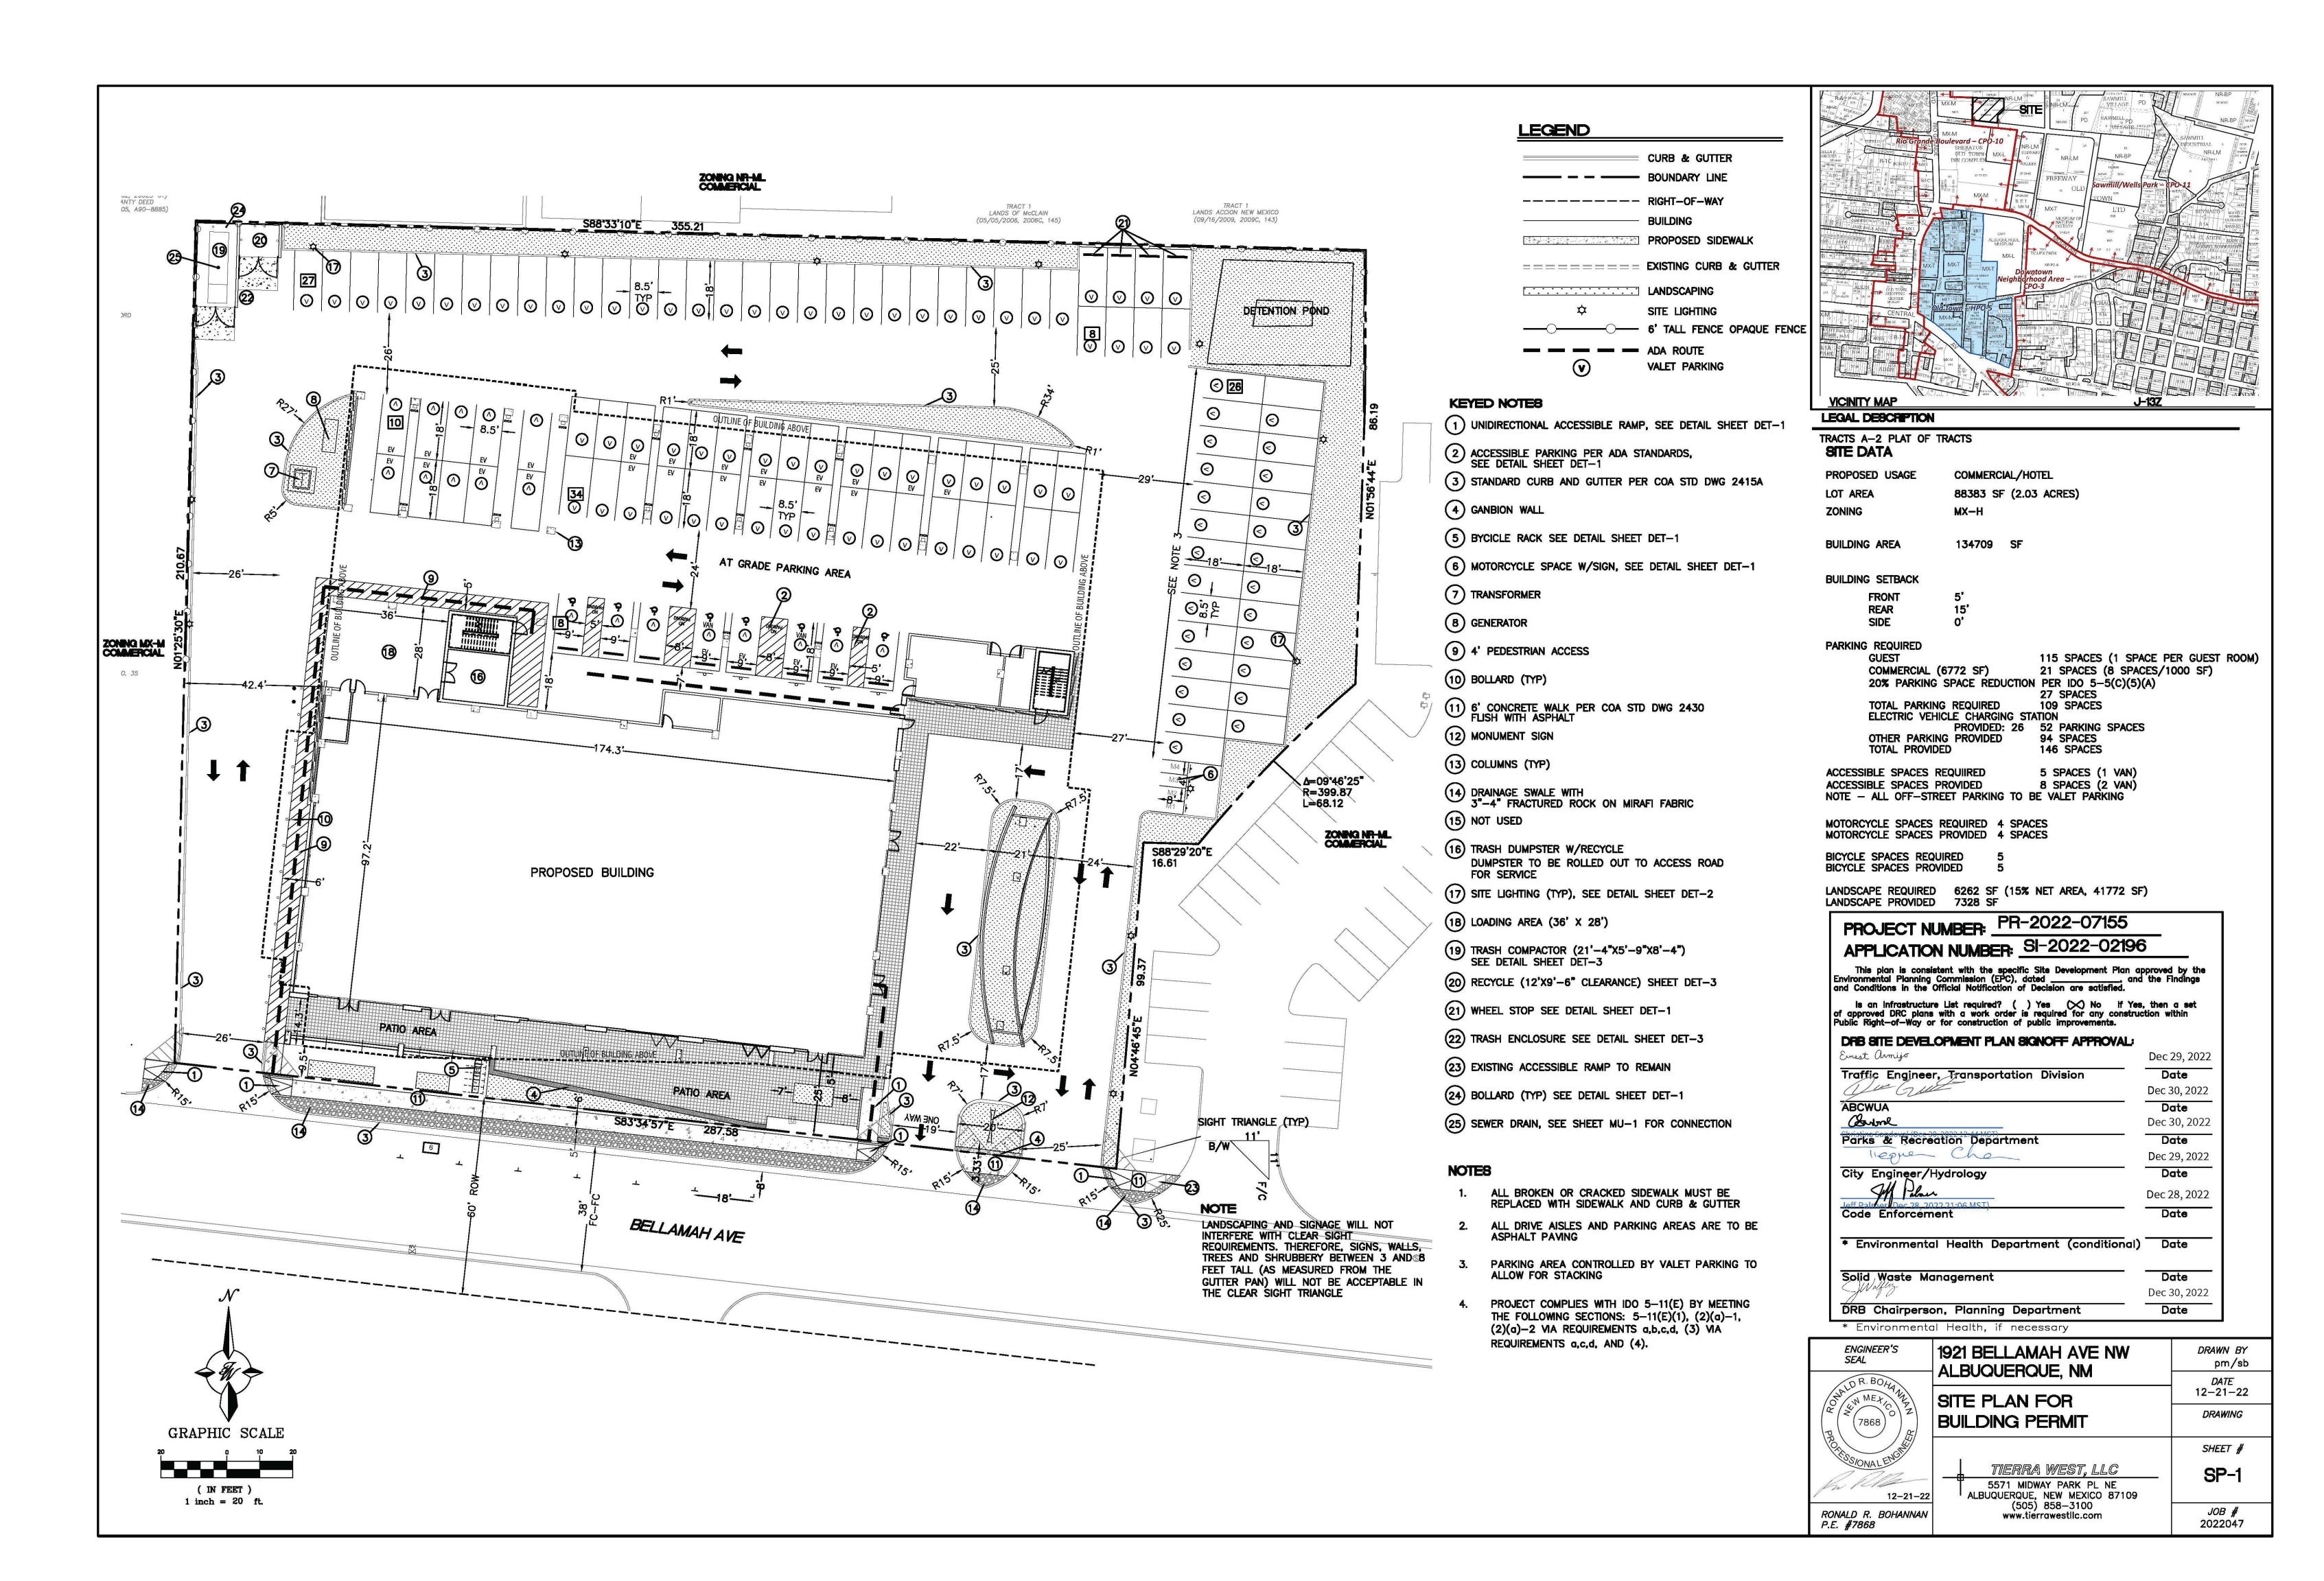

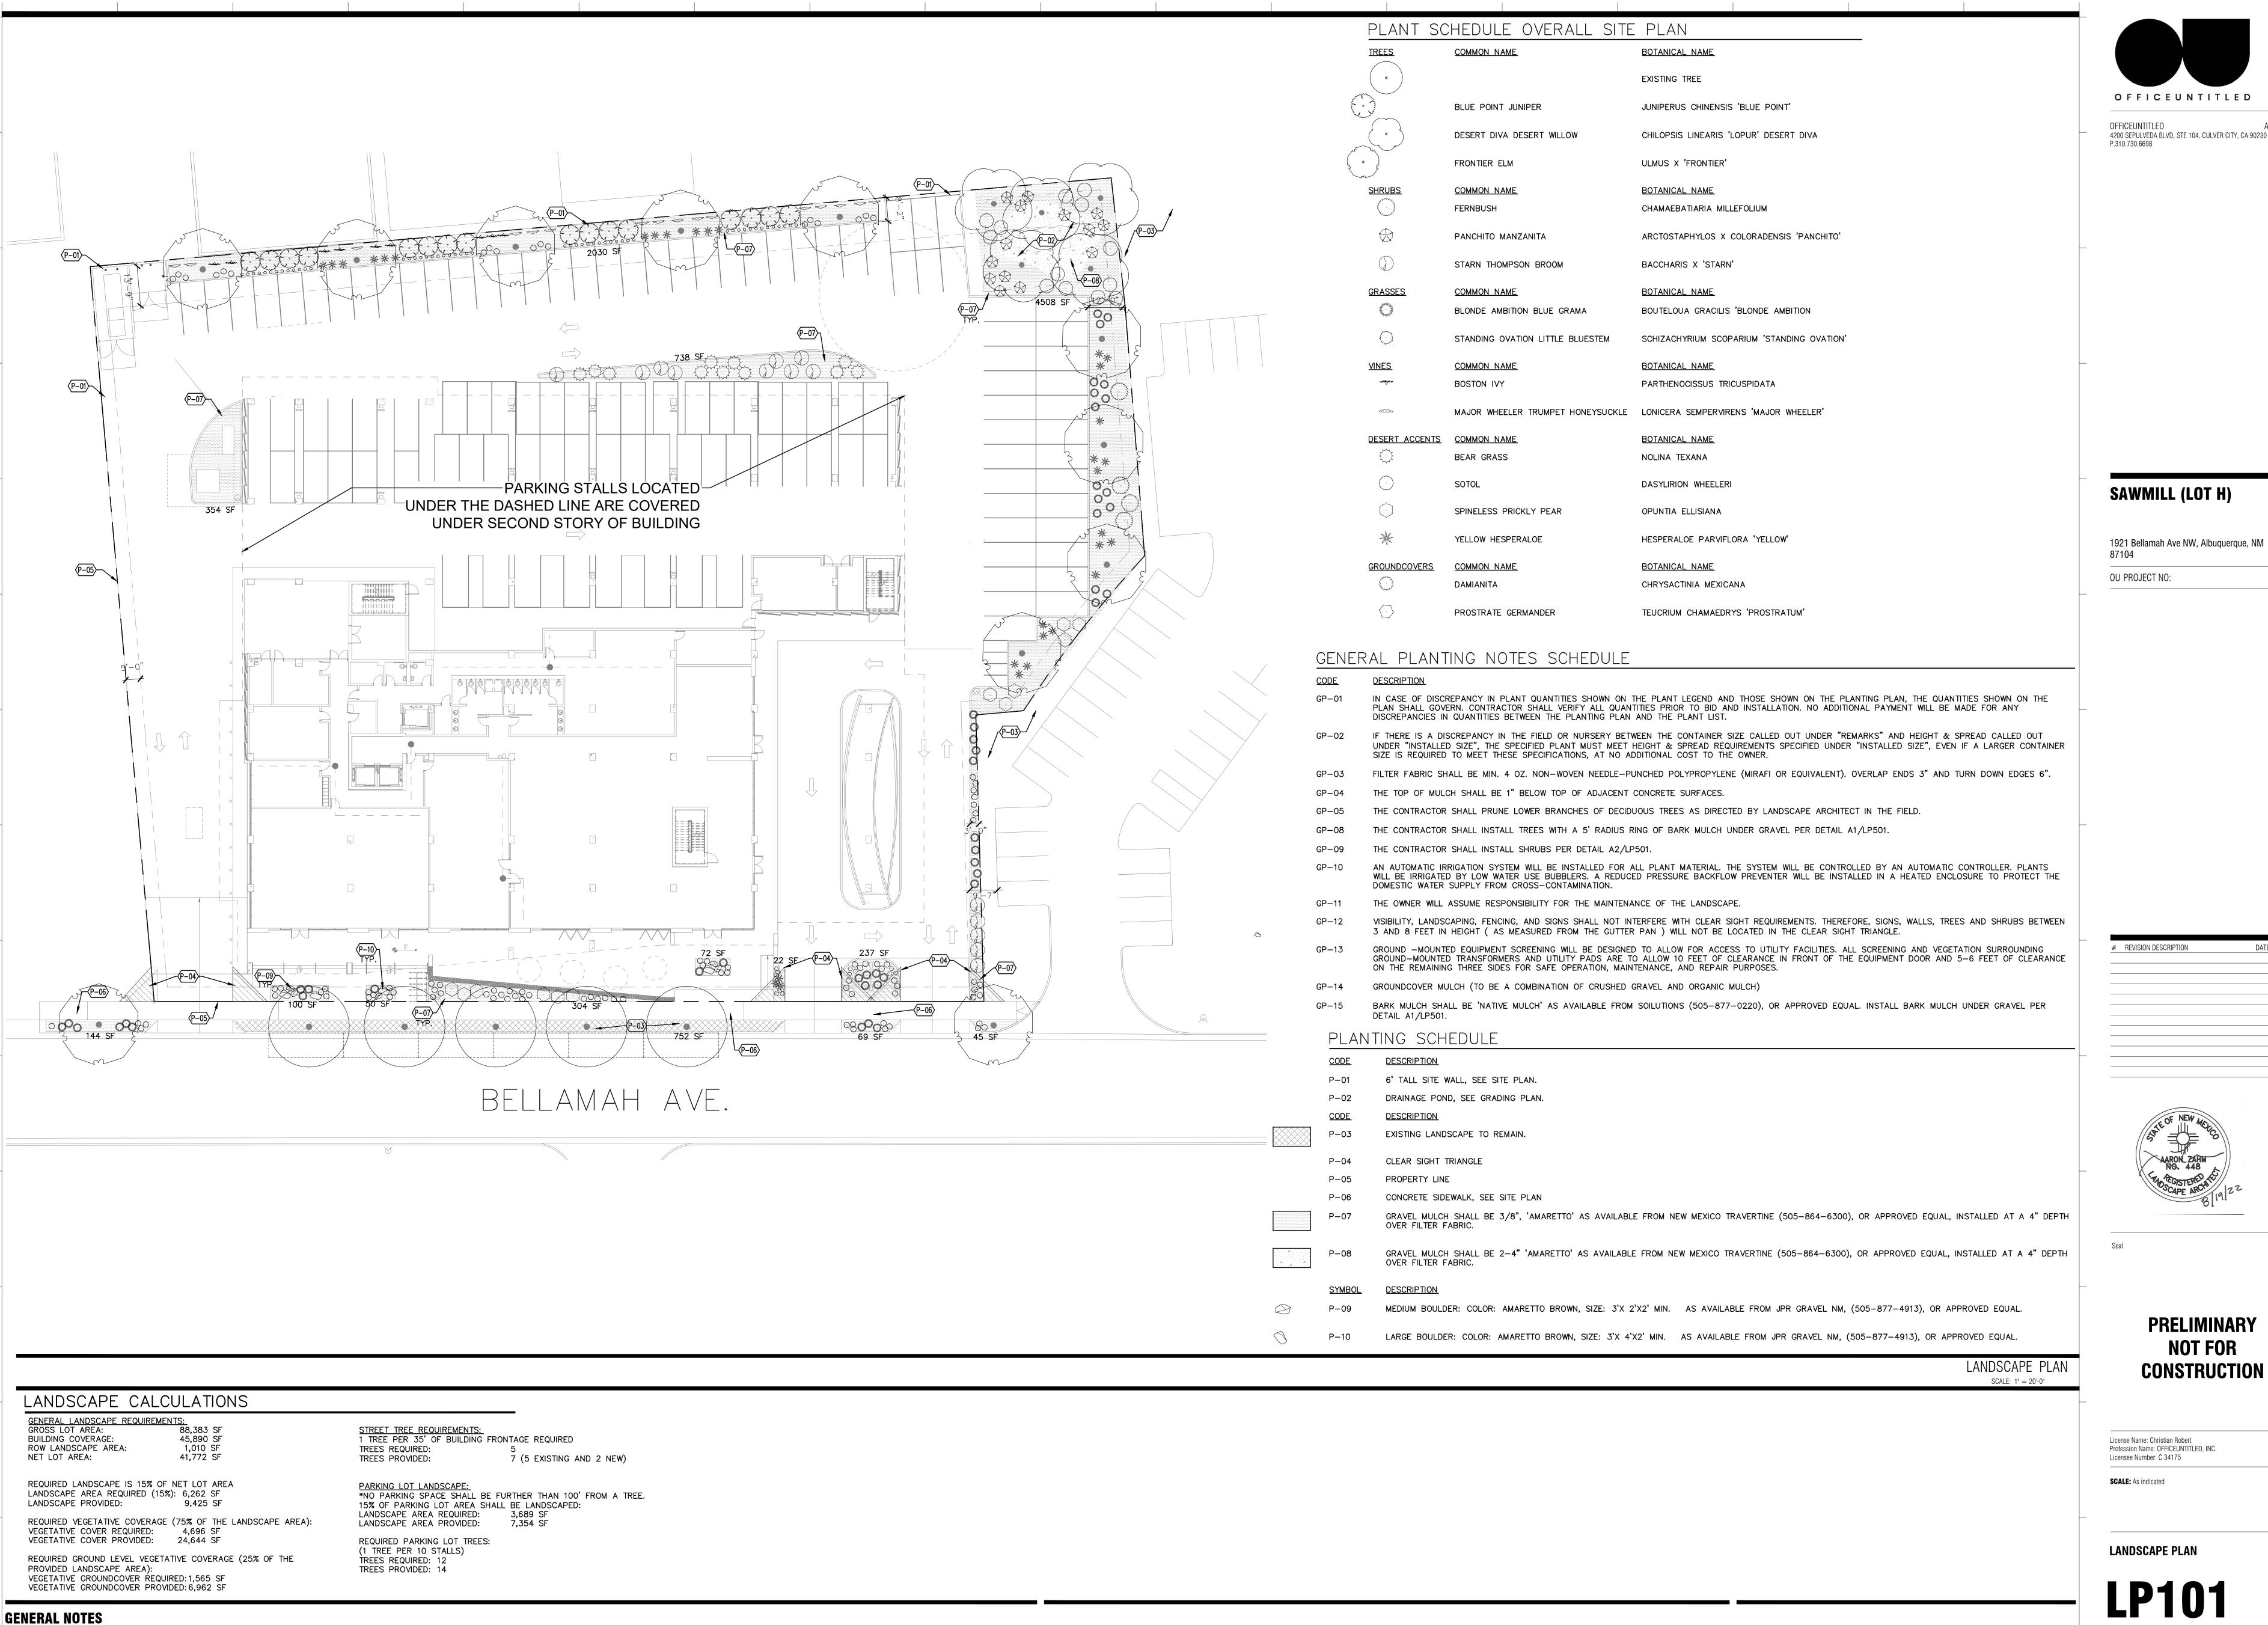



OFFICEUNTITLED ARCHITECT 4200 SEPULVEDA BLVD, STE 104, CULVER CITY, CA 90230 P.310.730.6698

SAWMILL (LOT H)

1921 Bellamah Ave NW, Albuquerque, NM

OU PROJECT NO:


PRELIMINARY NOT FOR

License Name: Christian Robert


Profession Name: OFFICEUNTITLED, INC. Licensee Number: C 34175

SCALE: As indicated

LANDSCAPE PLAN

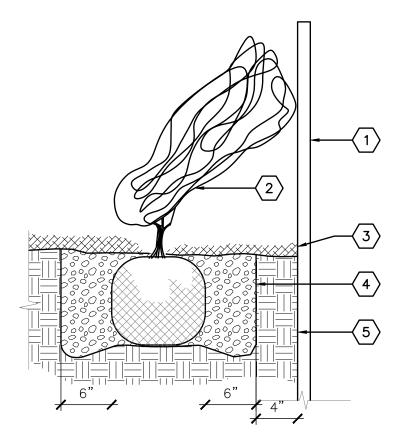


- VERTICAL STRUCTURE SEE PLANS.
 VINE SEE PLANTING PLANS.
- 3. 4"-DEPTH MULCH THROUGHOUT SHRUB BED
- UNLESS OTHERWISE NOTED ON PLANS.
- 4. BACKFILL AND SOIL AMENDMENTS SEE SPECIFICATIONS. 5. SUBGRADE COMPACTED TO 95%.

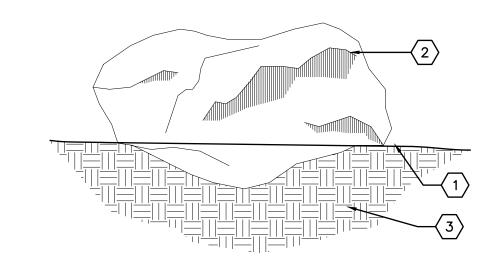


FINISH GRADE (MATERIAL VARIES) — BOULDER SHALL BE BURIED TO MIN 8"
DEPTH BELOW FINISH GRADE.
 BOULDER, SEE PLANS.
 SUBGRADE COMPACTED TO 95%.

ACCENT BOULDER

NOT TO SCALE

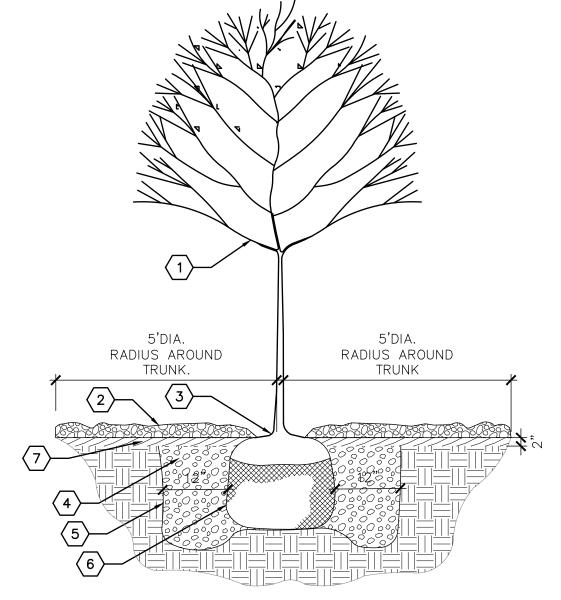

- 1. TREE LOCATION AND SPECIES PER PLAN.
- 2. GRAVEL MULCH. MULCH SHALL BE FEATHERED TO A 2" DEPTH ON TOP OF ROOT BALL AND SHALL BE HELD BACK 2" FROM TREE TRUNK.
- 3. REMOVE EXISTING SOIL (FROM NURSERY) AS NEEDED TO EXPOSE ROOT FLARE. INSTALL WITH ROOT FLARE FLUSH WITH SUB-GRADE (BOTTOM OF MULCH). 4. BACKFILL AND SOIL AMENDMENTS (SEE SPECIFICATIONS). THOROUGHLY MIX
- BACKFILL AND AMENDMENTS PRIOR TO INSTALLATION. 5. SCARIFY EDGE OF PLANTING HOLE, CONTINUOUS ALL SIDES.
- 6. REMOVE WIRE BASKET, WOOD BOX, PLASTIC TWINE, AND/OR ROPE PRIOR TO BACKFILL. REMOVE BURLAP EXCEPT FROM BOTTOM OF ROOT BALL.
- 7. INSTALL WOOD BARK MULCH AT 5' DIAMETER RADIUS AROUND TREE TRUNK.
- TREE PLANTING NOT TO SCALE

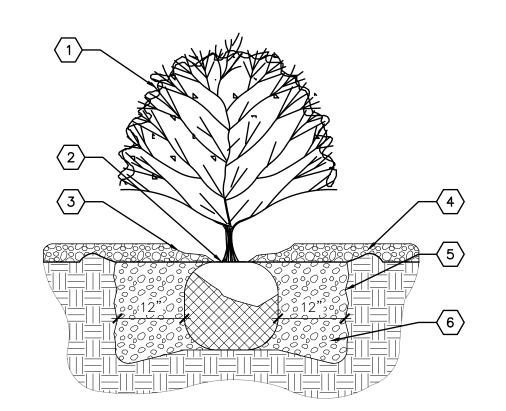

- SHRUB LOCATION AND SPECIES AS PER PLAN.
 PLANT AT SAME DEPTH MAINTAINED AT NURSERY.
- PLANT AT SAME DEPTH MAINTAINED AT NORSERT.
 FEATHER MULCH TO A 2" DEPTH ON TOP OF ROOT BALL AND HOLD BACK 2" FROM SHRUB STEM(S).
 GRAVEL MULCH.
 SCARIFY EDGE OF PLANTING HOLE, CONTINUOUS ALL SIDES.
 BACKFILL AND SOIL AMENDMENTS (SEE SPECIFICATIONS).
- SHRUB PLANTING

 NOT TO SCALE

| PLANT SC | HED | ULE | | | | | | |
|--|------------|-----------------------------------|--|----------------|-------------|-------------|--------------|-------------------------|
| TREES. | QTY | COMMON NAME | BOTANICAL NAME | <u>REMARKS</u> | HT. | SPD. | WATER USE | DECIDUOUS/ EVERGREEN |
| • | 5 | | EXISTING TREE | EXISTING | | | LOW | DECIDUOUS |
| | 16 | BLUE POINT JUNIPER | JUNIPERUS CHINENSIS 'BLUE POINT' | 6' HT. | 12' | 8' | LOW | EVERGREEN |
| NO CONTRACTOR OF THE PARTY OF T | 5 | DESERT DIVA DESERT WILLOW | CHILOPSIS LINEARIS 'LOPUR' DESERT DIVA | 36" BOX | 30 ʻ | 30 ' | LOW | DECIDUOUS |
| 2 m | 11 | FRONTIER ELM | ULMUS X 'FRONTIER' | 2" CAL. | 30 ʻ | 30 ʻ | MEDIUM | EVERGREEN |
| SHRUBS. | <u>QTY</u> | COMMON NAME | BOTANICAL NAME | <u>REMARKS</u> | <u>HT.</u> | SPD. | | |
| (·) | 4 | FERNBUSH | CHAMAEBATIARIA MILLEFOLIUM | 5 GAL. | 6' | 6' | LOW | DECIDUOUS |
| | 14 | PANCHITO MANZANITA | ARCTOSTAPHYLOS X COLORADENSIS 'PANCHITO' | 3 GAL. | 2' | 5' | LOW | EVERGREEN |
| | 14 | STARN THOMPSON BROOM | BACCHARIS X 'STARN' | 5 GAL. | 4' | 5' | LOW | EVERGREEN |
| <u>GRASSES</u> | QTY | COMMON NAME | BOTANICAL NAME | <u>REMARKS</u> | <u>HT.</u> | SPD. | | |
| Manual Commence of the Commenc | 47 | BLONDE AMBITION BLUE GRAMA | BOUTELOUA GRACILIS 'BLONDE AMBITION | 3 GAL. | 3' | 3' | LOW | DECIDUOUS |
| 0 | 52 | STANDING OVATION LITTLE BLUESTEM | SCHIZACHYRIUM SCOPARIUM 'STANDING OVATION' | 1 GAL. | 4' | 1' | LOW | DECIDUOUS |
| <u>VINES</u> | QTY | COMMON NAME | BOTANICAL NAME | <u>REMARKS</u> | HT. | SPD. | | |
| -sologyar- | 9 | BOSTON IVY | PARTHENOCISSUS TRICUSPIDATA | 1 GAL. | 15' | 15' | MEDIUM | DECIDUOUS |
| - 3 8880 - | 5 | ENGLISH IVY | HEDERA HELIX | 1 GAL. | 15' | 15' | MEDIUM | EVERGREEN |
| | 16 | MAJOR WHEELER TRUMPET HONEYSUCKLE | LONICERA SEMPERVIRENS 'MAJOR WHEELER' | 5 GAL. | 10' | 10' | LOW | DECIDUOUS |
| DESERT ACCENTS | QTY | COMMON NAME | BOTANICAL NAME | <u>REMARKS</u> | HT. | SPD. | | |
| ************************************** | 11 | BEAR GRASS | NOLINA TEXANA | 5 GAL. | 4' | 5' | LOW | EVERGREEN |
| \odot | 13 | SOTOL | DASYLIRION WHEELERI | 5 GAL. | 6' | 5' | LOW | EVERGREEN |
| | 12 | SPINELESS PRICKLY PEAR | OPUNTIA ELLISIANA | 5 GAL. | 4' | 6' | LOW | EVERGREEN |
| EW. | 52 | TWISTLEAF YUCCA | YUCCA RUPICOLA | 3 GAL. | 2' | 3' | LOW | EVERGREEN |
| * | 32 | YELLOW HESPERALOE | HESPERALOE PARVIFLORA 'YELLOW' | 3 GAL. | 4' | 4' | LOW | EVERGREEN |
| <u>GROUNDCOVERS</u> | <u>QTY</u> | COMMON NAME | BOTANICAL NAME | <u>REMARKS</u> | <u>HT.</u> | SPD. | | |
| de la company | 202 | DAMIANITA | CHRYSACTINIA MEXICANA | 1 GAL. | 2' | 2' | LOW | EVERGREEN |
| | 12 | PROSTRATE GERMANDER | TEUCRIUM CHAMAEDRYS 'PROSTRATUM' | 1 GAL. | 6" | 1'-6" | LOW | EVERGREEN |



OFFICEUNTITLED ARCHITECT 4200 SEPULVEDA BLVD, STE 104, CULVER CITY, CA 90230 P.310.730.6698

SAWMILL (LOT H)

1921 Bellamah Ave NW, Albuquerque, NM

OU PROJECT NO:

PRELIMINARY NOT FOR CONSTRUCTION


License Name: Christian Robert Profession Name: OFFICEUNTITLED, INC.

SCALE: As indicated

Licensee Number: C 34175

PLANTING DETAILS AND SCHEDULE

DETAILS AND PLANTING SCHEDULE

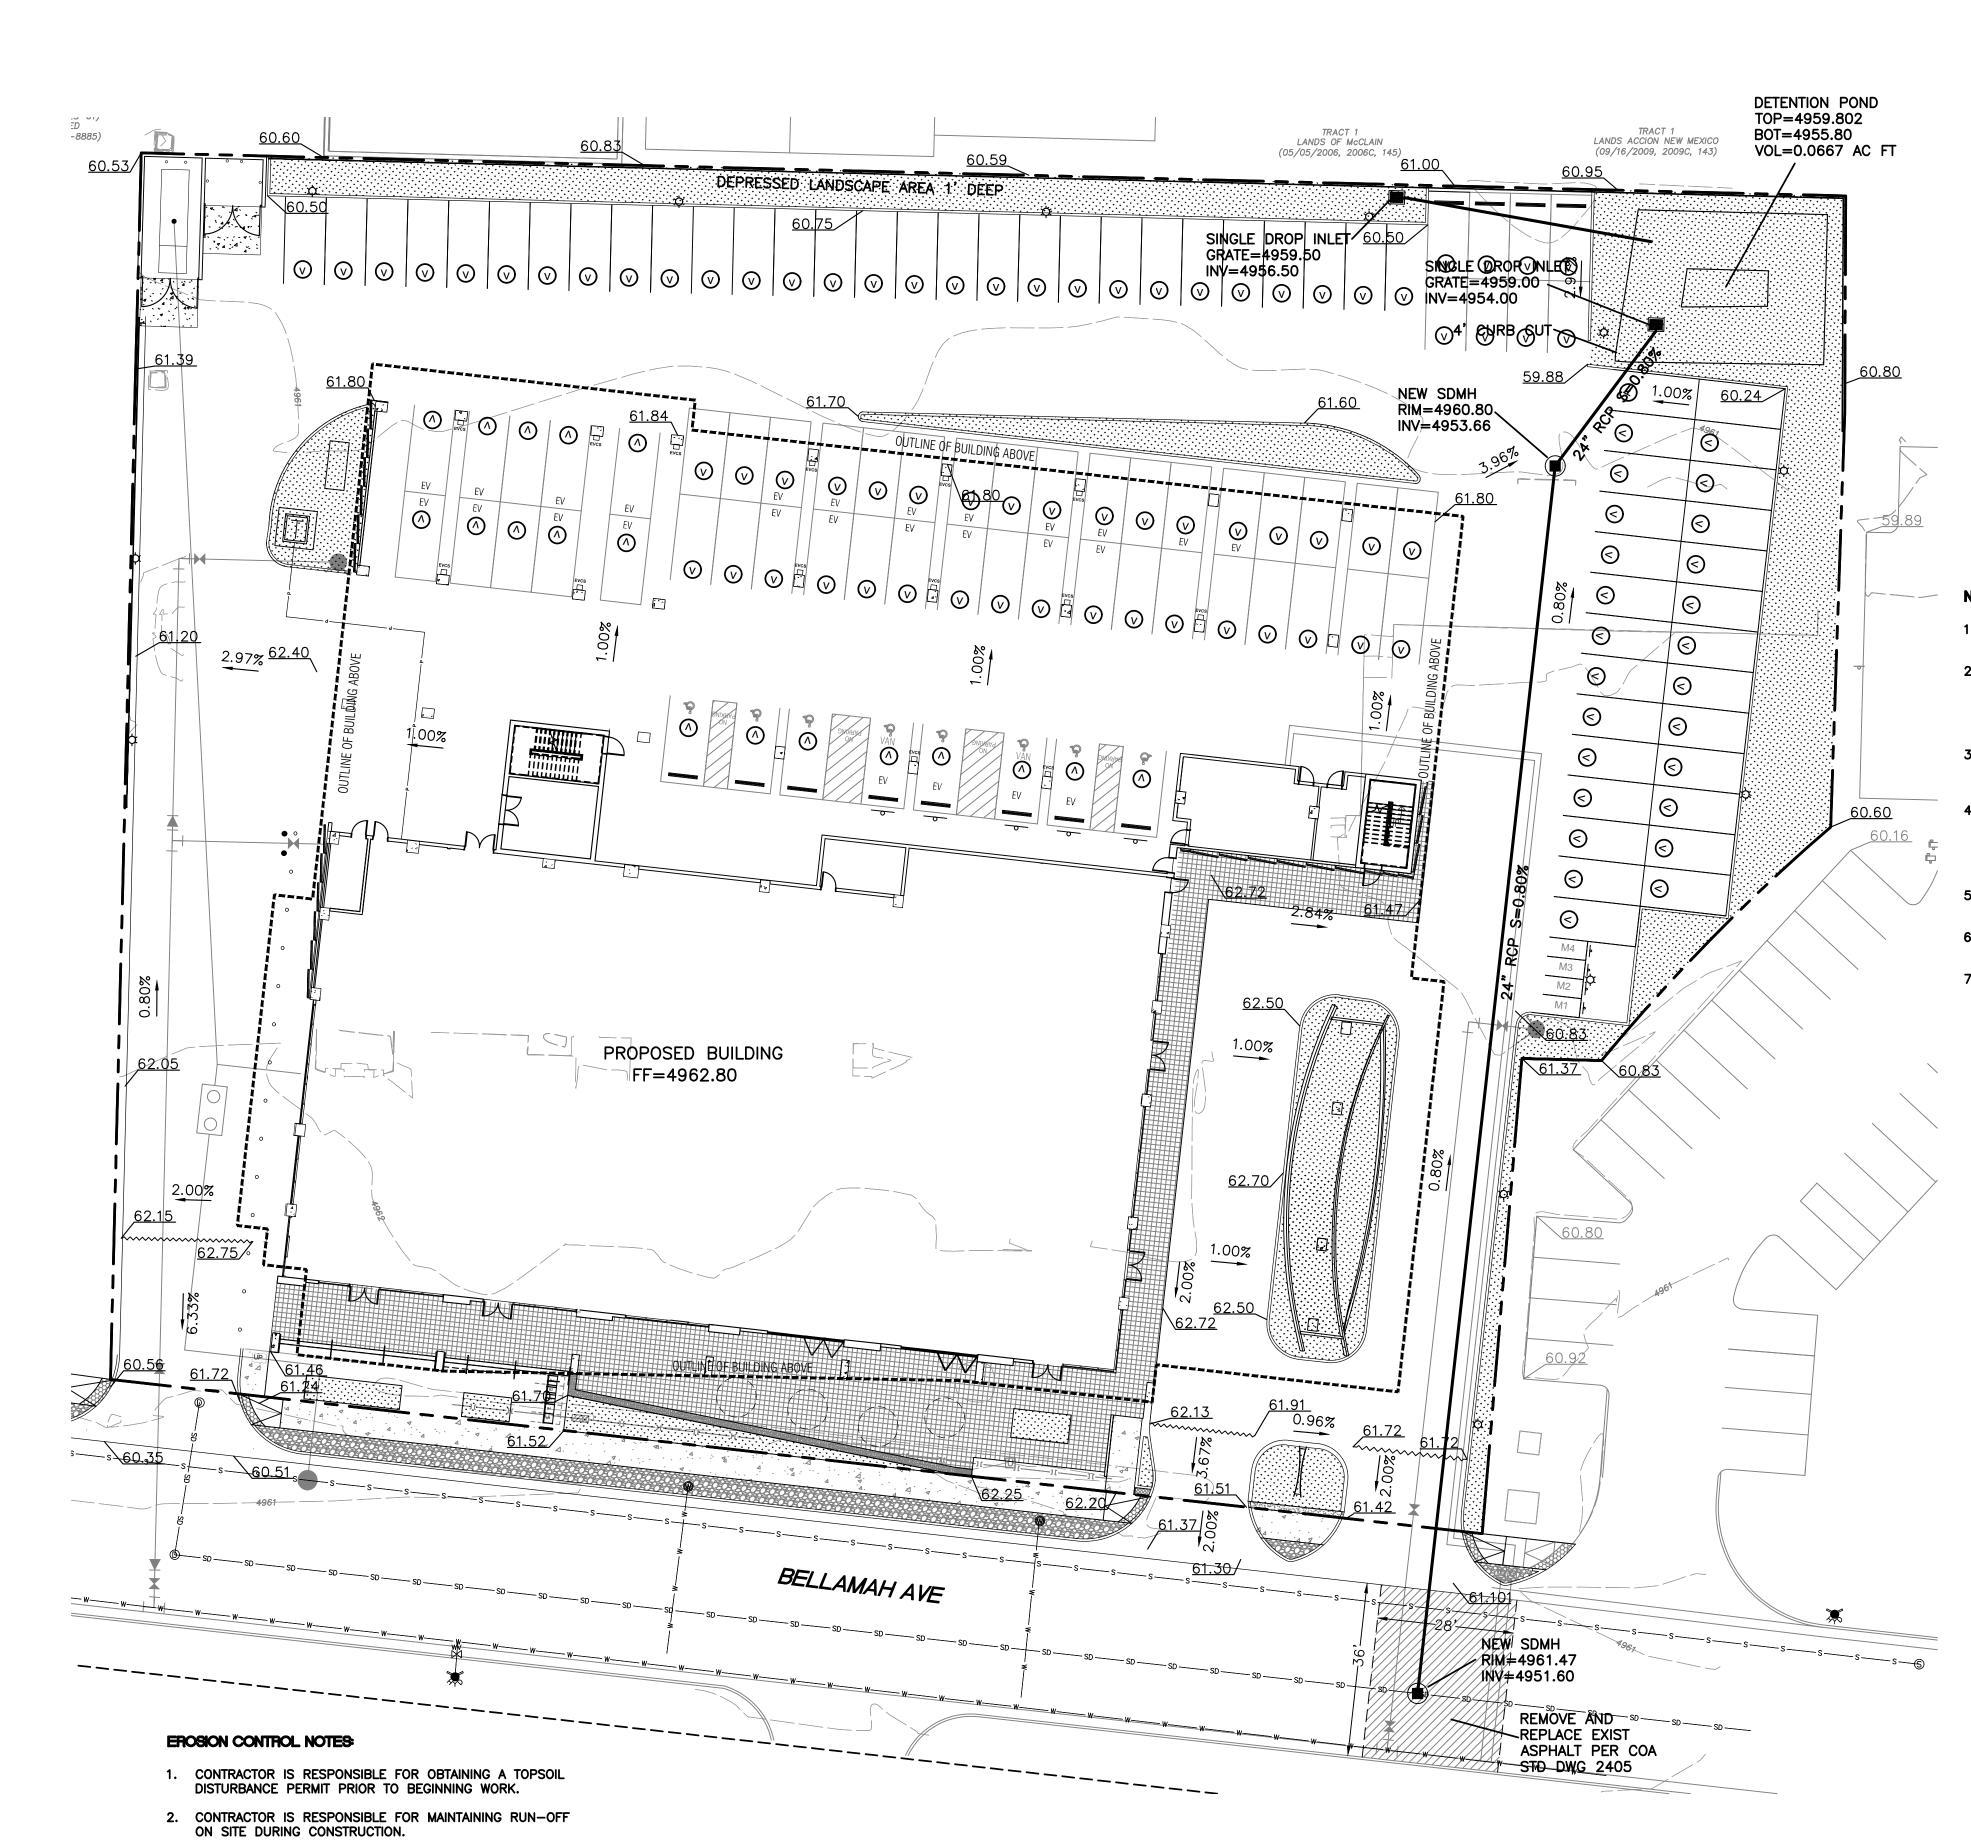

3. CONTRACTOR IS RESPONSIBLE FOR CLEANING ALL SEDIMENT

4. REPAIR OF DAMAGED FACILITIES AND CLEANUP OF SEDIMENT

FACILITIES IS THE RESPONSIBILITY OF THE CONTRACTOR.

5. ALL EXPOSED EARTH SURFACES MUST BE PROTECTED FROM

ACCUMULATIONS ON ADJACENT PROPERTIES AND IN PUBLIC


WIND AND WATER EROSION PRIOR TO FINAL (CITY) ACCEPTANCE

BE STABILIZED IN ACCORDANCE WITH COA SPECS OR 3" GRAVEL

6. ALL SLOPES NOT STABILIZED AT THE END OF THE PROJECT SHALL

THAT GETS INTO EXISTING RIGHT-OF-WAY.

OF ANY PROJECT.

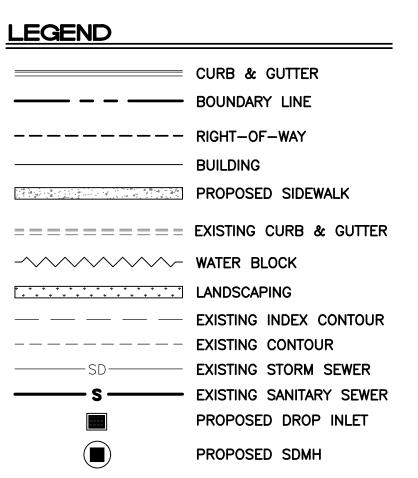

VICINITY MAP

NOTICE TO CONTRACTORS

- 1. AN EXCAVATION/CONSTRUCTION PERMIT WILL BE REQUIRED BEFORE BEGINNING ANY WORK WITHIN CITY RIGHT-OF-WAY.
- 2. ALL WORK DETAILED ON THESE PLANS TO BE PERFORMED, EXCEPT AS OTHERWISE STATED OR PROVIDED HERON, SHALL BE CONSTRUCTED IN ACCORDANCE WITH CITY OF ALBUQUERQUE INTERIM STANDARD SPECIFICATIONS FOR PUBLIC WORKS CONSTRUCTION, 1985.
- 3. TWO WORKING DAYS PRIOR TO ANY EXCAVATION, CONTRACTOR MUST CONTACT LINE LOCATING SERVICE, 765-1234, FOR LOCATION OF EXISTING UTILITIES.
- 4. PRIOR TO CONSTRUCTION, THE CONTRACTOR SHALL EXCAVATE AND VERIFY THE HORIZONTAL AND VERTICAL LOCATIONS OF ALL CONNECTIONS. SHOULD A CONFLICT EXIST, THE CONTRACTOR SHALL NOTIFY THE ENGINEER SO THAT THE CONFLICT CAN BE RESOLVED WITH A MINIMUM AMOUNT OF DELAY.
- 5. BACKFILL COMPACTION SHALL BE ACCORDING TO TRAFFIC/STREET
- 6. MAINTENANCE OF THESE FACILITIES SHALL BE THE RESPONSIBILITY OF THE OWNER OF THE PROPERTY SERVED.
- 7. WORK ON ARTERIAL STREETS SHALL BE PERFORMED ON A 24-HOUR

AREA WITH REDUCED FLOOD RISK DUE TO LEVEE FLOOD MAP 35001C0331H


EXISTING DRAINAGE:


THIS SITE IS CURRENTLY A WAREHOUSE WITH PAVED PARKING IN FRONT AND GRAVEL PARKING IN THE BACK. THE SITE IS BOUNDED BY COMMERCIAL BUILDINGS TO THE WEST, NORTH AND EAST AND BELLAMAH AVENUE TO THE SOUTH CONTAINING APPROXIMATELY 2.03 ACRES. THE SITE IS DIVIDED INTO 5 BASINS WITH BASIN A DISCHARGING 0.98 CFS TO BELLAMAH AVENUE. BASIN B DRAINS TO A STORM SEWER INLET THAT DRAINS TO THE EXISTING STORM SEWER IN BELLAMAH AVENUE. BASINS C, D AND E DRAIN TO THE GRAVEL PARKING AREA WHERE INFILTRATES THE GROUND AND EVAPORATES. THERE ARE NO OFFSITE FLOWS THAT ENTER THE SITE. THE SITE IS LOCATED ON FIRM MAP 35001C0331H AS SHOWN ABOVE. THE MAP SHOWS THAT THE SITE DOES NOT LIE WITHIN ANY 100 YEAR FLOOD PLAIN. THE SITE GENERATES A TOTAL OF 8.13 CFS WITH A 100YR, 6-HR VOLUME OF 0.337

PROPOSED DRAINAGE:

THE SITE IS NOW DIVIDED INTO TWO BASINS. BASIN 1 WILL DRAIN TO THE NORTH INTO A BIOSWALE AND A DETENTION POND OVER THE SURFACE. THE BIOSWALE WILL DRAIN TO THE POND SO THE WATER QUALITY VOLUME IS CAPTURED AND RETAINED. THE POND WILL DRAIN VIA A DROP INLET TO A STORM SEWER THAT WILL CONNECT TO THE STORM SEWER IN BELLAMAH. BASIN 2 IS THE FRONT PART OF THE BUILDING AND HARDSCAPE ALONG THE STREET. THIS BASIN WILL DISCHARGE 0.94 CFS TO BELLEMAH WHICH IS 0.04 CFS LESS THAN WAS WAS PREVIOUSLY DRAINED TO THE STREET. FROM THERE THE RUNOFF IS CAPTURED IN EXISTING DROP INLETS ALONG BELLAMAH AVE.

THE POND IN BASIN 2 WILL RETAIN THE DEVELOPED RUNOFF OF 0.036 AC-FT WHICH IS LESS THAN THE REQUIRED WATER QUALITY VOLUME OF 0.40 AC-FT. THE POND WILL DRAIN AT RATE OF 7.15 CFS. THEREFORE THE TOTAL DISCHARGE FROM THE SITE WILL BE 8.09 CFS WHICH IS BELOW THE EXISTING DISCHARGE OF 8.13 CFS.

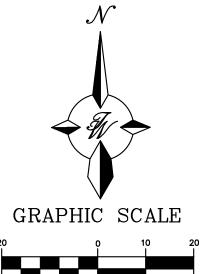

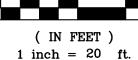

DRAWN BY

pm

DATE

10-26-22

DRAWING

SHEET #


GR-1

JOB #

2022047

CAUTION


ALL EXISTING UTILITIES SHOWN WERE OBTAINED FROM RESEARCH, AS-BUILTS, SURVEYS OR INFORMATION PROVIDED BY OTHERS. IT SHALL BE THE SOLE RESPONSIBILITY OF THE CONTRACTOR TO CONDUCT ALL NECESSARY FIELD INVESTIGATIONS PRIOR TO AND INCLUDING ANY EXCAVATION, TO DETERMINE THE ACTUAL LOCATION OF UTILITIES AND OTHER IMPROVEMENTS, PRIOR TO STARTING THE WORK. ANY CHANGES FROM THIS PLAN SHALL BE COORDINATED WITH AND APPROVED BY THE ENGINEER.

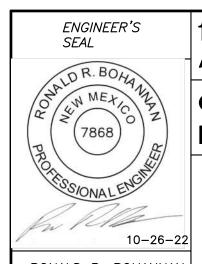


1921 BELLAMAH AVE NW ALBUQUERQUE, NM **CONCEPTUAL GRADING** PLAN

TIERRA WEST, LLC 5571 MIDWAY PARK PL NE ALBUQUERQUE, NEW MEXICO 87109 (505) 858-3100 www.tierrawestllc.com

RONALD R. BOHANNAN P.E. #7868

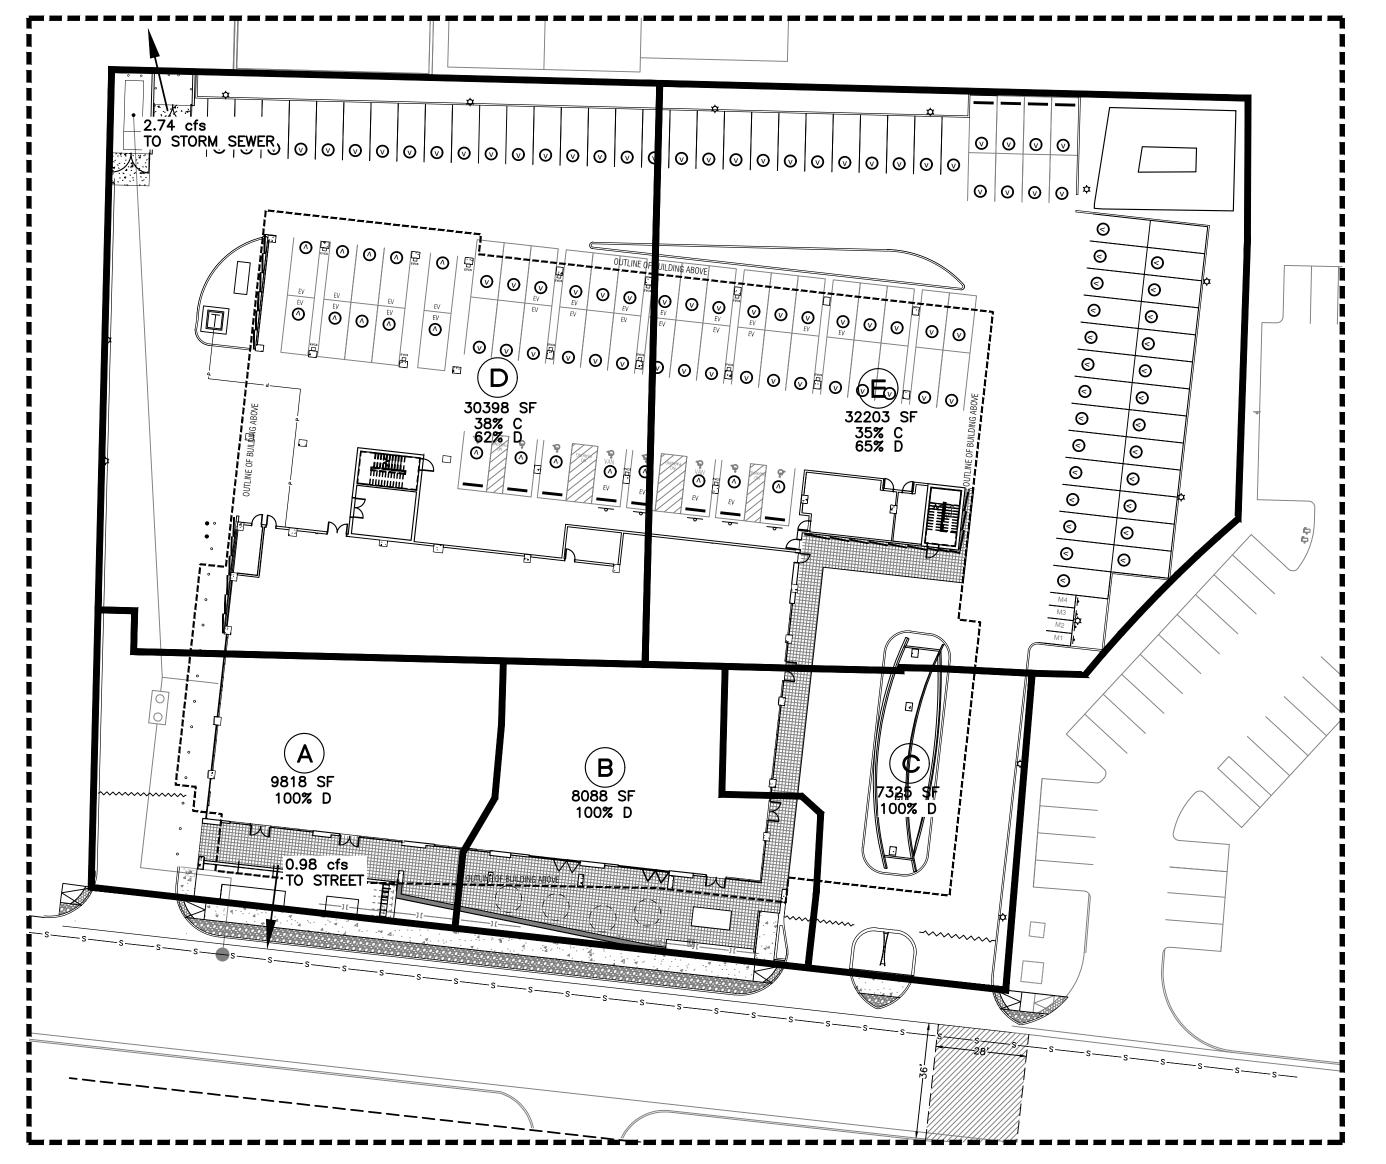

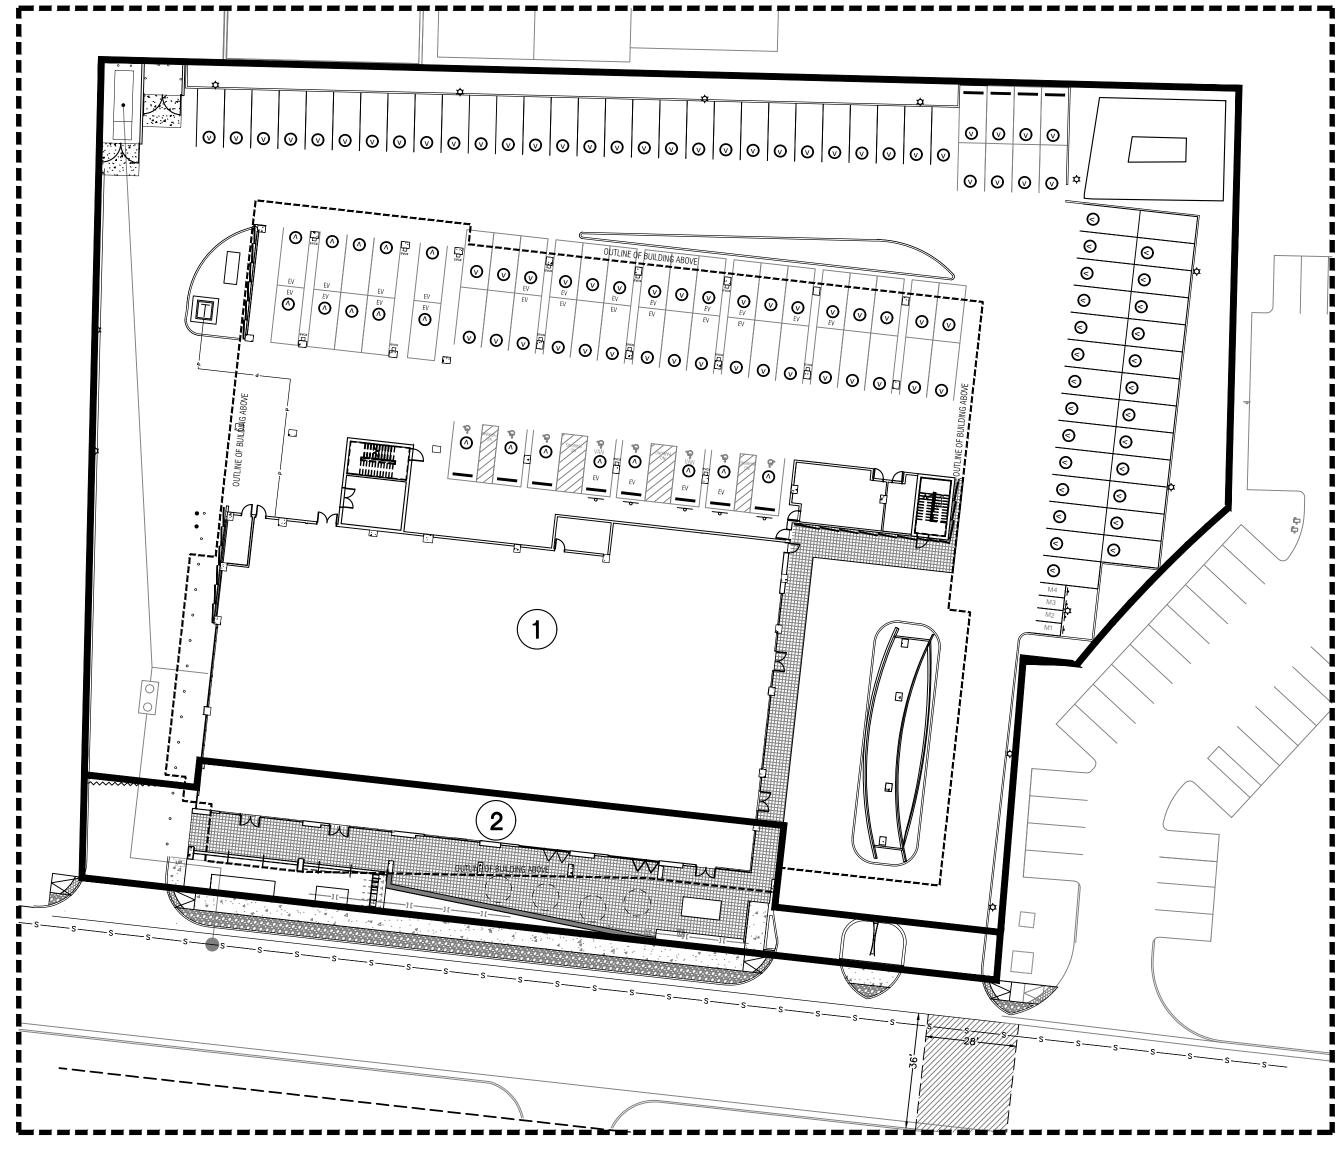


EXISTING BASINS

| | | | | | | Weig | ghted E | Metho | d | | | | | | | |
|----------|---------------|--------------|----------|--------------|---------|------------|--------------|------------|-------|---------|---------------|-----------|------|------------|---------|------|
| Existing | Basins | | | | | | | | | | | | | | | |
| | | | | | | | | | | | | 100-Year | | | 10-Year | |
| Basin | Area | Area | Trea | tment A | Trea | tment B | Treat | ment C | Treat | ment D | Weighted E | Volume | Flow | Weighted E | Volume | Flow |
| | (sf) | (acres) | % | (acres) | % | (acres) | % | (acres) | % | (acres) | (in) | (ac-ft) | cfs | (in) | (ac-ft) | cfs |
| Α | 9,818 | 0.23 | 0% | 0 | 0% | 0.00 | 0% | 0.00 | 100% | 0.23 | 2.330 | 0.044 | 0.98 | 1.510 | 0.028 | 0.61 |
| В | 8,088 | 0.19 | 0% | 0 | 0% | 0.00 | 0% | 0.00 | 100% | 0.19 | 2.330 | 0.036 | 0.81 | 1.510 | 0.023 | 0.50 |
| С | 7,325 | 0.17 | 0% | 0 | 0% | 0.00 | 0% | 0.00 | 100% | 0.17 | 2.330 | 0.033 | 0.73 | 1.510 | 0.021 | 0.46 |
| D | 30,968 | 0.71 | 0% | 0 | 0% | 0.00 | 38% | 0.27 | 62% | 0.44 | 1.836 | 0.109 | 2.74 | 1.119 | 0.066 | 1.62 |
| E | 32,203 | 0.74 | 0% | 0 | 0% | 0.00 | 35% | 0.26 | 65% | 0.48 | 1.875 | 0.116 | 2.87 | 1.150 | 0.071 | 1.71 |
| Dovolon | ad Pasins | | | | | | | | | | | 0.337 | 8.13 | | | |
| reverope | ed Basins | | | | | | | | | | | 100-Year | | | 10-Year | |
| Basin | Area | Area | Trea | tment A | Trea | tment B | Treat | ment C | Treat | ment D | Weighted E | Volume | Flow | Weighted E | Volume | Flow |
| | (sf) | (acres) | % | (acres) | % | (acres) | % | (acres) | % | (acres) | (in) | (ac-ft) | cfs | (in) | (ac-ft) | cfs |
| 1 | 78,739 | 1.81 | 0% | 0 | 12% | 0.22 | 0% | 0.00 | | 1.63 | 2.193 | 0.330 | 7.57 | 1.395 | 0.210 | 4.61 |
| 2 | 9,607 | 0.22 | 0% | 0 | 3% | 0.01 | 0% | 0.00 | 97% | 0.21 | 2.284 | 0.042 | 0.94 | 1.474 | 0.027 | 0.59 |
| | | | | | | | | | | 1.84 | | 0.372 | 8.52 | | | |
| | | | | | | | | | | Req | uired Ponding | 0.036 | | | | |
| Equation | ns: | | | | | | | | | | | | | | | |
| | | | | | Ī | Excess Pro | ecipitation, | E (inches) | | Peak | Discharge (cf | s/acre) | | | | |
| Neighter | d E = Ea*Aa + | Eb*Ab + Ed | c*Ac + E | d*Ad / (Tota | l Area) | Zone 2 | 100-Year | | | Zone 2 | 100-Year | 10 - Year | | | | |
| | | | | | | Ea | 0.62 | 0.15 | | Qa | 1.71 | 0.41 | | | | |
| /olume = | Weighted D | * Total Area | | | | Eb | 0.8 | 0.3 | | Qb | 2.36 | 0.95 | | | | |
| | | | | | | Ec | 1.03 | 0.48 | | Q_c | 3.05 | 1.59 | | | | |
| | | Ab + Qc * A | 014 | . Λ -Ι | | Ed | 2.33 | 1.51 | | Q_d | 4.34 | 2.71 | | | | |

PROPOSED BASINS

| ENGINEER'S SEAL | 1921 BELLAMAH AVE NW ALBUQUERQUE, NM | <i>DRAWN BY</i> pm |
|----------------------------------|--|-------------------------|
| DR. BOHANN ON MEXICO Z | CONCEPTUAL BASIN MAP | <i>DATE</i> 10–26–22 |
| ((7868)) | CONCEI TOAL BASIN MAI | DRAWING |
| PROFILESC | | SHEET # |
| 10-26-22 | TIERRA WEST, LLC 5571 MIDWAY PARK PL NE ALBUQUERQUE, NEW MEXICO 87109 | GR-2 |
| RONALD R. BOHANNAN P.E. #7868 | (505) 858-3100 www.tierrawestllc.com | <i>JOB #</i> 2022047 |

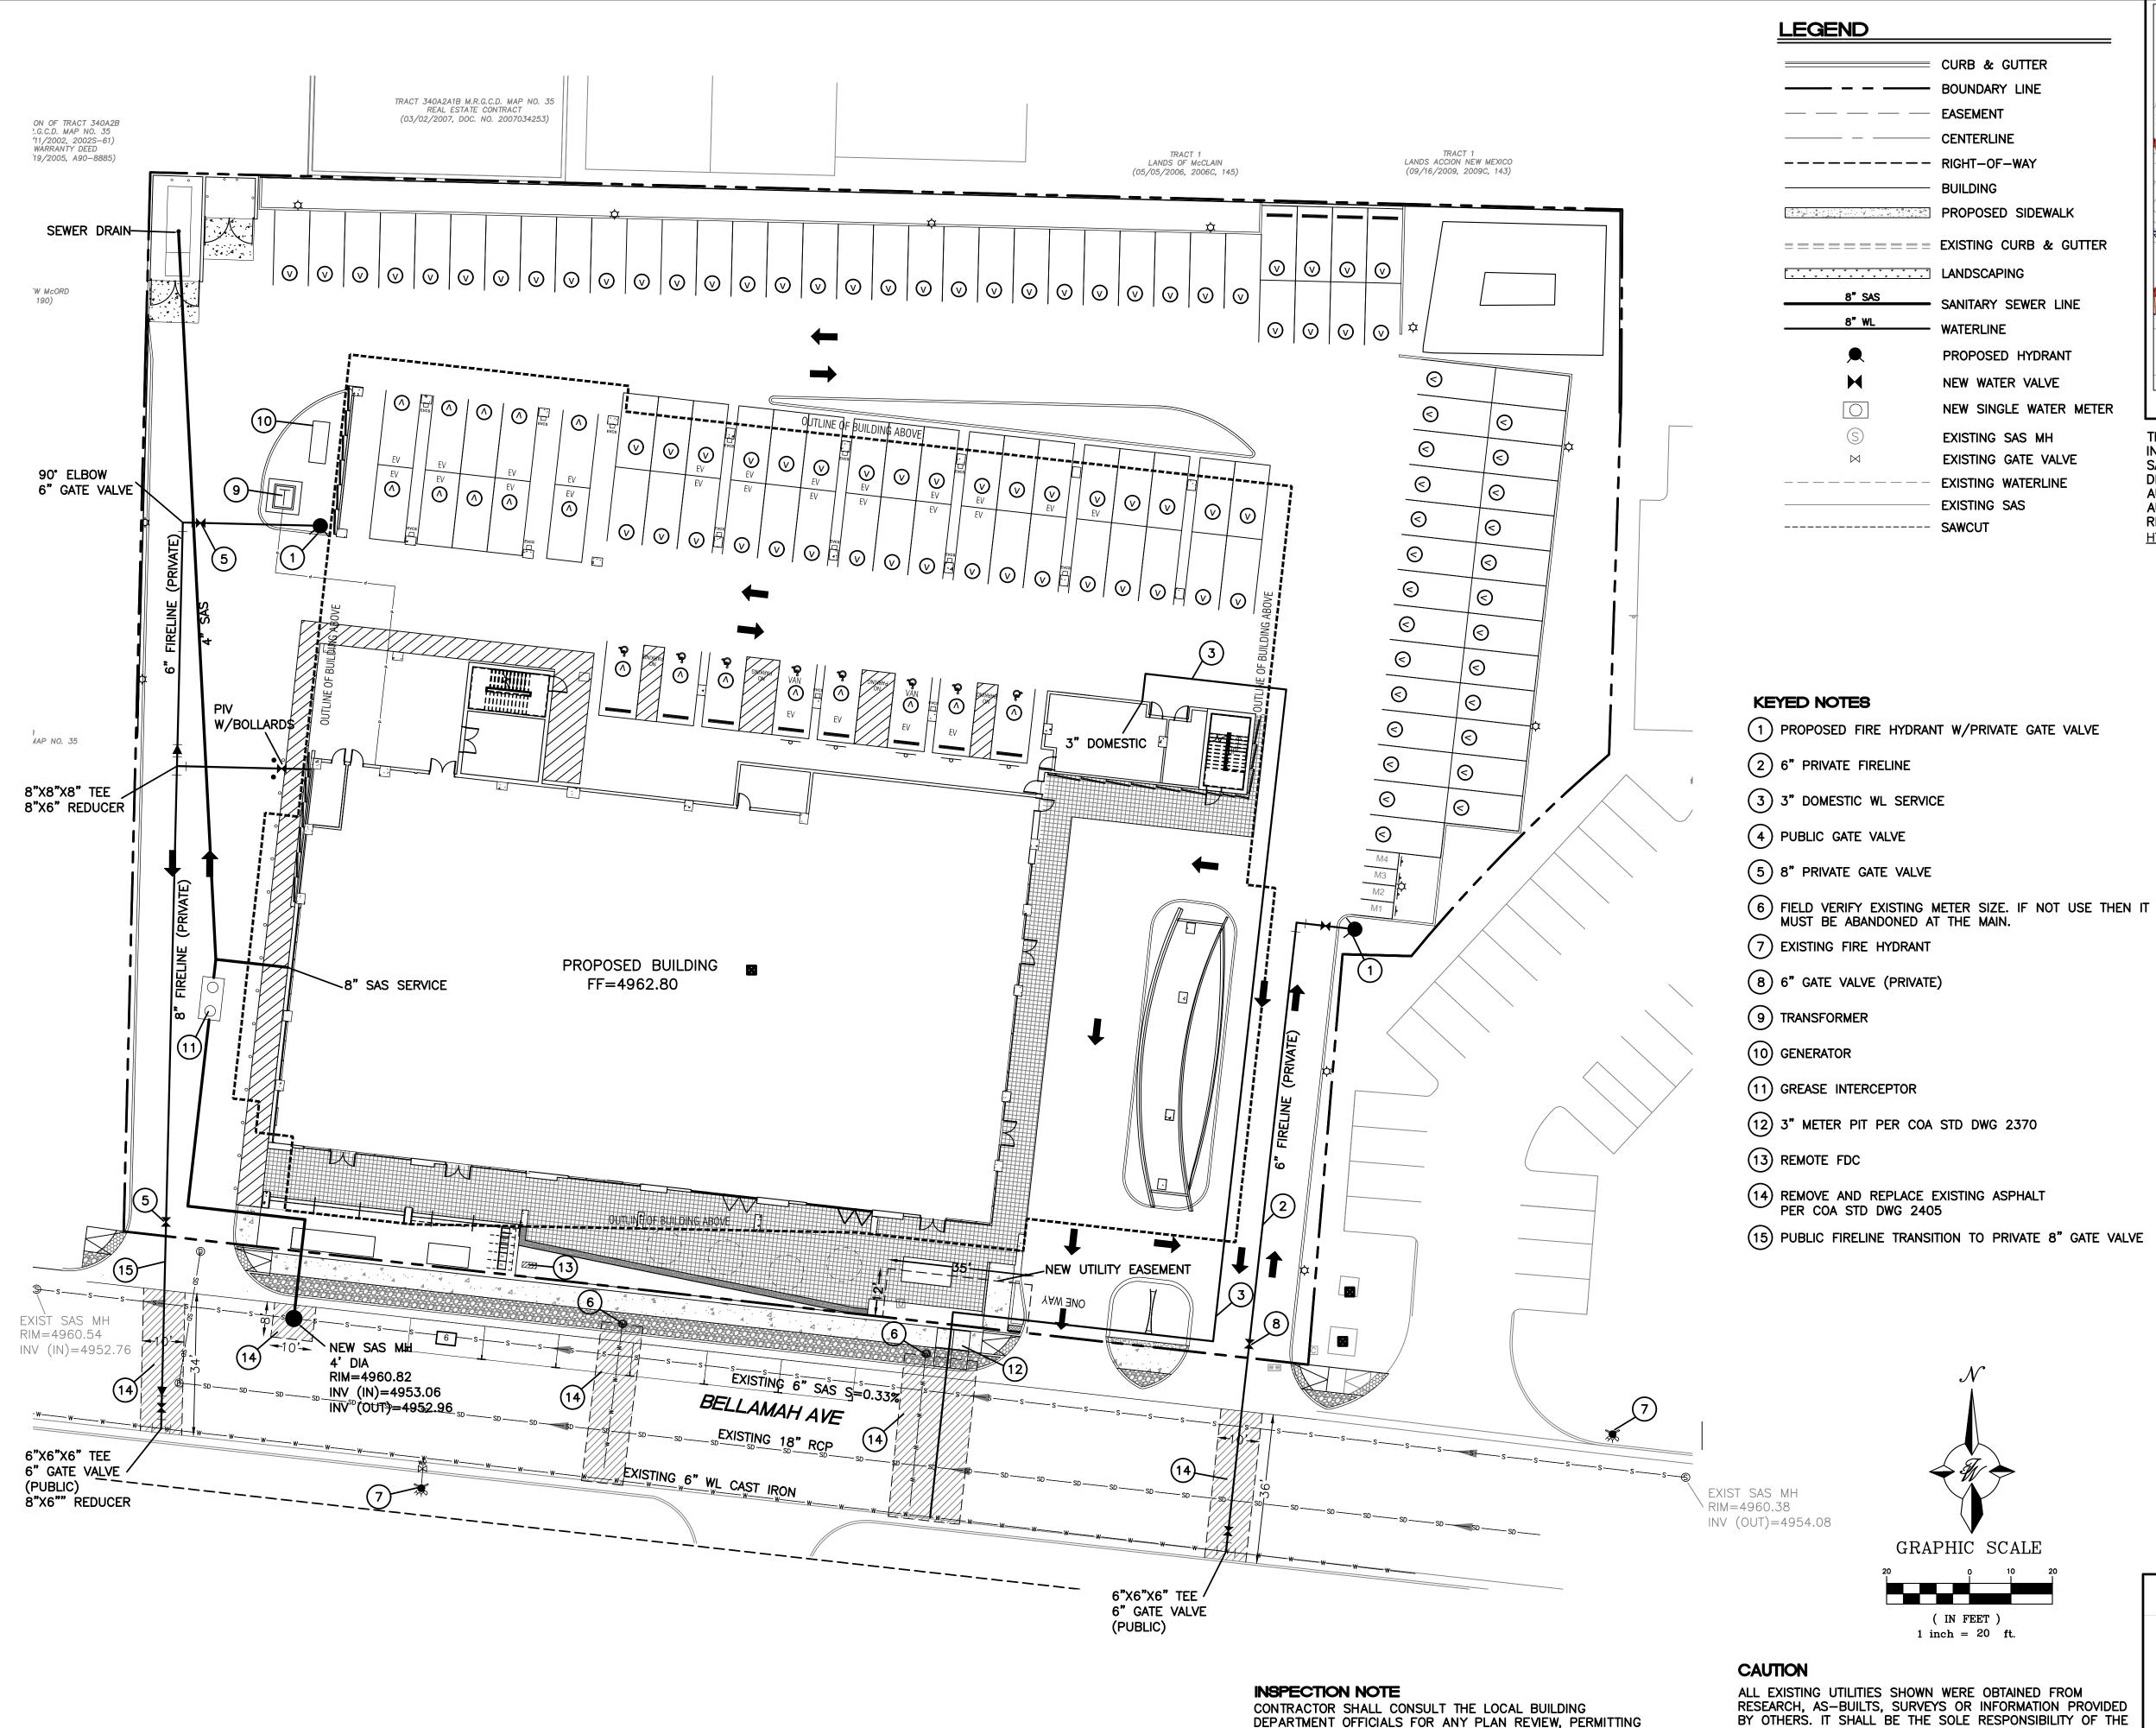

GRAPHIC SCALE

= CURB & GUTTER

BOUNDARY LINE

EASEMENT

PROPOSED SIDEWALK

SANITARY SEWER LINE

PROPOSED HYDRANT

NEW WATER VALVE

EXISTING SAS MH


EXISTING GATE VALVE

EXISTING WATERLINE

EXISTING SAS

NEW SINGLE WATER METER

CENTERLINE

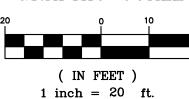


CAUTION

REQUIREMENTS OR BUILDING CODE INSPECTIONS THAT MAY

BE REQUIRED TO ENFORCE LOCAL, STATE OR NATIONAL

BUILDING CODES PRIOR TO CONSTRUCTING IMPROVEMENTS

ALL EXISTING UTILITIES SHOWN WERE OBTAINED FROM RESEARCH, AS-BUILTS, SURVEYS OR INFORMATION PROVIDED BY OTHERS. IT SHALL BE THE SOLE RESPONSIBILITY OF THE CONTRACTOR TO CONDUCT ALL NECESSARY FIELD INVESTIGATIONS PRIOR TO AND INCLUDING ANY EXCAVATION, TO DETERMINE THE ACTUAL LOCATION OF UTILITIES AND OTHER IMPROVEMENTS, PRIOR TO STARTING THE WORK. ANY CHANGES FROM THIS PLAN SHALL BE COORDINATED WITH AND APPROVED BY THE ENGINEER.

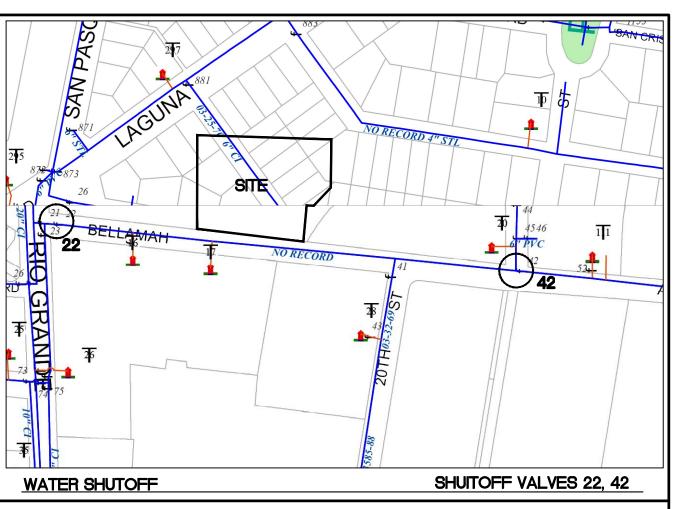


THE CONTRACTOR SHALL COORDINATE WITH THE WATER AUTHORITY SEVEN (7) DAYS IN ADVANCE OF PERFORMING WORK THAT WILL AFFECT THE PUBLIC WATER OR SANITARY SEWER INFRASTRUCTURE. WORK REQUIRING SHUTOFF OF FACILITIES DESIGNATED AS MASTER PLAN FACILITIES MUST BE COORDINATED WITH THE WATER AUTHORITY 14 DAYS IN ADVANCE OF PERFORMING SUCH WORK. ONLY WATER AUTHORITY CREWS ARE AUTHORIZED TO OPERATE PUBLIC VALVES. SHUTOFF REQUESTS MUST BE MADE ONLINE AT HTTP://ABCWUA.ORG/CONTENT/VIEW/463/729/

GENERAL UTILITY NOTES:

- 1. ALL WATER AND SEWER UTILITY WORK TO BE DONE IN ACCORDANCE WITH COA STANDARDS AND SPECIFICATIONS LATEST EDITION.
- 2. 4' MINIMUM BURY REQUIRED FOR ALL UTILITIES UNLESS OTHERWISE
- 3. REFERENCE ARCHITECTURAL PLANS FOR WATER LINE RISER LOCATIONS.
- 4. CLEAN OUTS ARE TO BE BUILT PER UNIFORM PLUMBING CODE STANDARDS.
- 5. ALL PLUMBING PIPE MATERIAL TO BE USED PER UPC.
- 6. FIRE LINE AND DOMESTIC WATERLINE MUST HAVE BACKFLOW PREVENTORS PER UPC. IF BACKFLOW PREVENTOR IS INSTALLED EXTERIOR OF BUILDING A HOT BOX SHALL BE INSTALLED AND
- 7. ALL EX. SD INLETS AND MH SHALL HAVE CONCRETE COLLARS POURED AND BE ADJUSTED TO FINISHED GRADE.
- ALL EXCAVATION, TRENCHING AND SHORING ACTIVITIES MUST BE CARRIED-OUT IN ACCORDANCE WITH OSHA 29 CFR 1926.650 SUBPART P.
- 9. ALL UTILITY DISTANCES SHOWN ARE FOR REFERENCE ONLY.
- 10. PNM HAS NUMEROUS ELECTRIC FACILITIES AT THIS SITE CURRENTLY SERVING EXISTING CUSTOMERS. THE APPLICANT SHALL COORDINATE WITH PNM REGARDING THESE EXISTING FACILITIES. ANY RELOCATION, CHANGES OR REALIGNMENT OF EXISTING ELECTRIC UTILITIES WILL BE THE DEVELOPER EXPENSE. IN SOME CASES, RELOCATION OR CHANGES TO EXISTING FACILITIES MAY NOT BE FEASIBLE DUE TO PHYSICAL, USE OR SAFETY CLEARANCE CONSTRAINTS.
- 11. PNM WILL REVIEW ALL TECHNICAL NEEDS, ISSUES AND SAFETY CLEARANCES FOR ITS ELECTRIC POWER SYSTEMS. ANY EXISTING AND PROPOSED PUBLIC UTILITY EASEMENTS SHALL BE INDICATED ON THE SITE PLAN UTILITY SHEET PRIOR TO DRB REVIEW. PNM'S STANDARD FOR PUBLIC UTILITY EASEMENTS IS 10 FEET IN WIDTH TO ENSURE ADEQUATE, SAFE CLEARANCES.
- 12. SCREENING SHALL BE DESIGNED TO ALLOW FOR ACCESS TO UTILITY FACILITIES. IT IS NECESSARY TO PROVIDE ADEQUATE CLEARANCE OF TEN FEET SURROUNDING ALL GROUND-MOUNTED UTILITIES FOR SAFE OPERATION, MAINTENANCE AND REPAIR PURPOSES.
- 13. ALL BUILDINGS CONSTRUCTION TYPE IS II-B
- 14. RESTRAINT JOINTS SHALL BE INSTALLED AT ALL CHANGES OF DIRECTION AND ELEVATION, ON ALL WATERMAIN. STAINLESS STEEL RODDING SHALL BE EXTENDED ALONG THE NEXT FULL-LENGTH PIPE AND ANCHORED ON THE PIPE BELL, OR MECHANICAL FITTING, ADDITIONALLY, AT ALL LOCATIONS OF THRUST BLOCKING. MEGA-LUGS ARE NOT TO BE ALLOWED. IN ACCORDANCE WITH ABCWUA REQUIREMENTS.
- 15. COORDINATION WITH WATER AUTHORITY CROSS CONNECTION SECTION WILL BE REQUIRED TO ENSURE PROPER BACKFLOW CONTAINMENT IS IN PLACE PRIOR TO RELEASE OF METER FOR THE SITE. CONTACT THE CROSS CONNECTION SECTION AT 505-289-3454.
- 16. COORDINATION WITH THE WATER AUTHORITY PRE-TREATMENT ENGINEER IS REQUIRED TO ENSURE THE SITE COMPLIES WITH WATER AUTHORITY SEWER USE ORDINANCE. CONTACT THE PRE-TREATMENT ENGINEER AT 505-289-3439.



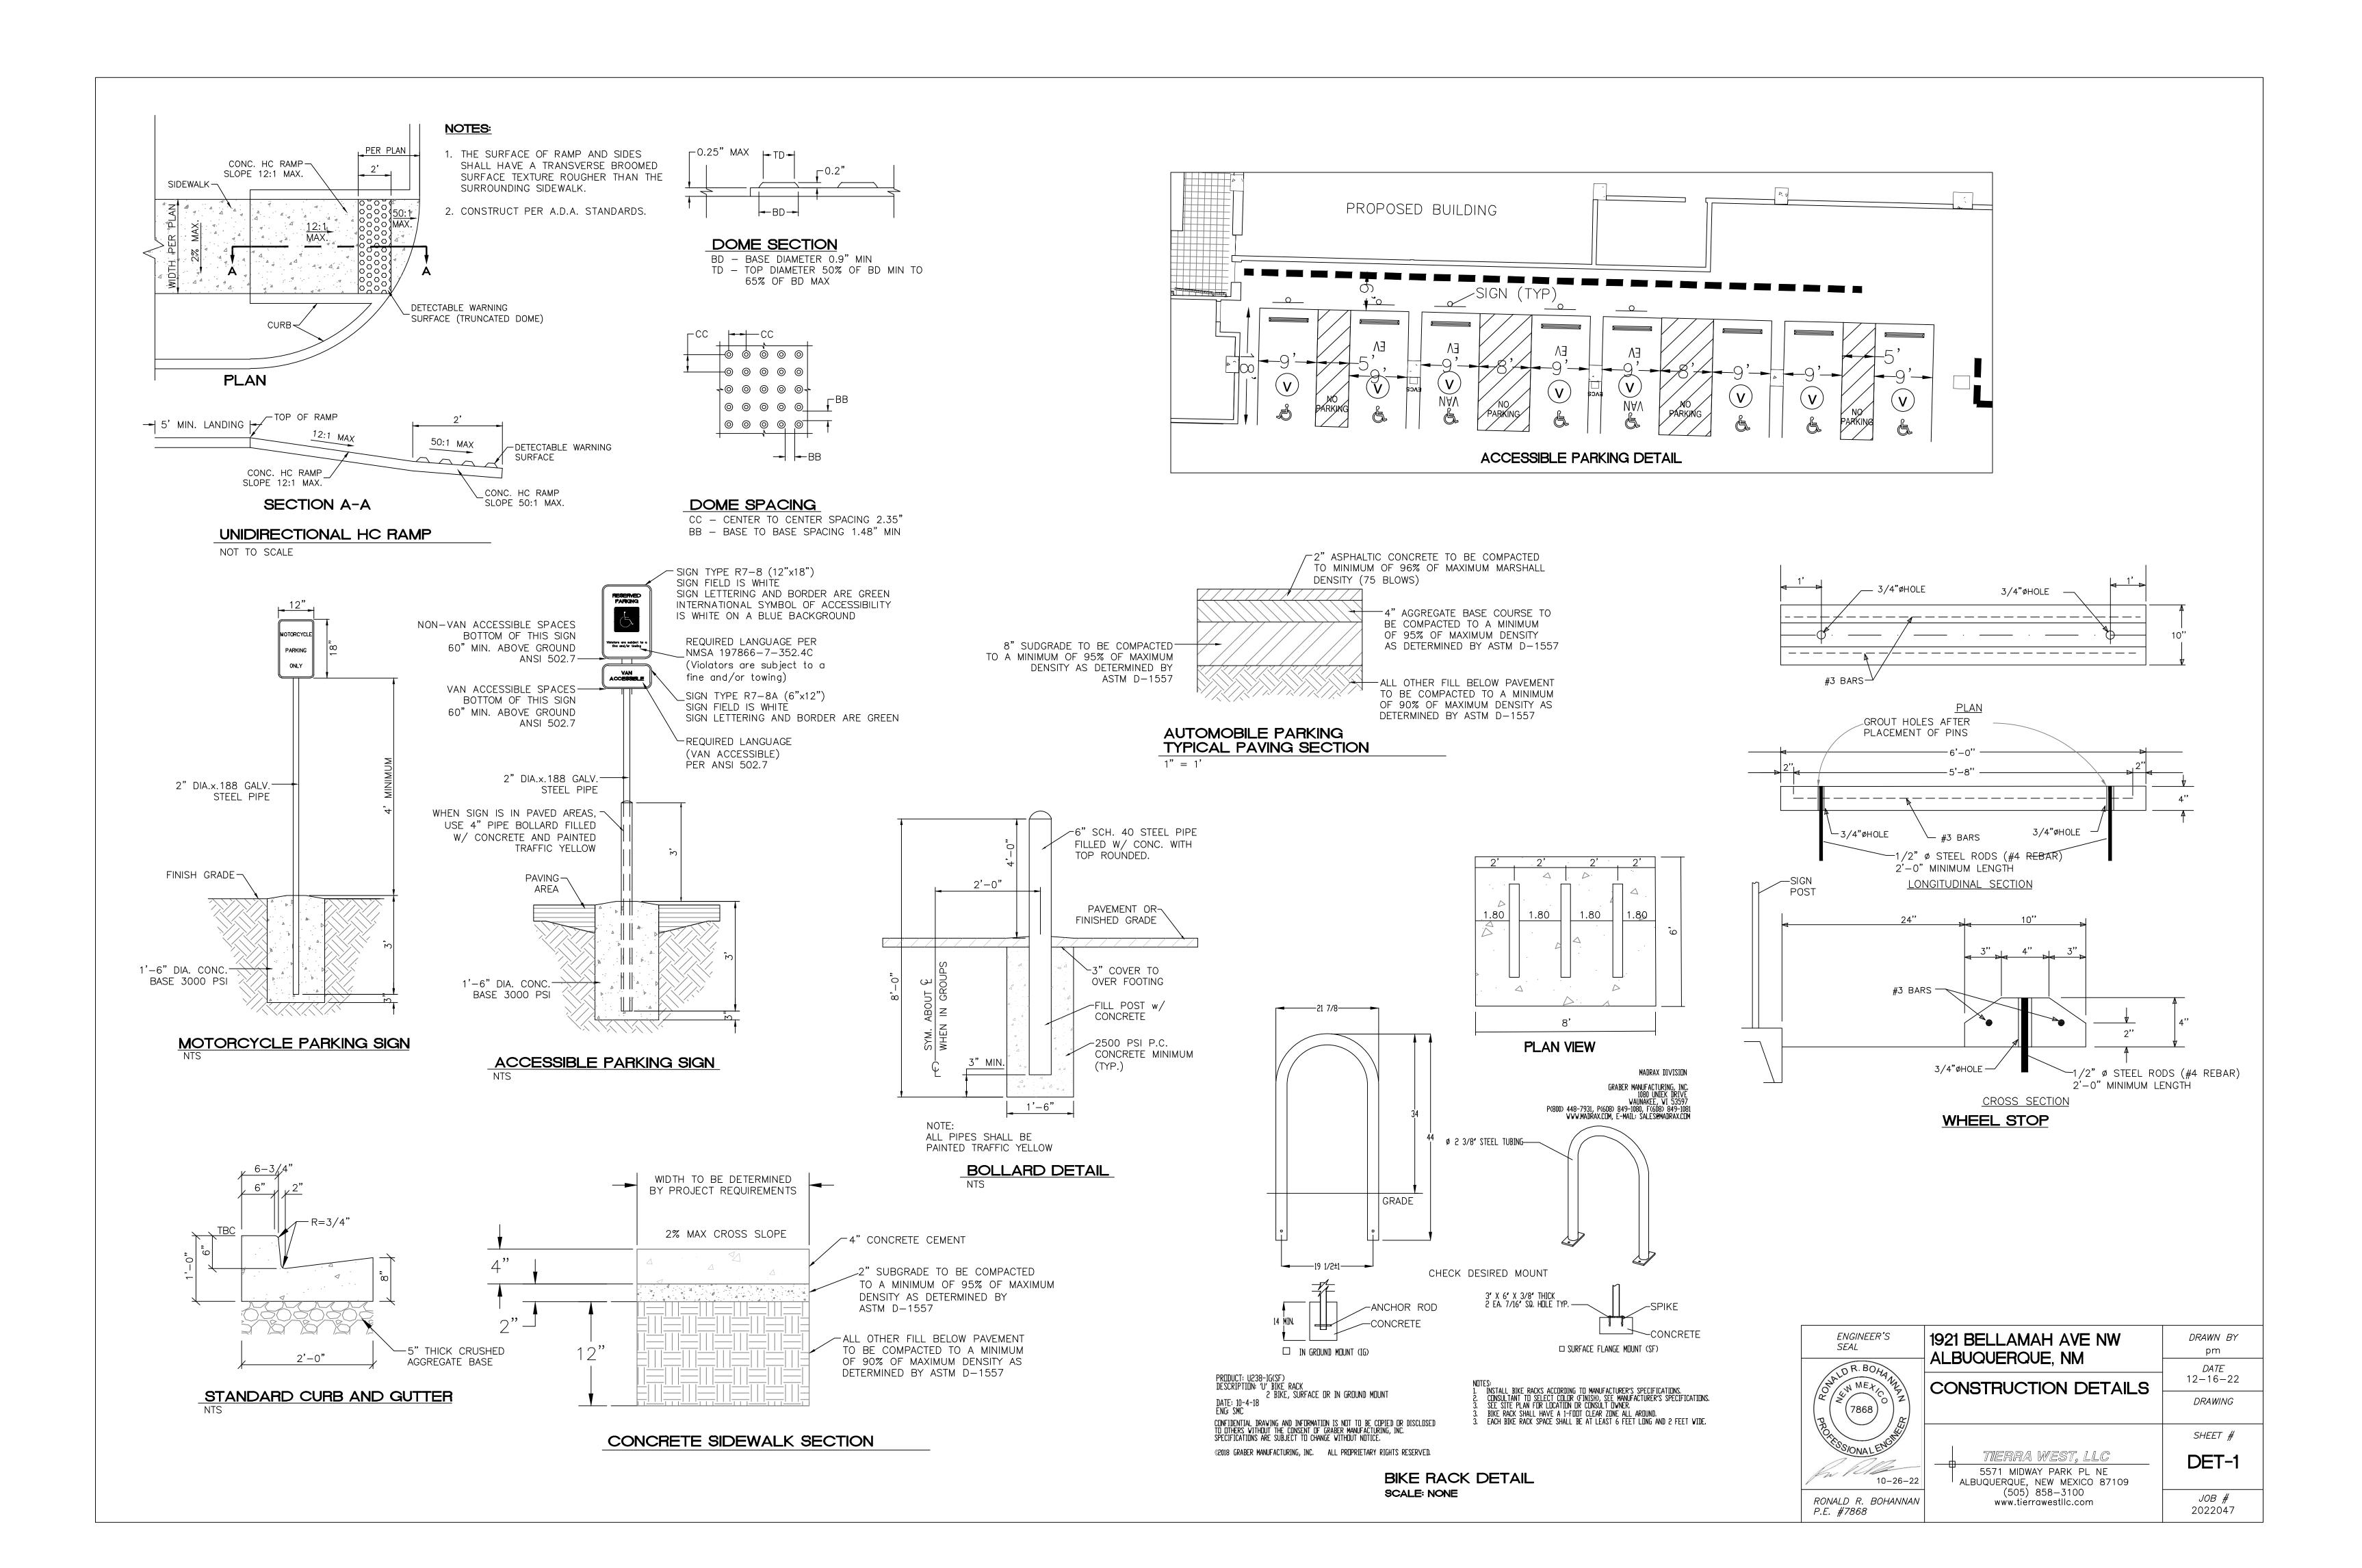




DIMENSIONS (in/ft)


| DOMITIENNE V2 | | | | | | | | | |
|---------------|---|-----------------------|-------|-------|-------|-------|--|--|--|
| Height | н | 13.1' | 16.4' | 19.7' | 23.0' | 26.2' | | | |
| Overhang | L | 31.5" - 47.2" - 59.0" | | | | | | | |


| DOMITIENNE V2 | Wall & a | against a pole mounting |
|---------------|----------|-------------------------|
| Overhang | L | 31.5" - 47.2" - 59.0" |
| Weight (lbs) | | 24.2- 37.5 41.9 |

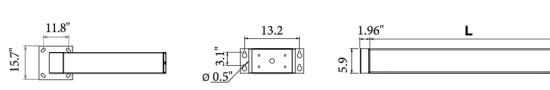

Base plate: 15.7" x 15.7" • Center to center: 11.8" x 11.8" 4 anchor bolts (not supplied)
Section: 9.8" x 5.9"

www.ragni-lighting.com

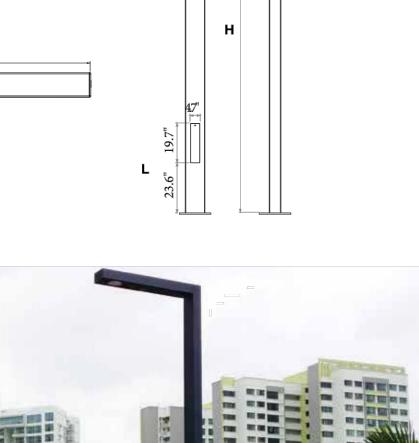

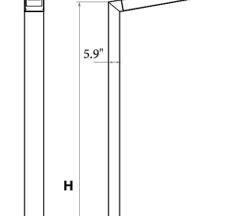

EVO2 MODULE

The EVO2 is very compact so that it can be incorporated into numerous luminaires in the Ragni range. In particular, it can replace classic reflectors (high-pressure sodium lamps, metal halide lamps...), and its compactness has made it possible to create the Ketch with its thin luminaire.



LED manufacturer: CREE
LED life-cycle: up to 100,000 hours
Color temperatures: 3000K ou 4000K.
CRI above 70

POWER AND LUMINOUS INTENSITIES PER MODULE - LUMINAIRE OUTPUT DATA

| 3000 K | | 350 mA | | | 500 mA | | 700 mA | | | |
|------------------|--------|--------|--------|--------------------|--------|--------|--------|--------|--------|--|
| Number of LED | P, (W) | Φ (lm) | (lm/W) | P _t (W) | Φ (lm) | (Im/W) | P, (W) | Φ (lm) | (lm/W) | |
| 16 | 21.4 | 1988 | 93 | 28.2 | 2867 | 102 | 36 | 3636 | 101 | |
| 32 | 34.4 | 3976 | 116 | 48.8 | 5734 | 118 | 68.9 | 7271 | 106 | |
| 48 | 51 | 5964 | 117 | 72.6 | 8601 | 118 | 102.3 | 10907 | 107 | |

| 4000 K | | | 350 mA | | | 500 mA | | 700 mA | | | |
|--------|---------------|--------------------|--------|--------|--------|--------|--------|--------|--------|--------|--|
| | Number of LED | P _t (W) | Φ (lm) | (lm/W) | P, (W) | Φ (lm) | (lm/W) | P, (W) | Φ (lm) | (lm/W) | |
| | 16 | 21.4 | 2147 | 100 | 28.2 | 3097 | 110 | 36 | 3932 | 109 | |
| | 32 | 34.4 | 4294 | 125 | 48.8 | 6193 | 127 | 68.9 | 7863 | 114 | |
| | 48 | 51 | 6441 | 126 | 72.6 | 9290 | 128 | 102.3 | 11795 | 115 | |

P₊ (W) = Total power consumption including driver consumption • Φ Nominal flux (lm) • Luminous efficiency (lm/W)

ORDERING INFORMATION


| Model | Pole Height (mm) | Head Length | # LED | CCT (K) | Drive Current | Distribution | Line Voltage | Mounting | Mounting Direction | Mounting Angle | Color |
|-------|------------------------|----------------|----------|---------------------------|------------------|--------------|-----------------|------------|-----------------------|-------------------|----------------|
| DOMV | | | | | | | | | | | |
| | 4000 | 800 | 16 | 3 - (<mark>3000K)</mark> | 35 - (350 mA) | T2 | 120 | T - (Top) | F - (Front) | 0 | BLK - (Black) |
| | 5000 | 1200 | 24 | 4 - (4000K) | 50 - (500 mA) | T3 | 220 | W - (Wall) | B - (Back) | 5 | BRZ - (Bronze |
| | 6000 | 1500 | 32 | | 70 - (700 mA) | T4 | 277 | | L - (Left) | 10 | SLV - (Silver) |
| | 7000 | | 48 | | CUSTOM | T5 | UNV | | R - (Right) | 15 | WHT - (White |
| | 8000 | | | | | | | | | 20 | (RAL #) |
| | сиѕтом | | | | | | | | | 30 | |



NOTES

1. LIGHT FIXTURES SHALL BE SHIELDED USING FULL CUTOFF LIGHT FIXTURES (I.E. A LIGHT FIXTURE WITH ZERO INTENSITY AT OR ABOVE 90 DEGREES ABOVE NADIR AND LIMITED TO A VALUE NOT EXCEEDING 10% OF LAMP LUMENS AT OR ABOVE 80°).

- 2. LIGHTING SHALL BE POSITIONED SO THAT LIGHT SPILLOVER ONTO THE AREA 10' BEYOND THE PROPERTY LINE SHALL NOT EXCEED 200' LAMBERTS AS MEASURED FROM THE PROPERTY LINE FACING THE LIGHT SOURCE.
- 3. OUTDOOR LIGHT FIXTURES SHALL HAVE A MINIMUM LIGHT INTENSITY OF 1 LUMEN PER SQUARE FOOT AND A MAXIMUM INTENSITY OF 2 LUMENS PER SQUARE FOOT.

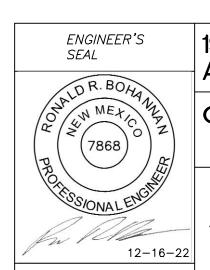

1921 BELLAMAH AVE NW ALBUQUERQUE, NM CONSTRUCTION DETAILS

TIERRA WEST, LLC

5571 MIDWAY PARK PL NE
ALBUQUERQUE, NEW MEXICO 87109
(505) 858-3100

RONALD R. BOHANNAN P.E. #7868 (505) 858-3100 (505)

DRAWN BY


12-16-22

DRAWING

SHEET #

DET-2

pm/sb

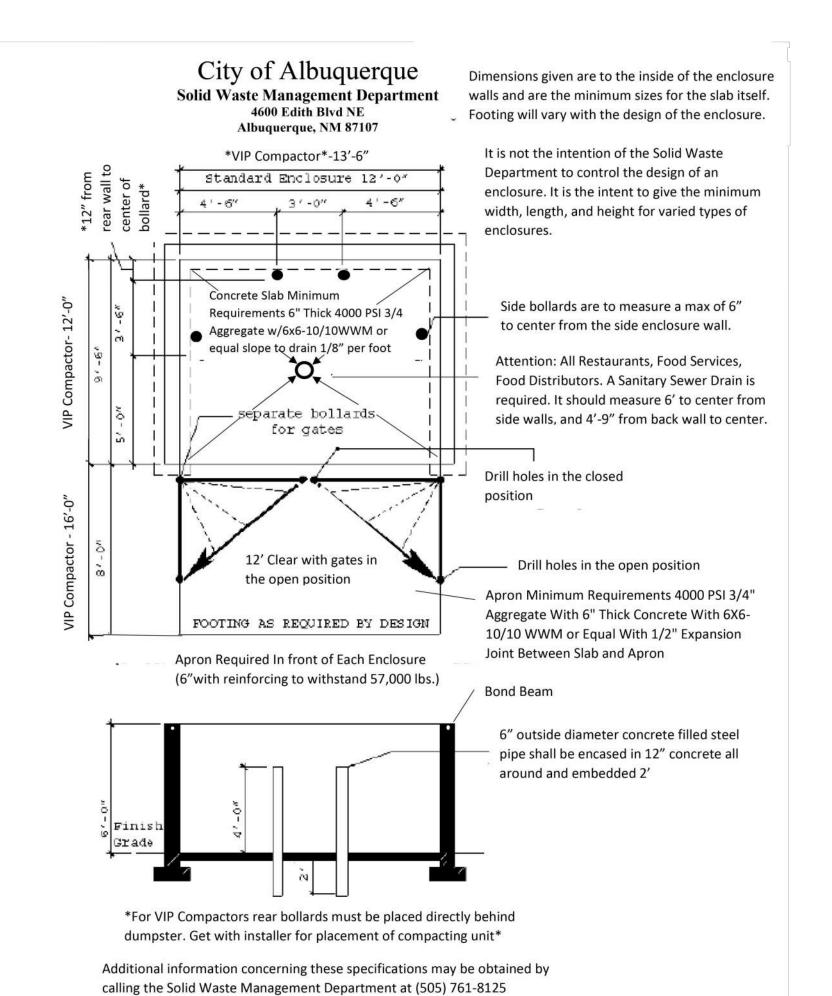


***Trash enclosures are intended for dumpsters only. ***

If casters are required for service a level smooth hard surface (Asphalt, Concrete) is required from the edge of the apron

City of Albuquerque
Solid Waste Management Department
4600 Edith Blvd NE

Albuquerque, NM 87107

Concrete pad is to be a minimum of 12' wide with a length of 10' greater than the combined length of the compactor and the container (box). Concrete is to be a minimum of 4000 PSI, steel reinforced, 6" thick

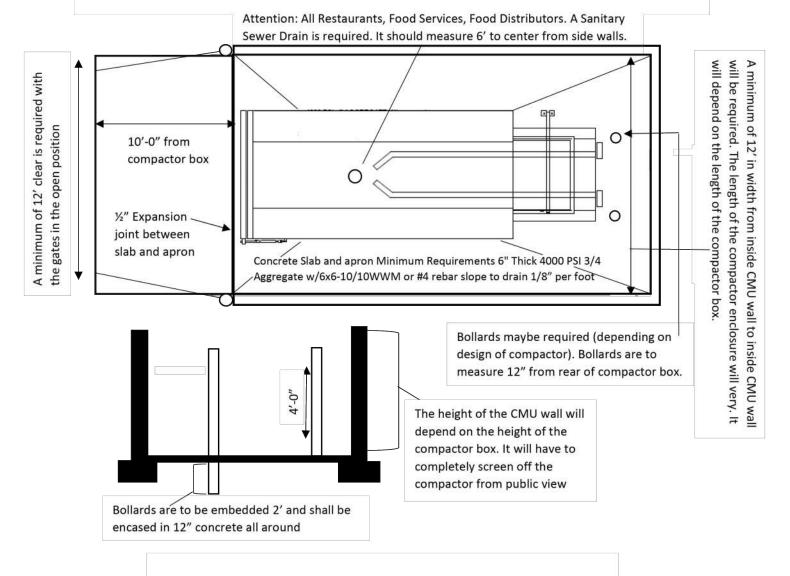


Additional information concerning these specifications may be obtained by calling the Solid Waste Management Department at (505) 761-8125 ***Trash enclosures are intended for dumpsters only. ***

Side Elevation

1/4" = 1'-0"


Back Elevation

1/4" = 1'-0"

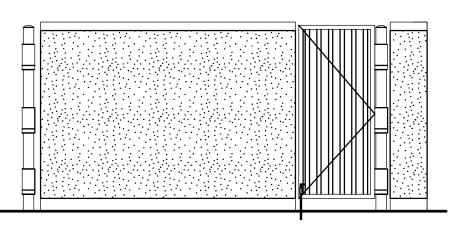

Side Elevation

1/4" = 1'-0"

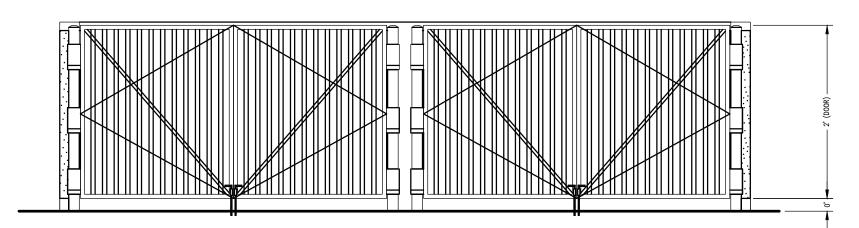



| _ | | | |
|---|---|---|-------------------------|
| | ENGINEER'S SEAL | 1921 BELLAMAH AVE NW ALBUQUERQUE, NM | <i>DRAWN BY</i> pm |
| | NDR. BOHA | ALBOQULIQUE, INIVI | DATE |
| | ON METICO Z | CONSTRUCTION DETAILS | 10-26-22 |
| | (2 (7868) Z | CONSTRUCTION BETAILS | DRAWING |
| | | | |
| | P. C. | | SHEET # |
| | OS/ONAL ENE | TIERRA WEST, LLC | DET-3 |
| | 10-26-22 | | |
| | RONALD R. BOHANNAN P.E. #7868 | (505) 858-3100 www.tierrawestllc.com | <i>JOB #</i> 2022047 |

OFFICEUNTITLED **OFFICEUNTITLED**4200 SEPULVEDA BLVD, STE 104, CULVER CITY, CA 90230
P.310.730.6698 BENT WHEATHERED — STEEL SHEET WEATHERING STEEL -CLADDING LED BACK LIT PANEL -SIGNAGE CUTOUT ON —— WEATHERING STEEL 6" CONCRETE PAD — LANDSCAPING. SEE — LANDSCAPING PLAN MONUMENT SIGNAGE - LATITUDINAL SECTION

SCALE: 1/2" = 1'-0" SAWMILL (LOT H) 1921 Bellamah Ave NW, Albuquerque, NM BENT WEATHERING — STEEL SHEET **0U** PROJECT NO: 21.002.000 6" CONCRETE PAD — LANDSCAPING. SEE — LANDSCAPING PLAN MOUNMENT SIGNAGE - SIDE ELEVATION

SCALE: 1/2" = 1'-0" # REVISION DESCRIPTION SIGNAGE CUTOUT ON — WEATHERING STEEL. CUTOUT LIT FROM BEHIND BENT WEATHERING — STEEL SHEET 6" CONCRETE PAD —— LANDSCAPING. SEE — LANDSCAPING PLAN MONUMENT SIGNAGE - FRONT/BACK ELEVATION SCALE: 1/2" = 1'-0" WHEATHERED — WEATHERING STEEL BENT WEATHERING — STEEL SHEET License Name: Christian Robert Profession Name: OFFICEUNTITLED, INC. Licensee Number: 005312 SIGNAGE DETAIL MONUMENT SIGNAGE - PLAN SCALE: 1/2" = 1'-0"

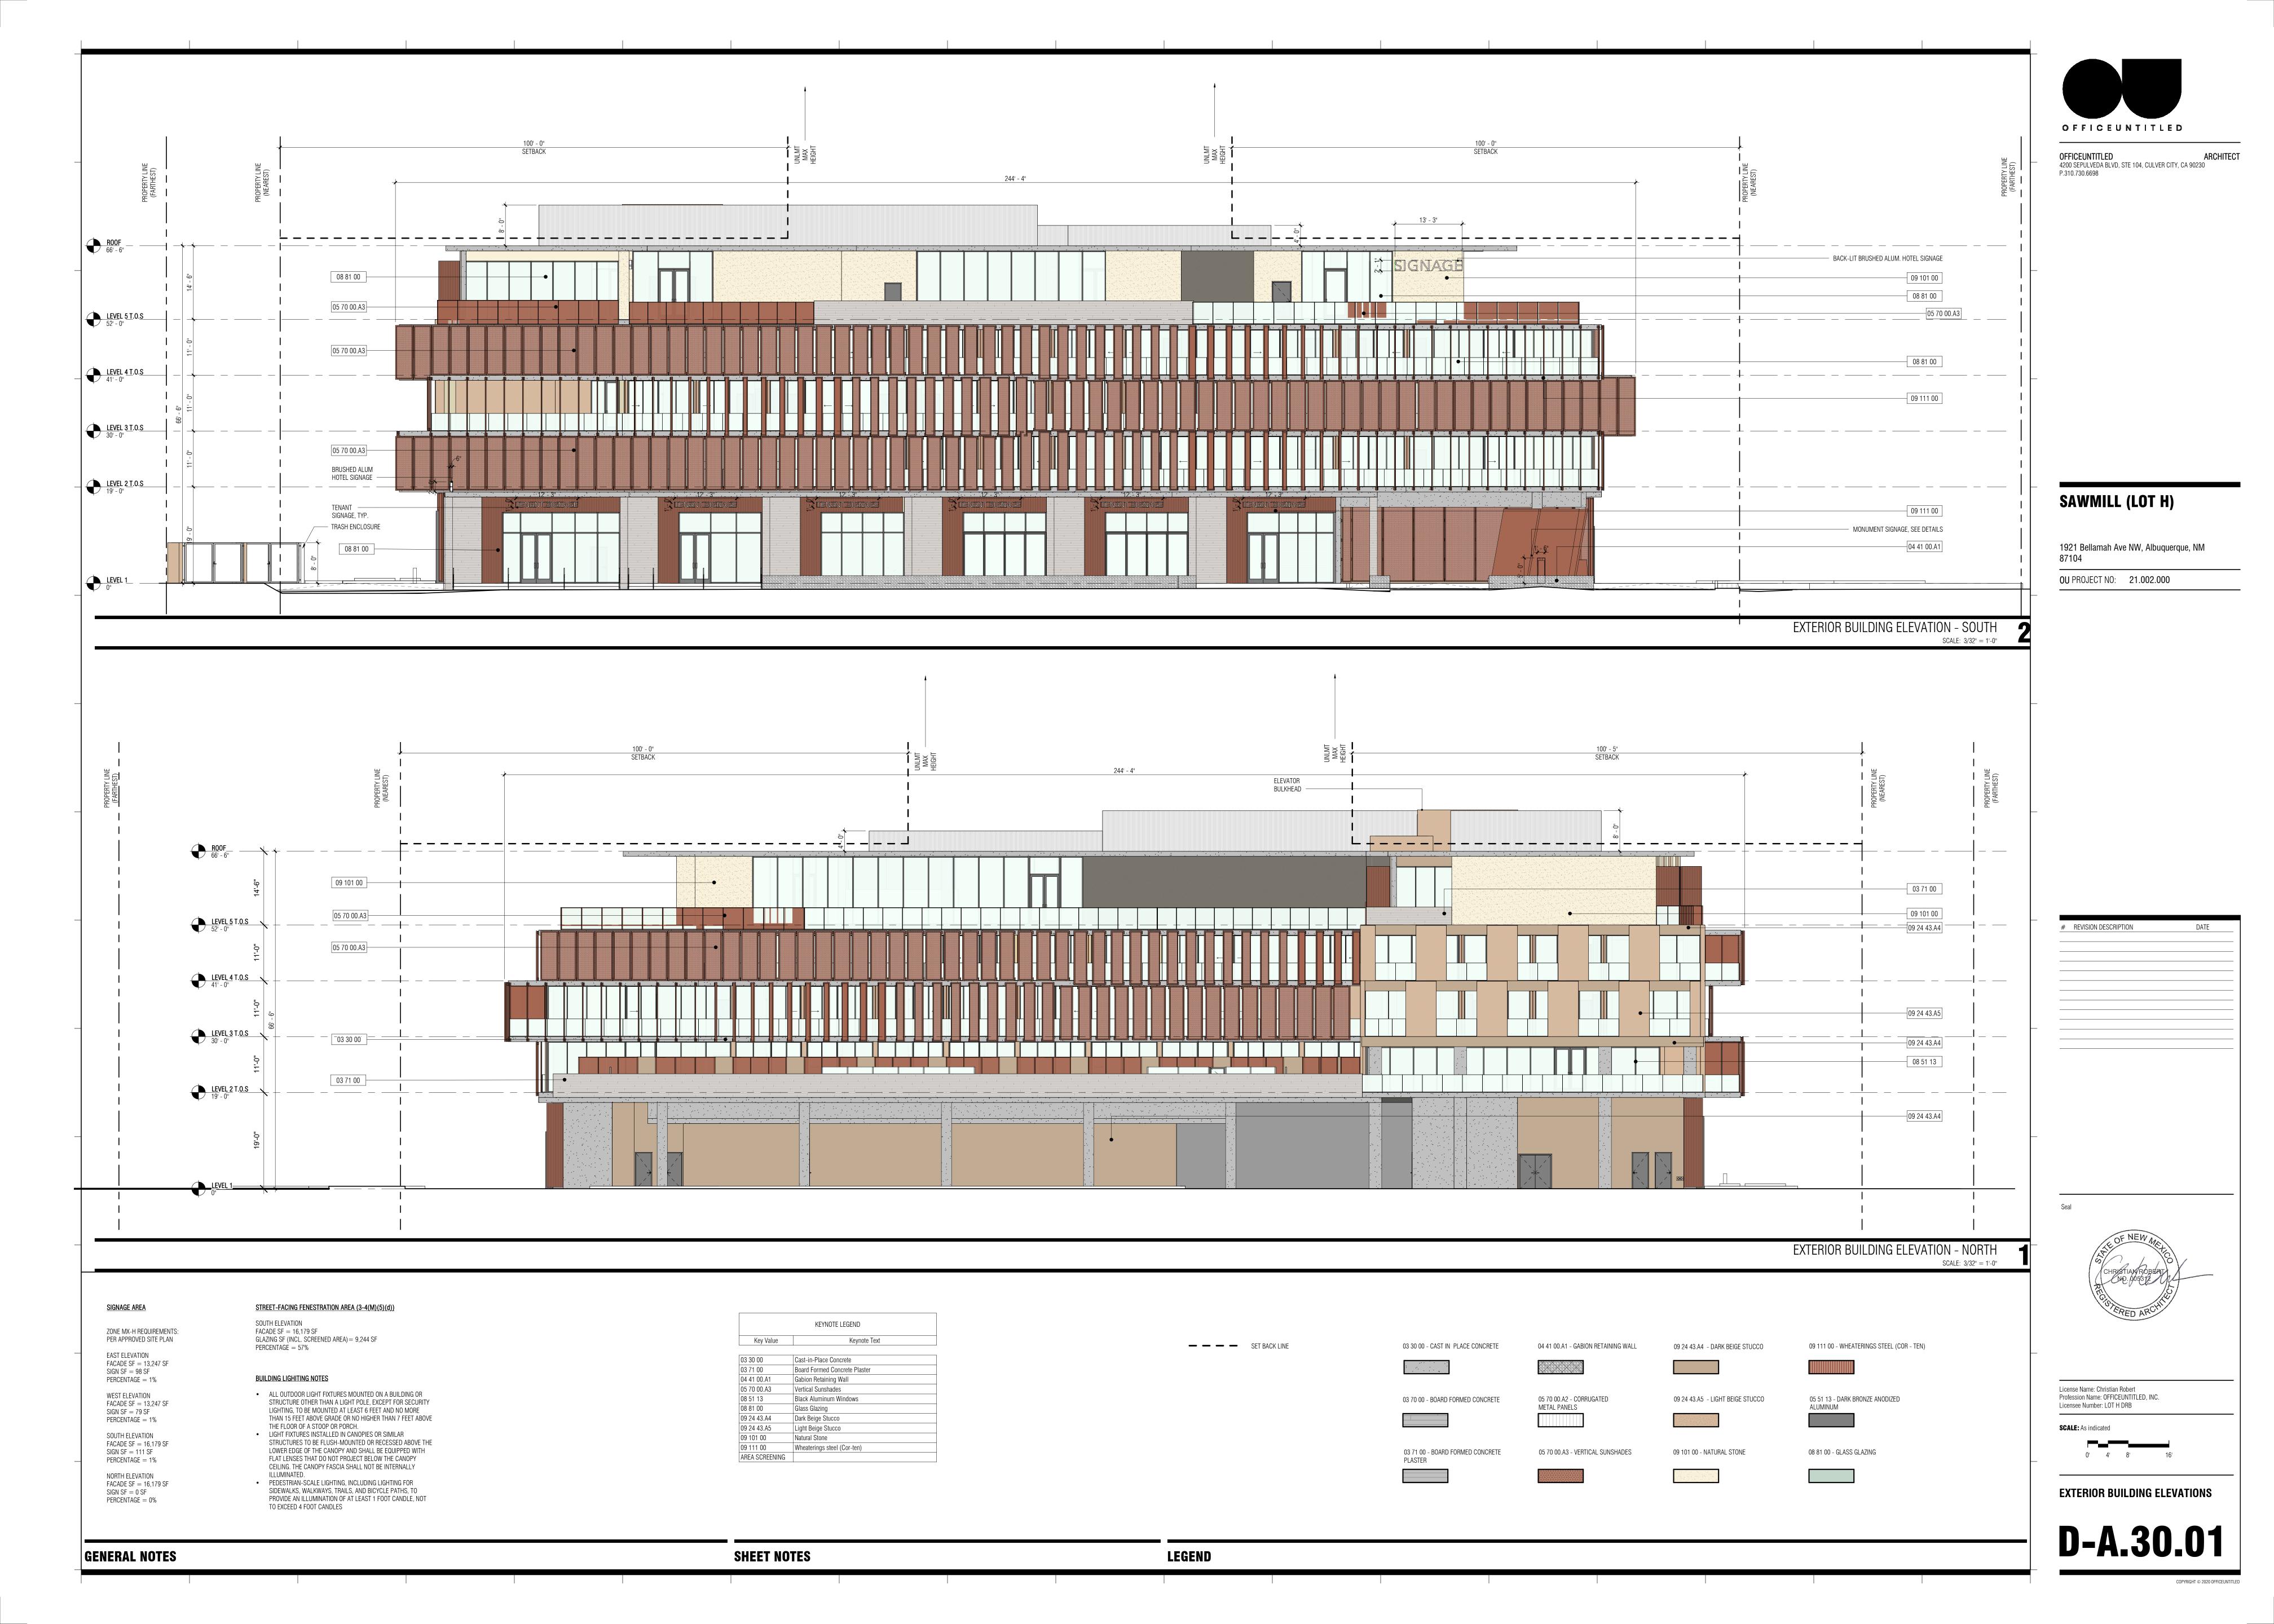

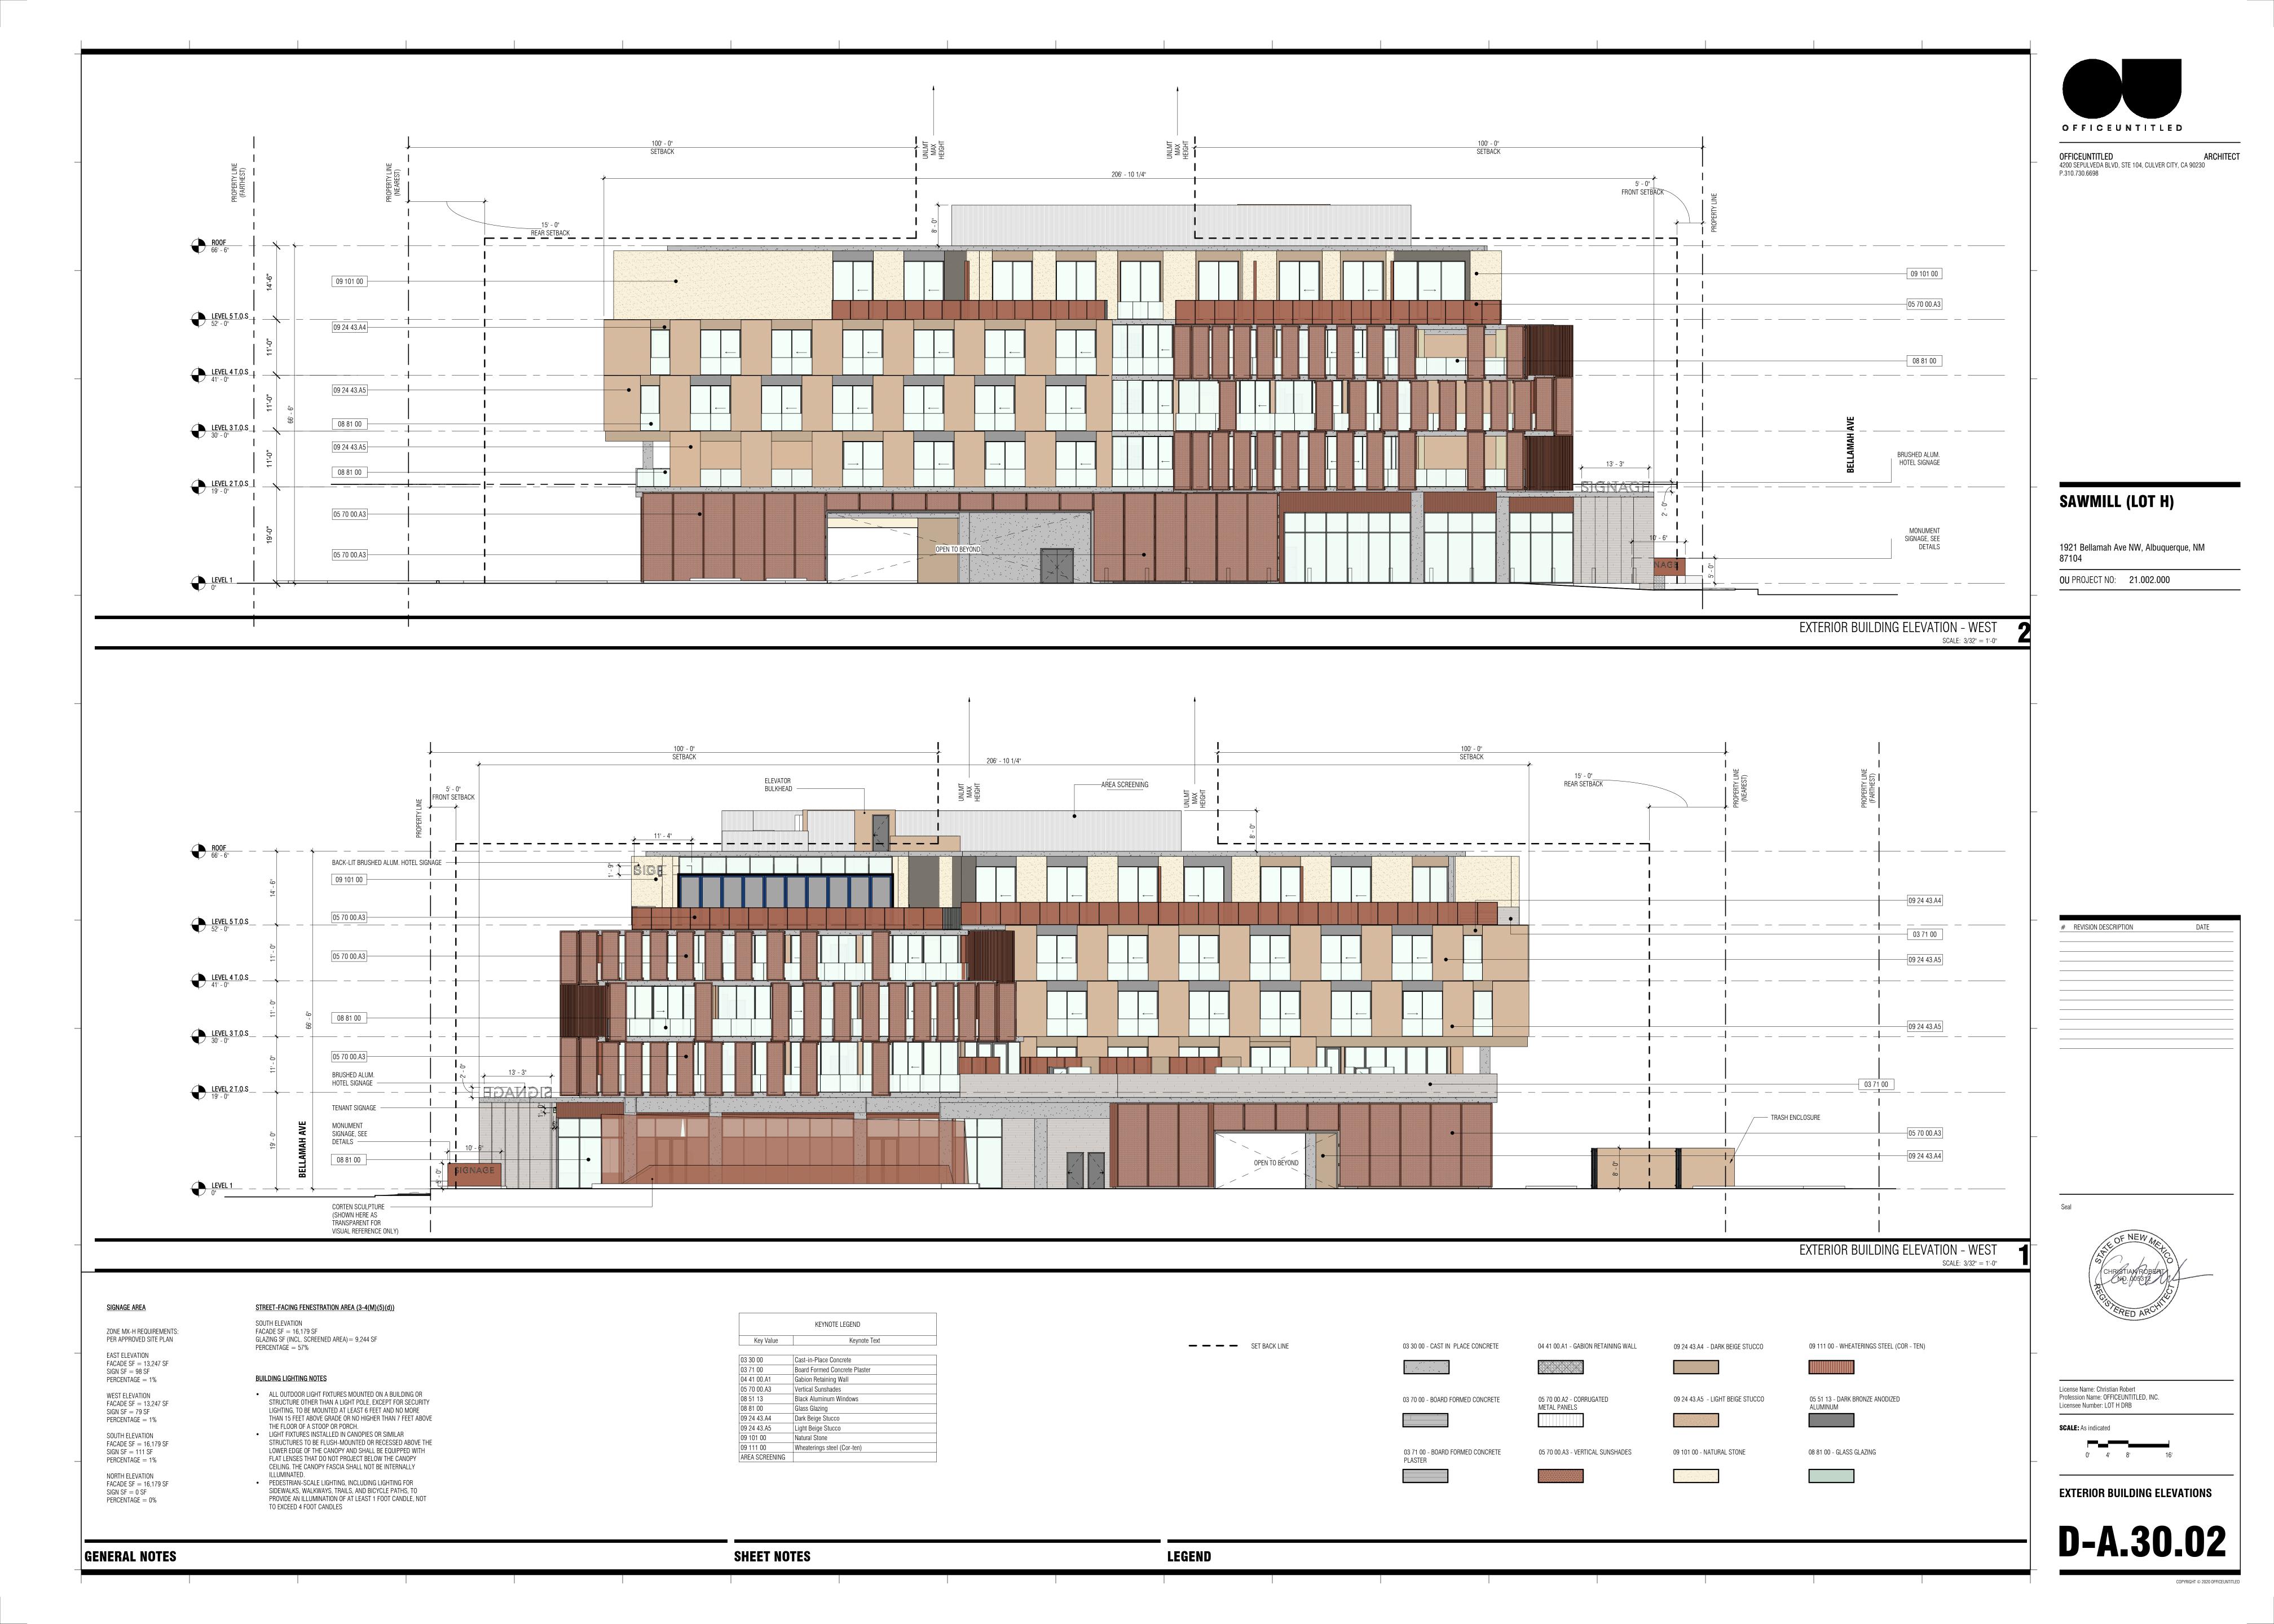

PR-2022-007155_SI-2022-02196_Site_Plan_Ap proved_12-21-22_Sheet_1

Final Audit Report 2022-12-30

Created: 2022-12-30

By: Jay Rodenbeck (jrodenbeck@cabq.gov)

Status: Signed

Transaction ID: CBJCHBCAABAAngFWryR2SmRIWFHsRWiM3R2dNhfqVD6y

"PR-2022-007155_SI-2022-02196_Site_Plan_Approved_12-21-2 2_Sheet_1" History

🖰 Document created by Jay Rodenbeck (jrodenbeck@cabq.gov)

2022-12-30 - 7:06:00 PM GMT- IP address: 73.242.135.213

Document emailed to jwolfley@cabq.gov for signature

2022-12-30 - 7:10:17 PM GMT

- Document emailed to Christina Sandoval (cmsandoval@cabq.gov) for signature 2022-12-30 7:10:17 PM GMT
- Email viewed by jwolfley@cabq.gov 2022-12-30 - 7:17:09 PM GMT- IP address: 143.120.133.169

Signer jwolfley@cabq.gov entered name at signing as Jolene Wolfley, CABQ Planning 2022-12-30 - 7:41:45 PM GMT- IP address: 143.120.133.169

Document e-signed by Jolene Wolfley, CABQ Planning (jwolfley@cabq.gov)

Signature Date: 2022-12-30 - 7:41:47 PM GMT - Time Source: server- IP address: 143.120.133.169

🖰 Email viewed by Christina Sandoval (cmsandoval@cabq.gov)

2022-12-30 - 7:44:23 PM GMT- IP address: 107.115.29.73

6 Document e-signed by Christina Sandoval (cmsandoval@cabq.gov)

Signature Date: 2022-12-30 - 7:44:34 PM GMT - Time Source: server- IP address: 107.115.29.73

Agreement completed.

2022-12-30 - 7:44:34 PM GMT

