

PROJECT INFORMATION

NEW OFFICE/WAREHOUSE 7226 CENTRAL AVE., SW ALBUQUERQUE, NEW MEXICO BRUNACINI DEVELOPMENT TATE FISHBURN ARCHITECT LEGAL DESCRIPTION: TRACTS 54, 55 & 1 TOWN OF ATRISCO

NR-C13.59 ACRES **BUILDING AREA:** OFFICE 2,937 GSF WAREHOUSE PHASE 1 47.063 GSF WAREHOUSE PHASE 2 65,000 GSF

GRANT UNIT 6

NO REQUIREMENT REQUIRED 11 SPACES

115,000 GSF PARKING ANALYSIS: OFF-STREET PARKING 2,937 GSF 3.5:1000 = 11 SPACES

112,063 GSF

TOTAL SPACES PROVIDED 75 SPACES HANDICAP PARKING (50-100 PRVD) = REQUIRED 4 SPACE TOTAL (1 VAN) PROVIDED 4 SPACE TOTAL (1 VAN) MOTORCYCLE PARKING $(1-25 \text{ RQD}) = \text{REQUIRED} \quad 1 \text{ SPACE}$

PROVIDED 1 SPACE 10% OF REQ'D or 3 = REQUIRED 3 SPACES PROVIDED 3 SPACES


Curve Table					
Curve #	Length	Radius	Delta	Chord Length	Chord Direction
C1	42.49' {42.45'}	25.00'	97°22'49"	37.56'	S 59°14'35" E
C2	39.23' {39.30'}	270.00'	819'32"	39.20'	S 06'23'24" E
С3	72.75' {72.68'}	330.00'	12°37'50"	72.60'	S 08'32'33" E
C4	76.76' {76.39'}	330.00'	13°19'36"	76.58'	S 21'31'15" E
C5	62.50' {62.50'}	270.00'	13°15'47"	62.36'	S 21'33'10" E
C6	72.89' {72.68'}	330.00'	12'39'18"	72.74	S 21"13'01" E
C7	59.49' {59.47'}	270.00'	12'37'24"	59.37	S 21'13'58" E


Line Table			
Line #	Direction	Length (ft)	
L1	N 89'18'08" W ((N 89'48'32" W))	129.99' (130.4')	
L2	N 14°33'44" W *(N 14°34'27" W)*	126.15'	
L3	N 14'41'34" W *(N 14'34'27" W)*	57.64' *(55.40')*	
L4	N 14°03'07" W *{N 15°06' W}*	40.73'	
L5	N 74°53'24" E *[N 74°53'24" E]*	40.01' *[40.00']*	
L6	S 72°06'00" W (*S 71°44'20" W*)	64.65'	
L7	N 14'20'05" W (*N 15'02'48" W*)	24.13' (*24.13'*)	
L8	S 71°16'46" W *[S 71°44'20" W]*	40.11' *[40.06']*	
L9	N 14'20'05" W (*S 15'02'48" E*)	59.86' (*60.00'*)	
L10	N 14°27'22" W *{N 15°06' W}*	100.08	
L11	N 14 ² 7'31" W	139.76'	

- 1) CONCRETE CURB, TYP.
- (2) (3) BICYCLE PARKING STALLS W/ 1' CLEAR ZONE AROUND STALL, REFER DETAIL 3/SDP-2
- 3 HC PARKING, RAMP & SIGN, REFER DETAIL 1/SDP-2
- (1) 4'X20' MOTORCYCLE PARKING SPACE & SIGN, REFER DETAIL 4/SDP-1, PARKING SPACE SHALL HAVE THE LETTERS 'MC' IN CAPITAL LETTERS, EACH OF WHICH SHALL BE AT LEAST ONE FOOT HIGH AND AT LEAST 2' WIDE PLACED AT THE REAR OF THE PARKING SPACE SO AS TO BE CLOSE TO WHERE VEHICLES REAR TIRE WOULD BE PLACED
- (5) 2" ASPHALT PAVING OVER 4" BASE COURSE
- 6) SIDEWALK & RAMPS PER COA STD DWG 2430 & 2415. ALL SIDEWALKS MUST HAVE A MIN. 4' PATHWAY AROUND ALL OBSTRUCTIONS WITHIN ROW. ROW DEDICATION MAY BE REQUIRED AND ALL WORK WITHIN ROW SHALL BE DONE UNDER A CITY WORK ORDER WITH ALL INFRASTRUCTURE ITEMS PLACED ON AN INFRASTRUCTURE LIST.
- (7) ENTRANCE DRIVE PER COA STD DWG 2426
- (8) REFUSE CONTAINER LOCATION
- (9) 4" CRUSHED RECYCLED ASPHALT
- (10) 10' WIDE CONCRETE SIDEWALK
- 11) RAMPS PER COA STD DWG 2430 & 2415
- (12) CONCRETE DRIVE @ TRUCK DOCK
- (13) ELEC. TRANSFORMER LOCATION
- (15) EXISTING BILL BOARD SIGN
- (16) NEW FIRE HYDRANT LOCATION (PRIVATE)
- 18) LINE OF FUTURE EXPANSION

INDEX TO DRAWINGS

SITE DEVELOPMENT PLAN SITE DETAILS **BUILDING ELEVATIONS** GRADING & DRAINAGE PLAN MASTER UTILITY PLAN LANDSCAPE PLAN

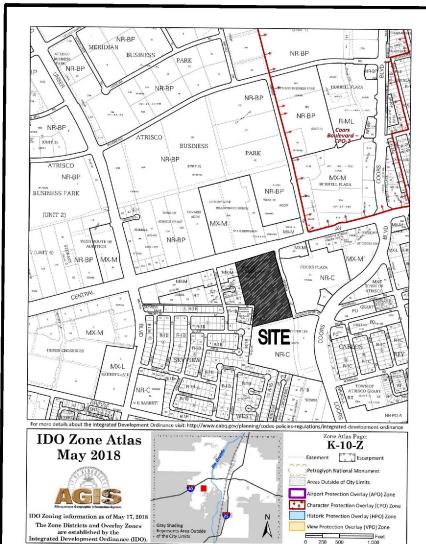

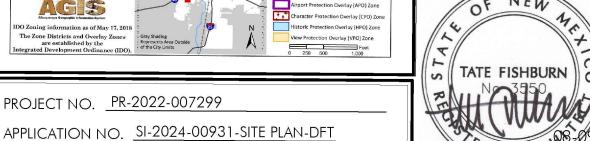

ENGINEERSEAL

ARCHITECT SEAL

PROJECT

Aug 28, 2024

Aug 28, 2024

Aug 29, 2024 Whitney Blelon Aug 28, 2024 PARKS & RECREATION DEPARTMENT

IS AN INFRASTRUCTURE LIST REQUIRED? () YES () NO IF YES, THEN A SET OF APPROVED DRC PLANS WITH A WORK

ORDER IS REQUIRED FOR ANY CONSTRUCTION WITHIN PUBLIC

RIGHT-OF-WAY OR FOR CONSTRUCTION OF PUBLIC IMPROVEMENTS.

Aug 28, 2024

PROJECT NO. <u>PR-2022-007299</u>

DFT SITE DEVELOPMENT PLAN APPROVAL:

TRAFFIC ENGINEER, TRANSPORTATION DIVISION

Ernest armyo

H Plen Aug 28, 2024 CODE ENFORCEMENT

*ENVIRONMENTAL HEALTH DEPARTMENT (CONDITIONAL)

PLANNING DEPARTMENT *ENVIRONMENTAL HEALTH, IF NECESSARY

SOLID WASTE MANAGEMENT

LEGEND

---- EASEMENT LINE

LANDSCAPED AREA

6' DESIGNMASTER FENCING, CLASSIC AND GATES AS NOTED SEE DETAIL 4/SDP-2

8' TALL OPAQUE FENCING AND GATES AS NOTED SEE DETAIL 4/SDP-2

PONDING PONDING AREA

SITE DISTANCE AND SITE TRIANGLE BASED ON COA DPM 7-4(I)(5)(iii) and 7-4(I)(5)(iv), LANDSCAPING AND SIGNAGE WILL NOT INTERFERE WITH CLEAR SIGHT REQUIREMENTS, THEREFORE SIGNS, WALLS, TREES, AND SHRUBBERY BETWEEN 3 AND 8 FEET TALL (AS MEASURED FROM THE GUTTER PAN) WILL NOT BE ACCEPTABLE IN THE CLEAR SITE

HANDICAP PARKING PAVEMENT MARKING

EXTERIOR LIGHT POLE LOCATION. SEE GENERAL NOTES FOR EXTERIOR LIGHTING REQUIREMENTS.

EXISTING FIRE HYDRANT **GENERAL NOTES**

- 1. THIS SITE PLAN MEETS THE REQUIREMENTS OF THE CITY OF
- ALBUQUERQUE IDO. ALL SITE LIGHTING SHALL COMPLY WITH IDO SECTION 14-16-5-8.
- OUTDOOR AND SITE LIGHTING. PLACEMENT OF FIXTURES & STANDARDS SHALL CONFORM TO STATE & LOCAL SAFETY & ILLUMINATION REQUIREMENTS.
- 4. ALL LIGHT FIXTURES SHALL BE FULLY SHIELDED HORIZONTAL LAMPS WITH NO LIGHT, LENS OR BULB PROTRUDING BELOW THE BOTTOM OF THE CUT-OFF FIXTURE IN ORDER THAT NO FUGITIVE LIGHT SHALL ESCAPE BEYOND THE PROPERTY LINE AND NO SITE LIGHTING LIGHT SOURCE SHALL BE VISIBLE FRO THE SITE PERIMETER.
- ROOF TOP AND GROUND MOUNTED EQUIPMENT SHALL BE SCREENED FROM THE PUBLIC VIEW BY MATERIALS OF THE SAME NATURE AS THE BUILDINGS BASIC MATERIALS. THE TOP OF ALL ROOFTOP EQUIPMENT SHALL BE BELOW THE TOP OF THE PARAPET OR SCREENED FROM VIEW FROM PUBLIC RIGHTS-OF-WAY AND THE SITE ACCESS EASEMENT. SITE HANDICAP RAMPS SHALL BE BUILT BY COA STANDARD DRAWING
- 7. ALL IMPROVEMENTS LOCATED IN THE RIGHT OF WAY MUST BE INCLUDED ON THE WORK ORDER.

AUGUST 9, 2024 1"=60'-0" OR AS NOTED

BR

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REVISIONS

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SITE DEVELOPMENT PLAN

DRAWING NAME



PROJECT

T INDUS
DEVELOP
AL AVE.,
NEW M SKYVIEW WEST FOR BRUNACINI D 7226 CENTRA ALBUQUERQUE, I

FENCING DETAILS
1/2"=1'-0"

DESIGNMASTER FENCING

DESIGNMASTER FENCING-STYLE CLASSIC. COLOR

MOTORCYCLE PARKING ONLY — TUBE STEEL FRAME 1" X 2" STEEL TUBE FRAME,
MITRE CORNERS

12" X 18" CUSTOM METAL SIGN,
BACKGROUND COLOR SELECTED BY
ARCHITECT TO MATCH BUILDING
COLOR, SYMBOL & LETTERS TO
BE CONTRASTING COLOR SELECTED
BY ARCHITECT, ATTACH SIGN TO
1/2" BAR STOCK SUPPORTS W/
VANDAL PROOF BOLTS, NO
FASTENERS EXPOSED ON FACE.
INCLUDE WORDING 'VIOLATORS ARE
SUBJECT TO A FINE AND/OR
TOWING' ON ADA SIGNAGE PARKING ONLY
VIOLATIONS ARE SUBJECT TO A FINE AND/OR TOWING

VAN
ACCESSIBLE —1/2"BAR STOCK WELD ANGLE
TO SIGN FACE
PLATE, STOP
ANGEL 1"
FROM EDGES VAN ACCESSIBLE SIGN REQ'D ONLY AT HC VAN PARKING LOCATIONS AS SHOWN ON SITE PLAN PAINT SIGN SUPPORT, COLOR SELECTED BY ARCHITECT SELECTED BY ARCHITECT

SELECTED BY ARCHITECT

SET FRAME IN 6" DIA, CONC.
FOOTING, 8" BELOW FINISH

GRADE


SIGN ELEVATION

PARKING SIGNS 3/4"=1'-0"

SECTION

OPAQUE FENCING

_ METAL PANELS TO MATCH BUILDING. COLOR GREY

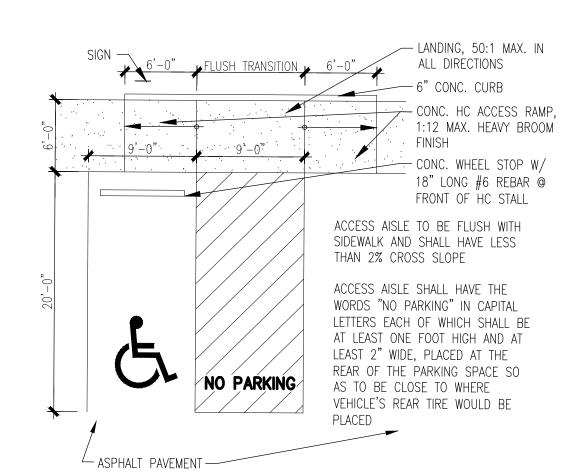

ACCESSIBLE PARKING & PATHWAY

DATE AUGUST 9, 2024


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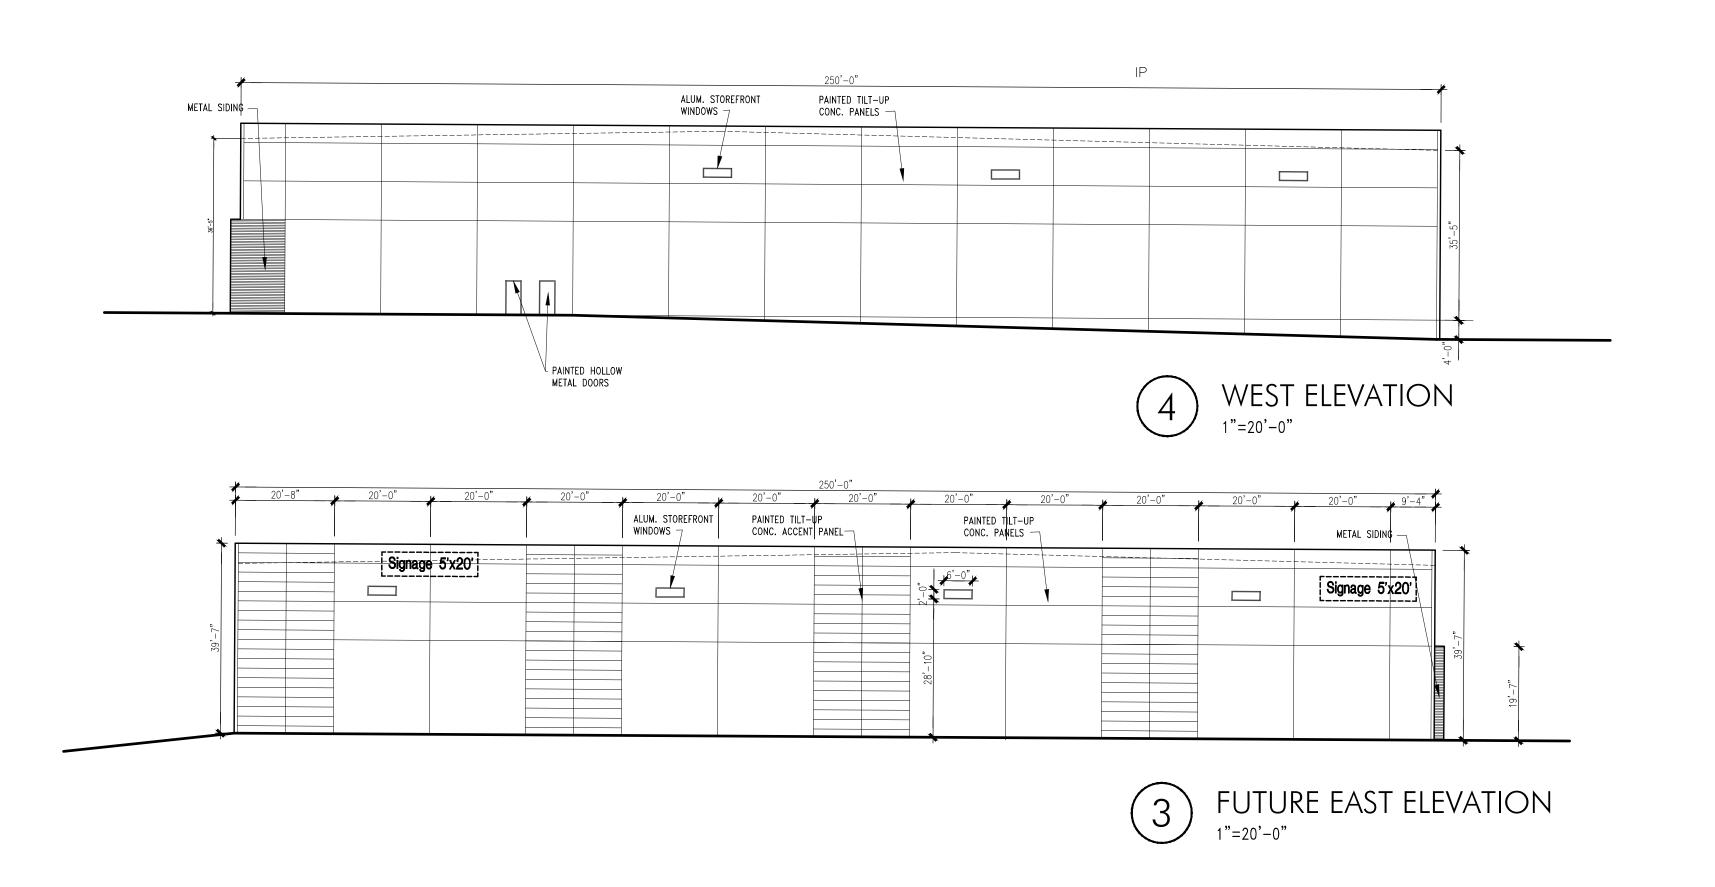
OR AS NOTED

DRAWING NAME SITE DEVELOPMENT PLAN- SITE DETAILS

SHEET NUMBER

SDP-2



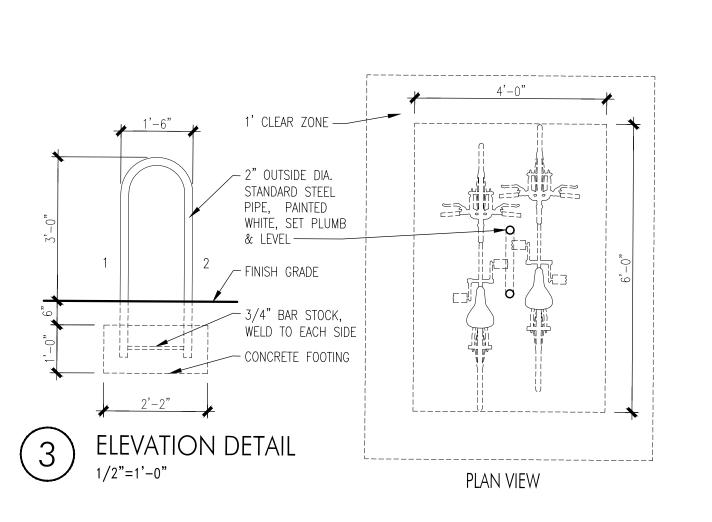


METAL ACCENT COLOR- WHITE ALUMINUM WINDOW FRAMES- CLEAR ANODIZED WINDOW GLAZING- 1" TINTED INSULATED TINT COLOR- SOLAR GRAY

ALL BUILDING MOUNTED LIGHT FIXTURES SHALL BE FULLY SHIELDED HORIZONTAL LAMPS WITH NO LIGHT, LENS OR BULB PROTRUDING BELOW THE BOTTOM OF THE CUT-OFF FIXTURE IN ORDER THAT NO FUGITIVE LIGHT SHALL ESCAPE BEYOND THE PROPERTY LINE AND NO SITE LIGHTING LIGHT SOURCE SHALL BE VISIBLE FRO THE SITE PERIMETER.

ALL BUILDING MOUNTED SIGNAGE TO BE LIGHTED EITHER INTERNALLY OR EXTERNALLY. ANY LIGHTING FOR SIGNAGE SHALL CONFORM TO NIGHT SKIES ACT. SIGNAGE MATERIAL TO BE EITHER RAISED METAL LETTERING OR TRANSLUCENT LEXAN PANELS OF ANY COLOR. NO BOX SIGNAGE ALLOWED. INDIVIDUAL RAISED LETTERS ONLY.

NORTH ELEVATION- BLDG. AREA.-17,851 S.F. SIGNAGE- 500 S.F. 500 / 17,851 = 2.8%

GRAPHIC SCALE

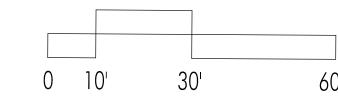

FACADE DESIGN COMPLIANCE IDO 5-11(E)(2) PROJECT FACADE DESIGN COMPLIES WITH IDO 5-11(E)(2). THERE ARE NO STREET FACING FACADES WITHIN 30' OF ROW PER THE IDO DEFINITION. IT ALSO COMPLIES WITH 5-11(E)(2)a AND 5-11(E)(2)6 AS THERE ARE NO STREET FACING FACADES WITHIN 30' OF ROW.

EXTERIOR FINISHES

TILT-UP CONC. PANELS- FIELD COLOR - LIGHT GRAY TILT-UP CONC. PANELS- ACCENT COLOR - MEDIUM GRAY TILT-UP CONC. PANELS- ACCENT COLOR - BLUE


METAL SIDING-COLOR- DARK GRAY

OVERHEAD & HM DOORS- LIGHT GRAY

ARCHITECT SEAL

BUILDING SIGNAGE CALCS:

EAST ELEVATION- BLDG. AREA.-9,917 S.F. SIGNAGE- 200 S.F. 200 / 9,917 = 2%

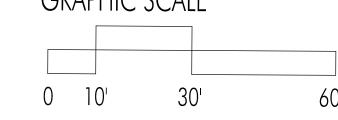

PROJECT

TATE FISHBURN

ENGINEER SEAL

7226 CENTRA Albuquerque, I

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REVISIONS

AUGUST 9, 2024

OR AS NOTED


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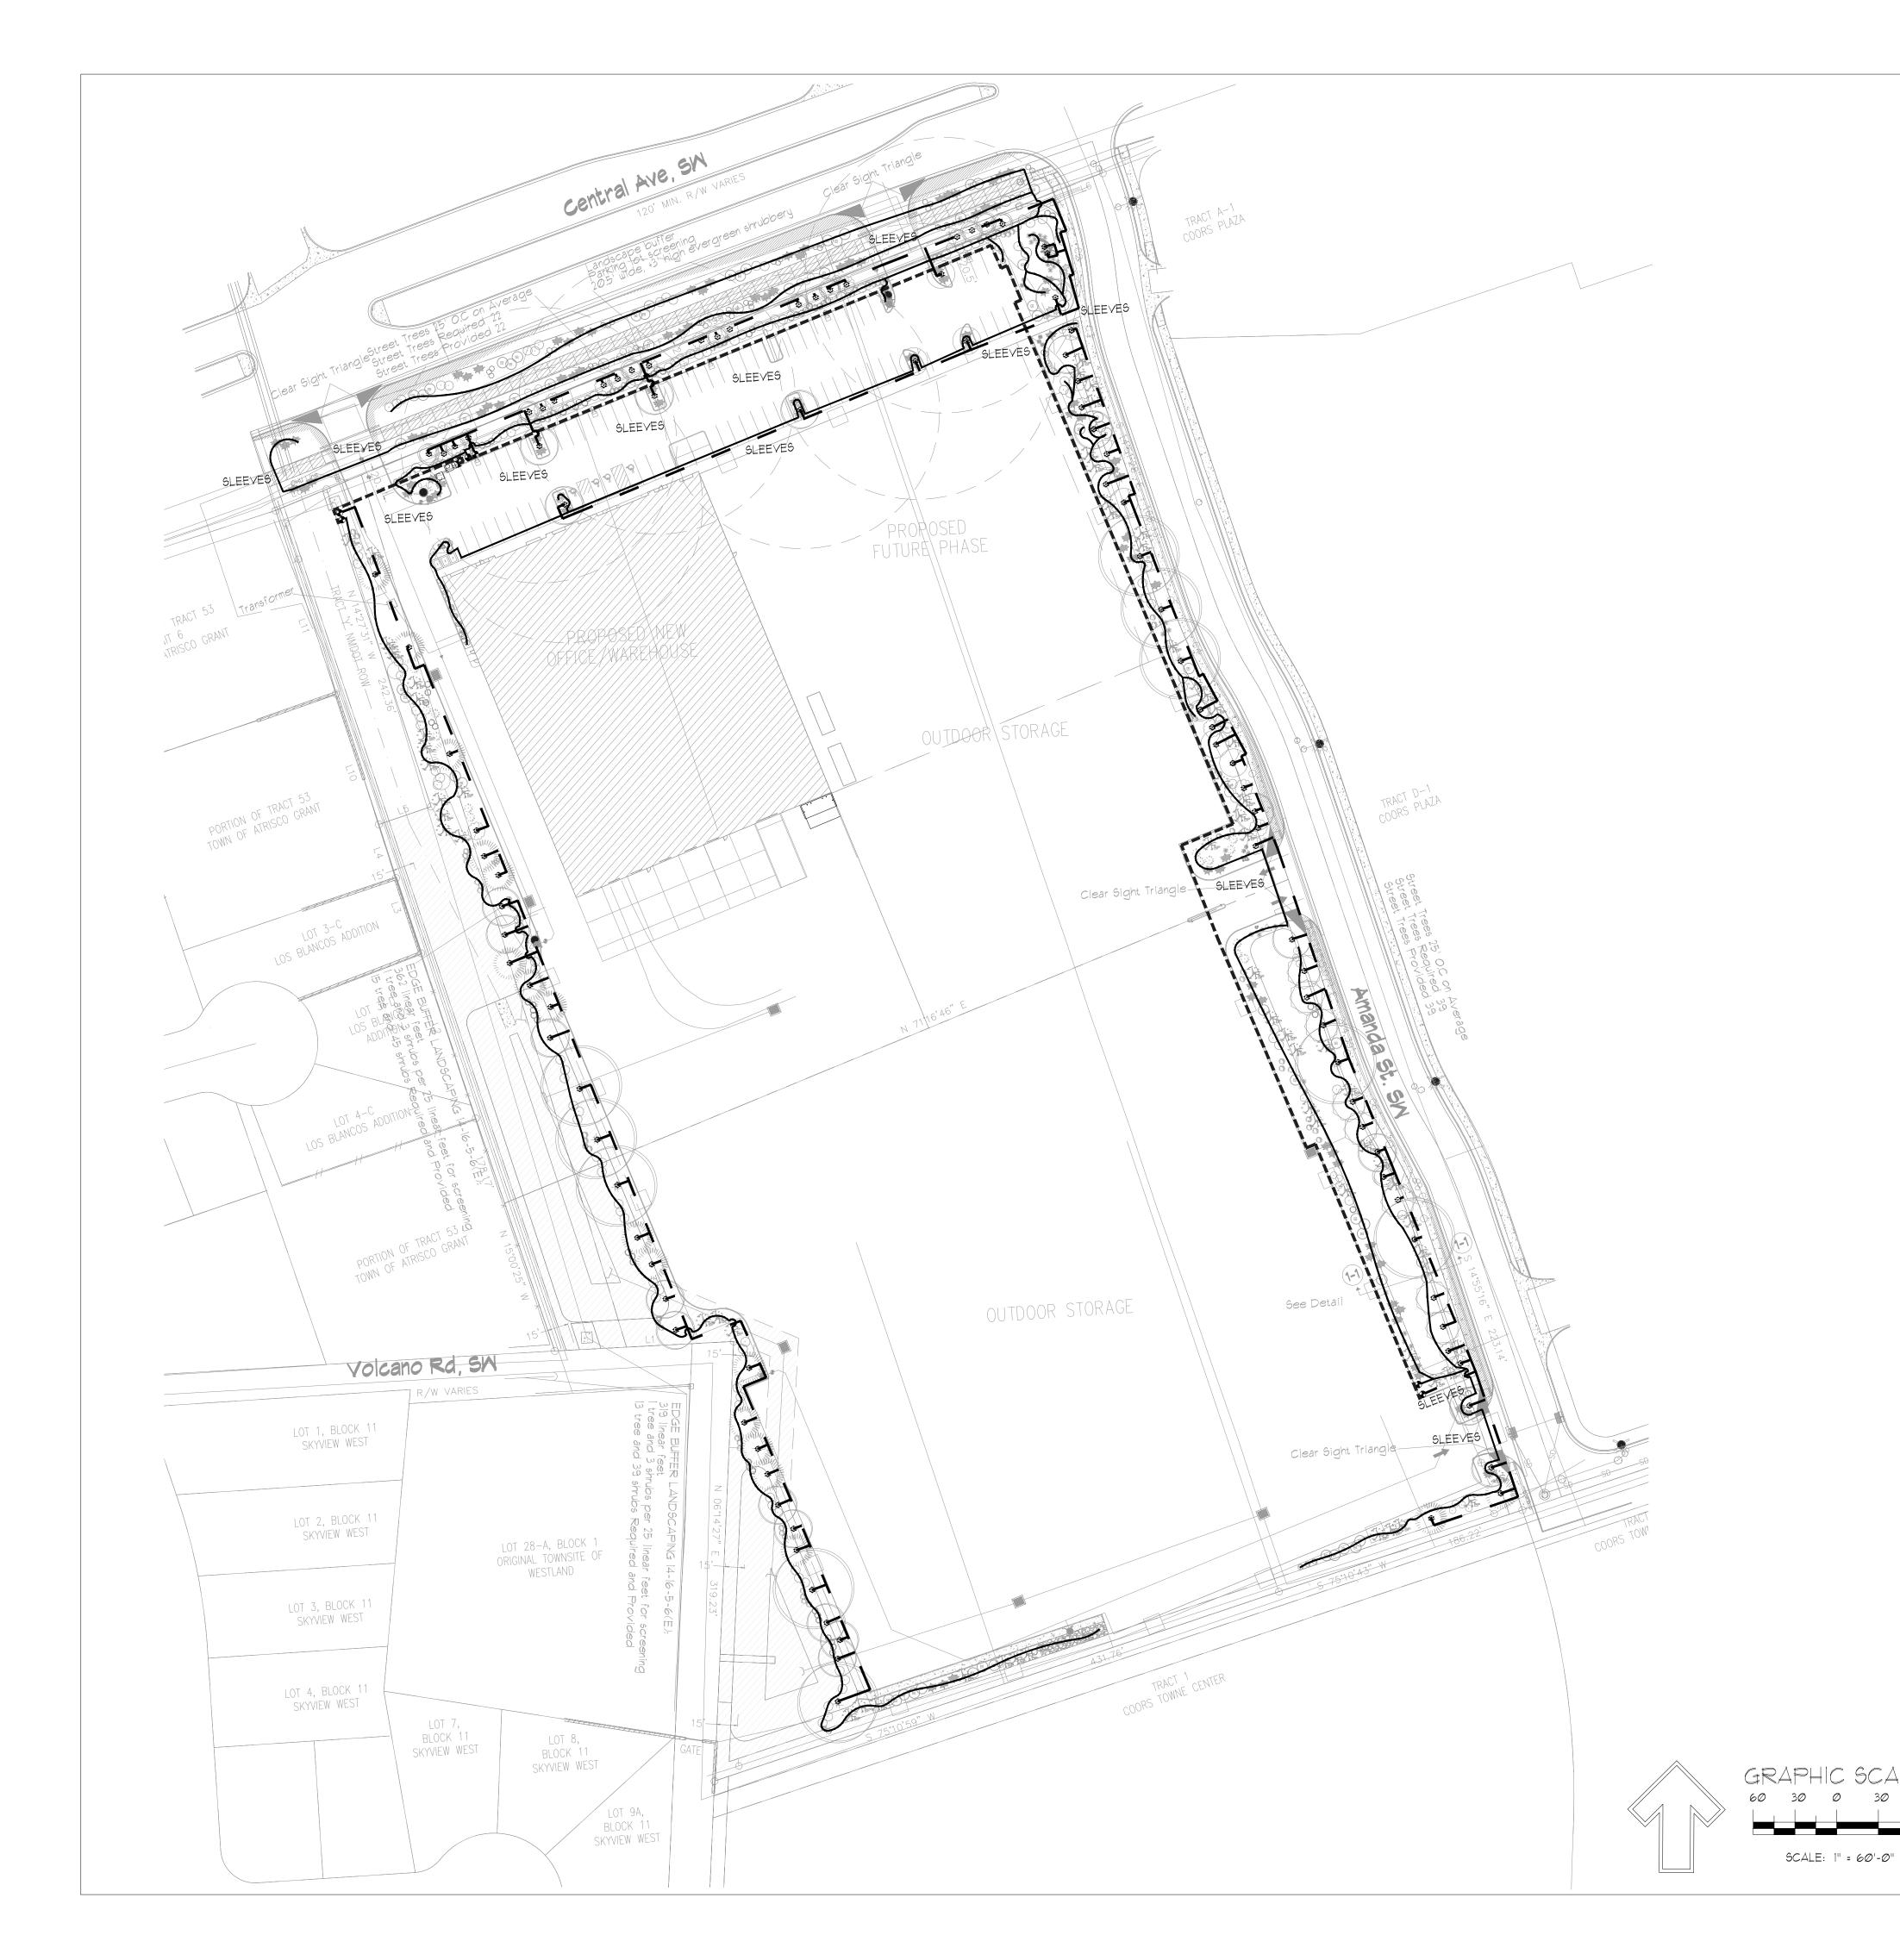
BUILDING ELEVATIONS

SHEET NUMBER

SDP-3





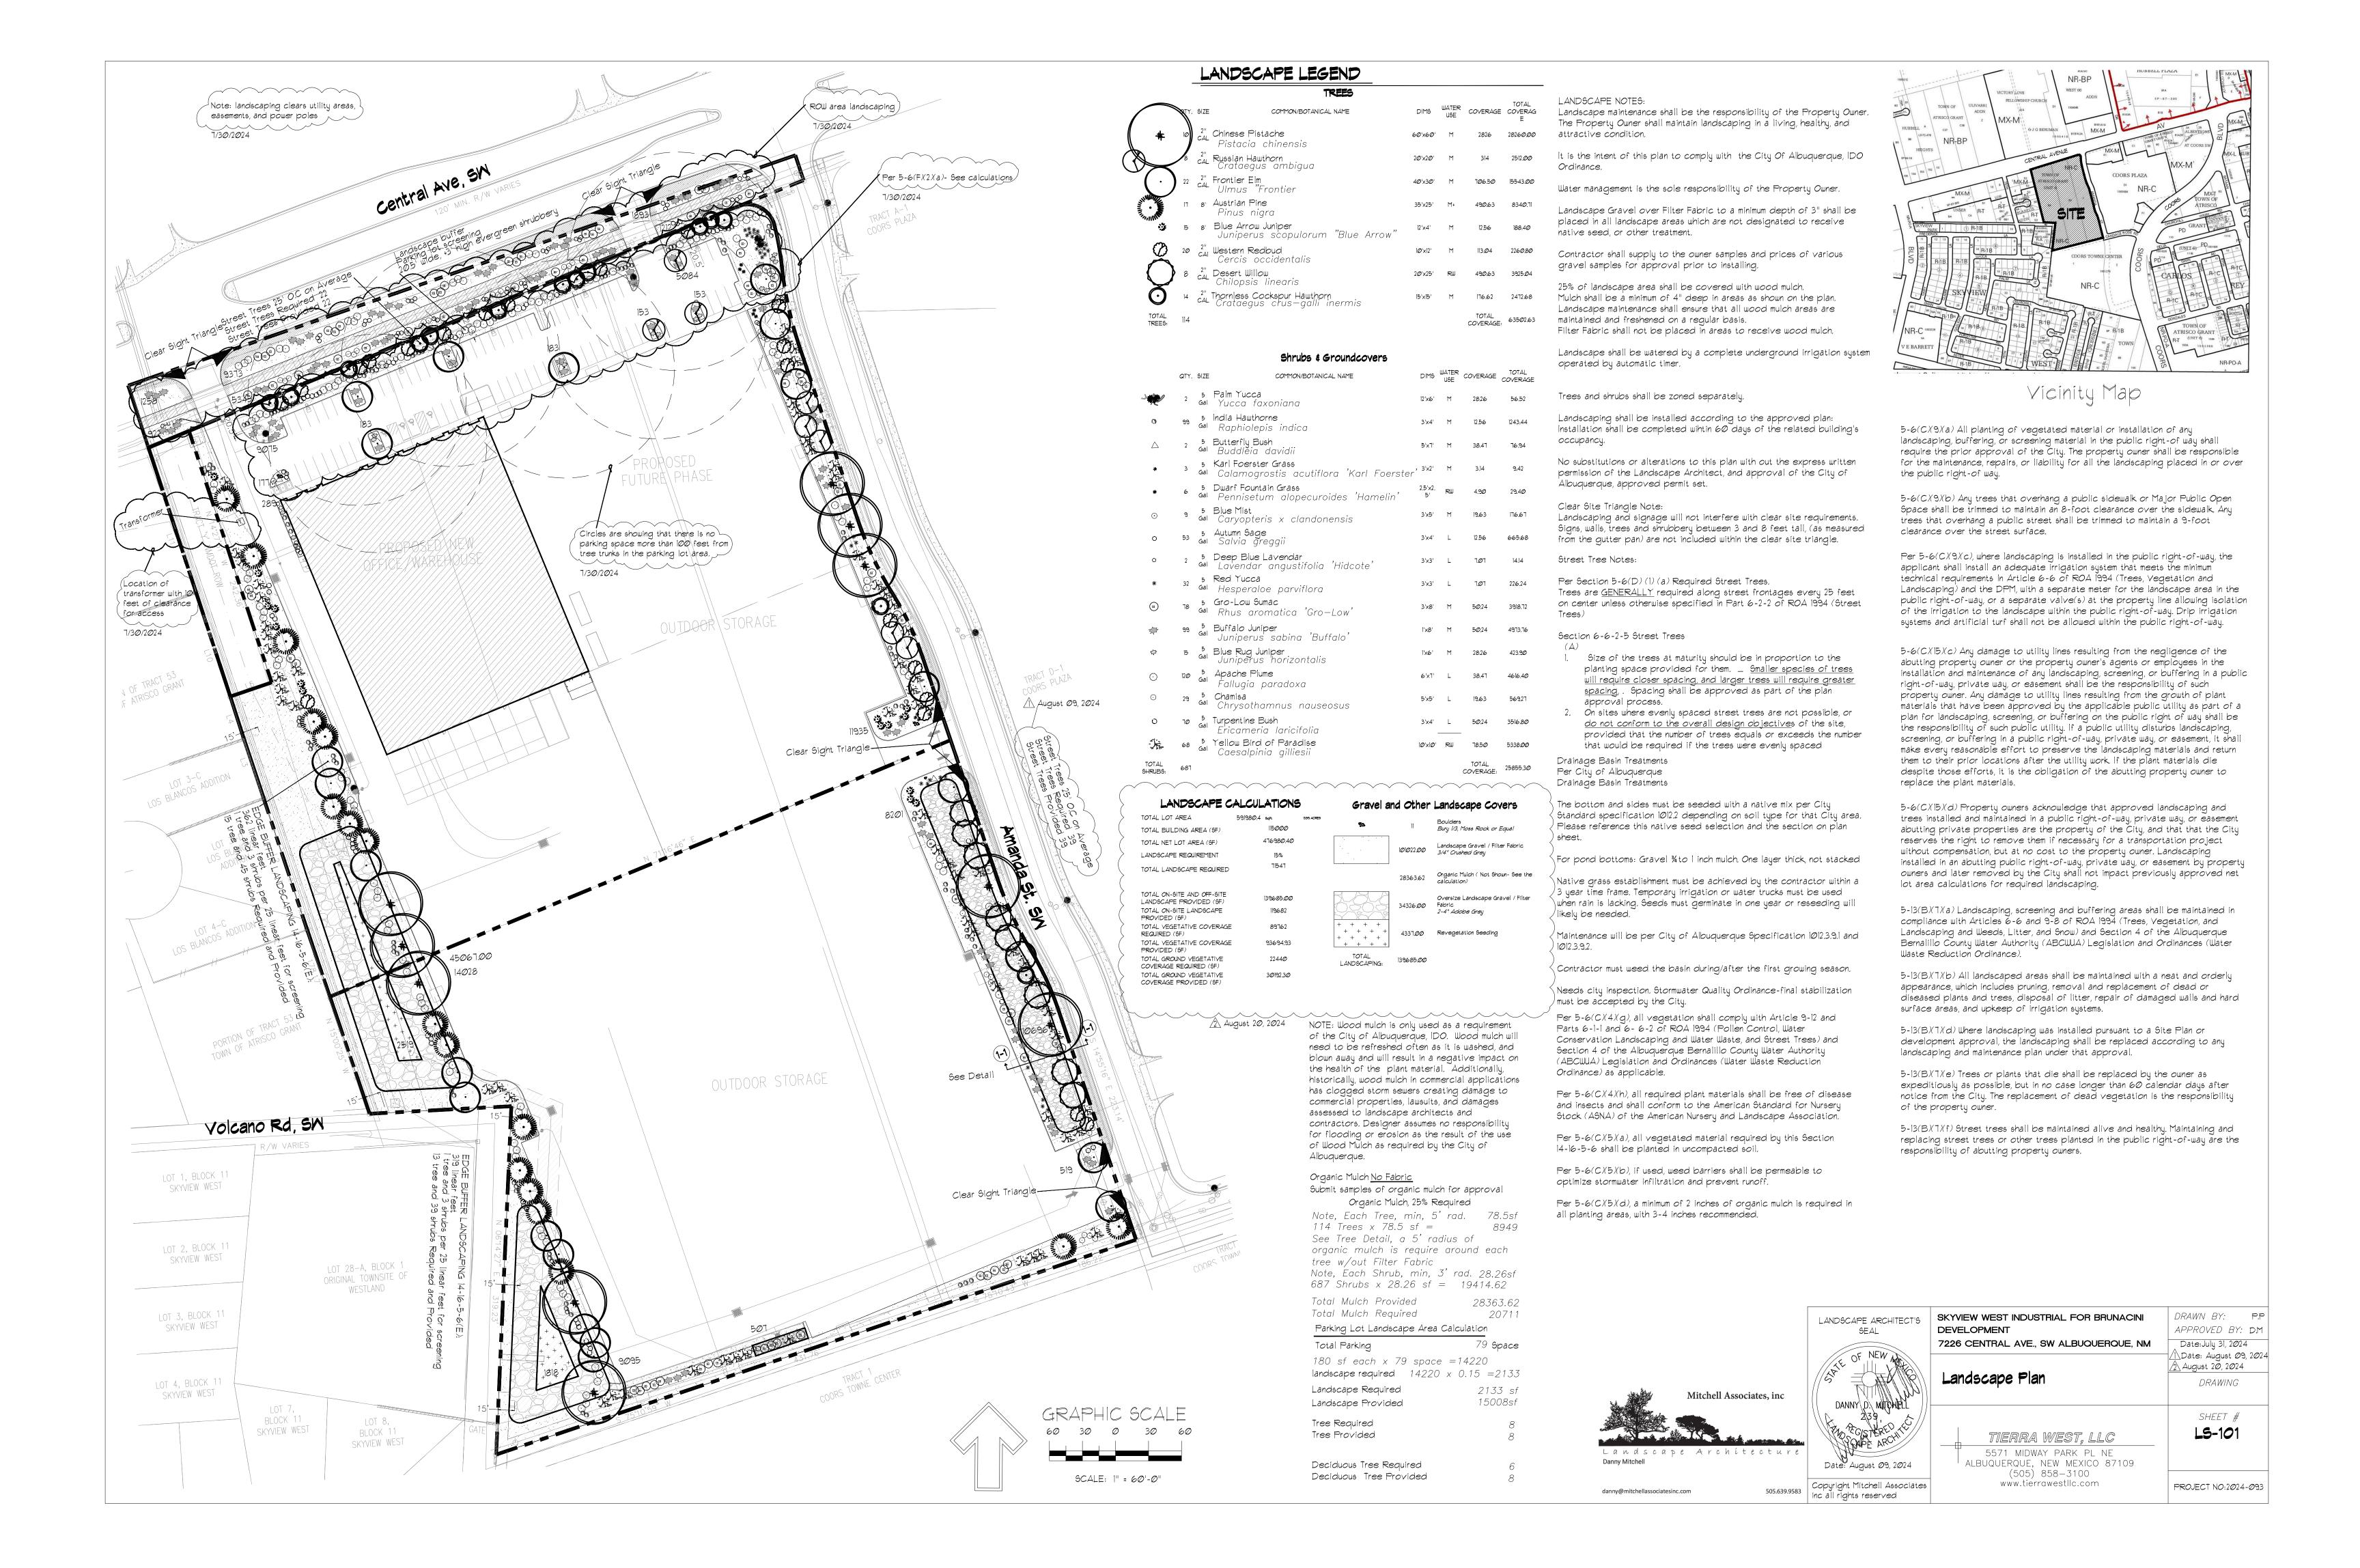

IRRIGATION LEGEND

MANUFACTURER POINT OF CONNECTION, PROVIDED BY OTHERS SEE CIVIL PLANS IRRIGATION CONTROLLER HUNTER 1 1/2", 100gpm, 70psi required As Required FEBCO (OR EQUAL) 11/2" Cover, Provide Freeze Protection I RPA HOTBOX ⊕ MASTERVALVE ASSEMBLY HUNTER Sch 40 PVC ---- MAINLINE 3/4" with Pressure Regulation and Y Filter 2 SIZES LARGER THAN PIPE TO BE SLEEVED. ◆ ELECTRIC ZONE VALVE HUNTER Class 200 PVC ── SLEEVES — Drip Line, Tree Netafim Rings Class 200 PVC Drip Line, Shrub Drip Emitter Line
Tree Drip Emmiter Polyline RAINBIRD, SEE DETAIL

Size Equipment as Required for Flow Rate

IRRIGATION NOTES

- I. CONTRACTOR SHALL VERIFY ALL DIMENSIONS, ELEVATIONS, EQUIPMENT QUANTITIES, AND UTILITY LOCATIONS PRIOR TO BEGINNING
- 2. CONTRACTOR SHALL NOTIFY LANDSCAPE ARCHITECT OF ANY DISCREPANCIES IN PLANS OR SPECIFICATIONS PRIOR TO BEGINNING OR CONTINUING WORK.
- 3. THE IRRIGATION CONTRACTOR SHALL MAKE NO SUBSTITUTIONS, DELETIONS, OR ADDITIONS TO THIS PLAN WITHOUT APPROVAL OF THE LANDSCAPE ARCHITECT.
- 4. ALL CONSTRUCTION SHALL CONFORM TO CITY, COUNTY, STATE, AND FEDERAL REQUIREMENTS. IT SHALL BE THE RESPONSIBILITY OF THE IRRIGATION CONTRACTOR TO ENSURE THAT ALL IRRIGATION EQUIPMENT MEETS GOVERNMENT REGULATIONS, CONTRACTOR SHALL ALSO BE RESPONSIBLE FOR OBTAINING ANY NECESSARY PERMITS OR APPROVALS.
- 5. THIS PLAN IS SCHEMATIC AND DUE TO THE NATURE OF CONSTRUCTION SLIGHT FIELD MODIFICATIONS MAY BE NECESSARY TO IMPLEMENT
- 6. IRRIGATION SYSTEMS CONNECTED TO POTABLE WATER SUPPLY, SHALL HAVE A BACKFLOW PREVENTER INSTALLED.
- T. IRRIGATION LATERAL LINES, MAIN LINES AND EQUIPMENT MAY BE SHOWN OUTSIDE PROPERTY LINES ON THIS PLAN, ALL IRRIGATION LINES AND EQUIPMENT ARE TO BE WITHIN AND INSTALLED WITHIN THE LIMITS OF THE PROPERTY LINE.
- 8. ALL IRRIGATION SLEEVING TO BE THE RESPONSIBILITY OF THE IRRIGATION CONTRACTOR, ELECTRICAL WIRES FOR IRRIGATION VALVES AND IRRIGATION LINES ARE TO BE PLACED IN. SEPARATE SLEEVES, SEE SLEEVING DETAIL.
- 9. SUPPLY LINE AND WATER METER TO BE PROVIDED BY OWNERBACKFLOW PREVENTOR TO BE PROVIDED BY IRRIGATION CONTRACTOR. IRRIGATION CONTRACTOR'S POINT OF CONNECTION TO BEGIN DOWNSTREAM OF THE IRRIGATION WATER METER.

IRRIGATION NOTES:

Irrigation shall be a complete underground system.

Trees and shrubs shall be on separate valves.

Point of connection for irrigation system shall be as indicated on the Utility Plan, Civil drawings. Landscape Contractor point of connection and responsibility shall begin downstream of the point of connection.

Irrigation will be operated by smart irrigation system automatic controller, capable of multi-programming ability.

Location of controller to be field determined and power source for controller to be provided by the owner.

Irrigation maintenance shall be the responsibility of the

Property Owner.

Water and Power source for irrigation system shall be the responsibility of the Property Owner.

Per 5-6(C)(14)(a), irrigation systems shall comply with Section 8 of the ABCWUA Legislation and Ordinances (Cross Connection Prevention and Control Ordinance).

Per 5-6(CX14Xb), all irrigation systems shall be designed to minimize the use of water.

5-6(C)(14)(c), all non-residential landscape irrigation shall have automatic timers and/or programmable settings to avoid

Per 5-6(CX14Xd), the irrigation system shall not spray or irrigate impervious surfaces, including sidewalks, driveways, drive aisles, streets, and parking and loading areas.



Danny Mitchell

danny@mitchellassociatesinc.com


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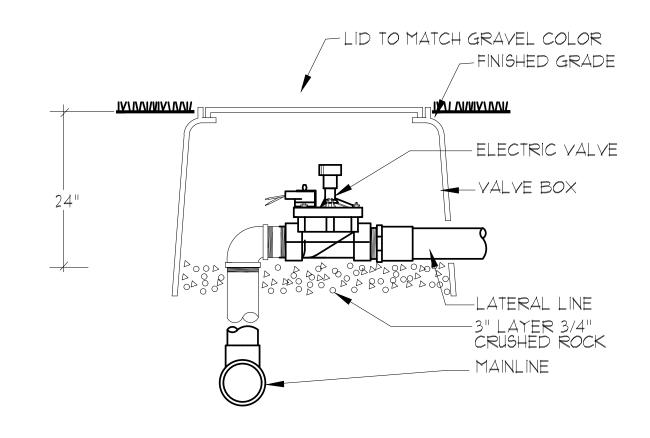
SEAL

DRAWN BY: P.P SKYVIEW WEST INDUSTRIAL FOR BRUNACINI LANDSCAPE ARCHITECT'S DEVELOPMENT APPROVED BY: DM 7226 CENTRAL AVE., SW ALBUQUERQUE, NM Date:July 31, 2024 DRAWING SHEET # L5-102 TIERRA WEST, LLC 5571 MIDWAY PARK PL NE ALBUQUERQUE, NEW MEXICO 87109 (505) 858-3100

PROJECT NO:2024-093

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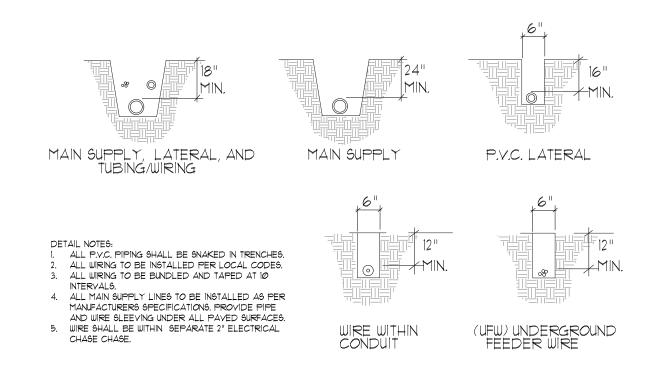


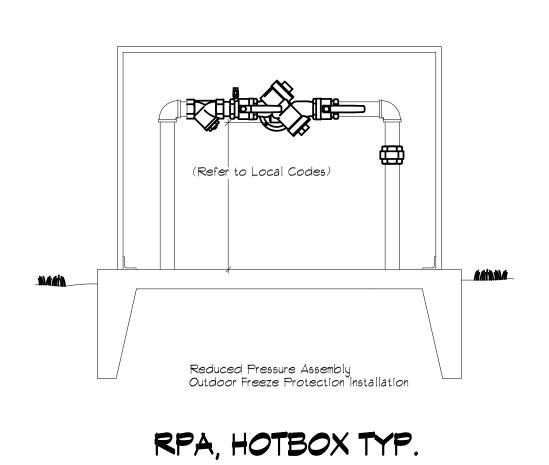


ELECTRIC VALVE ASSEMBLY

N.T.S.


NOTE: ALL IRRIGATION COMPONENTS WILL USE RECLAIMED WATER WHEN IT BECOMES AVAILABLE TO MESA DEL SOL




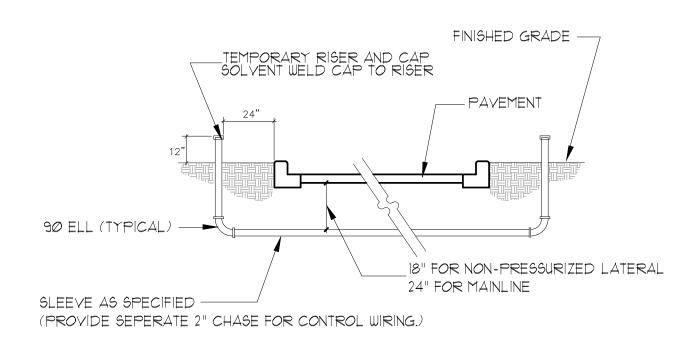

TRENCHING DETAIL

SLEEVE INSTALLATION DETAIL

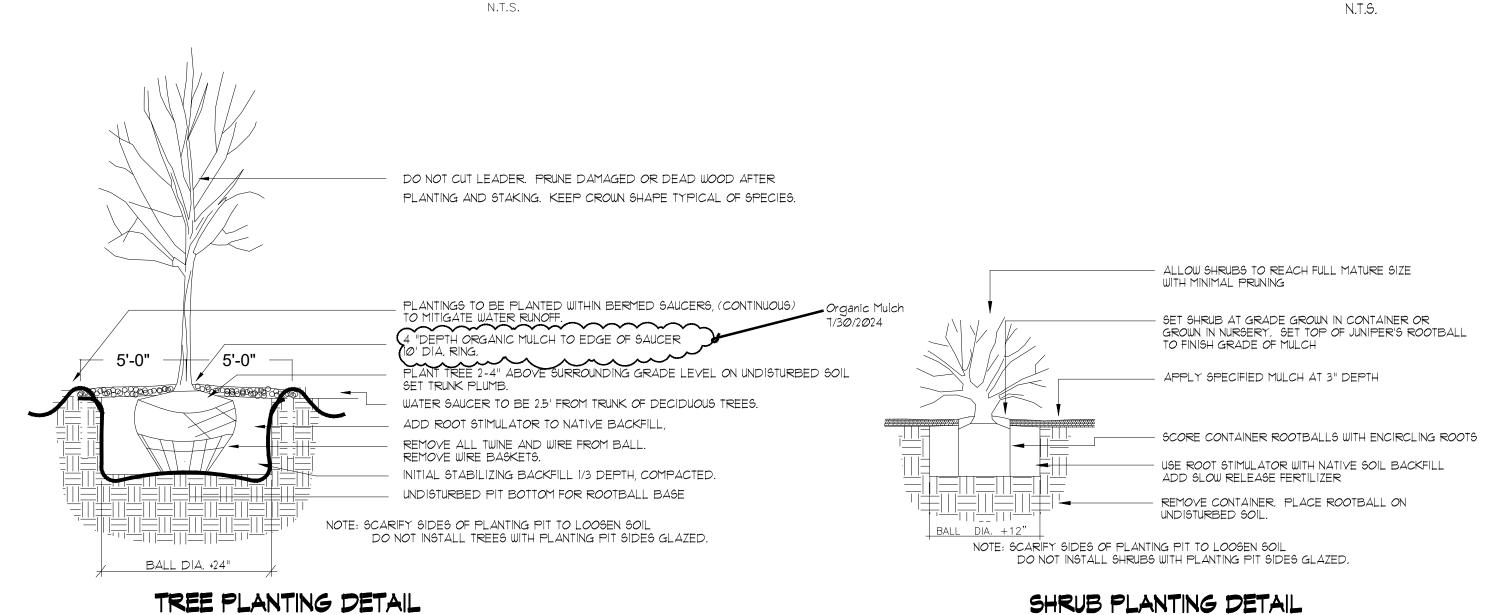


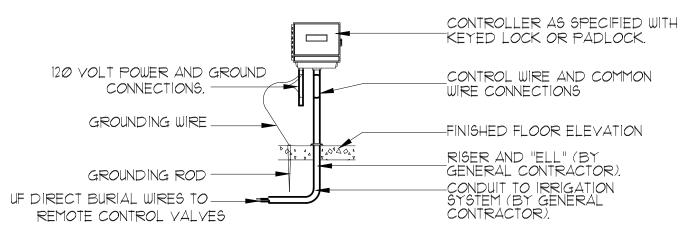

DETAIL NOTES:


- ELECTRICAL POWER TO BE SUPPLIED BY OTHERS. ALL WIRING TO BE INSTALLED PER LOCAL CODES. SEE ELECTRICAL PLANS FOR LOCATION OF CONTROLLER.
- CONTROLLER TO BE MOUNTED APPROXIMATELY 5'-0" ABOVE FINISHED FLOOR ELEVATION.

CONTROLLER DETAIL

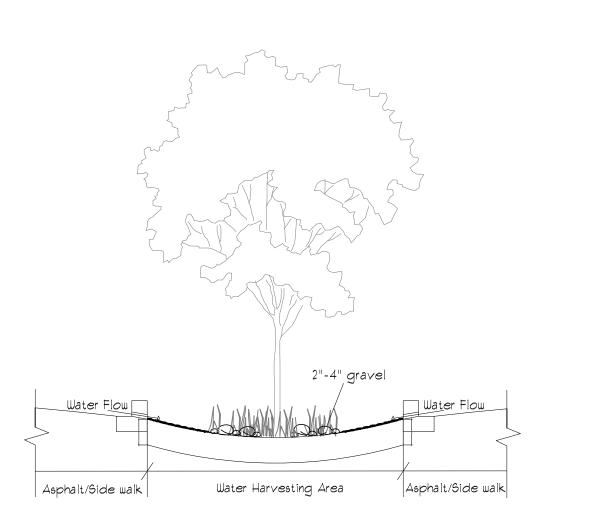

1-1 Mater Harvesting

Section-Typical

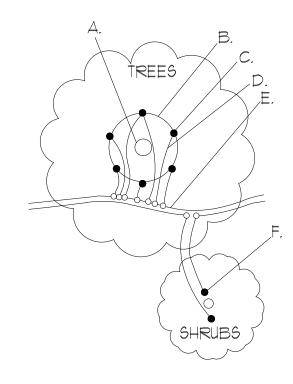


- A. TREE TRUNK/ROOT CROWN
- B. 24" CIRCLE FROM TRUNK
- C. EMITTERS
- D. 1/8" DISTRIBUTION LINE E. PE DRIPLINE
- F. EMITTER PLACED WITHIN 6" OF PLANT STEM NOTE: PLACE EMITTER ABOVE PLANT ON SLOPE

EMITTER PLACEMENT DETAIL




N.T.S.		
LANDSCAPE ARCHITECT'S SEAL	SKYVIEW WEST INDUSTRIAL FOR BRUNACINI DEVELOPMENT	DRAWN BY: P.P. APPROVED BY: D.M.
STE OF NEW AND THE STATE OF NE	7226 CENTRAL AVE., SW ALBUQUERQUE, NM	Date:July 31, 2024
DANNY D. MITCHELL	Landscape Details	DRAWING
DAINN D. MILENELL 239 FOR STERELITY FOR ARCHITE Date: August 09, 2024	TIERRA WEST, LLC 5571 MIDWAY PARK PL NE ALBUQUERQUE, NEW MEXICO 87109 (505) 858-3100	SHEET # LS-103
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——— SANITARY SEWER LINE

WATERLINE

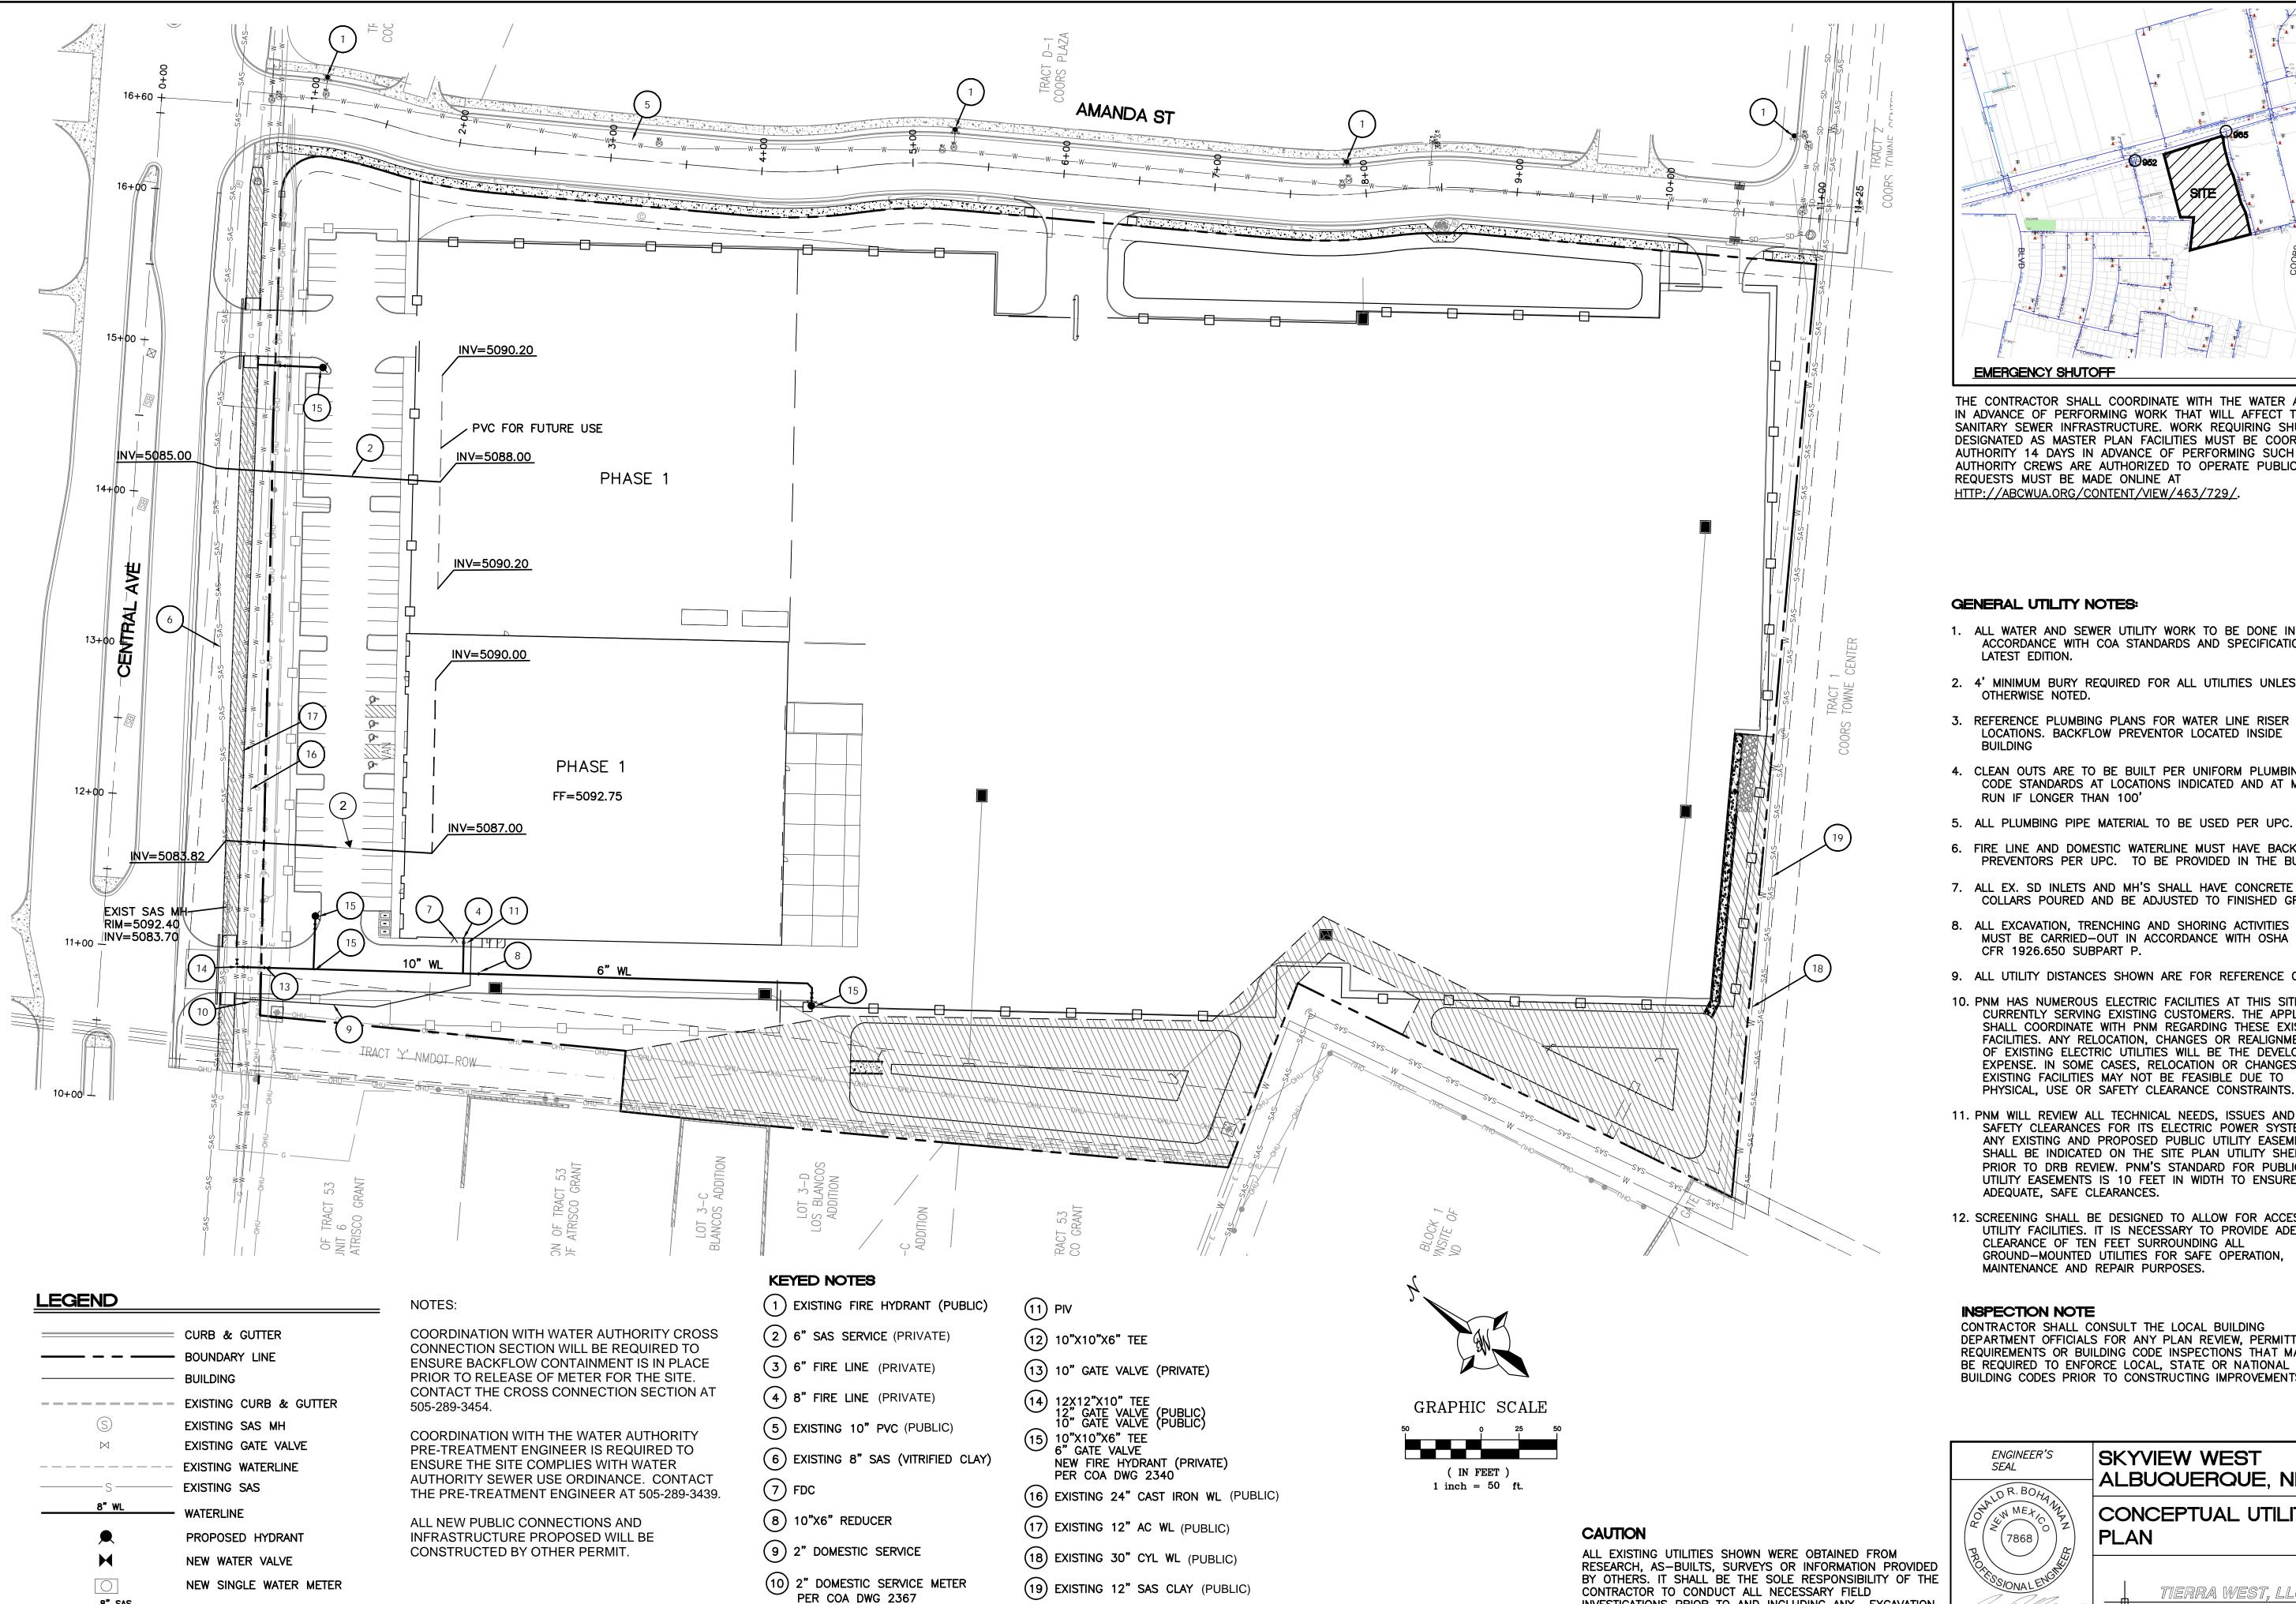

THE CONTRACTOR SHALL COORDINATE WITH THE WATER AUTHORITY SEVEN (7) DAYS IN ADVANCE OF PERFORMING WORK THAT WILL AFFECT THE PUBLIC WATER OR SANITARY SEWER INFRASTRUCTURE. WORK REQUIRING SHUTOFF OF FACILITIES DESIGNATED AS MASTER PLAN FACILITIES MUST BE COORDINATED WITH THE WATER AUTHORITY 14 DAYS IN ADVANCE OF PERFORMING SUCH WORK. ONLY WATER AUTHORITY CREWS ARE AUTHORIZED TO OPERATE PUBLIC VALVES. SHUTOFF REQUESTS MUST BE MADE ONLINE AT HTTP://ABCWUA.ORG/CONTENT/VIEW/463/729/.

GENERAL UTILITY NOTES:

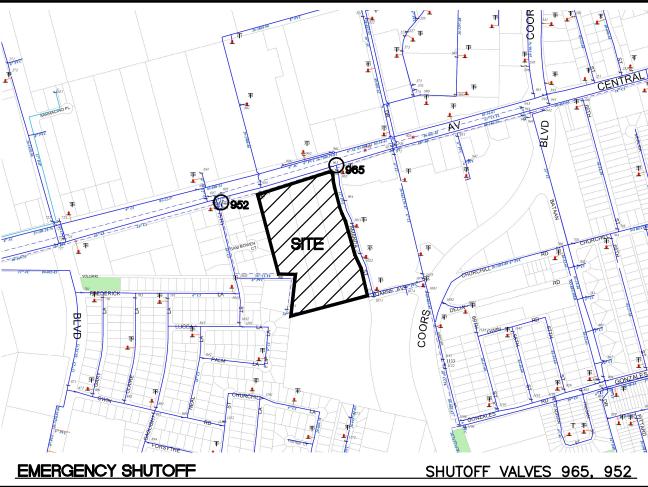- 1. ALL WATER AND SEWER UTILITY WORK TO BE DONE IN ACCORDANCE WITH COA STANDARDS AND SPECIFICATIONS LATEST EDITION.
- 2. 4' MINIMUM BURY REQUIRED FOR ALL UTILITIES UNLESS OTHERWISE NOTED.
- 3. REFERENCE PLUMBING PLANS FOR WATER LINE RISER LOCATIONS. BACKFLOW PREVENTOR LOCATED INSIDE
- 4. CLEAN OUTS ARE TO BE BUILT PER UNIFORM PLUMBING CODE STANDARDS AT LOCATIONS INDICATED AND AT MID RUN IF LONGER THAN 100'
- 5. ALL PLUMBING PIPE MATERIAL TO BE USED PER UPC.
- 6. FIRE LINE AND DOMESTIC WATERLINE MUST HAVE BACKFLOW PREVENTORS PER UPC. TO BE PROVIDED IN THE BUILDING
- COLLARS POURED AND BE ADJUSTED TO FINISHED GRADE.
- 8. ALL EXCAVATION, TRENCHING AND SHORING ACTIVITIES MUST BE CARRIED-OUT IN ACCORDANCE WITH OSHA 29 CFR 1926.650 SUBPART P.
- 9. ALL UTILITY DISTANCES SHOWN ARE FOR REFERENCE ONLY.
- 10. PNM HAS NUMEROUS ELECTRIC FACILITIES AT THIS SITE CURRENTLY SERVING EXISTING CUSTOMERS. THE APPLICANT SHALL COORDINATE WITH PNM REGARDING THESE EXISTING FACILITIES. ANY RELOCATION, CHANGES OR REALIGNMENT OF EXISTING ELECTRIC UTILITIES WILL BE THE DEVELOPER EXPENSE. IN SOME CASES, RELOCATION OR CHANGES TO EXISTING FACILITIES MAY NOT BE FEASIBLE DUE TO PHYSICAL, USE OR SAFETY CLEARANCE CONSTRAINTS.
- 11. PNM WILL REVIEW ALL TECHNICAL NEEDS, ISSUES AND SAFETY CLEARANCES FOR ITS ELECTRIC POWER SYSTEMS. ANY EXISTING AND PROPOSED PUBLIC UTILITY EASEMENTS SHALL BE INDICATED ON THE SITE PLAN UTILITY SHEET PRIOR TO DRB REVIEW. PNM'S STANDARD FOR PUBLIC UTILITY EASEMENTS IS 10 FEET IN WIDTH TO ENSURE ADEQUATE, SAFE CLEARANCES.
- 12. SCREENING SHALL BE DESIGNED TO ALLOW FOR ACCESS TO UTILITY FACILITIES. IT IS NECESSARY TO PROVIDE ADEQUATE CLEARANCE OF TEN FEET SURROUNDING ALL GROUND-MOUNTED UTILITIES FOR SAFE OPERATION, MAINTENANCE AND REPAIR PURPOSES.

INSPECTION NOTE

INVESTIGATIONS PRIOR TO AND INCLUDING ANY EXCAVATION,


TO DETERMINE THE ACTUAL LOCATION OF UTILITIES AND OTHER IMPROVEMENTS, PRIOR TO STARTING THE WORK. ANY

CHANGES FROM THIS PLAN SHALL BE COORDINATED WITH

AND APPROVED BY THE ENGINEER.

CONTRACTOR SHALL CONSULT THE LOCAL BUILDING DEPARTMENT OFFICIALS FOR ANY PLAN REVIEW, PERMITTING REQUIREMENTS OR BUILDING CODE INSPECTIONS THAT MAY BE REQUIRED TO ENFORCE LOCAL, STATE OR NATIONAL BUILDING CODES PRIOR TO CONSTRUCTING IMPROVEMENTS

ENGINEER'S SEAL	SKYVIEW WEST ALBUQUERQUE, NM	<i>DRAWN BY</i> pm
DR. BOH	ALBOQUENCOL, NIVI	DATE
ON MEXICO Z	CONCEPTUAL UTILITY	7-23-24
((7868))	PLAN	DRAWING
PROPERTY OF THE STATE OF THE ST		SHEET #
7-23-24	TIERRA WEST, LLC 5571 MIDWAY PARK PL NE ALBUQUERQUE, NEW MEXICO 87109	7
RONALD R. BOHANNAN P.E. #7868	(505) 858-3100 www.tierrawestllc.com	<i>JOB #</i> 2023062

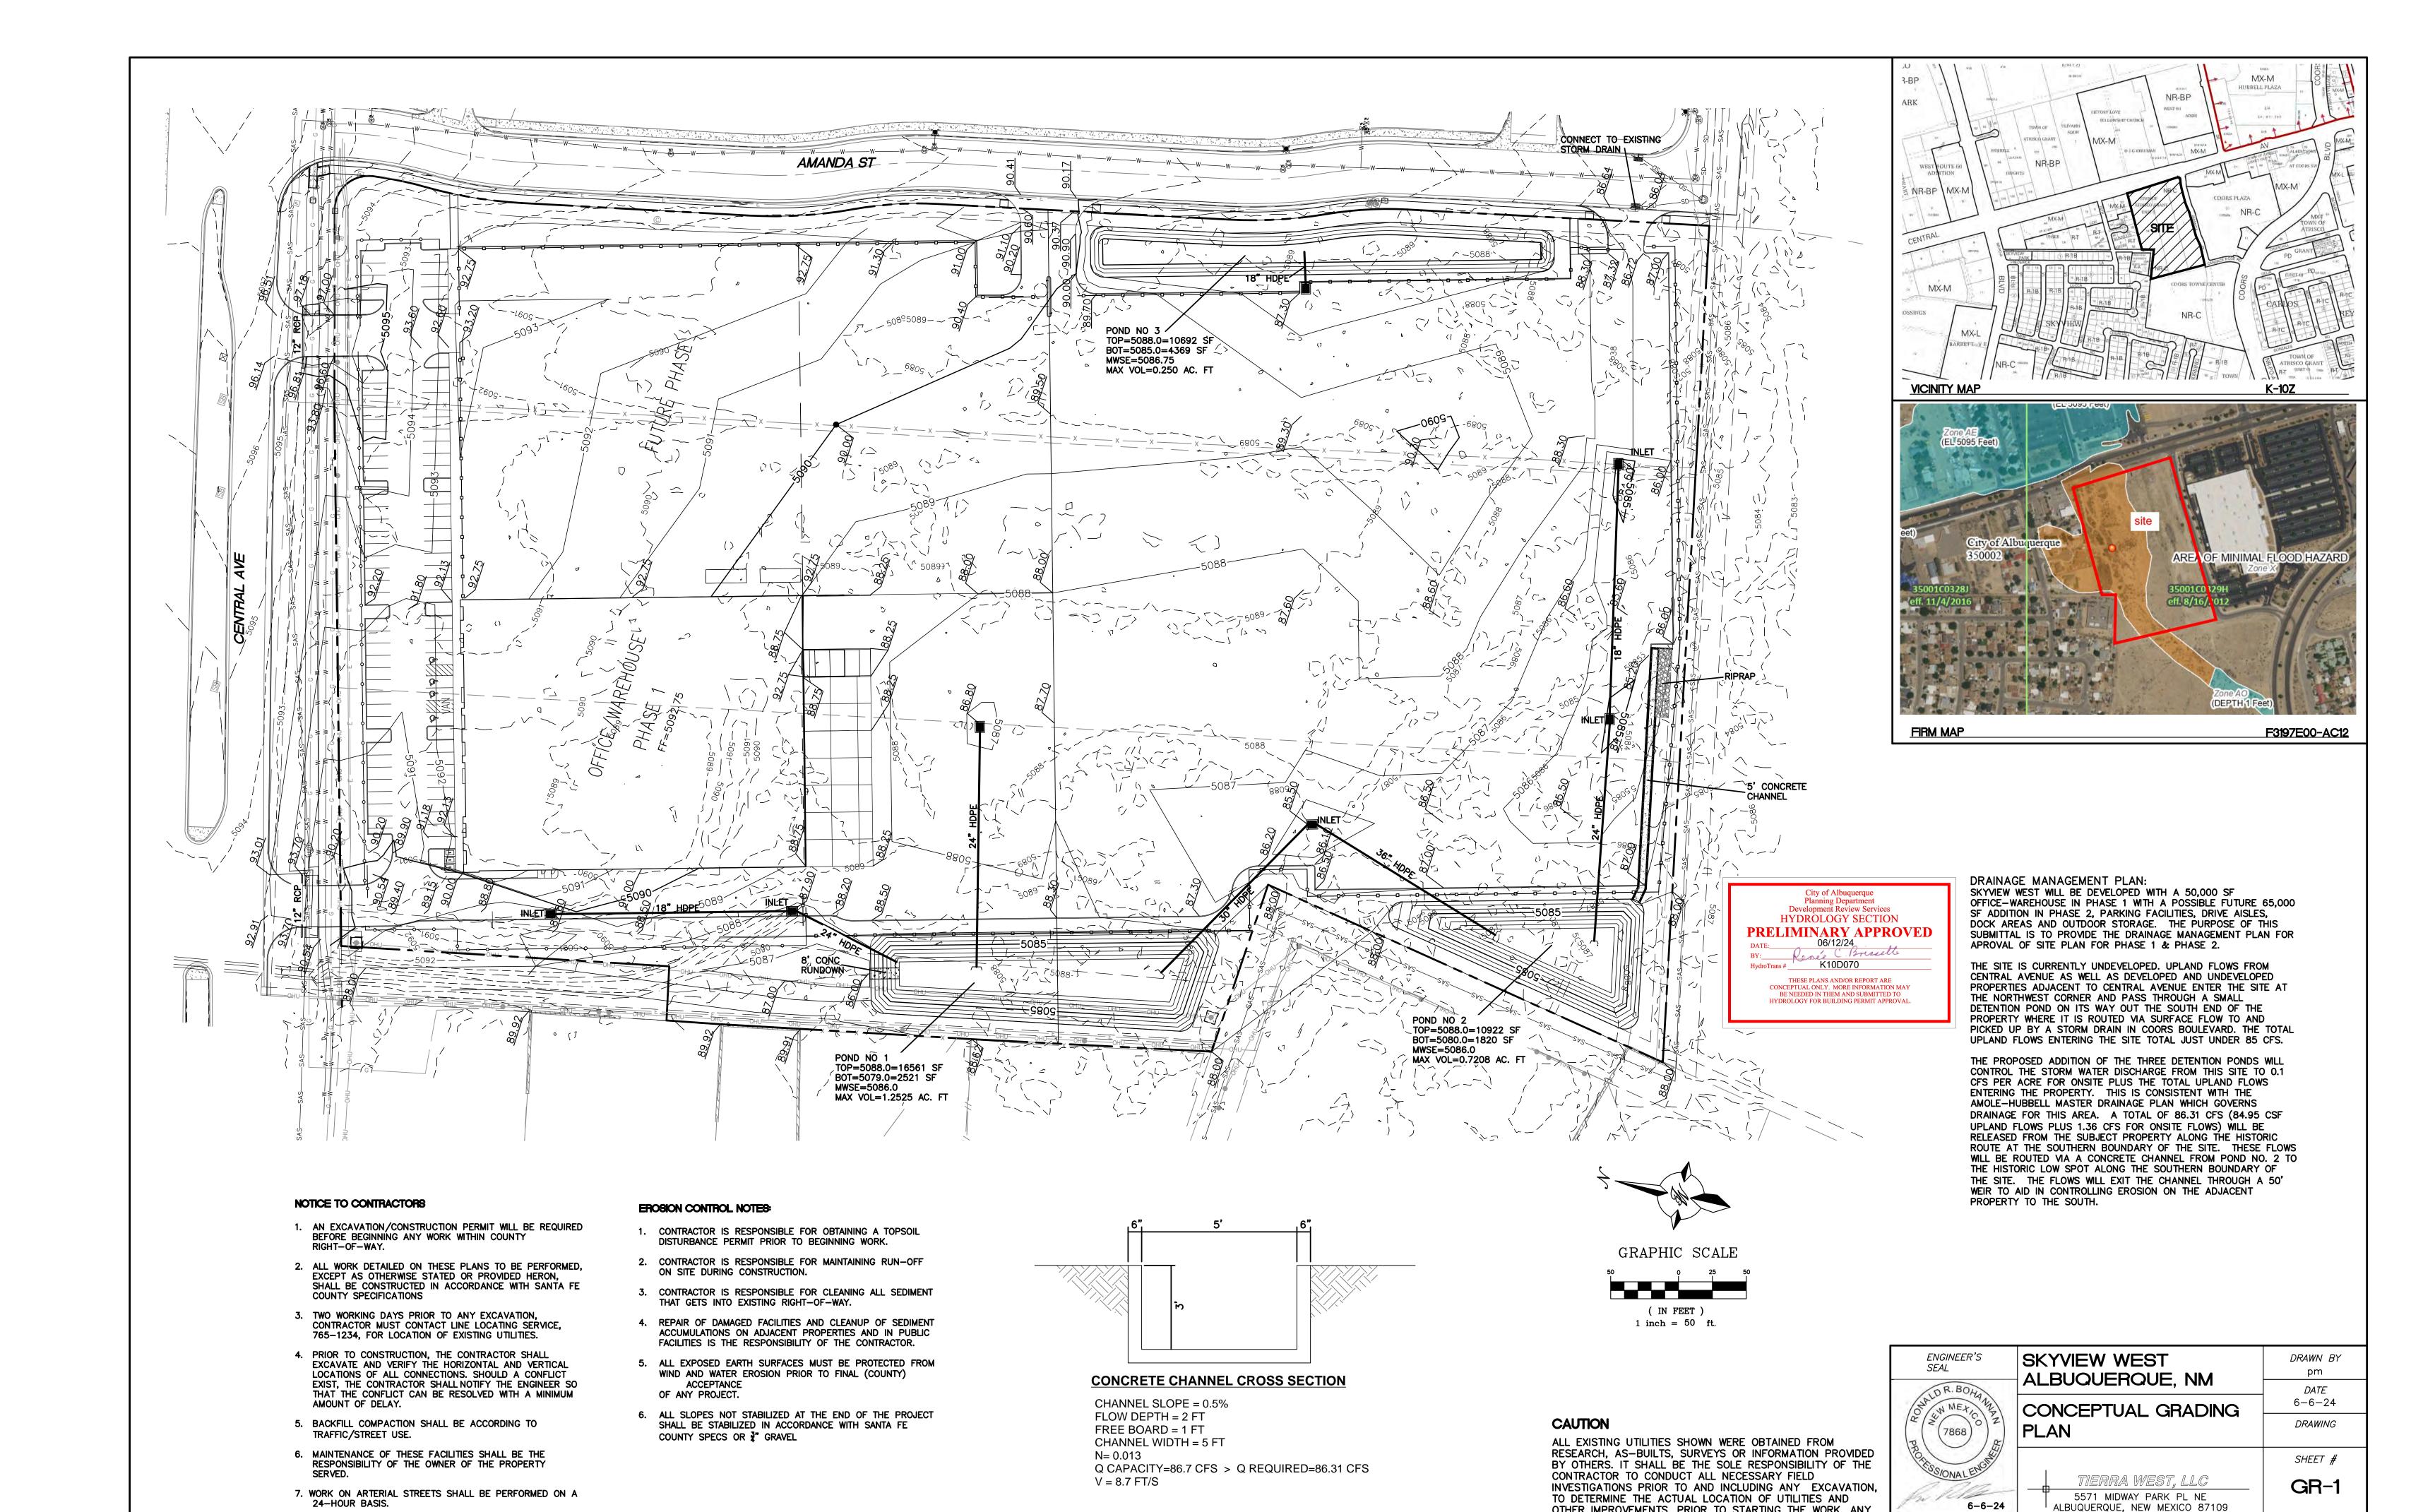

OTHER IMPROVEMENTS, PRIOR TO STARTING THE WORK. ANY

CHANGES FROM THIS PLAN SHALL BE COORDINATED WITH

AND APPROVED BY THE ENGINEER.

(505) 858-3100


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RONALD R. BOHANNAN

P.E. #7868

JOB #

2023062

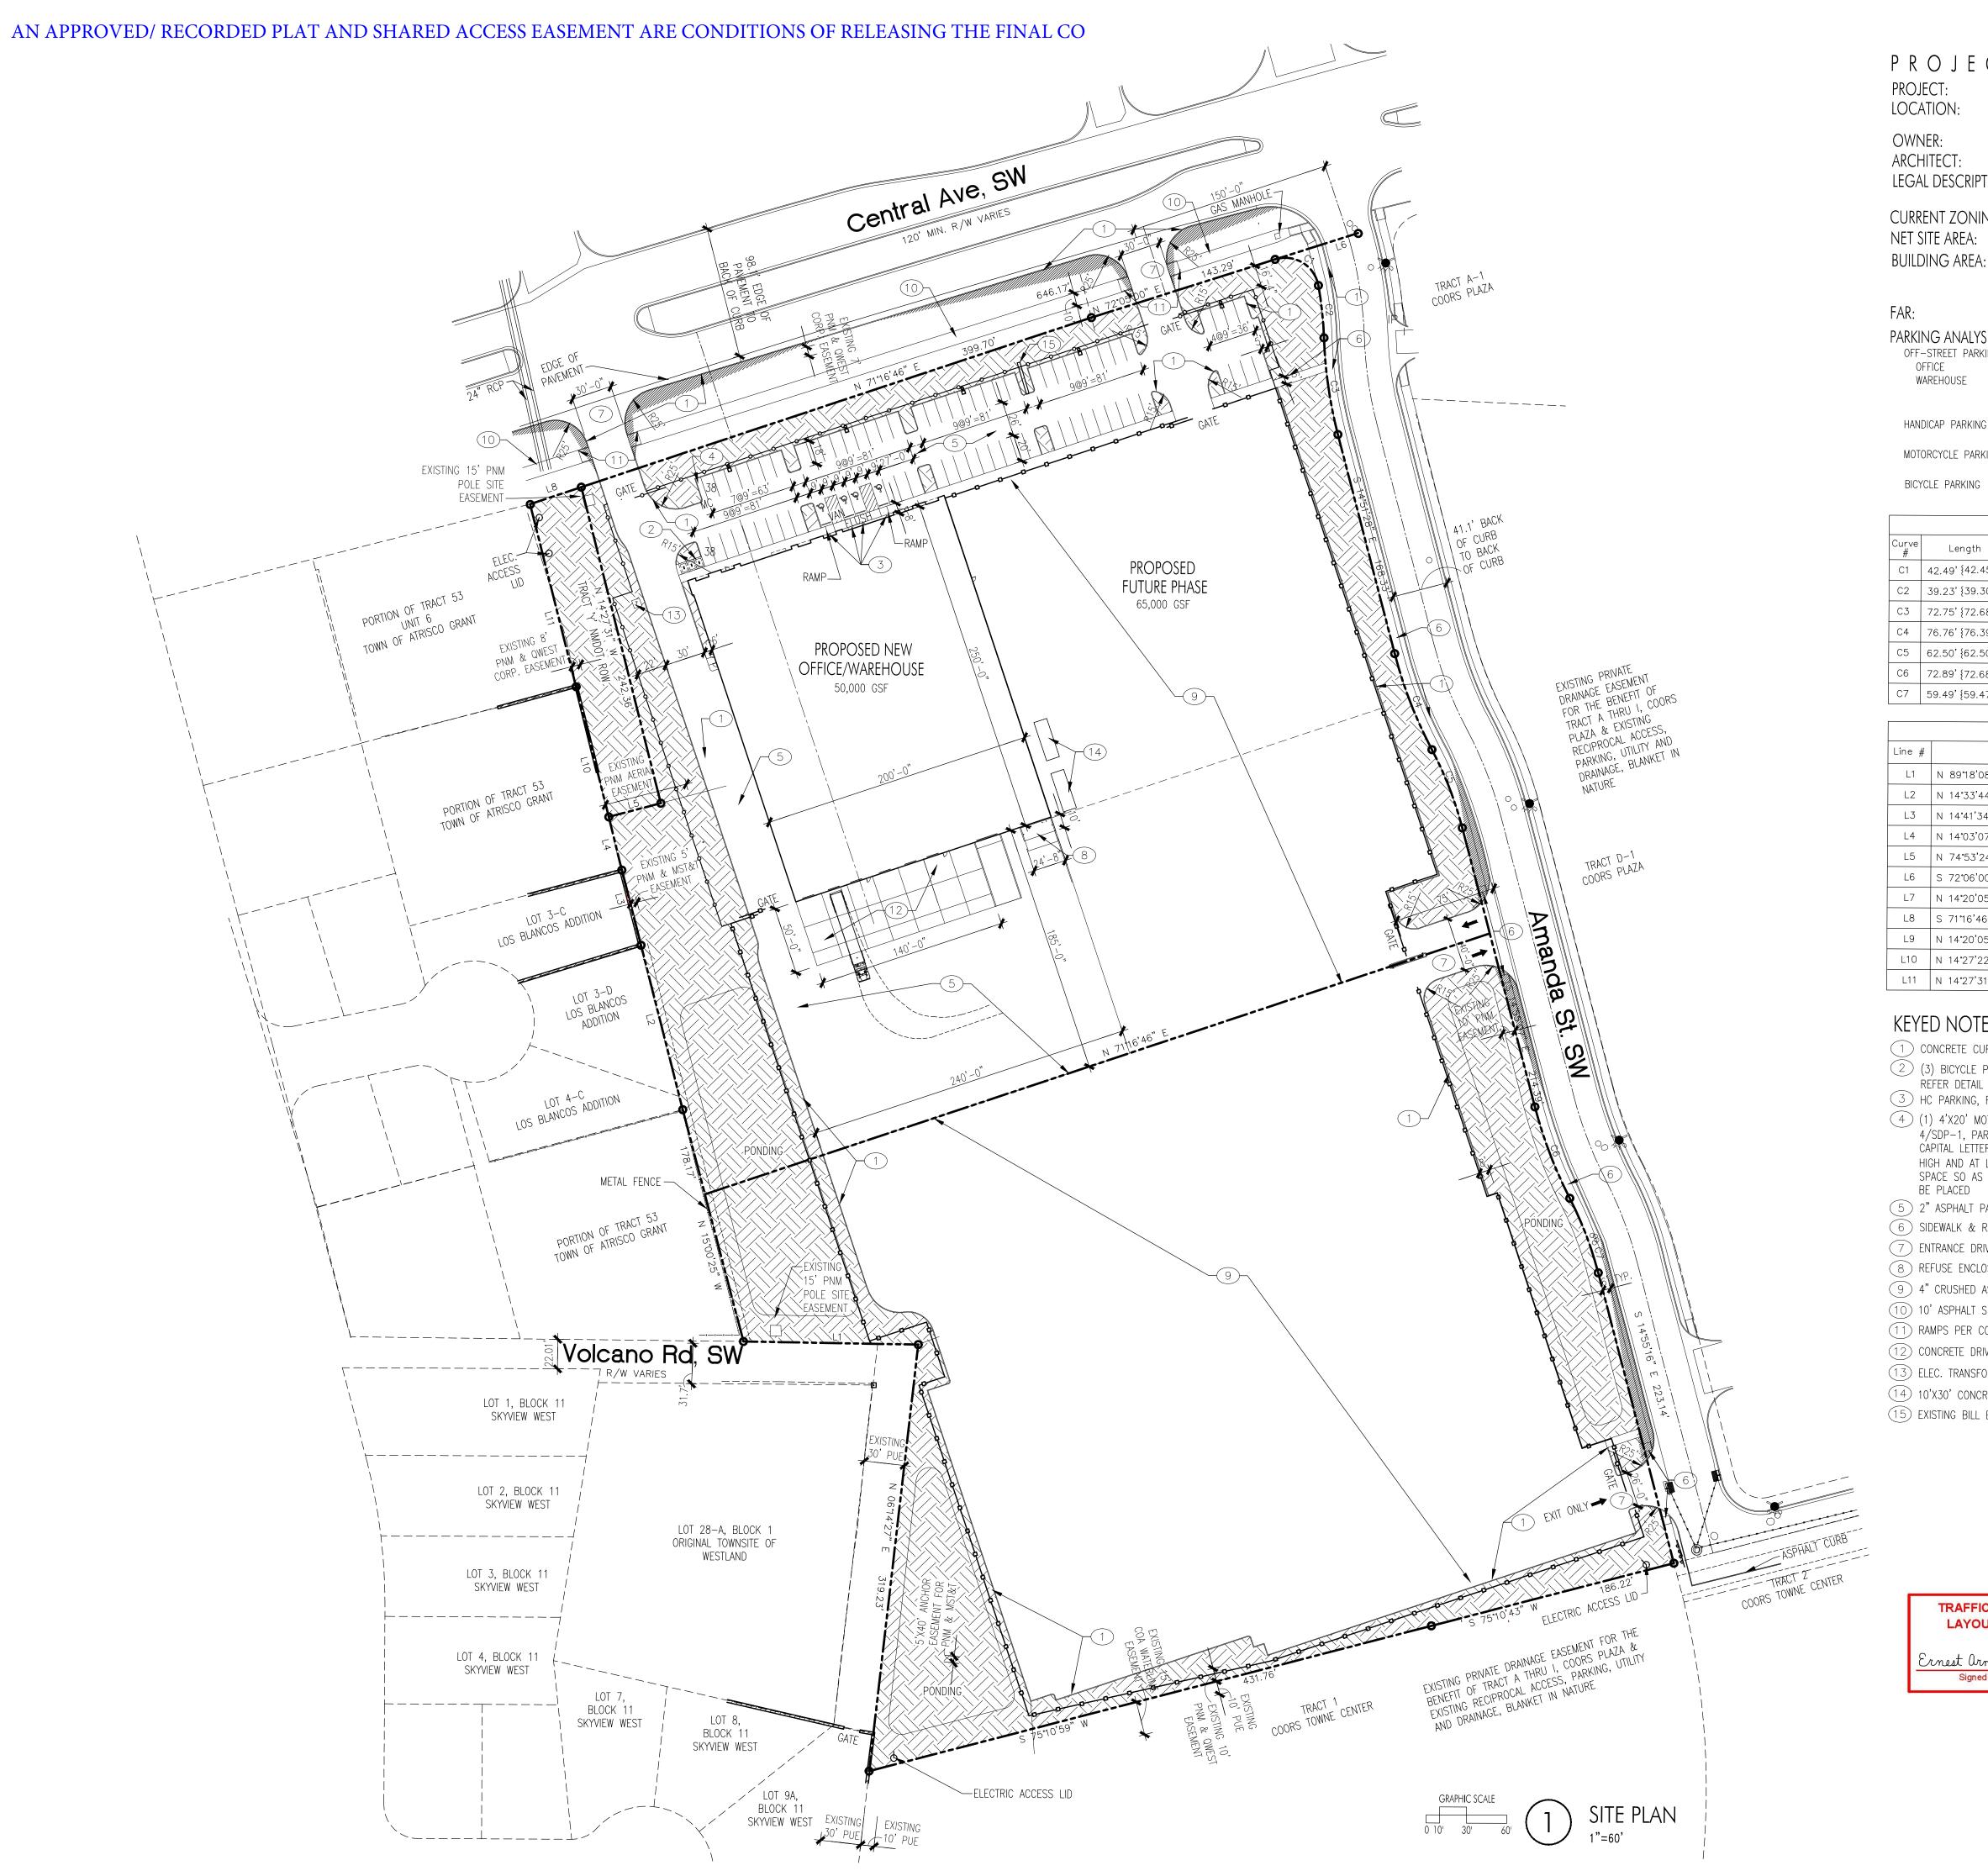

PROJECT INFORMATION

PROJECT: NEW OFFICE/WAREHOUSE LOCATION: 7226 CENTRAL AVE., SW ALBUQUERQUE, NEW MEXICO OWNER: BRUNACINI DEVELOPMENT ARCHITECT: TATE FISHBURN ARCHITECT LEGAL DESCRIPTION: TRACTS 54, 55 & 1 TOWN OF ATRISCO

CURRENT ZONING CLASSIFICATION: NET SITE AREA: 13.59 ACRES

> OFFICE 2,937 GSF WAREHOUSE PHASE 1 47,063 GSF WAREHOUSE PHASE 2 65,000 GSF

> > TOTAL SPACES PROVIDED 77 SPACES

GRANT UNIT 6

115,000 GSF

NR-C

PARKING ANALYSIS: OFF-STREET PARKING

OFFICE 2,937 GSF 3.5:1000 = 11 SPACES112,063 GSF WAREHOUSE NO REQUIREMENT REQUIRED 11 SPACES

HANDICAP PARKING (50-100 PRVD) = REQUIRED 4 SPACE TOTAL (1 VAN) PROVIDED 4 SPACE TOTAL (1 VAN) MOTORCYCLE PARKING $(1-25 \text{ RQD}) = \text{REQUIRED} \quad 1 \text{ SPACE}$ PROVIDED 1 SPACE

10% OF REQ'D or 3 = REQUIRED 3 SPACES BICYCLE PARKING PROVIDED 3 SPACES

Curve Table					
Curve #	Length	Radius	Delta	Chord Length	Chord Direction
C1	42.49' {42.45'}	25.00'	97°22'49"	37.56	S 59°14'35" E
C2	39.23' {39.30'}	270.00'	8°19'32"	39.20'	S 06°23'24" E
С3	72.75' {72.68'}	330.00'	12°37'50"	72.60'	S 08°32'33" E
C4	76.76' {76.39'}	330.00'	13°19'36"	76.58	S 21°31'15" E
C5	62.50' {62.50'}	270.00'	13°15'47"	62.36	S 21°33'10" E
C6	72.89' {72.68'}	330.00'	12°39'18"	72.74	S 21°13'01" E
C7	59.49' {59.47'}	270.00'	12°37'24"	59.37'	S 21°13'58" E

	Line Table			
Line #	Direction	Length (ft)		
L1	N 89°18'08" W ((N 89°48'32" W))	129.99' (130.4')		
L2	N 14°33'44" W *(N 14°34'27" W)*	126.15'		
L3	N 14°41'34" W *(N 14°34'27" W)*	57.64' *(55.40')*		
L4	N 14°03'07" W *{N 15°06' W}*	40.73'		
L5	N 74°53'24" E *[N 74°53'24" E]*	40.01' *[40.00']*		
L6	S 72°06'00" W (*S 71°44'20" W*)	64.65'		
L7	N 14°20'05" W (*N 15°02'48" W*)	24.13' (*24.13'*)		
L8	S 71°16'46" W *[S 71°44'20" W]*	40.11' *[40.06']*		
L9	N 14°20'05" W (*S 15°02'48" E*)	59.86' (*60.00'*)		
L10	N 14°27'22" W *{N 15°06' W}*	100.08'		
L11	N 14°27'31" W	139.76'		


KEYED NOTES


- (1) CONCRETE CURB, TYP.
- (2) (3) BICYCLE PARKING STALLS W/ 1' CLEAR ZONE AROUND STALL,
- REFER DETAIL 3/SDP-2 3 HC PARKING, RAMP & SIGN, REFER DETAIL 1/SDP-2
- (4) (1) 4'X20' MOTORCYCLE PARKING SPACE & SIGN, REFER DETAIL 4/SDP-1, PARKING SPACE SHALL HAVE THE LETTERS 'MC' IN CAPITAL LETTERS, EACH OF WHICH SHALL BE AT LEAST ONE FOOT HIGH AND AT LEAST 2' WIDE PLACED AT THE REAR OF THE PARKING SPACE SO AS TO BE CLOSE TO WHERE VEHICLES REAR TIRE WOULD BE PLACED
- (5) 2" ASPHALT PAVING OVER 4" BASE COURSE
- 6) SIDEWALK & RAMPS PER COA STD DWG 2430 & 2415
- (7) ENTRANCE DRIVE PER COA STD DWG 2426
- 8 REFUSE ENCLOSURE
- (9) 4" CRUSHED ASPHALT
- (10) 10' ASPHALT SIDEWALK
- (11) RAMPS PER COA STD DWG 2430 & 2415
- (12) CONCRETE DRIVE @ TRUCK DOCK
- (13) ELEC. TRANSFORMER LOCATION
- (14) 10'X30' CONCRETE PADS (15) EXISTING BILL BOARD SIGN

TRAFFIC CIRCULATION

LAYOUT APPROVED

Ernest armyo 6/5/2024

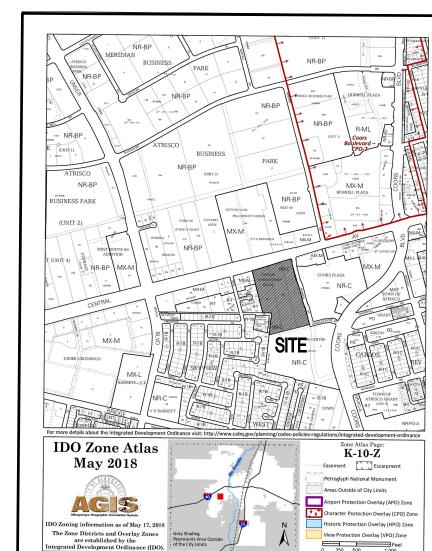

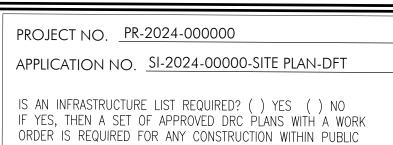

RIGHT-OF-WAY OR FOR CONSTRUCTION OF PUBLIC IMPROVEMENTS. DFT SITE DEVELOPMENT PLAN APPROVAL:

TRAFFIC ENGINEER, TRANSPORTATION DIVISION ABCWUA DATE

HYDROLOGY

PARKS & RECREATION DEPARTMENT

CODE ENFORCEMENT

*ENVIRONMENTAL HEALTH DEPARTMENT (CONDITIONAL)

SOLID WASTE MANAGEMENT

PLANNING DEPARTMENT *ENVIRONMENTAL HEALTH, IF NECESSARY

LEGEND

EASEMENT LINE



8' TALL OPAQUE FENCING AND GATES AS NOTED

PONDING PONDING AREA

SITE DISTANCE AND SITE TRIANGLE BASED ON COA DPM 7-4(I)(5)(III) and 7-4(I)(5)(IV), LANDSCAPING AND SIGNAGE WILL NOT INTERFERE WITH CLEAR SIGHT REQUIREMENTS, THEREFORE SIGNS, WALLS, TREES, AND SHRUBBERY BETWEEN 3 AND 8 FEET TALL (AS MEASURED FROM THE GUTTER PAN) WILL NOT BE ACCEPTABLE IN THE CLEAR SITE

HANDICAP PARKING PAVEMENT MARKING

EXISTING FIRE HYDRANT

GENERAL NOTES

- 1. THIS SITE PLAN MEETS THE REQUIREMENTS OF THE CITY OF
- ALBUQUERQUE IDO. 2. ALL SITE LIGHTING SHALL COMPLY WITH IDO SECTION 14-16-5-8.
- OUTDOOR AND SITE LIGHTING. 3. PLACEMENT OF FIXTURES & STANDARDS SHALL CONFORM TO STATE & DATE
- LOCAL SAFETY & ILLUMINATION REQUIREMENTS. 4. ALL LIGHT FIXTURES SHALL BE FULLY SHIELDED HORIZONTAL LAMPS WITH NO LIGHT, LENS OR BULB PROTRUDING BELOW THE BOTTOM OF THE CUT-OFF FIXTURE IN ORDER THAT NO FUGITIVE LIGHT SHALL ESCAPE BEYOND THE PROPERTY LINE AND NO SITE LIGHTING LIGHT

SOURCE SHALL BE VISIBLE FRO THE SITE PERIMETER.

- ROOF TOP AND GROUND MOUNTED EQUIPMENT SHALL BE SCREENED FROM THE PUBLIC VIEW BY MATERIALS OF THE SAME NATURE AS THE BUILDINGS BASIC MATERIALS. THE TOP OF ALL ROOFTOP EQUIPMENT SHALL BE BELOW THE TOP OF THE PARAPET OR SCREENED FROM VIEW FROM PUBLIC RIGHTS-OF-WAY AND THE SITE ACCESS EASEMENT. SITE DEVELOPMENT 6. SITE HANDICAP RAMPS SHALL BE BUILT BY COA STANDARD DRAWING
- 7. ALL IMPROVEMENTS LOCATED IN THE RIGHT OF WAY MUST BE INCLUDED ON THE WORK ORDER.



ARCHITECT SEAL

ENGINEER SEAL

PROJECT

DATE

REVISIONS

MAY 30, 2024

1"=60'-0"


OR AS NOTED

DRAWING NAME

PLAN

SHEET NUMBER

TRAFFIC CIRCULATION LAYOUT APPROVED Ernest armyo 6/5/2024
Signed Date

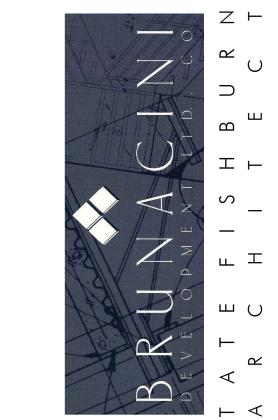



PROJECT

SKYVIEW WEST FOR BRUNACINI D 7226 CENTRA ALBUQUERQUE, I

REVISIONS

— LANDING, 50:1 MAX. IN ALL DIRECTIONS

CONC. WHEEL STOP W/
18" LONG #6 REBAR @
FRONT OF HC STALL

CONC. HC ACCESS RAMP, 1:12 MAX. HEAVY BROOM FINISH

ACCESS AISLE TO BE FLUSH WITH SIDEWALK AND SHALL HAVE LESS THAN 2% CROSS SLOPE

ACCESS AISLE SHALL HAVE THE WORDS "NO PARKING" IN CAPITAL LETTERS EACH OF WHICH SHALL BE AT LEAST ONE FOOT HIGH AND AT LEAST 2" WIDE, PLACED AT THE REAR OF THE PARKING SPACE SO AS TO BE CLOSE TO WHERE VEHICLE'S REAR TIRE WOULD BE PLACED

∠ ASPHALT PAVEMENT —

ACCESSIBLE PARKING & PATHWAY 1/8"=1'-0"

DATE


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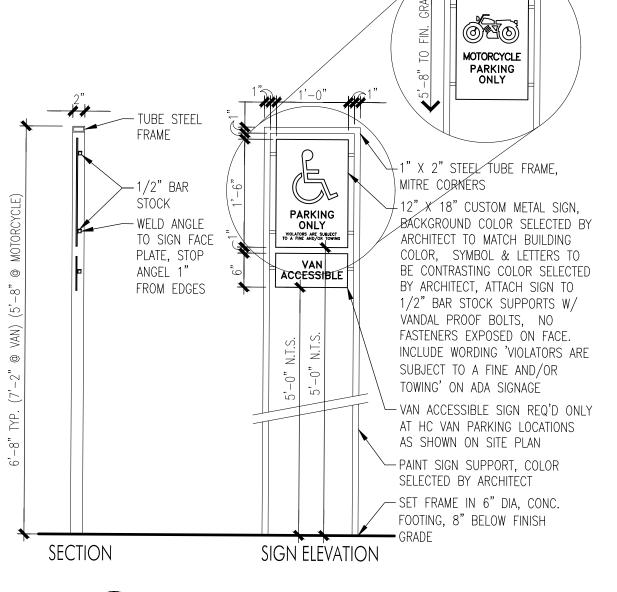
OR AS NOTED

DRAWING NAME SITE DEVELOPMENT PLAN- SITE DETAILS


SHEET NUMBER


SDP-2



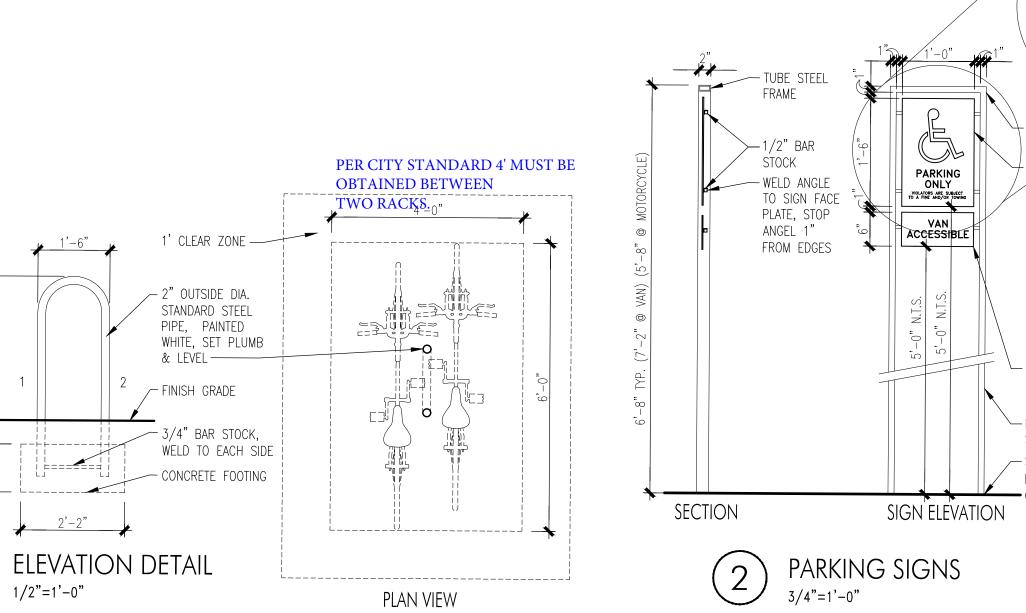

PARKING SIGNS 3/4"=1'-0"

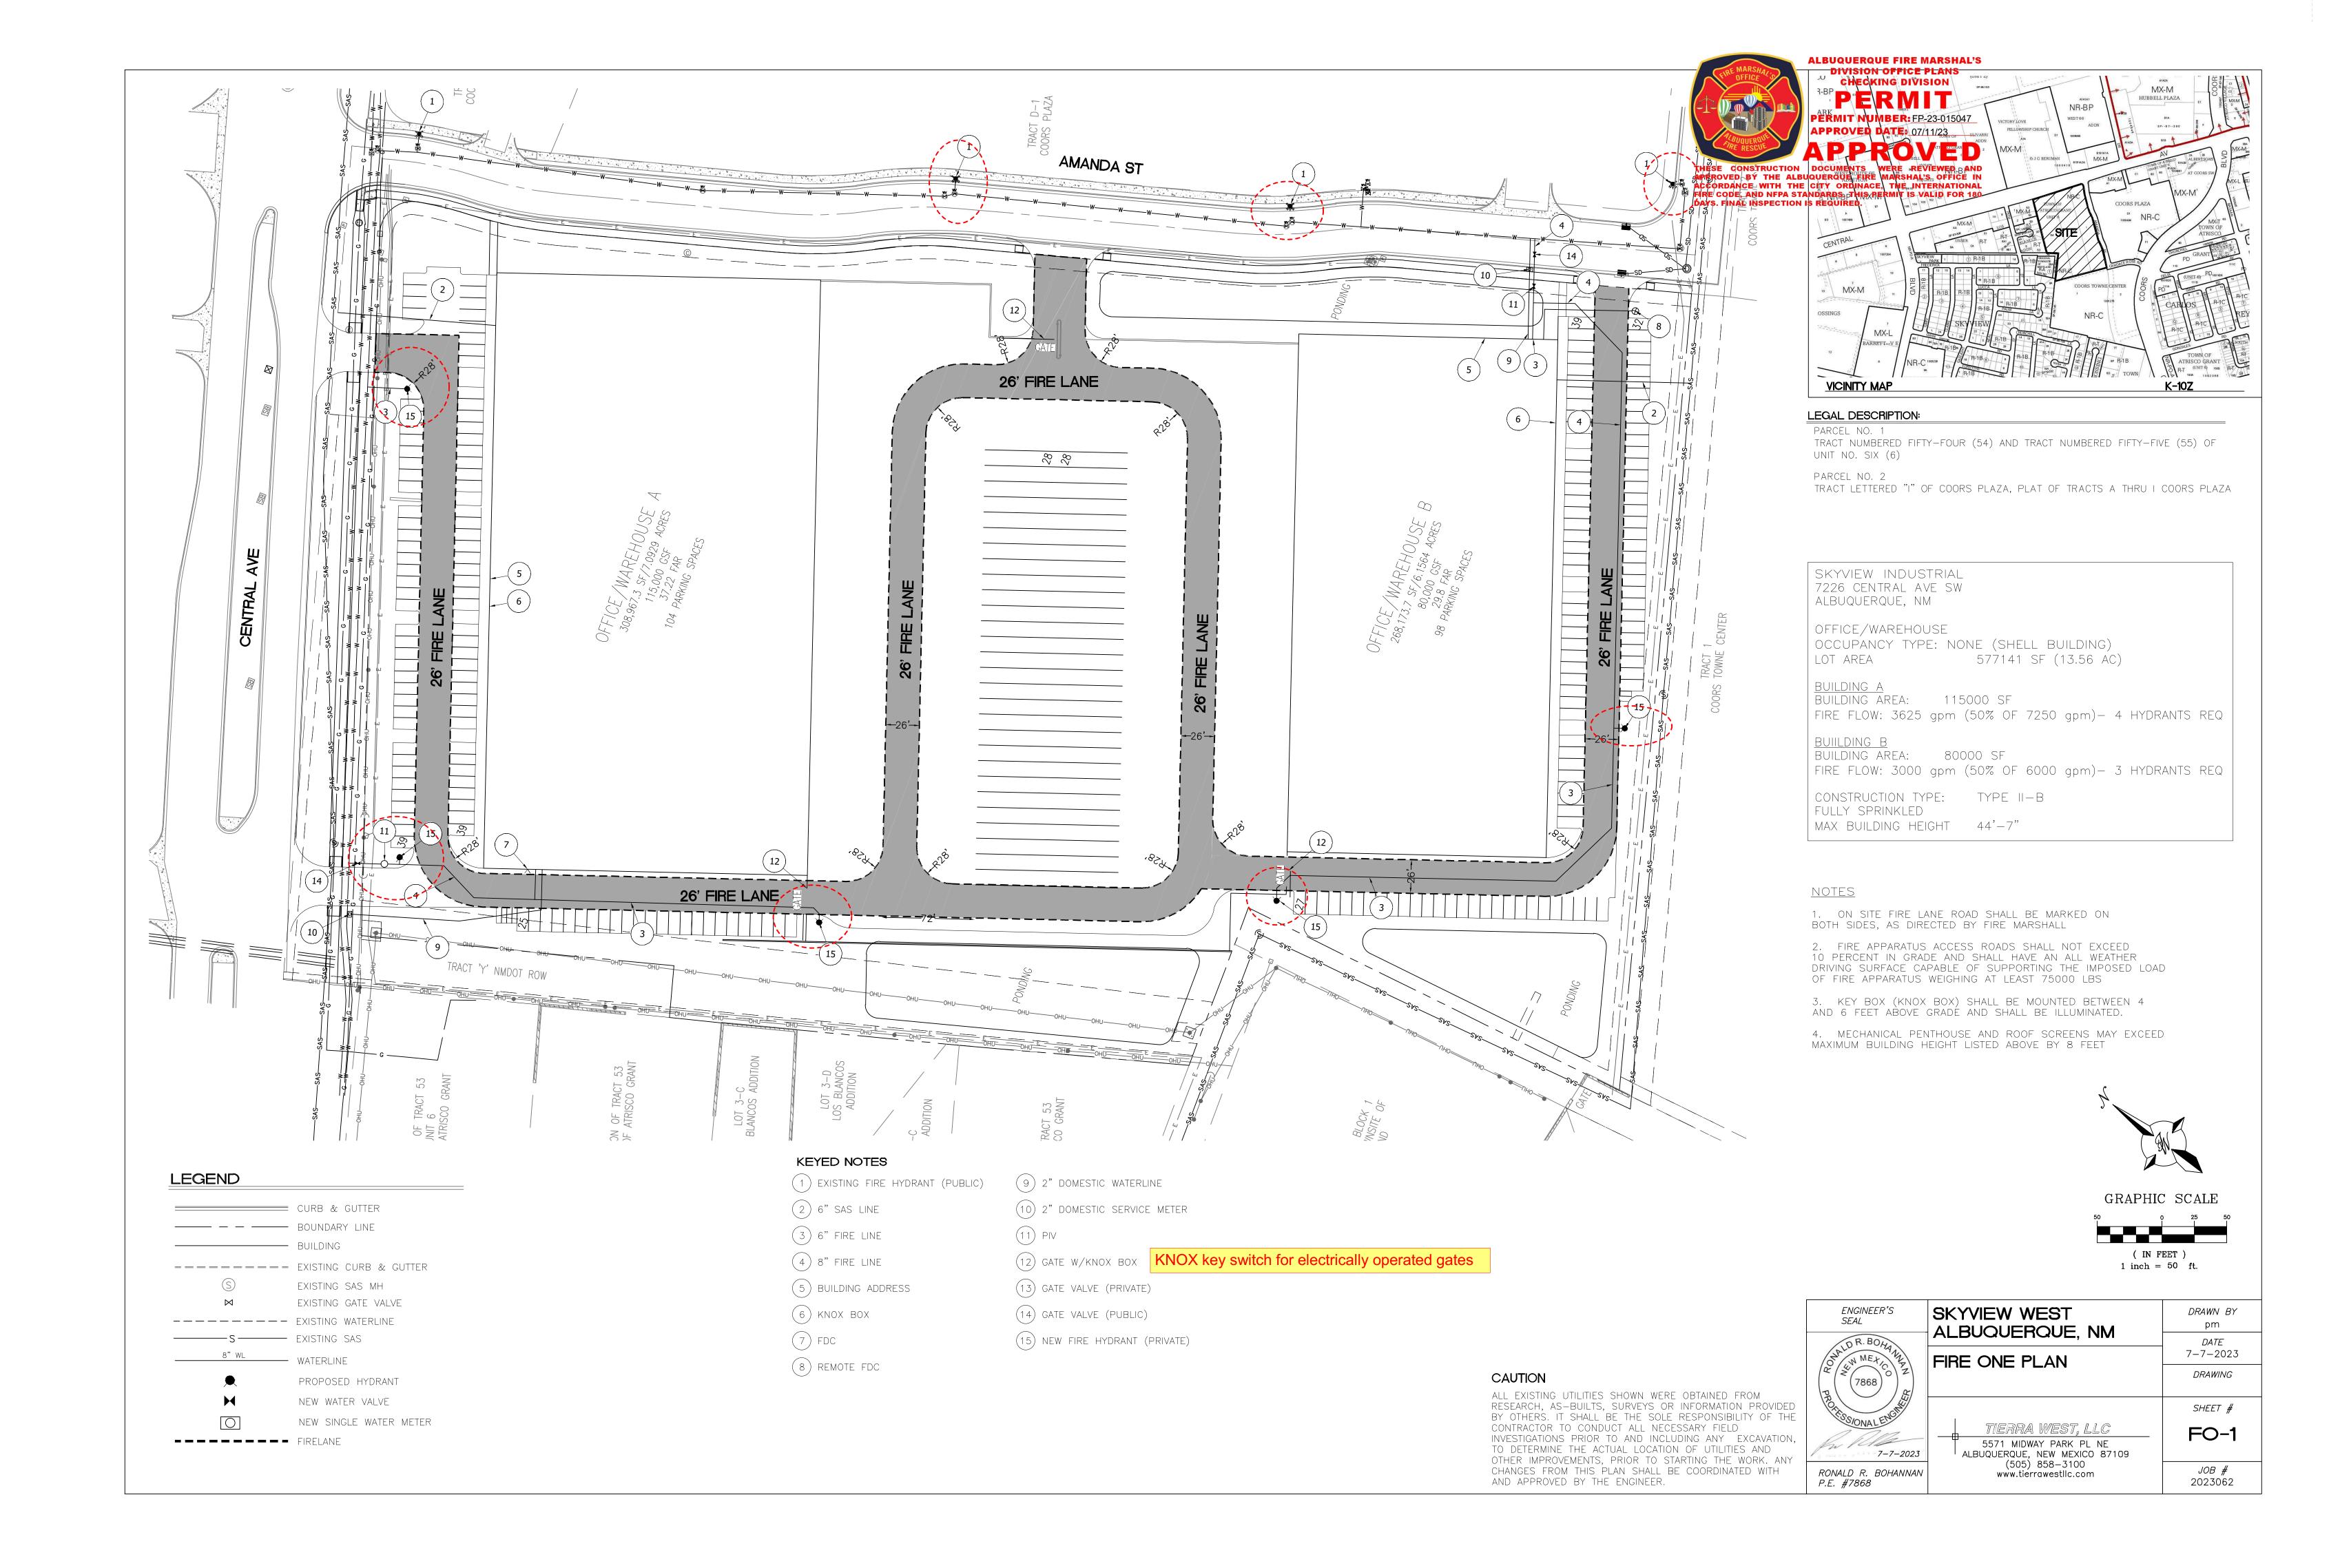

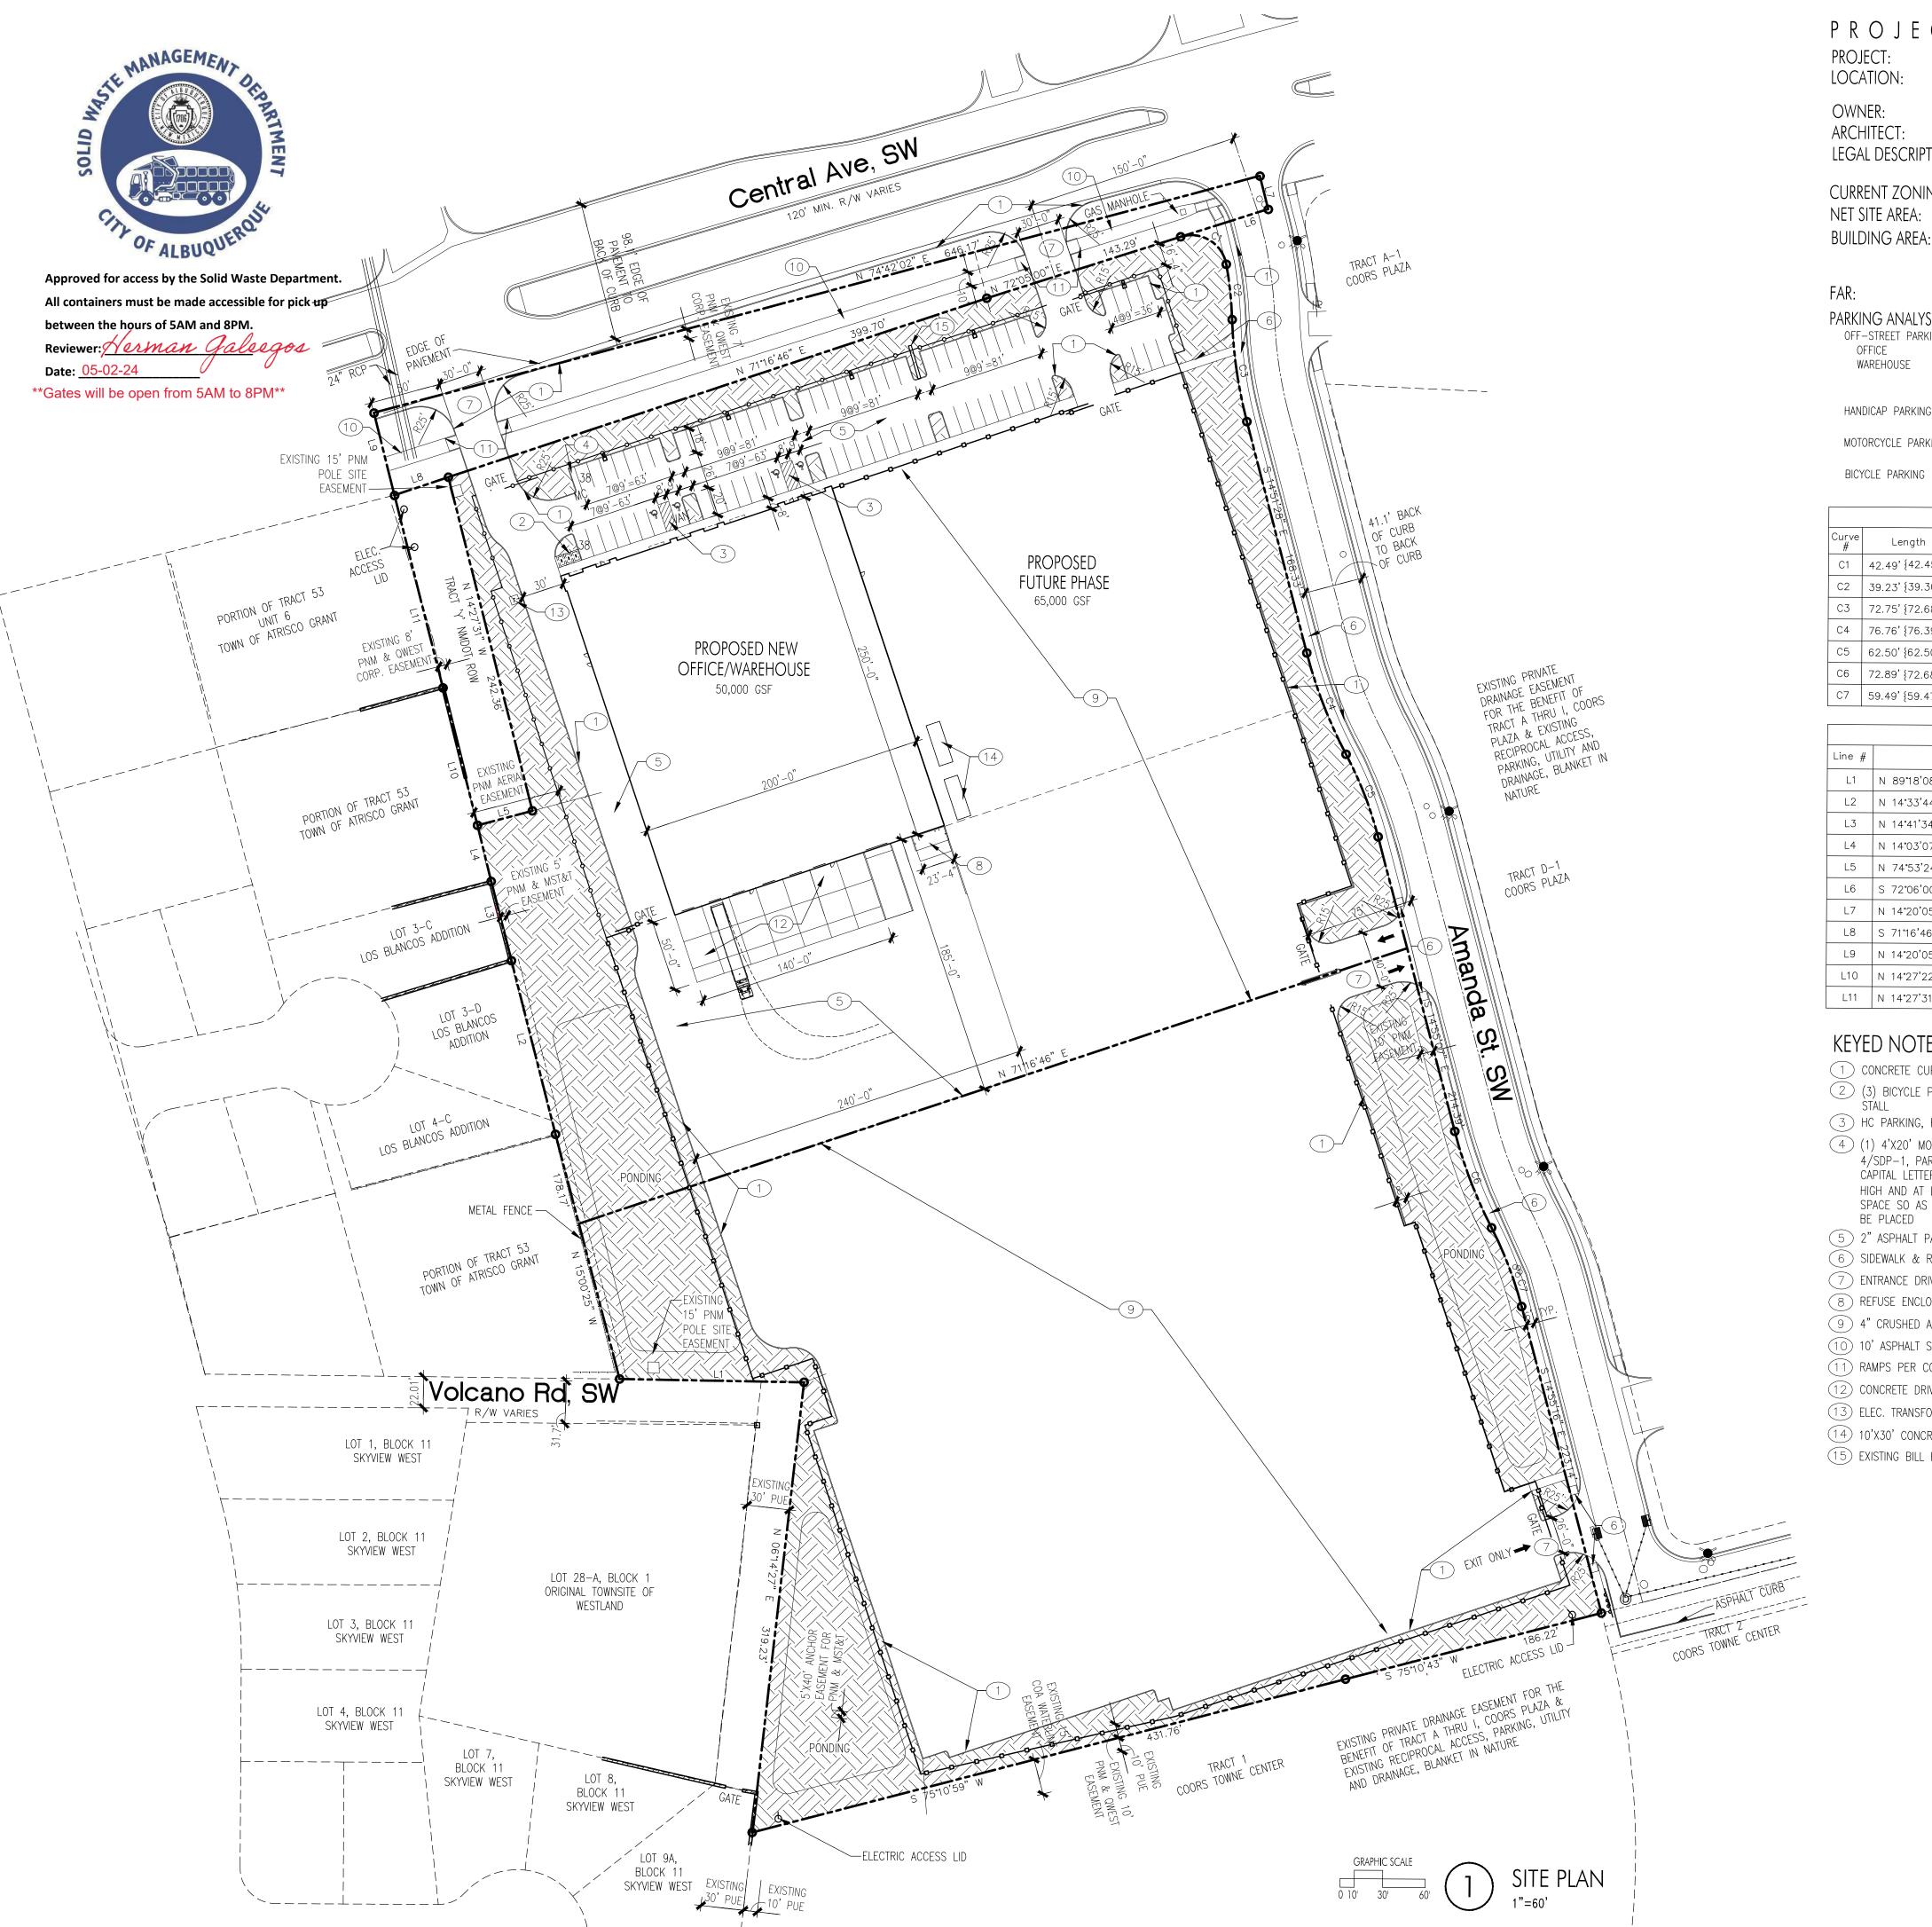

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> OFFICE 2,937 GSF WAREHOUSE PHASE 1 47,063 GSF WAREHOUSE PHASE 2 65,000 GSF

13.59 ACRES

115,000 GSF

PROVIDED 3 SPACES

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- (13) ELEC. TRANSFORMER LOCATION
- (14) 10'X30' CONCRETE PADS (15) EXISTING BILL BOARD SIGN

IDO Zone Atlas

May 2018



PROJECT

ENGINEER SEAL

LEGEND

EASEMENT LINE

LANDSCAPED AREA

6' DESIGNMASTER FENCING, CLASSIC AND GATES AS NOTED

8' TALL OPAQUE FENCING AND GATES AS NOTED

PONDING PONDING AREA

SITE DISTANCE AND SITE TRIANGLE BASED ON COA DPM 7-4(I)(5)(iii) and 7-4(I)(5)(iv), LANDSCAPING AND SIGNAGE WILL NOT INTERFERE WITH CLEAR SIGHT REQUIREMENTS, THEREFORE SIGNS, WALLS, TREES, AND SHRUBBERY BETWEEN 3 AND 8 FEET TALL (AS MEASURED FROM THE GUTTER PAN) WILL NOT BE ACCEPTABLE IN THE CLEAR SITE

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REVISIONS

MAY 1, 2024 1"=60'-0" OR AS NOTED

DRAWING NAME

SITE DEVELOPMENT PLAN

SHEET NUMBER

PR-2022-007299_SI-2024-00931_Site_Plan_Ap proved_8-21-24_Sheet_1

Final Audit Report 2024-08-29

Created: 2024-08-28

By: Jay Rodenbeck (jrodenbeck@cabq.gov)

Status: Signed

Transaction ID: CBJCHBCAABAAejSDgTUK2stAbx18AskLafeZa3_Nhpp4

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