

# SITE INFORMATION

ADDRESS: PROPERTY SOUTH AND WEST OF 10801 GOLF COURSE RD NW,

ALBUQUERQUE, NM 87114

LEGAL DESCRIPTION:
A PARCEL OF LAND SITUATED IN PROJECTED SECTION 1, T11N, R2E, N.M.P.M., TOWN OF ALAMEDA GRANT, CITY OF ALBUQUERQUE, BERNALILLO COUNTY, NEW MEXICO; SAID PARCEL BEING THE SAME AS TRACT A-1-A, B-1-A, B-1-B 8: C-1-A OF BLACK ARROYO DAM, FILED IN THE OFFICE OF THE COUNTY CLERK ON JULY 16. 2007 IN BK. 2007C. PG. 190. SEE PLAT FOR METES AND BOUNDS INFORMATION.

ZONE ATLAS MAP: A-12-Z ZONE DISTRICT: MX-M ADJACENT ZONING: MX-M + R-1D PROPOSED LAND USE: RESIDENTIAL

SETBACKS (GENERAL): FRONT (MIN/MAX.) 5 FT./NA (WEST SIDE BLVD.)

1 OR LESS BEDROOM (BR)= 225 SF./ DU

# **GENERAL NOTES**

- 1. ALL SIDEWALKS, RAMPS, CURBCUTS, AND CURB AND GUTTER SHALL BE BUILT PER THE C.O.A. STANDARD DRAWINGS AND ADA 2. CLEAR SITE DISTANCE: LANDSCAPING AND SIGNAGE WILL NOT INTERFERE WITH CLEAR SIGHT REQUIREMENTS, THEREFORE, SIGNS, WALLS, TREES, AND SHRUBBERY, BETWEEN 3 AND 8 FEET TALL( AS
- THIS AREA. SITE TRIANGLE SPEED IS BAED OFF OF 35 M.P.H. ROADWAT.

  3. REFER TO PLAT DRAWINGS FOR EXISTING AND PROPOSED EASEMENTS, PROPOSED LOT INFORMATION, AND FULL METES AND BOUNDS

  4. WINDOWS SHALL BE RECESSED NOT LESS THAN 2 INCHES AND/OR
- SHALL BE SURROUNDED BY A WINDOW CASING NOT LESS THAN 2 INCHES WIDE.
- 5. PER IDO 4-3(B)(8)(A) NO MORE THAN 40% OF THE REQUIRED USABLE OPEN SPACE CAN BE PRIVATE TO A HOUSEHOLD OR OCCUR ON UPPER STORIES- 37,365 SF. OF THIS PROJECT IS PRIVATE; WITH A REMAINING 69,444 SF. OF PUBLIC OPEN SPACE

# LEGEND

NEW ASPHALT	
NEW CONCRETE SIDEWALKS	
EXISTING SIDEWALK	4
PRIVATE OPEN SPACE	
10'-0" P.U.E EASEMENT	
32' PRIVATE AND AMAFCA ACCESS, PRIVATE DRAINAGE AND PUBLIC WATER AND	

# DRAWING INDEX


_		
	AS001	SITE PLAN + COVER SHEET + PROJECT INI
	AS101	ENLARGED SITE PLAN
	AS102	ENLARGED SITE PLAN
	TCL03	TRAFFIC CONTROL LAYOUT DETAILS
	R001	REFUSE PLAN
	F-1	FIRE ONE PLAN
	F-2	FIRE ONE PLAN
	F-3	FIRE ONE PLAN
	LP-01	PLANTING PLAN
	LP-02	PLANTING PLAN
	LS-01	LANDSCAPE PLAN
	LS-02	LANDSCAPE PLAN
	G1	CONCEPTUAL GRADING AND DRAINAGE
	G2	CONCEPTUAL GRADING AND DRAINAGE
	D1	CONCEPTUAL GRADING AND DRAINAGE
	C1	AMARCA CROSS SECTIONS

AMAFCA CROSS SECTIONS AMAFCA CROSS SECTIONS UTILITY PLANS

UTILITY PLANS UTILITY PLANS

ARCHITECTURAL ELEVATIONS- BUILDING TYPE A ARCHITECTURAL ELEVATIONS- BUILDING TYPE B ARCHITECTURAL ELEVATIONS- BUILDING TYPE C ARCHITECTURAL ELEVATIONS- BUILDING TYPE D

ARCHITECTURAL ELEVATIONS- BUILDING TYPE E ARCHITECTURAL RENDERINGS

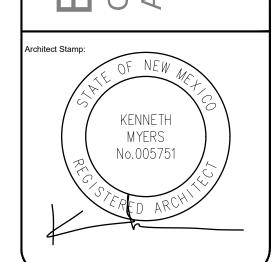


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urban design + development 1716 Central SW, Suite A Albuquerque, NM 87104 t: 505-243-0188

	KMA		KMA	
Phase: DFT SUBMITTAL				
Date:	09/22/20	25		

SITE PLAN COVER SHEET



# TCL GENERAL NOTES

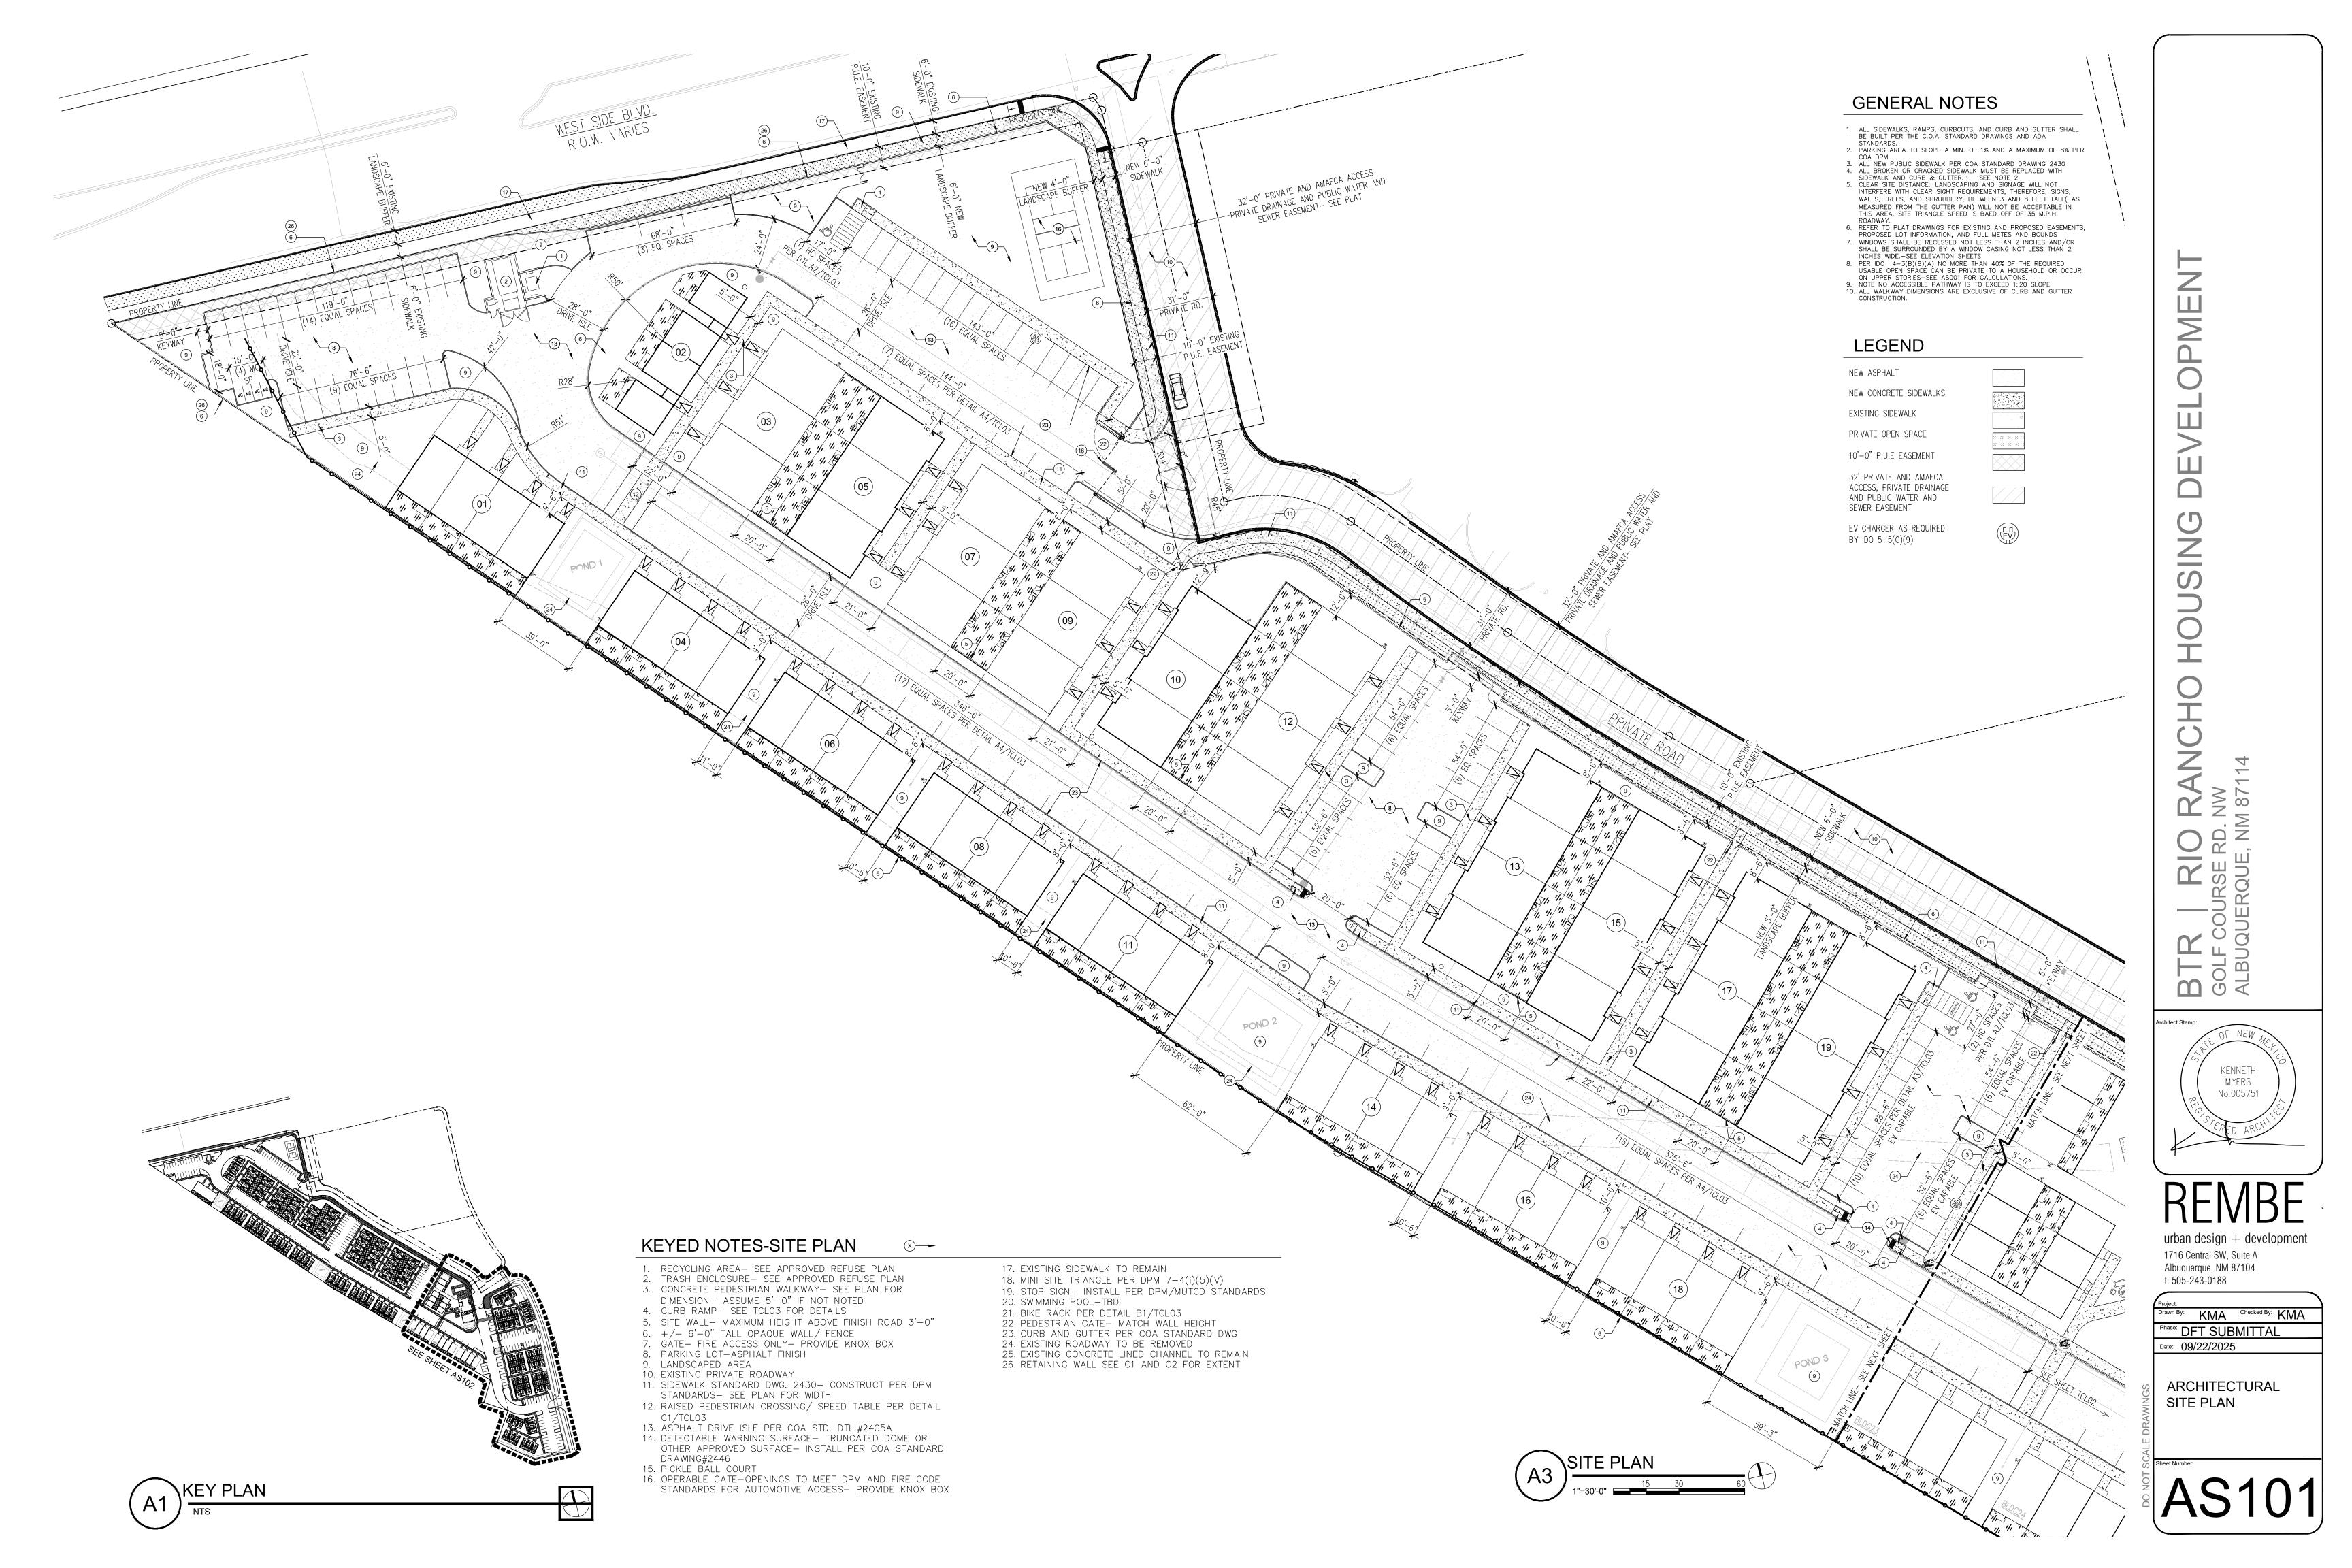- 1. PARKING AREA TO SLOPE A MIN. OF 1% AND A MAXIMUM OF 8% PER COA DPM
- 2. ALL NEW PUBLIC SIDEWALK PER COA STANDARD DRAWING 2430 3. ALL BROKEN OR CRACKED SIDEWALK MUST BE REPLACED WITH
- SIDEWALK AND CURB & GUTTER." SEE NOTE 2

  4. LANDSCAPING AND SIGNAGE WILL NOT INTERFERE WITH CLEAR SIGHT REQUIREMENTS. THEREFORE, SIGNS, WALLS, TREES, AND SHRUBBERY BETWEEN 3 AND 8 FEET TALL (AS MEASURED FROM THE GUTTER PAN) WILL NOT BE ACCEPTABLE IN THE CLEAR SIGHT
- 5. NOTE NO ACCESSIBLE PATHWAY IS TO EXCEED 1:20 SLOPE
  6. ALL WALKWAY DIMENSIONS ARE EXCLUSIVE OF CURB AND GUTTER
- CONSTRUCTION.
  7. PROVIDE STANARD CURB AND GUTTER PER STD. DTL.#2406 IN ALL PARKING LOTS, AND ROADWAYS

# LEGEND

BY IDO 5-5(C)(9)

NEW ASPHALT

NEW CONCRETE SIDEWALKS


EXISTING SIDEWALK


PRIVATE OPEN SPACE

10'-0" P.U.E EASEMENT

32' PRIVATE AND AMAFCA
ACCESS, PRIVATE DRAINAGE
AND PUBLIC WATER AND
SEWER EASEMENT

EV CHARGER AS REQUIRED

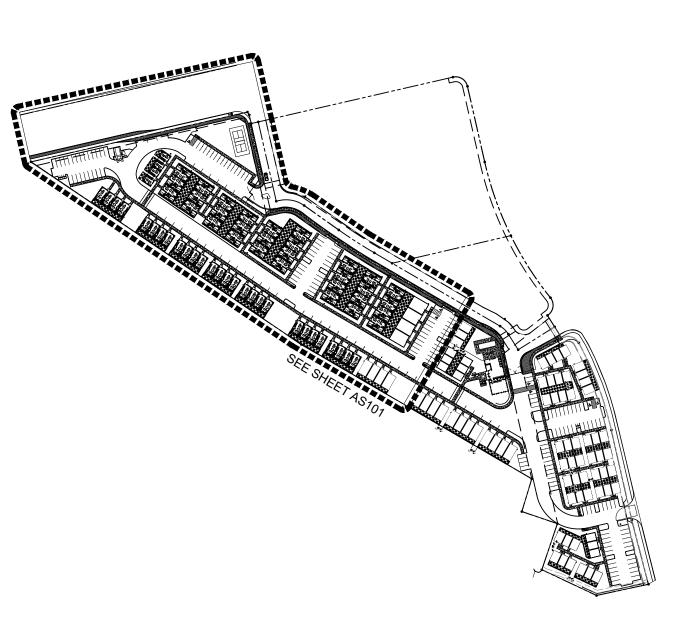

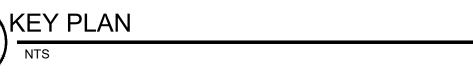


BTR | RIO RANCHO | GOLF COURSE RD. NW

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Project:

Drawn By: KMA

Checked By: KMA

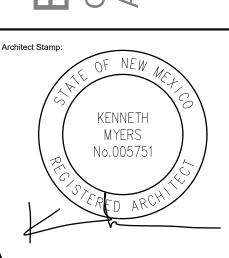
Phase: DFT SUBMITTAL

Date: 09/22/2025

ARCHITECTURAL SI

ARCHITECTURAL SITE PLAN

AS102

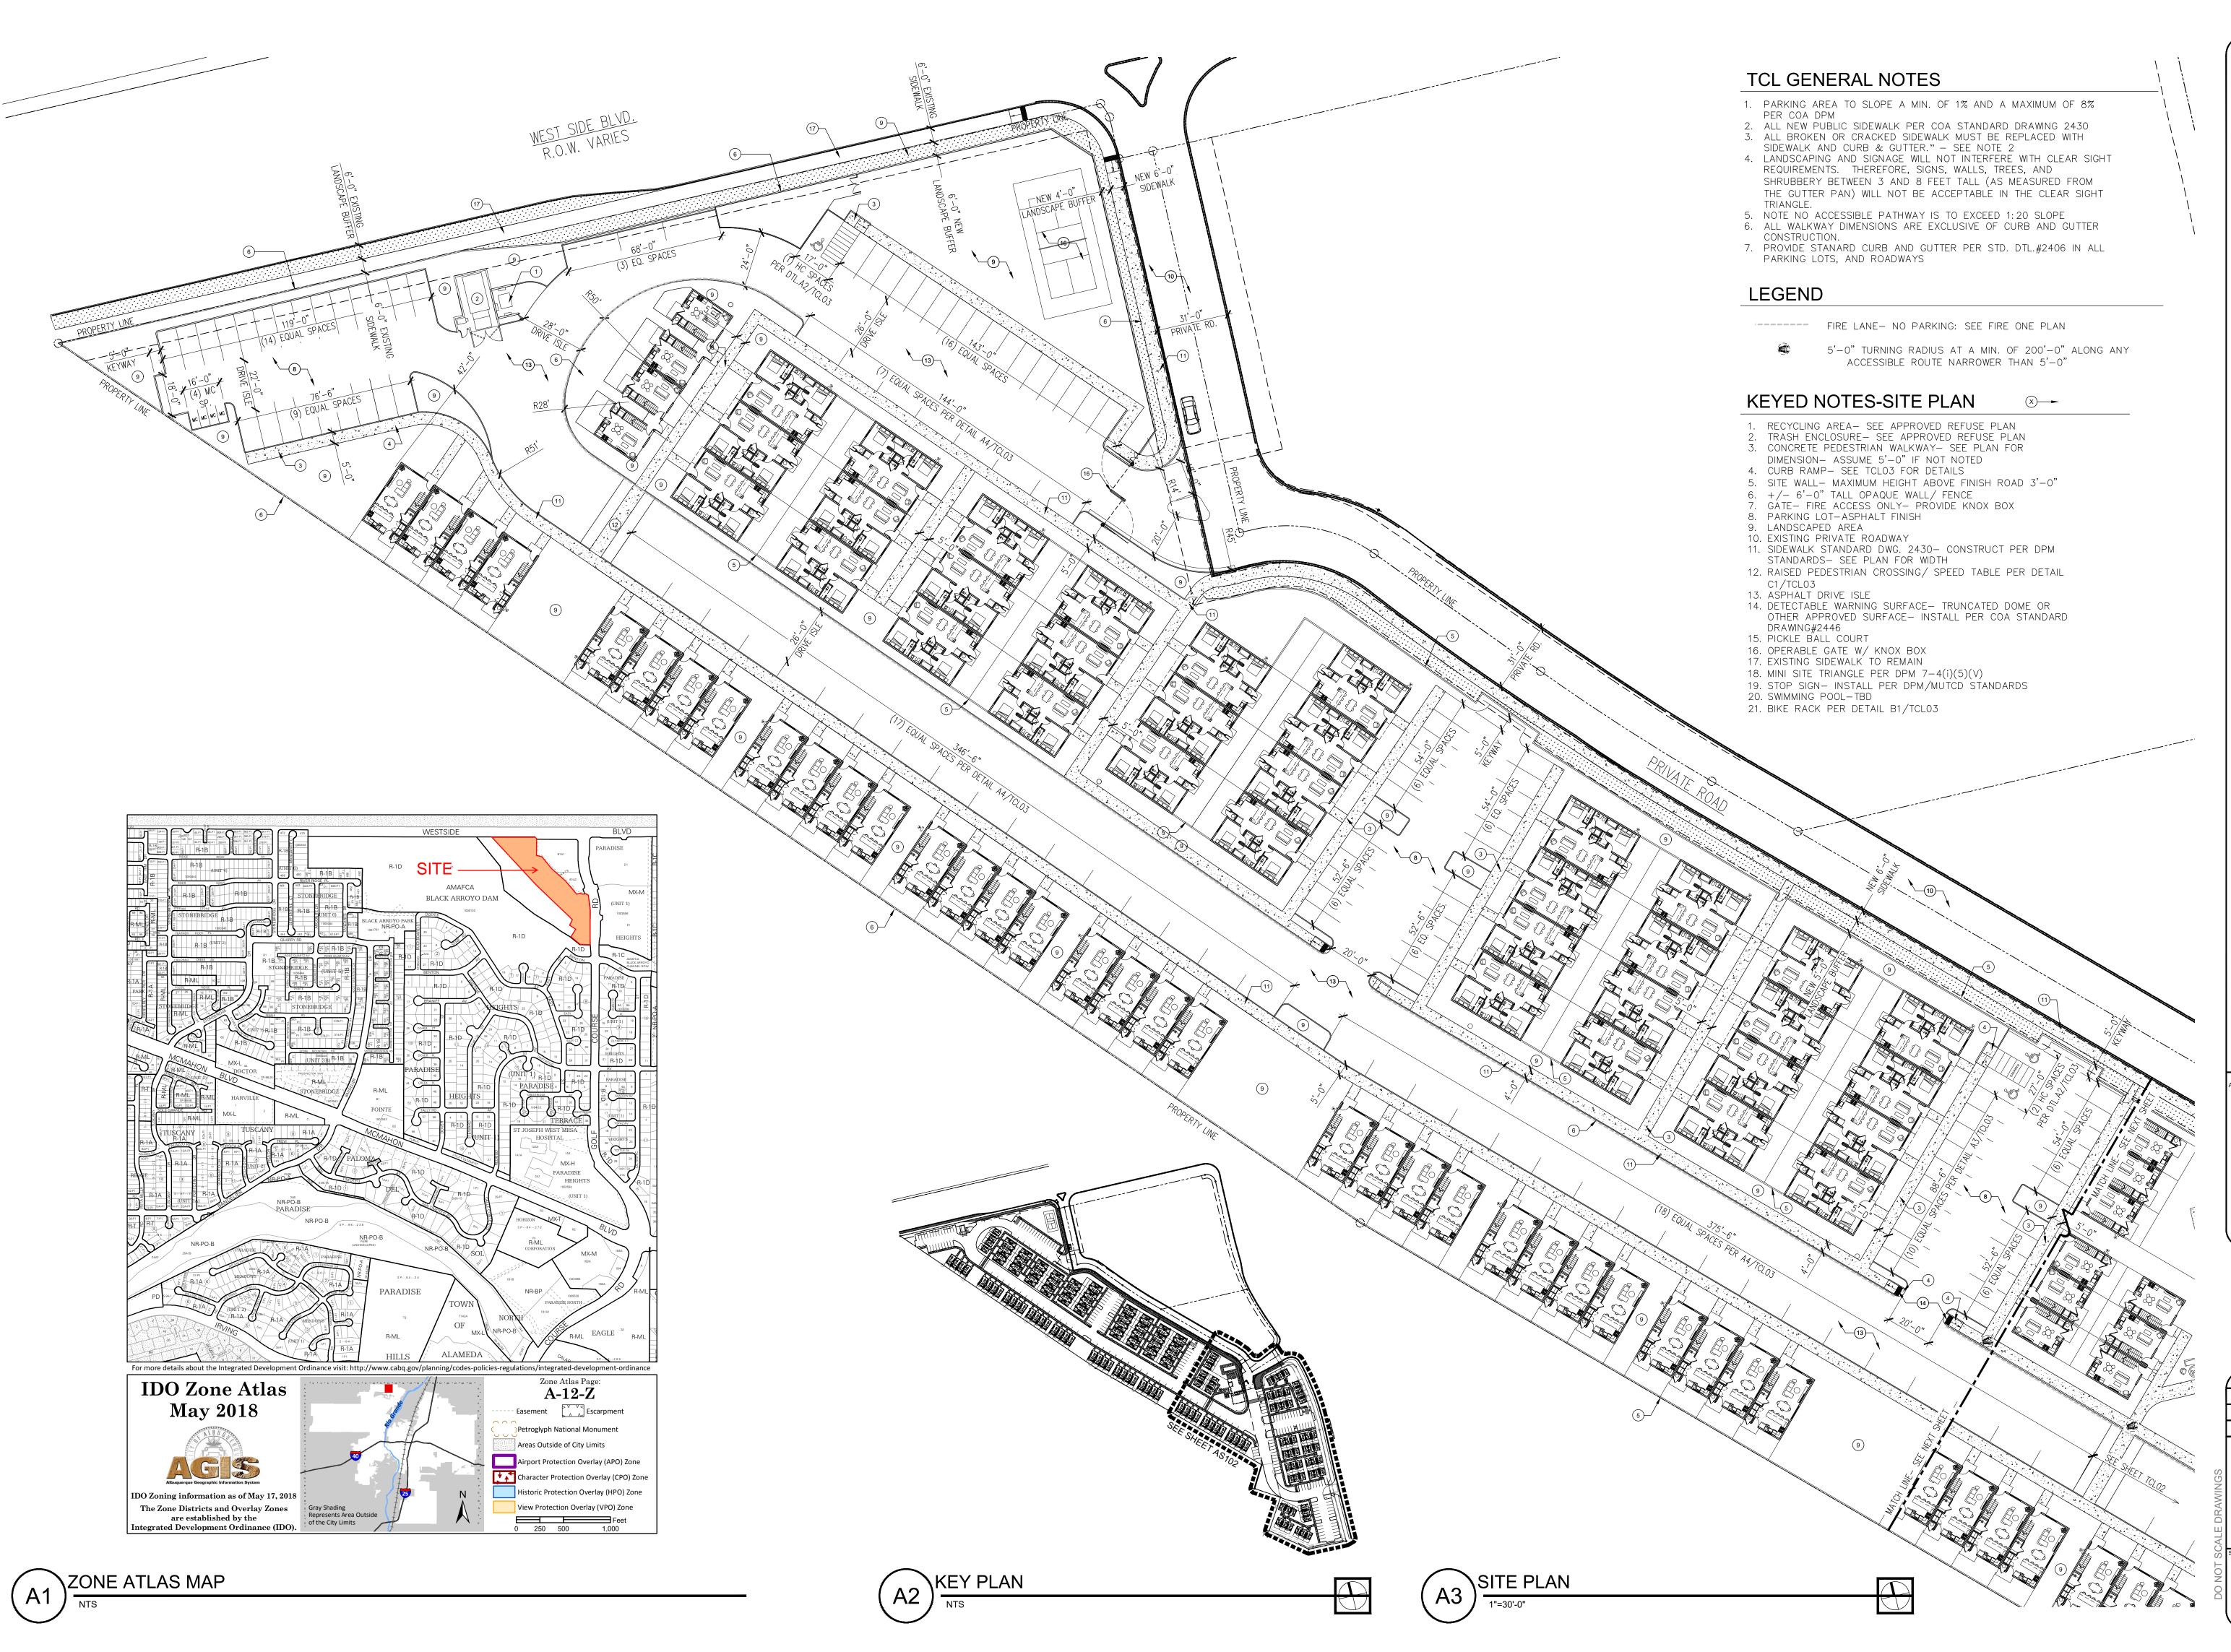

TR | RIO RANCHO HOUSING DEVELOPME

chitect Stamp:

OF NEW METH
MYERS
No.005751

HEIVIBE
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1716 Central SW, Suite A

Albuquerque, NM 87104 t: 505-243-0188

Drawn By: KMA Checked By: KMA

Phase: DFT SUBMITTAL

Date: 09/22/2025

TRAFFIC CONTROL LAYOUT PLAN

TCL0′

TCL GENERAL NOTES 1. PARKING AREA TO SLOPE A MIN. OF 1% AND A MAXIMUM OF 8% PER COA DPM

2. ALL NEW PUBLIC SIDEWALK PER COA STANDARD DRAWING 2430 3. ALL BROKEN OR CRACKED SIDEWALK MUST BE REPLACED WITH

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5. NOTE NO ACCESSIBLE PATHWAY IS TO EXCEED 1:20 SLOPE 6. ALL WALKWAY DIMENSIONS ARE EXCLUSIVE OF CURB AND GUTTER

CONSTRUCTION.

7. PROVIDE STANARD CURB AND GUTTER PER STD. DTL.#2406 IN ALL PARKING LOTS, AND ROADWAYS

# LEGEND

FIRE LANE- NO PARKING: SEE FIRE ONE PLAN

5'-0" TURNING RADIUS AT A MIN. OF 200'-0" ALONG ANY ACCESSIBLE ROUTE NARROWER THAN 5'-0"

# KEYED NOTES-SITE PLAN

RECYCLING AREA – SEE APPROVED REFUSE PLAN
 TRASH ENCLOSURE – SEE APPROVED REFUSE PLAN

3. CONCRETE PEDESTRIAN WALKWAY- SEE PLAN FOR

DIMENSION- ASSUME 5'-0" IF NOT NOTED 4. CURB RAMP- SEE TCL03 FOR DETAILS

5. SITE WALL- MAXIMUM HEIGHT ABOVE FINISH ROAD 3'-0"

6. +/- 6'-0" TALL OPAQUE WALL/ FENCE
7. GATE- FIRE ACCESS ONLY- PROVIDE KNOX BOX

8. PARKING LOT-ASPHALT FINISH

9. LANDSCAPED AREA

10. EXISTING PRIVATE ROADWAY 11. SIDEWALK STANDARD DWG. 2430— CONSTRUCT PER DPM STANDARDS— SEE PLAN FOR WIDTH

12. RAISED PEDESTRIAN CROSSING/ SPEED TABLE PER DETAIL

C1/TCL03 13. ASPHALT ROAD WAY PER COA STD. DTL.#2405A 14. DETECTABLE WARNING SURFACE— TRUNCÄTED DOME OR OTHER APPROVED SURFACE- INSTALL PER COA STANDARD

DRAWING#2446 15. PICKLE BÄLL COURT


16. OPERABLE GATE W/ KNOX BOX

17. EXISTING SIDEWALK TO REMAIN

18. MINI SITE TRIANGLE PER DPM 7-4(i)(5)(V)19. STOP SIGN- INSTALL PER DPM/MUTCD STANDARDS

20. SWIMMING POOL-TBD 21. BIKE RACK PER DETAIL B1/TCL03

Parking Calculations	Unit Count/sf.	IDO notes	Multiplier/Credit	Total Req'd	Provided
Residential Units MX-M	145	Table 5-5-1: multifamily= 1.2 SP per 1BR; 1.6 SP per to 2 BR	1.2/1.6	205.6	
Residential Community Ammenity	6,000	Table 5-5-1: Residential Com. Ammenity= 3 spaces per 1,000GFA	3	18	
		Plus 1 space per 3 design capacity per Table 5-5-2	12	4	
subtotal				228	
Total		5-5(C)(5)(b) Shared Parking Reduction; Table 5-5-3: Shared Parking Rediction Factors: Multi-family/ Other Non-residential= 1.3	1.3	175	218
EV charging stations	145	Per 5-5(C)(9) requires 5% of the required spaces be equiped w/ EV charging stations 240V or greater	5%	7.25	8
EV Capable	145	Per 5-5(C)(9) requires 25% of the required spaces be provided as EV capable	25%	36.25	36
Accessible Spaces (HC)	145	Per 208.2 ADAAG for 201-300 off street spaces 7 HC spaces required; 2 van space required		7	7
MotorCycle	145	IDO, table 5-5-4: Between 101-150 spaces = 4 MC Spaces required		4	6
Bicycle	145	IDO, table 5-5-5: 10% of required spaces	10%	14.5	14.5

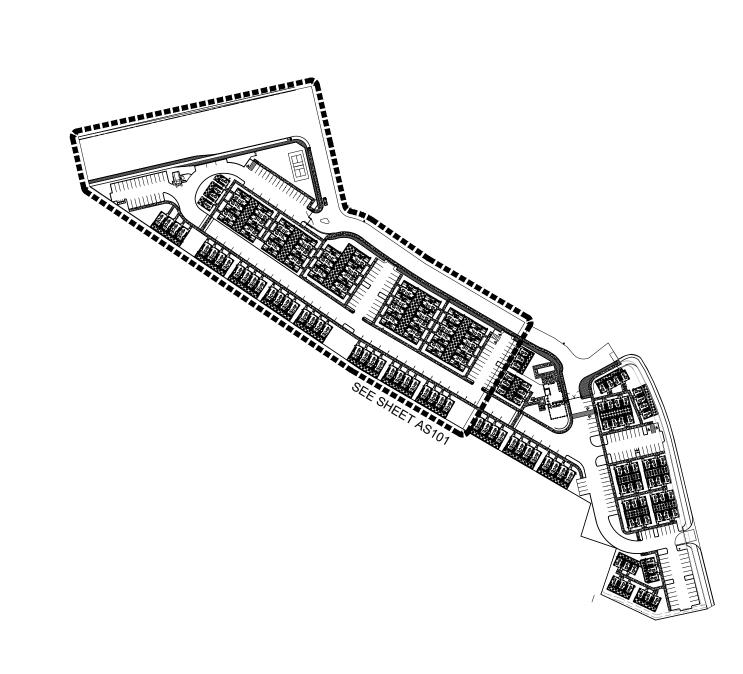

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Drawn By: KMA Checked By: KMA Phase: DFT SUBMITTAL

Date: 09/22/2025

KENNETH MYERS No.005751

TRAFFIC CONTROL LAYOUT

SITE PLAN


APPROXIMATE

LOCATION OF 6,000

SF. AMMENITIES BUILDING

KEY PLAN



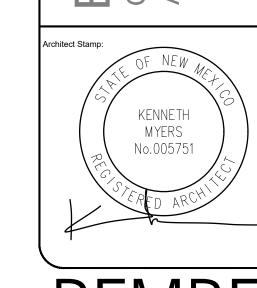





Albuquerque, NM 87104 t: 505-243-0188

oject: BTR-GOLF CRSE Drawn By: KMA Checked By: KMA hase: CONCEPTUAL

Date: 08/07/2025 TRAFFIC CONTROL LAYOUT PLAN


DETAILS CONCEPTUAL

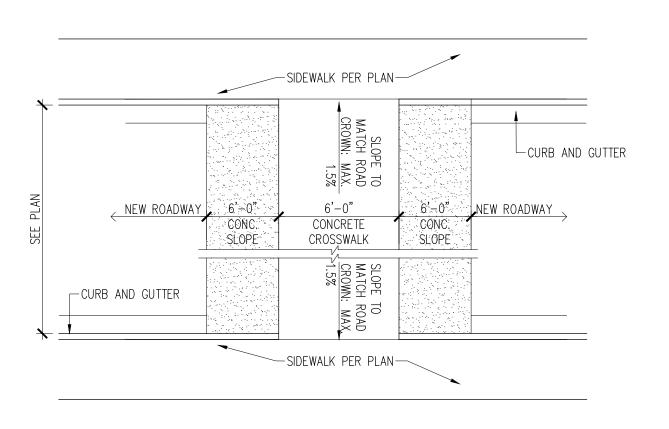


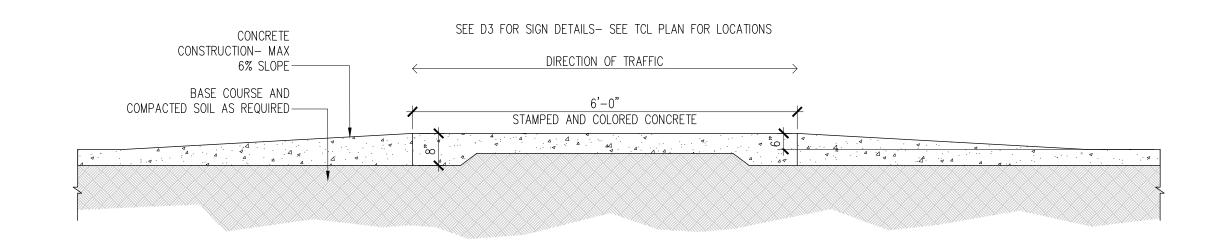



# C1) Cross Walk Detail

**B1** 

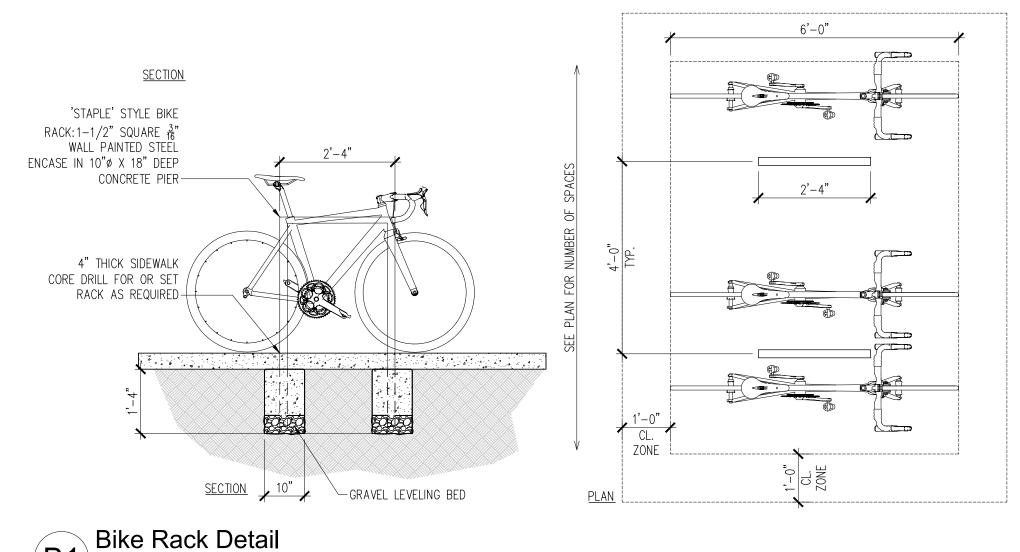

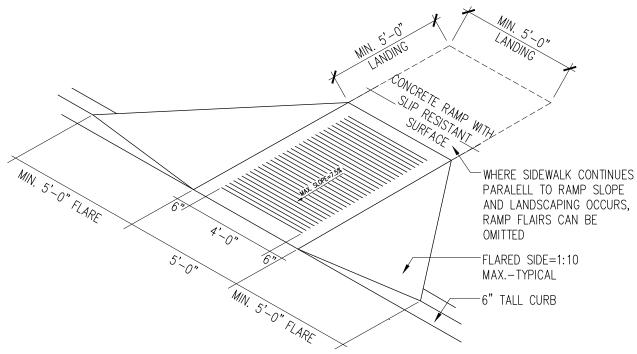

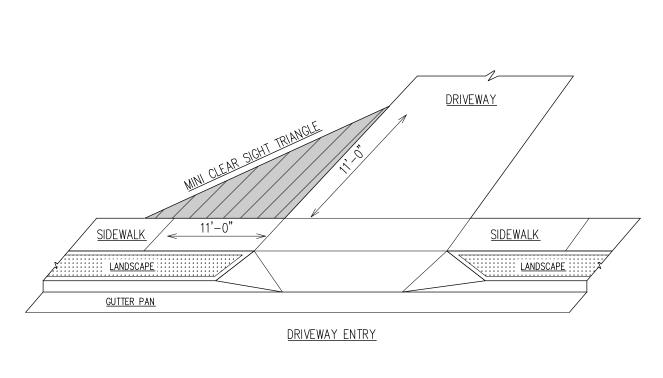

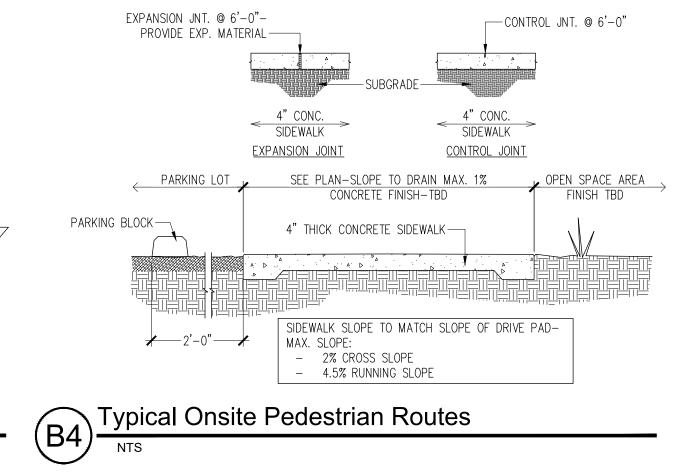

CARPOOL MOTORCYCLE HC PARKING PARKING SIGN PARKING SIGN SIGN

EQUAL EQUAL >

New Post Sign Detail

1/8"=1'-0"

LOCATE CENTER OF STRUCTURE 12" FROM BACK OF WALK

SIGN LETTERING AND BORDER = GREEN

1978 66-7-352.4C-'<u>VIOLATORS ARE</u> SUBJECT TO A FINE AND OR TOWING'

-6"x12" VAN ACCESSIBLE SIGN ONLY

REQ'D AT HC VAN PARKING

PROVIDE (4)  $2X2X\frac{3}{16}$ " TABS

PROVIDE (2)  $2X2X\frac{3}{16}$ " TABS-

WHERE SIGN IS REQUIRED

—SET STEEL SLEEVE IN CONCRETE

WHERE APPLICABLE- WELD SIGN AS

— CONCRETE PAD-WHERE APPLICABLE

WHEN NOT SET IN CONCRETE PAD

10" Ø CONCRETE FOOTING- SET 2" BELOW GRADE AND COVER WITH FINISH MATERIAL

-12"x18" ALUMINUM PANEL SIGN SEE

AT 5'-0" MIN OR ABOVE VAN SIGN)

ABOVE/ SEE PLAN FOR TYPE (SET BOTTOM

-PROVIDE REQUIRED LANGUAGE PER NMSA


-2X2X3/16" STEEL FRAME- MITER CORNERS GRIND SMOOTH- PAINT TO MATCH EXISTING SIGNS


—SIGN FIELD= WHITE

LOCATION(S)


B2 Alternate Curb Ramp Detail


B3 Mini-Clear Site Triangle

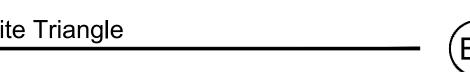


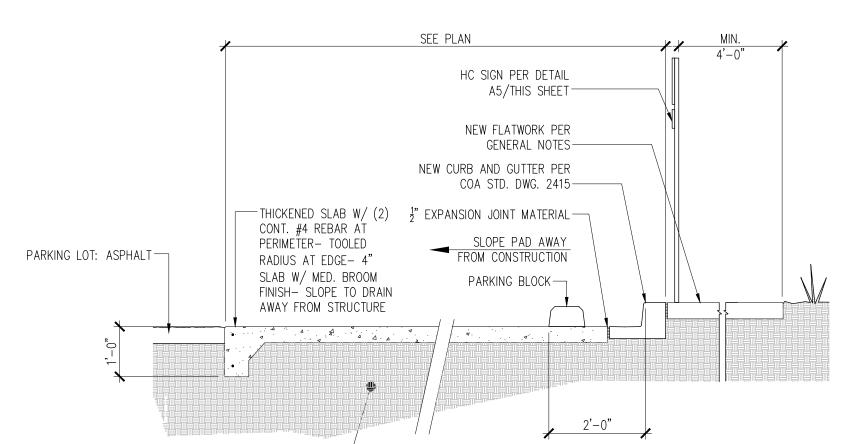

PREPARED SUBSOIL-

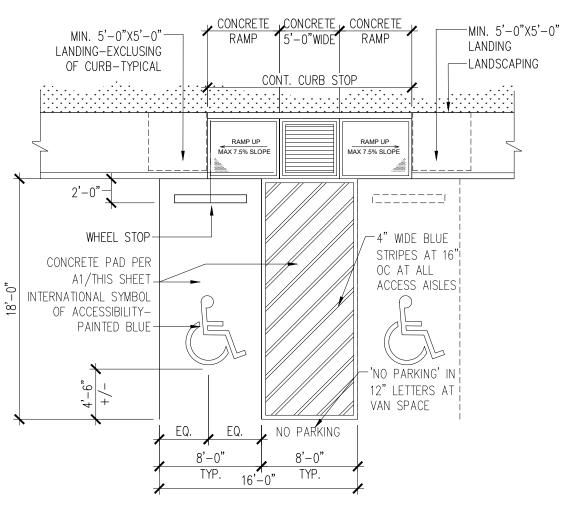

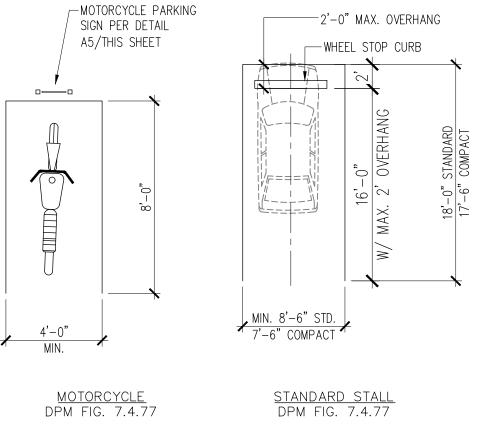

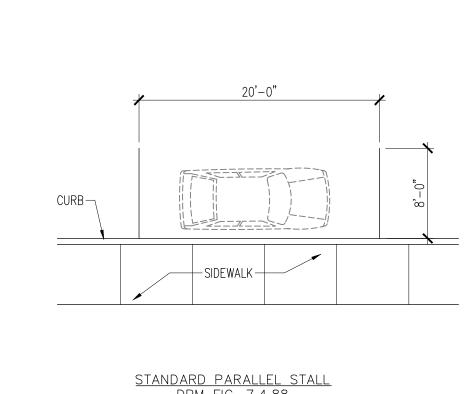


STANDARD PARALLEL STALL DPM FIG. 7.4.88

A4 Typical Parallel Parking Space

A2) Typical HC Parking Space/Curb Ramp

A1 Typical HC Parking Space Detail

A3 Typical Parking Space Detail

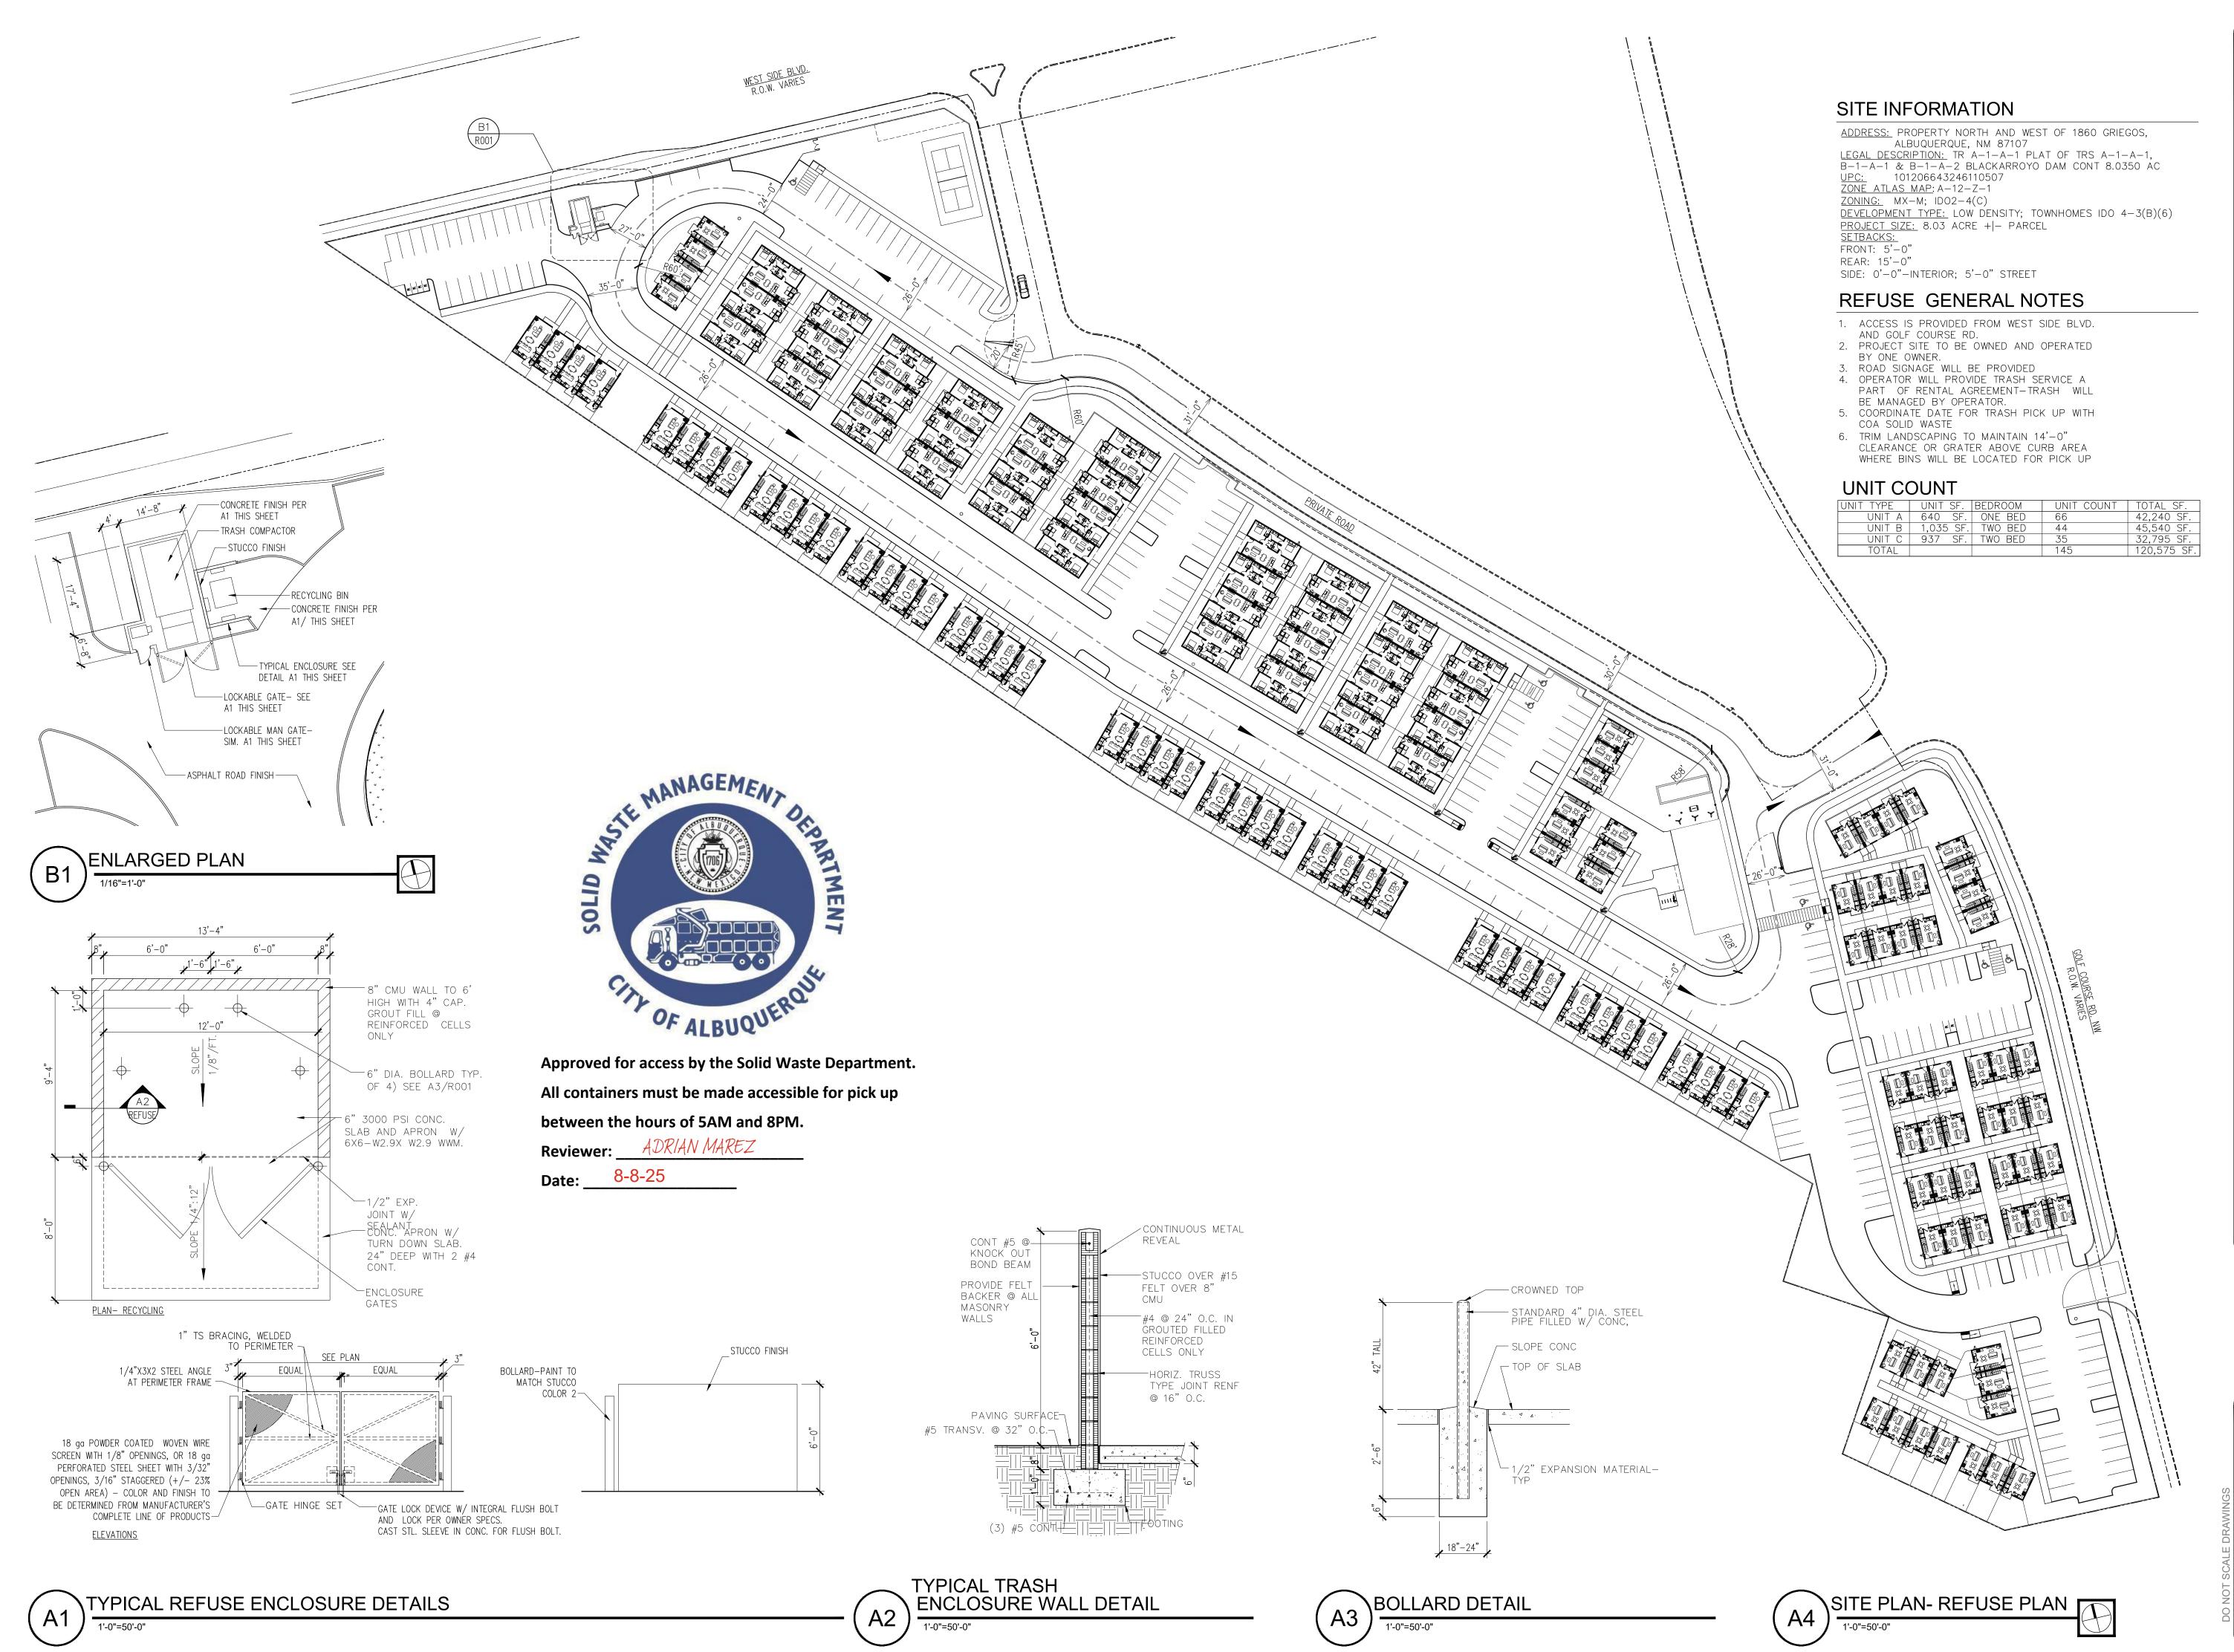

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ALBUQUERQUE, NM 87114

KENNETH MYERS
No.005751

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Project: BTR-GOLF CRSE

Drawn By: KMA

Checked By: KMA


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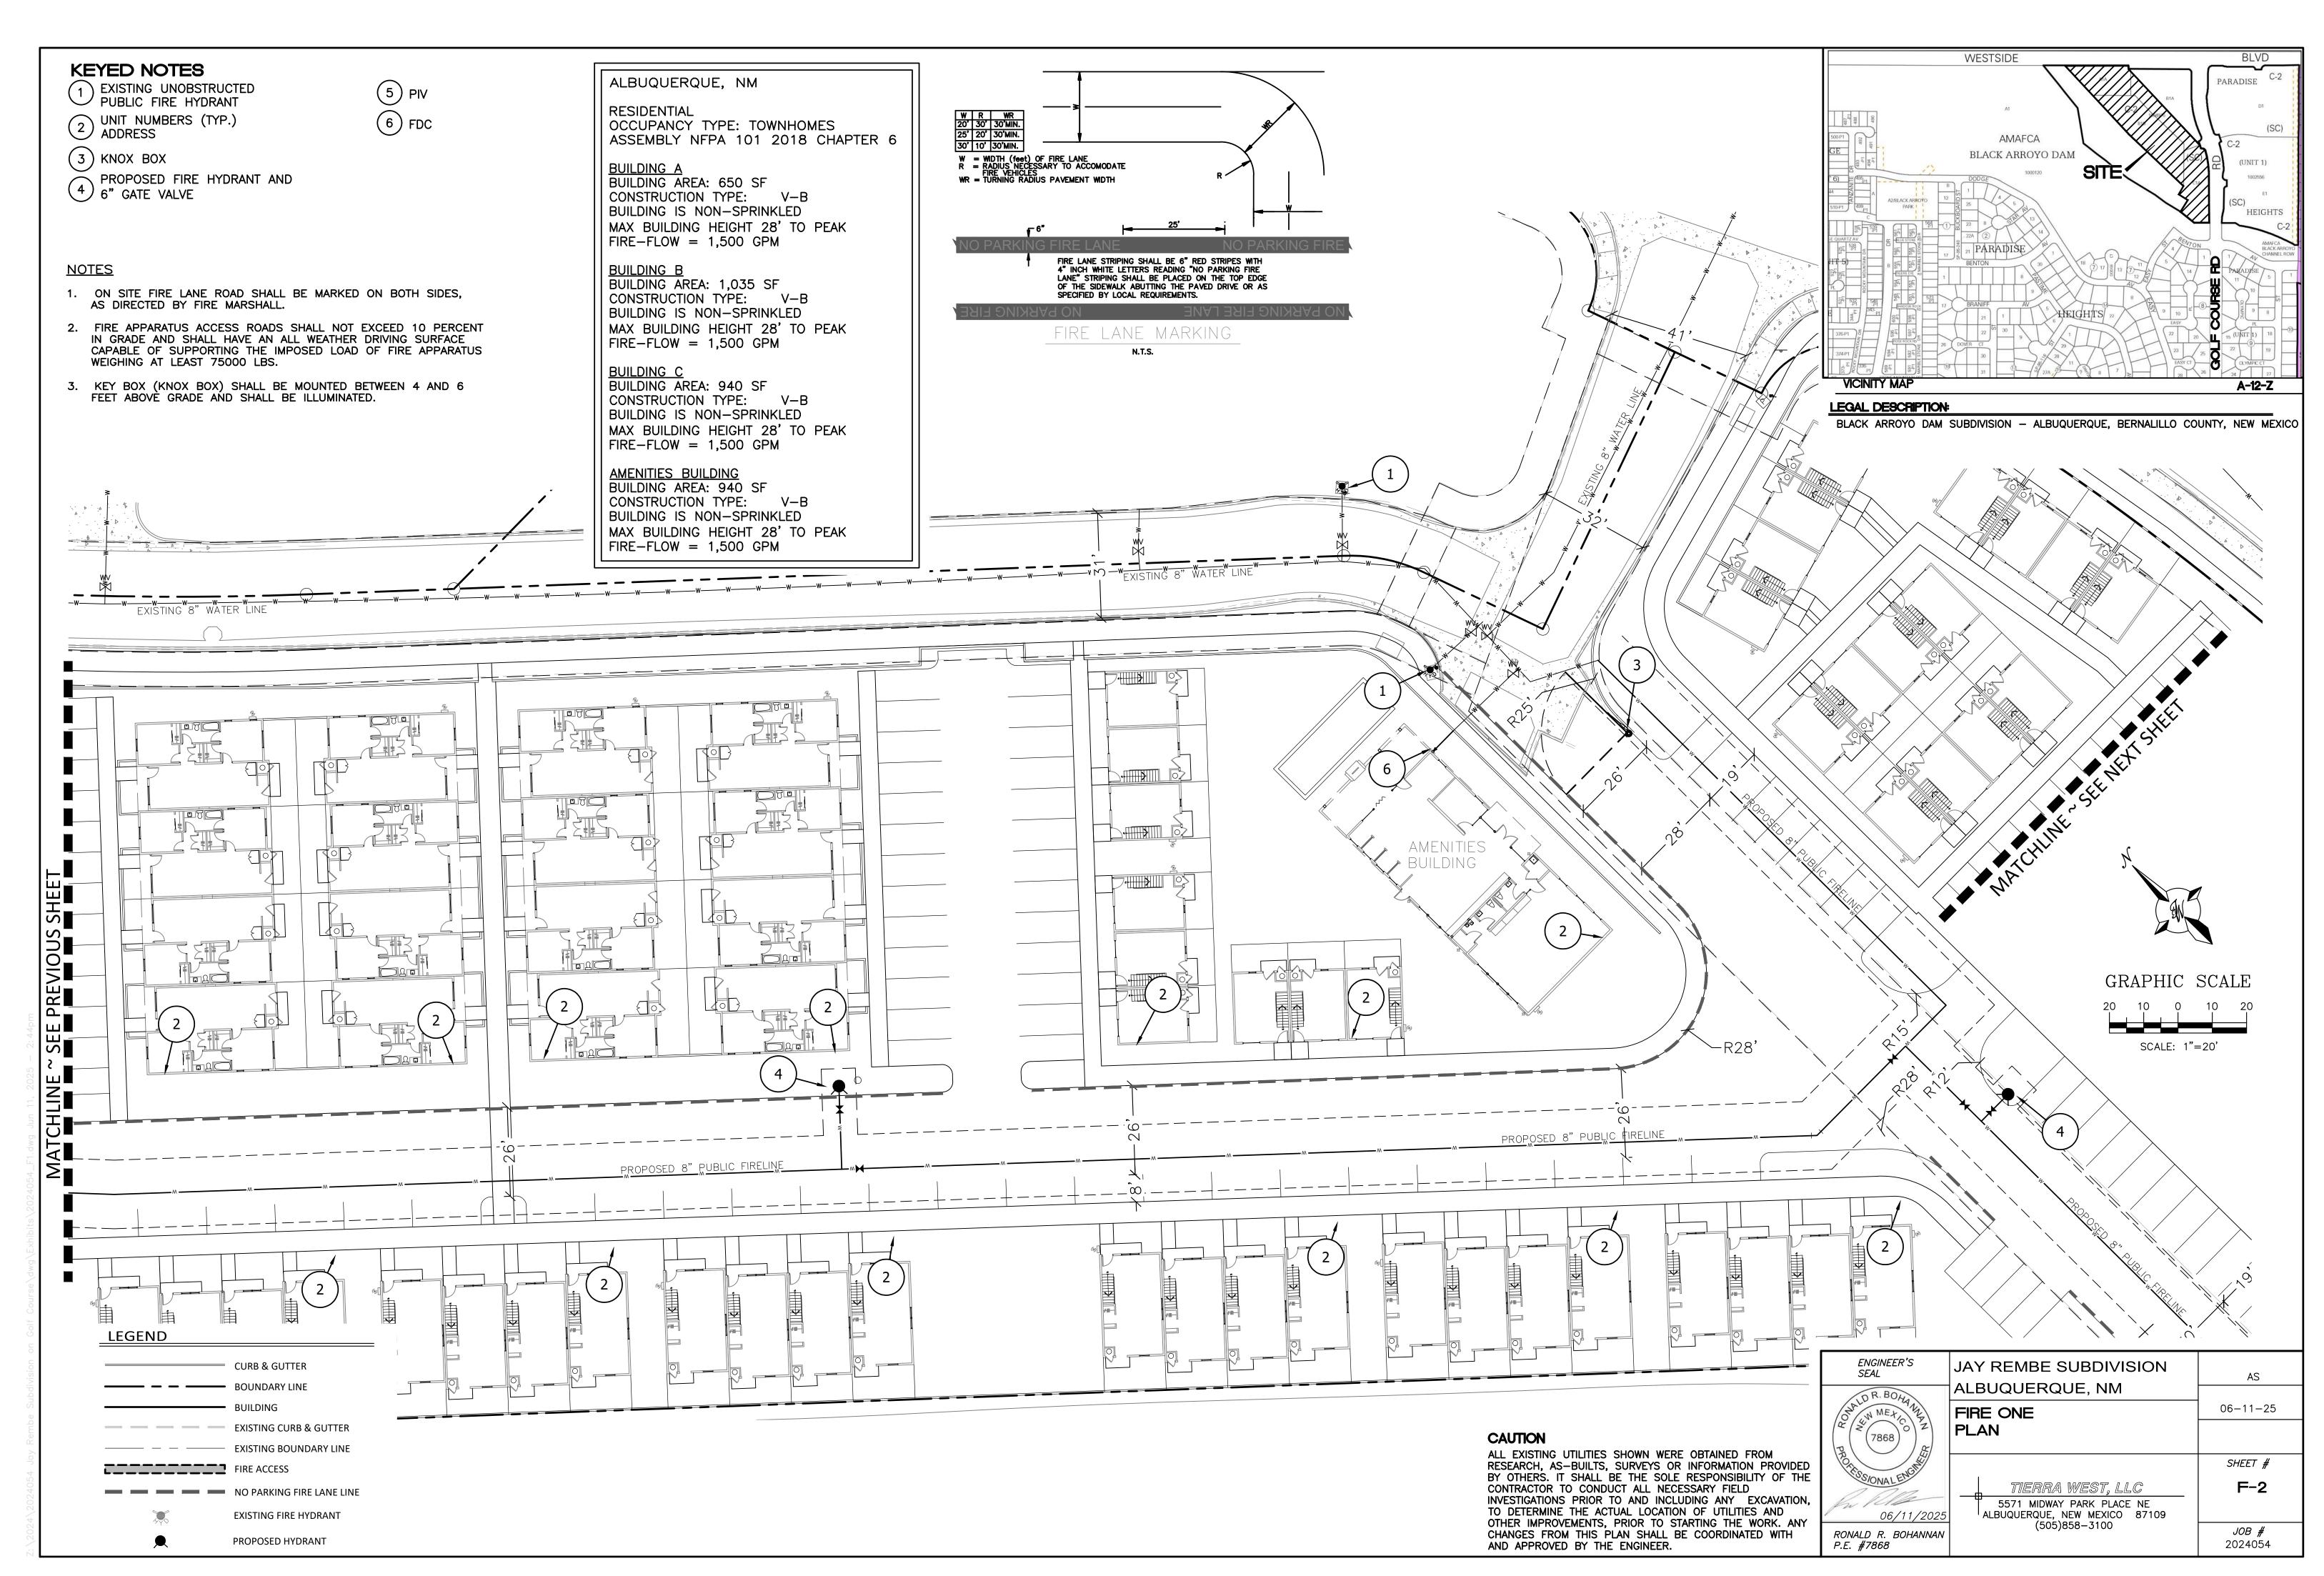
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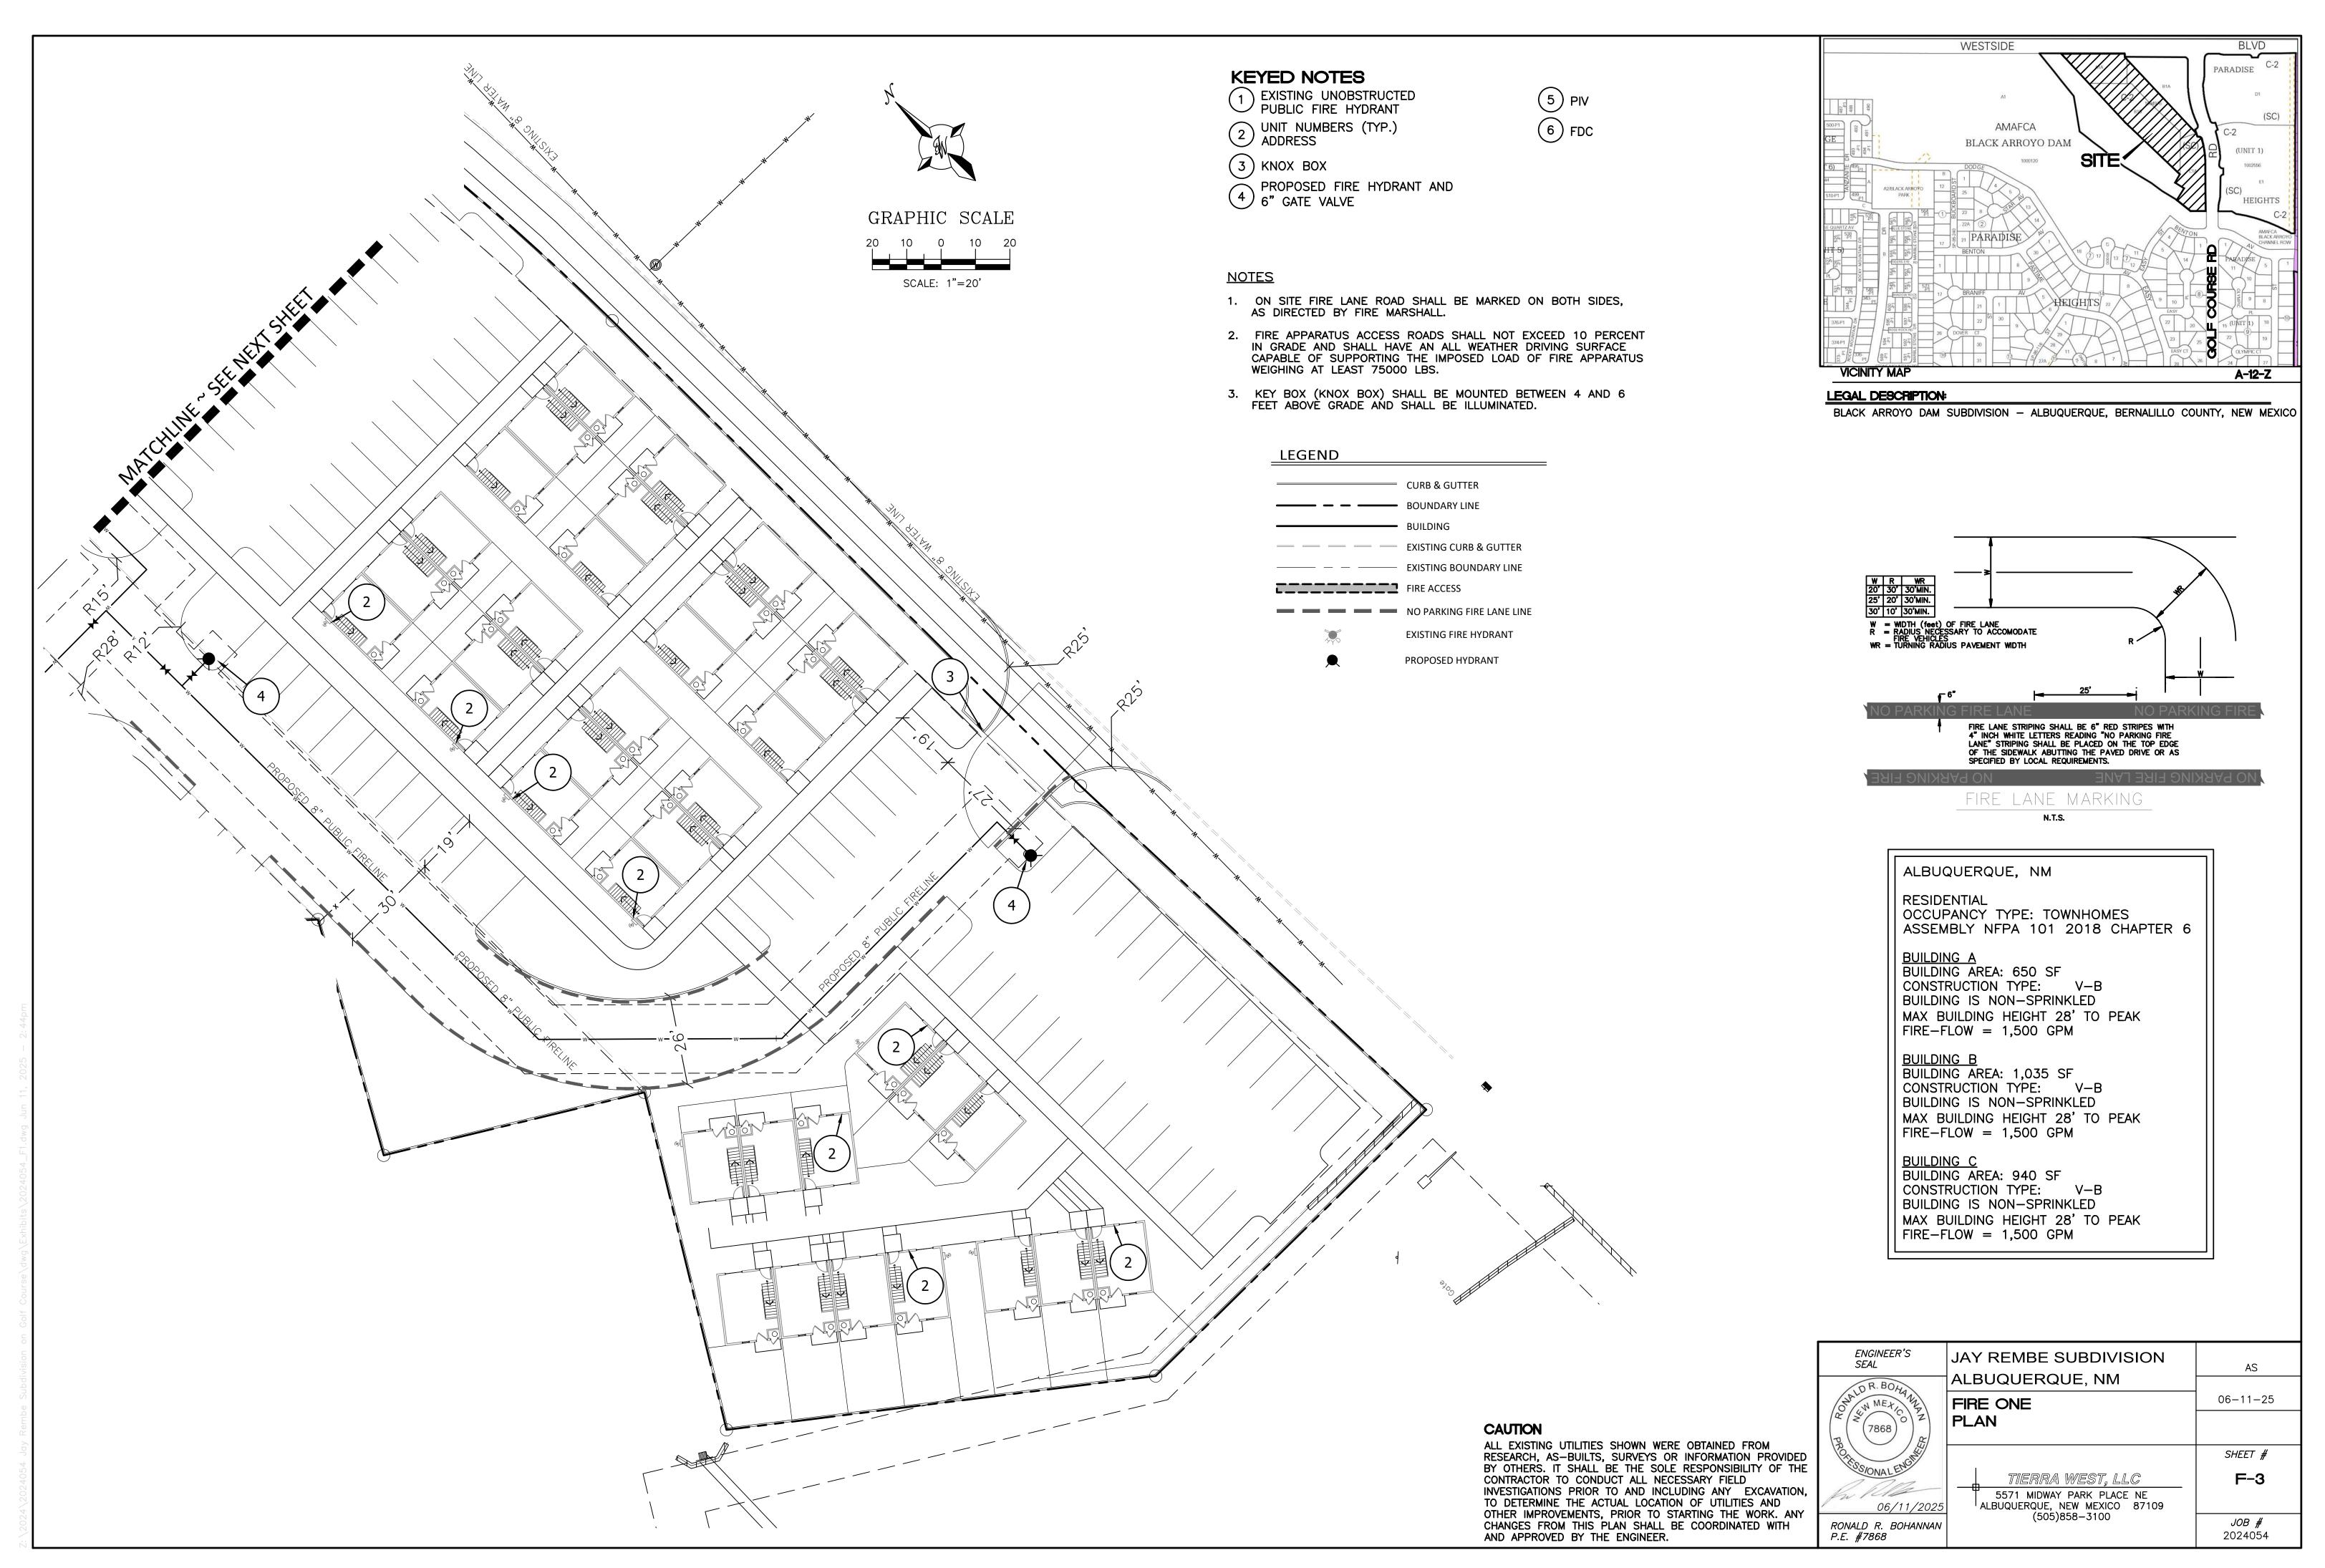
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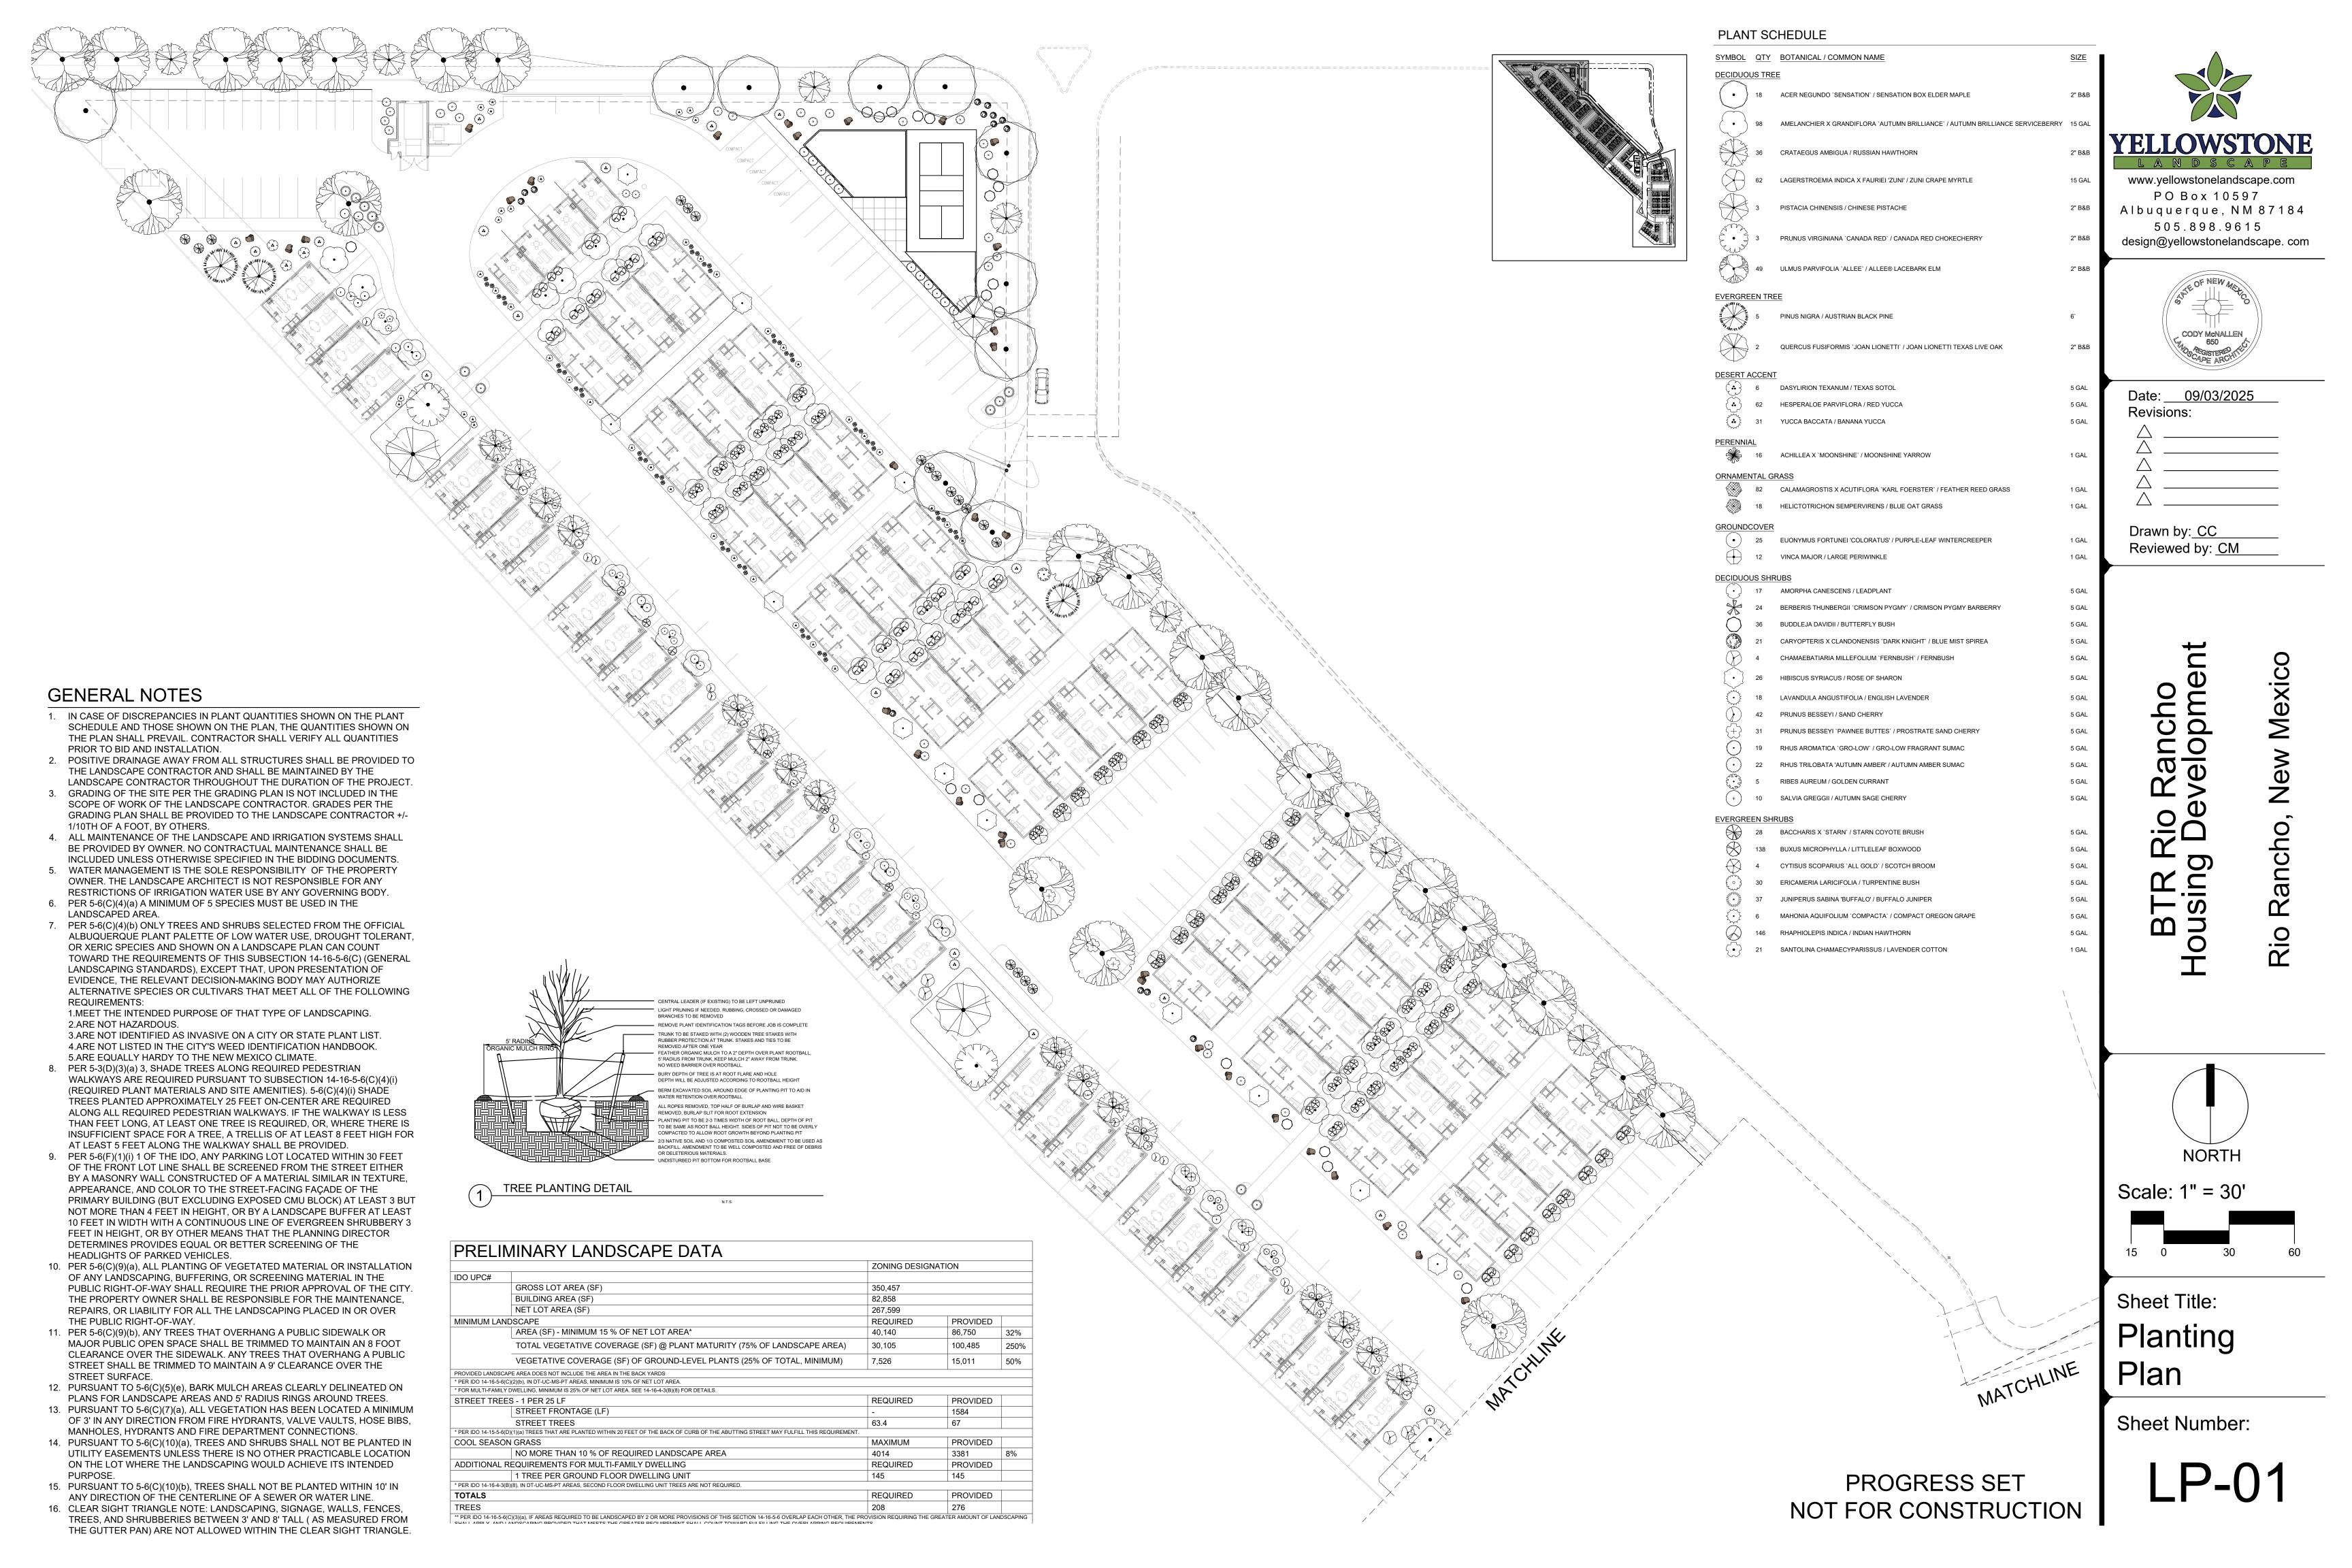
REFUSE PLAN

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# **GENERAL NOTES**

- 1. IN CASE OF DISCREPANCIES IN PLANT QUANTITIES SHOWN ON THE PLANT SCHEDULE AND THOSE SHOWN ON THE PLAN, THE QUANTITIES SHOWN ON THE PLAN SHALL PREVAIL. CONTRACTOR SHALL VERIFY ALL QUANTITIES PRIOR TO BID AND INSTALLATION.
- 2. POSITIVE DRAINAGE AWAY FROM ALL STRUCTURES SHALL BE PROVIDED TO THE LANDSCAPE CONTRACTOR AND SHALL BE MAINTAINED BY THE LANDSCAPE CONTRACTOR THROUGHOUT THE DURATION OF THE PROJECT.
- 3. GRADING OF THE SITE PER THE GRADING PLAN IS NOT INCLUDED IN THE SCOPE OF WORK OF THE LANDSCAPE CONTRACTOR. GRADES PER THE GRADING PLAN SHALL BE PROVIDED TO THE LANDSCAPE CONTRACTOR +/-1/10TH OF A FOOT, BY OTHERS.
- ALL MAINTENANCE OF THE LANDSCAPE AND IRRIGATION SYSTEMS SHALL BE PROVIDED BY OWNER. NO CONTRACTUAL MAINTENANCE SHALL BE INCLUDED UNLESS OTHERWISE SPECIFIED IN THE BIDDING DOCUMENTS.
   WATER MANAGEMENT IS THE SOLE RESPONSIBILITY OF THE PROPERTY OWNER. THE LANDSCAPE ARCHITECT IS NOT RESPONSIBLE FOR ANY RESTRICTIONS OF IRRIGATION WATER USE BY ANY GOVERNING BODY.
- 6. PER 5-6(C)(4)(a) A MINIMUM OF 5 SPECIES MUST BE USED IN THE LANDSCAPED AREA.
- 7. PER 5-6(C)(4)(b) ONLY TREES AND SHRUBS SELECTED FROM THE OFFICIAL ALBUQUERQUE PLANT PALETTE OF LOW WATER USE, DROUGHT TOLERANT, OR XERIC SPECIES AND SHOWN ON A LANDSCAPE PLAN CAN COUNT TOWARD THE REQUIREMENTS OF THIS SUBSECTION 14-16-5-6(C) (GENERAL LANDSCAPING STANDARDS), EXCEPT THAT, UPON PRESENTATION OF EVIDENCE, THE RELEVANT DECISION-MAKING BODY MAY AUTHORIZE ALTERNATIVE SPECIES OR CULTIVARS THAT MEET ALL OF THE FOLLOWING REQUIREMENTS:
- 1.MEET THE INTENDED PURPOSE OF THAT TYPE OF LANDSCAPING.2.ARE NOT HAZARDOUS.3.ARE NOT IDENTIFIED AS INVASIVE ON A CITY OR STATE PLANT LIST.
- 4.ARE NOT LISTED IN THE CITY'S WEED IDENTIFICATION HANDBOOK.
  5.ARE EQUALLY HARDY TO THE NEW MEXICO CLIMATE.

  8. PER 5-3(D)(3)(a) 3, SHADE TREES ALONG REQUIRED PEDESTRIAN
- WALKWAYS ARE REQUIRED PURSUANT TO SUBSECTION 14-16-5-6(C)(4)(i)
  (REQUIRED PLANT MATERIALS AND SITE AMENITIES). 5-6(C)(4)(i) SHADE
  TREES PLANTED APPROXIMATELY 25 FEET ON-CENTER ARE REQUIRED
  ALONG ALL REQUIRED PEDESTRIAN WALKWAYS. IF THE WALKWAY IS LESS
  THAN FEET LONG, AT LEAST ONE TREE IS REQUIRED, OR, WHERE THERE IS
  INSUFFICIENT SPACE FOR A TREE, A TRELLIS OF AT LEAST 8 FEET HIGH FOR
  AT LEAST 5 FEET ALONG THE WALKWAY SHALL BE PROVIDED.
- 9. PER 5-6(F)(1)(i) 1 OF THE IDO, ANY PARKING LOT LOCATED WITHIN 30 FEET OF THE FRONT LOT LINE SHALL BE SCREENED FROM THE STREET EITHER BY A MASONRY WALL CONSTRUCTED OF A MATERIAL SIMILAR IN TEXTURE, APPEARANCE, AND COLOR TO THE STREET-FACING FAÇADE OF THE PRIMARY BUILDING (BUT EXCLUDING EXPOSED CMU BLOCK) AT LEAST 3 BUT NOT MORE THAN 4 FEET IN HEIGHT, OR BY A LANDSCAPE BUFFER AT LEAST 10 FEET IN WIDTH WITH A CONTINUOUS LINE OF EVERGREEN SHRUBBERY 3 FEET IN HEIGHT, OR BY OTHER MEANS THAT THE PLANNING DIRECTOR DETERMINES PROVIDES EQUAL OR BETTER SCREENING OF THE
- HEADLIGHTS OF PARKED VEHICLES.

  10. PER 5-6(C)(9)(a), ALL PLANTING OF VEGETATED MATERIAL OR INSTALLATION OF ANY LANDSCAPING, BUFFERING, OR SCREENING MATERIAL IN THE PUBLIC RIGHT-OF-WAY SHALL REQUIRE THE PRIOR APPROVAL OF THE CITY. THE PROPERTY OWNER SHALL BE RESPONSIBLE FOR THE MAINTENANCE, REPAIRS, OR LIABILITY FOR ALL THE LANDSCAPING PLACED IN OR OVER
- THE PUBLIC RIGHT-OF-WAY.

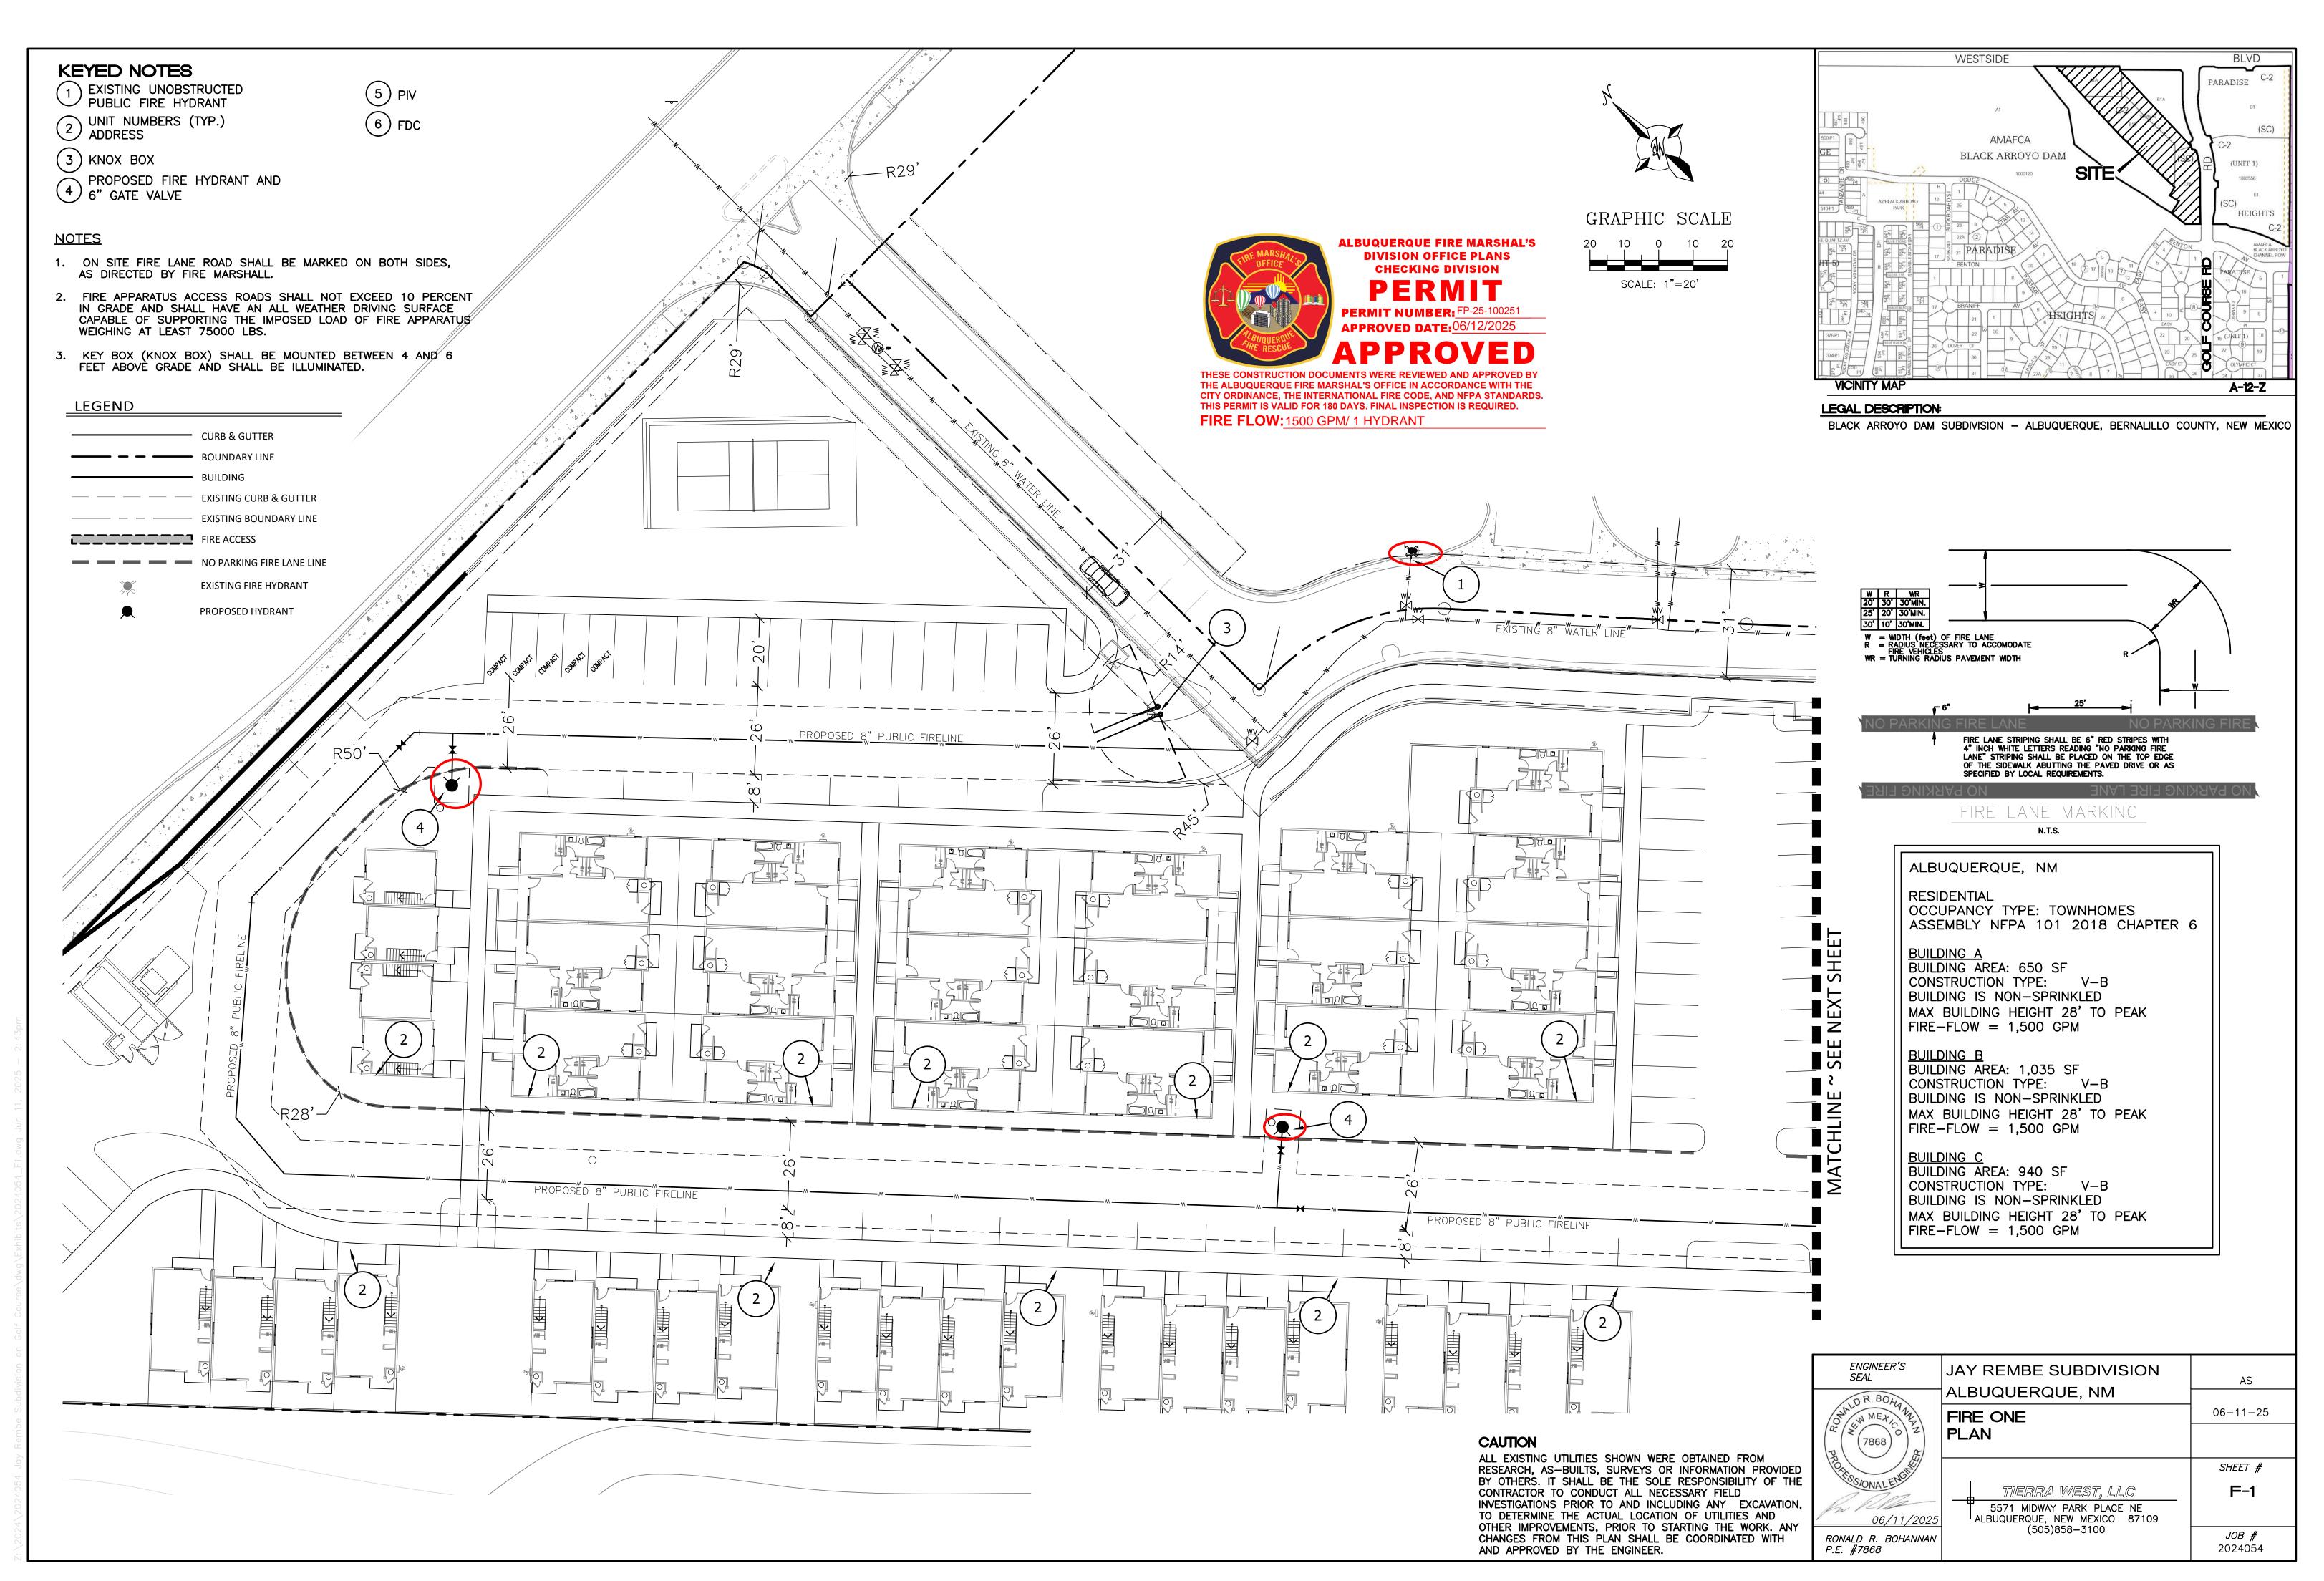  11. PER 5-6(C)(9)(b), ANY TREES THAT OVERHANG A PUBLIC SIDEWALK OR MAJOR PUBLIC OPEN SPACE SHALL BE TRIMMED TO MAINTAIN AN 8 FOOT CLEARANCE OVER THE SIDEWALK. ANY TREES THAT OVERHANG A PUBLIC STREET SHALL BE TRIMMED TO MAINTAIN A 9' CLEARANCE OVER THE
- STREET SURFACE.

  12. PURSUANT TO 5-6(C)(5)(e), BARK MULCH AREAS CLEARLY DELINEATED ON PLANS FOR LANDSCAPE AREAS AND 5' RADIUS RINGS AROUND TREES.

  13. PURSUANT TO 5-6(C)(7)(a), ALL VEGETATION HAS BEEN LOCATED A MINIMUM
- OF 3' IN ANY DIRECTION FROM FIRE HYDRANTS, VALVE VAULTS, HOSE BIBS, MANHOLES, HYDRANTS AND FIRE DEPARTMENT CONNECTIONS.

  14. PURSUANT TO 5-6(C)(10)(a), TREES AND SHRUBS SHALL NOT BE PLANTED IN UTILITY EASEMENTS UNLESS THERE IS NO OTHER PRACTICABLE LOCATION ON THE LOT WHERE THE LANDSCAPING WOULD ACHIEVE ITS INTENDED
- PURPOSE.

  15. PURSUANT TO 5-6(C)(10)(b), TREES SHALL NOT BE PLANTED WITHIN 10' IN ANY DIRECTION OF THE CENTERLINE OF A SEWER OR WATER LINE.
- 16. CLEAR SIGHT TRIANGLE NOTE: LANDSCAPING, SIGNAGE, WALLS, FENCES, TREES, AND SHRUBBERIES BETWEEN 3' AND 8' TALL ( AS MEASURED FROM THE GUTTER PAN) ARE NOT ALLOWED WITHIN THE CLEAR SIGHT TRIANGLE.

# PLANT SCHEDULE


PLANT SCHEDULE						
SYMBOL	QTY	BOTANICAL / COMMON NAME	SIZE			
DECIDUOL	JS TRE	<u>E</u>				
	18	ACER NEGUNDO 'SENSATION' / SENSATION BOX ELDER MAPLE	2" B&B			
•	98	AMELANCHIER X GRANDIFLORA 'AUTUMN BRILLIANCE' / AUTUMN BRILLIANCE SERVICEBERRY	15 GAL			
	36	CRATAEGUS AMBIGUA / RUSSIAN HAWTHORN	2" B&B			
	62	LAGERSTROEMIA INDICA X FAURIEI 'ZUNI' / ZUNI CRAPE MYRTLE	15 GAL			
	3	PISTACIA CHINENSIS / CHINESE PISTACHE	2" B&B			
T. J.	3	PRUNUS VIRGINIANA 'CANADA RED' / CANADA RED CHOKECHERRY	2" B&B			
	49	ULMUS PARVIFOLIA `ALLEE` / ALLEE® LACEBARK ELM	2" B&B			
EVERGRE	EN TRE	<u>:E</u>				
THE STATE OF THE S	5	PINUS NIGRA / AUSTRIAN BLACK PINE	6`			
	2	QUERCUS FUSIFORMIS 'JOAN LIONETTI' / JOAN LIONETTI TEXAS LIVE OAK	2" B&B			
DESERT A	CCENT	<u>.</u> -				
	6	DASYLIRION TEXANUM / TEXAS SOTOL	5 GAL			
۲ <b>٠</b>	62	HESPERALOE PARVIFLORA / RED YUCCA	5 GAL			
<b>₹.</b> }	31	YUCCA BACCATA / BANANA YUCCA	5 GAL			
PERENNIA	16	ACHILLEA X `MOONSHINE` / MOONSHINE YARROW	1 GAL			
ORNAMEN	ITAL GF	RASS				
	82	CALAMAGROSTIS X ACUTIFLORA `KARL FOERSTER` / FEATHER REED GRASS	1 GAL			
	18	HELICTOTRICHON SEMPERVIRENS / BLUE OAT GRASS	1 GAL			
GROUNDO						
	25	EUONYMUS FORTUNEI 'COLORATUS' / PURPLE-LEAF WINTERCREEPER	1 GAL			
	12	VINCA MAJOR / LARGE PERIWINKLE	1 GAL			
DECIDUOL			5.041			
	17	AMORPHA CANESCENS / LEADPLANT	5 GAL			
	24 36	BERBERIS THUNBERGII `CRIMSON PYGMY` / CRIMSON PYGMY BARBERRY  BUDDLEJA DAVIDII / BUTTERFLY BUSH	5 GAL			
	21	CARYOPTERIS X CLANDONENSIS 'DARK KNIGHT' / BLUE MIST SPIREA	5 GAL			
	4	CHAMAEBATIARIA MILLEFOLIUM 'FERNBUSH' / FERNBUSH	5 GAL			
	26	HIBISCUS SYRIACUS / ROSE OF SHARON	5 GAL			
Jung 1						
\(\frac{1}{2}\)	18	LAVANDULA ANGUSTIFOLIA / ENGLISH LAVENDER	5 GAL			
	42	PRUNUS BESSEYI / SAND CHERRY	5 GAL			
+	31	PRUNUS BESSEYI 'PAWNEE BUTTES' / PROSTRATE SAND CHERRY  RHUS AROMATICA 'GRO-LOW' / GRO-LOW FRAGRANT SUMAC	5 GAL			
	19		5 GAL			
	22	RHUS TRILOBATA 'AUTUMN AMBER' / AUTUMN AMBER SUMAC	5 GAL			
F 250 25	5 10	RIBES AUREUM / GOLDEN CURRANT SALVIA GREGGII / AUTUMN SAGE CHERRY	5 GAL			
<b>T</b>			U GAL			
EVERGRE	EN SHF 28	RUBS  BACCHARIS X 'STARN' / STARN COYOTE BRUSH	5 GAL			
	138	BUXUS MICROPHYLLA / LITTLELEAF BOXWOOD	5 GAL			
$\Diamond$	4	CYTISUS SCOPARIUS `ALL GOLD` / SCOTCH BROOM	5 GAL			
the said	30	ERICAMERIA LARICIFOLIA / TURPENTINE BUSH	5 GAL			
**************************************	37	JUNIPERUS SABINA 'BUFFALO' / BUFFALO JUNIPER	5 GAL			
	<i>-</i> 1	55 E. 100 ONDITTE DOLLARED FOR LINE	JUAL			

MAHONIA AQUIFOLIUM 'COMPACTA' / COMPACT OREGON GRAPE

SANTOLINA CHAMAECYPARISSUS / LAVENDER COTTON

146 RHAPHIOLEPIS INDICA / INDIAN HAWTHORN



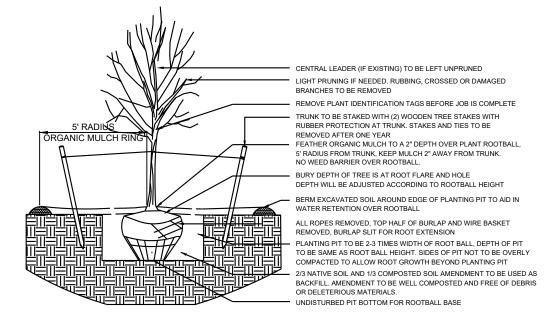


1	TREE PLANTING DETA

PRELIMINARY LANDSCAPE DATA

		ZONING DESIGN	NATION	
IDO UPC#				
	GROSS LOT AREA (SF)	350,457		
	BUILDING AREA (SF)	82,858		
	NET LOT AREA (SF)	267,599		
MINIMUM LA	NDSCAPE	REQUIRED	PROVIDED	
	AREA (SF) - MINIMUM 15 % OF NET LOT AREA*	40,140	86,750	32%
	TOTAL VEGETATIVE COVERAGE (SF) @ PLANT MATURITY (75% OF LANDSCAPE AREA)	30,105	100,485	250%
	VEGETATIVE COVERAGE (SF) OF GROUND-LEVEL PLANTS (25% OF TOTAL, MINIMUM)	7,526	15,011	50%
PROVIDED LANDS	CAPE AREA DOES NOT INCLUDE THE AREA IN THE BACK YARDS		<u>'</u>	
	6(C)(2)(b), IN DT-UC-MS-PT AREAS, MINIMUM IS 10% OF NET LOT AREA.			
* FOR MULTI-FAMI	LY DWELLING, MINIMUM IS 25% OF NET LOT AREA. SEE 14-16-4-3(B)(8) FOR DETAILS.			
STREET TRE	EES - 1 PER 25 LF	REQUIRED	PROVIDED	
	STREET FRONTAGE (LF)	-	1584	
	STREET TREES	63.4	67	
* PER IDO 14-15-5-	6(D)(1)(a) TREES THAT ARE PLANTED WITHIN 20 FEET OF THE BACK OF CURB OF THE ABUTTING STREET MAY FULFILL THIS REQUIREMENT			
COOL SEAS	ON GRASS	MAXIMUM	PROVIDED	
	NO MORE THAN 10 % OF REQUIRED LANDSCAPE AREA	4014	3381	8%
ADDITIONAL	REQUIREMENTS FOR MULTI-FAMILY DWELLING	REQUIRED	PROVIDED	
	1 TREE PER GROUND FLOOR DWELLING UNIT	145	145	
* PER IDO 14-16-4-	3(B)(8), IN DT-UC-MS-PT AREAS, SECOND FLOOR DWELLING UNIT TREES ARE NOT REQUIRED.	<u>'</u>	'	'
		REQUIRED	PROVIDED	
TOTALS		~		




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design@yellowstonelandscape.com

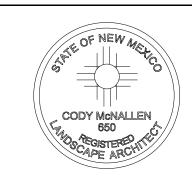


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	by: <u>CC</u>
Review	red by: CM

# BTR Rio Rancho Housing Development

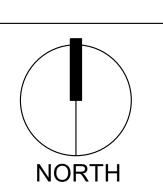

**R**io


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Sheet Title:
Planting
Plan

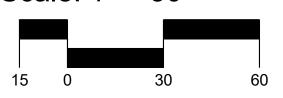Sheet Number:

LP-02



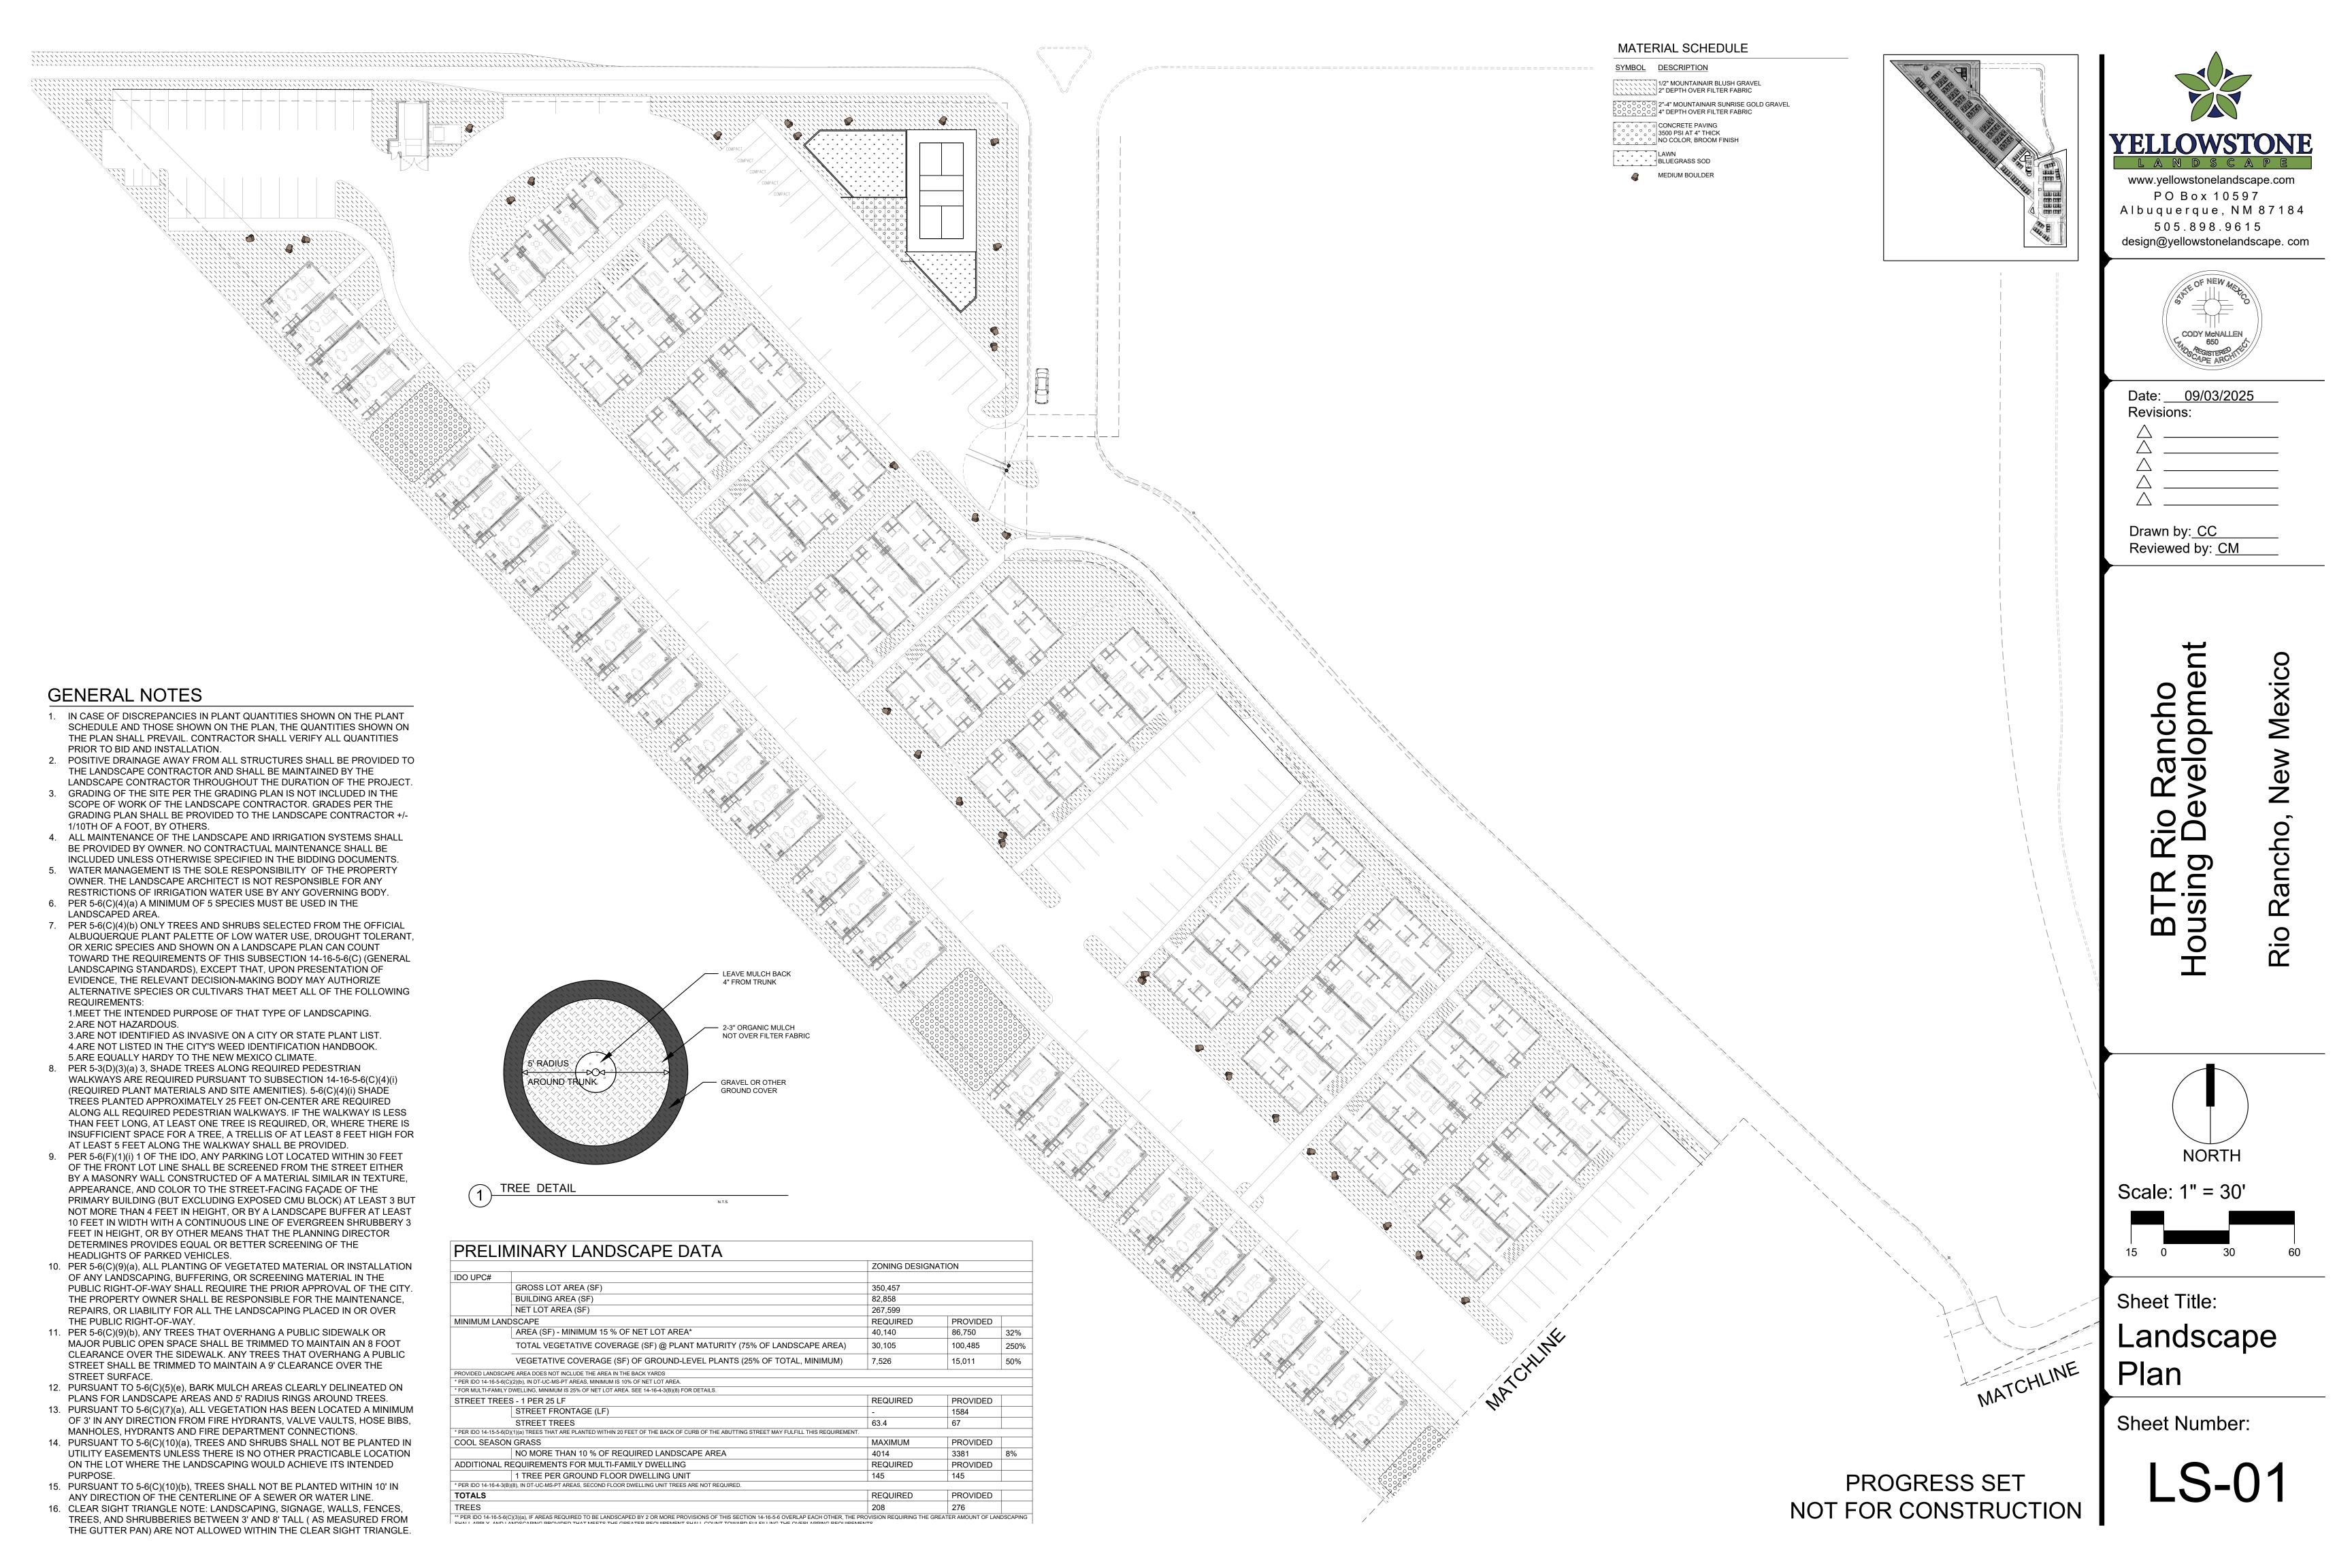

# GENERAL NOTES

- 1. IN CASE OF DISCREPANCIES IN PLANT QUANTITIES SHOWN ON THE PLANT SCHEDULE AND THOSE SHOWN ON THE PLAN, THE QUANTITIES SHOWN ON THE PLAN SHALL PREVAIL. CONTRACTOR SHALL VERIFY ALL QUANTITIES PRIOR TO BID AND INSTALLATION.
- 2. POSITIVE DRAINAGE AWAY FROM ALL STRUCTURES SHALL BE PROVIDED TO THE LANDSCAPE CONTRACTOR AND SHALL BE MAINTAINED BY THE LANDSCAPE CONTRACTOR THROUGHOUT THE DURATION OF THE PROJECT.
- 3. GRADING OF THE SITE PER THE GRADING PLAN IS NOT INCLUDED IN THE SCOPE OF WORK OF THE LANDSCAPE CONTRACTOR. GRADES PER THE GRADING PLAN SHALL BE PROVIDED TO THE LANDSCAPE CONTRACTOR +/-1/10TH OF A FOOT, BY OTHERS.
- ALL MAINTENANCE OF THE LANDSCAPE AND IRRIGATION SYSTEMS SHALL BE PROVIDED BY OWNER. NO CONTRACTUAL MAINTENANCE SHALL BE INCLUDED UNLESS OTHERWISE SPECIFIED IN THE BIDDING DOCUMENTS.
   WATER MANAGEMENT IS THE SOLE RESPONSIBILITY OF THE PROPERTY


OWNER. THE LANDSCAPE ARCHITECT IS NOT RESPONSIBLE FOR ANY

- RESTRICTIONS OF IRRIGATION WATER USE BY ANY GOVERNING BODY.


  6. PER 5-6(C)(4)(a) A MINIMUM OF 5 SPECIES MUST BE USED IN THE LANDSCAPED AREA.
- 7. PER 5-6(C)(4)(b) ONLY TREES AND SHRUBS SELECTED FROM THE OFFICIAL ALBUQUERQUE PLANT PALETTE OF LOW WATER USE, DROUGHT TOLERANT, OR XERIC SPECIES AND SHOWN ON A LANDSCAPE PLAN CAN COUNT TOWARD THE REQUIREMENTS OF THIS SUBSECTION 14-16-5-6(C) (GENERAL LANDSCAPING STANDARDS), EXCEPT THAT, UPON PRESENTATION OF EVIDENCE, THE RELEVANT DECISION-MAKING BODY MAY AUTHORIZE ALTERNATIVE SPECIES OR CULTIVARS THAT MEET ALL OF THE FOLLOWING REQUIREMENTS:
- 1.MEET THE INTENDED PURPOSE OF THAT TYPE OF LANDSCAPING.
  2.ARE NOT HAZARDOUS.
- 3.ARE NOT IDENTIFIED AS INVASIVE ON A CITY OR STATE PLANT LIST.
  4.ARE NOT LISTED IN THE CITY'S WEED IDENTIFICATION HANDBOOK.
  5.ARE EQUALLY HARDY TO THE NEW MEXICO CLIMATE.
- 8. PER 5-3(D)(3)(a) 3, SHADE TREES ALONG REQUIRED PEDESTRIAN WALKWAYS ARE REQUIRED PURSUANT TO SUBSECTION 14-16-5-6(C)(4)(i) (REQUIRED PLANT MATERIALS AND SITE AMENITIES). 5-6(C)(4)(i) SHADE TREES PLANTED APPROXIMATELY 25 FEET ON-CENTER ARE REQUIRED ALONG ALL REQUIRED PEDESTRIAN WALKWAYS. IF THE WALKWAY IS LESS THAN FEET LONG, AT LEAST ONE TREE IS REQUIRED, OR, WHERE THERE IS INSUFFICIENT SPACE FOR A TREE, A TRELLIS OF AT LEAST 8 FEET HIGH FOR AT LEAST 5 FEET ALONG THE WALKWAY SHALL BE PROVIDED.
- 9. PER 5-6(F)(1)(i) 1 OF THE IDO, ANY PARKING LOT LOCATED WITHIN 30 FEET OF THE FRONT LOT LINE SHALL BE SCREENED FROM THE STREET EITHER BY A MASONRY WALL CONSTRUCTED OF A MATERIAL SIMILAR IN TEXTURE, APPEARANCE, AND COLOR TO THE STREET-FACING FAÇADE OF THE PRIMARY BUILDING (BUT EXCLUDING EXPOSED CMU BLOCK) AT LEAST 3 BUT NOT MORE THAN 4 FEET IN HEIGHT, OR BY A LANDSCAPE BUFFER AT LEAST 10 FEET IN WIDTH WITH A CONTINUOUS LINE OF EVERGREEN SHRUBBERY 3 FEET IN HEIGHT, OR BY OTHER MEANS THAT THE PLANNING DIRECTOR DETERMINES PROVIDES EQUAL OR BETTER SCREENING OF THE
- HEADLIGHTS OF PARKED VEHICLES.

  10. PER 5-6(C)(9)(a), ALL PLANTING OF VEGETATED MATERIAL OR INSTALLATION OF ANY LANDSCAPING, BUFFERING, OR SCREENING MATERIAL IN THE PUBLIC RIGHT-OF-WAY SHALL REQUIRE THE PRIOR APPROVAL OF THE CITY. THE PROPERTY OWNER SHALL BE RESPONSIBLE FOR THE MAINTENANCE, REPAIRS, OR LIABILITY FOR ALL THE LANDSCAPING PLACED IN OR OVER
- THE PUBLIC RIGHT-OF-WAY.

  11. PER 5-6(C)(9)(b), ANY TREES THAT OVERHANG A PUBLIC SIDEWALK OR MAJOR PUBLIC OPEN SPACE SHALL BE TRIMMED TO MAINTAIN AN 8 FOOT CLEARANCE OVER THE SIDEWALK. ANY TREES THAT OVERHANG A PUBLIC STREET SHALL BE TRIMMED TO MAINTAIN A 9' CLEARANCE OVER THE
- 12. PURSUANT TO 5-6(C)(5)(e), BARK MULCH AREAS CLEARLY DELINEATED ON PLANS FOR LANDSCAPE AREAS AND 5' RADIUS RINGS AROUND TREES.
- 13. PURSUANT TO 5-6(C)(7)(a), ALL VEGETATION HAS BEEN LOCATED A MINIMUM OF 3' IN ANY DIRECTION FROM FIRE HYDRANTS, VALVE VAULTS, HOSE BIBS, MANHOLES, HYDRANTS AND FIRE DEPARTMENT CONNECTIONS.
- 14. PURSUANT TO 5-6(C)(10)(a), TREES AND SHRUBS SHALL NOT BE PLANTED IN UTILITY EASEMENTS UNLESS THERE IS NO OTHER PRACTICABLE LOCATION ON THE LOT WHERE THE LANDSCAPING WOULD ACHIEVE ITS INTENDED PURPOSE.
- 15. PURSUANT TO 5-6(C)(10)(b), TREES SHALL NOT BE PLANTED WITHIN 10' IN ANY DIRECTION OF THE CENTERLINE OF A SEWER OR WATER LINE.
- 16. CLEAR SIGHT TRIANGLE NOTE: LANDSCAPING, SIGNAGE, WALLS, FENCES, TREES, AND SHRUBBERIES BETWEEN 3' AND 8' TALL ( AS MEASURED FROM THE GUTTER PAN) ARE NOT ALLOWED WITHIN THE CLEAR SIGHT TRIANGLE.

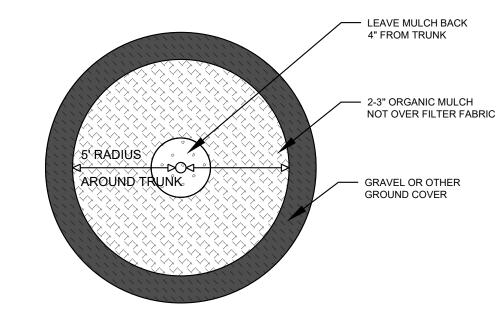

TREE DETAIL

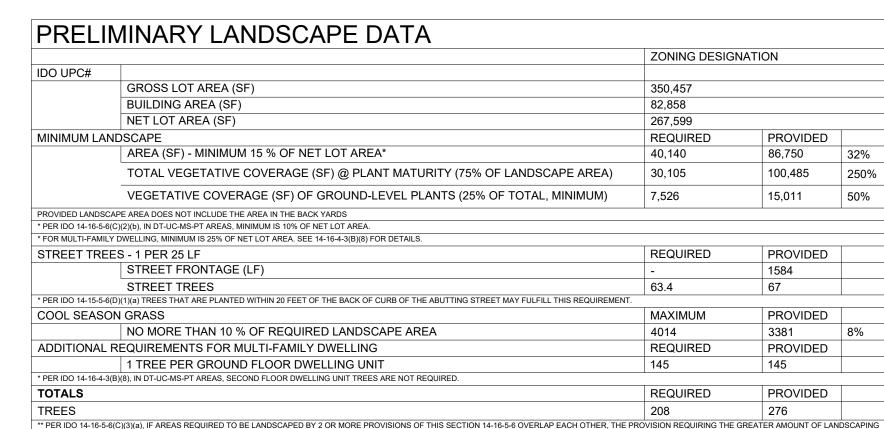



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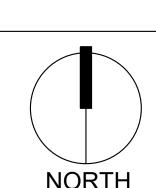
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> BTR Rio Rancho Housing Development


New Mexico

Rancho,

Rio



Scale: 1" = 30'

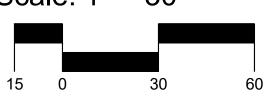



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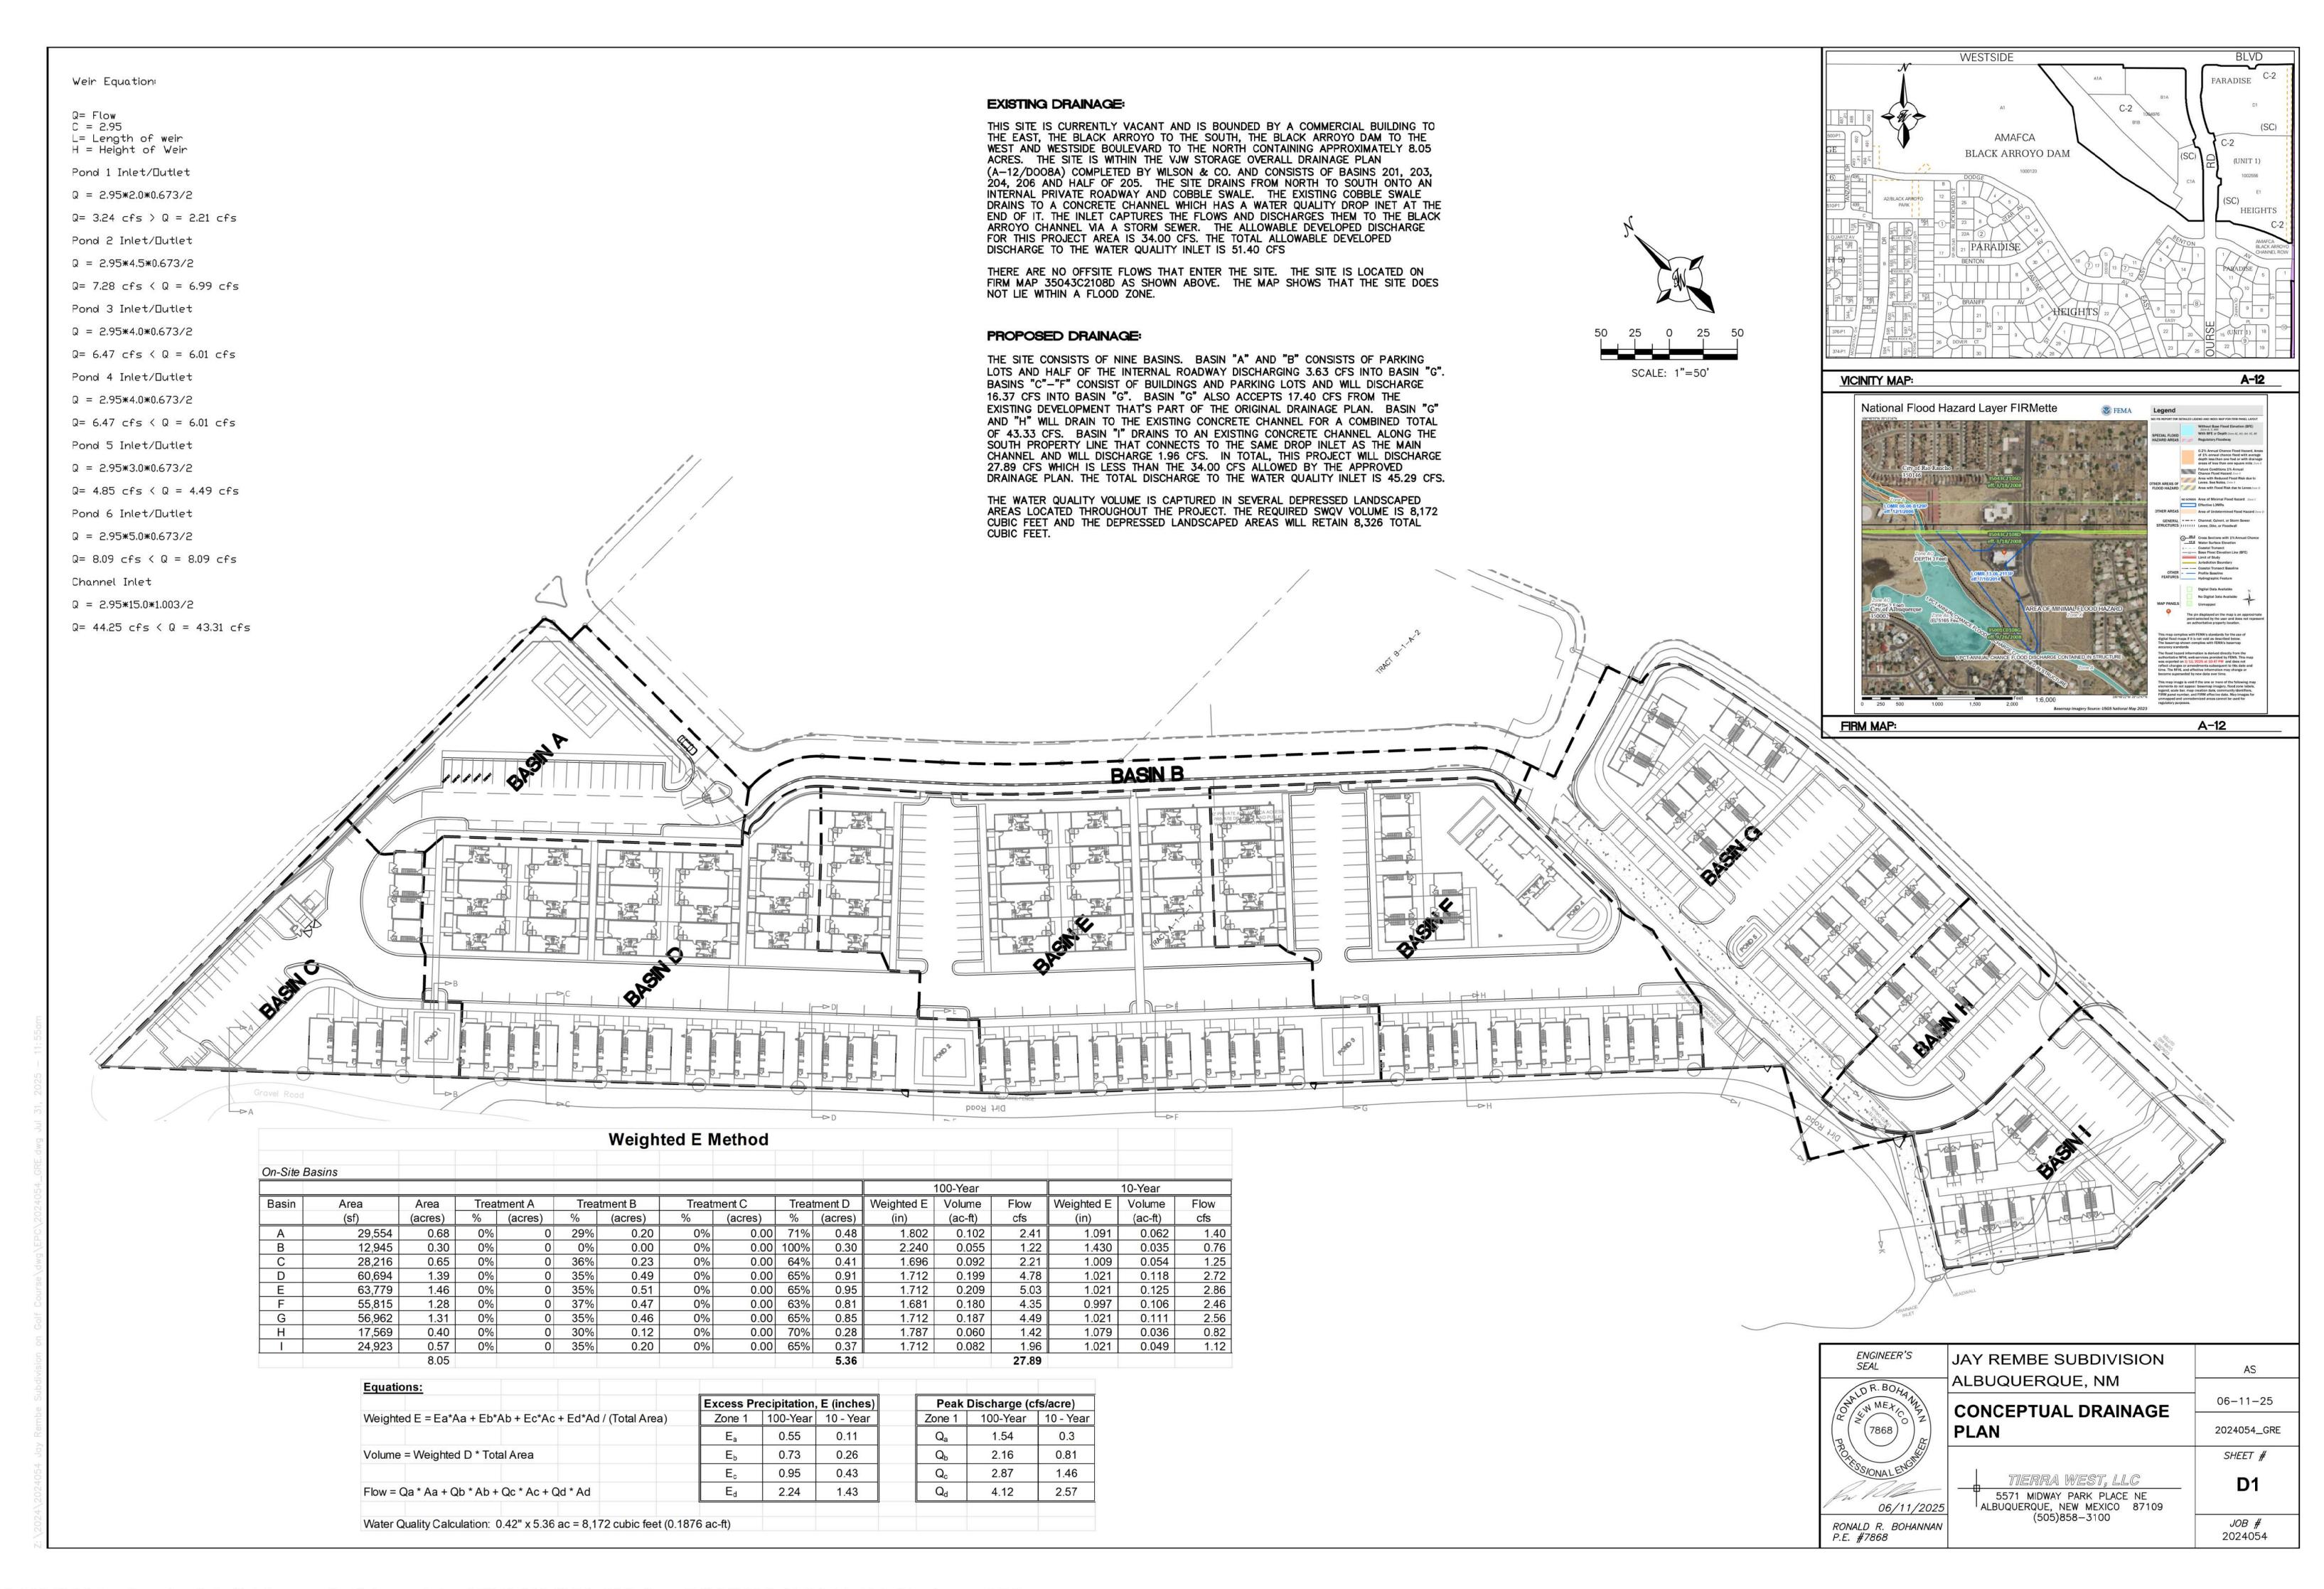
Landscape
Plan


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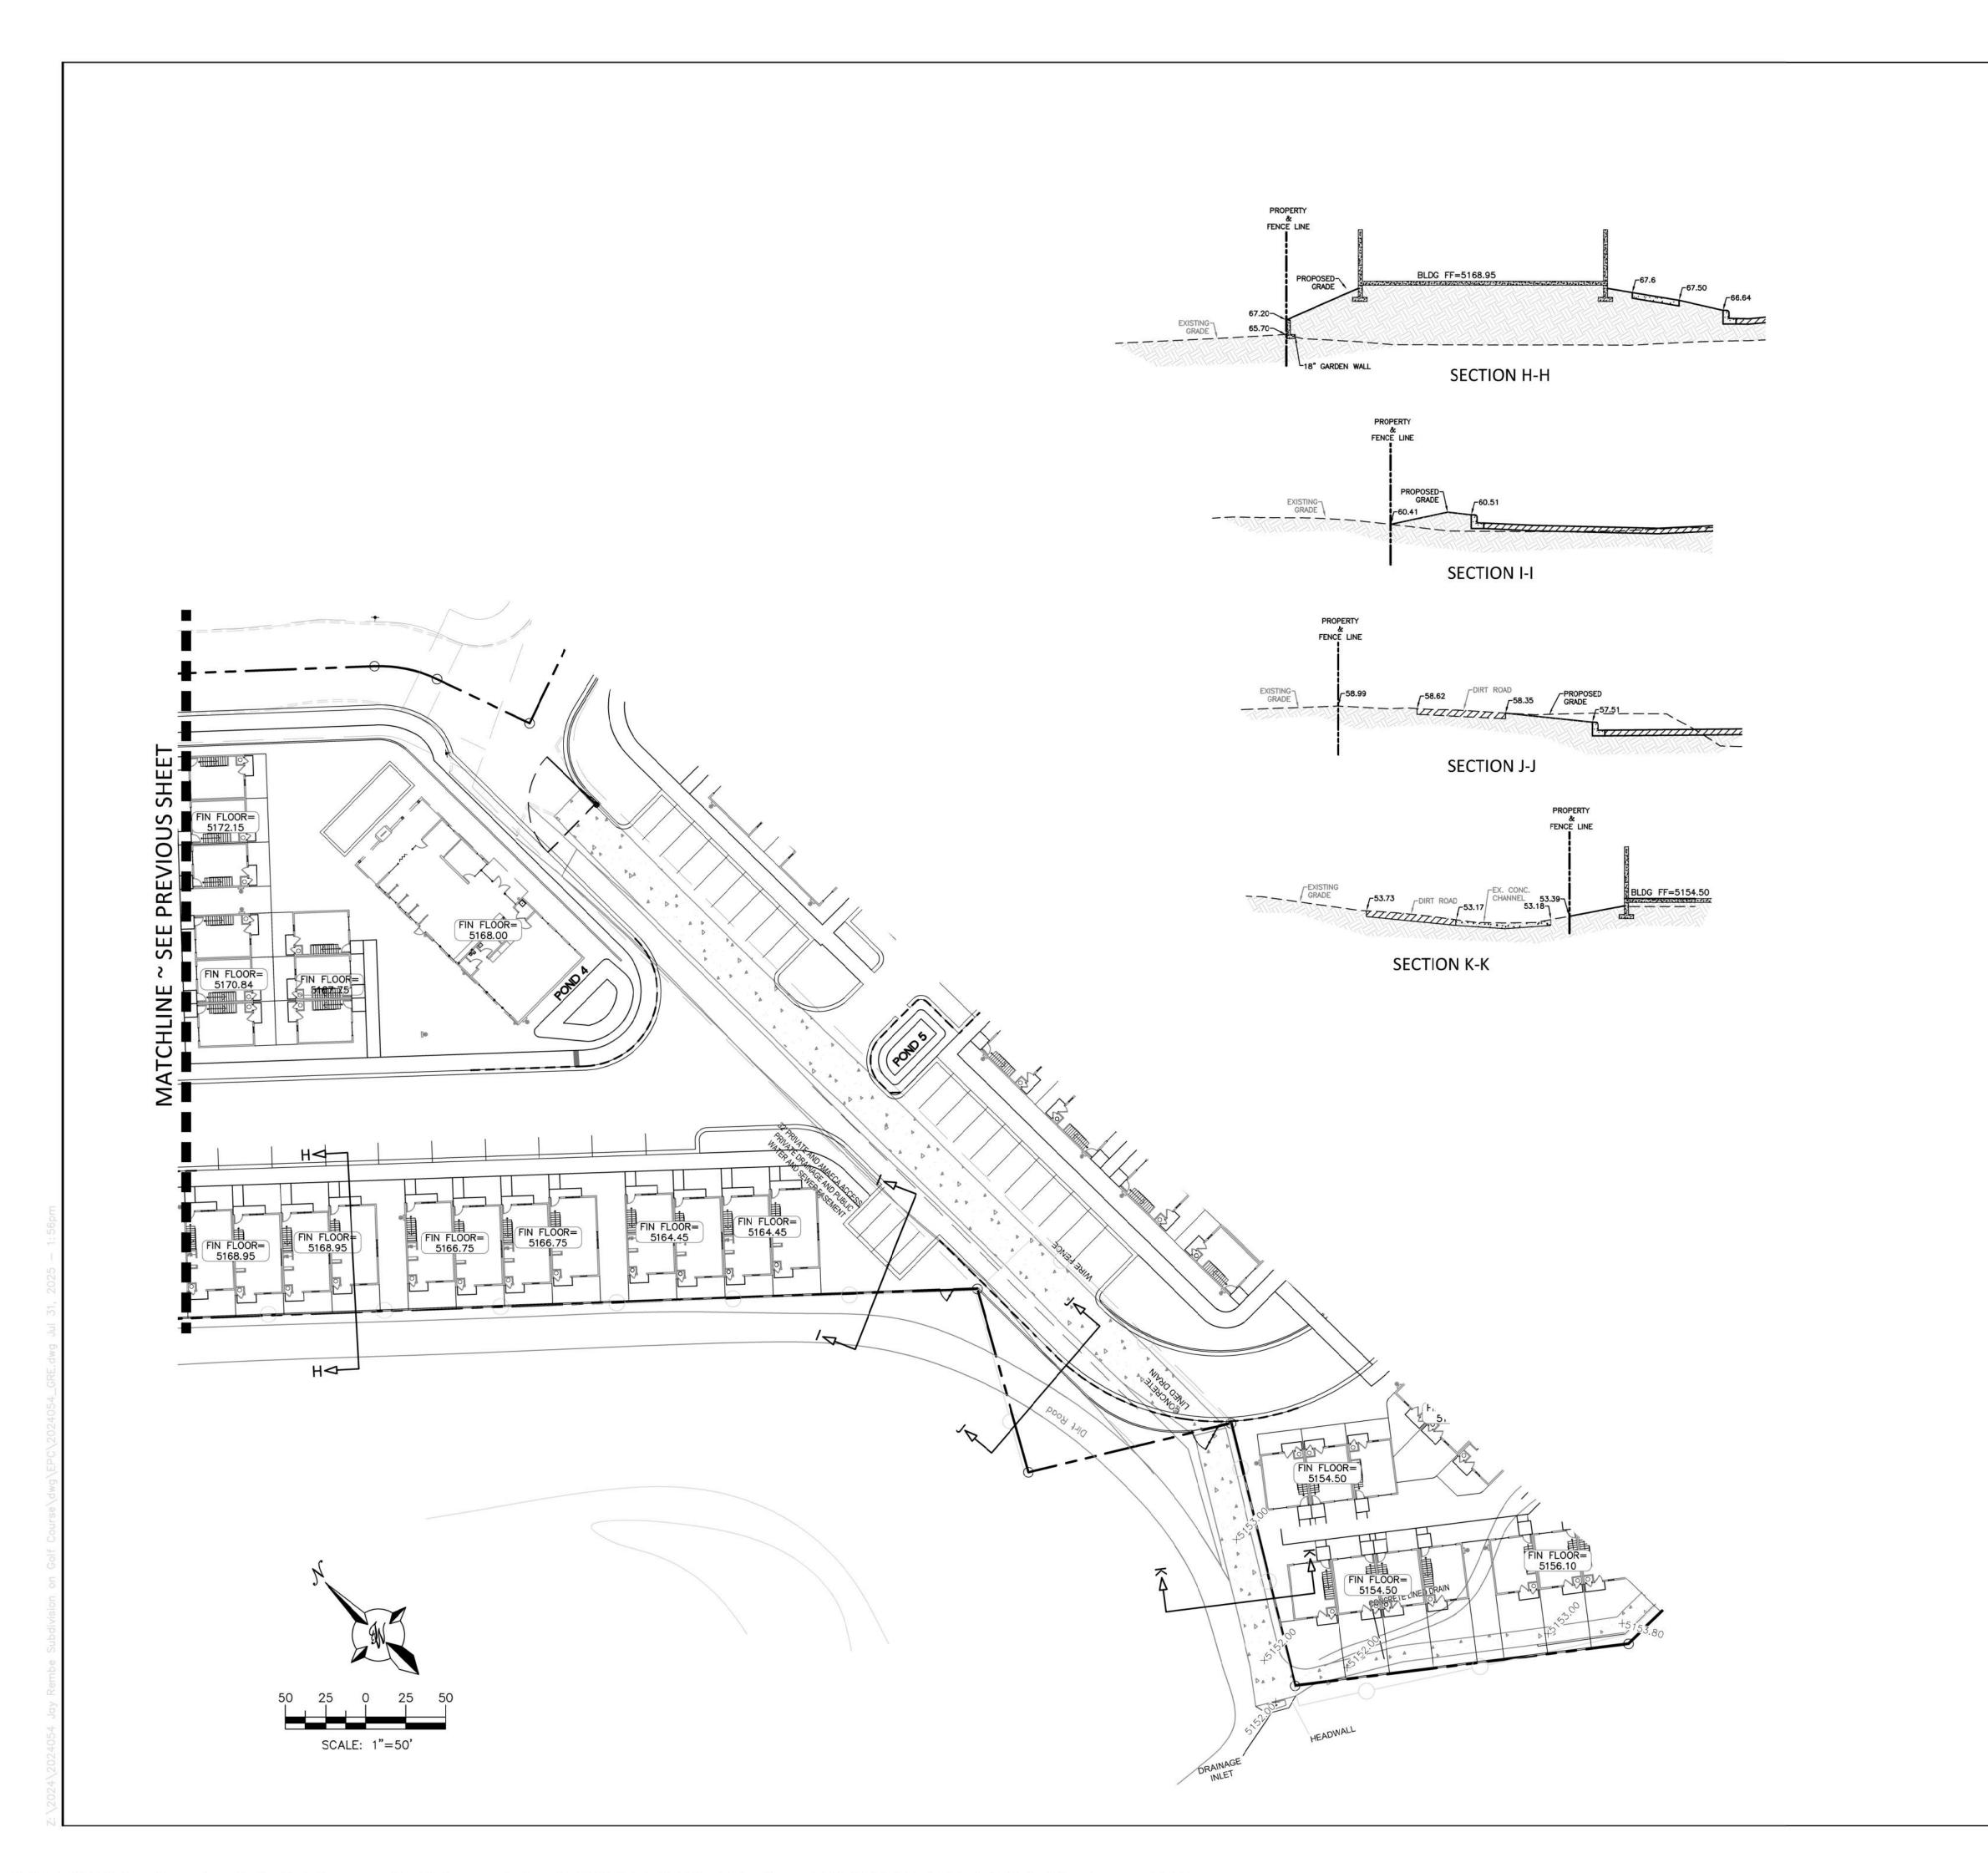
LS-02






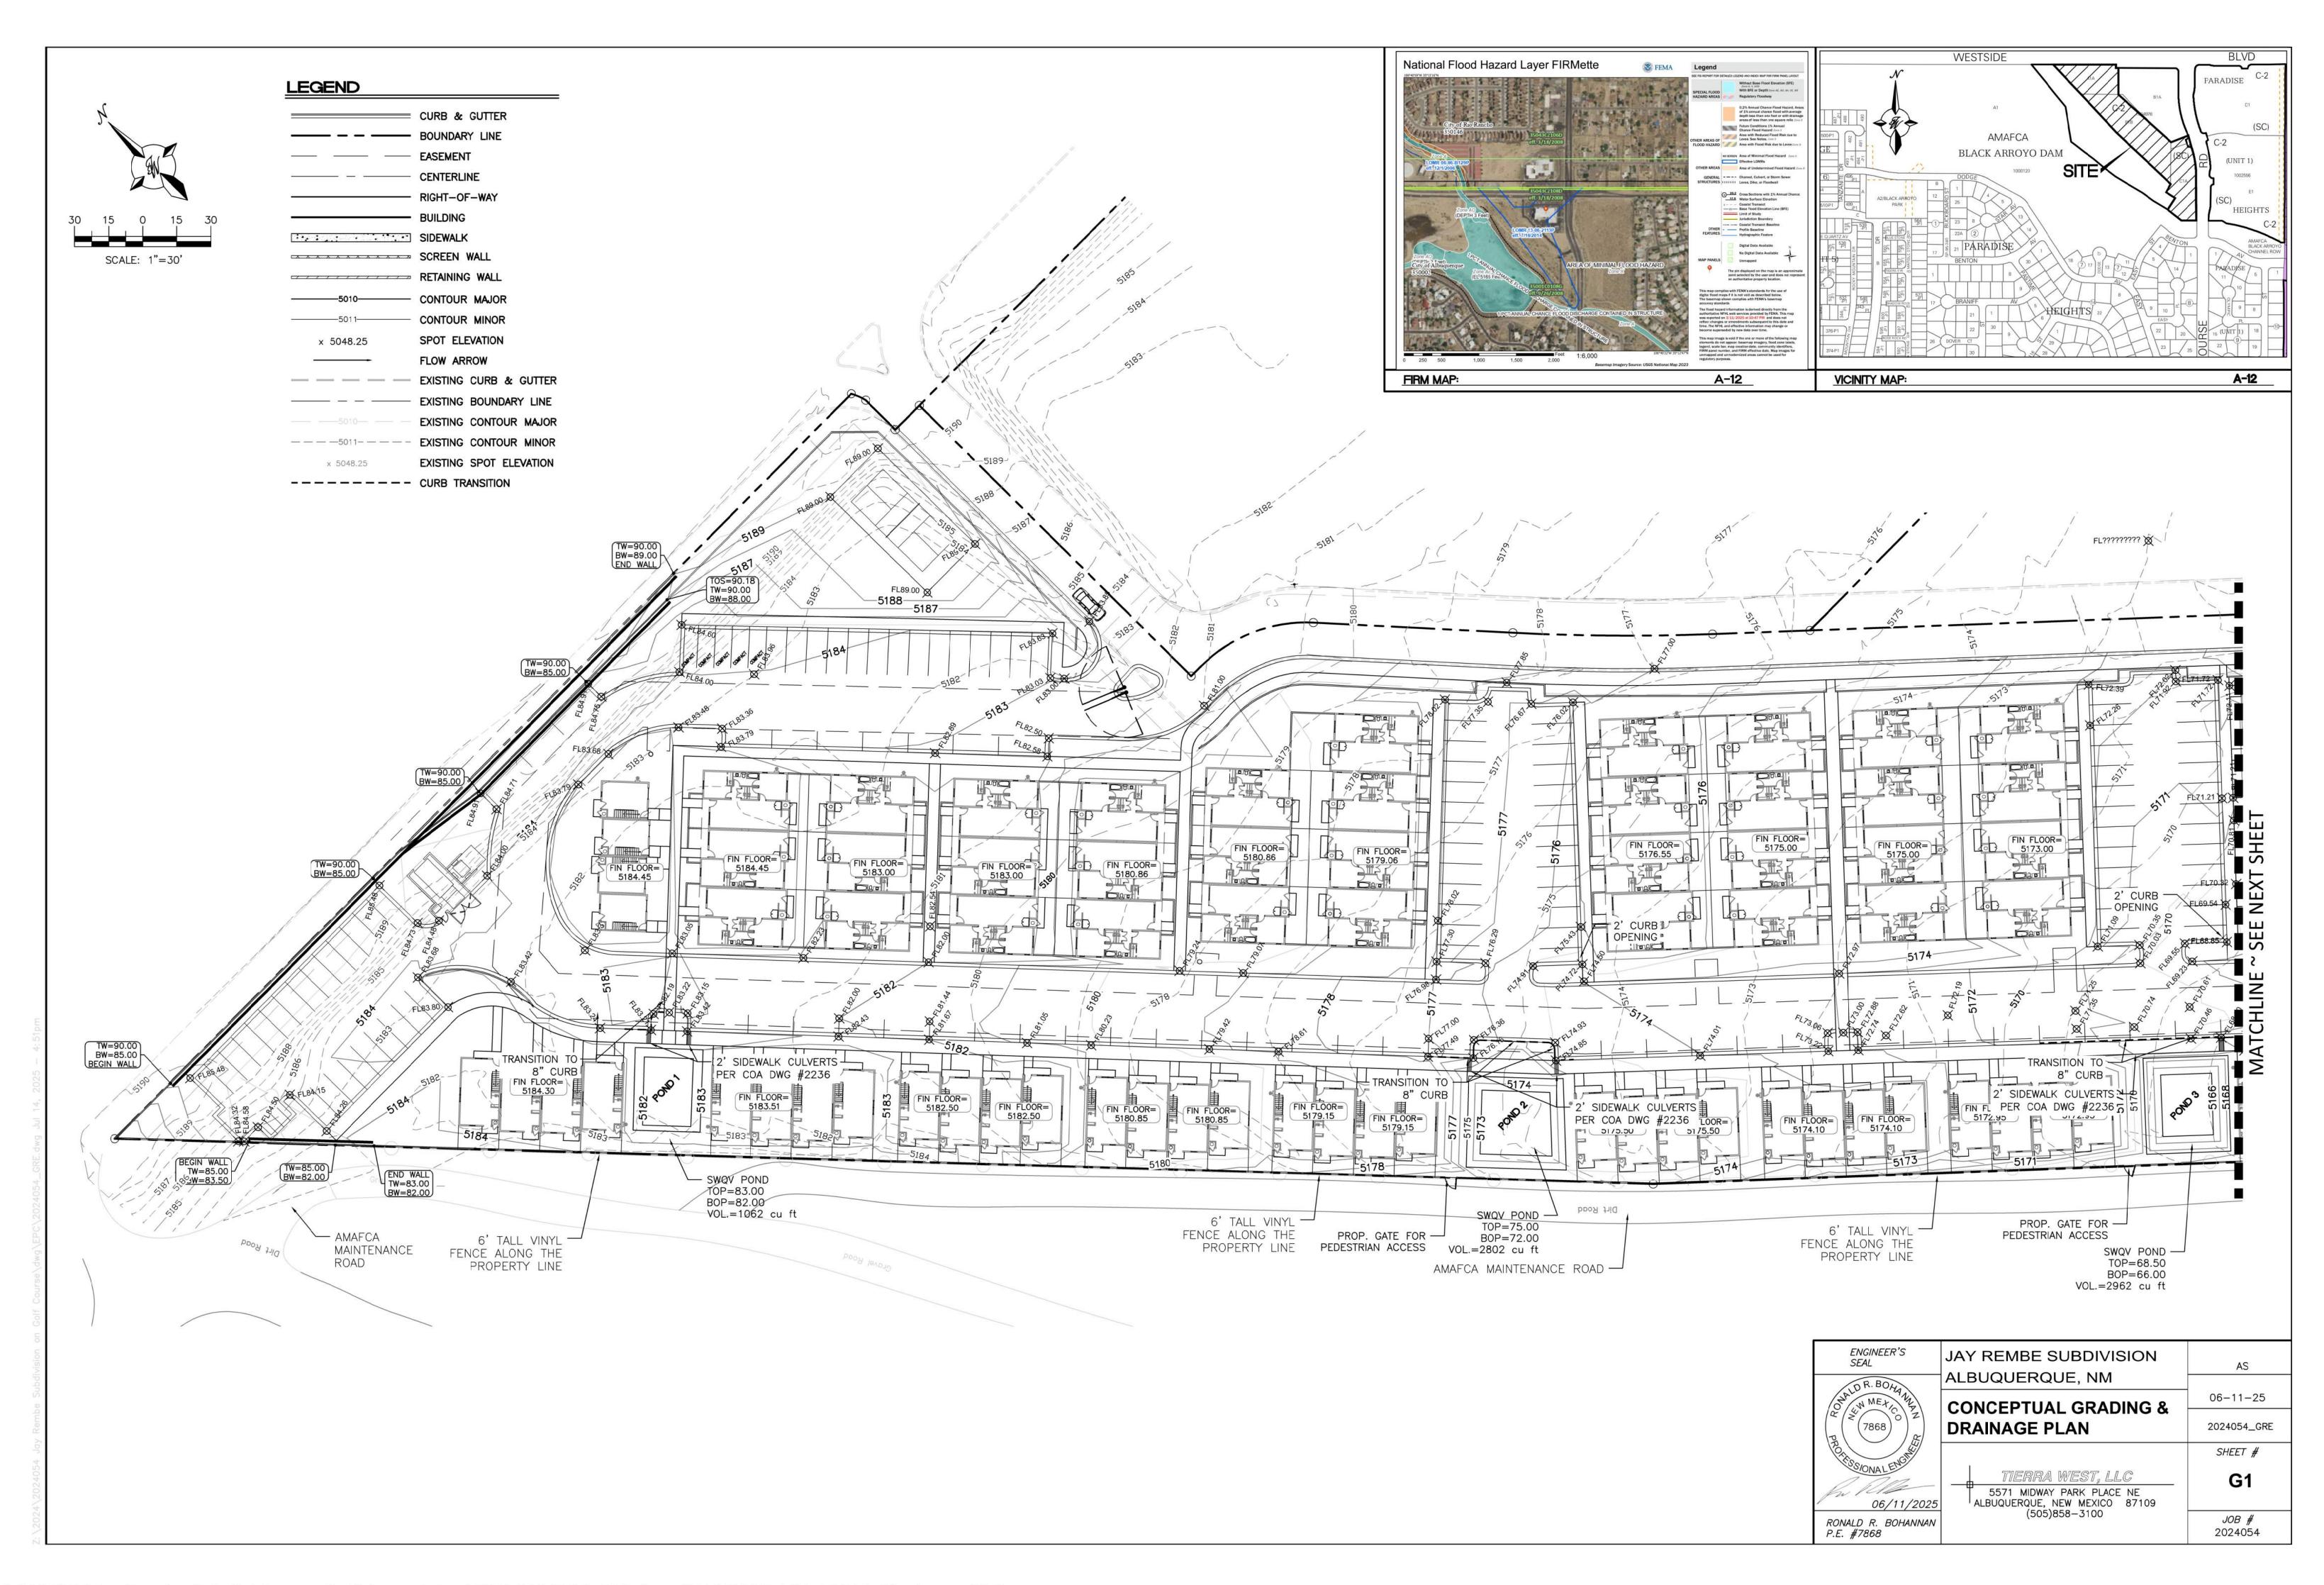


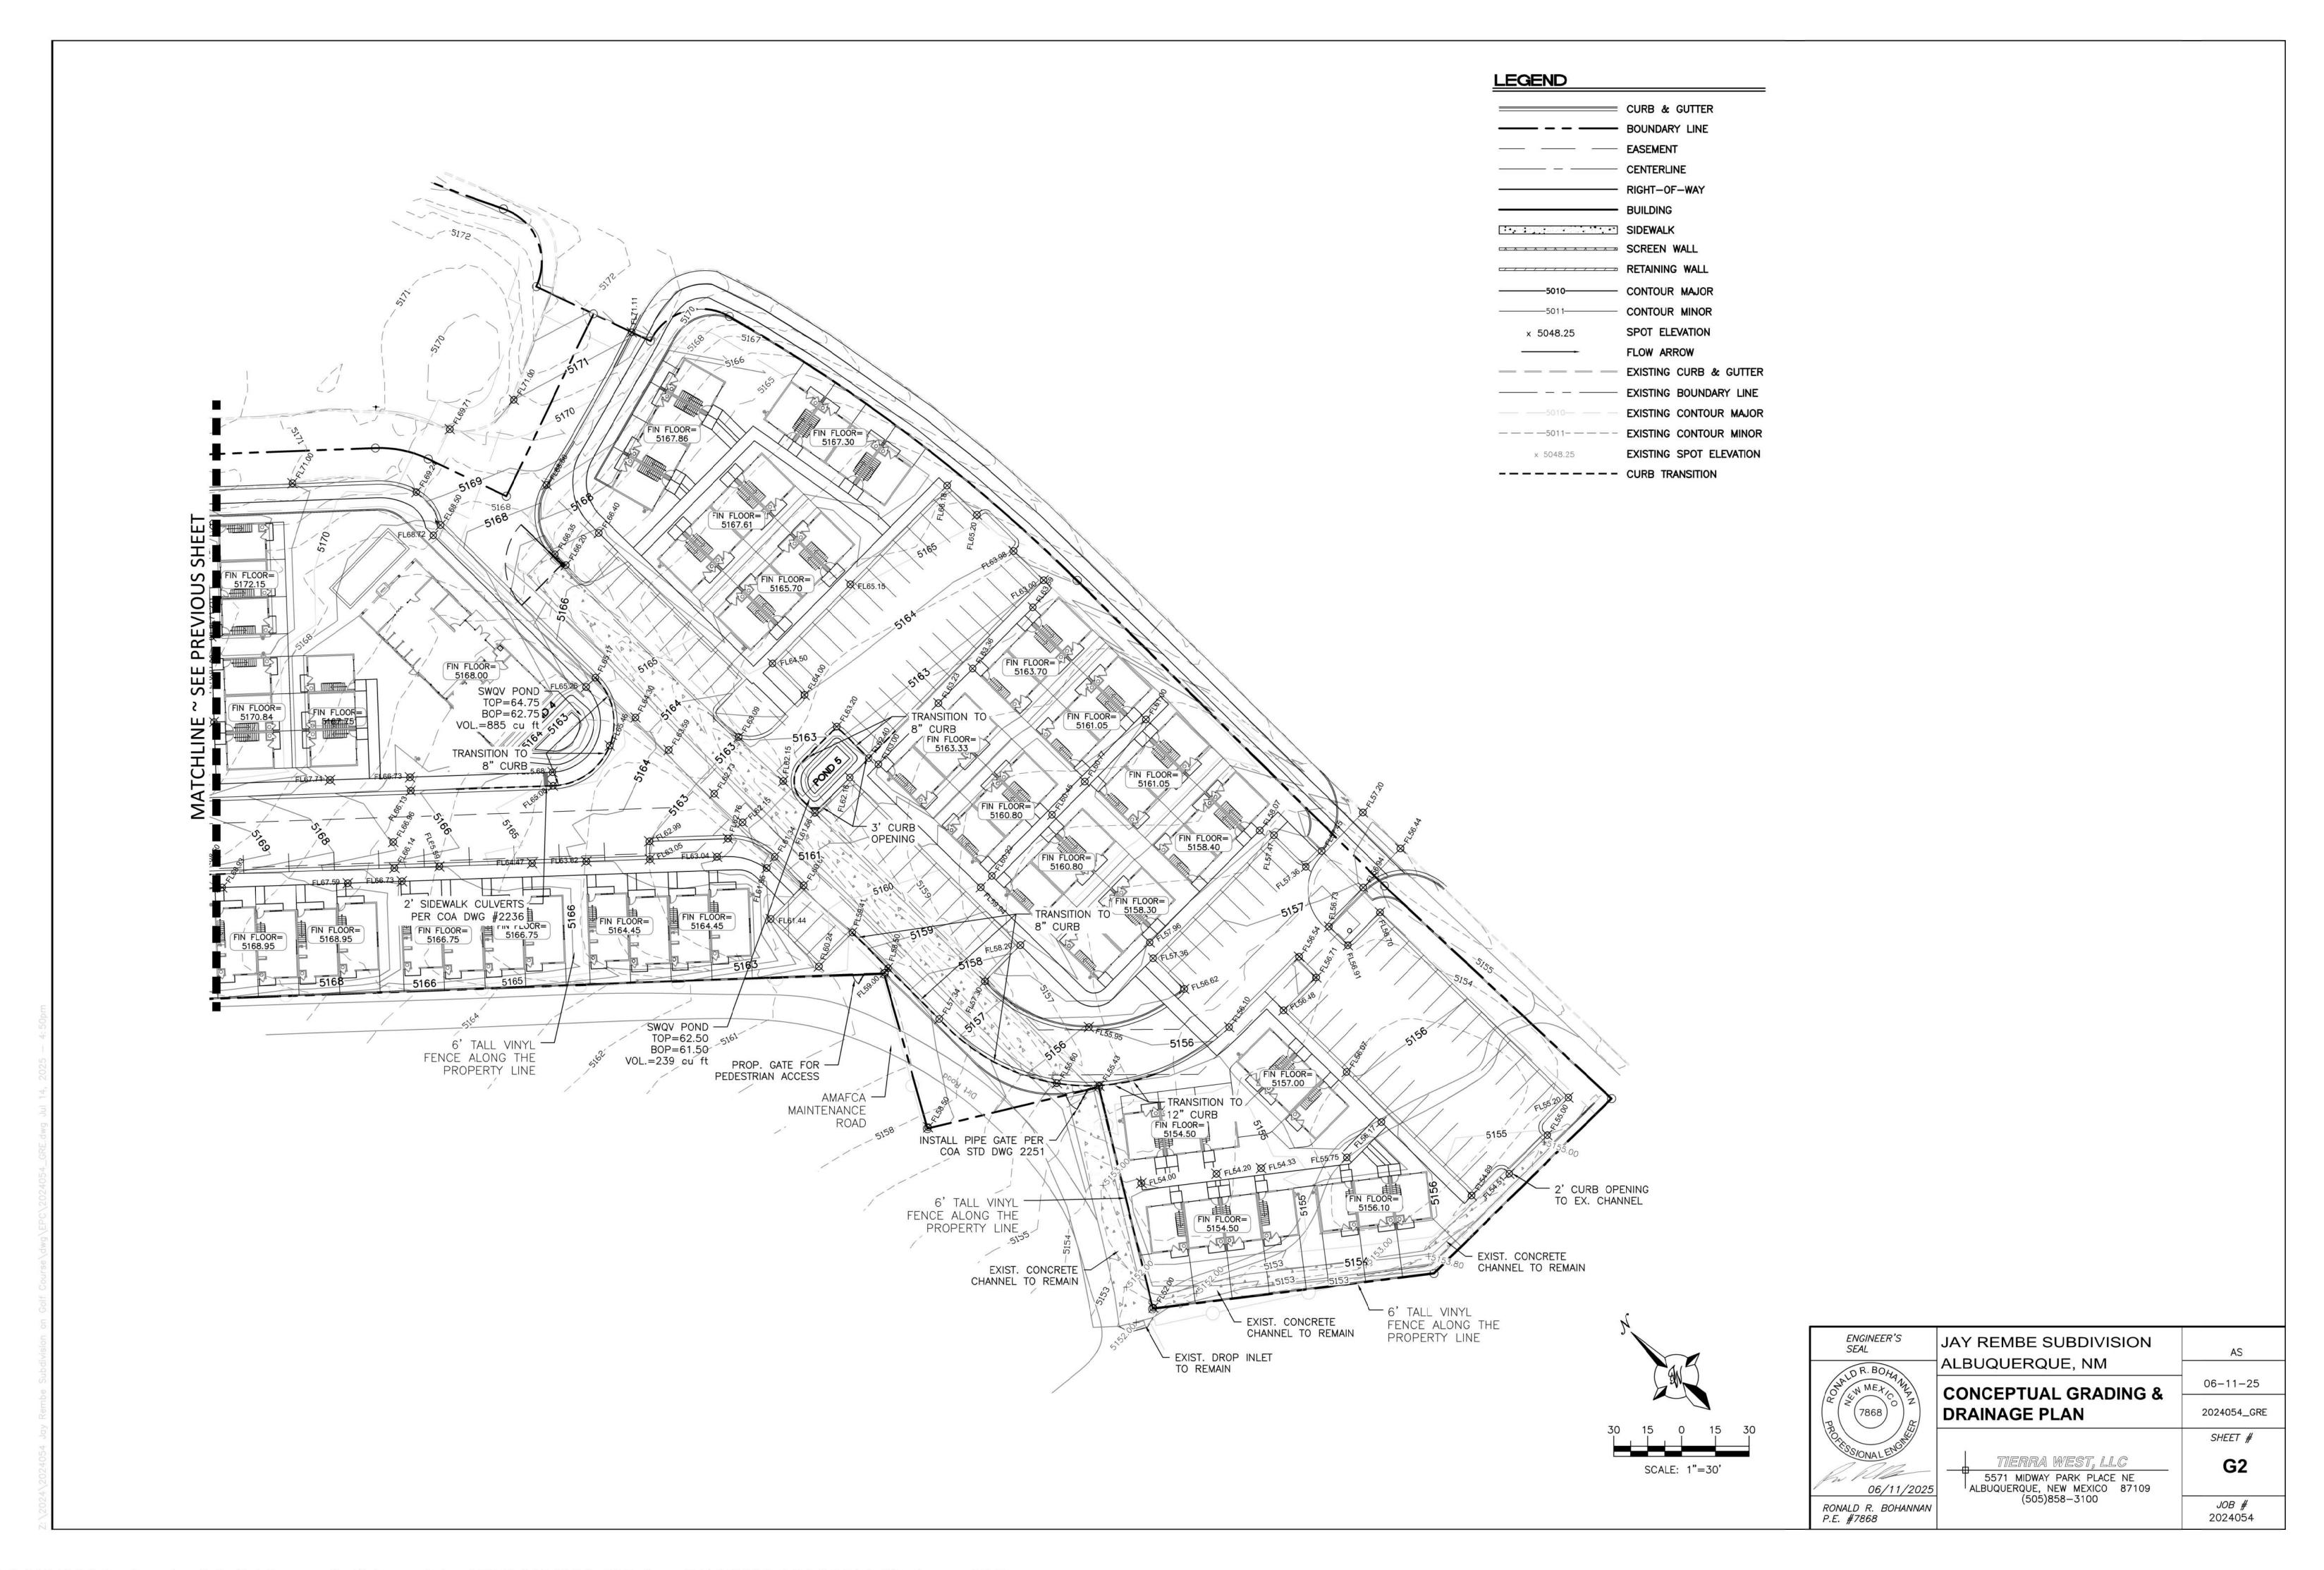


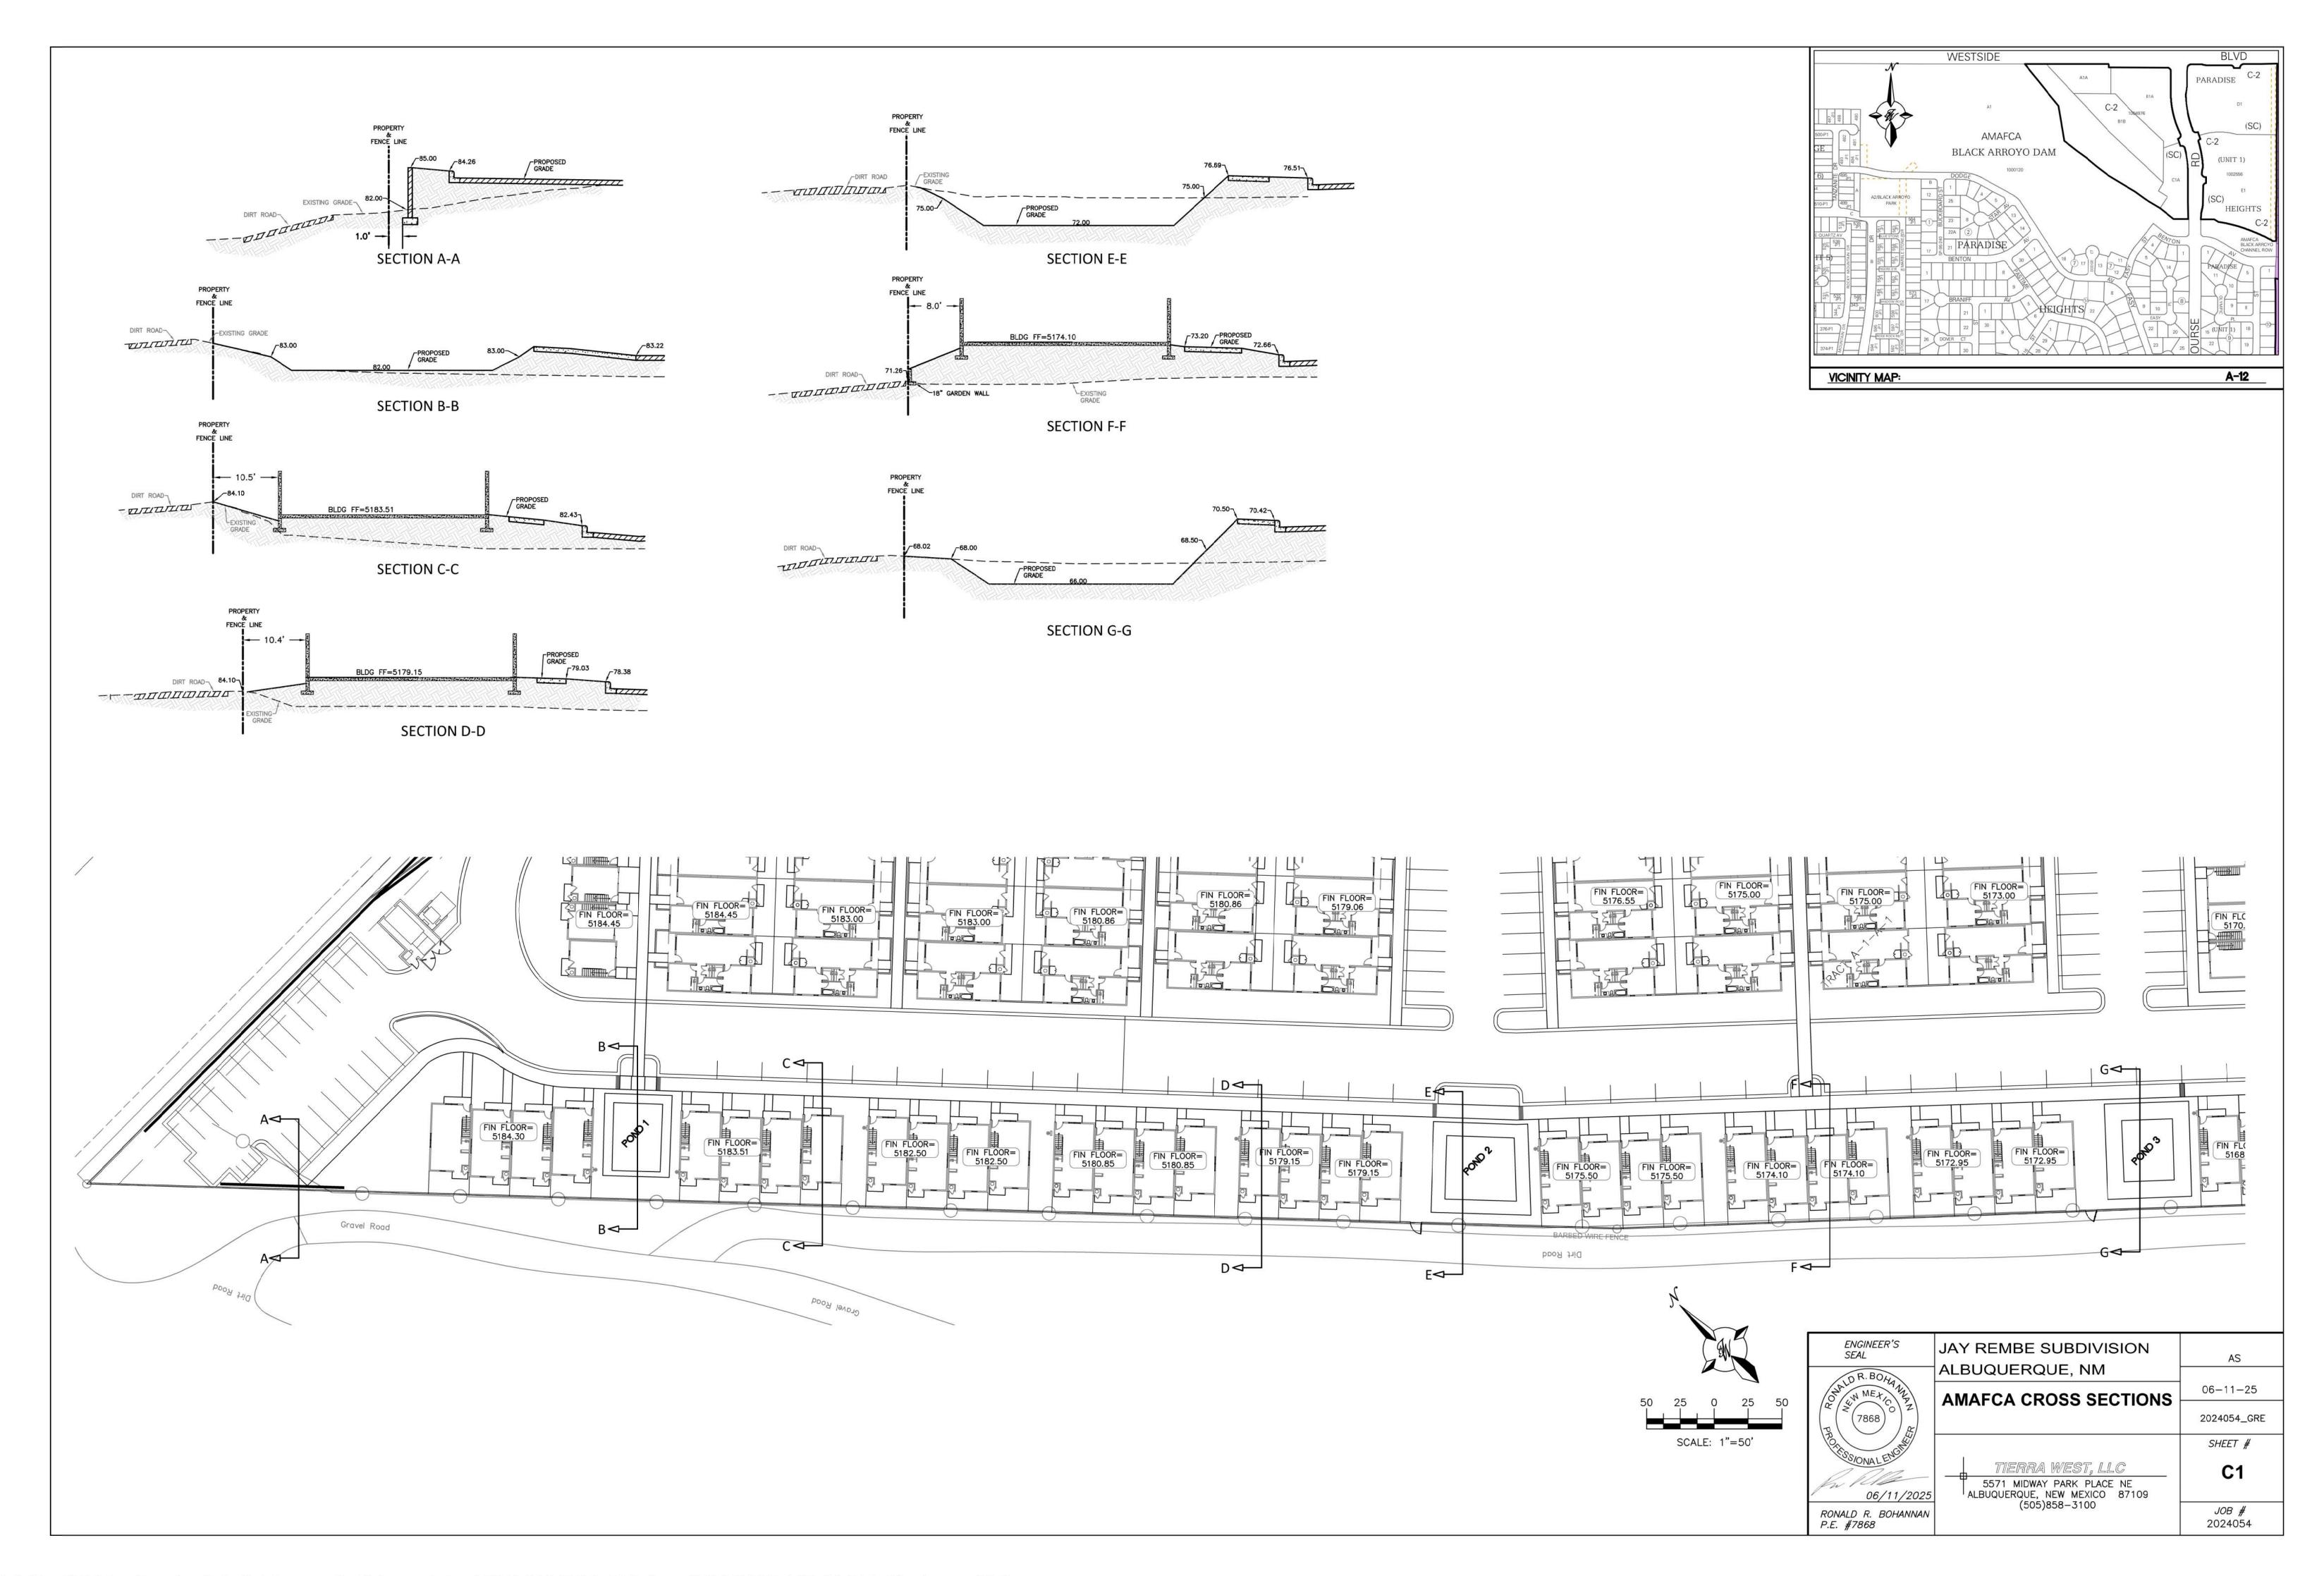


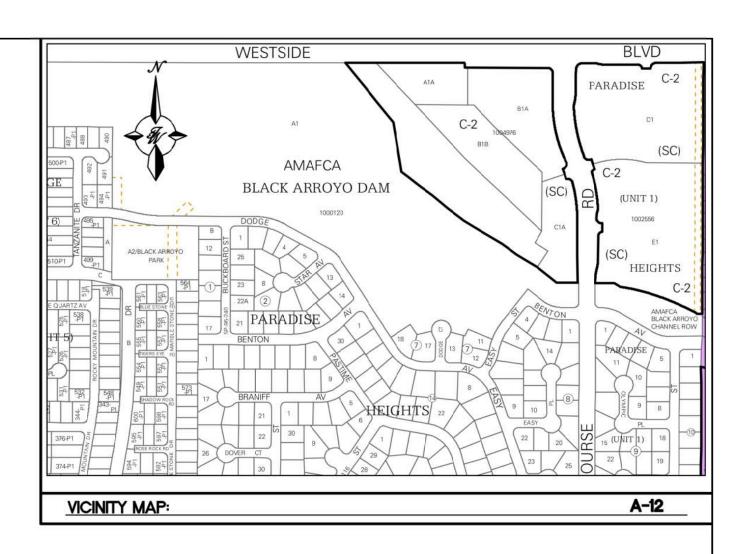

ENGINEER'S SEAL	JAY REMBE SUBDIVISION ALBUQUERQUE, NM	AS
OTALO R. BOHAN	AMAFCA CROSS SECTIONS	06-11-25
( (7868 ) )		2024054_GRE
PROTESSIONAL ENGINE	6	SHEET #
O6/11/2025	5571 MIDWAY PARK PLACE NE ALBUQUERQUE, NEW MEXICO 87109	C2
RONALD R. BOHANNAN P.E. #7868	(505)858-3100	<i>JOB #</i> 2024054

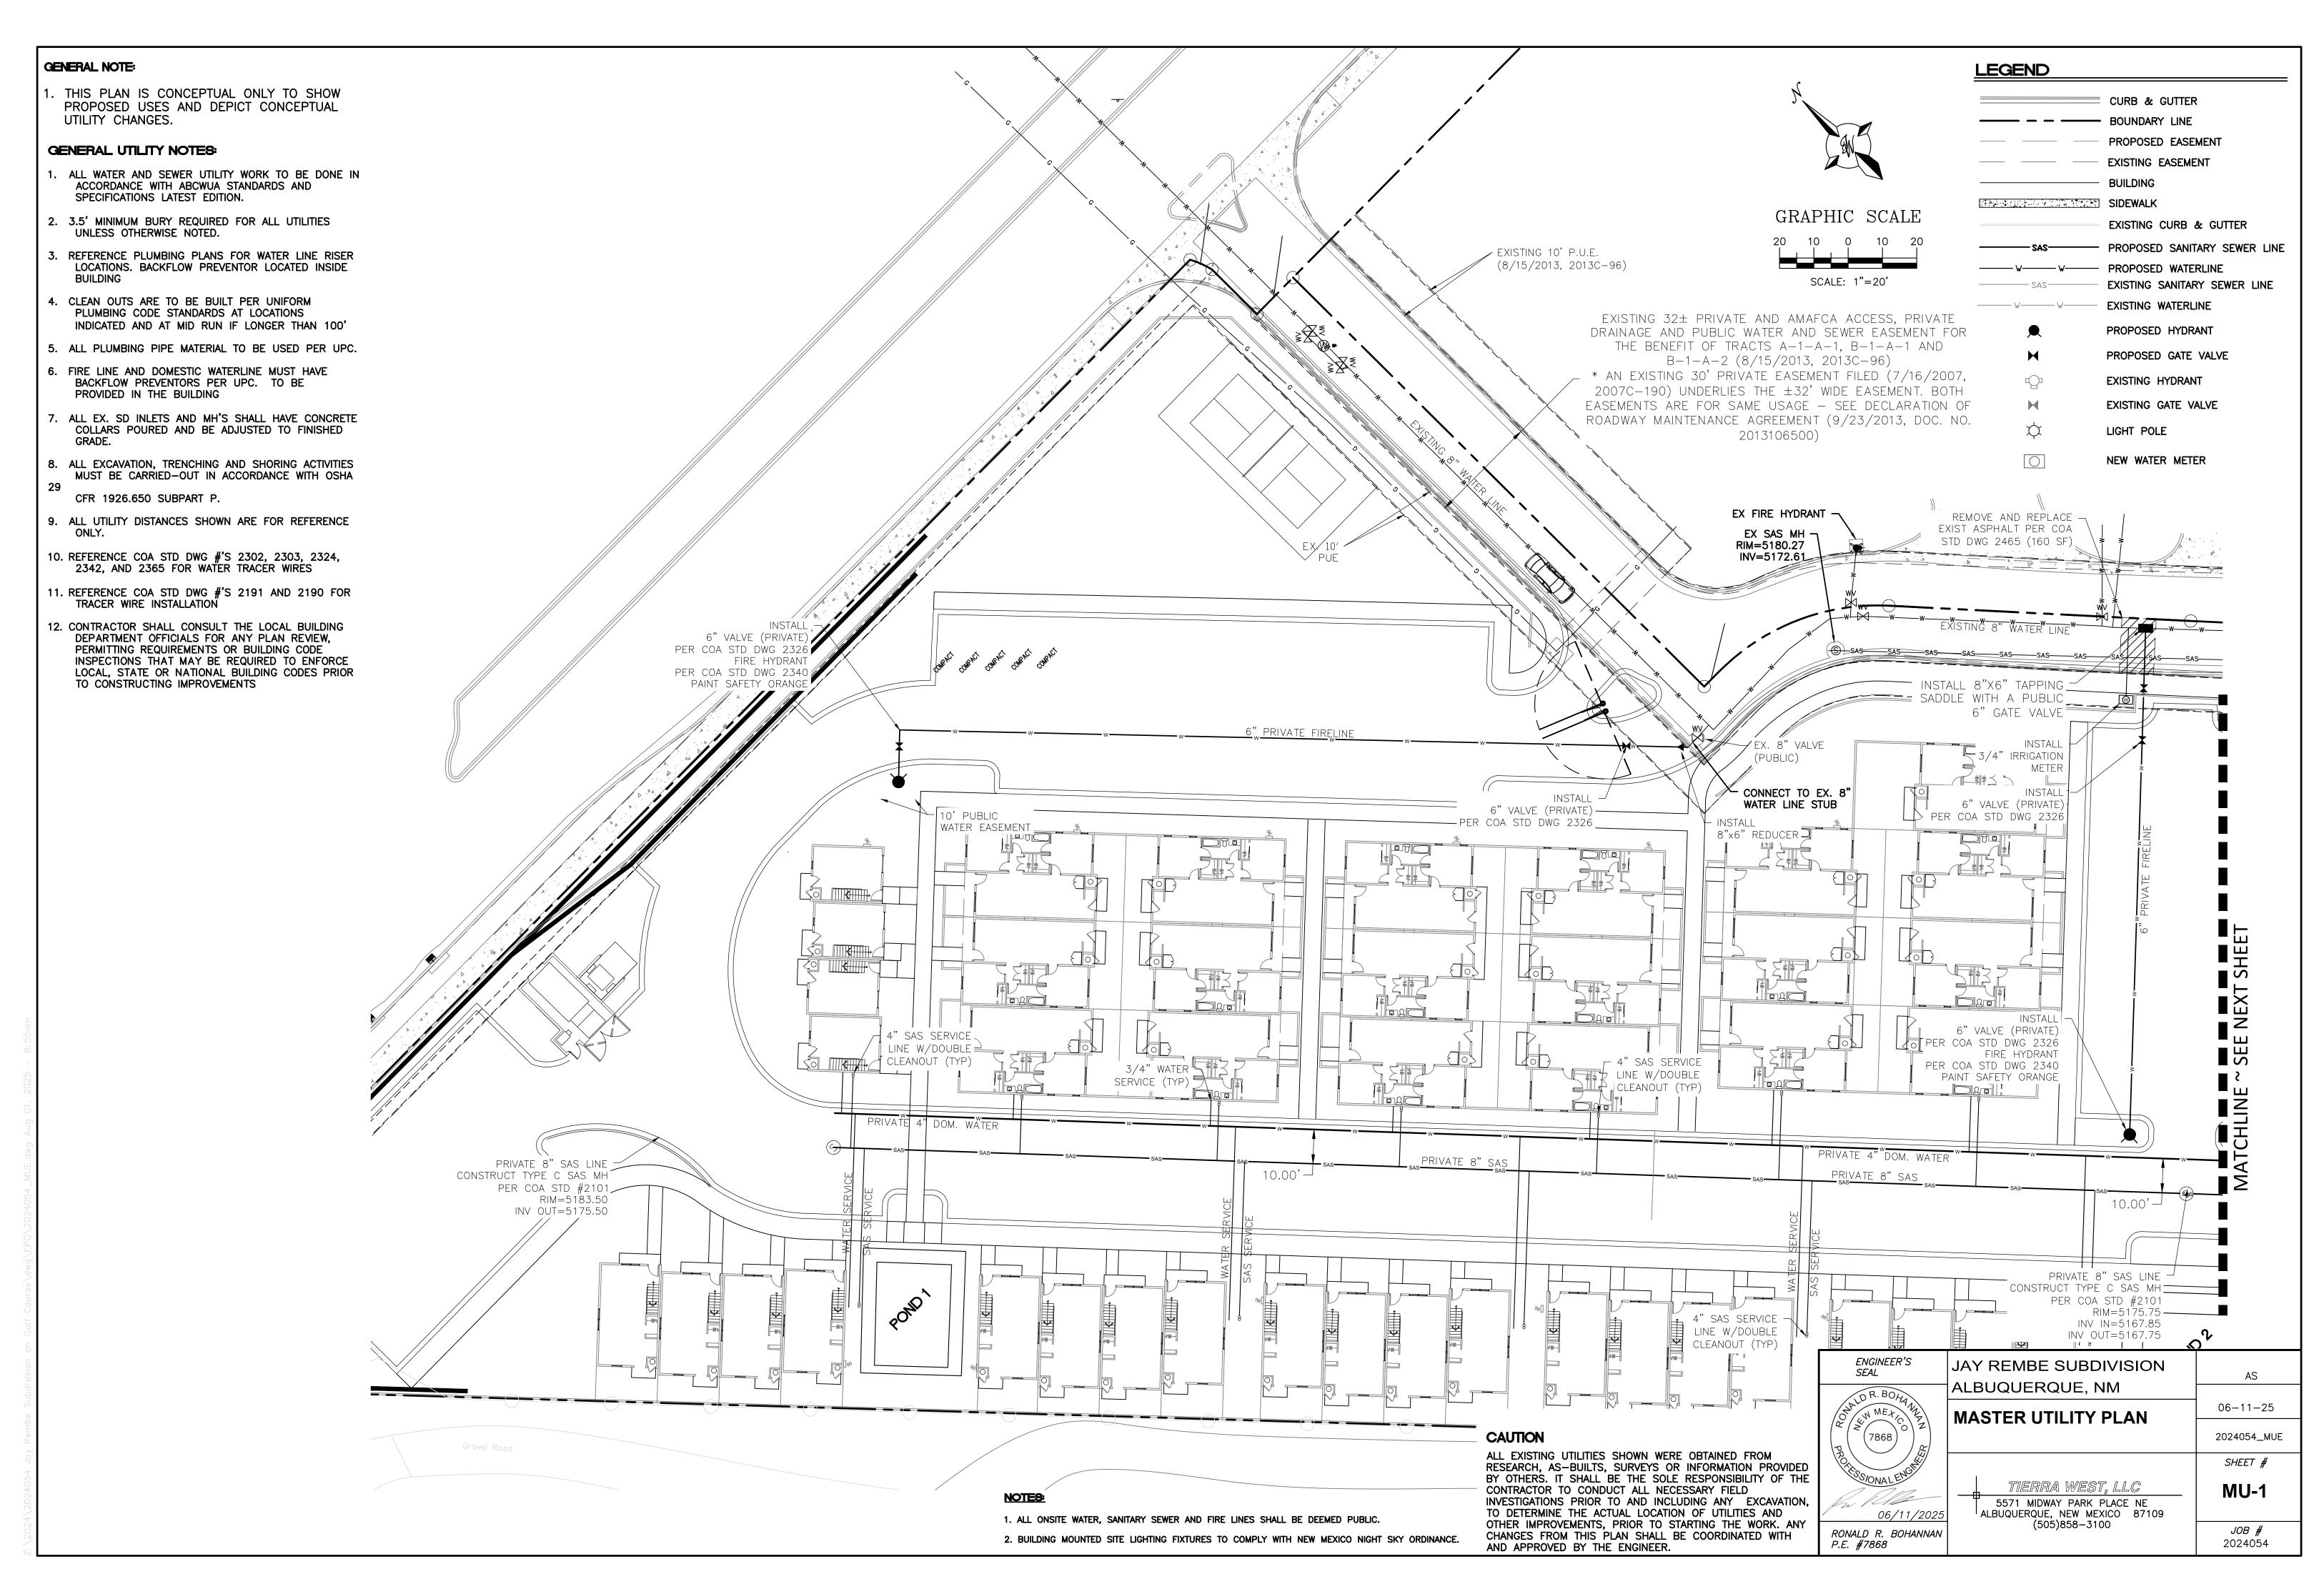

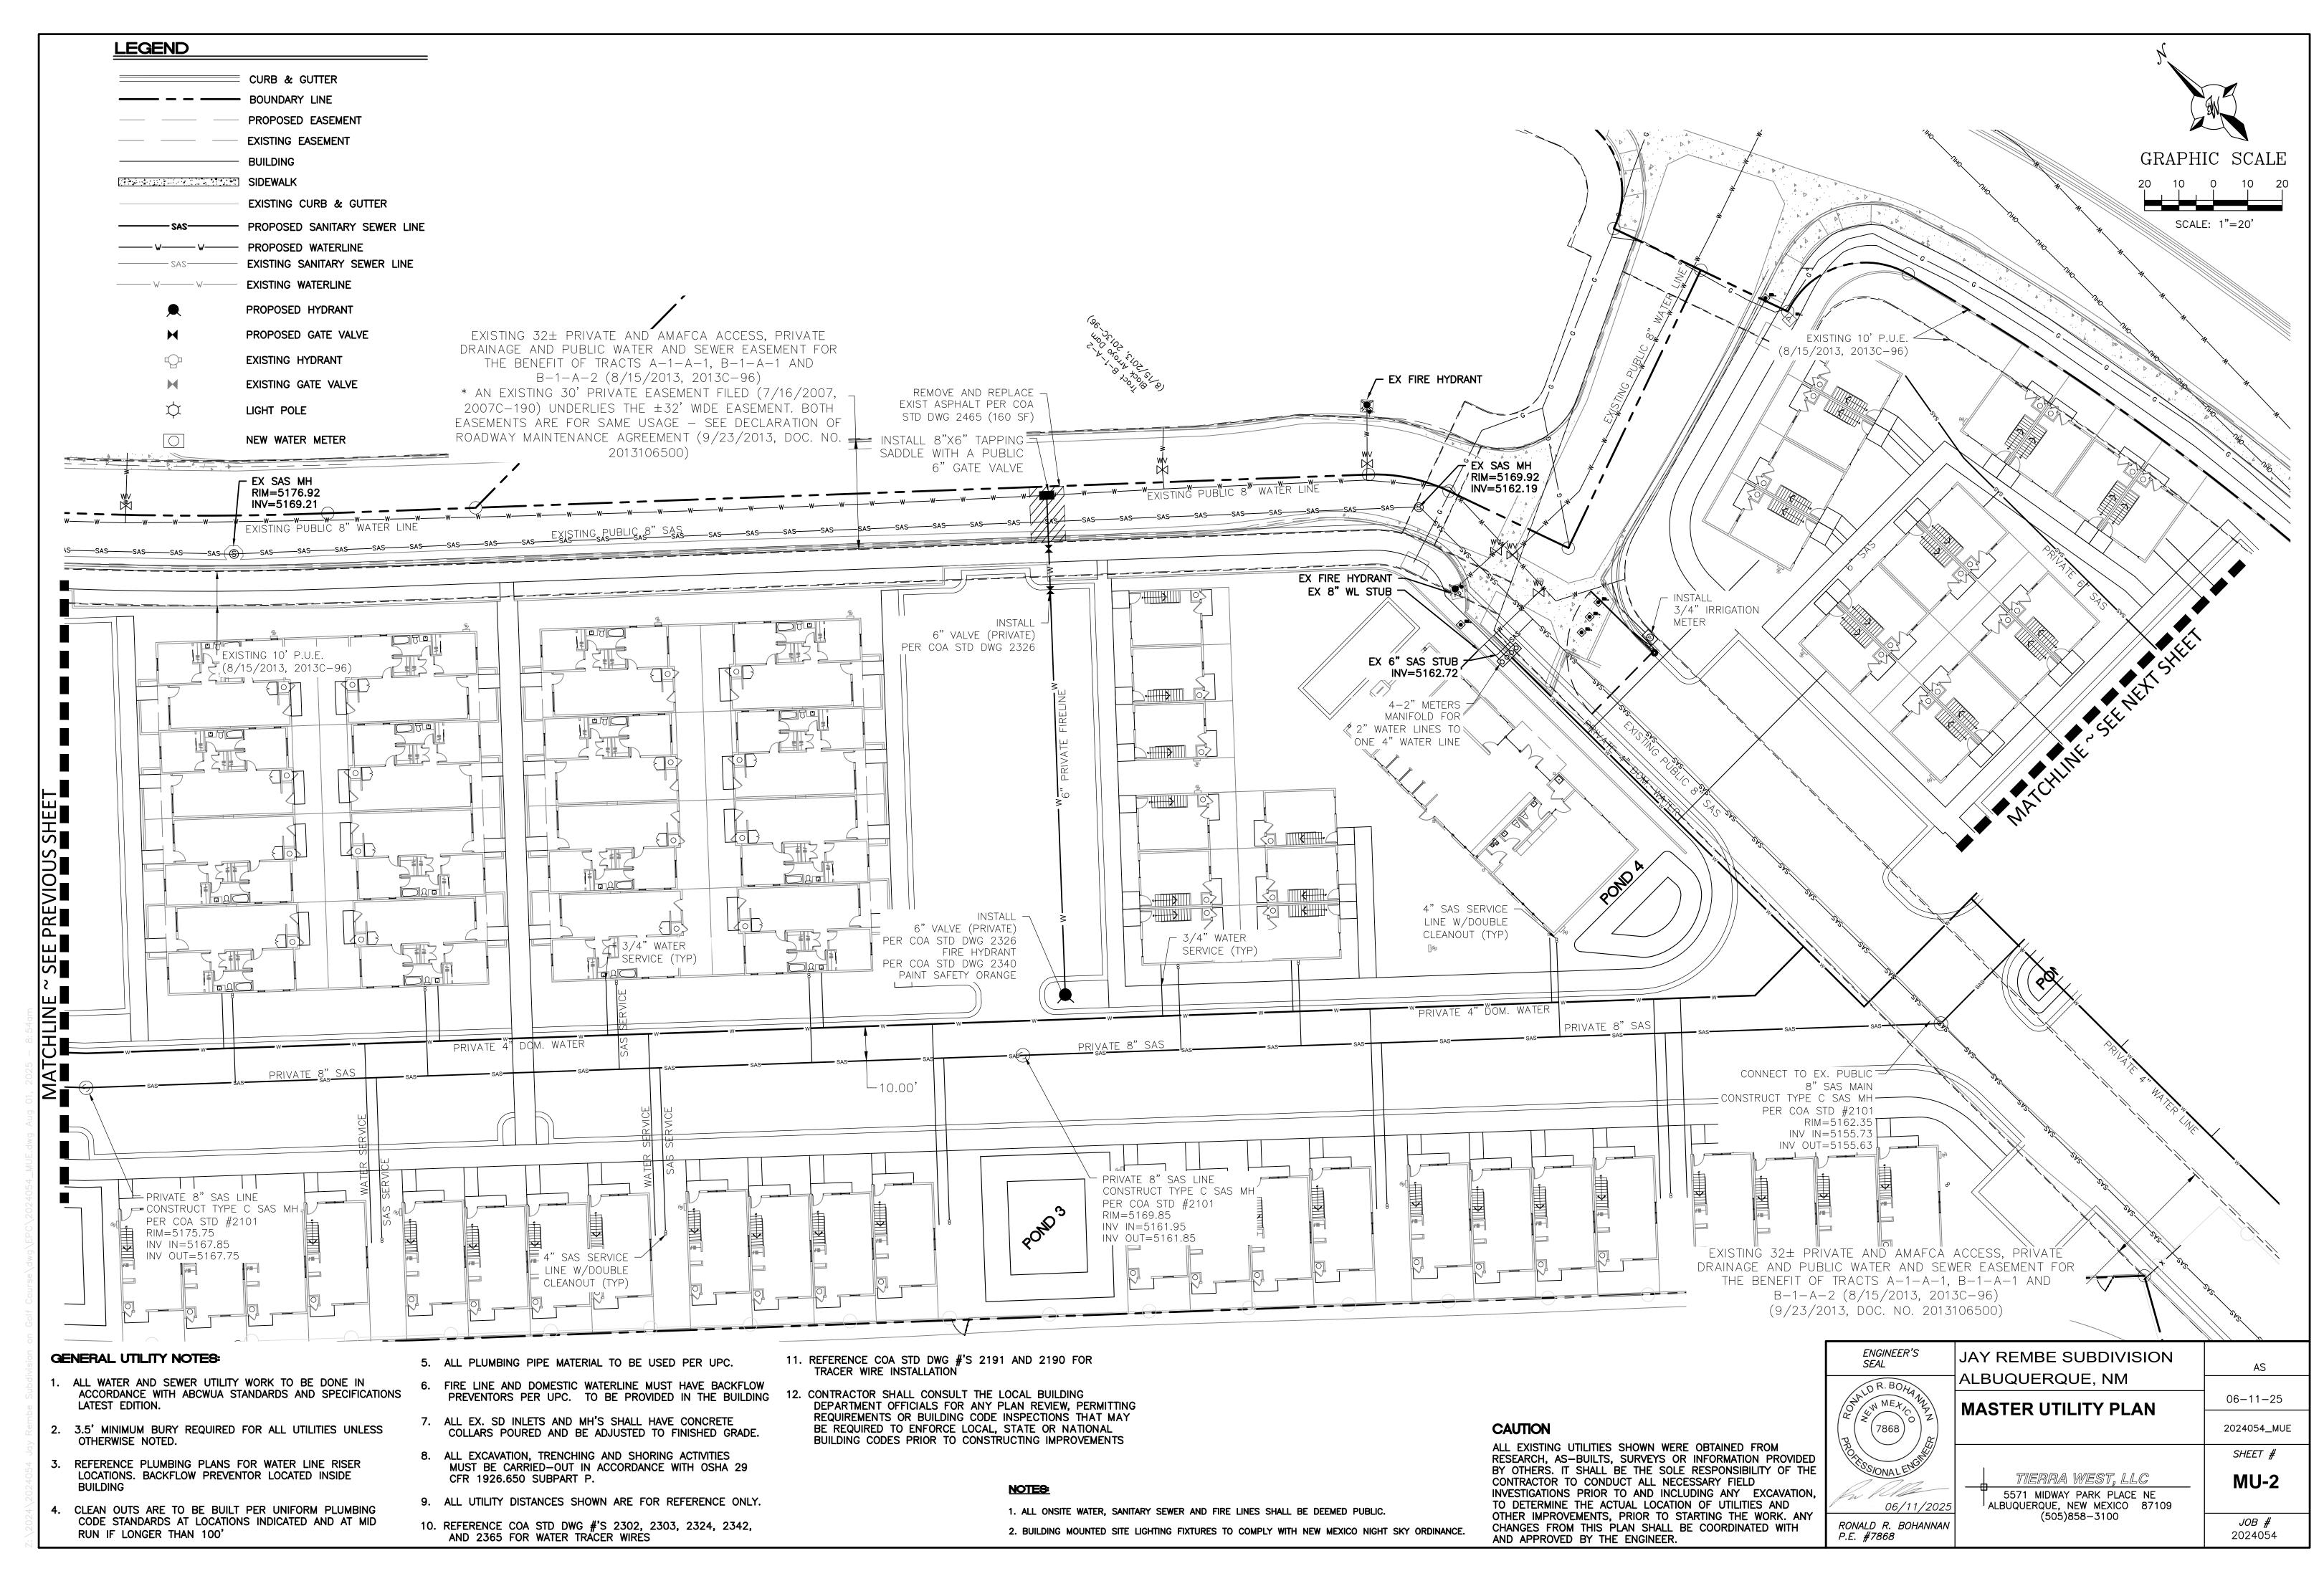

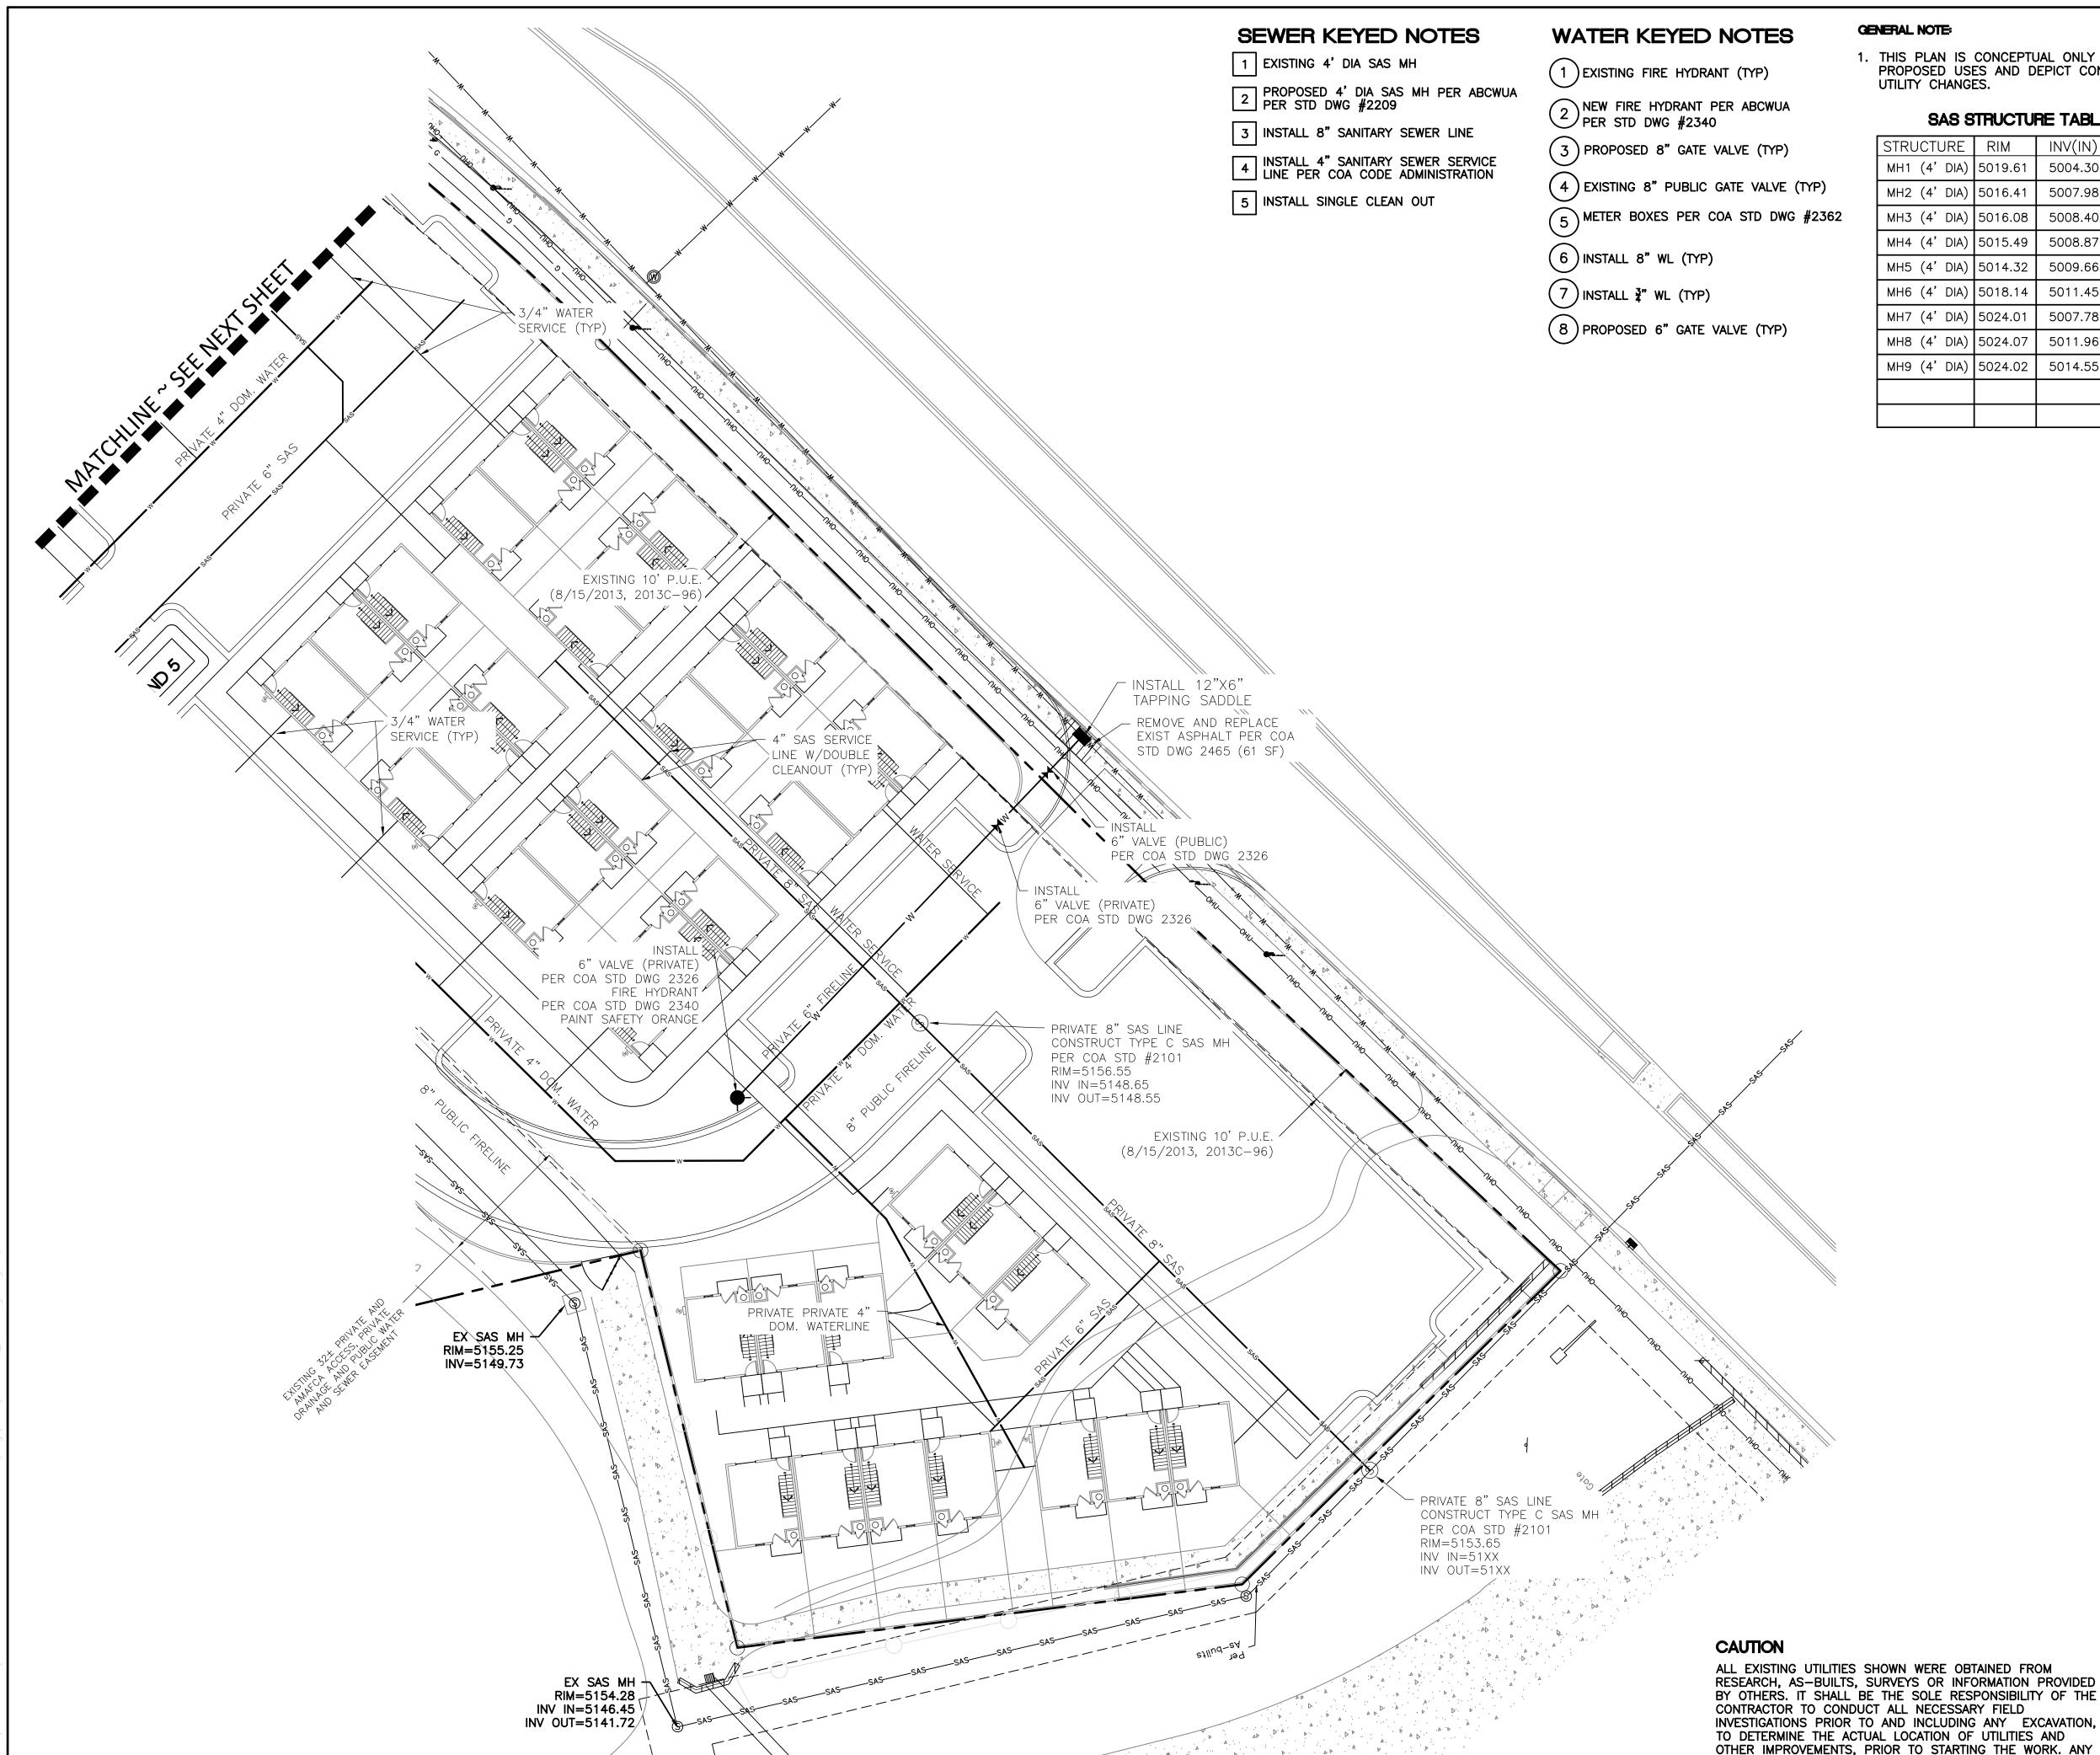


## GENERAL NOTE:

1. THIS PLAN IS CONCEPTUAL ONLY TO SHOW PROPOSED USES AND DEPICT CONCEPTUAL UTILITY CHANGES.

# SAS STRUCTURE TABLE

STRUCTURE	RIM	INV(IN)	INV(OUT
MH1 (4' DIA)	5019.61	5004.30	5004.20
MH2 (4' DIA)	5016.41	5007.98	5007.88
MH3 (4' DIA)	5016.08	5008.40	5008.30
MH4 (4' DIA)	5015.49	5008.87	5008.77
MH5 (4' DIA)	5014.32	5009.66	5009.56
MH6 (4' DIA)	5018.14	5011.45	5011.45
MH7 (4' DIA)	5024.01	5007.78	5007.68
MH8 (4' DIA)	5024.07	5011.96	5011.86
MH9 (4' DIA)	5024.02	5014.55	5014.45

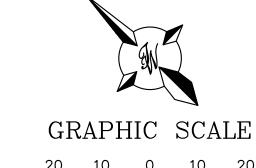


SCALE: 1"=20'

# **GENERAL UTILITY NOTES:**

CFR 1926.650 SUBPART P.

- 1. ALL WATER AND SEWER UTILITY WORK TO BE DONE IN ACCORDANCE WITH ABCWUA STANDARDS AND SPECIFICATIONS
- 2. 3.5' MINIMUM BURY REQUIRED FOR ALL UTILITIES UNLESS OTHERWISE NOTED.
- 3. REFERENCE PLUMBING PLANS FOR WATER LINE RISER LOCATIONS. BACKFLOW PREVENTOR LOCATED INSIDE BUILDING
- 4. CLEAN OUTS ARE TO BE BUILT PER UNIFORM PLUMBING CODE STANDARDS AT LOCATIONS INDICATED AND AT MID RUN IF LONGER THAN 100'
- 5. ALL PLUMBING PIPE MATERIAL TO BE USED PER UPC.
- 6. FIRE LINE AND DOMESTIC WATERLINE MUST HAVE BACKFLOW PREVENTORS PER UPC. TO BE PROVIDED IN THE BUILDING
- 7. ALL EX. SD INLETS AND MH'S SHALL HAVE CONCRETE COLLARS POURED AND BE ADJUSTED TO FINISHED GRADE.
- 8. ALL EXCAVATION, TRENCHING AND SHORING ACTIVITIES MUST BE CARRIED-OUT IN ACCORDANCE WITH OSHA 29
- 9. ALL UTILITY DISTANCES SHOWN ARE FOR REFERENCE ONLY.
- 10. REFERENCE COA STD DWG #'S 2302, 2303, 2324, 2342, AND 2365 FOR WATER TRÄCER WIRES
- 11. REFERENCE COA STD DWG #'S 2191 AND 2190 FOR TRACER WIRE INSTALLATION
- 12. CONTRACTOR SHALL CONSULT THE LOCAL BUILDING DEPARTMENT OFFICIALS FOR ANY PLAN REVIEW, PERMITTING REQUIREMENTS OR BUILDING CODE INSPECTIONS THAT MAY BE REQUIRED TO ENFORCE LOCAL, STATE OR NATIONAL BUILDING CODES PRIOR TO CONSTRUCTING IMPROVEMENTS

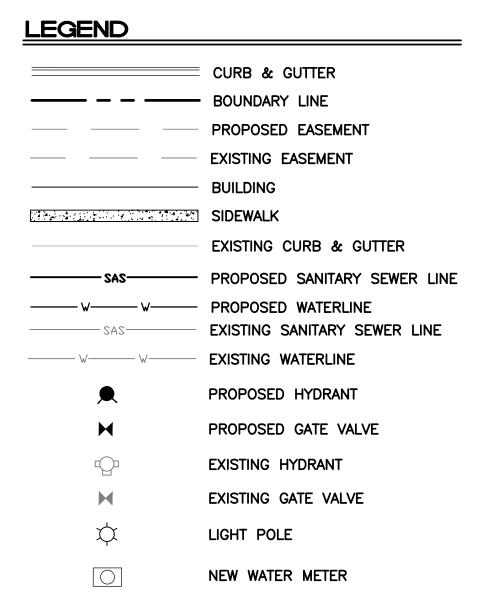

# NOTES:

CHANGES FROM THIS PLAN SHALL BE COORDINATED WITH

AND APPROVED BY THE ENGINEER.

- 1. ALL ONSITE WATER, SANITARY SEWER AND FIRE LINES SHALL BE DEEMED PUBLIC.








TYPICAL REAR ELEVATION

3/16"=1'-0"




TYPICAL ENTRY PATHWAY FACADE

NTS

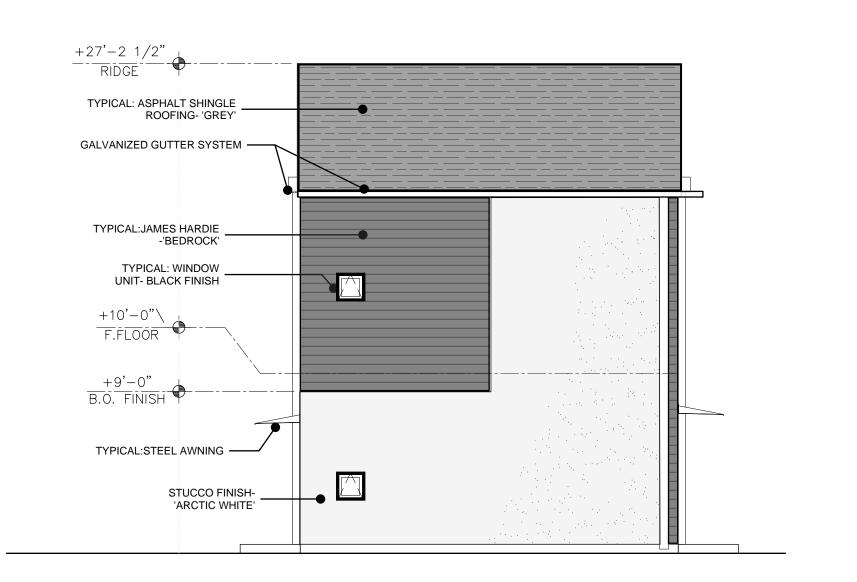

C2 TYPICAL SIDE ELEVATION

3/16"=1'-0"

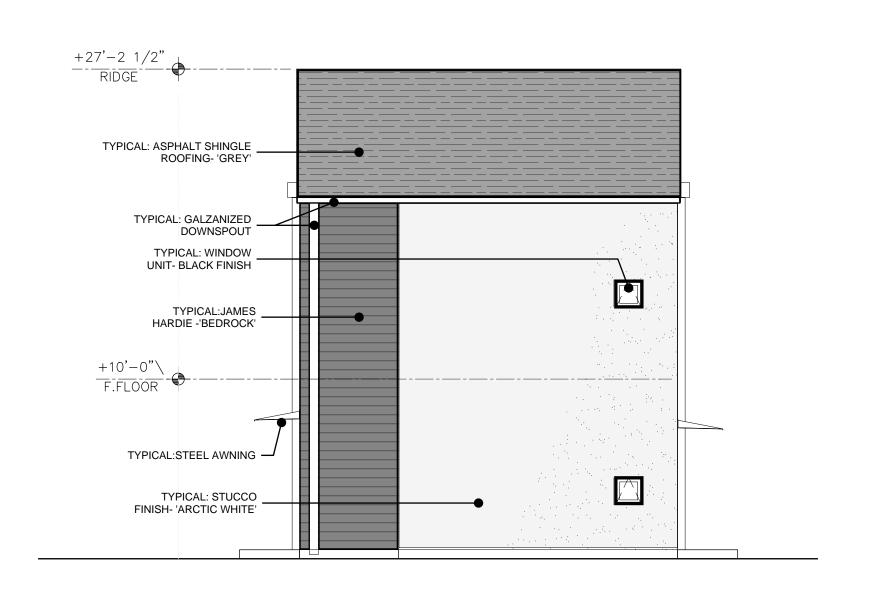

B2 TYPICAL SIDE ELEVATION

3/16"=1'-0"

BTR | RIO RANCHO HOUSING
GOLF COURSE RD, NW
ALBUQUERQUE, NM 87114

PMEN

KENNETH
MYERS
No.005751

CONTRACTOR ARCHIVE

ARC

REMBE

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Project:

Drawn By: KMA

Checked By: KMA

Phase: DFT SUBMITTAL

Date: 09/22/2025

ARCHITECTURAL ELEVATIONS BUILDING A

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PMEN. OUSING RANCI

Chitect Stamp:

KENNETH
MYERS
No.005751

COLUMN ARCHIVE

REMBE


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Phase: DFT SUBMITTAL

Date: 09/22/2025

ARCHITECTURAL ELEVATIONS BUILDING B

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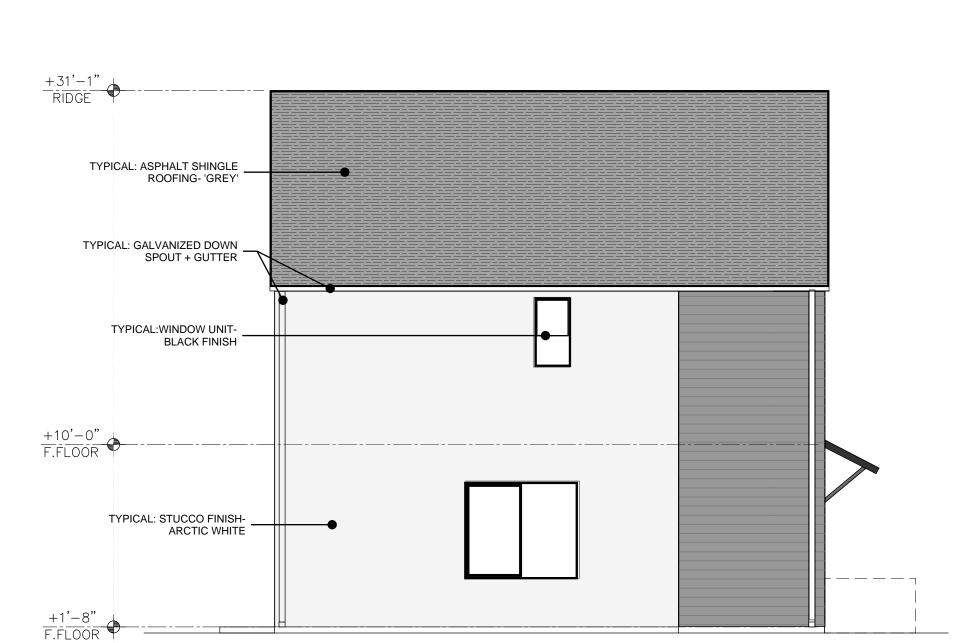


Drawn By: KMA Checked By: KMA Phase: DFT SUBMITTAL Date: 09/22/2025

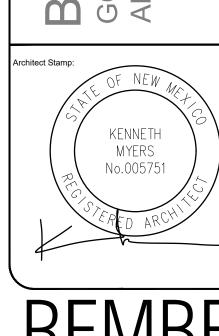ARCHITECTURAL **ELEVATIONS BUILDING C** 









TYPICAL: ASPHALT SHINGLE

TYPICAL: GALVANIZED DOWN

TYPICAL: JAMES HARDIE PLANK SMOOTH FINISH -'BEDROCK'

+10'-0" F.FLOOR

F.FLOOR

TYPICAL: STEEL AWNING -

TYPICAL: STUCCO FINISH-ARCTIC WHITE

TYPICAL SIDE ELEVATION

ROOFING- 'GREY'

SPOUT + GUTTER






C1 FRONT ELEVATION

3/16"=1'-0"



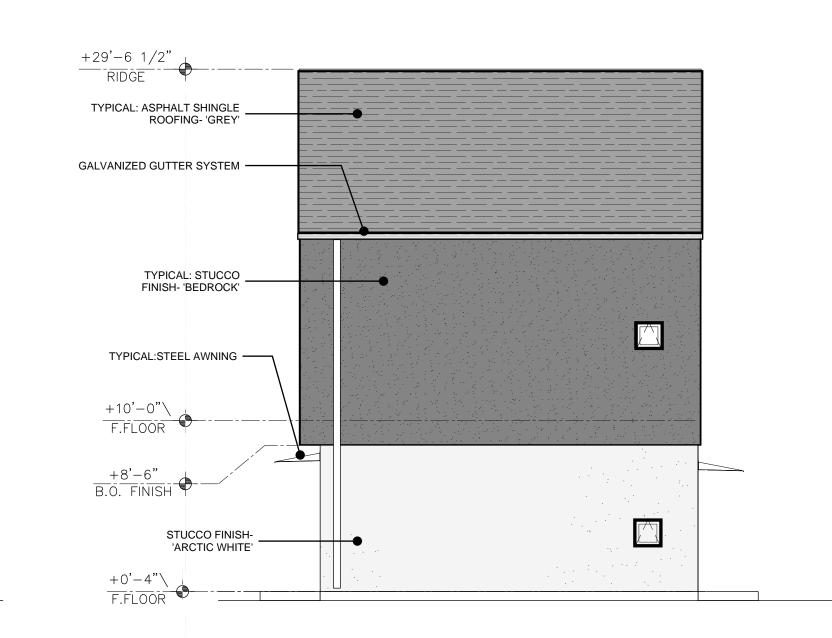

REAR ELEVATION

B2 TYPICAL SIDE ELEVATION

3/16"=1'-0"



(A1) WALKWAY ELEVATION

NTS

BTR RIO RANCHO HOUSING
GOLF COURSE RD. NW
GOLF COURSE RD. NW

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ARCHITECTURAL

ELEVATIONS BUILDING D

Date: 09/22/2025

PMEN.

