



DEVELOPMENT FACILITATION TEAM (DFT) APPLICATIONS

Effective 12/15/2022

Please check the appropriate box(es) and retime of application.	fer to supplemental	forms for submittal requiren	nents. All fees must be paid at the					
MISCELLANEOUS APPLICATION	NS	☐ Extension of Infrastructure Lis	st or IIA (Form S3)					
☐ Site Plan Administrative DFT (Forms P & P2)		PRE-APPLICATIONS						
☐ Final EPC Sign-off for Master Development/Site Plant	ans - EPC (Form P2)	☐ Sketch Plat Review and Com	ment (Form S3)					
☐ Amendment to Infrastructure List (Form S3)		☐ Sketch Plan Review and Com	nment (Form S3)					
☐ Temporary Deferral of S/W (Form S3)			APPEAL					
☐ Extension of IIA: Temp. Def. of S/W (Form S3)		☐ Administrative Decision (Form	n A)					
BRIEF DESCRIPTION OF REQUEST								
APPLICATION INFORMATION								
Applicant/Owner:			Phone:					
Address:			Email:					
City:		State:	Zip:					
Professional/Agent (if any):			Phone:					
Address:			Email:					
City:		State:	Zip:					
Proprietary Interest in Site:		List <u>al</u> l owners:						
SITE INFORMATION (Accuracy of the existing legal	Il description is crucia	-	essary.)					
Lot or Tract No.:		Block:	Unit:					
Subdivision/Addition:	T	MRGCD Map No.:	UPC Code:					
Zone Atlas Page(s):	Existing Zoning:		Proposed Zoning					
# of Existing Lots:	# of Proposed Lots:		Total Area of Site (Acres):					
LOCATION OF PROPERTY BY STREETS	T							
Site Address/Street:	Between:	and						
CASE HISTORY (List any current or prior project a	nd case number(s) the	at may be relevant to your reque	st.)					
I certify that the information I have included here and	sent in the required no	tice was complete, true, and accur						
Signature:			Date:					
Printed Name:			□ Applicant or □ Agent					

FORM P2 Page 1 of 3

FORM P2: SITE PLAN ADMINISTRATIVE – Development Facilitation Team (DFT) as of 12/25/2022 _ SITE PLAN ADMINISTRATIVE – DFT

A Single PDF file of the complete application including all documents being submitted must be emailed to PLNDRS@cabq.gov. Zipped files or those over 9 MB cannot be delivered via email, in which case the PDF must be provided to City Staff using other online resources such as Dropbox or FTP. The PDF shall be organized in the number order below. Divide the PDF with a title sheet for each of the three documentation sections in **bold** below.

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1) DFT Application form completed, signed, and dated
2) Form P2 with all the submittal items checked/marked
3) Form P with signatures from Hydrology, Transportation, and ABCWUA
4) Zone Atlas map with the entire site clearly outlined and labeled
5) Site Plan and related drawings (include a Site Plan key of the sheets submitted)
6) Copy of the original approved Site Plan or Master Development Plan (for amendments to or Extensions of the Site Plan)
7) Infrastructure List, if required for building of public infrastructure
8) Sensitive Lands Site Analysis for new site design in accordance with IDO Section 5-2(C) (The Sensitive Lands Site Analysis form can be obtained online at): https://documents.cabq.gov/planning/development-review-board/Sensitive_lands_analysis_form.pdf
9) Responses to climatic and geographic responsive design considerations (Recommended to promote sustainability, but not required. The Climatic and Geographic Responsiveness form can be obtained online at): https://documents.cabq.gov/planning/IDO/SubmittalFormIDO5-2(D)ClimaticGeographic Responsiveness.pdf
SUPPORTIVE DOCUMENTATION
10) Completed Site Plan Checklist
11) Letter of authorization from the property owner if application is submitted by an agent
12) Justification letter describing and justifying the request per the criteria in IDO Section 16-6-5(G)(3)
13) Explanation and justification of requested deviations, if any, in accordance with IDO Section 14 16-6-4(P). Note: If requesting more than allowed by deviation, a Variance – ZHE or Waiver –DHO will be required, as applicable
14) Sites 5 acres or greater: Archaeological Certificate in accordance with IDO Section 14-16-6-5(A) (not required for Extension)

15) Landfill disclosure statement per IDO Section 14-16-6-4(S)(5)(d)(2)(d) if site is within a designated landfill buffer zone 16) Architectural Review Committee approval letter if the site is located within a Master Development Plan area or a Framework Plan area **PUBLIC NOTICE DOCUMENTATION** ____ 17) Sign Posting Agreement _____ 18) Proof of a Pre-Submittal Neighborhood Meeting per IDO 6-4(C)(1)(b) for new building or multiple new buildings that include a total of more than 100 multi-family residential dwelling units or more than 50,000 square feet of non-residential development Office of Neighborhood Coordination neighborhood meeting inquiry response __ Proof of email with read receipt OR Certified Letter offering meeting to applicable associations Completed neighborhood meeting request form(s) If a meeting was requested or held, copy of sign-in sheet and meeting notes 19) Required Content of Notice at Submittal per IDO Section 14-16-6-4(K)(1) (not required for an extension) Office of Neighborhood Coordination notice inquiry response

__ Completed notification form(s), proof of additional information provided in accordance with

Proof of emailed notice to affected Neighborhood Association representatives

IDO Section 6-4(K)(1)(b)

FORM P2


Page 2 of 3

_	Description & Location: <u>Iract D-6, Me</u> k Avenue SE, between Watson SE and		ark II	
Onc	R Avenue OL, between watson OL an	d Hawking Drive OL		
Reque	est Description: Roses Southwest Pap	oers Warehouse, Phase	1 of 3.	
□ <u>H</u>	ydrology:			
· · ·	Sensitive Lands Analysis (5-2(C)) Grading and Drainage Plan AMAFCA Bernalillo County NMDOT MRGCD Treamer Chan ydrology Department	Approved X Approved Approved Approved Approved Approved Approved Approved Approved Date	X NA	
□ <u>T</u>	ransportation:			
	Traffic Circulations Layout (TCL) Traffic Impact Study (TIS) Neighborhood Impact Analysis (NIA) Bernalillo County MRCOG NMDOT MRGCD Ernest Urmyo ransportation Department	X Approved Date	NA	
□ <u>A</u>	lbuquerque Bernalillo County Water	Utility Authority (ABC	:WUA):	
•	Request for Availability submitted? Availability Statement/Serviceability Lette Note: Commitment for service is required		NA val.	
Ā	BCWUA	Date		
☐ So	frastructure Improvements Agreement (IIA olid Waste Department Signature on the P re Marshall Signature on the Plan		NA NA NA	

^{*} Prior to Final Site Plan approval submittals (include a copy of the recorded IIA)

Crick Avenue SE, between Watson SE a		
Request Description: Roses Southwest Pa		
□ <u>Hydrology:</u>		
 Sensitive Lands Analysis (5-2(C)) Grading and Drainage Plan AMAFCA Bernalillo County NMDOT MRGCD 	Approved NA Approved NA Approved NA Approved NA Approved NA Approved NA Approved NA	
Hydrology Department	Date	
□ <u>Transportation:</u>		
 Traffic Circulations Layout (TCL) Traffic Impact Study (TIS) Neighborhood Impact Analysis (NIA) Bernalillo County MRCOG NMDOT MRGCD Transportation Department	Approved	
□ Albuquerque Bernalillo County Water	er Utility Authority (ABCWUA):	
 Request for Availability submitted? Availability Statement/Serviceability Left Note: Commitment for service is required Caurin Bergeron ABCWUA	XYesNoNA etter Number 230704	
 □ Infrastructure Improvements Agreement (I □ Solid Waste Department Signature on the □ Fire Marshall Signature on the Plan 	IIA*) Approved NA	

^{*} Prior to Final Site Plan approval submittals (include a copy of the recorded IIA)

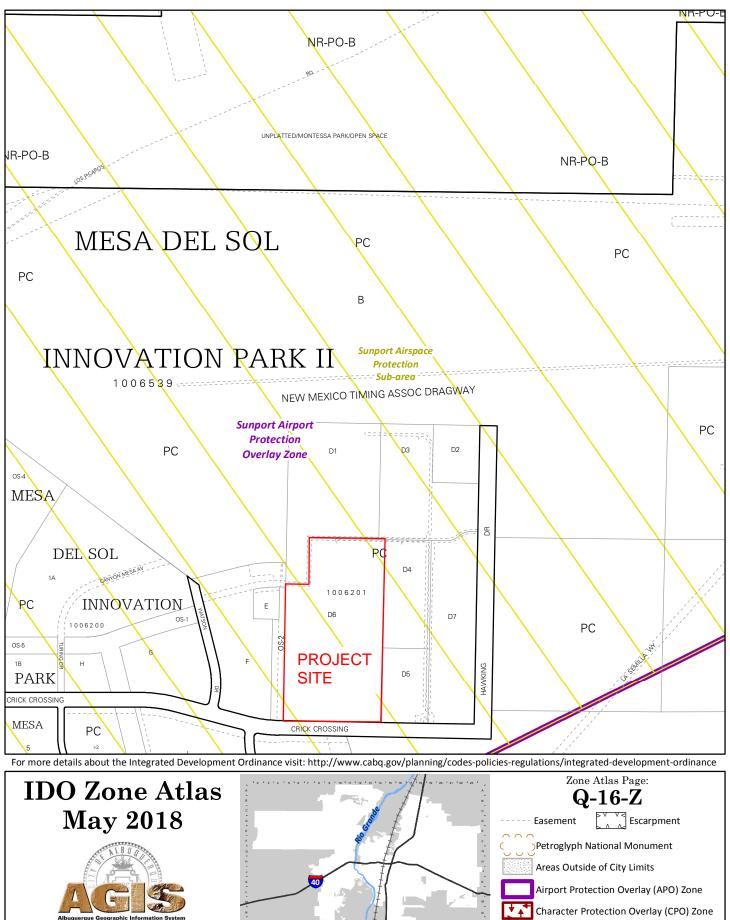



ARCHITECTURE + DESIGN

ARCHITECT/ ENGINEER



BUILDING PERMIT SET

DATE REVISION

10/16/23

PROJECT NO

TRAFFIC CIRCULATION LAYOUT -PHASE 1

SHEET NO.

TCL-1



ROSE

BUILDING PERMIT SET

DATE

10/16/23


REVISION

PROJECT NO

TRAFFIC CIRCULATION LAYOUT -PHASE 1

ENLARGED SHEET NO.


TCL-1A

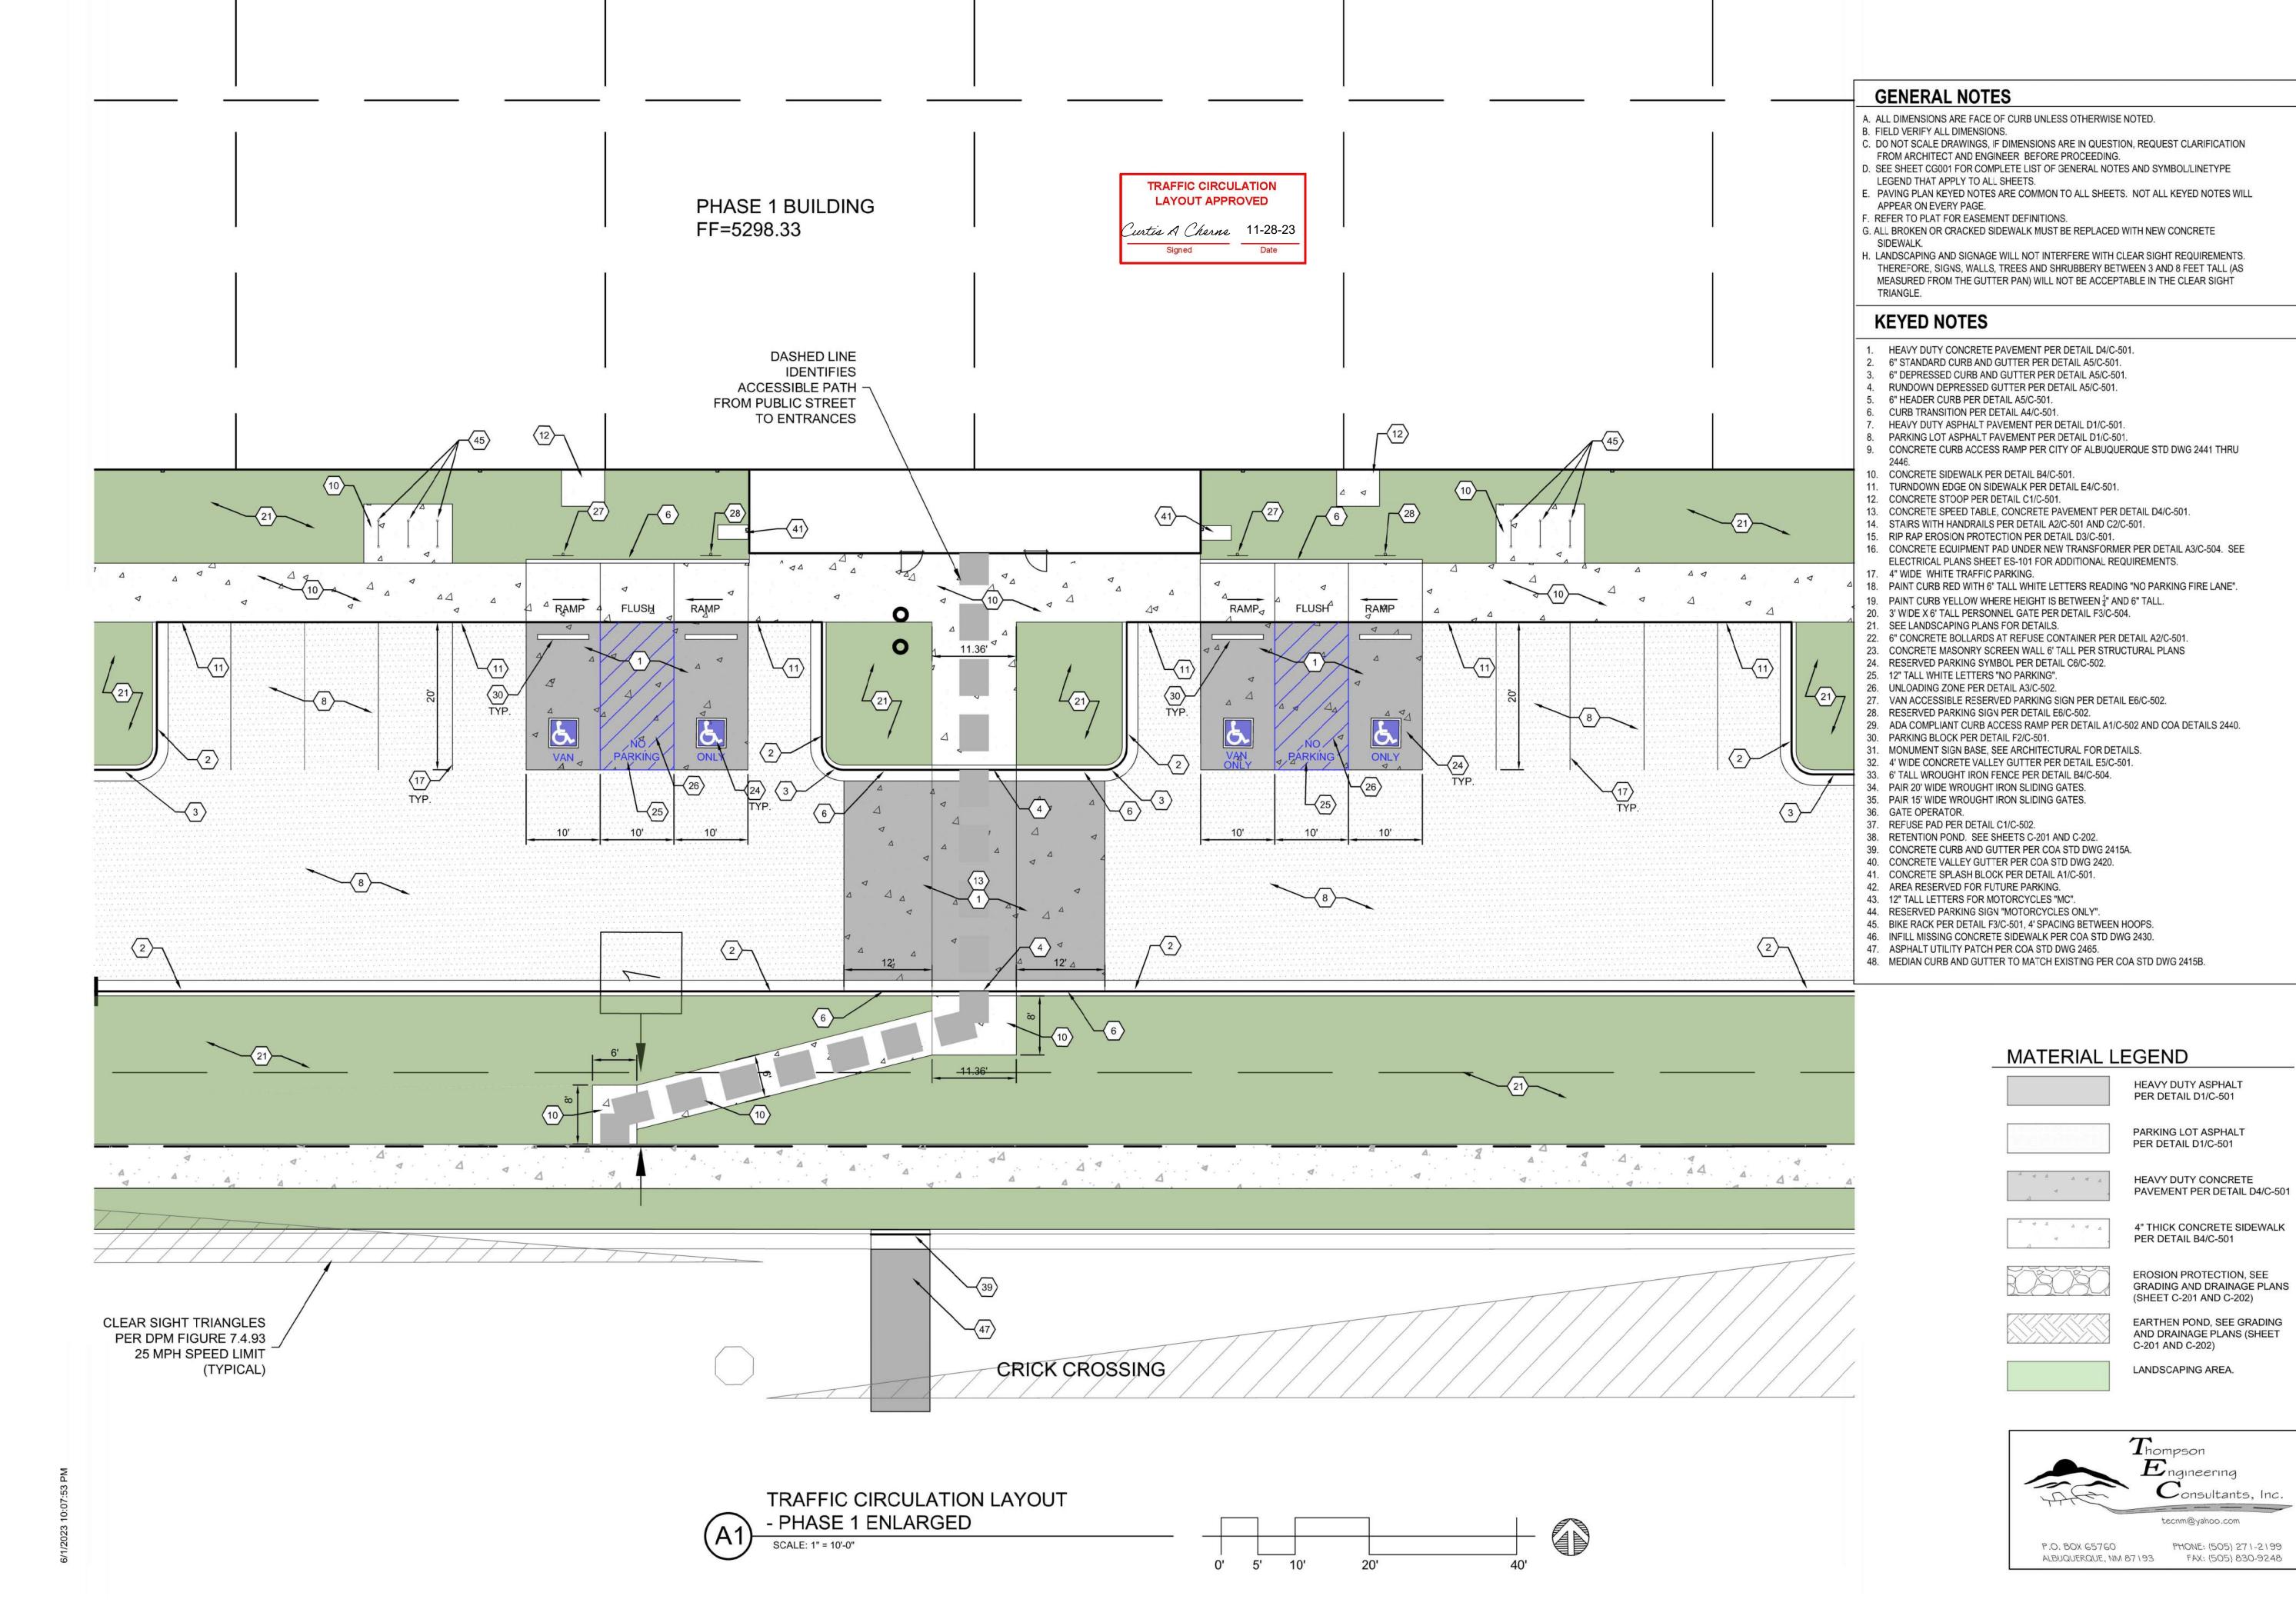

0' 5'

10'

20'

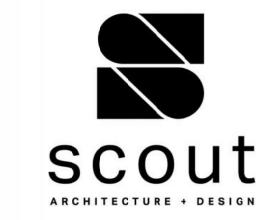

ARCHITECT/ ENGINEER



BUILDING PERMIT SET

DATE REVISION

PROJECT NO

TRAFFIC CIRCULATION LAYOUT -PHASE 1 **ENLARGED**

SHEET NO.

ALBUQUERQUE, NM 87 193 FAX: (505) 830-9248

TCL-1B

ARCHITECTURE + DESIGN

ARCHITECT/ ENGINEER

TRAFFIC

LAYOUT -


ENLARGED

PHASE 1


SHEET NO.

CIRCULATION

LANDSCAPING AREA.

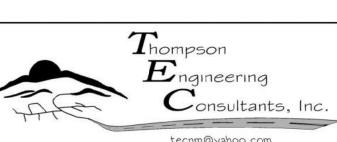

P.O. BOX 65760 PHONE: (505) 271-2199

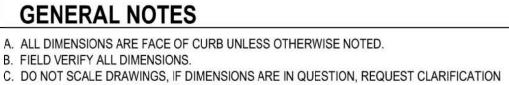

- FROM ARCHITECT AND ENGINEER BEFORE PROCEEDING. D. SEE SHEET CG001 FOR COMPLETE LIST OF GENERAL NOTES AND SYMBOL/LINETYPE
- LEGEND THAT APPLY TO ALL SHEETS. E. PAVING PLAN KEYED NOTES ARE COMMON TO ALL SHEETS. NOT ALL KEYED NOTES WILL
- APPEAR ON EVERY PAGE.
- . REFER TO PLAT FOR EASEMENT DEFINITIONS. G. ALL BROKEN OR CRACKED SIDEWALK MUST BE REPLACED WITH NEW CONCRETE
- H. LANDSCAPING AND SIGNAGE WILL NOT INTERFERE WITH CLEAR SIGHT REQUIREMENTS. THEREFORE, SIGNS, WALLS, TREES AND SHRUBBERY BETWEEN 3 AND 8 FEET TALL (AS MEASURED FROM THE GUTTER PAN) WILL NOT BE ACCEPTABLE IN THE CLEAR SIGHT

KEYED NOTES

- HEAVY DUTY CONCRETE PAVEMENT PER DETAIL D4/C-501.
- 6" STANDARD CURB AND GUTTER PER DETAIL A5/C-501.
- 3. 6" DEPRESSED CURB AND GUTTER PER DETAIL A5/C-501. RUNDOWN DEPRESSED GUTTER PER DETAIL A5/C-501.
- 6" HEADER CURB PER DETAIL A5/C-501.
- CURB TRANSITION PER DETAIL A4/C-501.
- HEAVY DUTY ASPHALT PAVEMENT PER DETAIL D1/C-501.
- 8. PARKING LOT ASPHALT PAVEMENT PER DETAIL D1/C-501. 9. CONCRETE CURB ACCESS RAMP PER CITY OF ALBUQUERQUE STD DWG 2441 THRU
- 10. CONCRETE SIDEWALK PER DETAIL B4/C-501.
- 11. TURNDOWN EDGE ON SIDEWALK PER DETAIL E4/C-501. CONCRETE STOOP PER DETAIL C1/C-501.
- 13. CONCRETE SPEED TABLE, CONCRETE PAVEMENT PER DETAIL D4/C-501.
- 14. STAIRS WITH HANDRAILS PER DETAIL A2/C-501 AND C2/C-501.
- 15. RIP RAP EROSION PROTECTION PER DETAIL D3/C-501. 16. CONCRETE EQUIPMENT PAD UNDER NEW TRANSFORMER PER DETAIL A3/C-504. SEE
- ELECTRICAL PLANS SHEET ES-101 FOR ADDITIONAL REQUIREMENTS.
- 4" WIDE WHITE TRAFFIC PARKING. 18. PAINT CURB RED WITH 6" TALL WHITE LETTERS READING "NO PARKING FIRE LANE".
- 19. PAINT CURB YELLOW WHERE HEIGHT IS BETWEEN ¹/₄" AND 6" TALL.
- 20. 3' WIDE X 6' TALL PERSONNEL GATE PER DETAIL F3/C-504.
- 21. SEE LANDSCAPING PLANS FOR DETAILS. 22. 6" CONCRETE BOLLARDS AT REFUSE CONTAINER PER DETAIL A2/C-501.
- 23. CONCRETE MASONRY SCREEN WALL 6' TALL PER STRUCTURAL PLANS
- 24. RESERVED PARKING SYMBOL PER DETAIL C6/C-502.
- 12" TALL WHITE LETTERS "NO PARKING". 26. UNLOADING ZONE PER DETAIL A3/C-502.
- 27. VAN ACCESSIBLE RESERVED PARKING SIGN PER DETAIL E6/C-502.
- 28. RESERVED PARKING SIGN PER DETAIL E6/C-502.
- 29. ADA COMPLIANT CURB ACCESS RAMP PER DETAIL A1/C-502 AND COA DETAILS 2440. 30. PARKING BLOCK PER DETAIL F2/C-501.
- 31. MONUMENT SIGN BASE, SEE ARCHITECTURAL FOR DETAILS.
- 32. 4' WIDE CONCRETE VALLEY GUTTER PER DETAIL E5/C-501.
- 33. 6' TALL WROUGHT IRON FENCE PER DETAIL B4/C-504. 34. PAIR 20' WIDE WROUGHT IRON SLIDING GATES.
- 35. PAIR 15' WIDE WROUGHT IRON SLIDING GATES.
- GATE OPERATOR.
- 37. REFUSE PAD PER DETAIL C1/C-502.
- 38. RETENTION POND. SEE SHEETS C-201 AND C-202. 39. CONCRETE CURB AND GUTTER PER COA STD DWG 2415A.
- 40. CONCRETE VALLEY GUTTER PER COA STD DWG 2420.
- 41. CONCRETE SPLASH BLOCK PER DETAIL A1/C-501.
- 42. AREA RESERVED FOR FUTURE PARKING.
- 43. 12" TALL LETTERS FOR MOTORCYCLES "MC". 44. RESERVED PARKING SIGN "MOTORCYCLES ONLY".
- 45. BIKE RACK PER DETAIL F3/C-501, 4' SPACING BETWEEN HOOPS.
- 46. INFILL MISSING CONCRETE SIDEWALK PER COA STD DWG 2430.
- 47. ASPHALT UTILITY PATCH PER COA STD DWG 2465. 48. MEDIAN CURB AND GUTTER TO MATCH EXISTING PER COA STD DWG 2415B.

MATERIAL LEGEND

HEAVY DUTY ASPHALT PER DETAIL D1/C-501 PARKING LOT ASPHALT

PER DETAIL D1/C-501 HEAVY DUTY CONCRETE

4" THICK CONCRETE SIDEWALK


PER DETAIL B4/C-501 EROSION PROTECTION, SEE GRADING AND DRAINAGE PLANS



EARTHEN POND, SEE GRADING AND DRAINAGE PLANS (SHEET C-201 AND C-202)

PAVEMENT PER DETAIL D4/C-501



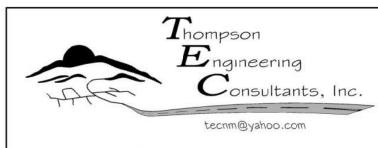

TCL-1C ALBUQUERQUE, NM 87 193 FAX: (505) 830-9248

TRAFFIC CIRCULATION LAYOUT APPROVED Purtis A Cherne 11-28-23 PHASE 1 BUILDING FF=5298.33 TRAFFIC CIRCULATION LAYOUT - PHASE 1 ENLARGED SCALE: 1" = 10'-0"

4 4

(33)—

SCALE: 1" = 10'-0"

SCOUT ARCHITECTURE + DESIGN

ARCHITECT/ ENGINEER



CRICK CROSSING

SE

BUILDING PERMIT SET

REVISION DATE

10/16/23

O IFOT NO

PROJECT NO

TRAFFIC CIRCULATION LAYOUT -PHASE 1

SHEET NO.

P.O. BOX 65760

PHONE: (505) 271-2199

ALBUQUERQUE, NM 87 193 FAX: (505) 830-9248

ENLARGED

TCL-1D

0' 5' 10'

20'

SCOUT ARCHITECTURE + DESIGN

ARCHITECT/ ENGINEER



CRICK CROSSING

SE

BUILDING PERMIT SET

REVISION DATE

DATE

O JECT NO

PROJECT NO

TRAFFIC CIRCULATION LAYOUT -PHASE 1


10/16/23

SHEET NO.

ALBUQUERQUE, NM 87 193 FAX: (505) 830-9248


ENLARGED

TCL-1E

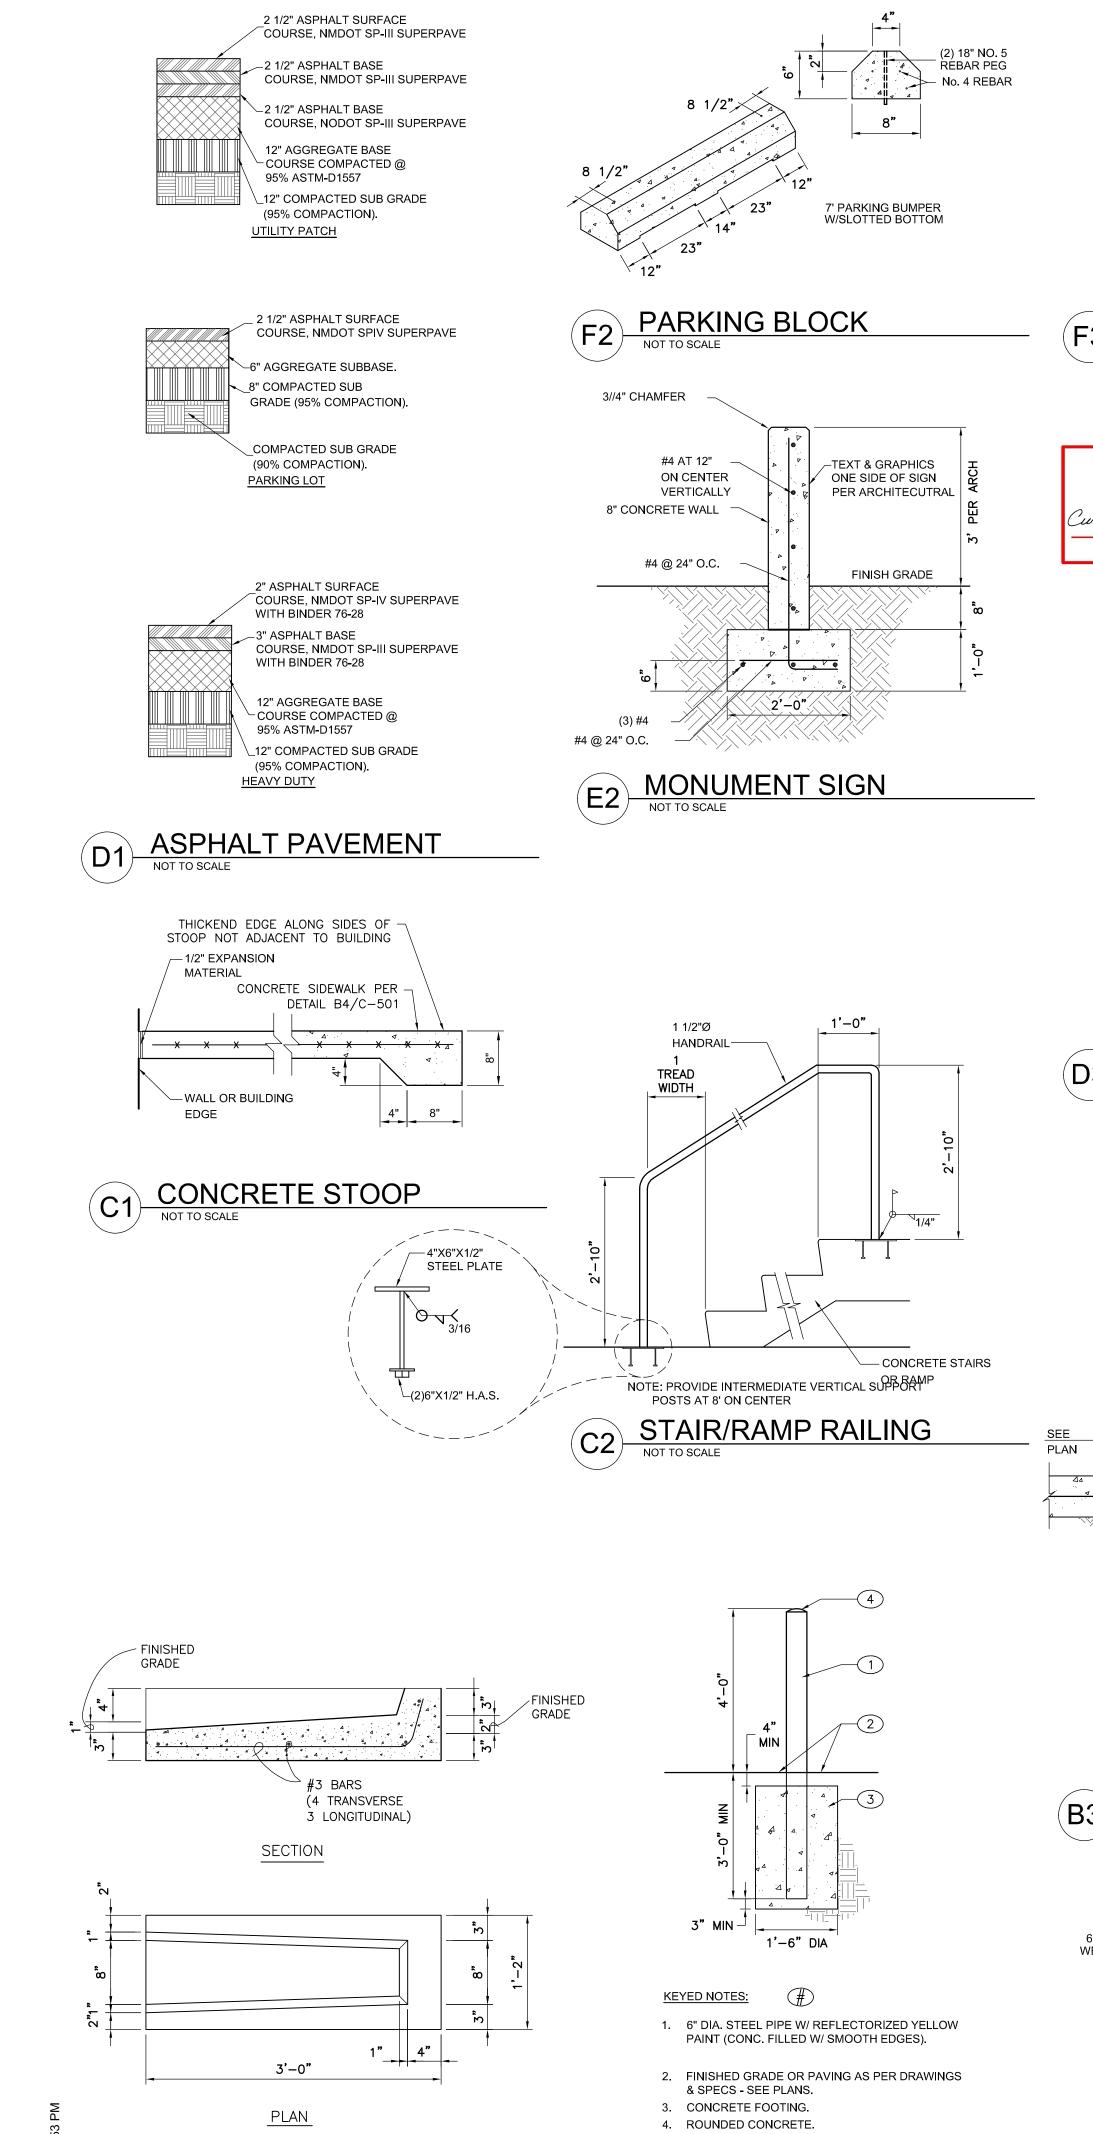

BOLLARD, 6"Ø

A1 CONCRETE SPLASH BLOCK
NOT TO SCALE

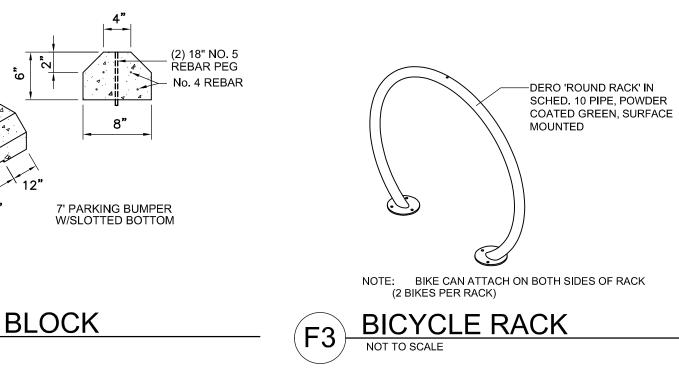



TURNDOWN EDGE

CONCRETE PAVEMENT

PROVIDE EXPANSION JOINTS AT INTERVALS NOT EXCEEDING 30'-0" ON

1/8"


CONTRACTION JOINT

—6"x6"x10x10


FABRIC


WELDED WIRE

- #5@12" O.C.E.W.

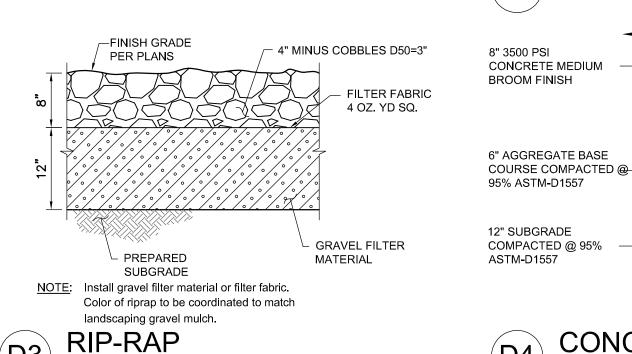


NOT TO SCALE

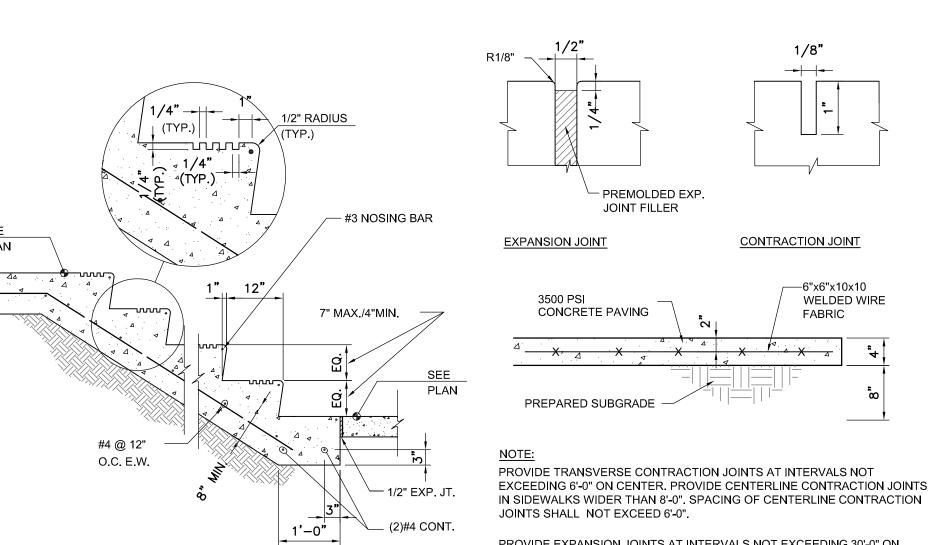


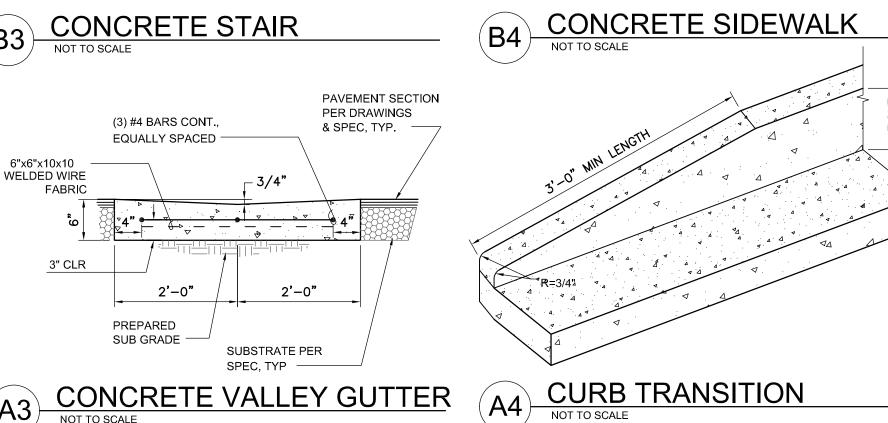


CENTER.

(2)#4 CONT.

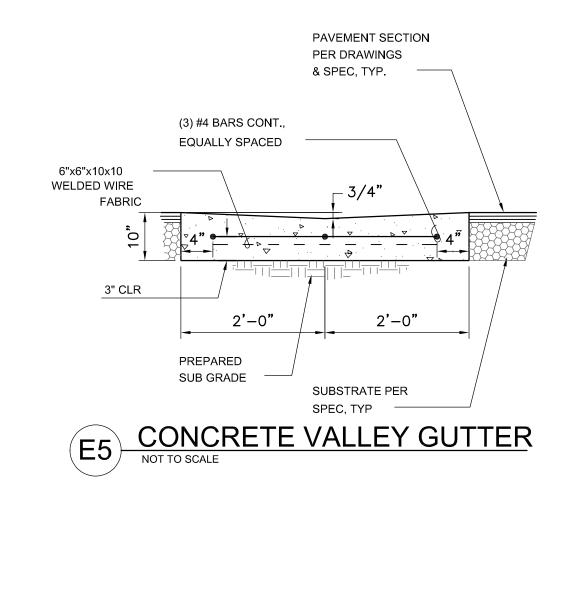

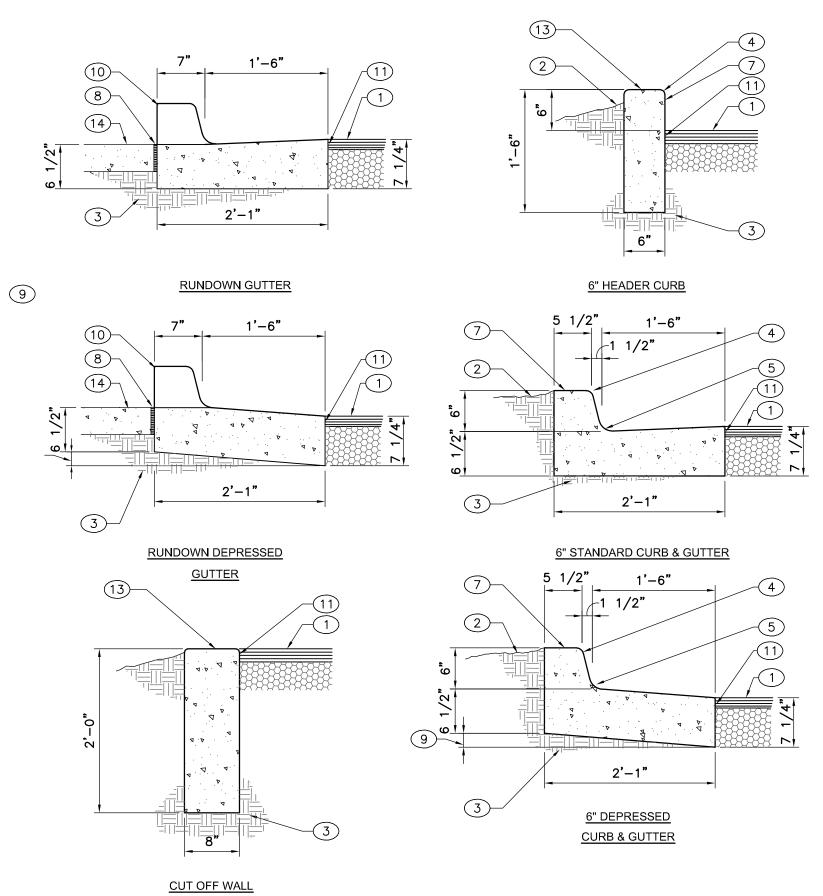

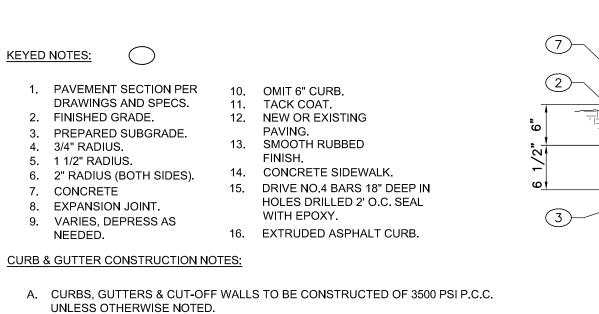

B. EDGES NOT SPECIFICALLY DIMENSIONED SHALL BE EDGED WITH A 3/8"

C. REMOVE & REPLACE 12" WIDE STRIP OF PAVEMENT BEYOND LIP OF


E. FOR 6" CURB & GUTTER PROVIDE CONTROL JTS. @ 6' O.C. MAX,


F. FOR ALL OTHER CURBING PROVIDE CONTROL JOINTS @ 10' O.C.,

PROVIDE EXPANSION JOINTS @ 50' O.C. & ADJACENT TO BUILDINGS AND

ALSO PROVIDE 1/2" EXPANSION JTS. AT 30' O.C. MAX, AT CURB

GUTTER WHEN CONSTRUCTING CURB & GUTTER ADJACENT TO

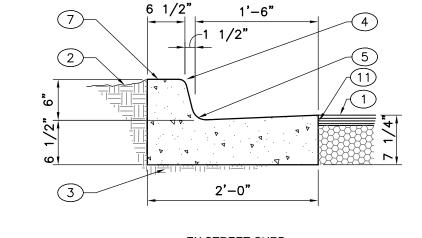

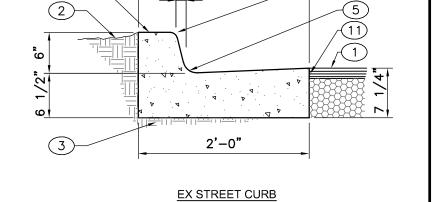

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ALBUQUERQUE, NM 87 193 FAX: (505) 830-9248

P.O. BOX 65760

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tecnm@yahoo.com

Consultants, Inc.

PHONE: (505) 27 1-2 199

DATE REVISION

BUILDING

S0

ARCHITECTURE + DESIGN

ARCHITECT/ ENGINEER

10/16/23 PROJECT NO

SHEET NO.

CURB SECTIONS

RETURNS, & AT EACH SIDE OF DRIVEWAYS.

D. DIMENSIONS AT ROUNDED CORNERS MEASURED TO

INTERSECTION OF STRAIGHT LINES.

EDGING TOOL.

WALLS.

EXISTING A.C. PAVEMENT.

PERMIT SET

CIVIL DETAILS



SOUTHWEST

SE

- sign lettering and border are green
- International Symbol of Accessibility
is white on a blue background

- sign lettering and border are green VAN Required language (Van Accessible Spaces) **ACCESSIBLE** ANSI 502.7

SIGN TYPE R7-8 (12"×18") - sign field is white

Optional Language

Required language per NMSA 197866-7-352 4C

- sign field is white

SIGN TYPE R7-8A (6"x12")

RESERVED PARKING SIGNS NOT TO SCALE PROVIDE SIGN POSTS AND MOUNTING PER D4/C-502.

ACCESSIBLE

Bottom of lowest sign 60" min. above the ground in parking lot. ANSI 502.7

84" min. for on-street parking


and in the pedestrian path of travel per MUTCD Sec 2A.18

PARKING


VIOLATORS ARE

SUBJECT TO A FINE

AND/OR TOWING

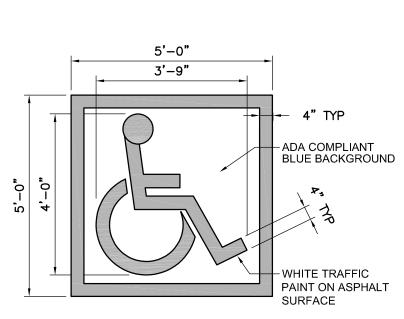

C6 RESERVED SYMBOL NOT TO SCALE

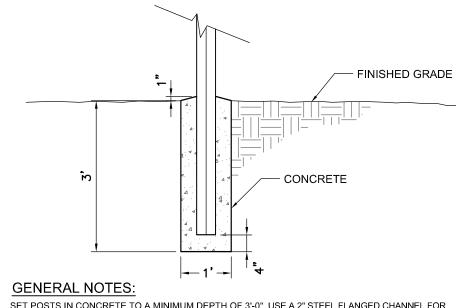

SET POSTS IN CONCRETE TO A MINIMUM DEPTH OF 3'-0". USE A 2" STEEL FLANGED CHANNEL FOR SIGN POSTS. FABRICATE SIGN PANELS OF .063 ALUMINUM. PAINT POST POSTAL BLUE, (MATTE


BUILDING


PERMIT SET


DATE

10/16/23

C-502

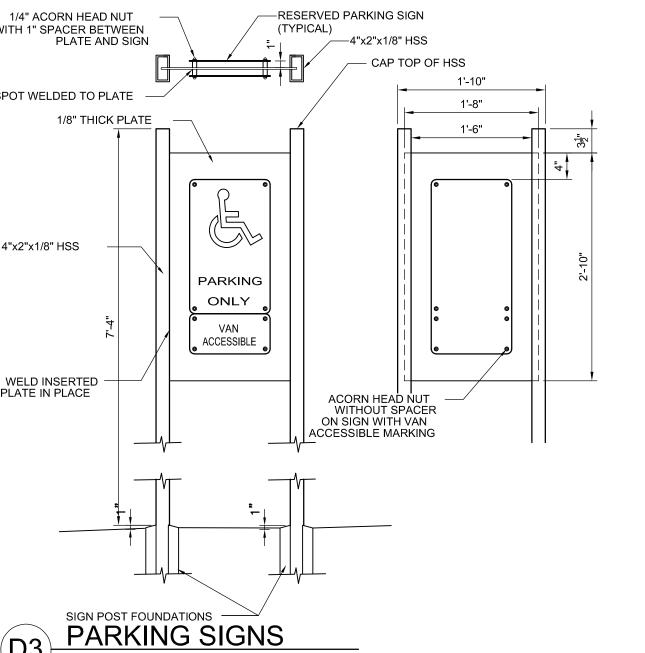

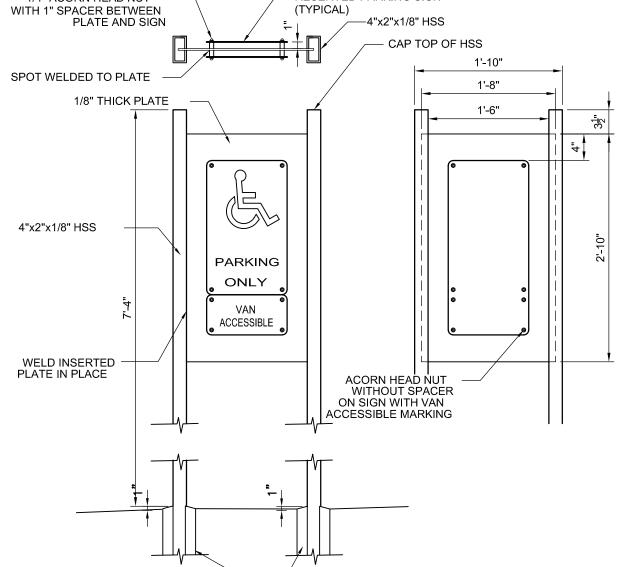

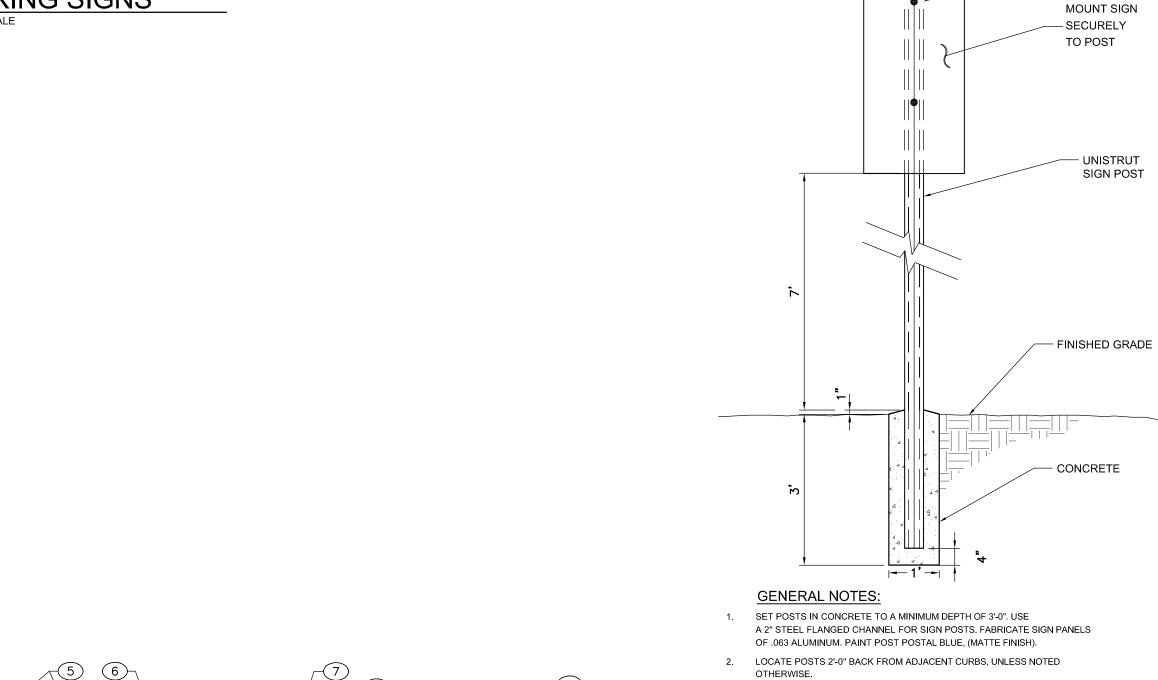

STOP

24"

KEYED NOTES: 1. ONE INCH FILLET ON ALL

2. WHITE PAINTED BACKGROUND 3. BLACK PAINTED BORDER

5. RED PAINTED BACKGROUND

6. WHITE PAINTED BORDER

NOTE:

4. HELVETICA MEDIUM 4" WHITE VINYL

7 HELVETICA BOLD 6" WHITE VINYL LETTERS

FOR SIGN INSTALLATION REFER TO DETAIL A6/C-502.

CORNERS

SPEED

18"

SPEED LIMIT SIGN 10 MPH.


RESERVED PARKING SIGNS

2.35" (CEN TO CEN.)

DETECTABLE WARNING

A5 SURFACE NOT TO SCALE

3/8" DIA. HOLES

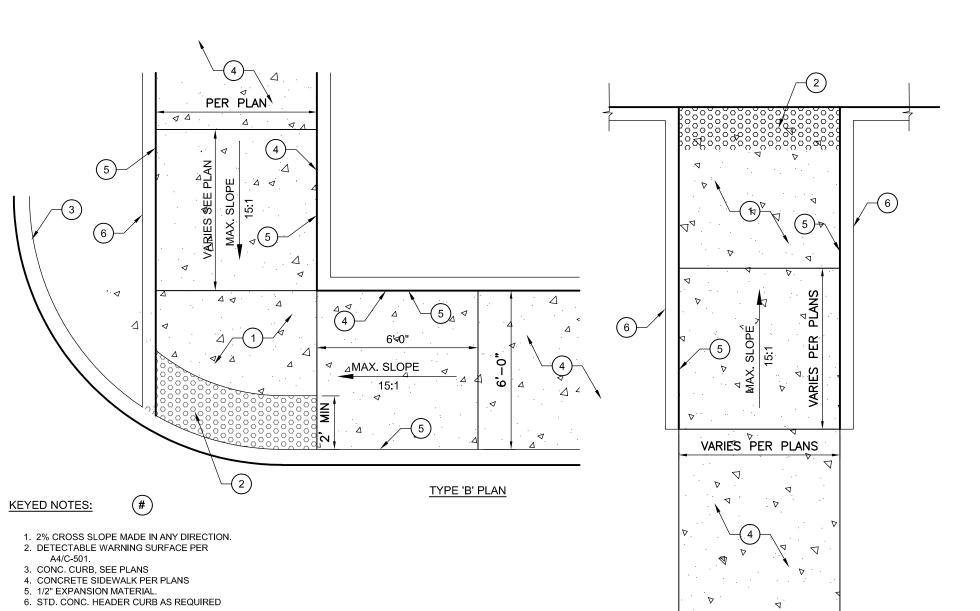


TYPE 'A' PLAN

TRAFFIC CIRCULATION

LAYOUT APPROVED

Curtis A Cherne 11-28-23

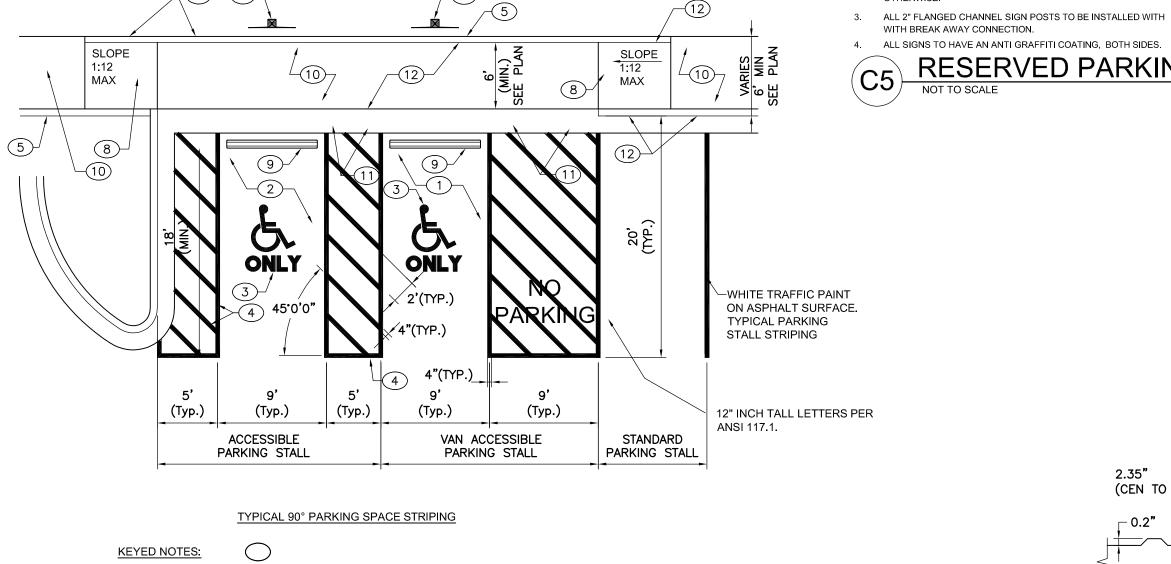

TYPICAL VAN ACCESSIBLE SPACE TYPICAL STANDARD ACCESSIBLE

6. RESERVED PARKING SIGN

PER DETAIL E6/C502.

- 7. VAN ACCESSIBLE RESERVED PARKING SIGN
- RESERVED PARKING SYMBOL
- 8. TYPICAL TYPE "B" CURB RAMP,
- 4. 4" WIDE WHITE STRIPING (TYP.). CONC. PARKING BARRIER CONCRETE HEADER CURB
 - 10. CONC. SIDEWALK, SEE PLANS
 - 11. RUNDOWN OR DEPRESSED RUNDOWN
 - 12. 1/2" EXPANSION MATERIAL.

ADA RESERVED PARKING STALL
NOT TO SCALE

(A1) CURB ACCESS RAMPS

NOT TO SCALE

 $T_{ ext{hompson}} \ E_{ ext{ngineering}}$ $ilde{C}$ onsultants, Inc. tecnm@yahoo.com P.O. BOX 65760 PHONE: (505) 271-2199

ALBUQUERQUE, NM 87 193 FAX: (505) 830-9248

LOCATE POSTS 2'-0" BACK FROM ADJACENT CURBS, UNLESS NOTED OTHERWISE.

NOT TO SCALE

SIGN POST

0.9" DIAM.

∠(NOMINAL)

CIVIL DETAILS

PROJECT NO

REVISION

SHEET NO.

CITY OF ALBUQUERQUE

Planning Department Alan Varela, Director



Mayor Timothy M. Keller

November 28, 2023

David Thompson, PE Thompson Engineering Consultants PO Box 65760 Albuquerque, NM 87193

Re: Roses SouthWest Papers

Not Addressed-Crick Ave SE-Mesa Del Sol

Traffic Circulation Layout

Architect's Stamp TCL Sheets 11-21-23 and C-501 and C-502 10-17-23 (Q16DA5000C)

Dear Mr. Thompson,

The TCL submittal received 11-28-2023 is approved for Building Permit by Transportation. A copy of the stamped and signed plan will be needed for each of the building permit plans. Please keep the original to be used for certification of the site for final C.O. for Transportation.

PO Box 1293

Albuquerque

When the site construction is completed and an inspection for Certificate of Occupancy (C.O.) is requested, use the original City stamped approved TCL for certification. Redline any minor changes and adjustments that were made in the field. A NM registered architect or engineer must stamp, sign, and date the certification TCL along with indicating that the development was built in "substantial compliance" with the TCL. Submit this certification, the TCL, and a completed <u>Drainage and Transportation Information Sheet</u> to the <u>PLNDRS@cabq.gov</u> for log in and evaluation by Transportation.

NM 87103

Once verification of certification is completed and approved, notification will be made to Building Safety to issue Final C.O. To confirm that a final C.O. has been issued, call Building Safety at 924-3690.

www.cabq.gov

Sincerely,

Curtis Cherne, P.E.


Senior Engineer, Planning Dept. Development Review Services

C: File

20' 40'



ARCHITECT/ ENGINEER

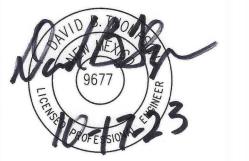

BUILDING PERMIT SET

REVISION DATE

10/16/23

DATE


PROJECT NO

ECT NO

SOLID WASTE PLAN-PHASE 1

SHEET NO.

SOLID-1

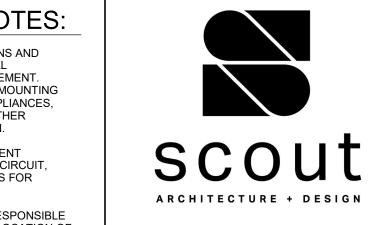

ARCHITECT/ ENGINEER

BG BUILDINGWORKS S y S t e m S f u | f i | e d 303.278.3820 www.bgbuildingworks.com Project No. 10997.00 Copyright 2023 ALBUQUERQUE | AVON | DENVER | FORT COLLINS




100% PERMIT DRAWINGS

10.12.23

ELECTRICAL SITE PLAN

ES101

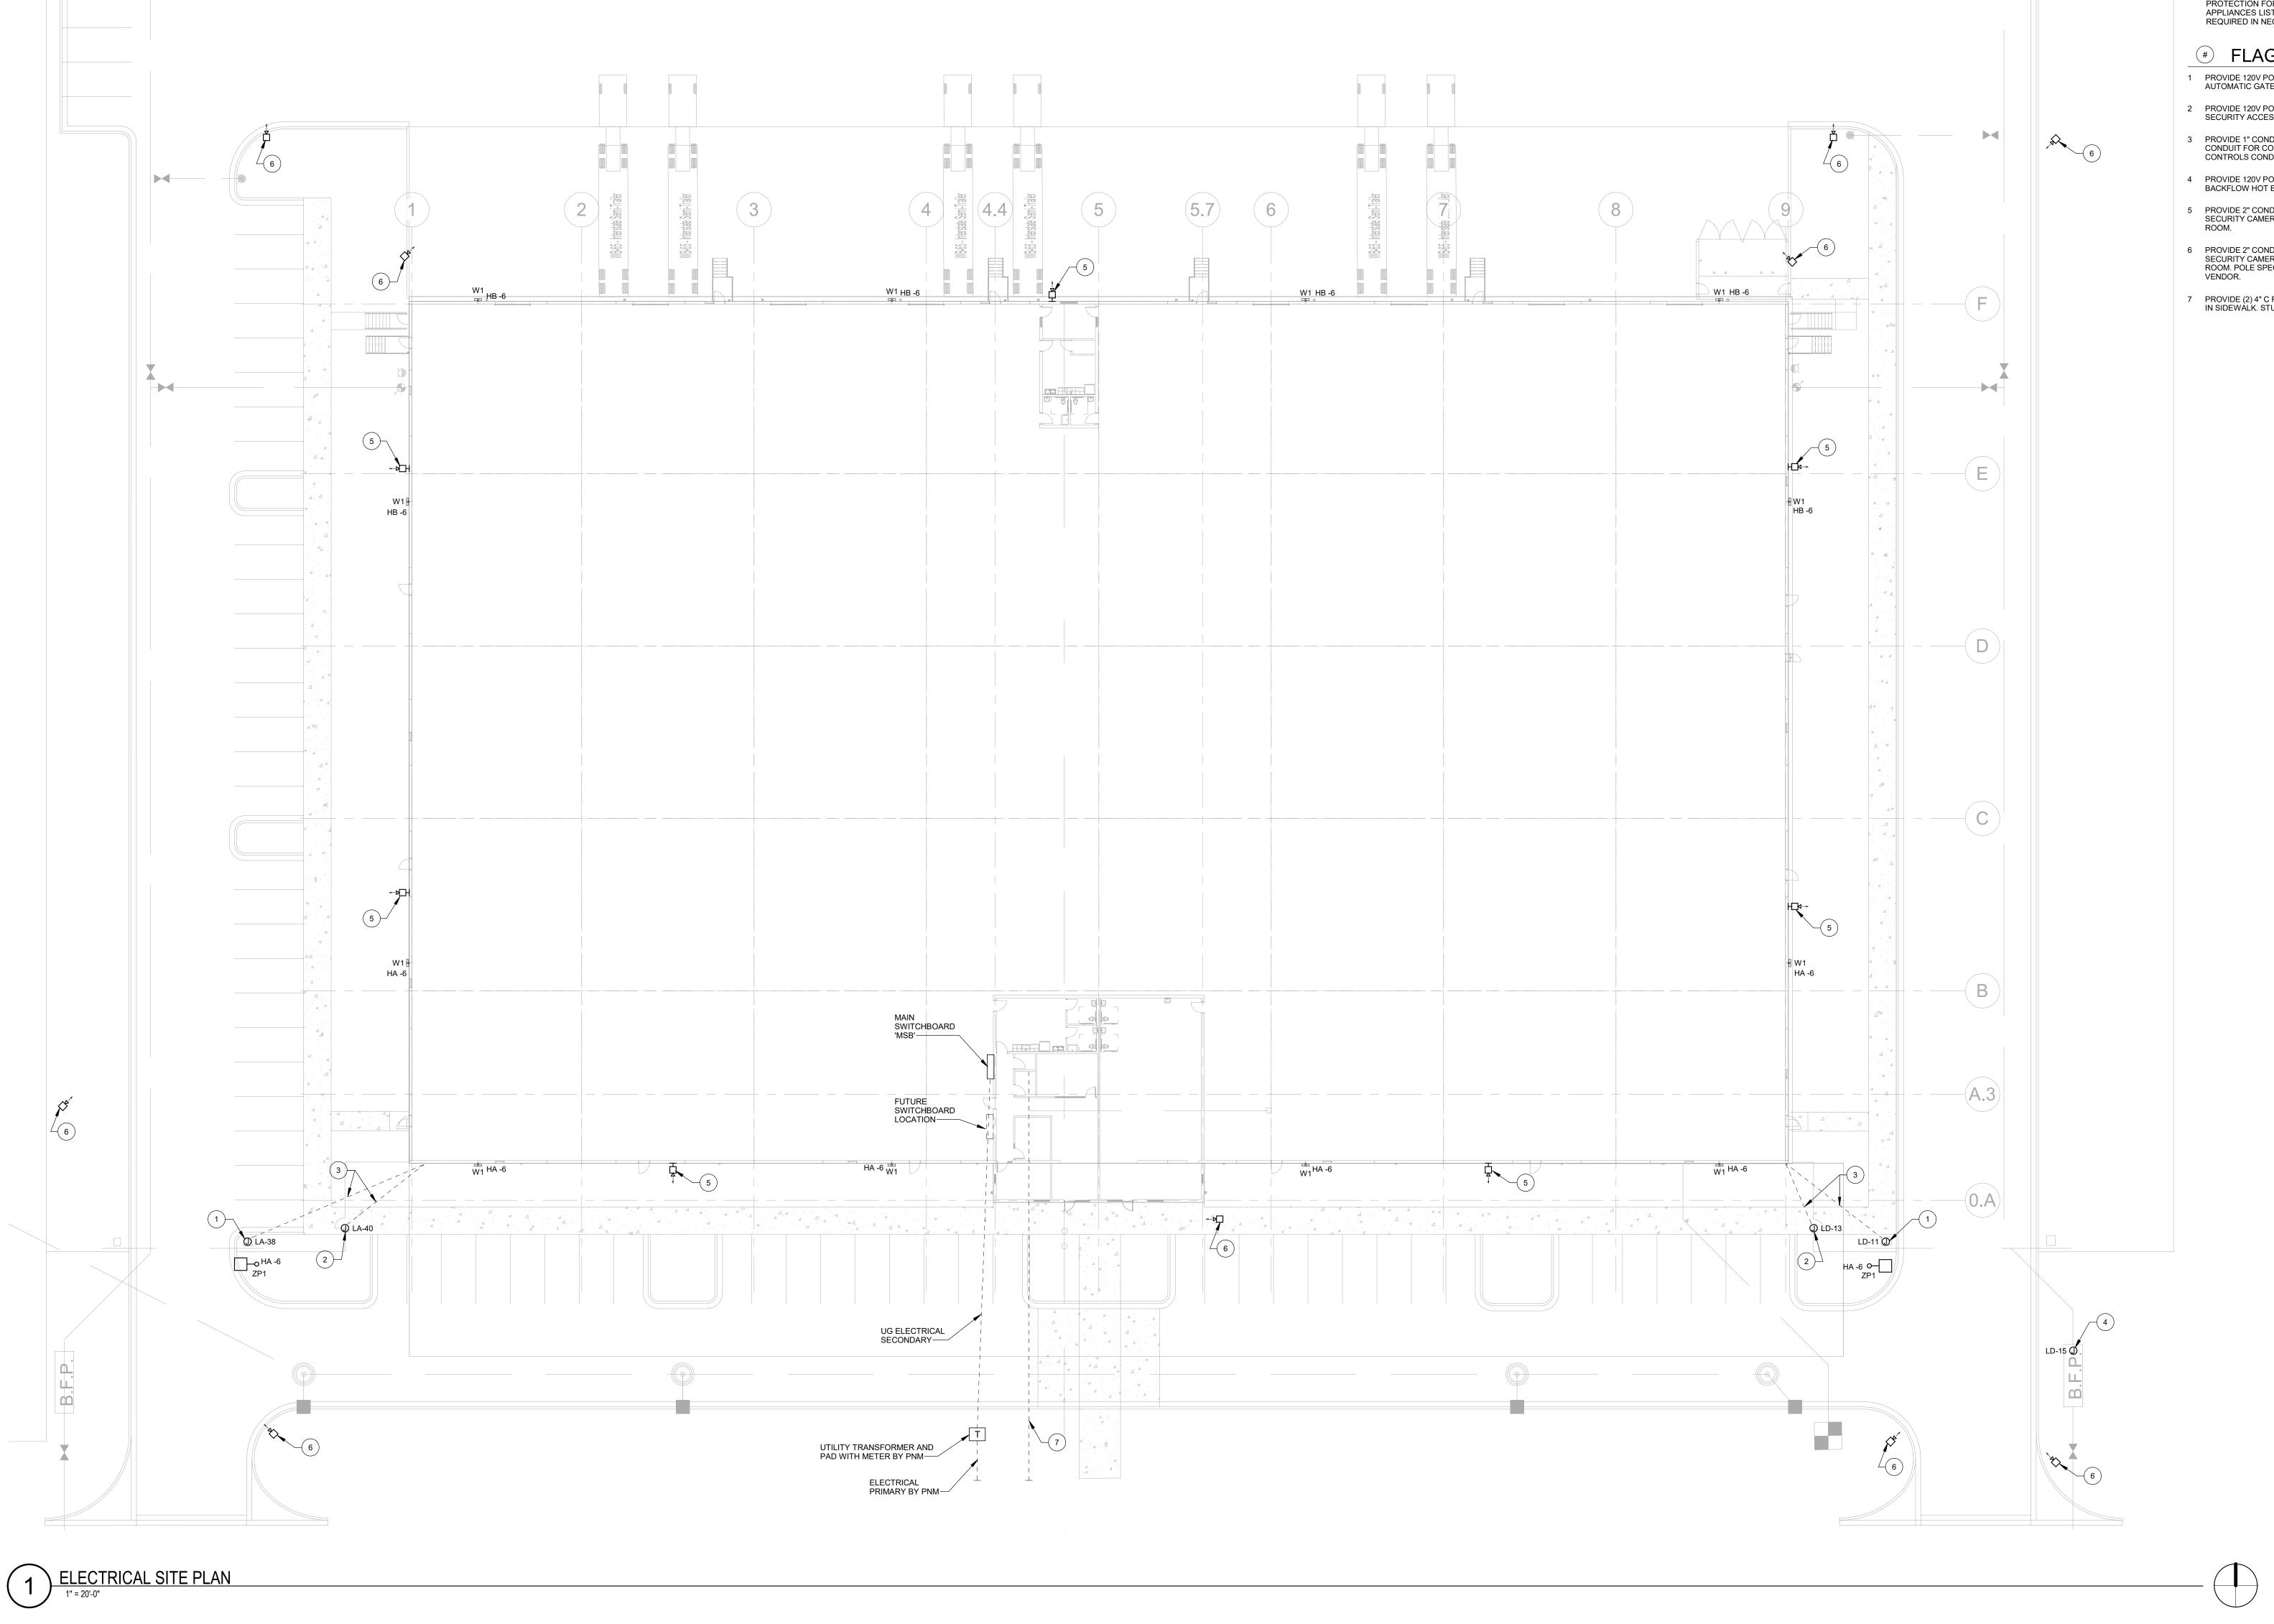

CITY OF ALBUQUERQUE

Planning Department Alan Varela, Director



December 7, 2023

Dave Thompson, P.E. Thompson Engineering Consultants P O Box 65760 Albuquerque, NM 87193

RE: Roses SW Papers

TR D-6 PLAT OF TRACTS D-1 THRU D-7 MESA DEL SOL

INNOVATIONPARK II Grading and Drainage Plan

Engineer's Stamp Date: 11/9/2023 Hydrology File: Q16DA5000C

Dear Mr. Thompson:

Based upon the information provided in your submittal received 11/13/2023, the Grading Plan and Drainage Report are approved for Building Permit. Please attach a copy of this approved plan in the construction sets for Building Permit processing along with a copy of this letter.

PRIOR TO CERTIFICATE OF OCCUPANCY:

Albuquerque

PO Box 1293

1. Engineer's Certification, per the DPM Part 6-14 (F): *Engineer's Certification Checklist For Non-Subdivision* is required.

NM 87103

2. Please provide the executed paper Drainage Covenant (latest revision) printed on one-side only with Exhibit A and a check for \$25.00 made out to "Bernalillo County" for the stormwater quality pond per Article 6-15(C) of the DPM to Hydrology for review.

www.cabq.gov

As a reminder, if the project total area of disturbance (including the staging area and any work within the adjacent Right-of-Way) is 1 acre or more, then an Erosion and Sediment Control (ESC) Plan and Owner's certified Notice of Intent (NOI) is required to be submitted to the Stormwater Quality Engineer (Doug Hughes, PE, jhughes@cabq.gov, 924-3420) 14 days prior to any earth disturbance.

If you have any questions, please contact me at 505-924-3695 or tchen@cabq.gov.

Sincerely,

Tiequan Chen, P.E.

Principal Engineer, Hydrology

Planning Department, Development Review Services



City of Albuquerque

Planning Department

Development & Building Services Division

DRAINAGE AND TRANSPORTATION INFORMATION SHEET (REV 6/2018)

Project Title: Roses SW Papers	Building Permit #:	Hydrology File #: Q16DA5000
DRB#:	EPC#:	Work Order#:
Legal Description: TR D-6 PLAT O	F TRACTS D-1 THRU D-7 ME	SA DEL SOL INNOVATIONPARK II
City Address: Not yet established		
Applicant: Thompson Engineering C Address: PO Box 65760, Albuquero		Contact: Dave Thompson
·		E-mail: tecnm@yahoo.com
		Contact:
Address:		
Phone#:	Fax#:	E-mail:
TYPE OF DEVELOPMENT: PI	LAT (# of lots) RESIDENCE	DRB SITE X ADMIN SITE
IS THIS A RESUBMITTAL? X	YesNo	
DEPARTMENT TRANSPORTATIO	ON <u>X</u> HYDROLOGY/DRAII	NAGE
Check all that Apply: TYPE OF SUBMITTAL:		PPROVAL/ACCEPTANCE SOUGHT: ING PERMIT APPROVAL
ENGINEER/ARCHITECT CERTIFICA		FICATE OF OCCUPANCY
PAD CERTIFICATION CONCEPTUAL G & D PLAN X GRADING PLAN X DRAINAGE REPORT DRAINAGE MASTER PLAN FLOODPLAIN DEVELOPMENT PERI ELEVATION CERTIFICATE CLOMR/LOMR TRAFFIC CIRCULATION LAYOUT TRAFFIC IMPACT STUDY (TIS) STREET LIGHT LAYOUT OTHER (SPECIFY) PRE-DESIGN MEETING?	PRELIM SITE PI SITE PI FINAL MIT APPLIC SIA/ RE FOUND GRADI SO-19 A PAVING GRADI WORK G CLOME	G PERMIT APPROVAL NG/ PAD CERTIFICATION ORDER APPROVAL
DATE SUBMITTED: 11-6-2023	OTHER	(SPECIFY)
COA STAFF:	ELECTRONIC SUBMITTAL RECEIV	/ED:

FEE PAID:_____



BUILDING **PERMIT SET**

DATE REVISION

PROJECT NO

DRIANAGE PLAN -**EXISTING** CONDITIONS

SHEET NO.

Record and Measured Legal Description

TRACT LETTERED D-SIX (D-6), PLAT OF MESA DEL SOL INNOVATION PARK II, AS THE SAME IS SHOWN AND DESIGNATED ON THE PLAT THEREOF RECORDED IN THE REAL PROPERTY RECORDS OF BERNALILLO COUNTY, NEW MEXICO ON DECEMBER 29, 2017, IN PLAT BOOK 2017C, PAGE 159, AS DOCUMENT NO. 2017124120.

Flood Notes

GENERAL NOTES

ARCHITECT BEFORE PROCEEDING.

D. SEE PAGE 1 OF THE PLAT FOR EXCEPTIONS 9-31

A. ALL DIMENSIONS ARE FACE OF CURB UNLESS OTHERWISE NOTED.
B. FIELD VERIFY ALL DIMENSIONS.

C. DO NOT SCALE DRAWINGS, IF DIMENSIONS ARE IN QUESTION, REQUEST CLARIFICATION FROM

BASED UPON SCALING, THIS PROPERTY LIES WITHIN FLOOD ZONE "X" WHICH IS DEFINED AS AN AREA OF MINIMAL FLOOD HAZARD AS DETERMINED BY F.E.M.A. AND SHOWN ON THE FLOOD INSURANCE RATE MAP NO. 35001C0363G, DATED SEPTEMBER 26, 2008.

1,068.70

ACS Monument " 4-Q16 " NAD 1983 CENTRAL ZONE X=1531376.793 * Y=1457837.32 * Z=5298.643 * (NAVD 1988) G-G=0.999664091 | Mapping Angle = -0.12.32.02* U.S. SURVEY FOOT

Benchmark -NAVD 88

MESA DEL SOL

INNOVATION PARK IN

NOT TO SCALE

DEL SOL

INNOVATION

Overlay Zone

NEW MEXICO TIMING ASSOC DRAGWAY

ZONE ATLAS PAGE Q-16-Z

ACS MONUMENT "4-Q16" HAVING AN ELEVATION OF 5298.64.

Easement Notes

(20)(29) 1 EXISTING 10' P.U.E. (8/7/2008, 2008C-175) AND AS SHOWN ON PLAT (12/29/2017, 2017C-159

20 29 2 EXISTING 30' PUBLIC PEDESTRIAN ACCESS EASEMENT (8/7/2008, 2008C-175) AND AS SHOWN ON PLAT AND AS SHOWN ON PLAT (12/29/2017, 2017C-159)

(20) (29) 3 EXISTING 50' PUBLIC ROADWAY EASEMENT (8/7/2008, 2008C-175) AND AS SHOWN ON PLAT (12/29/2017, 2017C-159)

20 29 4 EXISTING 40' PNM TRANSMISSION LINE EASEMENT (8/7/2008, 2008C-175) AND AS SHOWN ON PLAT (12/29/2017, 2017C-159)

(22)(29) 5 EXISTING 10' PNM EASEMENT (10/16/2008, DOC. NO. 2008113343) AND AS SHOWN ON PLAT (12/29/2017, 2017C-159)

(29)(31) 6 EXISTING 30' PERMANENT PRIVATE ACCESS EASEMENT (12/29/2017, 2017C-159) AND AS SHOWN ON PLAT (12/29/2017, 2017C-159) SEE REPAIR AND MAINTENANCE AGREEMENT (2/21/2020, DOC. NO. 2020016464)

(29) 7 EXISTING 20' PRIVATE UTILITY EASEMENT (12/29/2017, 2017C-159) AND AS SHOWN ON PLAT (12/29/2017, 2017C-159)

20 29 8 EXISTING 50' PNM TRANSMISSION LINE EASEMENT (8/7/2008, 2008C-175) AND AS SHOWN ON PLAT (12/29/2017, 2017C-159)

(15) 9 EXISTING NON-EXCLUSIVE ACCESS EASEMENT OVER COMMON AREAS (4/16/2008, AS DOC. NO. 2008043398) AND RESTATED WITHIN DECLARATION OF COVENANTS, CONDITIONS AND RESTRICTIONS FOR MESA DEL SOL (12/28/2010, DOC. NO. 2010132684)

(15) 10 EXISTING PERPETUAL NON-EXCLUSIVE UTILITY ACCESS EASEMENT (4/16/2008, AS DOC. NO. 2008043398) AND RESTATED WITHIN DECLARATION OF COVENANTS, CONDITIONS AND RESTRICTIONS FOR MESA DEL SOL (12/28/2010, DOC. NO. 2010132684)

(15) 11 EXISTING EASEMENT FOR MAINTENANCE, EMERGENCY AND ENFORCEMENT OF UTILITIES AND STRUCTURES (4/16/2008, AS DOC. NO. 2008043398) AND RESTATED WITHIN DECLARATION OF COVENANTS, CONDITIONS AND RESTRICTIONS FOR MESA DEL SOL (12/28/2010, DOC. NO.


(15) 12 EXISTING TEMPORARY CONSTRUCTION EASEMENTS OVER COMMON AREAS FOR INGRESS/EGRESS, SLOPE AND INSTALLATION OF DRAINAGE, WATER, STORM DRAINAGE, SANITARY SEWER AND OTHER UTILITIES AS WELL AS EQUIPMENT, MATERIALS AND SUPPLY STORAGE (4/16/2008, AS DOC. NO. 2008043398) AND RESTATED WITHIN DECLARATION OF COVENANTS, CONDITIONS AND RESTRICTIONS FOR MESA DEL SOL (12/28/2010, DOC. NO. 2010132684)

(15) 13 EXISTING RECIPROCAL, APPURTENANT EASEMENTS OF ENCROACHMENTS, AND MAINTENANCE USE OF ALL PERMITTED ENCROACHMENTS (4/16/2008, AS DOC. NO. 2008043398) AND RESTATED WITHIN DECLARATION OF COVENANTS, CONDITIONS AND RESTRICTIONS FOR MÉSA DEL SOL (12/28/2010, DOC. NO. 2010132684)


(15) 14 EXISTING RECIPROCAL, APPURTENANT EASEMENTS OVER, UNDER, ACROSS AND BETWEEN PARCELS AND COMMON AREAS FOR THE INSTALLATION AND MAINTENANCE OF FOOTINGS, FOUNDATION SUPPORT SYSTEMS, SHEETING ETC. (4/16/2008, AS DOC. NO. 2008043398) AND RESTATED WITHIN DECLARATION OF COVENANTS, CONDITIONS AND RESTRICTIONS FOR MESA DEL SOL (12/28/2010, DOC. NO. 2010132684)

(15) 15 EXISTING RECIPROCAL APPURTENANT EASEMENT OVER AND BETWEEN PARCELS AND COMMON AREAS FOR THE USE OF AIR SPACE (4/16/2008, AS DOC. NO. 2008043398) AND RESTATED WITHIN DECLARATION OF COVENANTS, CONDITIONS AND RESTRICTIONS FOR MÉSA DEL SOL (12/28/2010, DOC. NO. 2010132684)

(15) 16 EXISTING SIGHTLINE EASEMENT FOR THE PURPOSE OF PRESERVING OR PROTECTING VIEWS FROM OR TO PARTICULAR PARCELS (4/16/2008, AS DOC. NO. 2008043398) AND RESTATED WITHIN DECLARATION OF COVENANTS, CONDITIONS AND RESTRICTIONS FOR MESA DEL SOL (12/28/2010, DOC. NO. 2010132684)

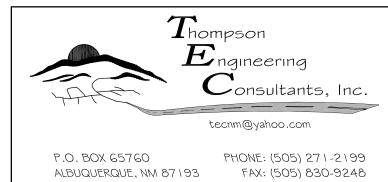

DRAINAGE PLAN - EXISTING CONDITIONS SCALE: 1" = 80-0"

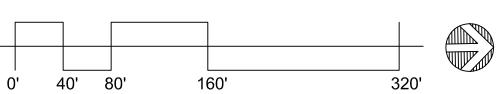

5293~

THE PURPOSE OF THIS DRAINAGE PLAN IS TO PRESENT THE EXISTING AND PROPOSED DRAINAGE CONDITIONS FOR THE PROPOSED ROSES SOUTHWEST PAPERS PROJECT. THE NEW BUILDING IS LOCATED ON CRICK CROSSING SW, IN MESA DEL SOL, IN SOUTHWEST ALBUQUERQUE. THE ZONE ATLAS PAGE FOR THE

II. SITE DESCRIPTION AND HISTORY

THE PROJECT SITE IS LOCATED ON THE NORTH SIDE OF CRICK CROSSING SW. WEST OF HAWKING DRIVE SW, IN MESA DEL SOL THE SITE IS CURRENTLY VACANT. PROPERTIES TO THE EAST AND NORTH HAVE BEEN DEVELOPED AND CONTAIN STORMWATER MANAGEMENT PONDS TO CONTROL RUNOFF. THE MESA DEL SOL COMMUNITY MASTER PLAN REQUIRES THAT ALL PARCELS CONTAIN THE 100 YEAR STORM RUNOFF EVENT IN RETENTION PONDS.

III. COMPUTATIONAL PROCEDURES

HYDROLOGIC ANALYSIS WAS PERFORMED UTILIZING THE DESIGN CRITERIA BASED ON CHAPTER 6, HYDROLOGY, OF THE DEVELOPMENT PROCESS MANUAL RELEASED 2020. TABLES WITHIN CHAPTER 6, WERE USED TO AID IN THE STUDY OF THE SITE

IV. PRECIPITATION

THE STORM EVENT USED FOR THE FOLLOWING CALCULATIONS IS THE 100YR-24HR STORM. THE PROJECT SITE IS LOCATED IN ZONE 3 (EAST OF RIO GRANDE, SOUTH OF I40 AND WITHIN TOWNSHIP 4E).

V. EXISTING DRAINAGE CONDITIONS

THE SITE IS CURRENTLY UNDEVELOPED. THE SITE TO THE EAST IS FULLY DEVELOPED. THE SITE IS BOUNDED ON THE NORTH BY A PRIVATE DRIVE THAT IS UTILIZED BY KAIROS POWER FOR ACCESS. THE SITE IS BOUNDED ON THE SOUTH BY CRICK CROSSING THAT HAS THE NORTH HALF STREET SECTION DEVELOPED. NO RUNOFF FROM ADJACENT SITES IS ANTICIPATED.

THE SITE GENERALLY DRAINS FROM EAST TO WEST BUT HAS VERY LITTLE SLOPE. A MAJORITY OF EXCESS RUNOFF WOULD CURRENTLY BE CAUGHT IN LOCAL DEPRESSION AND ALLOWED TO SOAK INTO THE GROUND. INFILTRATION RATES WERE MEASURED BY THE GEOTECHNICAL ENGINEER AT 6" PER HOUR.

CRICK CROSSING CONTAINS PUBLIC STORMWATER COLLECTION AND CONVEYANCE PIPING BUT DISCHARGE INTO THE SYSTEM IF LIMITED TO THE ROADWAY AND MINOR DISCHARGE AT DRIVEWAYS. AS MENTIONED IN THE SITE DESCRIPTION AND HISTORY PORTION, THE MASTER PLAN FOR MESA DEL SOL REQUIRES THAT ALL PARCELS PROVIDE FULL RETENTION OF EXCESS FOR OFF FOR THE 100 YEAR - 24 HOUR STORM RUNOFF EVENT (PROVIDED INFILTRATION WILL DRAIN THE POND PRIOR TO THE NEXT STORM EVENT).

VI. PROPOSED DRAINAGE CONDITIONS

THE NEW BUILDING WILL BE 100,600 SF WAREHOUSE/MANUFACTURING BUILDING. THE FRONT AND SIDES WILL BE GENERALLY AT GRADE TO ALLOW FOR EASY ACCESS FOR PEDESTRIANS, AND DUE TO NFPA REQUIRING ACCESS DOORS AT 100' INTERVALS. THE NORTH SIDE OF THE BUILDING WILL BE A LOADING DOCK, SO THERE WILL BE A 4' DROP FROM FINISHED FLOOR TO DOCK GRADE.

THE SITE FOR PHASE 1 ALL DRAINS TO THE RETENTION POND ON THE WEST SIDE OF THE SITE. THE ROOF WILL DRAIN BOTH NORTH AND SOUTH. 60% OF THE ROOF WILL DRAIN TO THE DOCK SIDE. ALONG THE SOUTH SIDE OF THE SITE IN THE PARKING AREA, CATCH BASINS WILL COLLECT RUNOFF AND CONVEY STORM WATER TO THE RETENTION POND. CATCH BASINS HAVE BEEN SET AT CLOSE AS POSSIBLE TO THE DRIVEWAYS TO CAPTURE STORM RUNOFF. A SMALL AREA AT EACH DRIVEWAY WILL SPILL OUT INTO CRICK CROSSING AND WILL BE COLLECTED IN THE SUMP CONDITION TYPE A CATCH BASIN NEAR THE EASTERN ENTRANCE DRIVE. THE INCREASE TO THE STREET RUNOFF IS LESS THAN 2,000 SF AND THEREFORE LESS THAN 0.1 CFS. THIS IS A NEGLIGIBLE INCREASE. AN 18" HDPE STORM PIPE WILL CONVEY THE STORM RUNOFF FROM THE FOUR CATCH BASINS TO THE RETENTION POND.

APPROXIMATELY 25% OF BASIN PRO #1 FLOWS TO THE SOUTH TO THE CATCH BASINS. THERE ARE A TOTAL OF FOUR CATCH BASINS AND PER FIGURE 6.9.9 THE CAPACITY OF EACH TYPE "C" INLET FLOWING AT A MAXIMUM OF 0.5' DEEP (AND 1% SLOPE GOING TOWARD INLET ALONG CURB LINE) THE COLLECTION RATE IS APPROXIMATELY 6.6 CFS. WITH THE REQUIRED COLLECTION OF 8 CFS (25% OF 39.61 CFS) ONLY TWO INLETS WOULD BE REQUIRED. FOUR INLETS WILL ELIMINATE THE BYPASS OUT INTO THE PUBLIC STREET VIA THE DRIVEWAYS, EXCEPT FOR WHAT RAIN FALLS BEYOND THE CATCH BASINS.

NORTHERN (60% OF ROOF) ROOF RUNOFF WILL BE COLLECTED IN INTERNAL ROOF DRAINS AND ROUTED INTERNALLY TO DISCHARGE THROUGH THE 4' TALL STEM WALL AT THE LOADING DOCK. FROM THERE THE RUNOFF WILL SHEET FLOW OVER TO A SERIES OF SUMP CONDITION MEDIAN TYPE CATCH BASINS. HDPE STORM PIPES WILL CONVEY RUNOFF TO THE POND.

THERE ARE A TOTAL OF 3 TYPE "D" (MEDIAN TYPE) CATCH BASINS LOCATED IN THE TRUCK DOCK AREA. EACH AREA LOCATED IN A SUMP CONDITION WITH A MAXIMUM DEPTH OF 0.90'. BEYOND THAT DEPTH, THE WATER OVERTOPS FROM ONE CATCH BASIN TO THE NEXT AND FLOW WEST TOWARD THE RETENTION POND.

THE WEIR EQUATION (Q=CLH³₂) WAS USED TO EVALUATE THE CAPACITY OF THE TYPE "D" CATCH BASINS. THE GRATE PERIMETER IS (25"X40") = 10.83'. AT A MAXIMUM DEPTH OF 0.90' THE CAPACITY OF THE INLET IS $(Q=2.7*10.83!*.9^{\frac{2}{3}}) = 24.9 \text{ CFS}.$ THE FUTURE PHASE 2 WILL DOUBLE THE REQUIRED FLOW RATE OF THE BASIN CONTRIBUTING TO THE LINE OF TYPE "D" CATCH BASINS. THE TOTAL RUNOFF TO BE COLLECTED IN THIS SYSTEM WILL BE = 32.4 CFS (AFTER PHASE 2 IS CONSTRUCTED, AND ONLY 16.64 IN THIS PHASE, SEE NORTH SUB BASIN COMPUTATIONS). THE THREE INLETS WILL HAVE CAPACITY OF 74.7 CFS. PIPES HAVE BEEN SIZED TO KEEP THE ENERGY GRADE LINE BELOW GRADE.

CONVEYANCE PIPING WILL START WITH 18" HDPE AND BE UP-SIZED TO 30" HDPE AT THE SECOND CATCH BASIN, AND 36" HDPE AT THE THIRD INLET TO BE ABLE TO CONVEY THE EXCESS STORM RUNOFF TO THE RETENTION POND. THE ENERGY GRADE LINE WILL REMAIN BELOW THE SURFACE AT ALL INLETS.

INFILTRATION WAS CONFIRMED BY THE GEOTECHNICAL ENGINEER AS 6" PER HOUR. THE EXCESS RUNOFF FROM THE 100 YEAR 6 HOUR EVENT IS 39.61 CFS. THE RUNOFF VOLUME AS REQUIRED BY THE MESA DEL SOL COMMUNITY MASTERPLAN IS 2.1 ACRE-FEET FOR THE 100 YEAR - 24 HOUR EVENT. THE PROPOSED POND IS 3.0' DEEP TO THE MWSEL (PLUS OVER 2 OF FREEBOARD) . THE INFILTRATION OF 6" PER HOUR (4.16 CFS) WOULD REQUIRED OVER 11.2 HOURS TO SOAK IN COMPLETELY. THEREFORE THE POND HAS BEEN SIZED TO CONTAIN SINGLE 100 YEAR. THE EXCESS RUNOFF VOLUME ENTERING THE POND IS 2.1 ACRE FEET.

VII. CONCLUSIONS


THE SITE HAS BEEN DESIGNED TO COLLECT AND CONVEY THE 100-YEAR, 6-HOUR PEAK RUNOFF RATE OF 39.61 CFS. THE FULL RETENTION POND AS REQUIRED BY THE MESA DEL SOL COMMUNITY MASTER PLAN HAS BEEN SIZED TO FULL CONTAIN SINGLE 100-YEAR EVENT SINCE THE INFILTRATION RATE IS 6" PER HOUR AND WILL BE FULLY ABSORBED PRIOR TO THE NEXT POTENTIAL MONSOON EVENT.

FUTURE PHASES WILL REQUIRE THE EXPANSION OF THE STORM POND. COMPUTATIONS HAVE BEEN INCLUDED FOR THE FULL BUILDOUT AS CURRENTLY PLANNED, AND THE FULL RETENTION POND CAN EASILY BE ACCOMMODATED.

Pond Routing and Vo	olumes	Full Buildout Pl	nase 1
Incoming Flow Rate	Qin	94.93	39.61 cfs
Allowable Discharge Rate	Qout	3.5	4 .19 cfs
Hyrdology Zone		3	3 per Figure A-
Area Total	At	23.792	10.181 acres
Area Type A	Aa	0	0 %
Area Type B	Ab	25	30 %
Area Type C	Ac	0	0 %
Area Type D Impervious	Ad	75	70 %
Excess runoff rates	Α	0.67	0.67
	В	0.86	0.86
	С	1.09	1.09
	D	2.58	2.58
Weighted E (Exces Runoff)		2.15	2.06
Time of Concentration		0.2	0.2 hours
Time to Peak =0.7*Tc + ((1.6-(Ad/At)/12)		0.211	0.215 hours
Time of Base =2.107*E*At/Qp-(.25*Ad/At)		0.948	0.943 hours
Duration of Peak		0.188	0.175 hours
Time for end of peak		0.398	0.390 hours
Time when storage begins		0.008	0.023 hours
Time incoming is less that discharge		0.928	0.884 hours
Volume Required during storm	acre-inch	50.926	18.648 acre inch
Volume Required during storm	cf	184,862	67,691 cubic feet
Volume Stored in Pond during storm	cf	220,780	70,825 cubic feet

TABLE	6.2.7 Precipitation Zones									
Zone	ocation									
1	West of the Rio Grande									
2										
3	Between San Mateo and Eubank, North of Interstate 40 and between San Mateo and the East boundary of Range 4 East, South of Interstate 40									
4 East of Eubank, North of Interstate 40 and East of the East boundary of Range 4 East, South of Interstate 40										
	Not including the Cibola National Forest									

Infiltration Rates		
Per GeoMAT Report Perc Rate	6" per hour	inches per hour
	.5 ft / hour	ft/ hour
	0.0001389	ft/sec
Pond area	29,931	sf
Infiltration Flow Rate	4.16	cfs

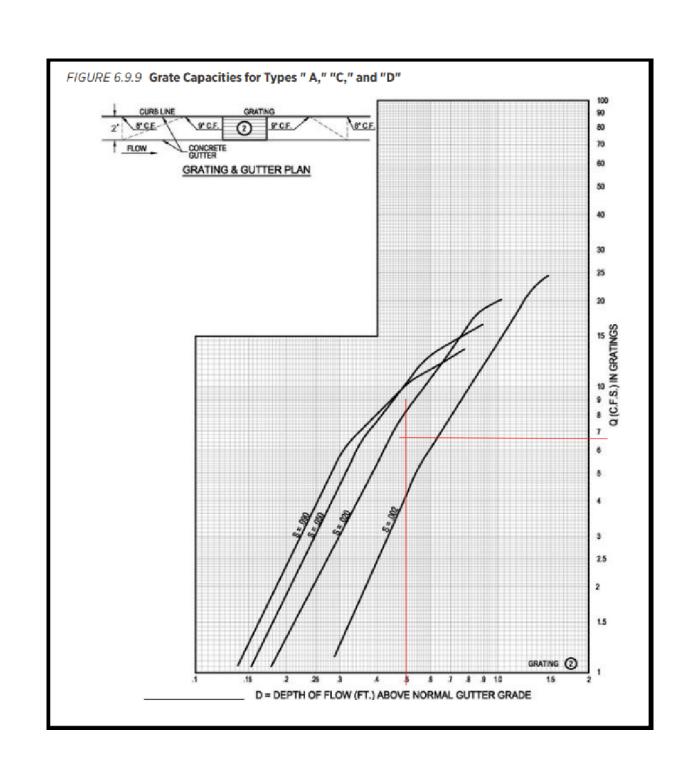

	Drainage Summary	City of Albuquerque
Project: Project Numbe: Date: By:	Roses Southwest Papers TEC Roses SW Papers 09/16/23 MTD	Planning Department Development Review Services HYDROLOGY SECTION APPROVED 12/7/2023 BY: Tiegre Che
Site Location Precipitaion Zone Existing summary	3 Per COA DPM Chapter 6	HydroTrans # R16DA5000C THE APPROVAL OF THESE PLANS/REPORT SHALL NOT BE CONSTRUED TO PERMIT VIOLATIONS OF ANY CITY ORDINANCE OR STATE LAW, AND SHALL NOT PREVENT THE CITY OF ALBUQUERQUE FROM REQUIRING CORRECTION, OR ERROR OR DIMENSIONS IN PLANS, SPECIFICATIONS, OR CONSTRUCTIONS, SUCH APPROVED PLANS SHALL NOT BE CHANGED, MODIFIED OR ALTERED WITHOUT AUTHORIZATION.
Basin Name	Ex Basin 1	APPROVAL OF GRADING & DRAINAGE PLAN(S) SHALL EXPIRE
Area (sf)	1036392.4	TWO (2) YEARS AFTER THE APPROAL DATE BY THE CITY IF NO BUILDING PERMIT HAS BEEN PULLED ON THE DEVELOPMENT.
Area (acres)	23.79	

Proposed summary

Wter Quality Acre Feet

Area "A"

Area "B" Area "C"

Area "D"

100yr. 6hr.

10yr. 6hr.

2yr. 6hr.

100 yr.

10yr.

100yr. 24hr.

Peak Discharge (cfs)

%A Land treatment

%B Land treatment

%C Land treatment %D Land treatment

Soil Treatment (acres)

Excess Runoff (acre-feet)

Froposed Summary				
Basin Name	Overall Site	Phase 1	North SubBasin	
Area (sf)	1036392.4	443500	168977.5	
Area (acres)	23.792	10.181	3.879	
%A Land treatment				
%B Land treatment	25	30	10	
%C Land treatment				
%D Land treatment	75	70	90	
Soil Treatment (acres)				
Area "A"	0.00	0.00	0.00	
Area "B"	5.95	3.05	0.39	
Area "C"	0.00	0.00	0.00	
Area "D"	17.84	7.13	3.49	
Excess Runoff (acre-feet)				
100yr. 6hr.	4.2628	1.7512	0.7784	acre-
10yr. 6hr.	2.6072	1.0606	0.4881	acre-
2yr. 6hr.	1.5862	0.6363	0.3071	acre-
100yr. 24hr.	5.1342	2.0992	0.9489	acre-
100yr, 10day	6.7461	2.7430	1.2643	acre-
Peak Discharge (cfs)				
100 yr.	94.93	39.61	16.64	cfs
10yr.	56.51	23.29	10.23	cfs
2yr.	31.76	12.79	6.10	cfs
W (0 11 D 11 V) (0	00000	0700.4	4000.0	
Water Quality Ponding Voulme (cf)	22023.3	8796.1	4308.9 d	T

0.5056

80

0.00

19.03

4.76

0.00

1.7963

0.7455

0.1546

1.7963

62.48

28.41

6.23

acre-ft.

acre-ft.

acre-ft.

acre-ft.

cfs

cfs

cfs

HYDRAULIC GRADELINE CALCULATIONS STORM LINE ON LOADING DOCK SIDE

Roses Southwest Papers

0.2019

LINE:	Loading Dock																		
1	2	3	4	5	6	7	8	9	10		13	14		15	16	19	20	21	22
											LOSSES								
STATION	STRUCT	D	Q	A	V	K	Sf	L	DELTA	Q	hf	hb	Aavg	hj	hmh	SUM	E.G.	hv	H.G.
		Inches															5285.40	1.50	5285.40
1+00.00	POND																5287.23	0.33	5286.90
		36	32.44	7.069	4.589	667	0.002	90			0.21					0.21	5287.44	0.33	5286.90
1+60.00	MH #1								10	0.00		0.02	7.07	0.00	0.02	0.04	5287.48	0.33	5287.11
		36	32.44	7.069	4.589	667	0.002	78			0.18					0.18	5287.66	0.33	5287.15
3+38.00	CB #1								0	10.81		0.00	5.99	0.28	0.00	0.28	5287.94	0.33	5287.34
		30	21.63	4.909	4.406	410	0.003	210			0.58					0.58	5288.52	0.30	5287.61
5+48.00	CB #2									10.81		0.00	2.45	0.73	0.00	0.73	5289.26	0.30	5288.22
		18	10.81	1.767	6.119	105	0.011	210			2.23					2.23	5291.48	0.58	5288.96
7+58.00	CB #3									10.81		0.00	2.45	0.00	0.02	0.02	5291.50	0.58	5290.90

0.0989 acre-ft

 $T_{
m hompson}$ $oldsymbol{E}$ ngineering Consultants, Inc. tecnm@yahoo.com P.O. BOX 65760 PHONE: (505) 27 1-2199 ALBUQUERQUE, NM 87 193 FAX: (505) 830-9248

BY: DAA

DATE: REVISED 9-27-23

ARCHITECTURE + DESIGN

ARCHITECT/ ENGINEER



BUILDING PERMIT SET


10/16/23

DATE REVISION


PROJECT NO

SITE DRAINAGE PLAN -NARRATIVE AND CALCULATIONS

SHEET NO.

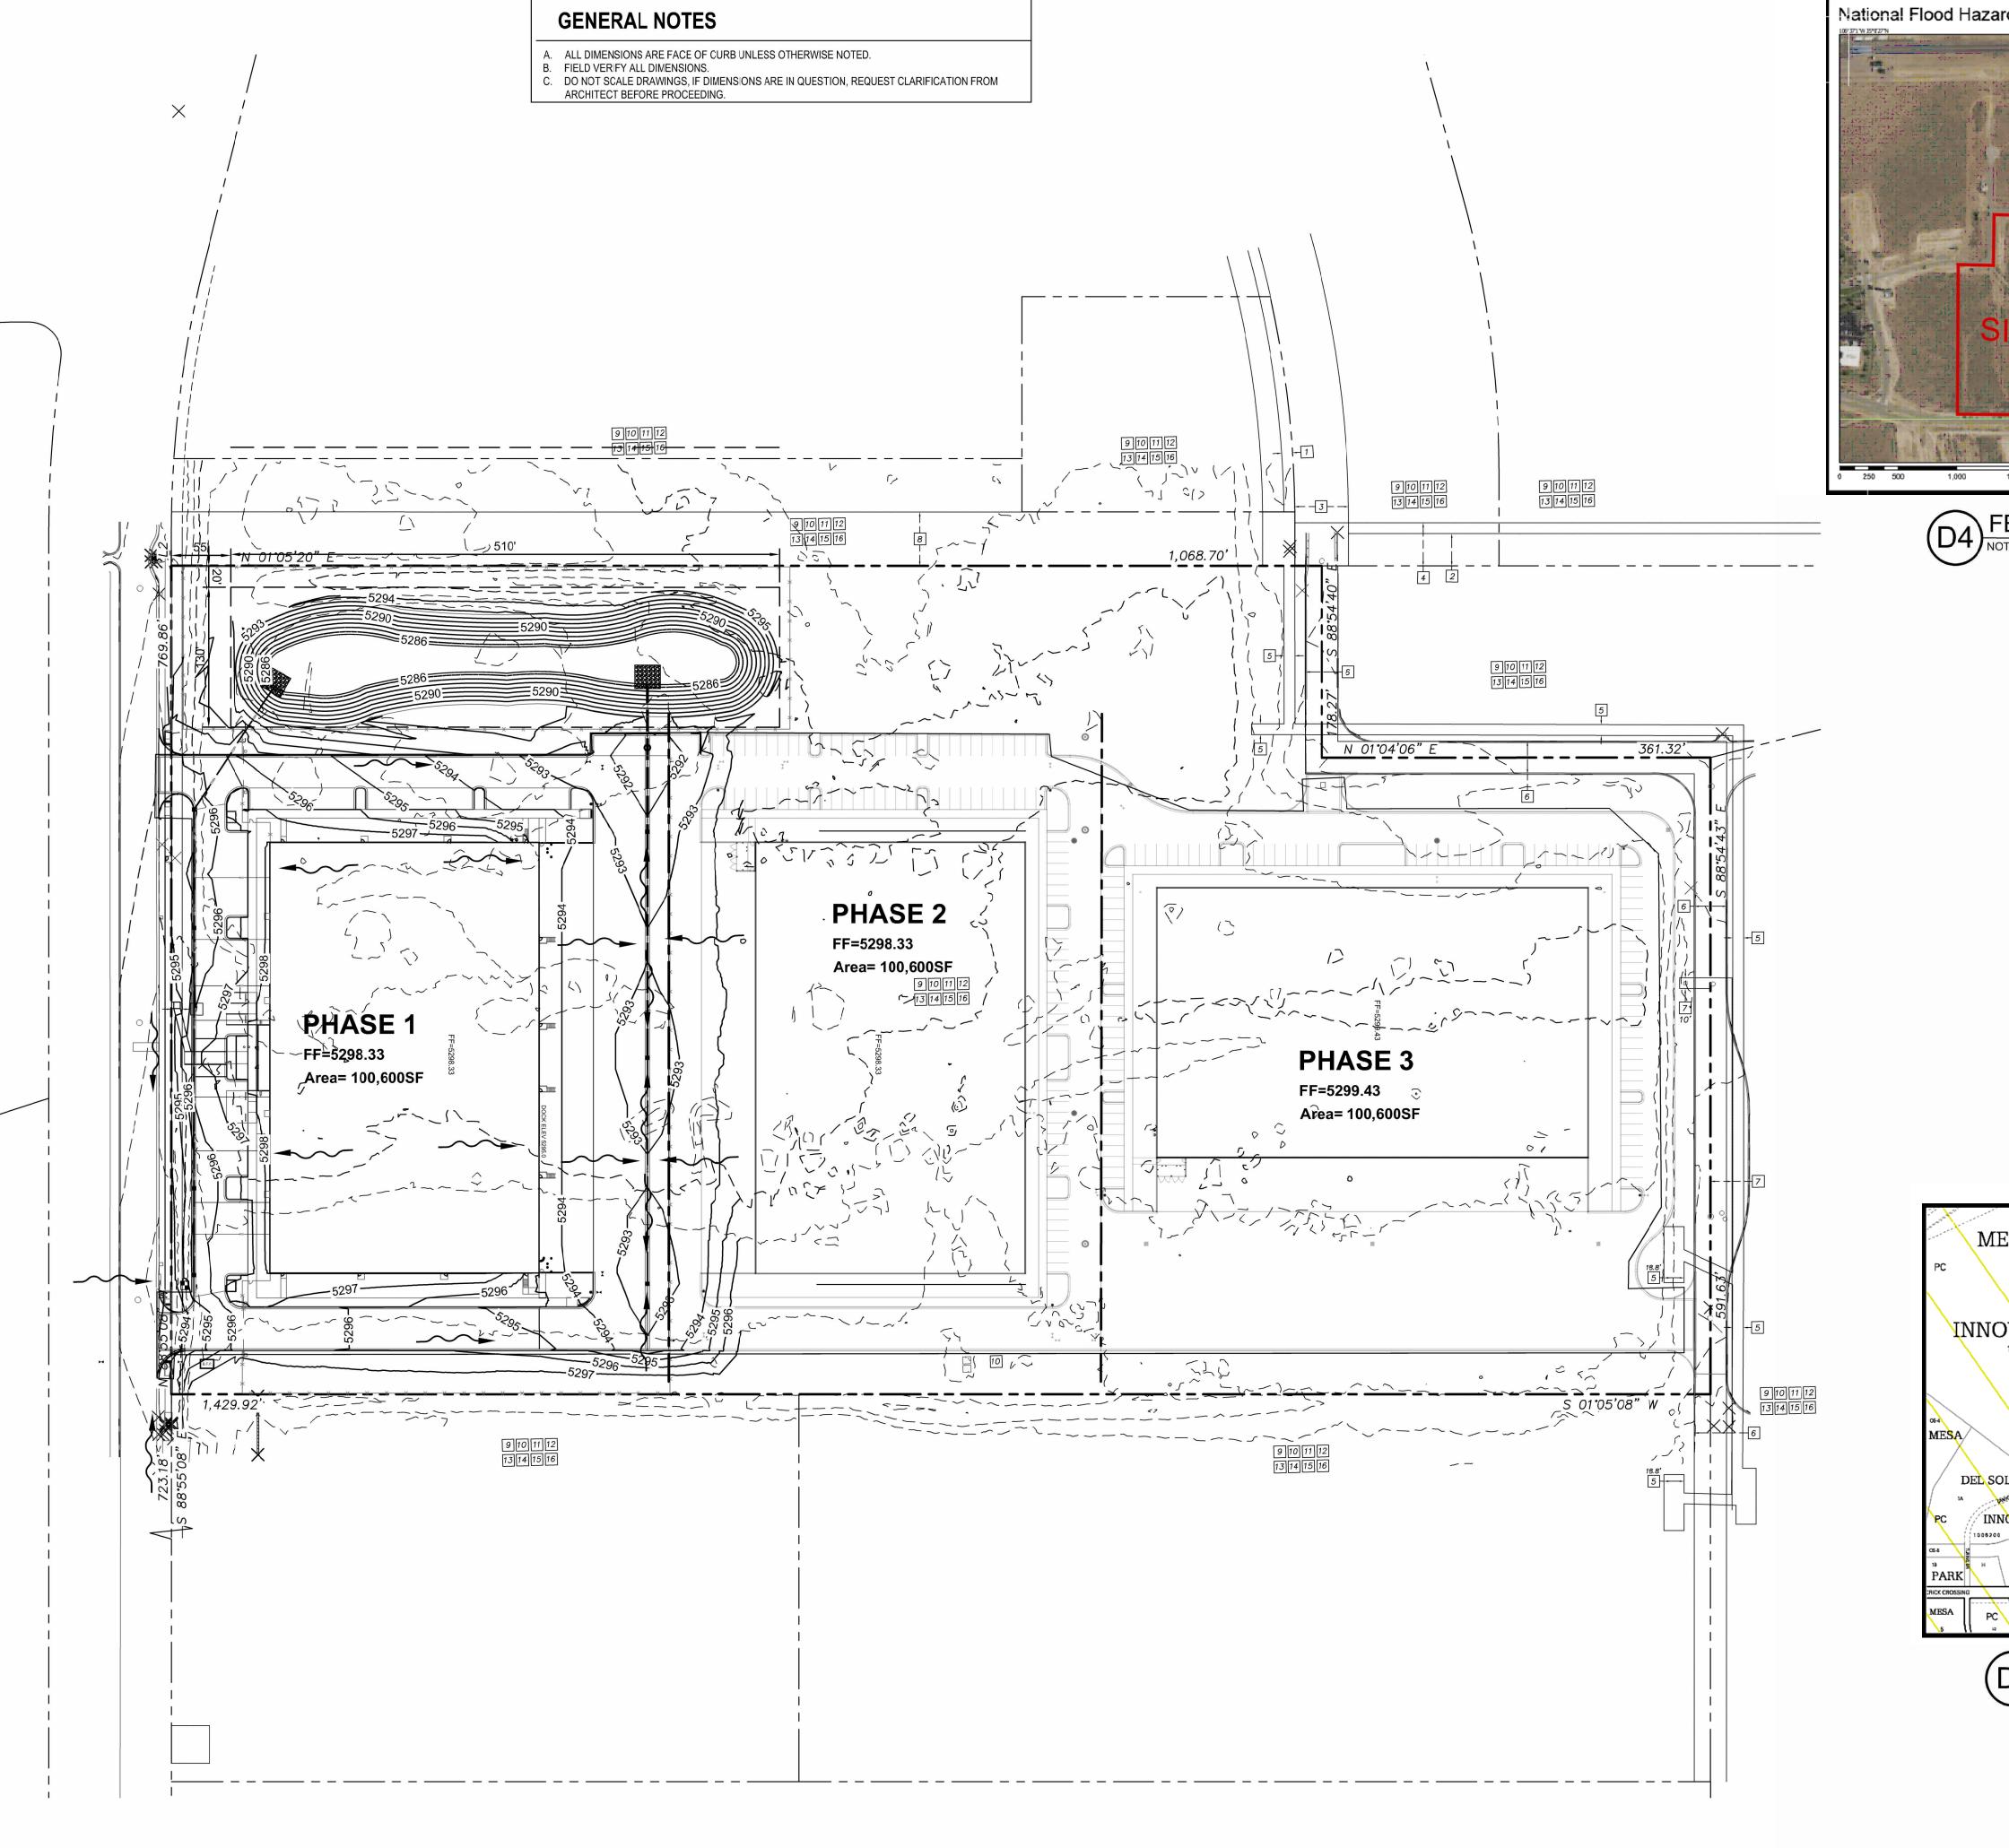


0' 40' 80'

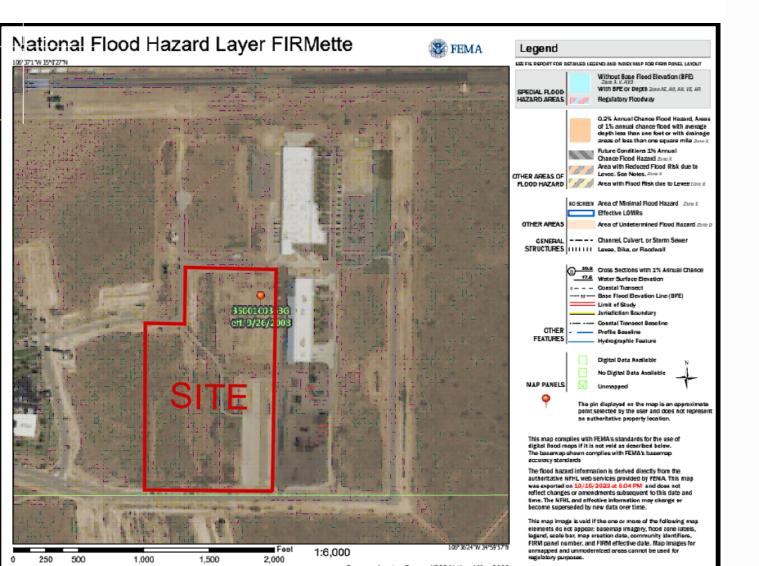


FEMA FIRMETTE

NOT TO SCALE

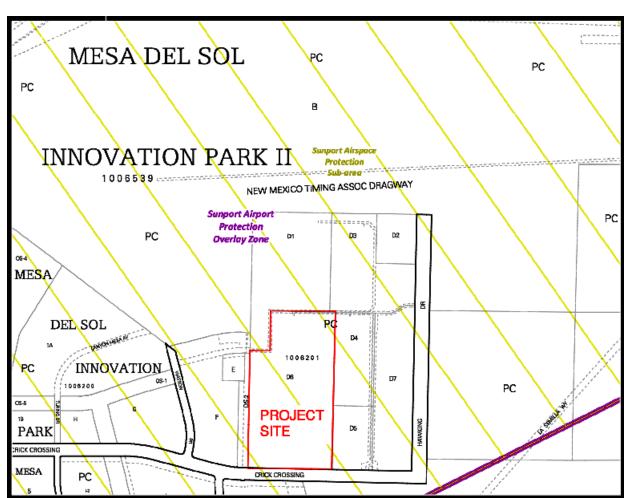

D1) ZONE ATLAS PAGE Q-16-Z

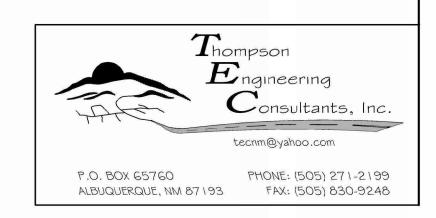

ARCHITECTURE + DESIGN

ARCHITECT/ ENGINEER



BUILDING PERMIT SET


DATE REVISION

PROJECT NO

DRIANAGE PLAN -OVERALL

SHEET NO.

DRAINAGE PLAN - OVERALL

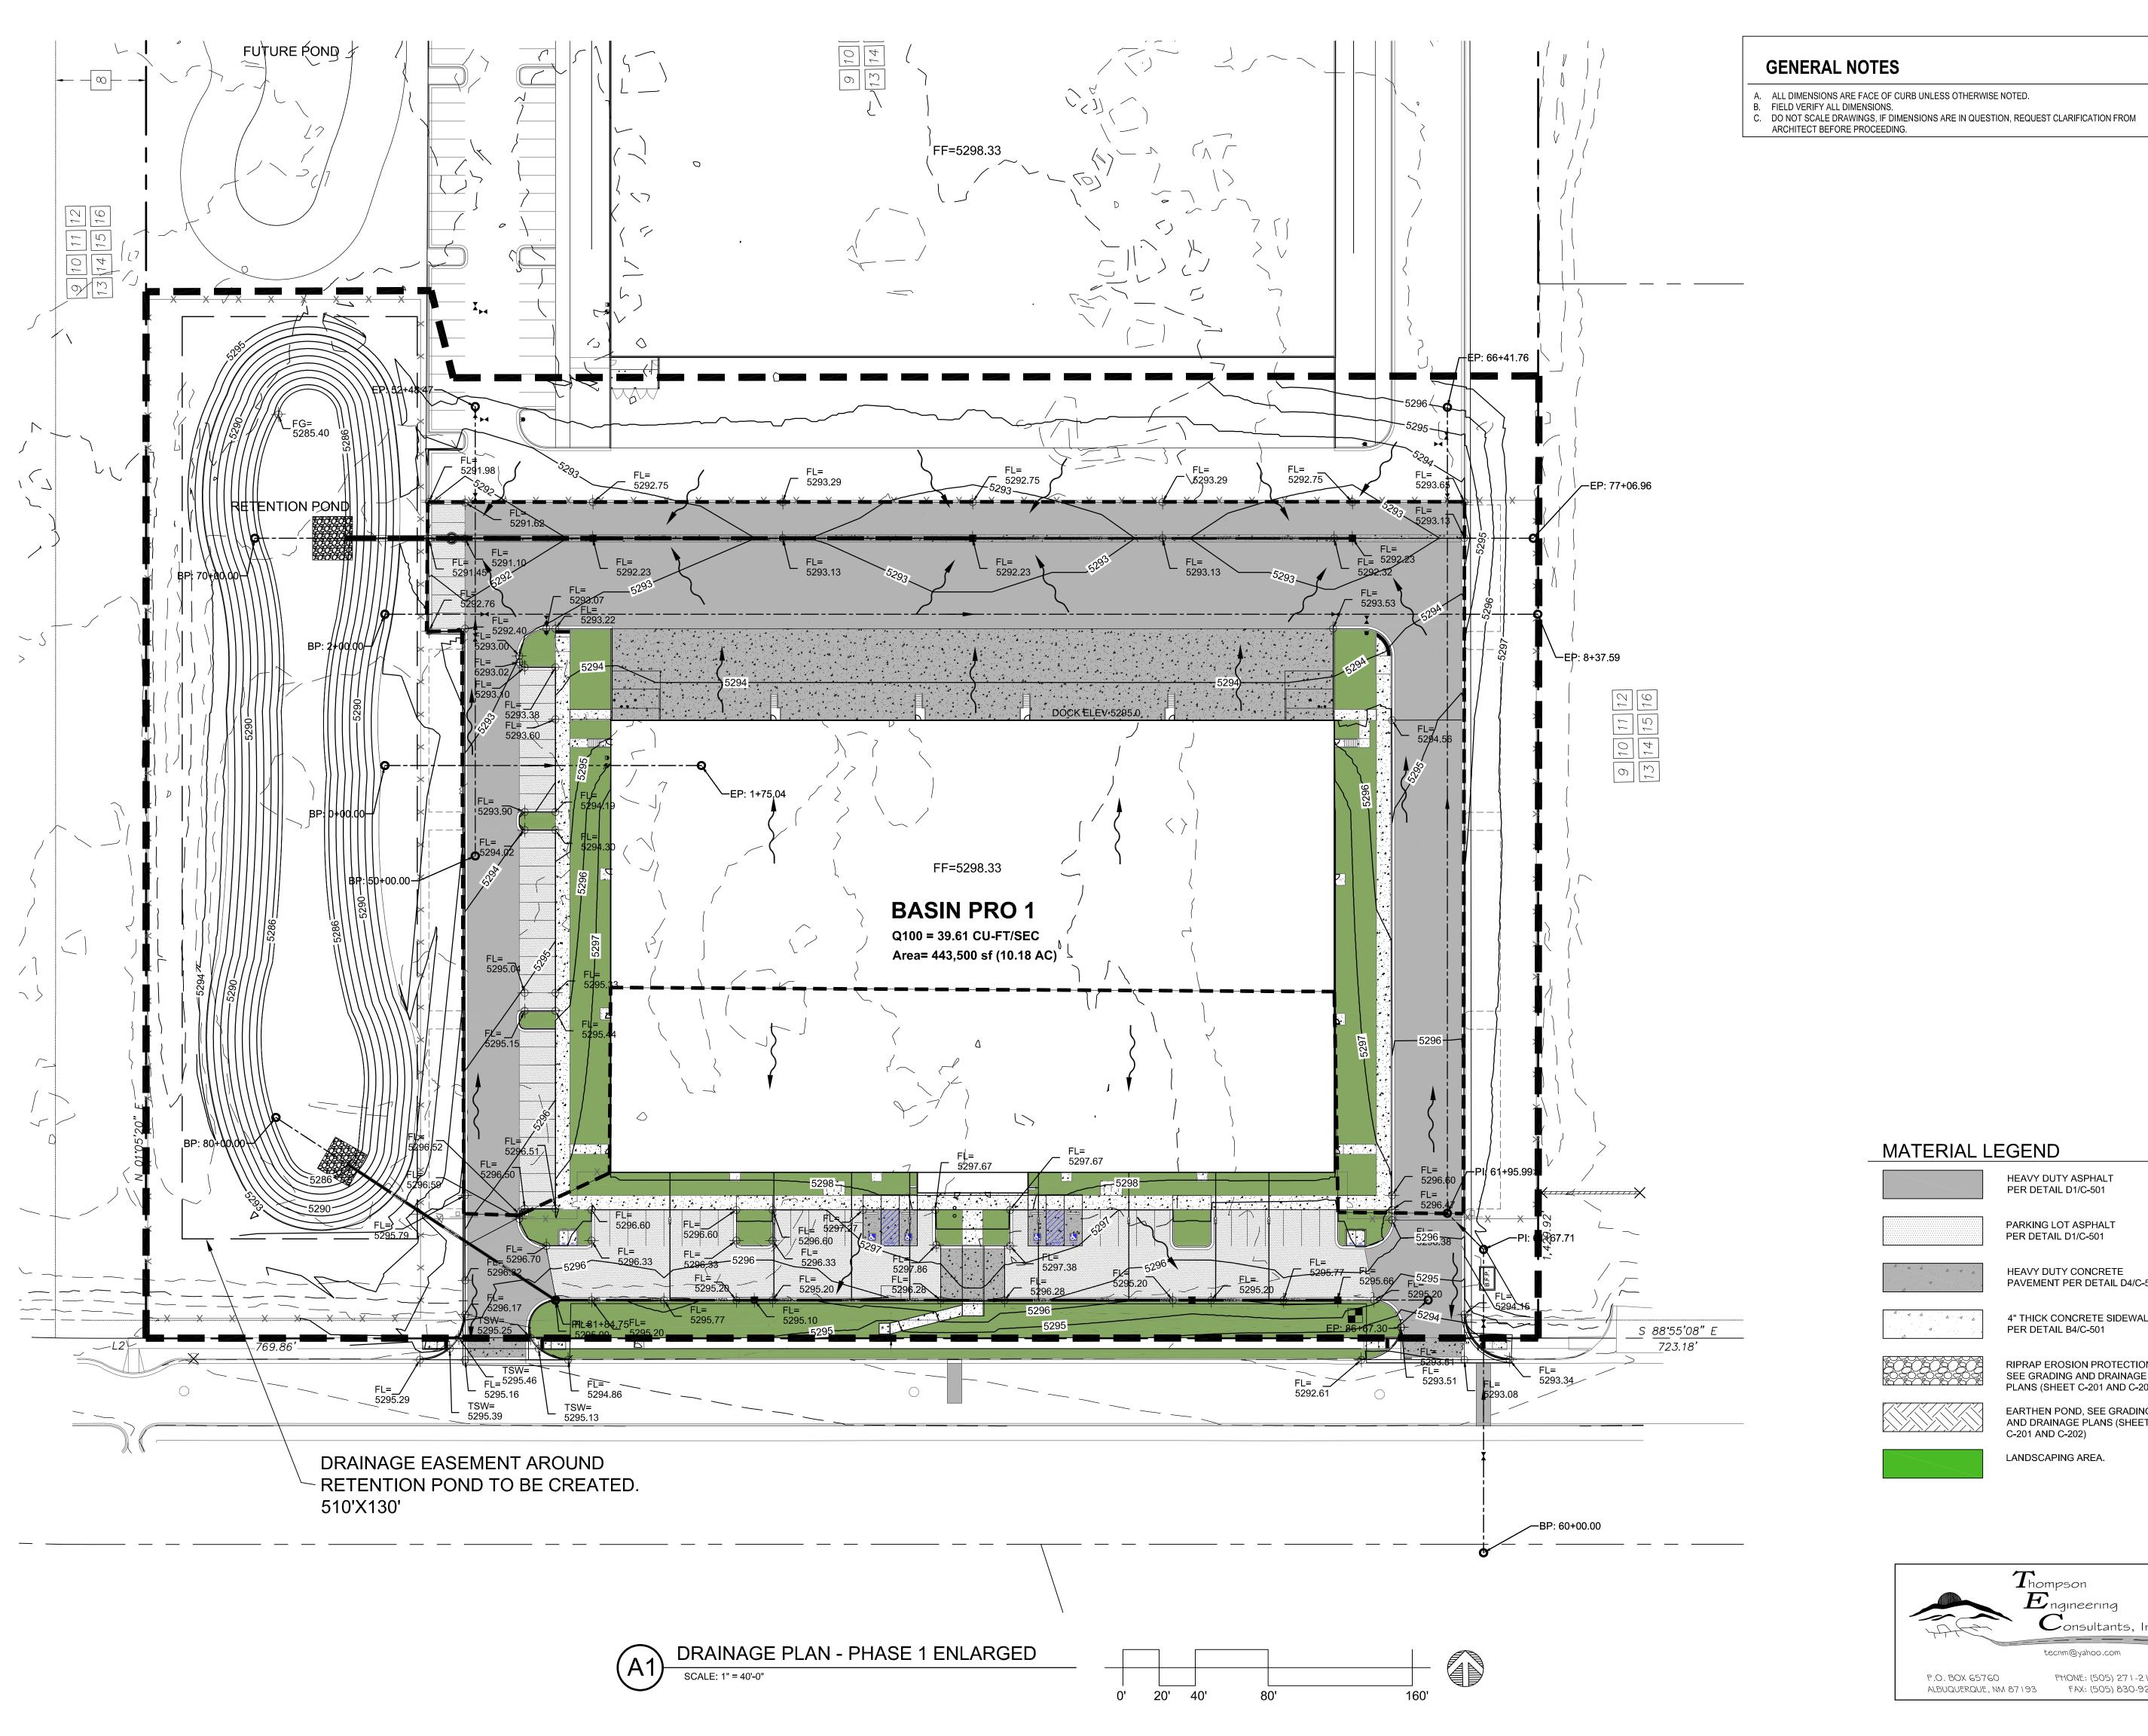

scout ARCHITECTURE + DESIGN

ARCHITECT/ ENGINEER



HEAVY DUTY ASPHALT PER DETAIL D1/C-501

PARKING LOT ASPHALT PER DETAIL D1/C-501

HEAVY DUTY CONCRETE PAVEMENT PER DETAIL D4/C-501

4" THICK CONCRETE SIDEWALK PER DETAIL B4/C-501

RIPRAP EROSION PROTECTION, SEE GRADING AND DRAINAGE PLANS (SHEET C-201 AND C-202)

EARTHEN POND, SEE GRADING AND DRAINAGE PLANS (SHEET C-201 AND C-202)

LANDSCAPING AREA.

 $T_{ ext{hompson}} \ E_{ ext{ngineering}}$

ALBUQUERQUE, NM 87 193 FAX: (505) 830-9248

P.O. BOX 65760

 $ec{C}$ onsultants, Inc.

PHONE: (505) 271-2199

tecnm@yahoo.com

BUILDING

DATE

PERMIT SET


REVISION

PROJECT NO

DRAINAGE PLAN -PHASE 1 **ENLARGED**

SHEET NO.

CD-2

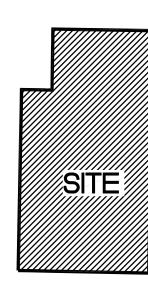

<u>Missina or invalid reference</u>

Vicinity Map - Zone Atlas Q-16-Z and R-16-Z

Record and Measured Legal Description

TRACT LETTERED D-SIX (D-6), PLAT OF MESA DEL SOL INNOVATION PARK II, AS THE SAME IS SHOWN AND DESIGNATED ON THE PLAT THEREOF RECORDED IN THE REAL PROPERTY RECORDS OF BERNALILLO COUNTY, NEW MEXICO ON DECEMBER 29, 2017, IN PLAT BOOK 2017C, PAGE 159, AS DOCUMENT NO. 2017124120.

- FIELD SURVEY PERFORMED IN JANUARY 2023.
- . ALL DISTANCES ARE GROUND DISTANCES: U.S. SURVEY FOOT. 3. THE BASIS OF BEARINGS REFERENCES NEW MEXICO STATE PLANE
- COORDINATES (NAD 83-CENTRAL ZONE).
- 4. WITH REGARD TO UNDERGROUND UTILITY LOCATIONS, SOURCE INFORMATION FROM PLANS AND MARKINGS WERE COMBINED WITH OBSERVED EVIDENCE OF UTILITIES PURSUANT TO SECTION 5.E.iv. TO DEVELOP A VIEW OF THE UNDERGROUND UTILITIES. HOWEVER, LACKING EXCAVATION, THE EXACT LOCATION OF UNDERGROUND FEATURES CANNOT BE ACCURATELY, COMPLETELY AND RELIABLY DEPICTED. IN ADDITION. IN SOME JURISDICTIONS, 811 OR OTHER SIMILAR UTILITY LOCATE REQUESTS FROM SURVEYORS MAY BE IGNORED OR RESULT IN AN INCOMPLETE RESPONSE, WHICH MAY AFFECT THIS SURVEYOR'S ASSESSMENT OF THE LOCATION OF THE UTILITIES. WHERE ADDITIONAL OR MORE DETAILED INFORMATION IS REQUIRED, THE CLIENT IS ADVISED THAT THAT EXCAVATION AND/OR A PRIVATE UTILITY LOCATE REQUEST MAY BE NECESSARY. INVERT DATA SHOWN WITH A \pm SHOULD BE CONSIDERED TAKEN FROM AS-BUILTS. (NM811 TICKET NO. 23JA030601)
- 5. THE COORDINATES SHOWN HEREON REFERENCE MODIFIED NEW MEXICO STATE PLANE COORDINATES (NAD 83-GROUND-CENTRAL ZONE), USING A GROUND TO GRID FACTOR OF 0.9996635537, WITH AN ORIGIN OF (0,0).
- 6. THERE ARE NO EASEMENTS, RIGHTS-OF-WAY, OLD HIGHWAYS, OR ABANDONED ROADS, LANES OR DRIVEWAYS AFFECTING THE PROPERTY APPEARING FROM A CAREFUL PHYSICAL INSPECTION OF THE SAME, OTHER THAN THOSE SHOWN AND DEPICTED ON THE SURVEY OR THOSE WHICH MAY BE DISCOVERED BY A COMPLETE EXAMINATION OF THE PROPERTY AND ALL ADJOINERS.
- THERE ARE NO VISIBLE BOUNDARY LINE CONFLICTS.
- EXCEPT AS SHOWN ON THIS SURVEY, THERE ARE NO OBSERVABLE ENCROACHMENTS OF IMPROVEMENTS ON THE PROPERTY UPON ANY EASEMENT, RIGHTS-OF-WAY, OR ADJACENT LAND NOR ENCROACHMENTS OF IMPROVEMENTS LOCATED ON ADJACENT LAND UPON THE PROPERTY.
- 9. THERE ARE NO GAPS, GORES, OVERLAPS OR HIATUS INHERENT TO THE SUBJECT PROPERTY BASED ON THE FIELD SURVEY PERFORMED AND THE TITLE COMMITMENT PROVIDED.
- 10. THE SUBJECT PROPERTY HAS DIRECT ACCESS TO AND FROM CRICK CROSSING SE (118' R/W). A PUBLIC RIGHT-OF-WAY.
- 11. THERE WAS NO EVIDENCE OF RECENT STREET OR SIDEWALK CONSTRUCTION OR REPAIRS IN THE PROCESS OF CONDUCTING THE FIELDWORK.
- 12. THERE WAS NO EVIDENCE OF RECENT EARTH MOVING WORK, BUILDING CONSTRUCTION OR BUILDING ADDITIONS OBSERVED IN THE PROCESS OF CONDUCTING THE FIELDWORK.
- 13. AT THE TIME OF THE SURVEY, THERE WAS NO OBSERVABLE EVIDENCE OF SUBSTANTIAL REFUSE OR USE AS A BURIAL GROUND OR CEMETERY.
- 14. THE SURVEYED LEGAL DESCRIPTION IS ONE AND THE SAME AS THAT LEGAL DESCRIPTION CONTAINED ON THE TITLE COMMITMENT ISSUED BY OLD REPUBLIC NATIONAL TITLE INSURANCE COMPANY, UNDER COMMITMENT NO. 2207829, WITH AN EFFECTIVE DATE OF APRIL 5, 2023.

Indexing Information

Sections 15 and 22, Township 9 North, Range 3 East, N.M.P.M. Owner: Akinita LLC UPC #: 101605227405540202

Documents

- 1. TITLE COMMITMENT PROVIDED BY OLD REPUBLIC NATIONAL TITLE, HAVING FILE NO. 2207829 AND AN EFFECTIVE DATE OF APRIL 5, 2023.
- 2. PLAT OF RECORD FOR MESA DEL SOL INNOVATION PARK II, FILED IN THE BERNALILLO COUNTY CLERK'S OFFICE ON DECEMBER 29, 2017, IN BOOK 2017C, PAGE 159, DOC. NO. 2017124120.
- 3. WARRANTY DEED FOR SUBJECT PROPERTY FILED IN THE BERNALILLO COUNTY CLERK'S OFFICE ON MAY 27, 2020, AS DOC. NO. 2020046995.

Benchmark -NAVD 88

ACS MONUMENT "3-Q16" HAVING AN ELEVATION OF 5310.39.

Easement Notes

- (20)(29) 1 EXISTING 10' P.U.E. (8/7/2008, 2008C-175) AND AS SHOWN ON PLAT (12/29/2017, 2017C-159)
- (20)(29) 2 EXISTING 30' PUBLIC PEDESTRIAN ACCESS EASEMENT (8/7/2008, 2008C-175) AND AS SHOWN ON PLAT AND AS SHOWN ON PLAT (12/29/2017, 2017C-159)
- (20) (29) 3 EXISTING 50' PUBLIC ROADWAY EASEMENT (8/7/2008, 2008C-175) AND AS SHOWN ON PLAT (12/29/2017, 2017C-159)
- (20) (29) 4 EXISTING 40' PNM TRANSMISSION LINE EASEMENT (8/7/2008, 2008C-175) AND AS SHOWN ON PLAT (12/29/2017, 2017C-159)
- (22)(29) 5 EXISTING 10' PNM EASEMENT (10/16/2008, DOC. NO. 2008113343) AND AS SHOWN ON PLAT (12/29/2017, 2017C-159)
- (29) (31) 6 EXISTING 30' PERMANENT PRIVATE ACCESS EASEMENT (12/29/2017, 2017C-159) AND AS SHOWN ON PLAT (12/29/2017, 2017C-159) SEE REPAIR AND MAINTENANCE AGREEMENT (2/21/2020, DOC. NO. 2020016464)
- (29) 7 EXISTING 20' PRIVATE UTILITY EASEMENT (12/29/2017, 2017C-159) AND AS SHOWN ON PLAT (12/29/2017, 2017C-159)
- (20)(29) 8 EXISTING 50' PNM TRANSMISSION LINE EASEMENT (8/7/2008, 2008C-175) AND AS SHOWN ON PLAT (12/29/2017, 2017C-159)
- (15) 9 EXISTING NON-EXCLUSIVE ACCESS EASEMENT OVER COMMON AREAS (4/16/2008, AS DOC. NO. 2008043398) AND RESTATED WITHIN DECLARATION OF COVENANTS, CONDITIONS AND RESTRICTIONS FOR MESA DEL SOL (12/28/2010, DOC. NO. 2010132684)
- (15)|10| EXISTING PERPETUAL NON—EXCLUSIVE UTILITY ACCESS EASEMENT (4/16/2008, AS DOC. NO. 2008043398) AND RESTATED WITHIN DECLARATION OF COVENANTS. CONDITIONS AND RESTRICTIONS FOR MESA DEL SOL (12/28/2010, DOC. NO. 2010132684)
- (15) 11 EXISTING EASEMENT FOR MAINTENANCE, EMERGENCY AND ENFORCEMENT OF UTILITIES AND STRUCTURES (4/16/2008, AS DOC. NO. 2008043398) AND RESTATED WITHIN DECLARATION OF COVENANTS, CONDITIONS AND RESTRICTIONS FOR MESA DEL SOL (12/28/2010, DOC. NO. 2010132684)
- 15) 12 EXISTING TEMPORARY CONSTRUCTION EASEMENTS OVER COMMON AREAS FOR INGRESS/EGRESS. SLOPE AND INSTALLATION OF DRAINAGE, WATER, STORM DRAINAGE, SANITARY SEWER AND OTHER UTILITIES AS WELL AS EQUIPMENT, MATERIALS AND SUPPLY STORAGE (4/16/2008, AS DOC. NO. 2008043398) AND RESTATED WITHIN DECLARATION OF COVENANTS, CONDITIONS AND RESTRICTIONS FOR MESA DEL SOL (12/28/2010, DOC. NO. 2010132684)
- (15)13 EXISTING RECIPROCAL, APPURTENANT EASEMENTS OF ENCROACHMENTS, AND MAINTENANCE USE OF ALL PERMITTED ENCROACHMENTS (4/16/2008, AS DOC. NO. 2008043398) AND RESTATED WITHIN DECLARATION OF COVENANTS, CONDITIONS AND RESTRICTIONS FOR MESA DEL SOL (12/28/2010, DOC. NO. 2010132684)
- (15)14 EXISTING RECIPROCAL, APPURTENANT EASEMENTS OVER, UNDER, ACROSS AND BETWEEN PARCELS AND COMMON AREAS FOR THE INSTALLATION AND MAINTENANCE OF FOOTINGS, FOUNDATION SUPPORT SYSTEMS, SHEETING ETC. (4/16/2008, AS DOC. NO. 2008043398) AND RESTATED WITHIN DECLARATION OF COVENANTS, CONDITIONS AND RESTRICTIONS FOR MESA DEL SOL (12/28/2010, DOC. NO. 2010132684)
- 15)15 EXISTING RECIPROCAL APPURTENANT EASEMENT OVER AND BETWEEN PARCELS AND COMMON AREAS FOR THE USE OF AIR SPACE (4/16/2008, AS DOC. NO. 2008043398) AND RESTATED WITHIN DECLARATION OF COVENANTS, CONDITIONS AND RESTRICTIONS FOR MESA DEL SOL (12/28/2010, DOC. NO. 2010132684)
- (15)|16| EXISTING SIGHTLINE EASEMENT FOR THE PURPOSE OF PRESERVING OR PROTECTING VIEWS FROM OR TO PARTICULAR PARCELS (4/16/2008, AS DOC. NO. 2008043398) AND RESTATED WITHIN DECLARATION OF COVENANTS, CONDITIONS AND RESTRICTIONS FOR MESA DEL SOL (12/28/2010, DOC. NO. 2010132684)

Exceptions 9-31

- 9 RESERVATIONS AND EXCEPTIONS IN THE EXCHANGE PATENT BY THE COMMISSIONER OF PUBLIC LANDS OF THE STATE OF NEW MEXICO, RECORDED ON JUNE 21, 2006 IN BOOK A119, PAGE 1045 AS DOC. NO. 2006091303 AND STATE OF NEW MEXICO PATENT FOR STATE TRUST LAND RECORDED APRIL 17, 2008 AS DOC. NO. 2008043677, RECORDS OF BERNALILLO COUNTY, NEW MEXICO. AFFECTS SUBJECT PROPERTY-BLANKET IN NATURE
- 10 LEVEL A DEVELOPMENT AGREEMENT ENTERED INTO BY AND BETWEEN FOREST CITY COVINGTON NM, LLC, A NEVADA LIMITED LIABILITY COMPANY AND THE CITY OF ALBUQUERQUE, A NEW MEXICO MUNICIPAL CORPORATION RECORDED MARCH 21, 2006 IN BOOK A113, PAGE 9604 AS DOC. NO. 2006039738, RECORDS OF BERNALILLO COUNTY, NEW MEXICO. AFFECTS SUBJECT PROPERTY-BLANKET IN NATURE
- 11 ASSIGNMENT OF LAND USE AUTHORIZATION FROM PATRICK H. LYONS, THE NEW MEXICO COMMISSIONER OF PUBLIC LANDS, TRUSTEE OF THE ENABLING ACT TRUST ACT OF JUNE 20, 1920, 36 STAT. 557, CH 310 TO THE REGENTS OF THE UNIVERSITY OF NEW MEXICO, A CONSTITUTIONALLY CREATED EDUCATIONS INSTITUTION OF THE STATE OF NEW MEXICO, RECORDED JUNE 21, 2006 IN BOOK A119, PAGE 1046 AS DOC. NO. 2006091304, RECORDS OF BERNALILLO COUNTY, NEW MEXICO. AFFECTS SUBJECT PROPERTY-BLANKET IN NATURE
- 12 INTENTIONALLY OMITTED
- 13 INTENTIONALLY OMITTED
- 14 NOTICE OF AIRPORT IMPACTS AND COVENANTS NOT TO SUE DATED JUNE 23, 2006, RECORDED JULY 7, 2006 IN BOOK A120, PAGE 642 AS DOC. NO. 2006100926, RECORDS OF BERNALILLO COUNTY, NEW MEXICO. NOT SURVEY RELATED
- (15) COVENANTS, CONDITIONS AND RESTRICTIONS AS SET FORTH IN THE DOCUMENT ENTITLED DECLARATION OF COVENANTS, CONDITIONS AND RESTRICTIONS FOR THE MESA DEL SOL EMPLOYMENT CENTER, RECORDED APRIL 16, 2008 AS DOC. NO. 2008043398; RECORDED JULY 17, 2009 AS DOC. NO. 2009081004; RECORDED DECEMBER 28, 2010 AS DOC. NO. 2010132684 AND RECORDED OCTOBER 8, 2018 AS DOC. NO. 2018087976. NOTE: THIS EXCEPTION OMITS ANY COVENANT. CONDITION OR RESTRICTION BASED ON RACE, COLOR, RELIGION, SEX, HANDICAP, FAMILIAL STATUS OR NATIONAL ORIGIN AS PROVIDED IN 42 U.S.C. SEC. 3604, UNLESS AND ONLY TO THE EXTENT THAT THE COVENANT (A) IS NOT IN VIOLATION OF STATE OR FEDERAL LAW, (B) IS EXEMPT UNDER 42 U.S.C. SEC. 3607. OR (C) RELATES TO A HANDICAP. BUT DOES NOT DISCRIMINATE AGAINST HANDICAPPED PEOPLE, AND AS SHOWN ON THE BOUNDARY SURVEY, ALTA/NSPS LAND TITLE SURVEY PREPARED BY CSI-CARTESIAN SURVEYS, INC., DATED JANUARY 10, 2023, UNDER JOB NO. 222114, LAST REVISED APRIL 10, 2023 ("SURVEY") AFFECTS SUBJECT PROPERTY-EASEMENTS SHOWN HEREON AS 9101112131415 AND 16
- 16 AGREEMENT AND COVENANT BETWEEN THE CITY OF ALBUQUERQUE AND MESA DEL SOL, LLC. A NEW MEXICO LIMITED LIABILITY COMPANY, RECORDED JUNE 25, 2008 AS DOC. NO. 2008071872, RECORDS OF BERNALILLO COUNTY, NEW MEXICO. AFFECTS SUBJECT PROPERTY-BLANKET IN NATURE
- 17 MESA DEL SOL TAX INCREMENT DEVELOPMENT DISTRICTS NOTICE OF FORMATION RESOLUTION DATED DECEMBER 28, 2006, RECORDED DECEMBER 28, 2006 IN BOOK A129, PAGE 4126 AS DOC. NO. 2006194654; FIRST AMENDMENT TO THE MASTER DEVELOPMENT AGREEMENT MESA DEL SOL TAX INCREMENT DEVELOPMENT DISTRICTS 1 THROUGH 5 BY AND AMONG THE CITY OF ALBUQUERQUE, NEW MEXICO, MESA DEL SO, LLC AND MESA DEL SOL TAX INCREMENT DEVELOPMENT DISTRICTS 1 THROUGH 5, RECORDED MARCH 30, 2010 AS DOC. NO. 2010026776, RECORDS OF BERNALILLO COUNTY, NEW MEXICO. NOT SURVEY RELATED
- 18 LEVEL B DEVELOPMENT AGREEMENT ENTERED INTO BY AND BETWEEN GRANTOR AND THE CITY OF ALBUQUERQUE, A NEW MEXICO MUNICIPAL CORPORATION, RECORDED DECEMBER 3, 2007 AS DOC. NO. 2007163468; AMENDED BY FIRST AMENDMENT TO MESA DEL SOL PHASE I LEVEL B DEVELOPMENT AGREEMENT RECORDED AUGUST 22, 2011 AS DOC. NO. 2011075937, RECORDS OF BERNALILLO COUNTY, NEW MEXICO. AFFECTS SUBJECT PROPERTY-BLANKET IN NATURE
- 19 INTENTIONALLY OMITTED
- (20) [A] TEN FOOT P.U.E. RESERVED ALONG THE SOUTH PORTION OF INSURED PREMISES, [B] EASEMENTS, NOTICE OF SUBDIVISION PLAT CONDITIONS AND NOTES AS SHOWN, NOTED AND PROVIDED FOR ON THE BULK LAND PLAT FOR MESA DEL SOL INNOVATION PARK II, RECORDED AUGUST 7, 2008 IN PLAT BOOK 2008C, PAGE 175 AS DOC. NO. 2008089615, RECORDS OF BERNALILLO COUNTY, NEW MEXICO, AND AS SHOWN ON SURVEY PREPARED BY CSI-CARTESIAN SURVEYS, INC., DATED JANUARY 10, 2023, UNDER JOB NO. 222114, LAST REVISED APRIL 10, 2023 ("SURVEY"). {A} AFFECTS SUBJECT PROPERTY—SHOWN HEREON AS 1 {B} AFFECTS SUBJECT PROPERTY-SHWON HEREON AS 234 AND 8
- 21 TAX INCREMENT DEVELOPMENT DISTRICT COVENANT DATED SEPTEMBER 16, 2008, BY AND BETWEEN MESA DEL SOL, LLC, A NEW MEXICO LIMITED LIABILITY COMPANY AND SCHOTT SOLAR, INC., A DELAWARE CORPORATION, RECORDED SEPTEMBER 17, 2008 AS DOC. NO. 2008102553 AND ASSUMPTION OF TIDD COVENANT RECORDED JUNE 1, 2016 AS DOC. NO. 2016049810, RECORDS OF BERNALILLO COUNTY, NEW MEXICO. NOT SURVEY RELATED
- (22) EASEMENT, AND INCIDENTAL PURPOSES THERETO, GRANTED TO PUBLIC SERVICE COMPANY OF NEW MEXICO. A NEW MEXICO CORPORATION, RECORDED OCTOBER 16, 2008 AS DOC. NO. 2008113343, RECORDS OF BERNALILLO COUNTY, NEW MEXICO AND AS SHOWN ON SURVEY PREPARED BY CSI-CARTESIAN SURVEYS, INC., DATED JANUARY 10, 2023, UNDER JOB NO. 222114, LAST REVISED APRIL 10, 2023 ("SURVEY"). AFFECTS SUBJECT PROPERTY-SHOWN HEREON AS 5
- 23 PUBLIC IMPROVEMENT DISTRICT PROHIBITION COVENANT DATED SEPTEMBER 16, 2008, BY AND BETWEEN MESA DEL SOL. LLC. A NEW MEXICO LIMITED LIABILITY COMPANY AND SCHOTT SOLAR, INC., A DELAWARE CORPORATION, RECORDED SEPTEMBER 17, 2008. AS DOC. NO. 2008102555, RECORDS OF BERNALILLO COUNTY, NEW MEXICO.
- 24 INTENTIONALLY OMITTED
- 25 NOTICE OF MESA DEL SOL EMPLOYMENT CENTER OWNER'S ASSOCIATION, INC. RECORDED APRIL 30, 2014 AS DOC. NO. 2014033938, RECORDS OF BERNALILLO COUNTY, NEW MEXICO. NOT SURVEY RELATED
- 26 NOTICE OF MESA DEL SOL COMMUNITY COMPANY, INC. RECORDED OCTOBER 18, 2019 AS DOC. NO. 2019089422, RECORDED SEPTEMBER 2, 2022 AS DOCUMENT NO. 2022080789, RECORDS OF BERNALILLO COUNTY, NEW MEXICO. NOT SURVEY RELATED
- 27 MESA DEL SOL MASTER PARKS AGREEMENT RECORDED JULY 30, 2014 AS DOC. NO. 2014059937, RECORDS OF BERNALILLO COUNTY, NEW MEXICO. AFFECTS SUBJECT PROPERTY-BLANKET IN NATURE
- 28 SUBDIVISION IMPROVEMENTS AGREEMENT PUBLIC AND/OR PRIVATE—AGREEMENT TO CONSTRUCT PUBLIC AND/OR PRIVATE SUBDIVISION IMPROVEMENTS, RECORDED DECEMBER 30, 2016 AS DOC. NO. 2016121967; AMENDED BY AMENDMENT TO AGREEMENT TO CONSTRUCT INFRASTRUCTURE IMPROVEMENTS AND AMENDMENT TO DRB INFRASTRUCTURE LIST RECORDED AUGUST 27, 2019 AS DOC. NO. 2019072687, AMENDED AND EXTENSION AGREEMENT FILED APRIL 11, 2022 AS DOCUMENT NO. 2022035809, RECORDS OF BERNALILLO COUNTY, NEW MEXICO. NOT SURVEY RELATED
- (29) {A} EXISTING 10' P.U.E., {B} EXISTING 30' PUBLIC PEDESTRIAN ACCESS EASEMENT, {C} EXISTING 50' PUBLIC ROADWAY EASEMENT, {D} EXISTING 40' PNM TRANSMISSION LINE EASEMENT, {E} EXISTING 10' PNM EASEMENT, {F} EXISTING 30' PERMANENT PRIVATE ACCESS EASEMENT, SEE REPAIR AND MAINTENANCE AGREEMENT (2/21/2020, DOC. NO. 2020016464), {G} EXISTING 20' PRIVATE UTILITY EASEMENT, {H} EXISTING 50' PNM TRANSMISSION LINE EASEMENT, EASEMENTS AND NOTES AS SHOWN, NOTED AND PROVIDED FOR ON THE PLAT OF TRACTS D-1 THRU D-7, MESA DEL SOL INNOVATION PARK II, RECORDED IN PLAT BOOK 2017C, PAGE 159 AS DOC. NO. 2017124120; REMAINING MONUMENTATION AFFIDAVIT RECORDED JANUARY 5, 2018 AS DOC. NO. 2018001453, RECORDS OF BERNALILLO COUNTY, NEW MEXICO, AS SHOWN ON SURVEY PREPARED BY CSI-CARTESIAN SURVEYS, INC., DATED JANUARY 10, 2023, UNDER JOB NO. 222114, LAST REVISED APRIL 10, 2023 ("SURVEY").
- {A} AFFECTS SUBJECT PROPERTY—SHOWN HEREON AS 1 $\{\mathtt{B}\}$ affects subject property—shown hereon as lacksquare{C} AFFECTS SUBJECT PROPERTY—SHOWN HEREON AS 3
- {D} AFFECTS SUBJECT PROPERTY—SHOWN HEREON AS 4 {E} AFFECTS SUBJECT PROPERTY—SHOWN HEREON AS 5 {F} AFFECTS SUBJECT PROPERTY—SHOWN HEREON AS L
- {G} AFFECTS SUBJECT PROPERTY—SHOWN HEREON AS [{H} AFFECTS SUBJECT PROPERTY—SHOWN HEREON AS 8
- 30 INTENTIONALLY OMITTED
- (31) REPAIR AND MAINTENANCE AGREEMENT BY AND BETWEEN GOLD MESA INVESTMENTS, LLC, A NEW MEXICO LIMITED LIABILITY COMPANY, AND MB INVESTMENTS GROUP, LLC, A MISSOURI LIMITED LIABILITY COMPANY, RECORDED FEBRUARY 21, 2020 AS DOCUMENT NO. 2020016464, RECORDS OF BERNALILLO COUNTY, NEW MEXICO AS SHOWN ON SURVEY PREPARED BY CSI-CARTESIAN SURVEYS, INC., DATED JANUARY 10, 2023, UNDER JOB NO. 222114, LAST REVISED APRIL 10, 2023 ("SURVEY"). AFFECTS SUBJECT PROPERTY-PERTAINS TO EASEMENT 6

Boundary Survey, ALTA/NSPS Land Title Survey

Topographic Map Tract D-6 Mesa Del Sol Innovation Park II

City of Albuquerque Bernalillo County, New Mexico April 2023

Surveyor's Certificate for ALTA/NSPS Survey

DATE

TO: RO4, LLC, A NEW MEXICO LIMITED LIABILITY COMPANY, AKINITA LLC, A NEW MEXICO LIMITED LIABILITY COMPANY, OLD REPUBLIC NATIONAL TITLE INSURANCE COMPANY:

THIS IS TO CERTIFY THAT THIS MAP OR PLAT AND THE SURVEY ON WHICH IT IS BASED WERE MADE IN ACCORDANCE WITH THE 2016 MINIMUM STANDARD DETAIL REQUIREMENTS FOR ALTA/NSPS LAND TITLE SURVEYS, JOINTLY ESTABLISHED AND ADOPTED BY ALTA AND NSPS, AND INCLUDES ITEMS 1-4 AND 7(A) OF TABLE A THEREOF. THE FIELD WORK WAS COMPLETED ON JANUARY 10, 2023.

BRIAN J. MARTINEZ

N.M.R.P.S. NO. 18374

REVISIONS: 2/2/2023 - ORIGINAL

4/10/2023 - REVISED TO ADD NOTES 6-14 AND REFLECT THE UPDATED TITLE COMMITMENT



Surveyor's Certificate for Boundary Survey

. BRIAN J. MARTINEZ. NEW MEXICO PROFESSIONAL SURVEYOR NO. 18374. DO HEREBY CERTIFY THAT THIS BOUNDARY SURVEY PLAT AND THE ACTUAL SURVEY ON THE GROUND UPON WHICH IT IS BASED WERE PERFORMED BY ME OR UNDER MY DIRECT SUPERVISION: THAT I AM RESPONSIBLE FOR THIS SURVEY; THAT THIS SURVEY MEETS THE MINIMUM STANDARDS FOR SURVEYING IN NEW MEXICO; AND THAT IT IS TRUE AND CORRECT TO THE BEST OF MY KNOWLEDGE AND BELIEF. I FURTHER CERTIFY THAT THIS SURVEY IS NOT A LAND DIVISION OR SUBDIVISION AS DEFINED IN THE NEW MEXICO SUBDIVISION ACT AND THAT THIS INSTRUMENT IS A BOUNDARY SURVEY PLAT OF AN EXISTING TRACT OR TRACTS.

BRIAN J. MARTINEZ N.M.R.P.S. NO. 18374

DATE

Surveyor's Certificate for Topographic Map

. BRIAN J. MARTINEZ, A NEW MEXICO REGISTERED PROFESSIONAL LAND SURVEYOR DO HEREBY CERTIFY THAT THE TOPOGRAPHIC MAP SHOWN HEREON IS TRUE AND CORRECT TO THE BEST OF MY KNOWLEDGE AND BELIEF.

BRIAN J. MARTINEZ N.M.R.P.S. NO. 18374

DATE








BASED UPON SCALING. THIS PROPERTY LIES WITHIN FLOOD ZONE "X" WHICH IS DEFINED AS AN AREA OF MINIMAL FLOOD HAZARD AS DETERMINED BY F.E.M.A. AND SHOWN ON THE FLOOD INSURANCE RATE MAP NO. 35001C0363G, DATED SEPTEMBER 26, 2008.

- A. ALL DIMENSIONS ARE FACE OF CURB UNLESS OTHERWISE NOTED.
- B. FIELD VERIFY ALL DIMENSIONS.
- C. DO NOT SCALE DRAWINGS, IF DIMENSIONS ARE IN QUESTION, REQUEST CLARIFICATION FROM ARCHITECT BEFORE PROCEEDING.
- D. SEE SHEETS C-303 AND C-304 FOR STORM DRAIN LINE PLAN AND PROFILES.
- E. SEE SHEETS C-305 THRU C-307 FOR WATERLINE PLAN AND PROFILES.


KEYED NOTES

- 1. STORMWATER RETENTION POND, SEE SHEET C202..
- 2. 20'X20' RIP RAP EROSION PROTECTION PER DETAIL D3/C-501.
- 3. STA: 80+47.26, OFF: 0.00' RT, 18" HDPE FLARED END SECTION.
- 4. 18" HDPE STORM DRAIN PIPE
- 5. STA: 81+84.75, OFF: 0.00' RT, TYPE "C" CATCH BASIN PER COA STD DWG 2205.
- 6. STA: 82+94.72, OFF: 0.00' RT, TYPE "C" CATCH BASIN PER COA STD DWG 2205.
- 7. STA: 85+36.68, OFF: 0.04' RT, TYPE "C" CATCH BASIN PER COA STD DWG 2205.
- 8. STA: 86+17.30, OFF: 0.04' RT, TYPE "C" CATCH BASIN PER COA STD DWG 2205



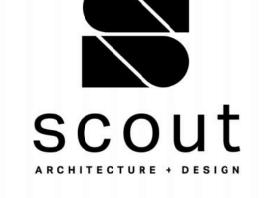

ARCHITECT/ ENGINEER

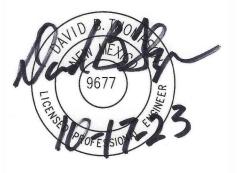

ROSE

BUILDING PERMIT SET

DATE

10/16/23


REVISION


PROJECT NO

STORM DRAIN PLAN AND

PROFILE SOUTH PARKING LOT

SHEET NO.

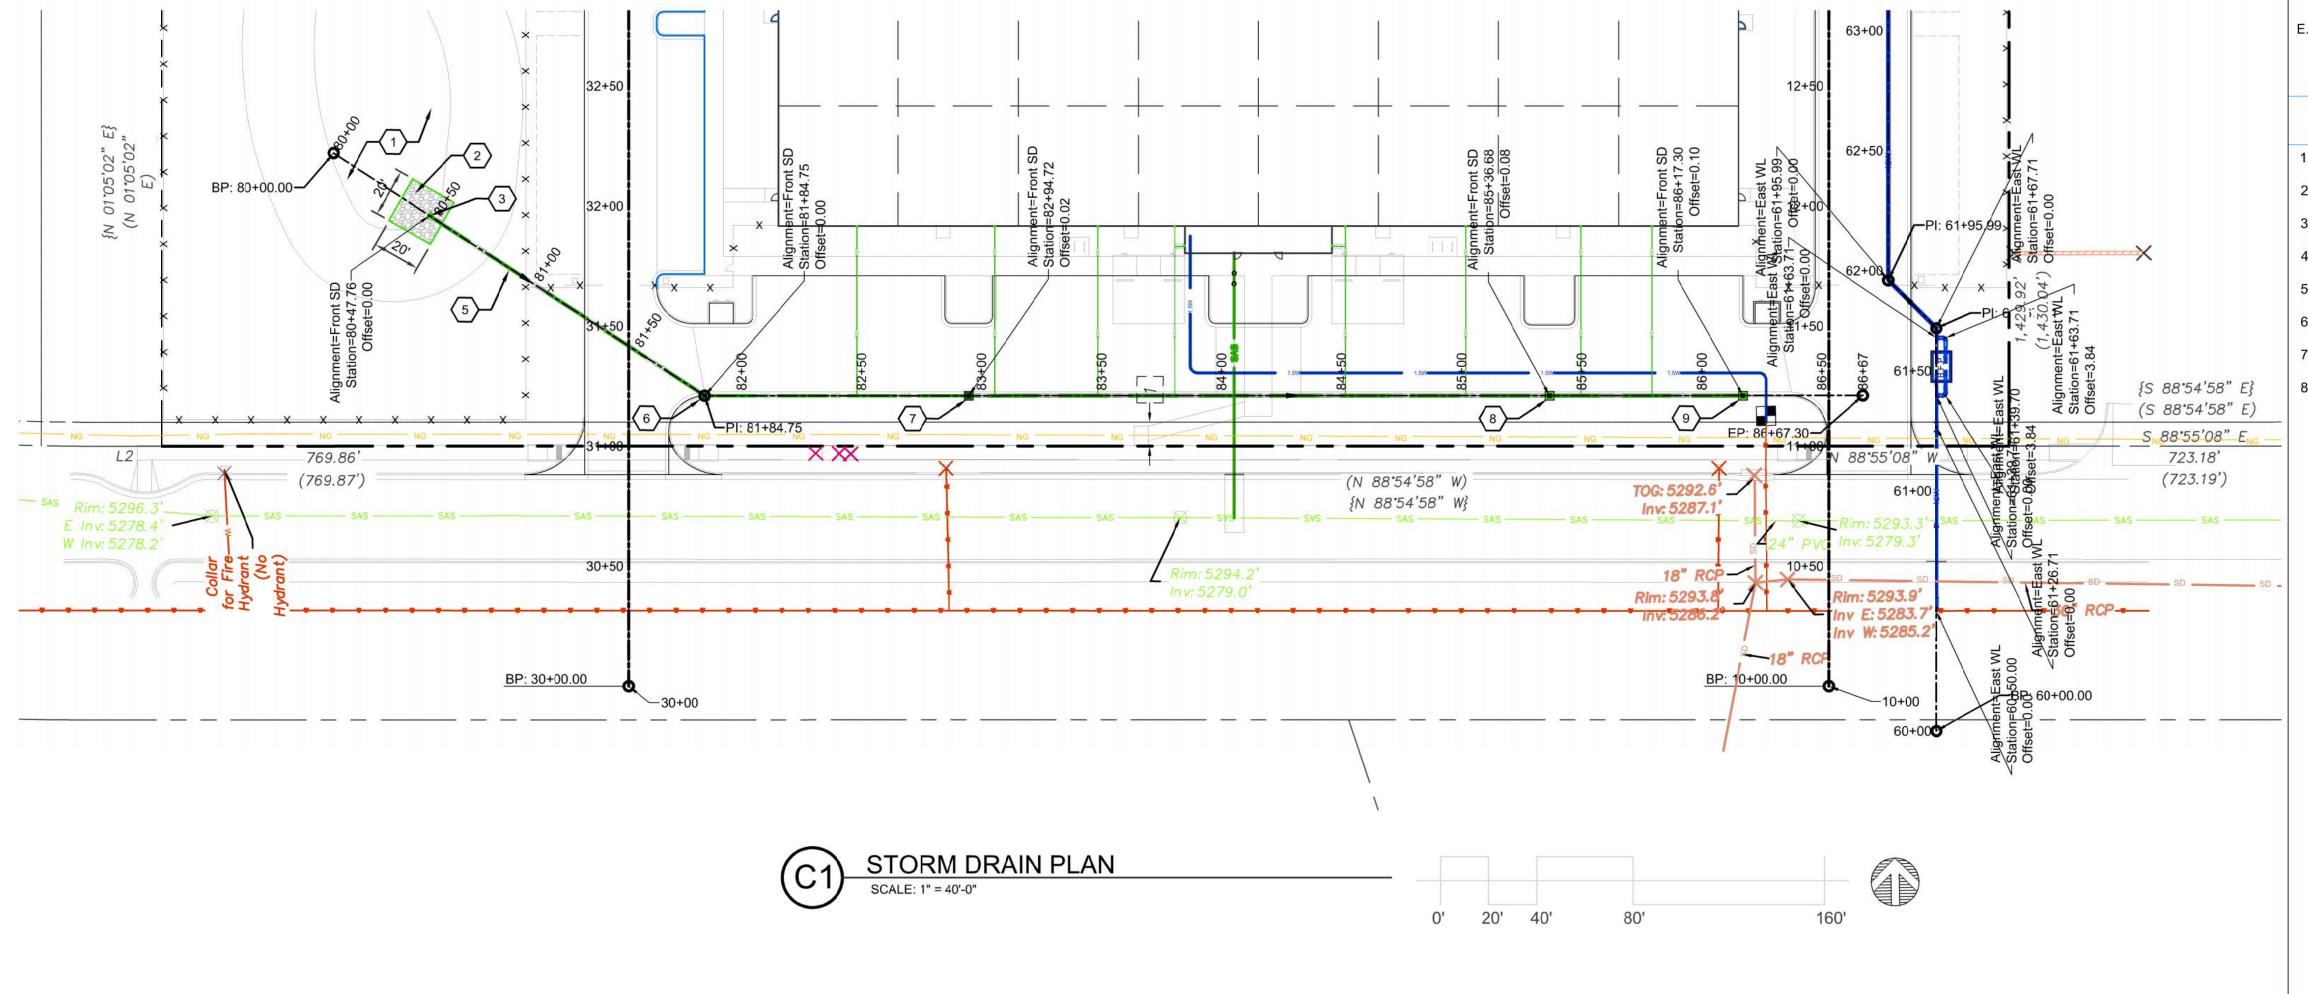

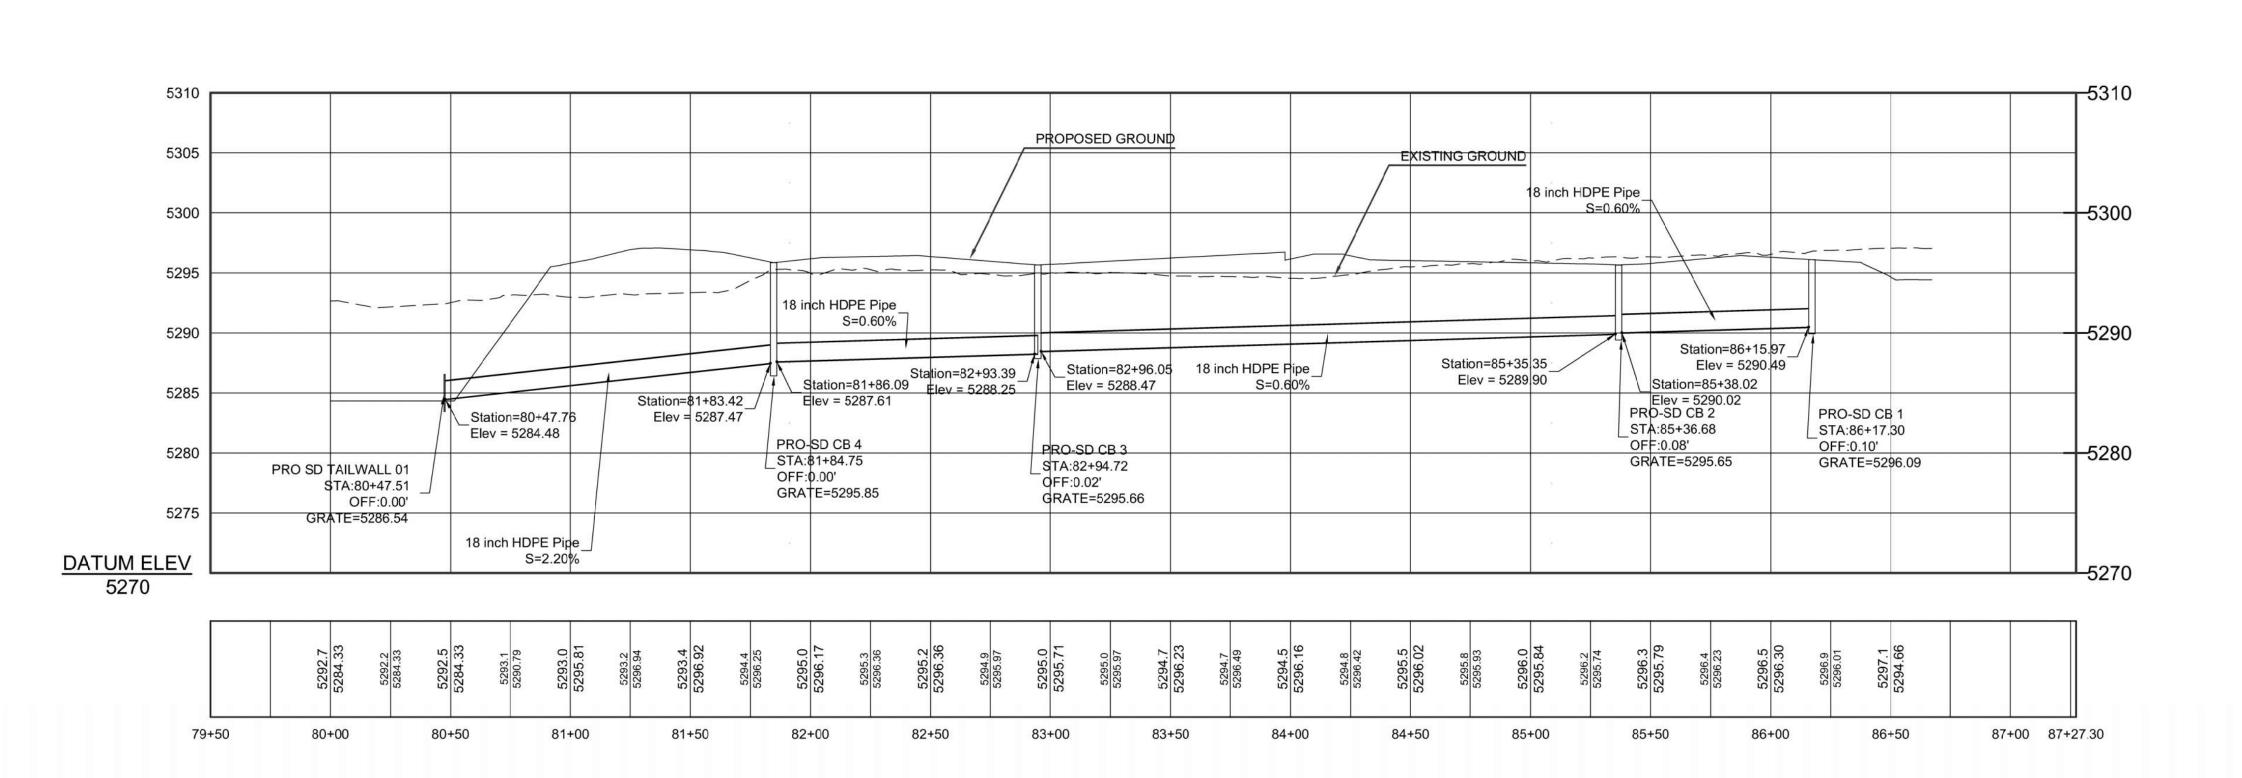


Consultants, Inc. tecnm@yahoo.com

P.O. BOX 65760 ALBUQUERQUE, NM 87 193 FAX: (505) 830-9248

PHONE: (505) 271-2199

 $T_{ ext{hompson}}$ $E_{ ext{ngineering}}$

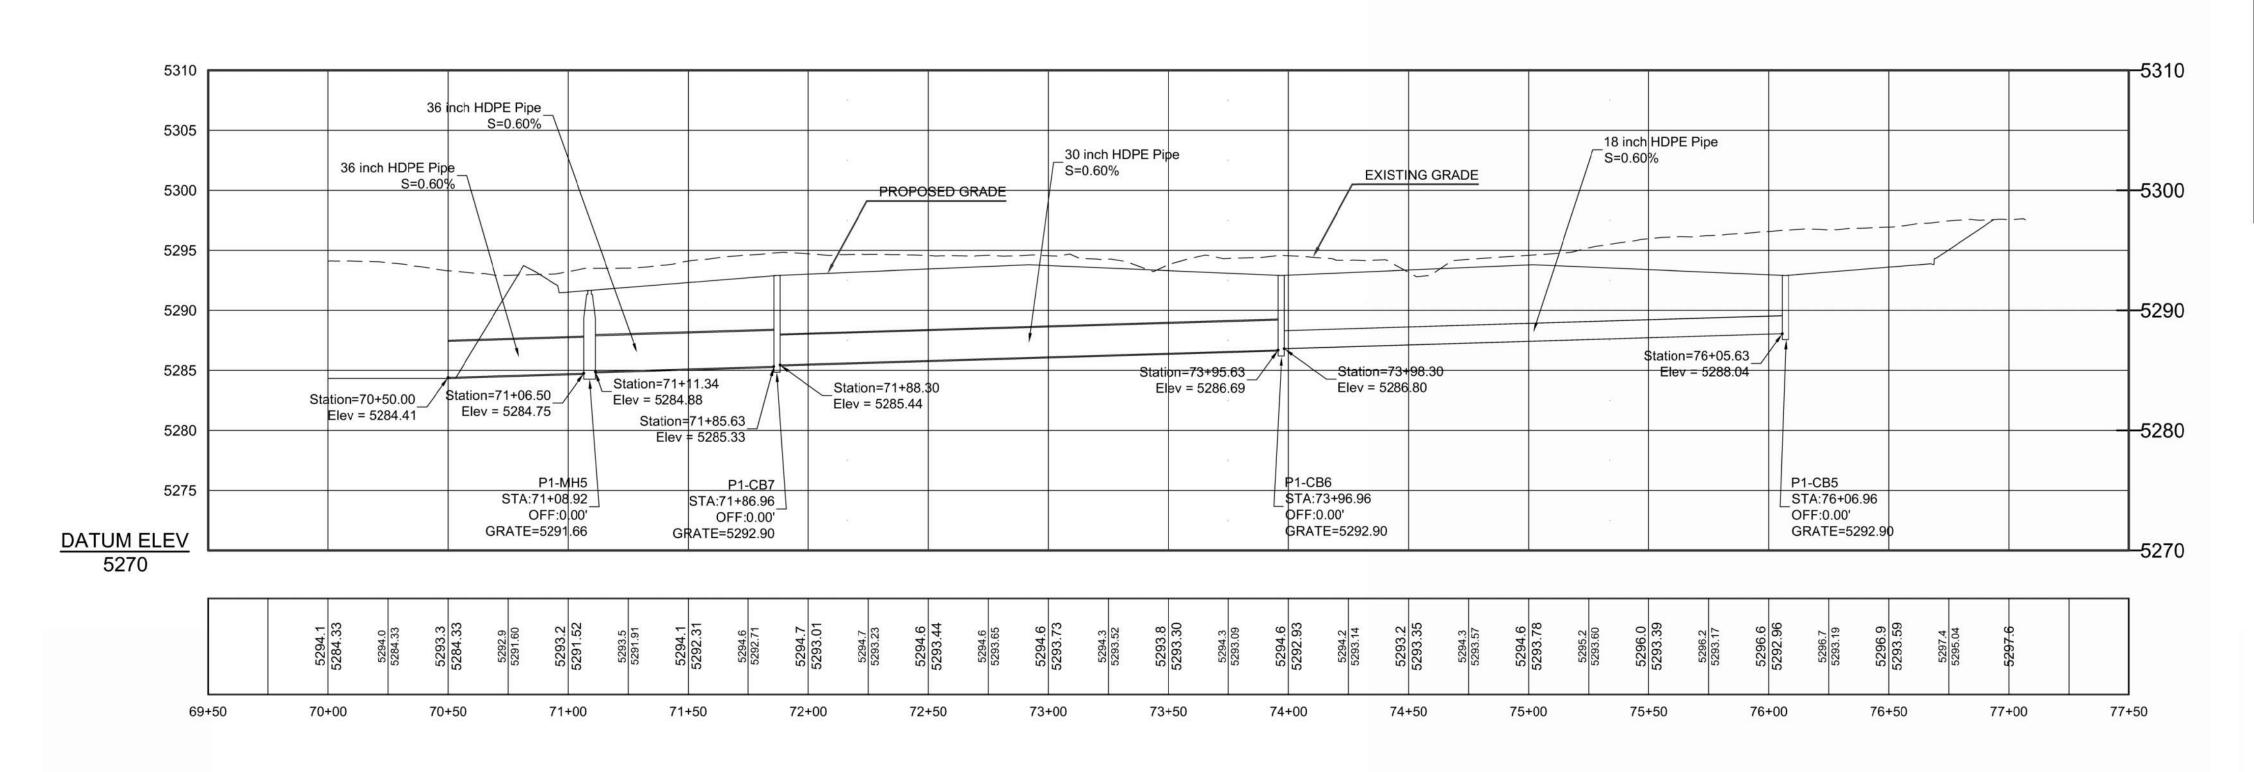

STORM DRAIN PROFILE SCALE: 1" = 40'-0" HORIZ, 1"= 8' VERT. **VERTICAL EXAGGERATION 5X**

GENERAL NOTES


- A. ALL DIMENSIONS ARE FACE OF CURB UNLESS OTHERWISE NOTED.
- B. FIELD VERIFY ALL DIMENSIONS.
- C. DO NOT SCALE DRAWINGS, IF DIMENSIONS ARE IN QUESTION, REQUEST CLARIFICATION FROM ARCHITECT BEFORE PROCEEDING.
- D. SEE SHEETS C-303 AND C-304 FOR STORM DRAIN LINE PLAN AND
- PROFILES.
- E. SEE SHEETS C-305 THRU C-307 FOR WATERLINE PLAN AND PROFILES.

KEYED NOTES

- 1. STORMWATER RETENTION POND, SEE SHEET C202.
- 2. 24'X22' RIP RAP EROSION PROTECTION PER DETAIL D3/C501.
- 3. STA: 70+50.00, OFF: 0.00' RT, 36" HDPE FLARED END SECTION.
- 4. 36" HDPE STORM DRAIN PIPE
- 5. STA 71+08.92, OFF: 0.00' RT, 6' DIA STORM DRAIN MAINHOLE TYPE "E" PER COA STD DWG 2208.
- 6. STA: 71.85.96, OFF: 0.00' RT, TYPE "D" CATCH BASIN PER COA STD DWG 2206.
- 7. 30" HDPE STORM DRAIN PIPE
- 8. STA: 73+96.96, OFF: 0.00' RT, TYPE "D" CATCH BASIN PER COA STD DWG 2206.
- 9. 18" HDPE STORM DRAIN PIPE
- 10. STA: 76+06.96, OFF: 0.00' RT, TYPE "D" CATCH BASIN PER COA STD DWG 2206.



ARCHITECT/ ENGINEER

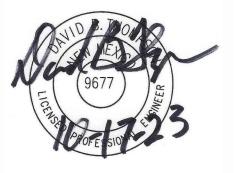

ROSE

BUILDING PERMIT SET

DATE REVISION

PROJECT NO

STORM DRAIN PLAN AND PROFILE NORTH

10/16/23

SHEET NO.

 $T_{ ext{hompson}}$ $E_{ ext{ngineering}}$

ALBUQUERQUE, NM 87 193 FAX: (505) 830-9248


P.O. BOX 65760

Consultants, Inc.

PHONE: (505) 271-2199

tecnm@yahoo.com

PARKING LOT

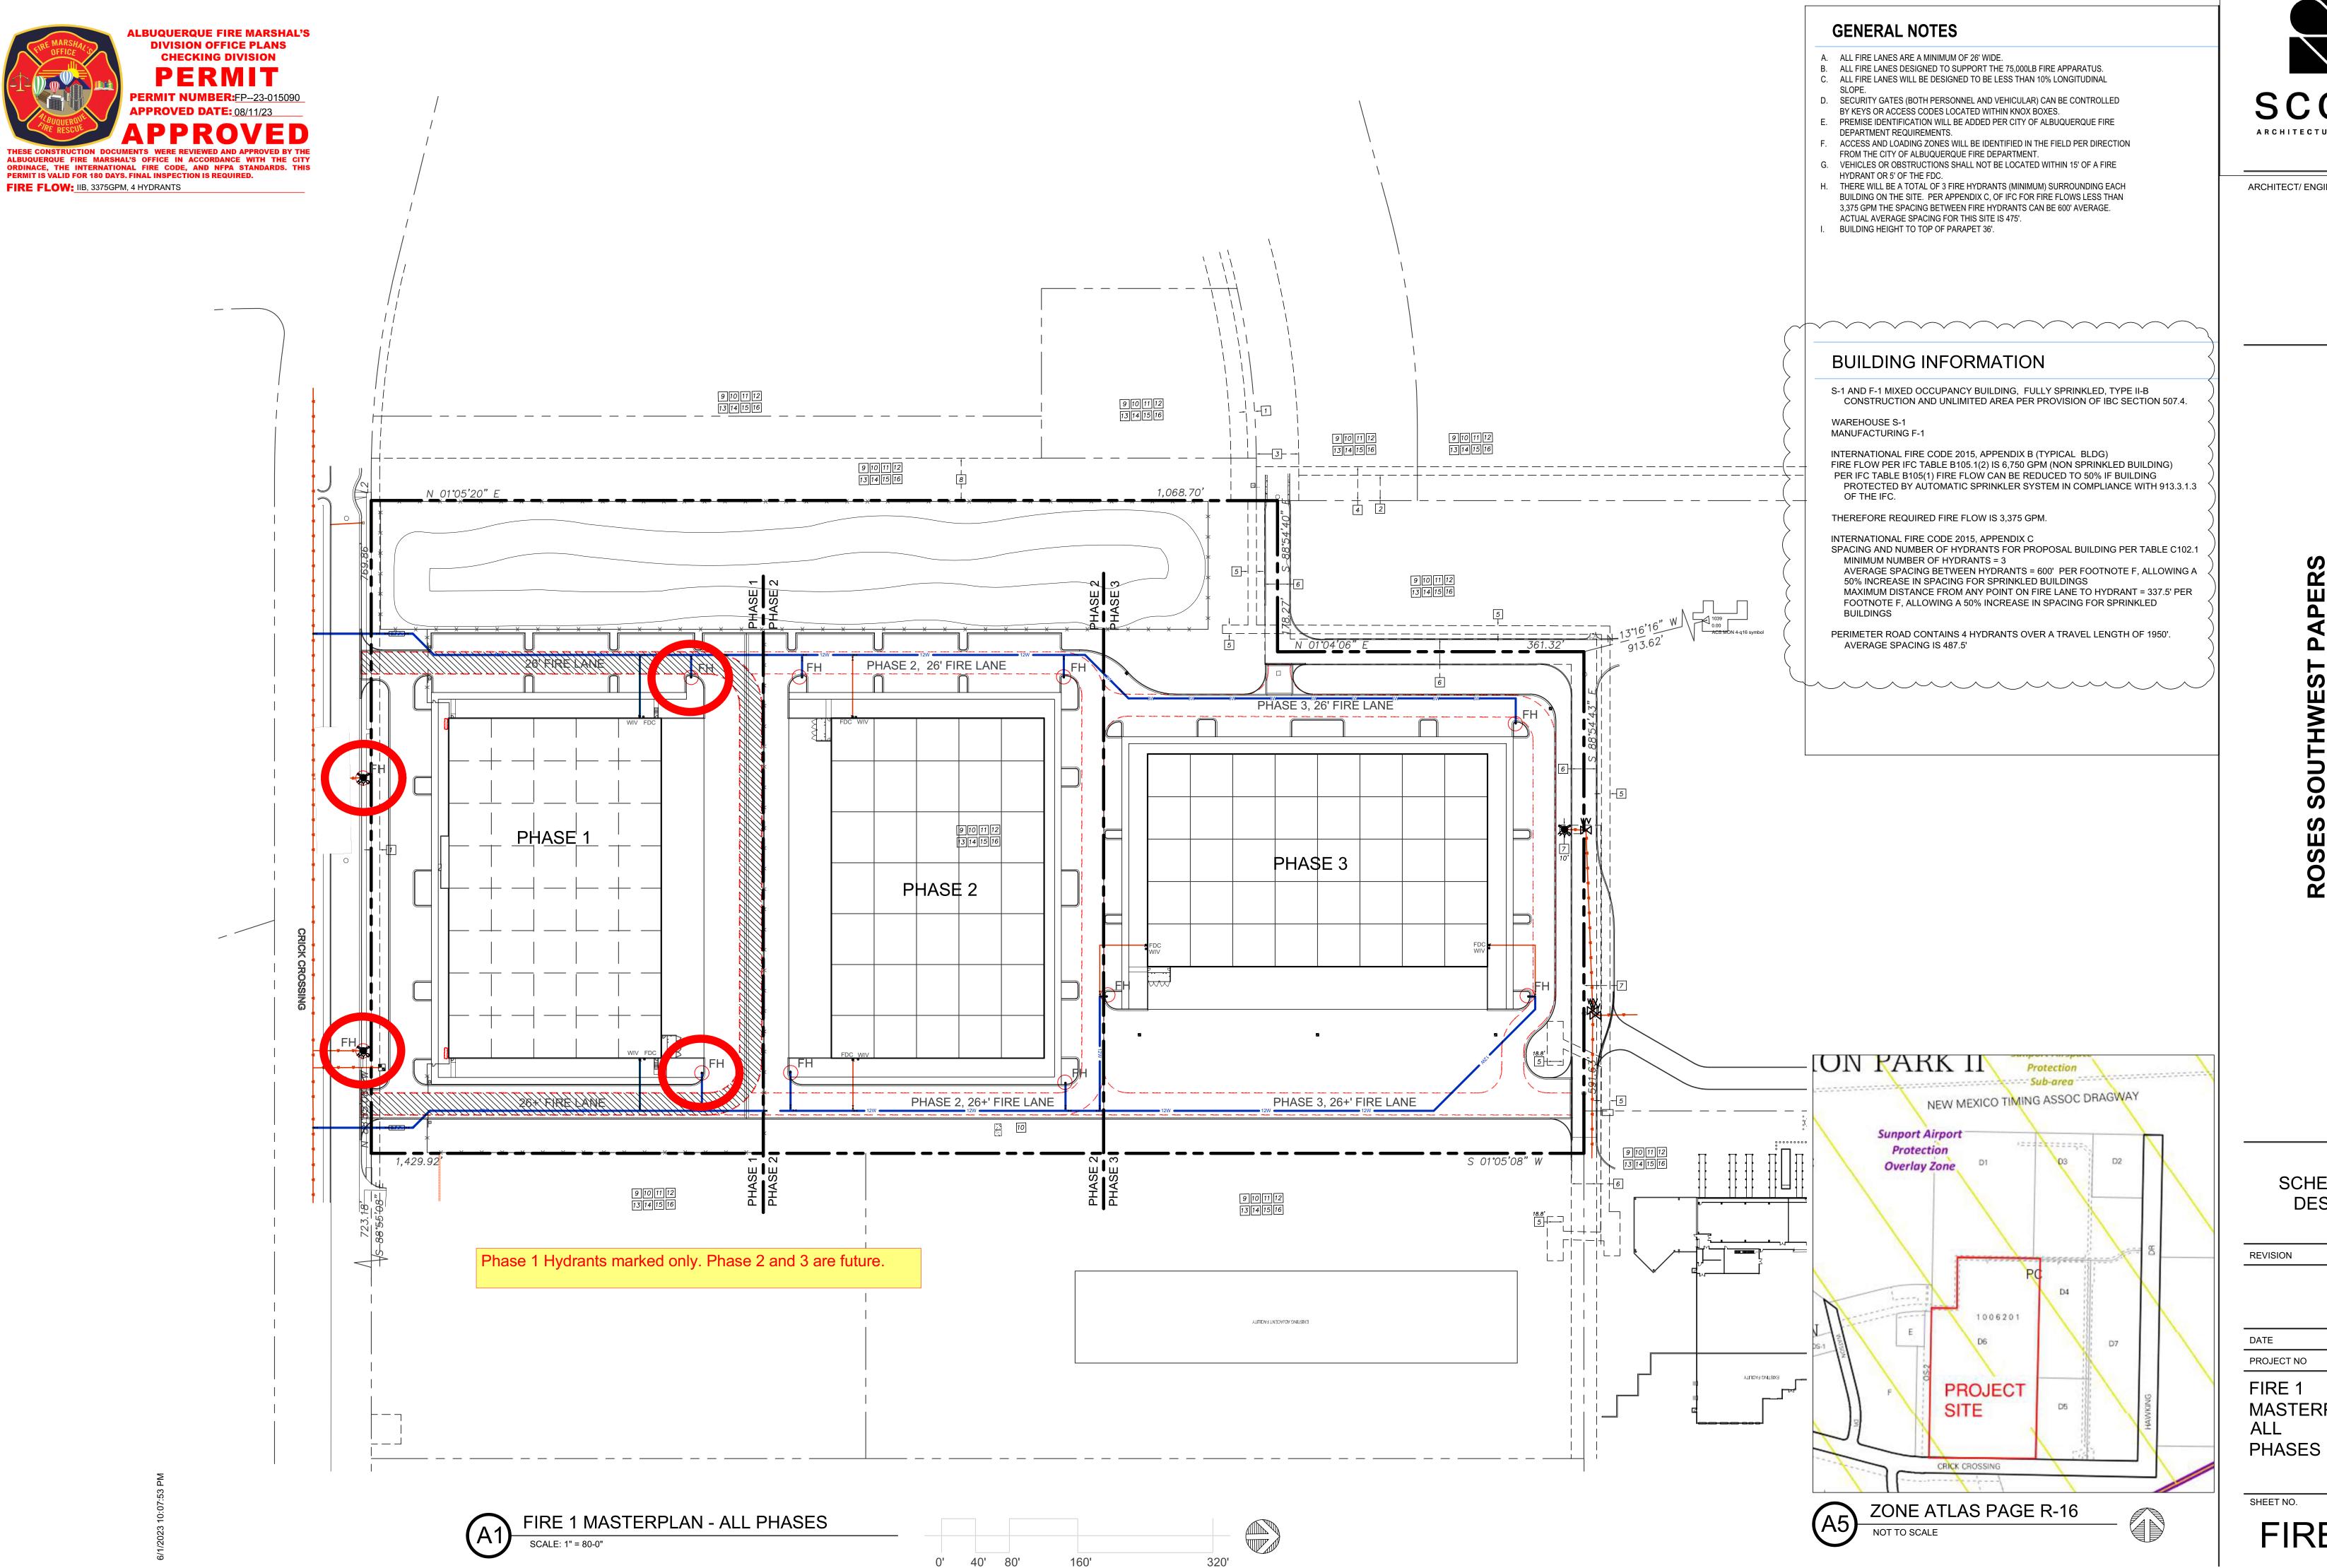

ARCHITECTURE + DESIGN

ARCHITECT/ ENGINEER


SCHEMATIC DESIGN

DATE

8/4/23

MASTERPLAN -

FIRE 1.0

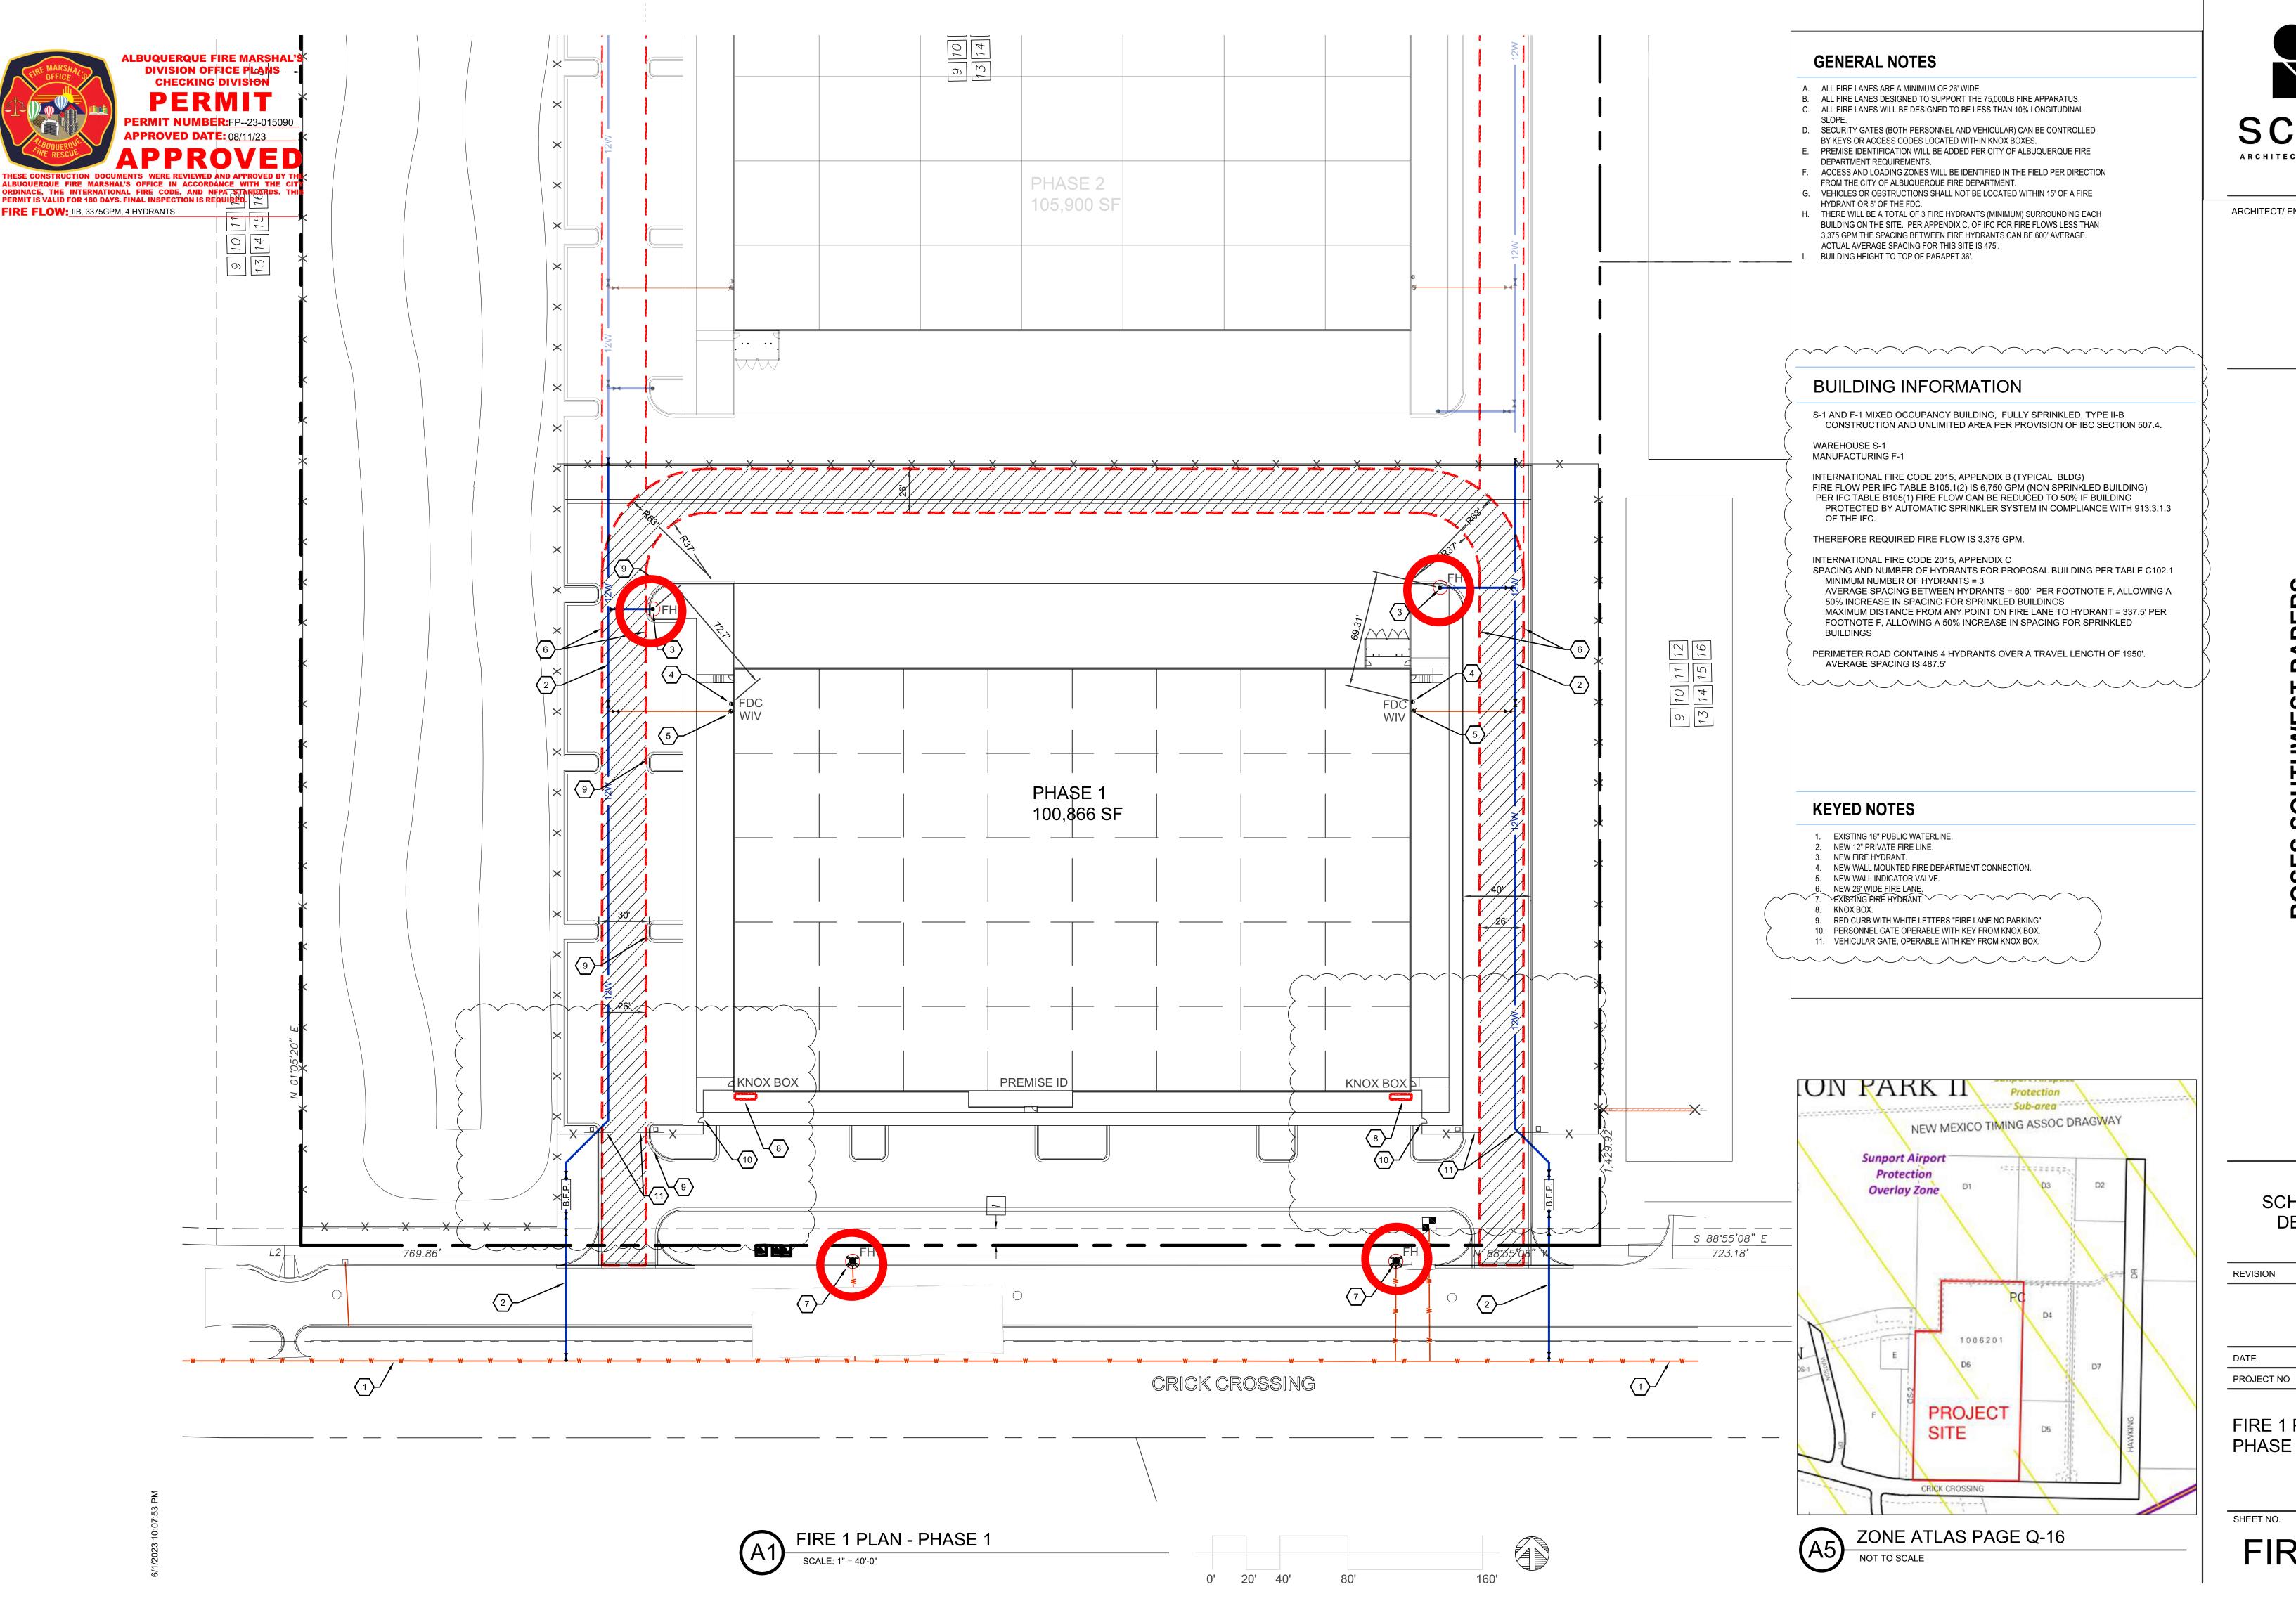

ARCHITECT/ ENGINEER

SCHEMATIC DESIGN


DATE REVISION


FIRE 1 PLAN -

PHASE 1

SHEET NO.

FIRE 1.1

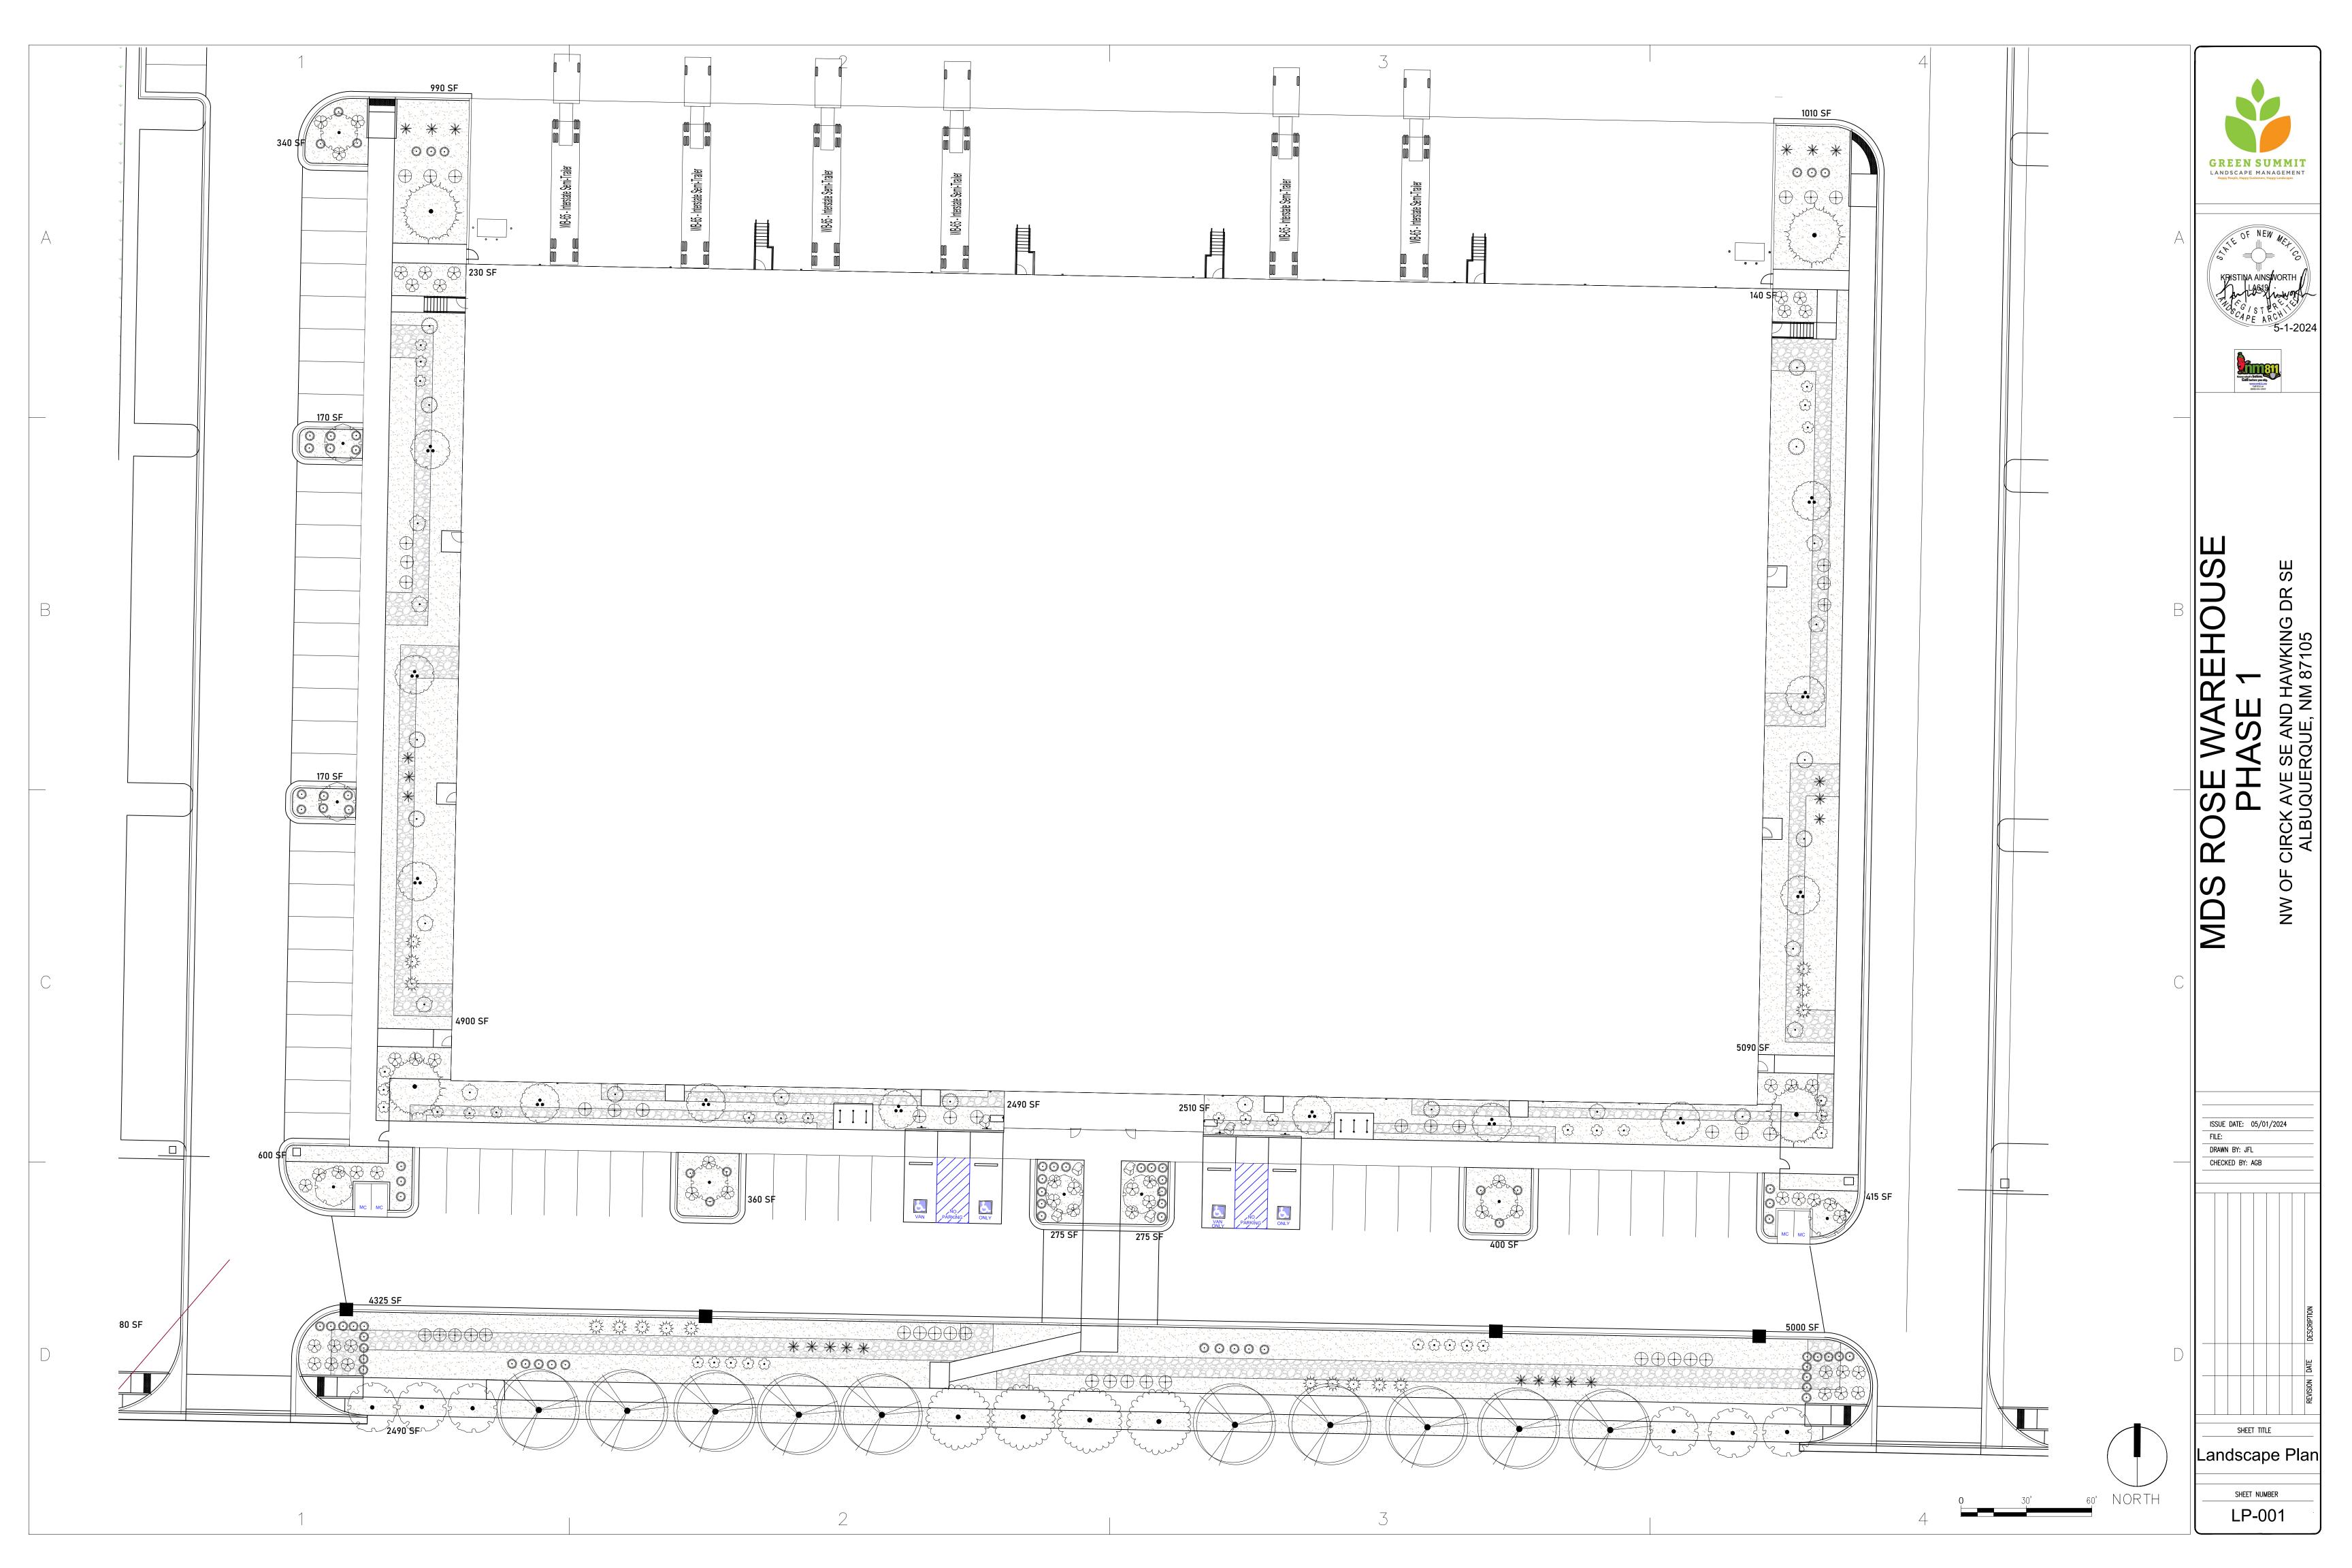

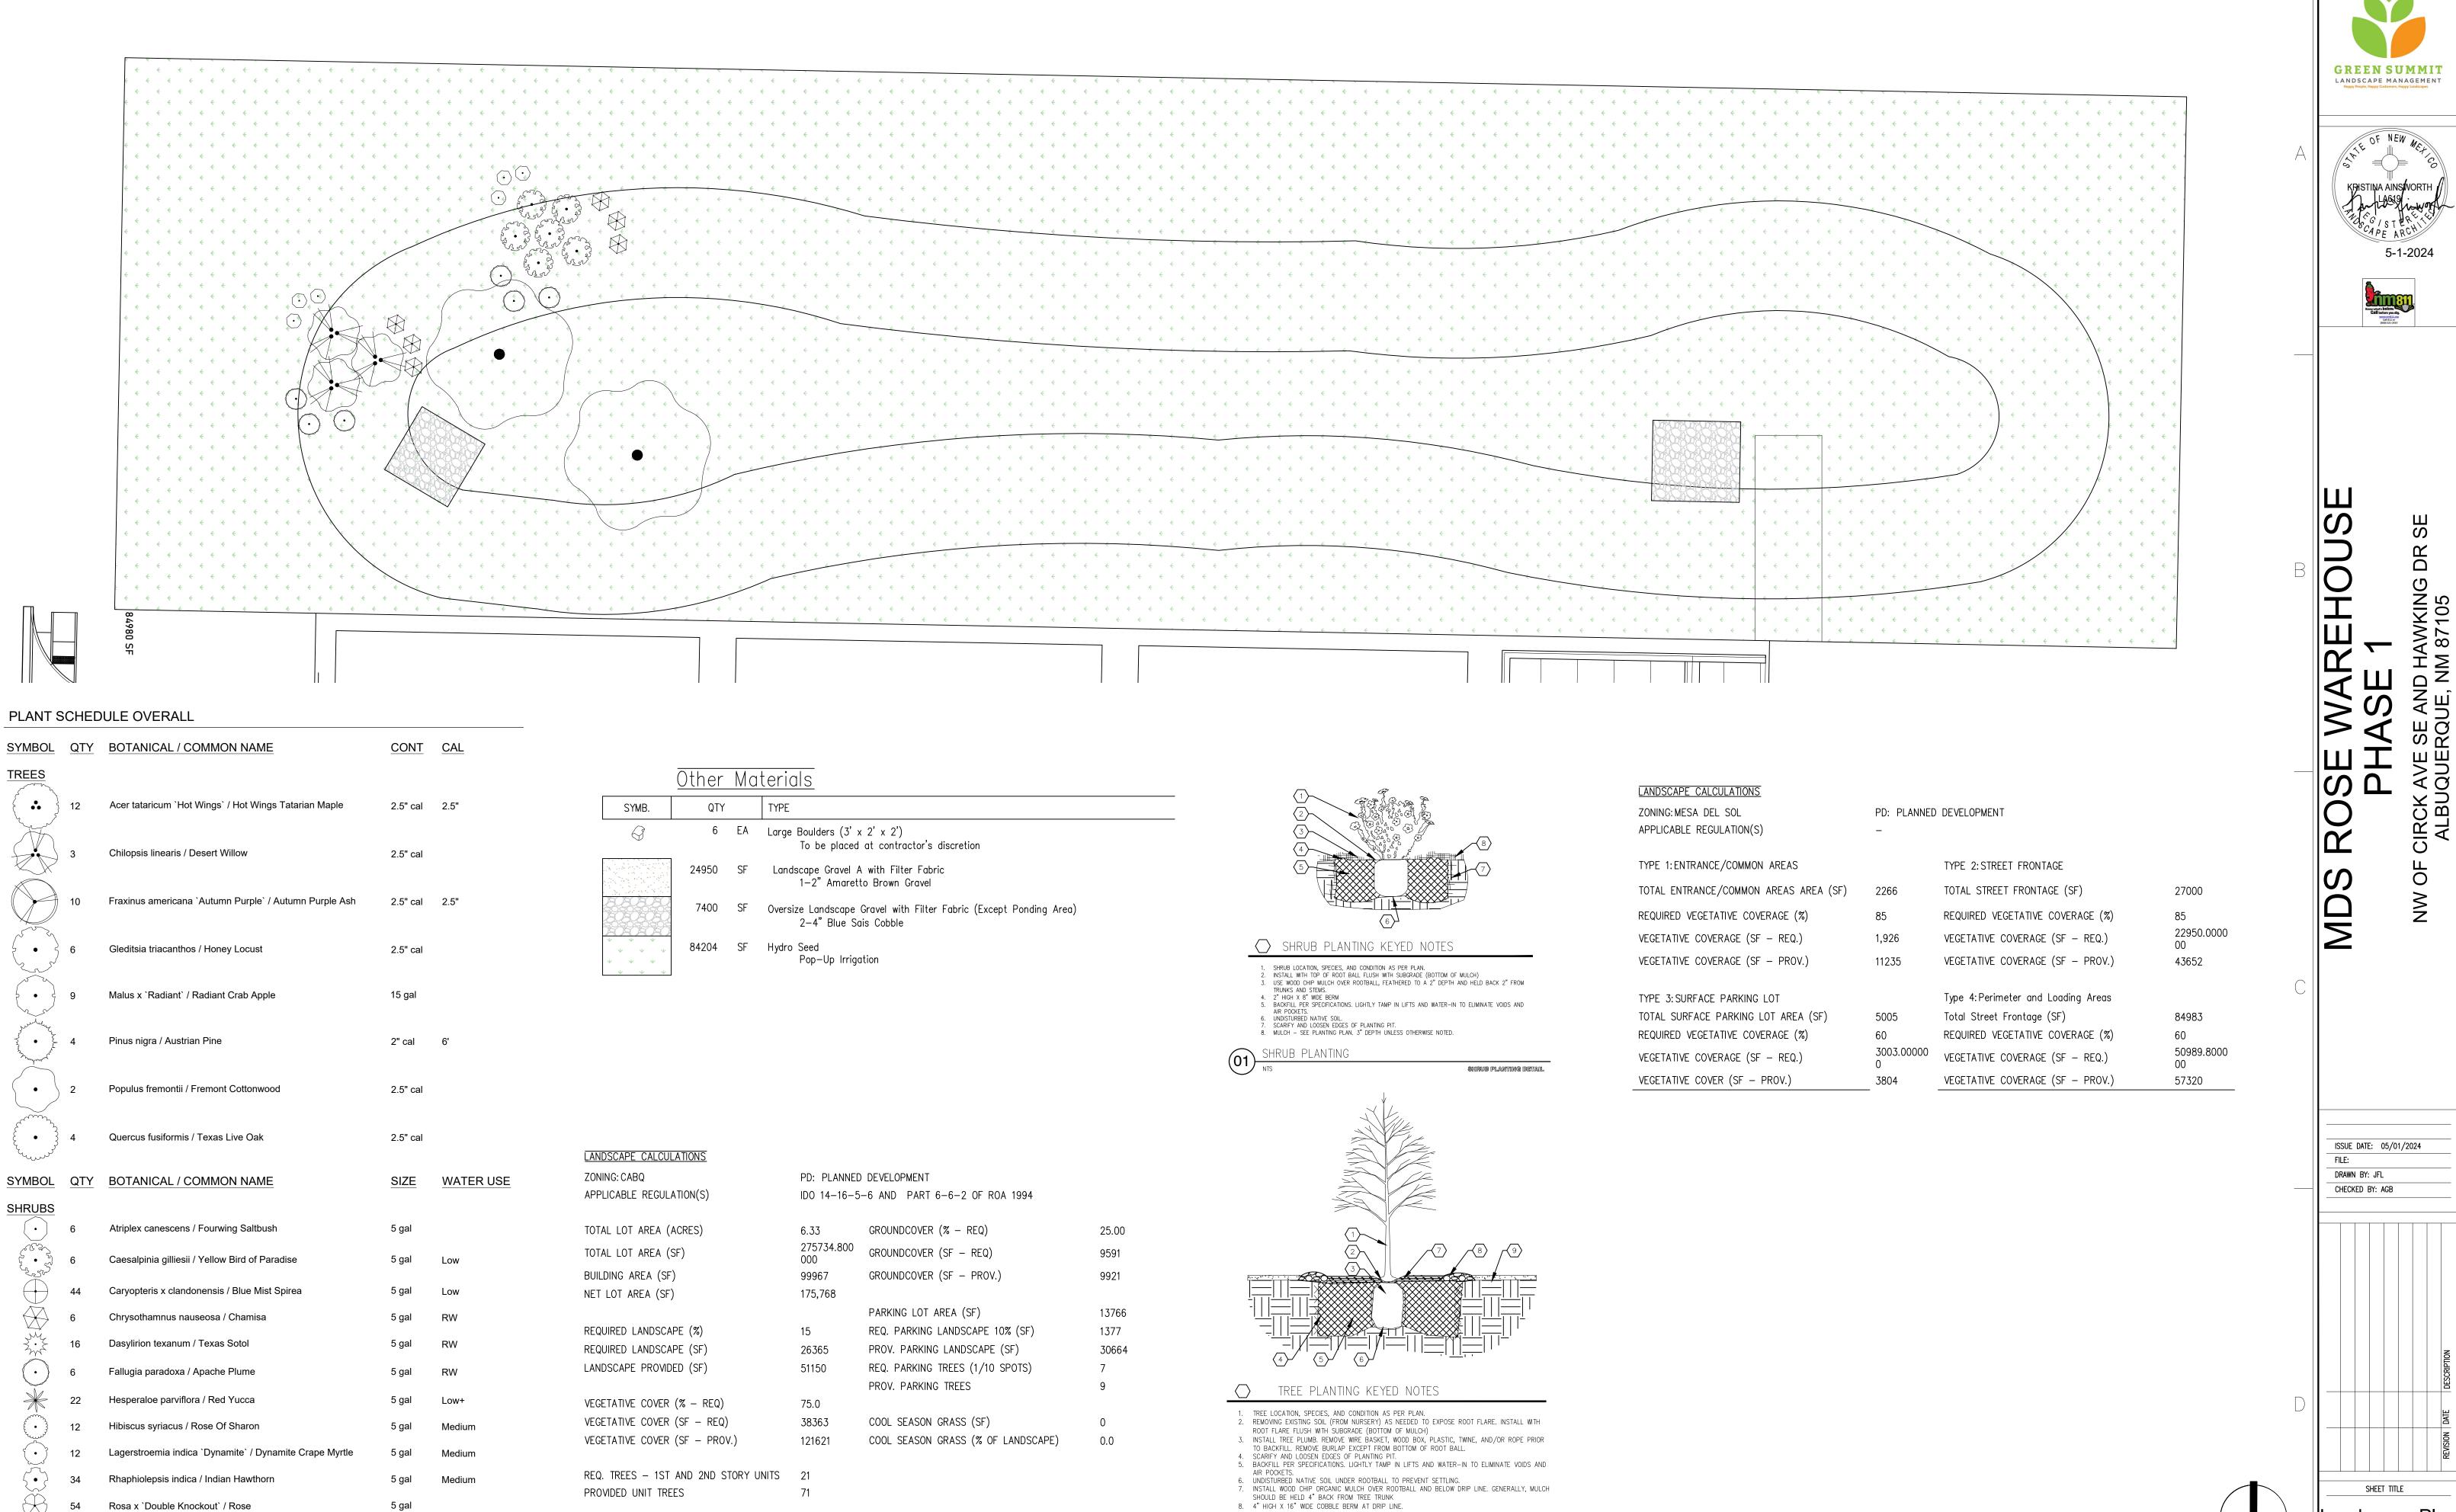


9. MULCH - SEE PLANTING PLAN TREE PLANTING

tree planting detail

GRASSES

Calamagrostis x acutiflora `Karl Foerster` / Feather Reed Grass 1 gal

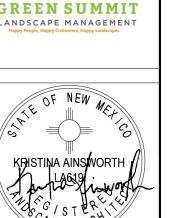




Landscape Plan

SHEET NUMBER LP-002

60' NORTH



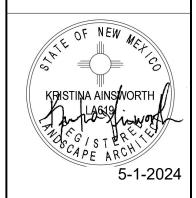




CIRCK AVE SE AND HAWKING ALBUQUERQUE, NM 87105


MDS

ISSUE DATE: 04/18/2024 DRAWN BY: JFL CHECKED BY: AGB

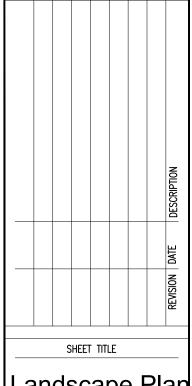

Landscape Plan

SHEET NUMBER LI-001

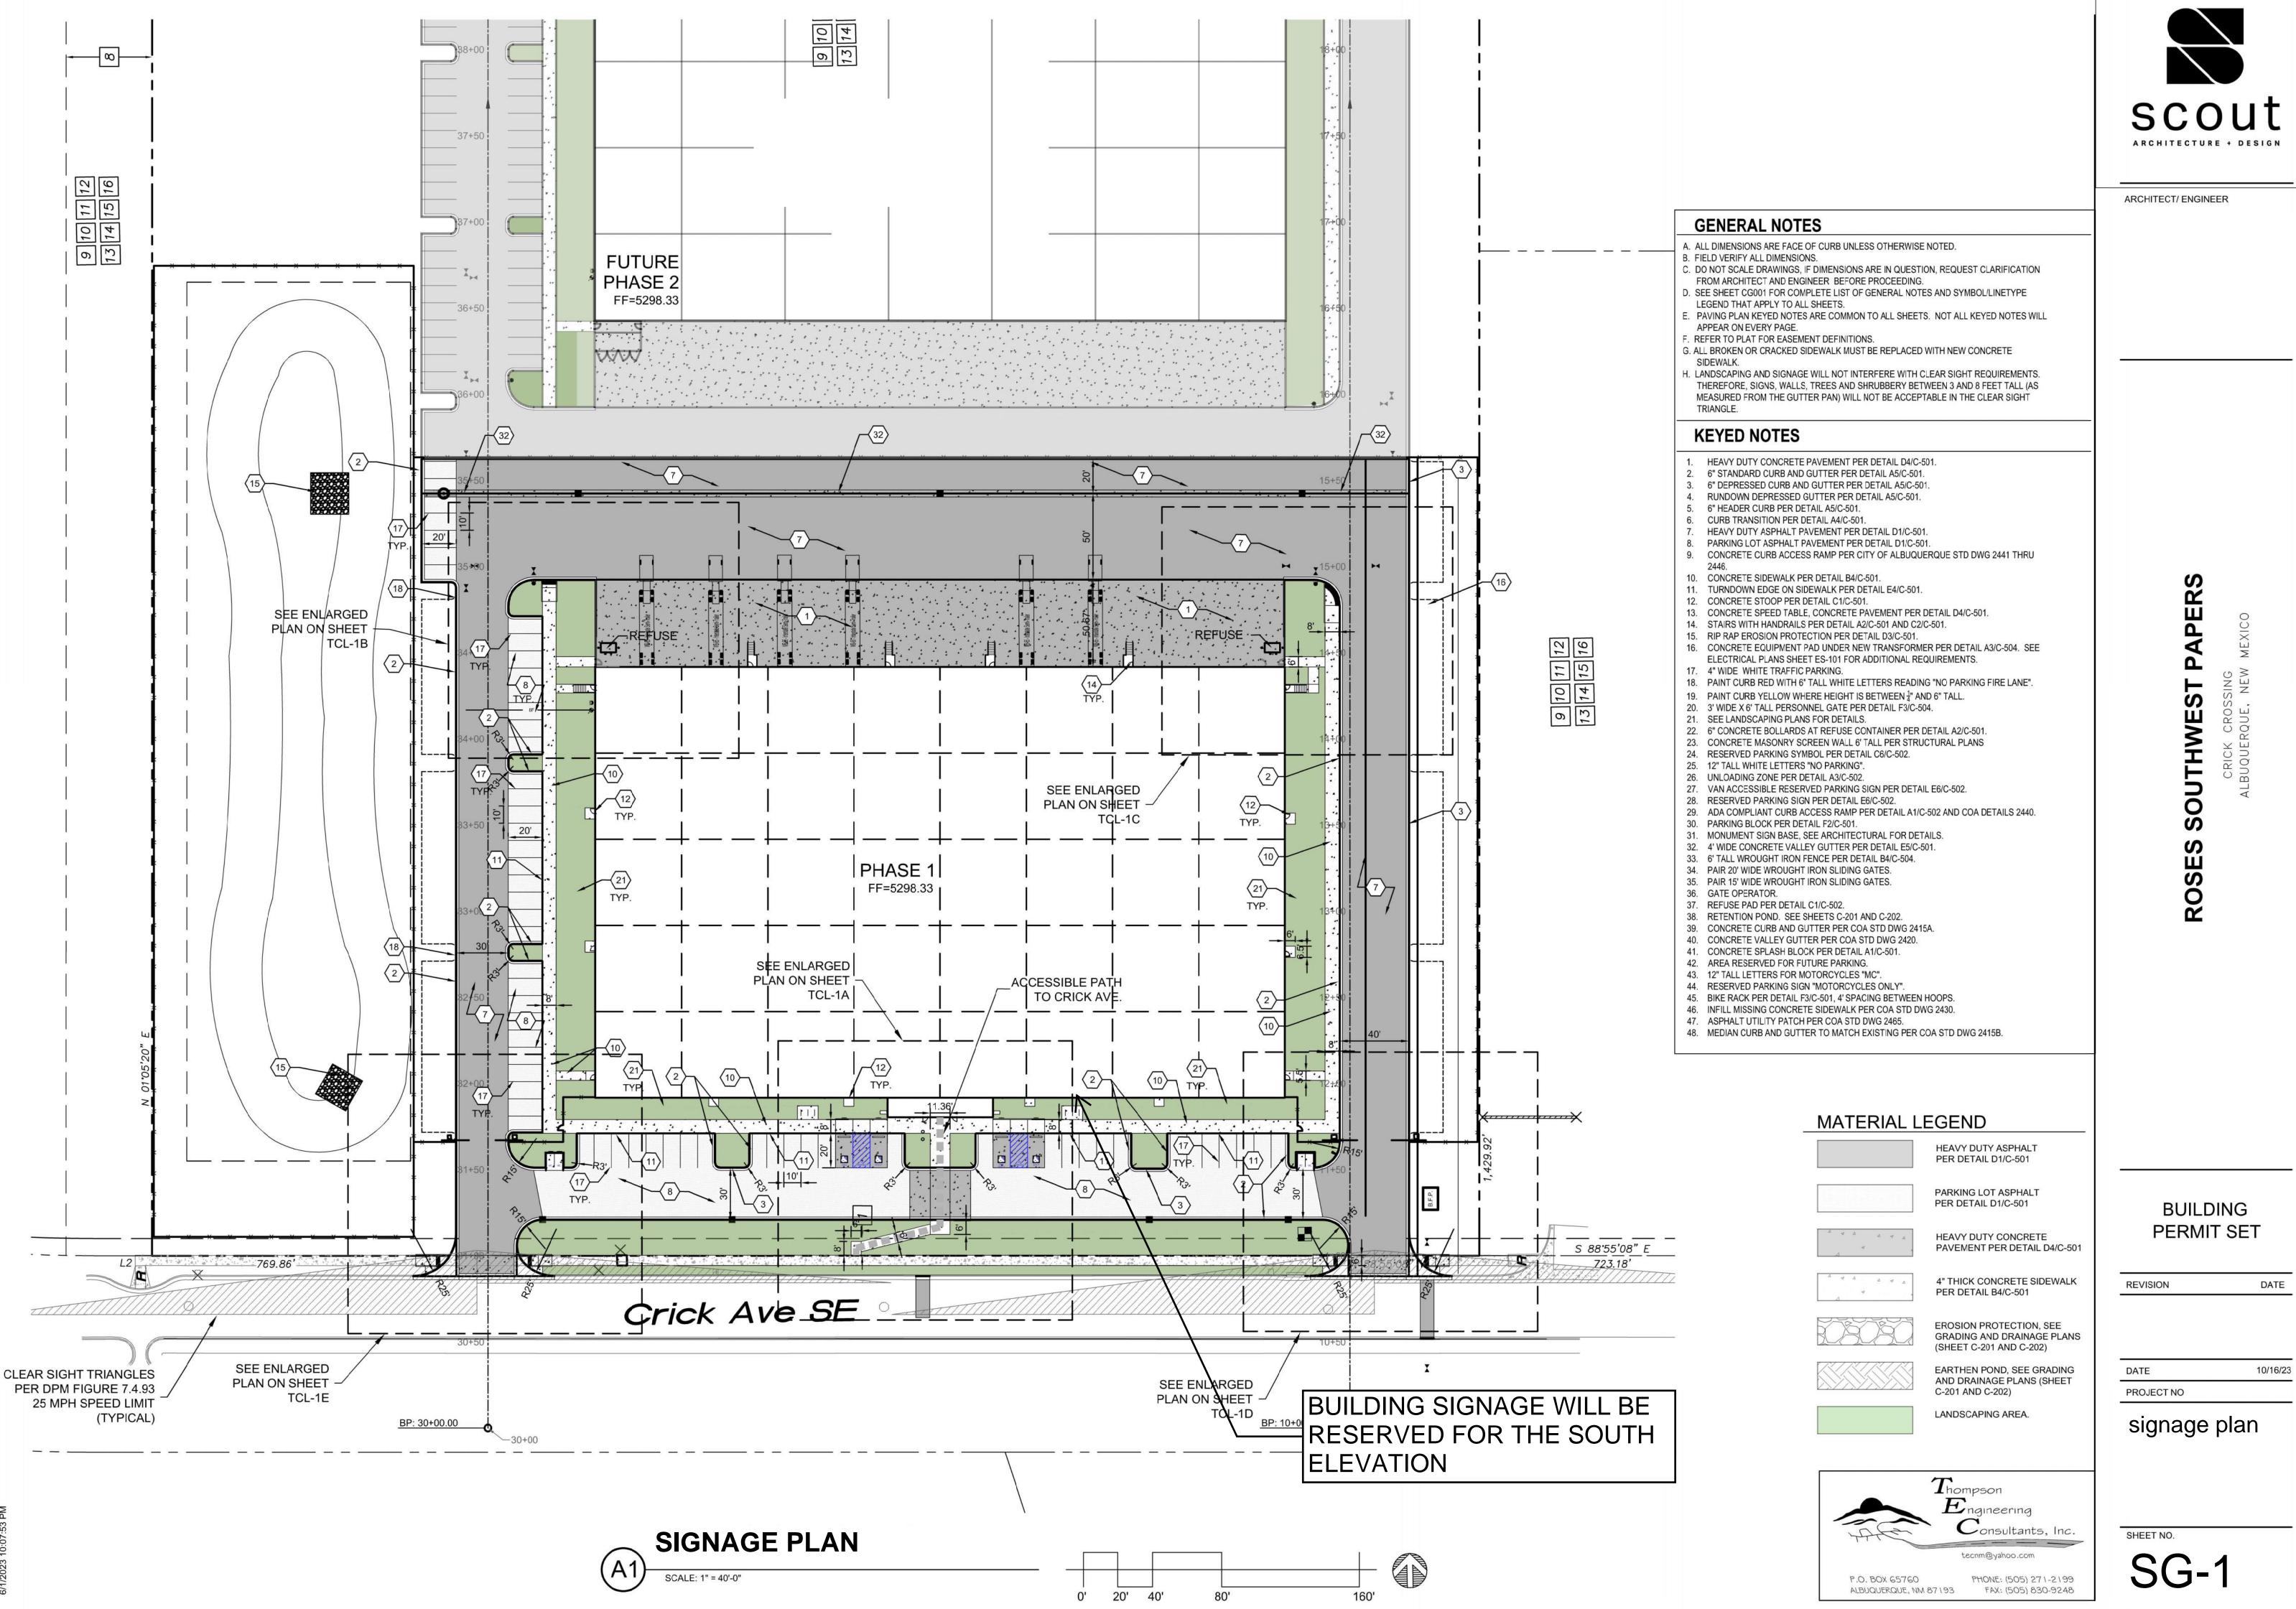

DATE

ENTRY PERSPECTIVE

ARCHITECT/ ENGINEER

ROSES SW PAPERS - WAREHOUSE

NW OF CRICK AVENUE SE AND HAWKING DRIVE SE

MESA DEL SOL ARCHITECTURAL REVIEW STEP 1

DATE

01.02.23

REVISION

DATE

PROJECT NO

CONCEPTUAL ELEVATIONS

SHEET NO.



Dave Aube <daveaube9@gmail.com>

RE: FW: Form 2 for Roses Southwest Papers at 99999 Crick Avenue, SE, Mesa Del Sol

1 message

Wolfley, Jolene <jwolfley@cabq.gov>

Fri, Jun 7, 2024 at 2:54 PM

To: Dave Aube <daveaube9@gmail.com>, "Rodenbeck, Jay B." <jrodenbeck@cabq.gov> Cc: "Chen, Tiequan" <tchen@cabq.gov>, Thompson Engineering consultan <tecnm@yahoo.com>

Dave,

This is an excellent Sensitive Lands Analysis. Sorry that we did not get this reviewed in a timely way and thanks for continuing to inquire.

The report shows that no sensitive lands exist on the subject parcel.

Hydrology can sign the necessary form to move this application to an agenda.

Thanks for your patience. And I do apologize. We are extremely busy right now.



JOLENE WOLFLEY, M.C.P.

associate director o 505.924.3891

e jwolfley@cabq.gov

cabq.gov/planning

From: Dave Aube <daveaube9@gmail.com> Sent: Monday, April 1, 2024 1:07 PM

To: Rodenbeck, Jay B. <jrodenbeck@cabq.gov>

Cc: Wolfley, Jolene <jwolfley@cabq.gov>; Chen, Tiequan <tchen@cabq.gov>; Thompson Engineering consultan <tecnm@yahoo.com>

Subject: Re: FW: Form 2 for Roses Southwest Papers at 99999 Crick Avenue, SE, Mesa Del Sol

[EXTERNAL] Forward to phishing@cabq.gov and delete if an email causes any concern.

Jay

Attached is the Sensitive Lands Analysis for Roses Southwest Papers.

Please let me know if you need any clarification.

Thanks

Dave

Cell 505-463-4503

Good afternoon Dave,

Due to the size of the site (approx. 23.8-acres in size) and the amount of what appears to be ungraded area, a Sensitive Lands Analysis will need to be submitted before Tiequan can sign Form SP for Hydrology.

If confirmation can be provided that the entirety of the site has been graded, such an Analysis won't be required, otherwise it will be required.



Jay Rodenbeck

Planning Manager

Development Review Services

o (505) 924-3994

c (505) 553-0682

e jrodenbeck@cabq.gov

cabq.gov/planning

From: Dave Aube <daveaube9@gmail.com>
Sent: Wednesday, March 27, 2024 5:08 PM
To: Rodenbeck, Jay B. <irodenbeck@cabq.gov>

Cc: Chen, Tiequan <tchen@cabq.gov>

Subject: Re: Form 2 for Roses Southwest Papers at 99999 Crick Avenue, SE, Mesa Del Sol

 $\textbf{[EXTERNAL]} \ Forward \ to \ \underline{phishing@cabq.gov} \ and \ delete \ if \ an \ email \ causes \ any \ concern.$

Jay

Attached is an overall site plan and the ZAP that you requested.

Please let me know if any additional drawings will be helpful in the determination of Sensitive Lands.

Cell 505-463-4503

Thanks

Dave

On Wed, Mar 27, 2024 at 9:33 AM Rodenbeck, Jay B. sjrodenbeck@cabq.gov> wrote:

Good afternoon Dave,

Can you please send me, at the very least, a Site Plan sheet as well as the Zone Atlas Map of the site in question to help determine if a Sensitive Lands Analysis will be required or not.



Jay Rodenbeck

Planning Manager

Development Review Services

o (505) 924-3994

c (505) 553-0682

e jrodenbeck@cabq.gov

cabq.gov/planning

From: Chen, Tiequan <tchen@cabq.gov>
Sent: Wednesday, March 27, 2024 8:51 AM
To: Dave Aube <daveaube9@gmail.com>
Cc: Rodenbeck, Jay B. <jrodenbeck@cabq.gov>

Subject: FW: Form 2 for Roses Southwest Papers at 99999 Crick Avenue, SE, Mesa Del Sol

Hi Dave:

Please contact Jay Rodenbeck asking him if the sensitive land analysis (IDO 5-2(C)) is required. Hydrology needs Planning's review and approval prior to sign off the form SP.

Thanks!



TIEQUAN CHEN, P.E.

principal engineer, hydrology

development review services

o 505.924.3695

e tchen@cabq.gov

cabq.gov/planning

From: Dave Aube <daveaube9@gmail.com>

Sent: Tuesday, March 26, 2024 8:28 PM

To: Armijo, Ernest M. <earmijo@cabq.gov>; Chen, Tiequan <tchen@cabq.gov>; Bergeron, Edwin V. <ebergeron@abcwua.org>

Cc: Thompson Engineering consultan <tecnm@yahoo.com>

Subject: Re: Form 2 for Roses Southwest Papers at 99999 Crick Avenue, SE, Mesa Del Sol

[EXTERNAL] Forward to phishing@cabq.gov and delete if an email causes any concern.

Ernest and all

Attached is the corrected From SP for the Roses Southwest Papers Project. As mentioned previously we are submitting to DFT for Site Plan Approval.

We have received approvals from Hydrology and Transportation. Q16DA5000C

We have the ABCWUA Water and Sewer Availability. #230704

Please fill out and forward on to all listed.

Let me know if you have any questions.

Thanks

Dave

cell 505-463-4503

On Tue, Mar 26, 2024 at 7:32 AM Armijo, Ernest M. <earmijo@cabq.gov> wrote:

Dave,

Form P has changed to Form SP.

Also, do not fill out any of the information below the top lines with name of project location and description. Those are for us to fill out.



ERNEST ARMIJO, P.E., C.F.M.

principal engineer

transportation **o** 505.924.3991

e earmijo@cabq.gov

cabq.gov/planning

From: Dave Aube <daveaube9@gmail.com> Sent: Monday, March 25, 2024 7:06 PM

To: Chen, Tiequan <tchen@cabq.gov>; Armijo, Ernest M. <earmijo@cabq.gov>; Magnanelli, Grant H. <gmagnanelli@abcwua.org>

Cc: Thompson Engineering consultan <tecnm@yahoo.com>

Subject: Form 2 for Roses Southwest Papers at 99999 Crick Avenue, SE, Mesa Del Sol

[EXTERNAL] Forward to phishing@cabq.gov and delete if an email causes any concern.

Good morning

Can you please take a look at the attached Form P2 that is required for our submittal to DFT.

We have included the Project Number and Approval Dates for each of the Approvals/Statements.

Please let me know if you have any questions.

Thanks

Dave

Cell 505-463-4503

Project #: _____ Application #: _____

This checklist will be used to verify the completeness of site plans submitted for review by the Planning Department. Because development proposals vary in type and scale, there may be submittal requirements that are not specified here. Also there may additional requirements if a site is located in CPO, HPO, and/or VPO or if located in DT-UC-MS or PT areas. See the IDO or AGIS for boundaries. Nonetheless, applicants are responsible for providing a complete submittal. Certification as specified below is required.
CERTIFY THAT THE SUBMITTED SITE PLAN IS COMPLETE AND ACCURATE, AND THAT ALL APPLICABLE INFORMATION AS SPECIFIED IN THIS CHECKLIST IS PROVIDED. FURTHER, I UNDERSTAND THAT THIS APPLICATION IS BEING ACCEPTED PROVISIONALLY AND THAT INACCURATE AND/OR INCOMPLETE INFORMATION MAY RESULT IN THE SUBSEQUENT REJECTION OF THE APPLICATION OR IN A DELAY OF ONE MONTH OR MORE IN THE DATE THE APPLICATION IS SCHEDULED FOR PUBLIC HEARING.
Applicant or Agent Signature / Date

Site plan packets shall be composed of the following plan sheets (unless otherwise approved in writing prior to submittal by the Planning Department):

- **1. Site Plan (**including utilities and easements)
- 2. Landscaping Plan
- 3. Grading and Drainage Plan
- 4. Utility Plan
- 5. Building and Structure Elevations
- 6. Previously approved Development Plan (if applicable)

The electronic format must be organized in the above manner.

The following checklist describes the minimum information necessary for each plan element. The Applicant must include all checklist items on their site plan drawings and confirm inclusion by checking off the items below. Non-applicable items must be labeled "N/A." Each non-applicable designation must be explained by notation on the Checklist.

NOTE: There may be addition information required if site is located with a CPO, VPO or HPO and/or any other special areas as defined by the IDO.

NOTE: If there requests for deviations (Section 14-16-6-4(O), they must be clearly labelled on the site plan (Sheet 1) as well as addressed in the application letter made with the submittal.

SHEET #1 - SITE PLAN

A. General Information

X 1. Date of drawing and/or last revision
X 2. Scale: 1.0 acre or less 1" = 10'
1.0 - 5.0 acres 1" = 20'
Over 5 acres 1" = 50'
Over 20 acres 1" = 100' 1" = 80'

- X₃. Bar scale
- X 4. North arrow
- X 5. Legend
- x 6. Scaled vicinity map
- X 8. Existing and proposed easements (identify each)
- <u>X</u> 9. Phases of development, if applicable

B. Proposed Development

1. Structural

- X A. Location of existing and proposed structures (distinguish between existing & proposed) and include any accessory structures
- X B. Square footage of each structure
- X C. Proposed use of each structure
- X D. Signs (freestanding) and other improvements
- X E. Walls, fences, and screening: indicate height, length, color and materials
- X F. Dimensions of all principal site elements or typical dimensions
- X G. Loading facilities
- XH. Site lighting (indicate height & fixture type)
- X I. Indicate structures within 20 feet of site
- NAJ. Elevation drawing of refuse container and enclosure, if applicable.
- X K. Existing zoning/land use of all abutting properties

2. Parking, Loading and Internal Circulation

- X A. Parking layout with spaces numbered per aisle and totaled.

 - X 2. Calculations: spaces required and proposed (include any reduction calculations) for motorcycle, bicycle, compact and ADA spaces
 - NA 3. On street parking spaces
- X B. Bicycle parking & facilities
 - X 1. Bicycle racks location and detail
 - NA 2. Other bicycle facilities, if applicable
- X C. Vehicular Circulation (Refer to DPM and IDO)
 - X 1. Ingress and egress locations, including width and curve radii dimensions
 - X 2. Drive aisle locations, including width and curve radii dimensions
 - X 3. End aisle locations, including width and curve radii dimensions
 - X 4. Location & orientation of refuse enclosure, with dimensions
 - X 5. Loading, service area, and refuse service locations and dimensions
- X D. Pedestrian Circulation
 - X 1. Location and dimensions of all sidewalks and pedestrian paths (including ADA connection from ROW to building and from ADA parking to building)

Location and dimension of drive aisle crossings, including paving treatment <u>X</u> 2. <u>X</u> 3. Location and description of amenities, including patios, benches, tables, etc. NA E. Off-Street Loading Location and dimensions of all off-street loading areas <u>NA</u>F. Vehicle Stacking and Drive-Through or Drive-Up Facilities Location and dimensions of vehicle stacking spaces and gueuing lanes 1. Landscaped buffer area if drive-through lanes are adjacent to public R/W ___ 2. Striping and Sign details for one-way drive through facilities ____ 3. 3. Streets and Circulation X A. Locate and identify adjacent public and private streets and alleys. Existing and proposed pavement widths, right-of-way widths and curve radii _X 1. Identify existing and proposed turn lanes, deceleration lanes and similar features <u>X</u> 2. related to the functioning of the proposal, with dimensions <u>NA</u> 3. Location of traffic signs and signals related to the functioning of the proposal <u>NA</u> 4. Identify existing and proposed medians and median cuts Sidewalk widths and locations, existing and proposed _X_ 5. <u>NA</u> 6. Location of street lights Show and dimension clear sight triangle at each site access point _X_ 7. _**X**_ 8. Show location of all existing driveways fronting and near the subject site. NAB. Identify Alternate transportation facilities within site or adjacent to site Bikeways and bike-related facilities Pedestrian trails and linkages ____ 2. Transit facilities, including routes, bus bays and shelters existing or required ____ 3. 4. Phasing X A. Proposed phasing of improvements and provision for interim facilities. Indicate phasing plan, including location and square footage of structures and associated improvements including circulation, parking and landscaping. SHEET #2 - LANDSCAPING PLAN X 1. Scale - must be same as scale on sheet #1 - Site plan X 2. Bar Scale X 3. North Arrow __x_ 4. Property Lines X 5 Existing and proposed easements X 6. Identify nature of ground cover materials Impervious areas (pavement, sidewalks, slope pavings, curb and gutters, etc.) **X**_B. Pervious areas (planting beds, gravel areas, grass, ground cover vegetation, etc.)

Ponding areas either for drainage or landscaping/recreational use

- X 7. Identify type, location and size of plantings (common and/or botanical names).
 - NAA. Existing, indicating whether it is to preserved or removed.
 - X B. Proposed, to be established for general landscaping.
 - X C. Proposed, to be established for screening/buffering.
- X 8. Describe irrigation system Phase I & II . . .
- X 9. Planting Beds, indicating square footage of each bed
- NA 10. Turf Area only 20% of landscaped area can be high water turf; provide square footage and percentage.
- X 11. Responsibility for Maintenance (statement)
- X 12. Landscaped area requirement; square footage and percent (specify clearly on plan)
- X 13. Landscaped buffer areas provided; dimensions, label clearly that it is a landscape buffer, square footage and percent (specify clearly on plan)
- X 14. Planting or tree well detail
- _x_ 15. Street Trees (only trees from the Official Albuquerque Plant Palette and Sizing list or 8 inch caliper or larger will be counted)
- _X 16. Parking lot edges and interior calculations, dimensions and locations including tree requirements
- 17. Show Edge Buffer Landscaping (14-16-5-6(D)) location, dimensions and plant material

SHEET #3 -GRADING AND DRAINAGE PLAN

A separate grading and drainage plan (and drainage report) must be submitted to the DRS Hydrology Section prior to the DRB submittal for a site plan (See DRWS Form).

A. General Information

- X 1. Scale must be same as Sheet #1 Site Plan
- _X 2. Bar Scale
- X 3. North Arrow
- X 4. Property Lines
- _x_ 6. Building footprints
- NA 7. Location of Retaining walls

B. Grading Information

- Y 1. On the plan sheet, provide a narrative description of existing site topography, proposed grading improvements and topography within 100 feet of the site.
- _X 2. Indicate finished floor elevation and provide spot elevations for all corners of the site (existing and proposed) and points of maximum cut or fill exceeding 1 foot.
- X 3. Identify ponding areas, erosion and sediment control facilities.
- NA 4. Cross Sections

Provide cross section for all perimeter property lines where the grade change is greater than 4 feet at the point of the greatest grade change. Provide one additional cross section in each direction within no more than 100 feet of the reference point.

SHEET #4- UTILITY PLAN

- X A. Fire hydrant locations, existing and proposed. (or submit signed off Fire One Plan)
- X B. Distribution lines
- **X** C. Right-of-Way and easements, existing and proposed, on the property and adjacent to the boundaries, with identification of types and dimensions.
- X D. Existing water, sewer, storm drainage facilities (public and/or private).
- X E. Proposed water, sewer, storm drainage facilities (public and/or private)
- X F. Existing electric lines both overhead and underground. Power Poles shown with dimensions to proposed buildings and structures must be clearly shown.

SHEET #5 - BUILDING AND STRUCTURE ELEVATIONS

A. General Information

- X A. Scale
- X_B. Bar Scale
- X C. Detailed Building Elevations for each facade
 - X 1. Identify facade orientation
 - X 2. Dimensions of facade elements, including overall height and width
 - X 3. Location, material and colors of windows, doors and framing
 - X 4. Materials and colors of all building elements and structures
 - X 5. Location and dimensions of mechanical equipment (roof and/or ground mounted)

B. Building Mounted Signage

- X 1. Site location(s)
- X 2. Sign elevations to scale
- X 3. Dimensions, including height and width
- X 4. Sign face area dimensions and square footage clearly indicated
- X 5. Lighting
- X 6. Materials and colors for sign face and structural elements.
- X 7. List the sign restrictions per the IDO

Attention: Planning Department

Re: Roses Southwest Papers

Request for Approval of Site Plan Administrative - DFT

Dear Planning Department:

We are writing on behalf of our client, Roses Southwest Papers to request approval of a Site Plan Administrative for a proposed three Phase Warehouse Project in Mesa Del Sol located on Crick Avenue SE between Waston Drive SE and Hawking Drive SE. The current lot is described as TR D-6 PLAT OF TRACTS D-1 THRU D-7 MESA DEL SOL INNOVATIONPARK II (A SUBDIVISION OF TRACT D MESA DEL SOL INNOVATIONPARK II) CONT 23.7954 AC.

The zoning designation for this property is PC (Planned Community) under the Mesa Del Sol Community Masterplan (MDSCMP). The MDSCMP has identified this location for Industrial Facilities and the Mesa Del Sol Architectural Review Committee has approved the project as compliant with the MDSCMP standard.

The site contains 23.8 acres and will contain three 100,000sf warehouse buildings, constructed in phases. This request is for all three phases. Plans have been submitted and approved by Hydrology, Transportation, ABCWUA, Solid Waste and Fire. The approved plans are included in the package for easy reference.

Landscaping and Lighting Plans are only developed for the first phase, and will be similar for the remaining phases.



Aerial of the Site.



Image of site looking north-west.



Image of site looking north.

In preparation for this submittal, the Office of Neighborhood Coordination (ONC) was contacted to identify any Neighborhood Association (NA) in the area. At this time there are no recognized (registered with the ONC) Neighborhood Associations. This is mentioned as the standard is to require that a Information meeting be

conducted with the NA prior to application to DFT. We confirmed with City staff that this requirement if void if there are no registered NA in the area.

Per Section 16-6-5(G)(3)(a) the Site Plan has been developed in compliance with the IDO and DPM as reflected in the approvals from the separate engineering departments.

Per Section 16-6-5(G)(3)(b) the MDSCMP requires that stormwater for the 100-year event be fully retained on site. The site has been designed to meet those requirements, and therefore will not burden the public stormwater infrastructure surrounding the site.

Water and Sanitary Sewer for the project can be supplied by ABCWUA. We have received a Water and Sewer Availability and Serviceability Statement from the ABCWUA. The site has been designed in accordance to the requirements contained in the ABCWUA Statement. No Public Work Order is required for utility extensions.

The Roadway system is still being developed in the area. The northern have street section for Crick Avenue is fully developed including curb and gutter and sidewalk with street trees. No Public Work Order for roadway improvements.

Because the surrounding streets and utilities are developed this site will not require public improvements to be constructed. No Infrastructure Improvements Agreement will be required.

Per Section 16-6-5(G)(3)(c) the site has been checked by the MDSMCP Architectural Review Committee to determine that relevant sections of the Master Development Plan have been included in the design.

Section 16-6-5(G)(3)(d) does not apply to this property as it is not within a Framework Plan.

Thank you for your consideration. We look forward to hearing from you.

Please do not hesitate to contact me at (505) 414-6212 if you have any questions or require additional information.

Sincerely,

cc:

Shannon VanDusen

C:\Coalescense\Roses Papers\DFT Site Plan\Justificaiton Letter ROSES SWP 5-23-24.doc



December 19th, 2023

City of Albuquerque Planning Department

To Whom it May Concern:

Please accept the following as the authorization letter for our civil engineer Thompson Engineering Consultant, Inc. to act as our agent for the purpose of processing the administrative Design Facilitation Team approval process for site plan for the project at 99999 Hawking Drive, Albuquerque 87106. This is BP# - 40671. Project is located at NW of Crick Avenue SE and Hawking Drive SE.

If you have any questions, please feel free to contact me at 505.842.0134.

Thank you,

Robert Espat

President

Espat Opportunity Zone Fund LLC.

robespat@rosesnm.com

http://www.rosessouthwest.com

phone 505.842.0134



Tim Keller, Mayor Sarita Nair, CAO

City of Albuquerque

P.O. Box 1293 Albuquerque, NM 87103

Planning Department

Alan Varela, Interim Director

DATE: February 26, 2	2024 que Archaeological Ordinance - Compliance Documentation
SUBJECT: Amuduen	que Archaeological Ordinance - Compliance Documentation
Case Number(s):	PR-2019-001971
Agent:	SCOUT design
Applicant:	Espat Opportunity Fund LLC
Legal Description:	TR D-6 PLAT OF TRACTS D-1 THRU D-7 MESA DEL SOL INNOVATIONPARK
Zoning:	PC
Acreage:	23.79 acres
Zone Atlas Page(s):	Q-16-z
CERTIFICATE OF CERTIFICATE OF SUPPORTING DO Historic Googel Earth	FAPPROVAL: Yes V No
SITE VISIT: n/a	
RECOMMENDAT	TIONS:
	d clear by 2009 and previously surveyed under NMCRIS 109134 with no significant finds,
	ATE OF NO EFFECT ISSUED-under 6-5(A) (3)(a) criterion 1 "an archaeological investigation has nd criterion 2 "The property has been disturbed through previous land use"

SUBMITTED BY:

SUBMITTED TO:

Planning, Development Services

Douglas H. M. Boggess, MA, RPA Date
Senior Principal Investigator
Acting City Archaeologist
Lone Mountain Archaeological Services, Inc.

Mesa del Sol Architectural Review Committee 5700 University Blvd. SE Ste. 300 Albuquerque, New Mexico 87106

May 10th, 2024

Scout Architecture and Design 4215 Avenida La Resolana NE Albuquerque, NM 87110

Re: Mesa del Sol Architectural Review Committee
Step 2 Submission Approval for Roses Southwest Papers

Dear Scout Architecture and Design Team,

This letter serves as formal confirmation of the Mesa del Sol Architectural Review Committee's (MdS ARC) approval of the Roses Southwest Papers Step 2 Submission. The submission, initially dated February 7th, 2024, underwent a series of acknowledgments and responses on February 12th, 2024, March 22nd, 2024, April 4th, 2024, and May 3rd, 2024. We are pleased to announce that the approval response has been finalized as of May 10th, 2024.

The MdS ARC grants approval for the Step 2 Submission, taking into account the acknowledgments and responses outlined in the aforementioned correspondences. The resubmission of plans includes the following details:

Project Title: ROSES SOUTHWEST PAPERS

Project Address: NW OF CRICK AVENUE SE AND HAWKING DRIVE SE, ALBUQUERQUE, NM 87105

Project Number: REVISION 003 / ARC COMMENTS 05.03.24

• Project Dated: 10.12.23

For additional information regarding this submission and its approval, please contact the Mesa del Sol Architectural Review Committee. We anticipate a collaborative effort in the development of Roses Southwest Papers and look forward to working closely with you.

Sincerely,

Jerome Gonzales

Jerome Gonzales

Architectural Review Committee

Mesa del Sol

DFT SIGN POSTING AGREEMENT – A PUBLIC NOTICE REQUIREMENT

All development applications are required to complete public notice under the Integrated Development Ordinance, Section 6-1, Table 6-1-1. https://www.cabq.gov/planning/codes-policies-regulations/integrated-development-ordinance-1 All applicants are obligated to satisfy all of the public notice requirements, i.e., sending email notifications, mailing notices, and posting signage on the subject property. **This form covers posting signs.** Adherence to sign posting requirements will inform the public of a proposed project and relevant project details.

Signs should be picked up at the Development Review Services office, located at 600 2nd St in the Plaza Del Sol building. Signs are available upon the acceptance of the application. The cost for the signs is included in the project application fee. It is critical that the signs be prominently located and clearly visible without any obstructions from each street frontage.

Applicants are responsible to maintain posting from time of application through the appeal period (15 days following a final decision on the application). Signs must be posted within 3 days of application acceptance and remain for at least 15 days. Evidence of the sign posting must also be provided within 3 days. In addition, applicants must ensure that required signs are in place during the 15-day appeal period after the project approval. Evidence of posting includes: Time stamped photographs of the sign at the location must be submitted as a supplement to the application.

Failure to install or replace the signs during the required timeframe may result in your application being deferred.

LOCATION

- A. The sign shall be conspicuously located, i.e, within twenty feet of the public sidewalk (or edge of a street).
- B. The face of the sign shall be parallel to the street.
- C. No barrier shall prevent a person from coming within five feet of the sign to read it.

NUMBER

- A. One sign shall be posted on each street frontage.
- B. If the land does not abut a public street, a sign shall be placed at the edge of the public right-of-way of the nearest paved street, in addition to the sign placed on the property.

PHYSICAL POSTING

- A. A heavy stake with two crossbars or a full plywood backing works best to keep the sign in place, especially during high winds.
- B. Large nails or staples are best for attaching signs to a post or backing; the sign tears out less easily.

I have read and understand all of the public notice requirements. By my signature, I acknowledge that: I understand (A) I have read the sign posting requirements; (B) I understand my obligation to keep the signs posted for (15) days at the time of application, and (15) days after application approval, (C) where/how the sign(s) should be posted, and (D) agree to provide evidence of posting.

I further certify that the required public notice signs were posted per the instructions above.

SIGNATURE & DATE:		
Oad B Home	6-11-24_	
PROJECT NUMBER & ADDRESS:		
Roses Southwest Papers		
99999 Crick Avenue, SF		



Dave Aube <daveaube9@gmail.com>

99999 Hawking Drive SE _Public Notice Inquiry Sheet Submission

1 message

Flores, **Suzanna A.** <Suzannaflores@cabq.gov> To: Dave Aube <daveaube9@gmail.com>

Wed, Jun 12, 2024 at 2:49 PM

Dear Applicant:

As of June 12, 2024 there are **NO** neighborhood associations to notify. You will need to attach a copy of this e-mail from the Office of Neighborhood Coordination (ONC) to your application when you submit it to the Planning Department.

Please note that the ONC does not have any jurisdiction over any other aspect of your application beyond this neighborhood contact information. We can't answer questions about sign postings, pre-construction meetings, permit status, site plans, buffers, or project plans, so we encourage you to contact the Planning Department at: 505-924-3857 Option #1, e-mail: devhelp@cabq.gov, or visit: https://www.cabq.gov/planning/online-planning-permitting-applications with those types of questions.

Thank you,

Suzie



Suzie Flores

Senior Administrative Assistant

Office of Neighborhood Coordination (ONC) | City Council Department | City of Albuquerque

(505) 768-3334 Office

E-mail: suzannaflores@cabq.gov

Website: www.cabq.gov/neighborhoods

Public Notice Inquiry For:

Administrative Decision

If you selected "Other" in the question above, please describe what you are seeking a Public Notice Inquiry for below:

Contact Name

David Albert Aube

Telephone Number

5054634503

Email Address

daveaube9@gmail.com

Company Name

Company Address

4590 Nicole Court

City

Missoula

State

MT

ZIP

59803

Legal description of the subject site for this project:

UPC: 101605227405540202

Owner: ESPAT OPPORTUNITY ZONE FUND LLC

Owner Address: 1701 2ND ST NW ALBUQUERQUE NM 87102-4505

Situs Address: HAWKING DR SE ALBUQUERQUE 87105

Legal Description: TR D-6 PLAT OF TRACTS D-1 THRU D-7 MESA DEL SOL INNOVATIONPARK II (A SUBDIVISION OF TRACT D MESA DEL

SOL INNOVATIONPARK II) CONT 23.7954 AC

Physical address of subject site:

999999 Hawking Drive SE (address not yet assigned)

Subject site cross streets:

Crick Crossing

Other subject site identifiers:

This site is located on the following zone atlas page:

Q-16

Captcha

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