

Overlay Zones	N/A		
Allowable Uses	Table 4-2-1 Dwelling, single-family detached		
Use-specific Standards	IDO section 4-3(B)(1)(a) Dwelling, singlefamily Detached		
Dimensional Standards, Tables, and	IDO section 5-1(C)(1) Residential Zone		
Exceptions	District Table, Table 5-1-1 Residential Zone		
	District Dimensional Standards (R-1A		
	standards)		
Site Design and Sensitive Lands	IDO sections 5-2(C)(2)(b), 5-2(C)(4) Site		
	Design to Avoid Sensitive Lands		
Access and Connectivity	IDO sections 5-3(C) General Access and		
	Circulation, 5-3(D) Pedestrian Circulation,		
	5-3(E) Subdivision Access and Circulation		
Subdivision of Land	IDO section 5-4(C) Compliance with Zoning		
	Requirements		
Parking and Loading	IDO section 5-5(C)(1) Off-street Parking		
	Calculations, Table 5-5-1 Minimum Off-		
	street Parking Requirements (Dwelling,		
	single-family detached) and 5-5(F)(2)(a)		
	Design Access and Circulation		


Landscaping, Buffering, and Screening	Per IDO single-family detached homes do
	not require a landscape plan. One has bee
	submitted as part of this request, but it is
	not a requirement. Buffering shall follow
	and exceed IDO section 5-6(E)(5)(a) Area o
	Change Next to Area of Consistency, Table
	5-6-5 Edge Buffer buffering in DT-UC-MS-
	PT and provide a wall fence or vegetative
	screen greater than or equal to 6 ft.
Walls and Fences	IDO Table 5-7-1 Maximum Wall Height
Outdoor and Site Lighting	N/A
Neighborhood Edges	N/A
Solar Access	IDO section 5-10(C) Building Height, Table
	5-10-1 Solar Rights Maximum Building
	Heights
Building Design	IDO section 5-11(C) Low-density Residenti
	Development
Signs	IDO section 5-12(E) Standards Applicable
	All Signs
Operation and Maintenance	IDO section 5-13(B)(2) Building and
	Structures

• This property is encumbered by a Flood Hazard Area - Zone AH with a water surface elevation of 4981.0. Camino Español is flat with no curb and gutter and currently drains onto the adjacent properties where the water ponds. The adjacent residential developments to the west and south which are in the same flood zone contain the storm water on their properties--there are existing walls along the west and south property lines that prevent storm water from coming onto the Spanish Walk property.

• To address the Flood Hazard Area (Zone AH), a Letter of Map Revision Based on Fill (LOMR-F) will be prepared and submitted to FEMA for the lots located within the flood hazard area. The site will be graded, in accordance with the approved grading and drainage plan, to raise the building pads a minimum of one foot above the Zone AH water surface elevation. The storm water from the site and half of Camino Español will be directed to two retention ponds (on the east and west sides of the subdivision) that are sized to retain the storm water volume from the 100-year, 10-day storm. The LOMR-F will remove the flood plain from the lots that are currently in the flood hazard area.

- This is a representation of the approved lot layout, but slight changes could occur at the DHO with the
- Any existing and/or new PNM easements and facilities shall be reflected on any resulting future Site Plan or Plat. • Perimeter and interior landscape design shall abide by any easement restrictions and not impact PNM facilities.

SITE VICINITY

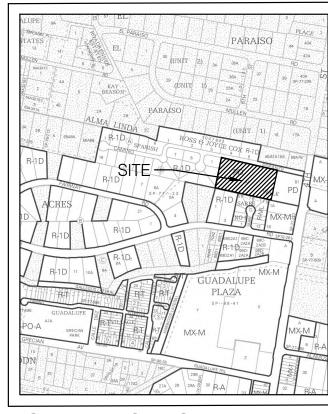

ZONE ATLAS PAGE E-14-Z

DEVELOPMENT DATA LEGAL DESCRIPTION: Tract A-1, Spanish Walk Subdivision, Containing 2.42 Acres

LAND USE: Dwelling, Single Family Detached Homes PEDESTRIAN AND VEHICULAR ACCESS:

- Access is provided from Camino Espanol NW a private access easement. The project is constructing new crusher fine paths on Camino Espanol, (see
- 4th Street, approximately 200 feet to the east, is designated as a Minor Arterial.
- 4th Street is shown as a proposed bike route. Bus service is provided along 4th/ Street by Route 10
- and the nearest bus stops are less than 1/4 mile. • There are existing sidewalks on the west side of 4th Street north of Camino Espanol and no sidewalks south. There are continuous sidewalks on the east

LOT SIZE: The minimum lot size in 4,500 square feet with a minimum lot width of 45 feet.

Front Yard Minimum: 20 feet to Garage; 15' to House Side Yard Minimum: 5 feet, 10 foot corner Rear Yard Minimum: 15 feet

MAXIMUM BUILDING HEIGHT ALLOWED: Single-story,

Building design: single-family shall comply with the building design requirements of IDO section 14-16-5-11(c) low-density residential development. PARKING REQUIREMENTS: Each dwelling units will provide 4 off-street parking spaces - 2 garage spaces

GENERAL NOTES:

- 1. Perimeter coyote fence, private roadway, retention areas, landscaping and signs will be owned and maintained by the Homeowner's Association.
- 2. Landscaping, signage, walls, fences, trees, and shrubbery between 3 feet and 8 feet tall (as measured from the gutter pan) are not allowed within the clear sight triangle.

PROJECT NUMBER: PR-2023-008085

This plan is consistent with the specific Site Development Plan approved by the Environmental Planning Commission (EPC) dated February 16, 2023 and the Findings and Conditions in the Official Notification of Decision are satisfied.

Is an Infrastructure List required? () Yes () No If yes, then a set of approved DRC plans with a work order is required for any construction within Public Right-of-Way or for construction of public

DFT SITE DEVELOPMENT PLAN APPROVAL:

Ernest armijo Nov 13, 2023 Traffic Engineering, Transportation Division Dec 13, 2023 Win Guil ABCWUA Nov 14, 2023 Whitney Phelan Parks and Recreation Department Nov 13, 2023 liegue Hydrology Nov 13, 2023 Code Enforcemen

*Environmental Heath Department (conditional) See attached. Solid Waste Management

Dec 14, 2023 Planning Department DATE: 3/28/2023



Planning / Landscape Architecture 302 Eighth Street NW Albuquerque, NM 87102 (505) 764-9801 Fax 842-5495 e-mail:cp@consensusplanning.com

CONSULTANTS

ISAACSON & ARFMAN, Inc. Consulting Engineering Associates Ibuquerque, New Mexico 87108 Ph. 505-268-8828 www.iacivil.com



NOT FOR CONSTRUCTION

SPANISH WALK ALBUQUERQUE, NM


PREPARED FOR: LAS VENTANAS NM, INC. 8330-A WASHINGTON PLACE NE ALBUQUERQUE, NM 87113


SUBMITTAL: MARCH 28, 2023				
REV	REVISIONS			
NO.	DATE	DESCRI	PTION	
PRO	JECT NO:	1538-04		
CAD	DWG FIL	E:		
DESI	GNED BY	′: I&A	DATE: 3/28/23	
DRAWN BY: AN DATE		DATE: 3/28/23		
CHE	CKED BY	ÅN JS	DATE: 3/28/23	
SHE	ET TITL	.E		


SITE PLAN EPC

DRAWING SHEET

A100

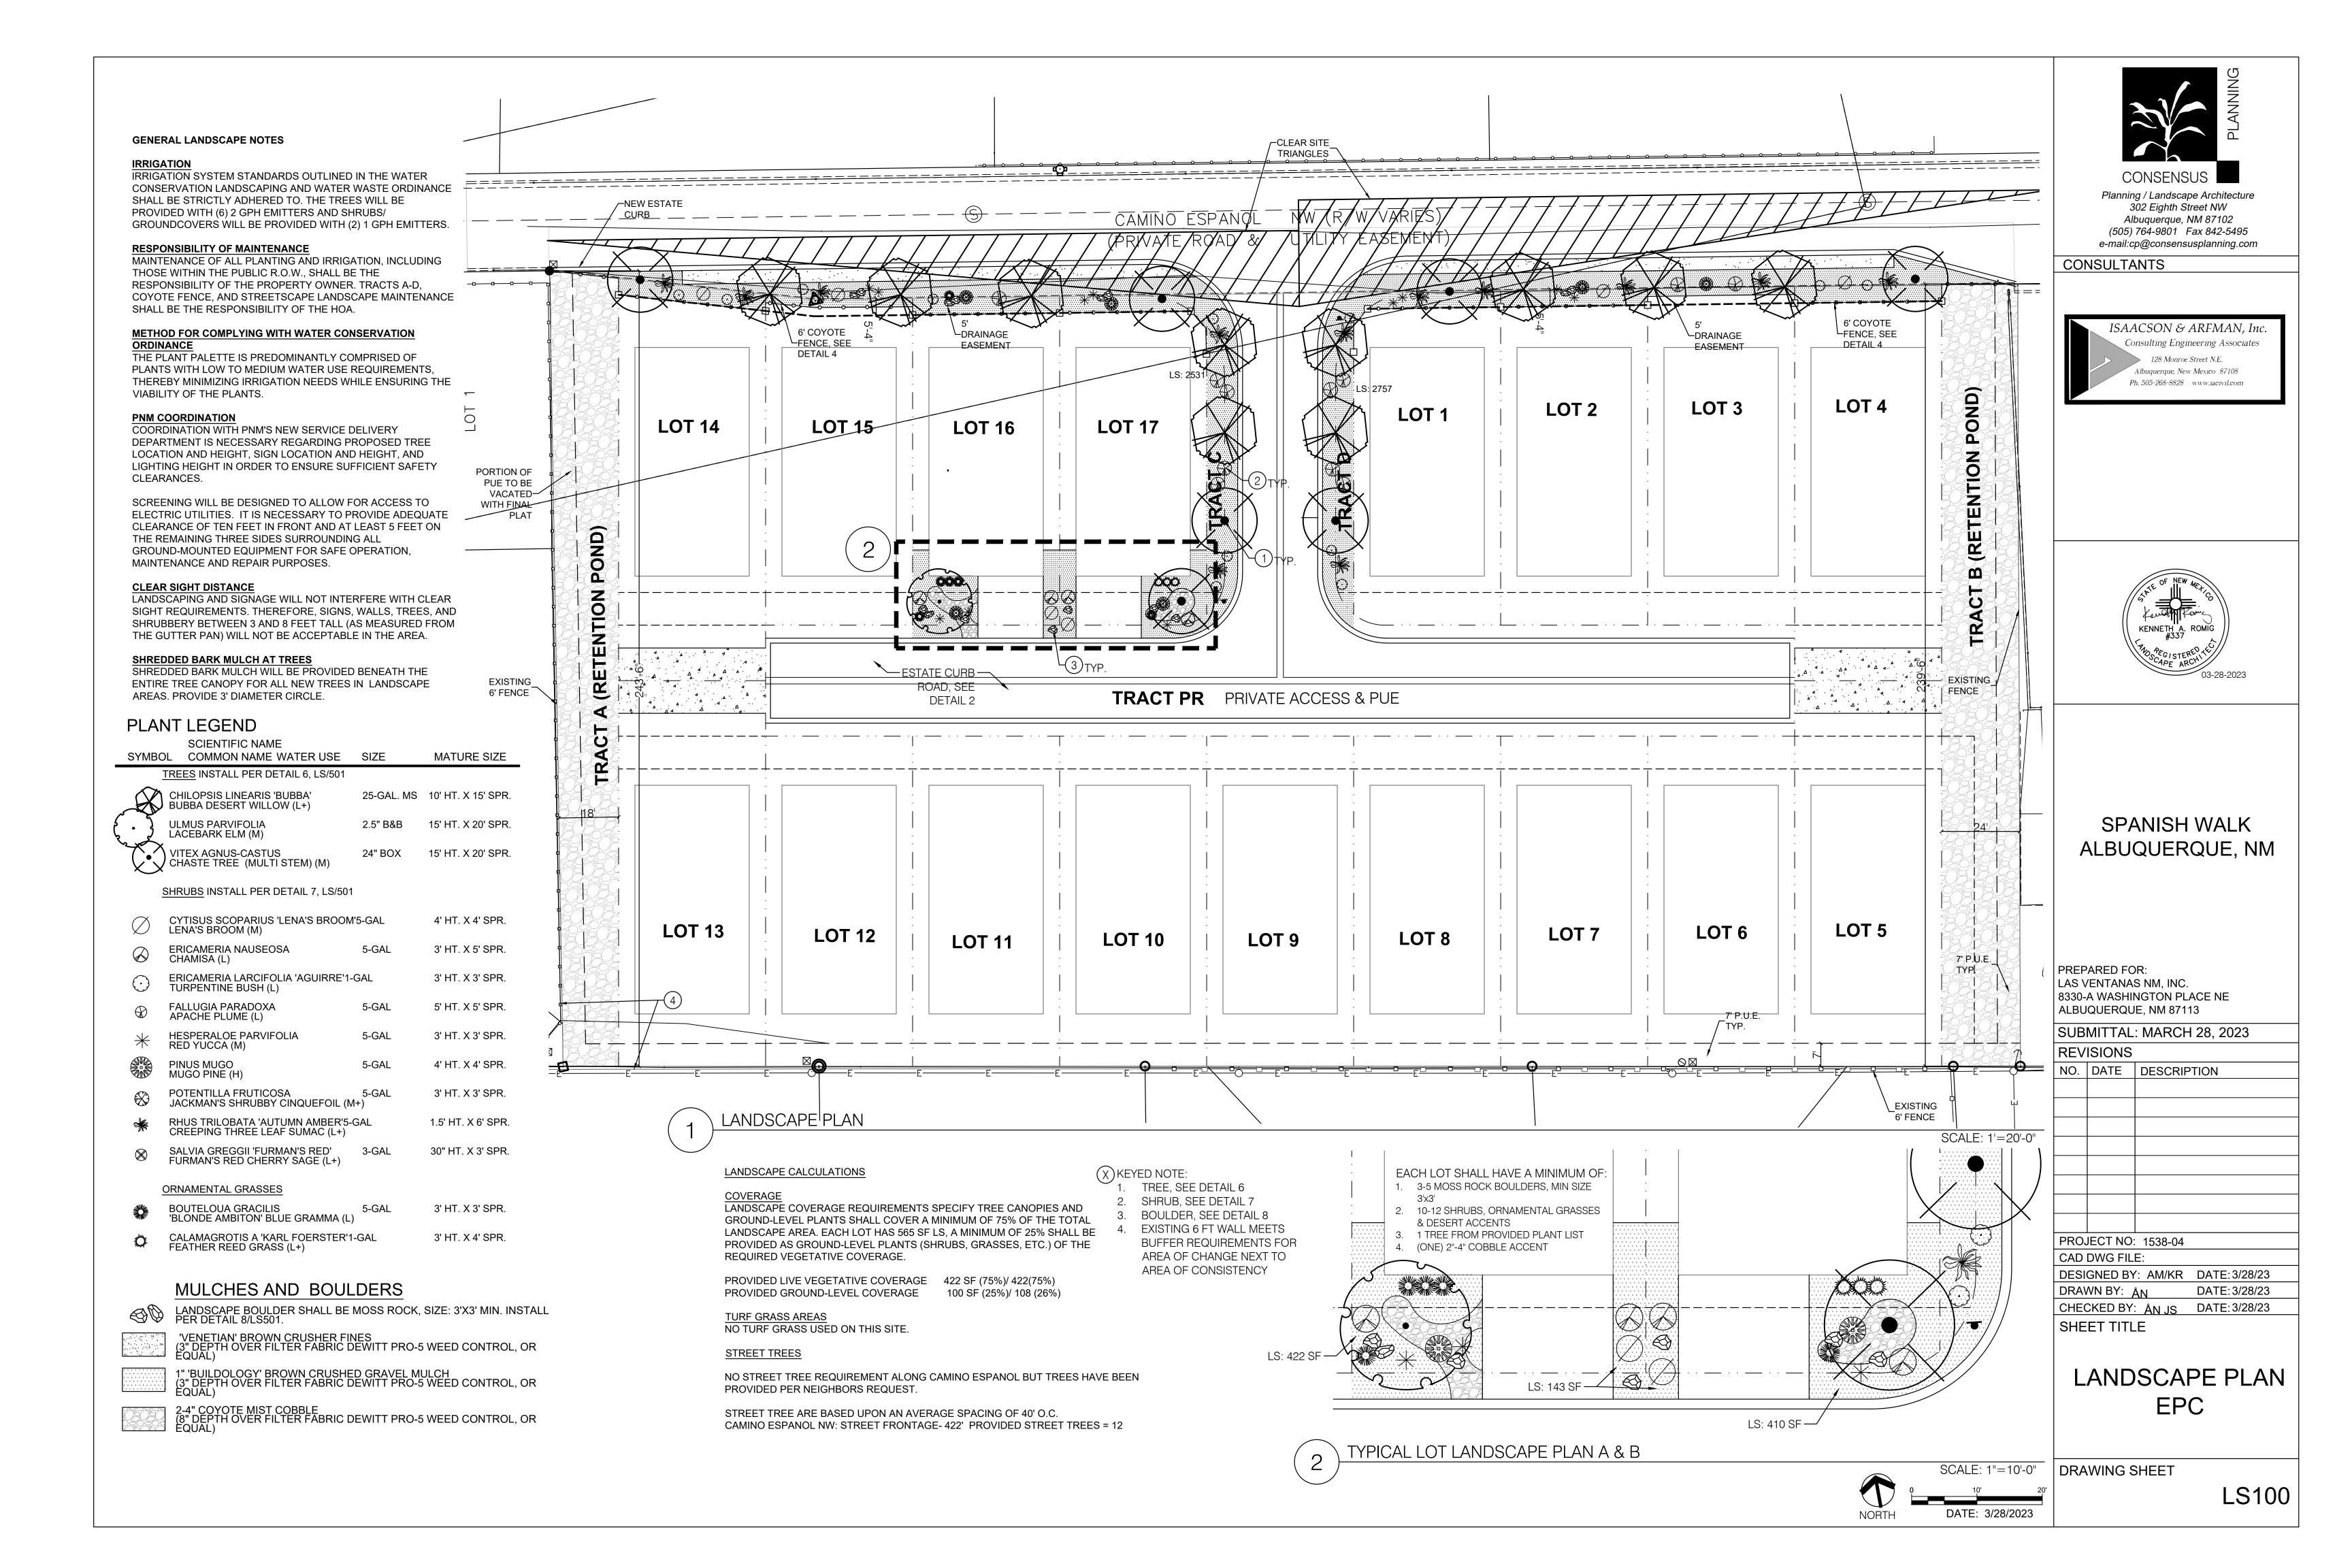

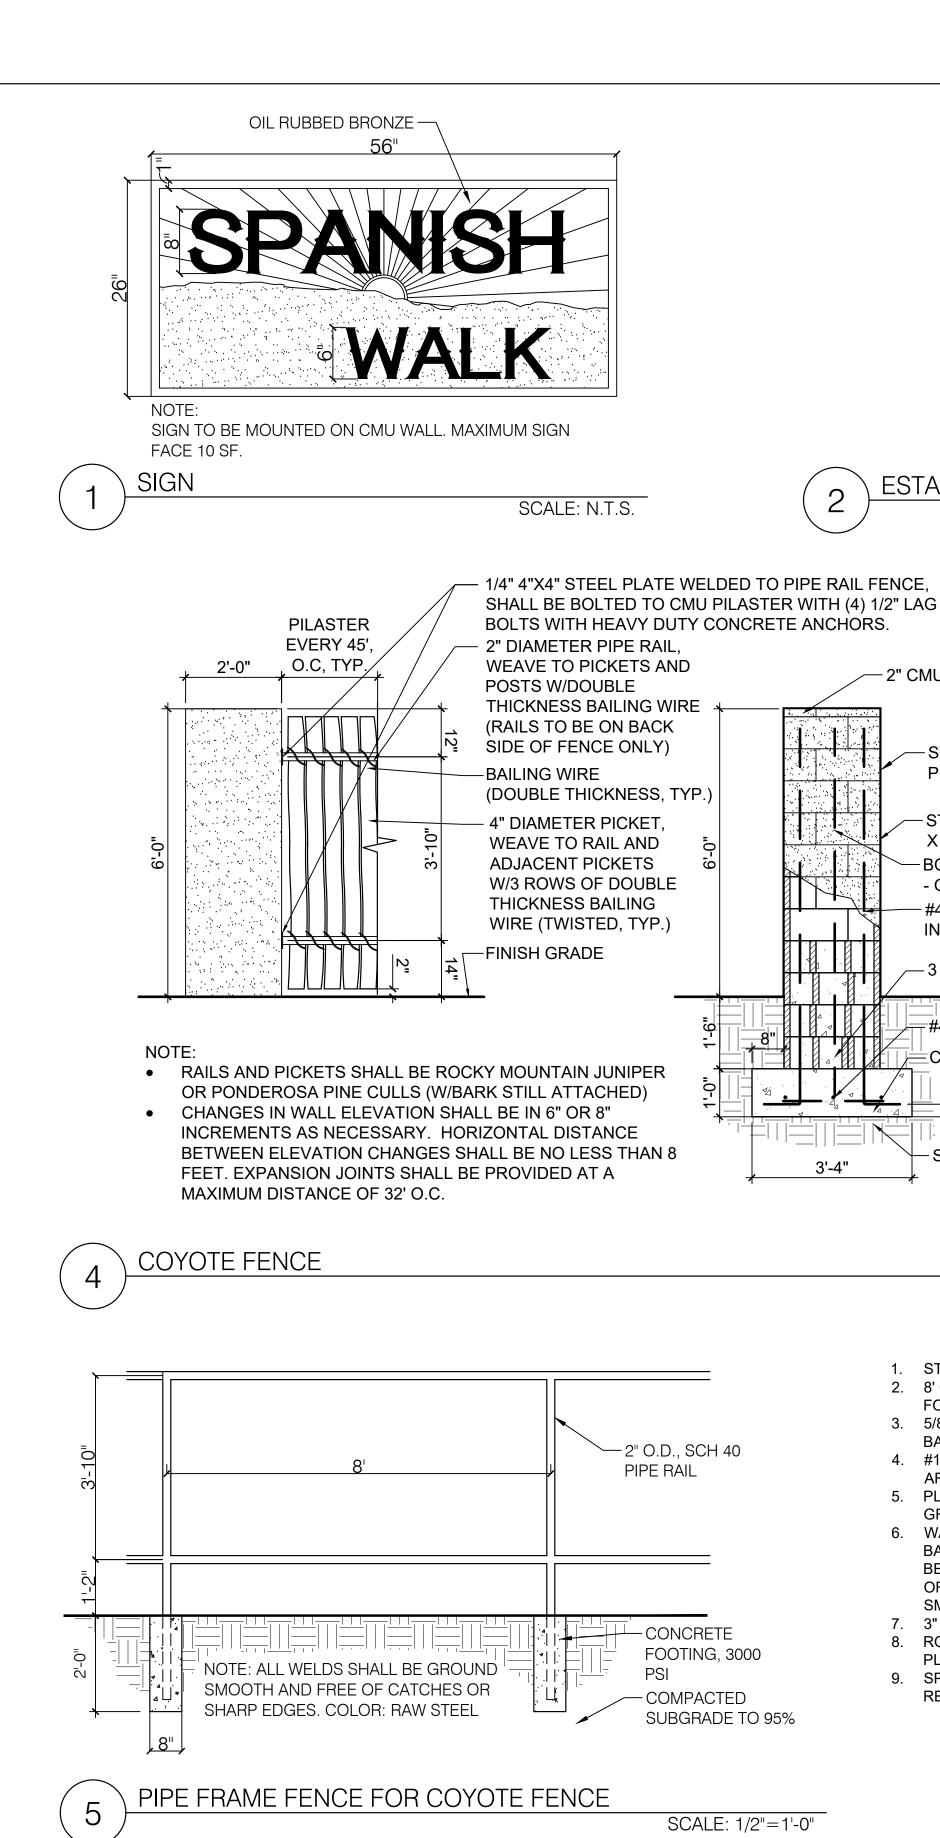

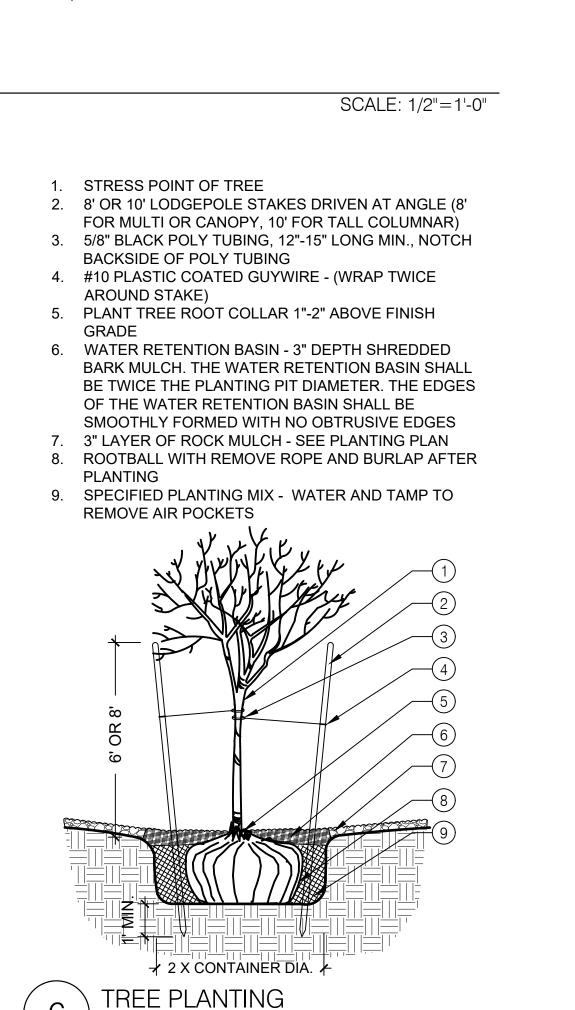

SCALE: N.T.S.

ESTATE CURB

ESTATE CURB

2" CMU BLOCK CAP

-STUCCOED CMU

X 8" X 16" - TYP.

- GROUT SOLID.

PILASTER COLOR: TAN

-STUCCOED PILASTER CMU - 8"

BOND BEAM W/ 1- #4 REBAR CONT.

-#4 REBAR @ 32" O.C. W/ 12" HOOK

IN FOOTING - GROUT SOLID.

— 3 - #4 REBAR CONT. @ 12" O.C.

 $\stackrel{arphi}{=}$ CONCRETE FOOTING, 4,000 PSI.

SUBGRADE COMPACTED TO 95%.

 $\overline{}$ #4 REBAR @ 12" O.C.


NTS MODIFIED COA STD DWG 2415B

FOR CONSTRUCTION NOTES.

ESTATE CURB WITH MODIFIED DIMENSIONS SEE COA STD DWG 2415B

SCALE: N.T.S.

- 4" DEPTH STABILIZED **COMPACTED CRUSHER FINES** OVER GEO-TEXTILE FABRIC -FINISH GRADE **ASPHALT** -SUBGRADE COMPACTED TO 95% NOTE: TRAIL SHALL BE FLUSHED WITH TOP OF CONCRETE WHERE SITUATION OCCURS CRUSHER FINE PATH SCALE: N.T.S.

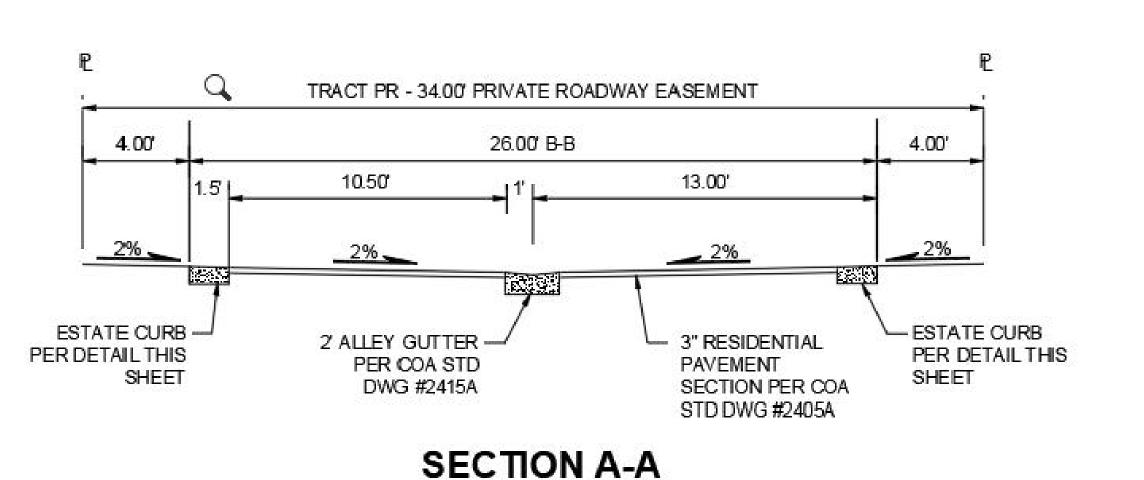

1. PLANT TREE ROOT COLLAR 1"-2" ABOVE FINISH

GRADE


2. WATER RETENTION BASIN - 3" LAYER OF SHREDDED BARK MULCH. THE WATER RETENTION BASIN SHALL BE TWICE THE PLANTING PIT DIAMETER. THE EDGES OF THE WATER RETENTION BASIN SHALL BE

SMOOTHLY FORMED WITH NO OBTRUSIVE EDGES. 3. SPECIFIED PLANTING MIX - WATER AND TAMP TO REMOVE AIR POCKETS

4. 3" LAYER OF ROCK MULCH - SEE PLANTING PLAN

5. ROOTBALL

SHRUB PLANTING SCALE: N.T.S.

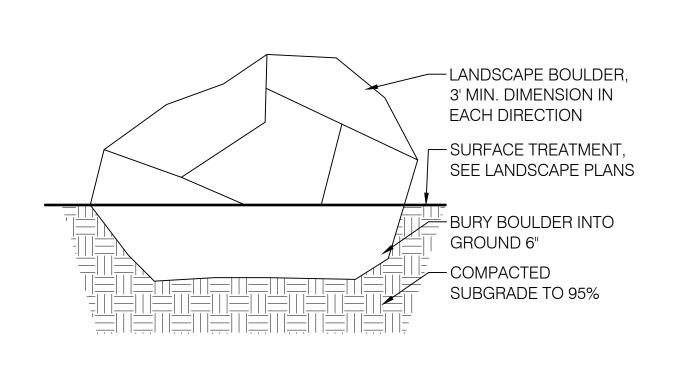


SCALE: N.T.S.

DATE: 3/28/2023

LANDSCAPE BOULDER

Planning / Landscape Architecture 302 Eighth Street NW Albuquerque, NM 87102 (505) 764-9801 Fax 842-5495 e-mail:cp@consensusplanning.com CONSULTANTS ISAACSON & ARFMAN, Inc Consulting Engineering Associates Albuquerque, New Mexico 87108 Ph. 505-268-8828 www.iacivil.com

CONSENSUS

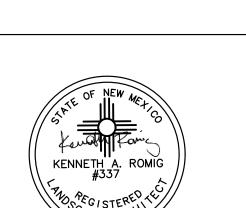

SPANISH WALK ALBUQUERQUE, NM


PREPARED FOR: LAS VENTANAS NM, INC. 8330-A WASHINGTON PLACE NE ALBUQUERQUE, NM 87113

, , , , , , , , , , , , , , , , , , , ,					
SUBMITTAL: MARCH 28, 2023					
REV	ISIONS				
NO.	DATE	DESCRIP	TION		
PRO	JECT NO:	1538-04			
CAD	DWG FIL	E:			
DESI	GNED BY	: AM/KR	DATE: 3/28/23		
DRA	NN BY:	ÅN	DATE: 3/28/23		
CHE	CKED BY:	ÅN JS	DATE: 3/28/23		
SHE	ET TITL	.E			

SITE PLAN **DETAILS** EPC


A500

DRAWING SHEET

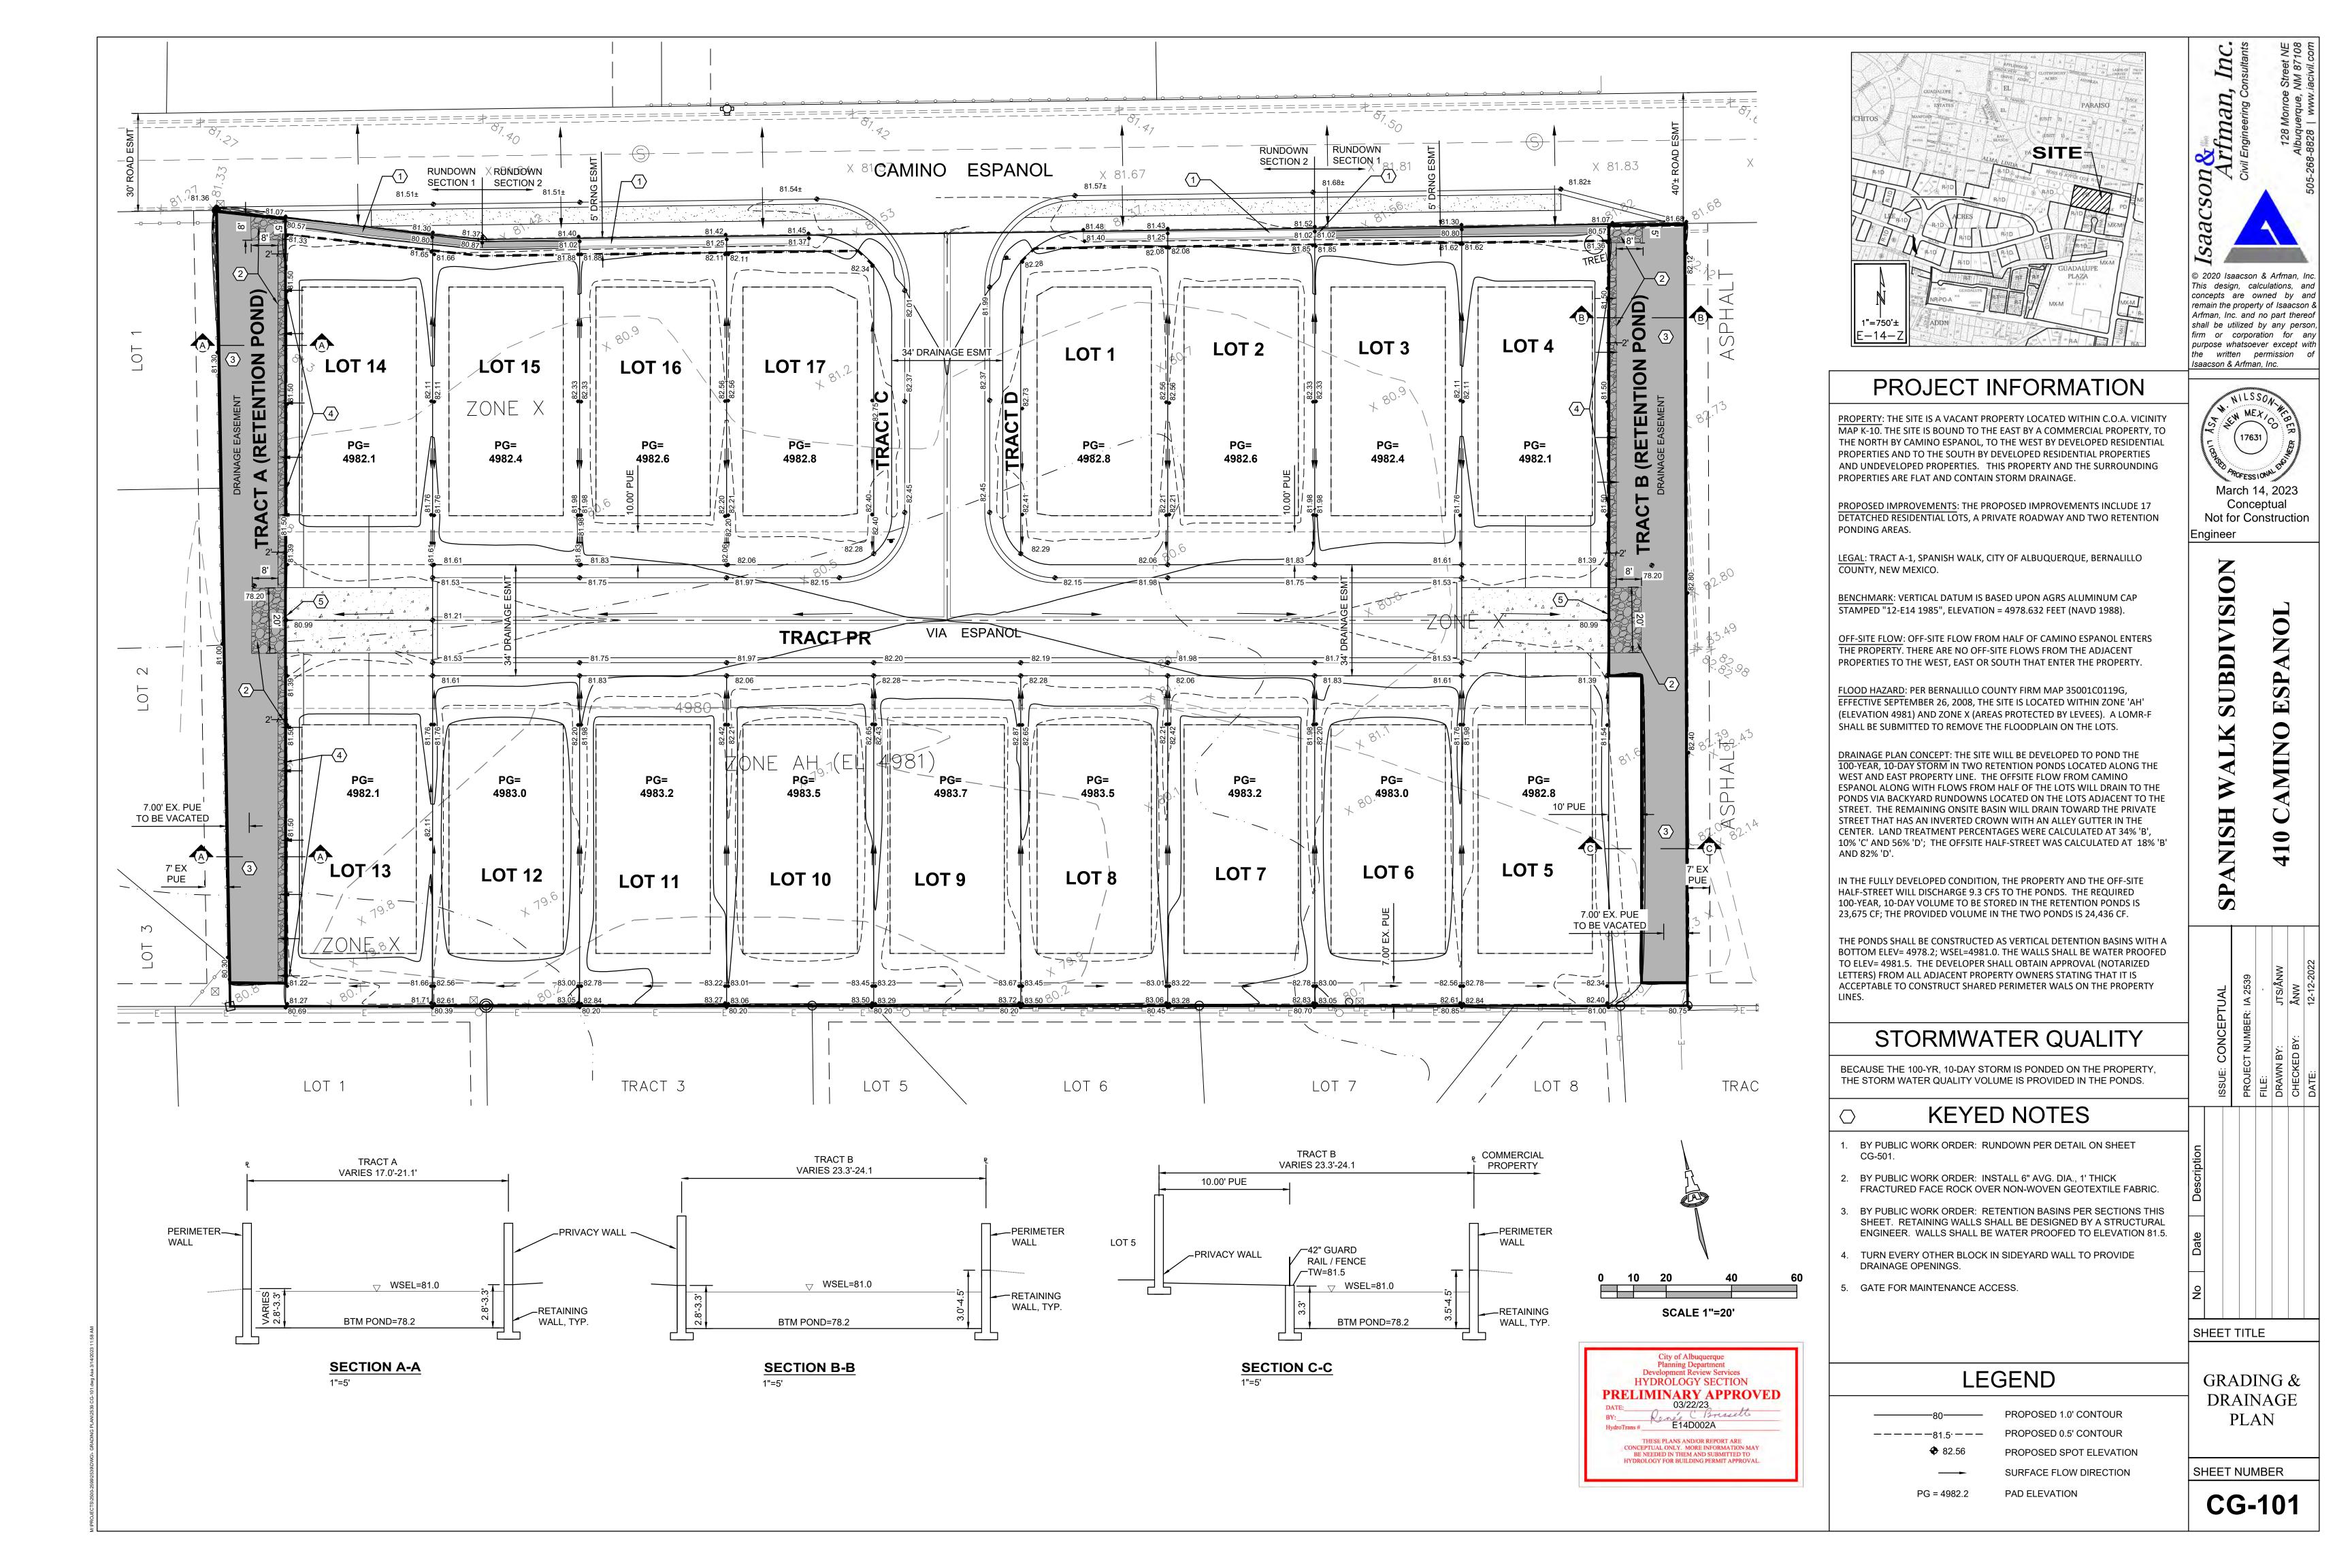


GRADING GENERAL NOTES

- A. GRADING SHALL BE PERFORMED AT THE ELEVATIONS AND IN ACCORDANCE WITH THE DETAILS SHOWN ON THIS PLAN.
- B. ALL SITE PREPARATION, GRADING OPERATIONS, FOUNDATION CONSTRUCTION, AND PAVEMENT INSTALLATION WORK SHALL BE CONSTRUCTED IN ACCORDANCE WITH THE GEOTECHNICAL REPORT, WHICH WILL BE PROVIDED BY THE OWNER. ALL OTHER WORK SHALL, UNLESS OTHERWISE NOTED IN THE PLANS, BE CONSTRUCTED IN ACCORDANCE WITH THE CITY OF ALBUQUERQUE STANDARD SPECIFICATIONS FOR PUBLIC WORKS CONSTRUCTION, CURRENT EDITION.
- C. PROPOSED SPOT AND CONTOUR ELEVATIONS SHOWN REPRESENT TOP OF FINISH MATERIAL (I.E. TOP OF CONCRETE, TOP OF CONCRETE BUILDING PAD, TOP OF PAVEMENT MATERIAL, TOP OF LANDSCAPING MATERIAL, ETC.). CONTRACTOR SHALL GRADE, COMPACT SUBGRADE AND DETERMINE EARTHWORK ESTIMATES BASED ON ELEVATIONS SHOWN MINUS FINISH MATERIAL THICKNESSES.
- D. IF FIELD GRADE ADJUSTMENTS ARE REQUIRED, THE CONTRACTOR SHALL NOTIFY THE ENGINEER.
- E. THE ENVIRONMENTAL PROTECTION AGENCY (EPA) AND THE CITY OF ALBUQUERQUE REQUIRE A STORM WATER POLLUTION PREVENTION PLAN (SWPPP), AN NDPES PERMIT FOR PROJECTS WHERE CONSTRUCTION ACTIVITIES MEET THE EPA THRESHOLD. (SWPPP, NPDES PERMIT BY OTHERS.). CONTRACTOR SHALL COORDINATE WITH OWNER TO DETERMINE WHO WILL PREPARE SWPPP AND INSPECT REQUIRED ELEMENTS.
- F. ALL NEW PAVEMENT SURFACES SHALL BE CONSTRUCTED WITH POSITIVE SLOPE AWAY FROM BUILDINGS AND POSITIVE SLOPE TOWARD EXISTING AND/OR PROPOSED DRAINAGE PATHS. PAVING AND ROADWAY GRADES SHALL BE ±0.1' FROM PLAN ELEVATIONS.
- G. WHERE GRADES BETWEEN NEW AND EXISTING ARE SHOWN AS 'MATCH' OR '±', TRANSITIONS SHALL BE SMOOTH.
- H. PAD ELEVATIONS SHALL BE WITHIN 0.1'±.
- I. POND DESIGN PARAMETERS AND STORMWATER CONTROL MEASURES SHOWN ON THIS PLAN (TOP OF POND, BOTTOM OF POND, SIZE OF ORIFICE, AREA OF POND, ETC.) TO BE STRICTLY ADHERED TO FOR CERTIFICATION PURPOSES. SEE DETAIL SHEET FOR ADDITIONAL INFORMATION.
- J. POST-CONSTRUCTION MAINTENANCE FOR PRIVATE STORMWATER FACILITIES WILL BE THE RESPONSIBLITY OF THE FACILITIES OWNER. ENGINEER RECOMMENDS THAT OWNER INSPECT SITE YEARLY AND AFTER EACH RAINFALL TO IDENTIFY NEW AREAS OF EROSION AND INSTALL ADDITIONAL EROSION PROTECTION AS NEEDED BASED ON ACTUAL OCCURRENCES.
- K. EXISTING UTILITY LINES ARE SHOWN IN AN APPROXIMATE MANNER ONLY AND MAY BE INCOMPLETE OR OBSOLETE. SUCH LINES MAY OR MAY NOT EXIST WHERE SHOWN OR NOT SHOWN. CONTRACTOR SHALL CONTACT NM-811 FOR UTILITY LINE SPOTS FIVE WORKING DAYS PRIOR TO CONDUCTING SITE FIELD WORK. CONTRACTOR SHALL FIELD VERIFY AND LOCATE ALL UTILITIES PRIOR TO COMMENCEMENT OF ANY CONSTRUCTION. CONTRACTOR IS FULLY RESPONSIBLE FOR ANY AND ALL DAMAGE CAUSED BY ITS FAILURE TO LOCATE, IDENTIFY AND PRESERVE ANY AND ALL EXISTING UTILITIES, PIPELINES, AND UNDERGROUND UTILITY LINES. THE CONTRACTOR SHALL BE RESPONSIBLE FOR COORDINATION OF NECESSARY DRY UTILITY ADJUSTMENTS.
- L. FOR ENGINEER'S CERTIFICATION OF SUBSTANTIAL COMPLIANCE (FOR CERTIFICATE OF OCCUPANCY) CONTRACTOR SHALL PROVIDE AN AUTOCAD FORMAT AS-BUILT SURVEY PREPARED BY A LICENSED SURVEYOR WHICH INCLUDES:
- L.A. AS-BUILT SPOT ELEVATIONS AT EACH DESIGN SPOT ELEVATION SHOWN ON THE APPROVED PLAN;
- L.B. AS-BUILT ELEVATIONS AT EACH CORNER OF THE PAD AND AT THE CENTER OF THE PAD; TOP AND BOTTOM ELEVATIONS AS REQUIRED TO DEFINE THE PERIMETER OF PONDS (TO
- BE USED BY ENGINEER TO CALCULATE AS-BUILT VOLUME PROVIDED);
- L.D. ALL CONSTRUCTION, INCLUDING DRAIN INLETS, PIPES AND PONDS SHOWN ON THIS PLAN MUST BE CONSTRUCTED IN SUBSTANTIAL COMPLIANCE WITH THE APPROVED PLAN IN ORDER TO RECEIVE ENGINEER'S CERTIFICATION.
- M. UPON WRITTEN REQUEST, THE ELECTRONIC FILE OF THE GRADING AND DRAINAGE WILL BE PROVIDED TO THE CONTRACTOR FOR VERTICAL CONTROL.
- N. SITE CONSTRUCTION LAYOUT / STAKING SHALL BE COORDINATED WITH THE OWNER.

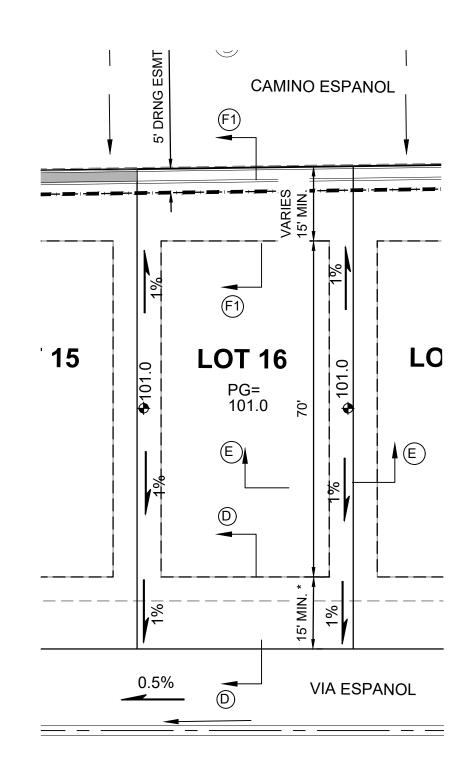


* 15' SETBACK TO HOUSE; 20' SETBACK TO GARAGE

TYPICAL LOT DETAIL LOTS 1-4 & 14-17

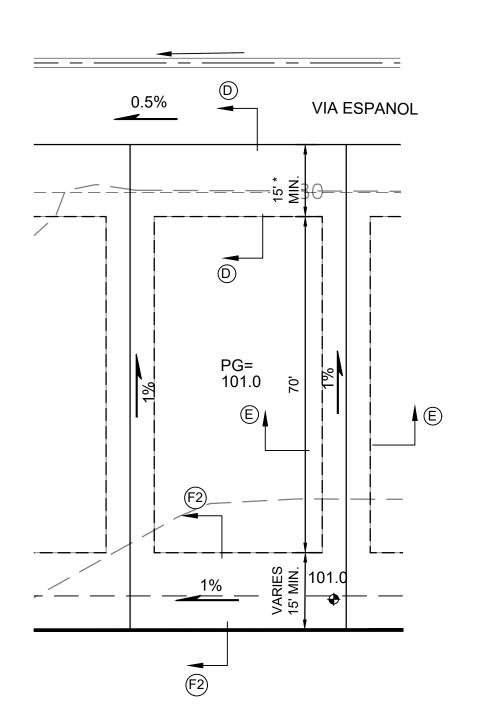


* 15' SETBACK TO HOUSE; 20' SETBACK TO GARAGE

TYPICAL LOT DETAIL

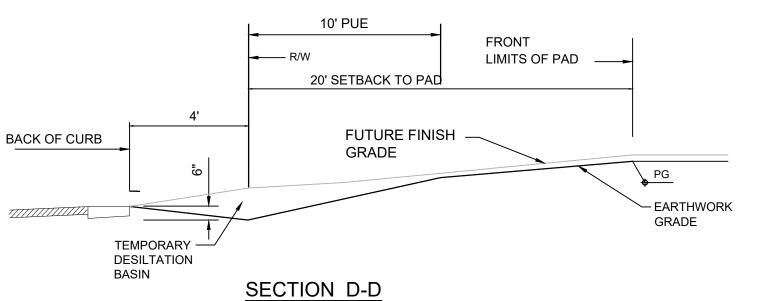


FRONT YARD GRADING


SCALE: 1"=5'-0" FRONT YARD GRADES AT COMMON LOT LINES SHALL BE AT FINISH GRADE TO SET WATER METERS AND DRY UTILITY EQUIPMENT.

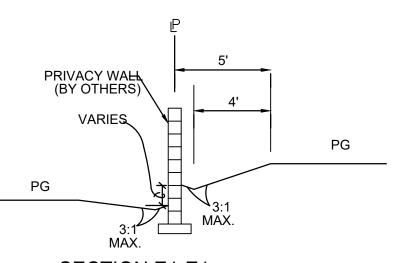


SECTION E1-E1 TYPICAL SIDEYARD GRADING SCALE: 1"=5' LOTS 1-3, 14-17

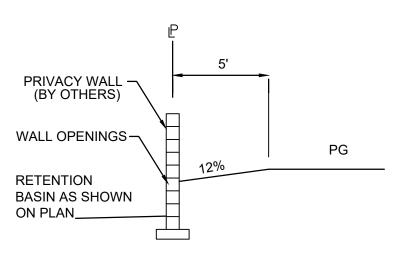


SECTION E2-E2 TYPICAL SIDEYARD GRADING SCALE: 1"=5' LOTS 4, 13 &14

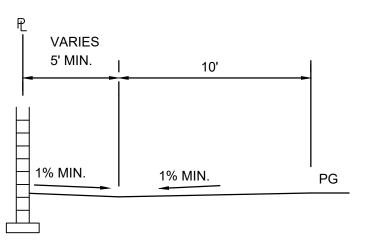


SECTION F1-F1 TYPICAL BACKYARD GRADING SCALE: 1"=5'

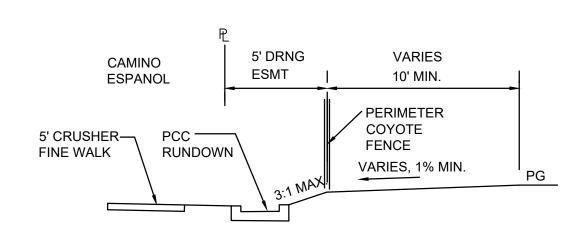

SECTION F2-F2 TYPICAL BACKYARD GRADING SCALE: 1"=5'

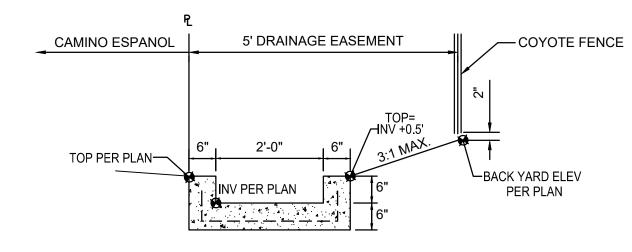


RUNDOWN - SECTION 1 SCALE: N.T.S. RUNDOWN SHALL BE CONSTRUCTED WITH PUBLIC WORK ORDER

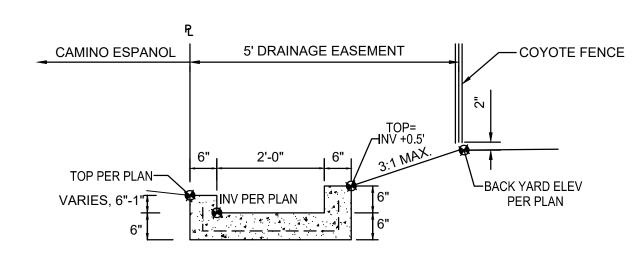

RUNDOWN - SECTION 2 SCALE: N.T.S. RUNDOWN SHALL BE CONSTRUCTED WITH PUBLIC WORK ORDER

HYDROLOGY SECTION PRELIMINARY APPROVED BY: Reselle Brisselle
HydroTrans # E14D002A THESE PLANS AND/OR REPORT ARE CONCEPTUAL ONLY. MORE INFORMATION MAY BE NEEDED IN THEM AND SUBMITTED TO HYDROLOGY FOR BUILDING PERMIT APPROVAL.

© 2020 Isaacson & Arfman, In This design, calculations, and concepts are owned by and remain the property of Isaacson & Arfman, Inc. and no part thereof shall be utilized by any person, firm or corporation for any purpose whatsoever except with the written permission of Isaacson & Arfman, Inc.

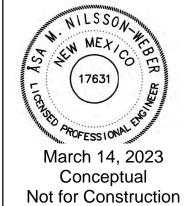

|Engineer

10


SHEET TITLE

CONCEPTUAL GRADING & DRAINAGE PLAN

SHEET NUMBER

CG-501


LOTS 5-13

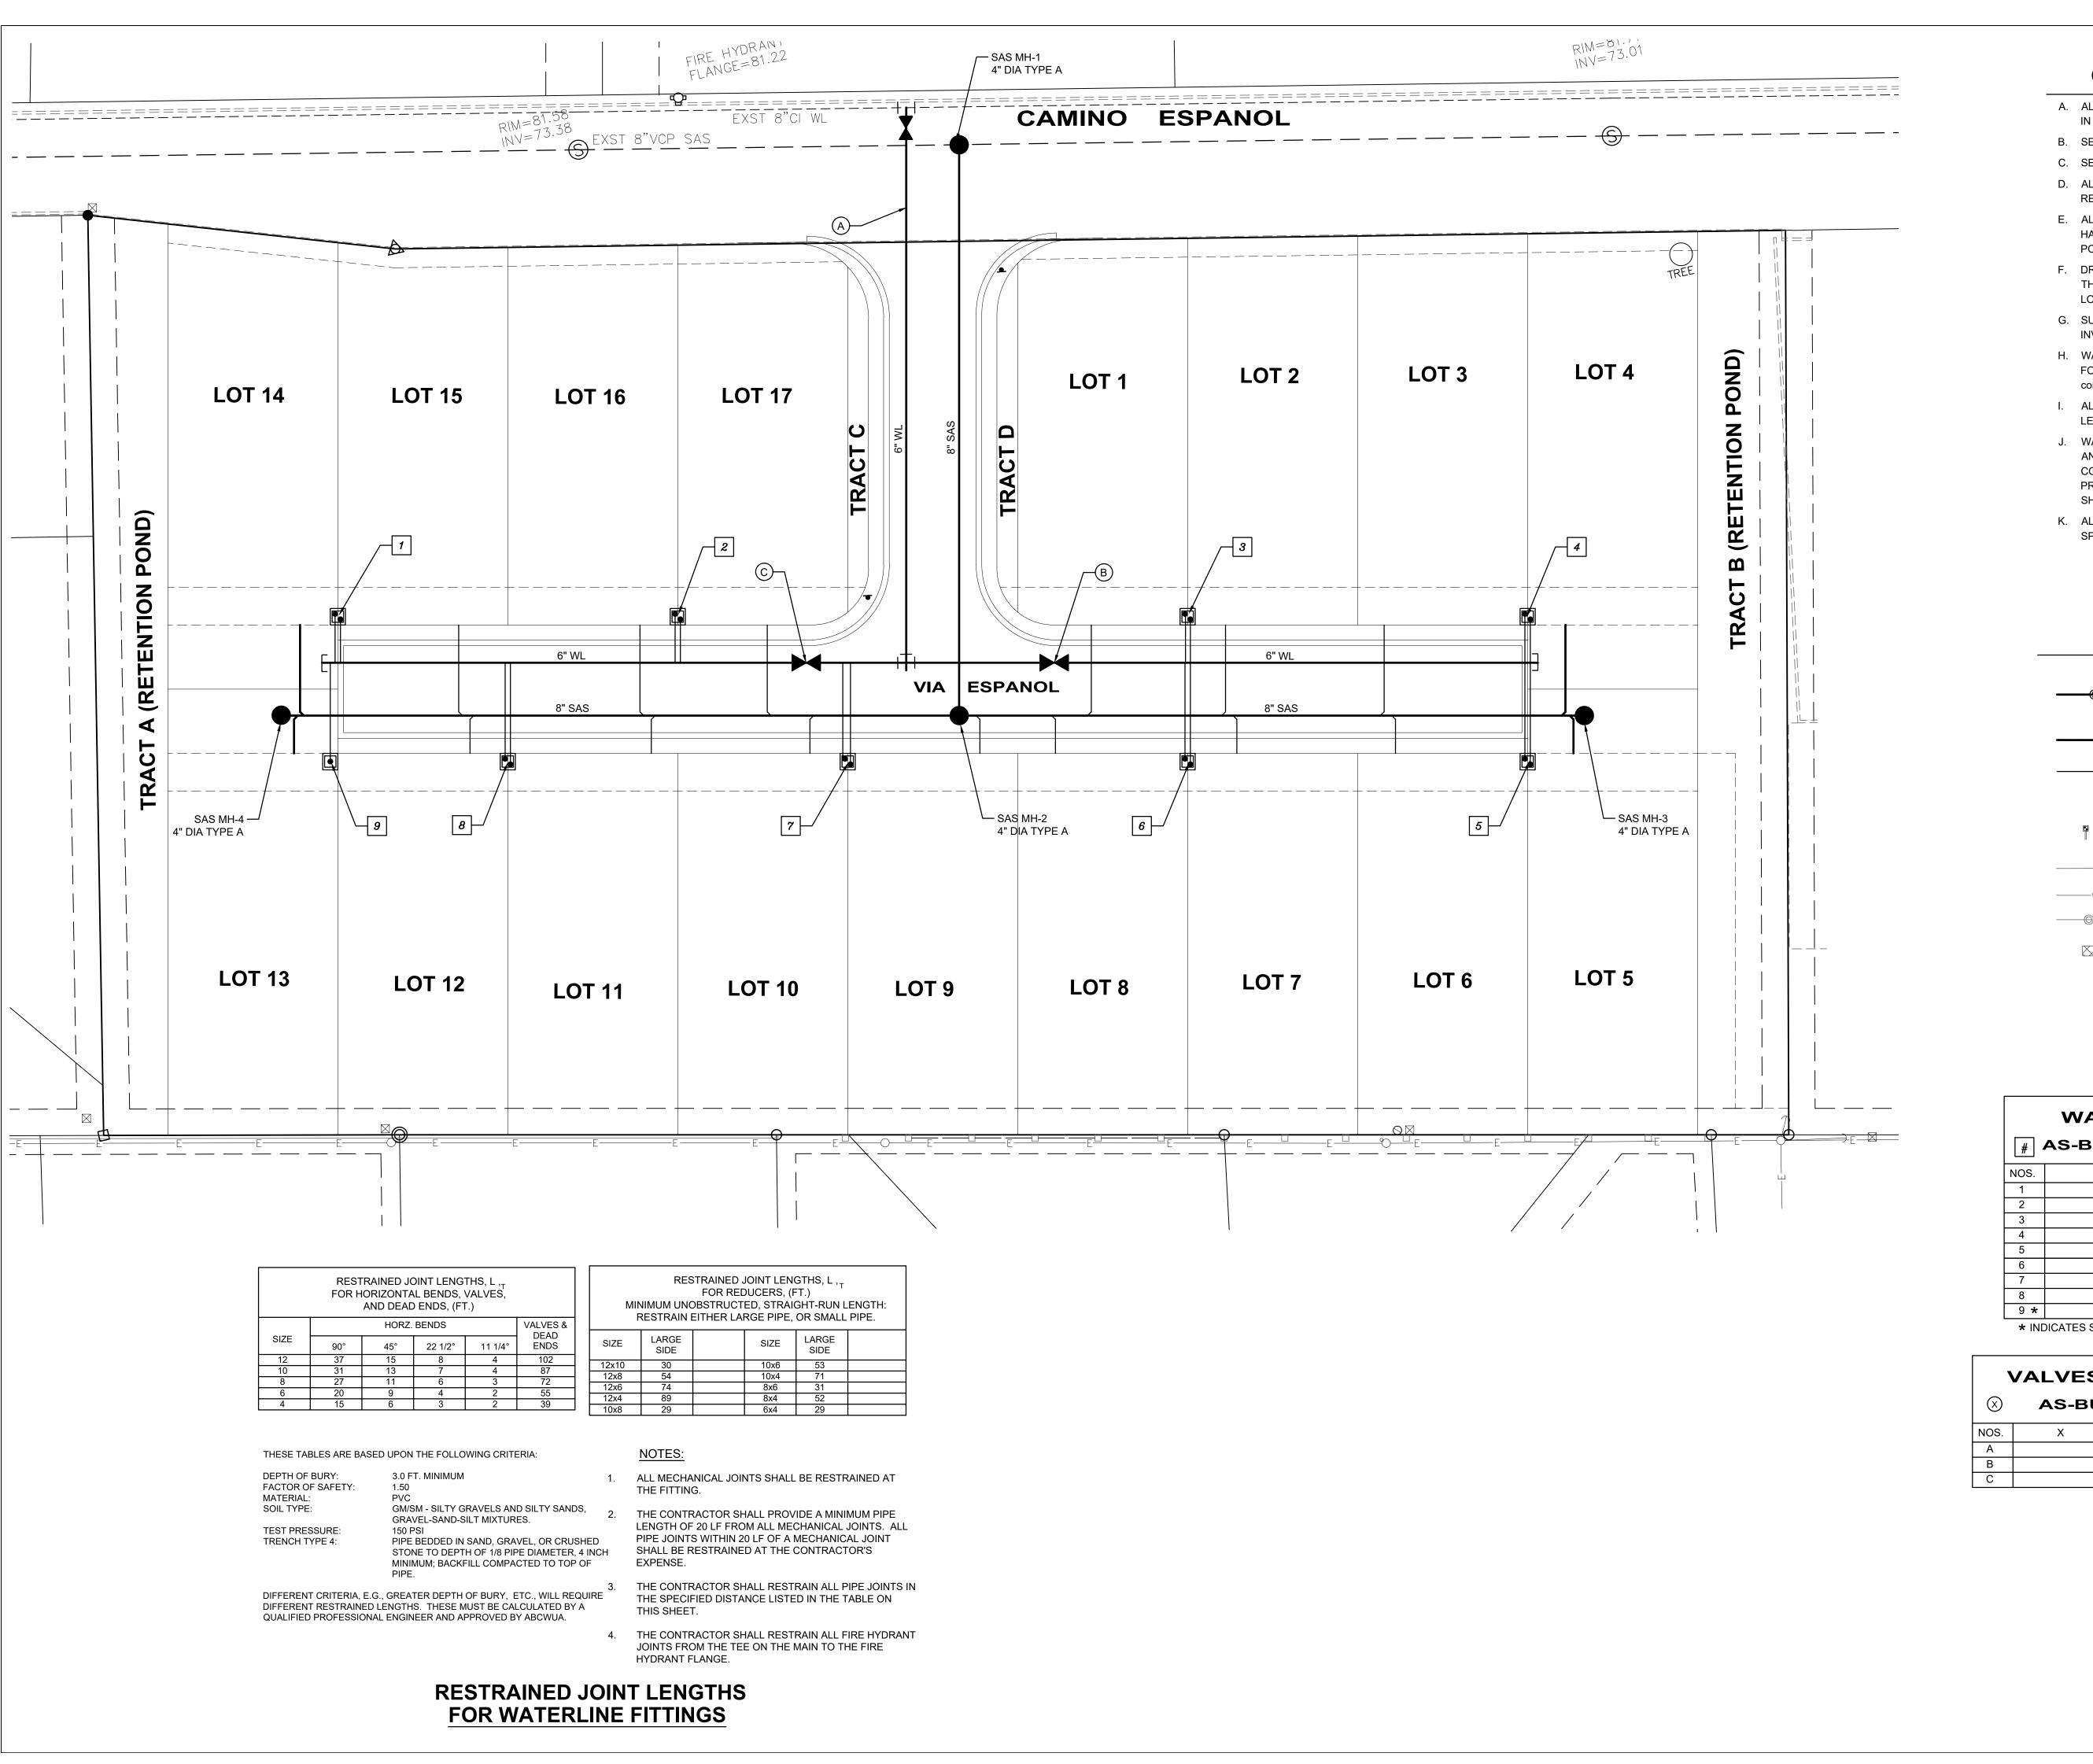

GENERAL UTILITY NOTES


- A. ALL WATER AND SEWER WORK SHALL BE CONSTRUCTED IN ACCORDANCE WITH THE ABCWUA SPECIFICATIONS.
- B. SEE SHEET 2 FOR EASEMENT NOTES.
- C. SEE THIS SHEET FOR WATER SHUT-OFF PLAN.
- D. ALL FITTINGS AND VALVES SHALL HAVE JOINT RESTRAINTS. SEE THIS SHEET FOR TABLES.
- E. ALL CROSSINGS OF WATER AND SEWER LINES SHALL HAVE 18" MIN CLEARANCE. IF 18" CLEARANCE IS NOT POSSIBLE, INSTALL LEAN FILL BETWEEN PIPES.
- F. DRY UTILITY LOCATIONS AND DESIGN ARE NOT A PART OF THIS PLAN. CONTRACTOR SHALL COORDINATE WITH THE LOCAL DRY UTILITY COMPANIES.
- G. SURVEYOR SHALL VERIFY ALL TP ELEVATIONS, RIM AND INVERT ELEVATIONS ON MANHOLES.
- H. WATER AUTHORITY SPECIFICATIONS AND NOTES CAN BE FOUND ONLINE: https://www.abcwua.org/info-for-buildersconstruction-information-for-builders/
- I. ALL SANITARY SEWER LINES SHALL BE AS-BUILT WITH LENGTHS, INVERT ELEVATIONS AND SLOPES.
- J. WATER SERVICES ON PUBLIC SIDE FROM MAIN TO METER AND ON PRIVATE SIDE FROM METER SHALL BE EITHER COPPER OR MUNICIPEX PER ABCWUA APPROVED PRODUCTS LIST. IF MUNICIPEX PIPE IS USED, STIFFENERS SHALL BE USED AT THE COMPRESSION COUPLINGS.
- K. ALL WATER FITTINGS TO BE DUCTILE IRON PER ABCWUA SPECIFICATIONS.

LEGEND

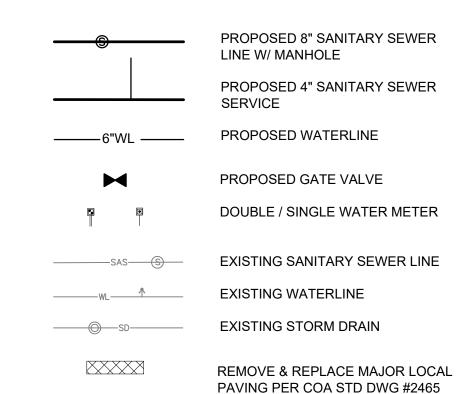


# 4	WATER METERS # AS-BUILT COORDINATES			
NOS.	Χ	Υ		
1				
2				
3				
4				
5				
6				
7				
8				
9 *				
* INE	* INDICATES SINGLE METERS ALL OTHER ARE DOUBLE			

	VALVES & FIRE HYDRANTS					
\otimes	AS-BUILT COORDINATES					
NOS.	Х	Y	Z			
Α						
В						
С						

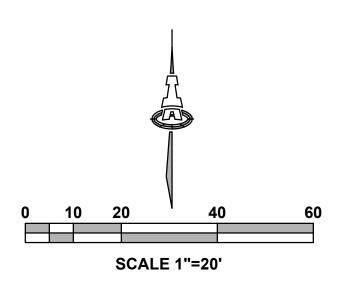

saacson& Arfman,

© 2020 Isaacson & Arfman, Inc This design, calculations, and concepts are owned by and remain the property of Isaacson & Arfman, Inc. and no part thereof shall be utilized by any person, firm or corporation for any purpose whatsoever except with the written permission of Isaacson & Arfman, Inc.

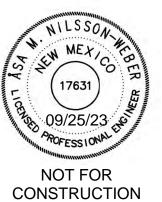

Engineer


ISI SI SP

CONCEPTUAL UTILITY **PLAN**

SHEET NUMBER

CU-101


SHEET TITLE

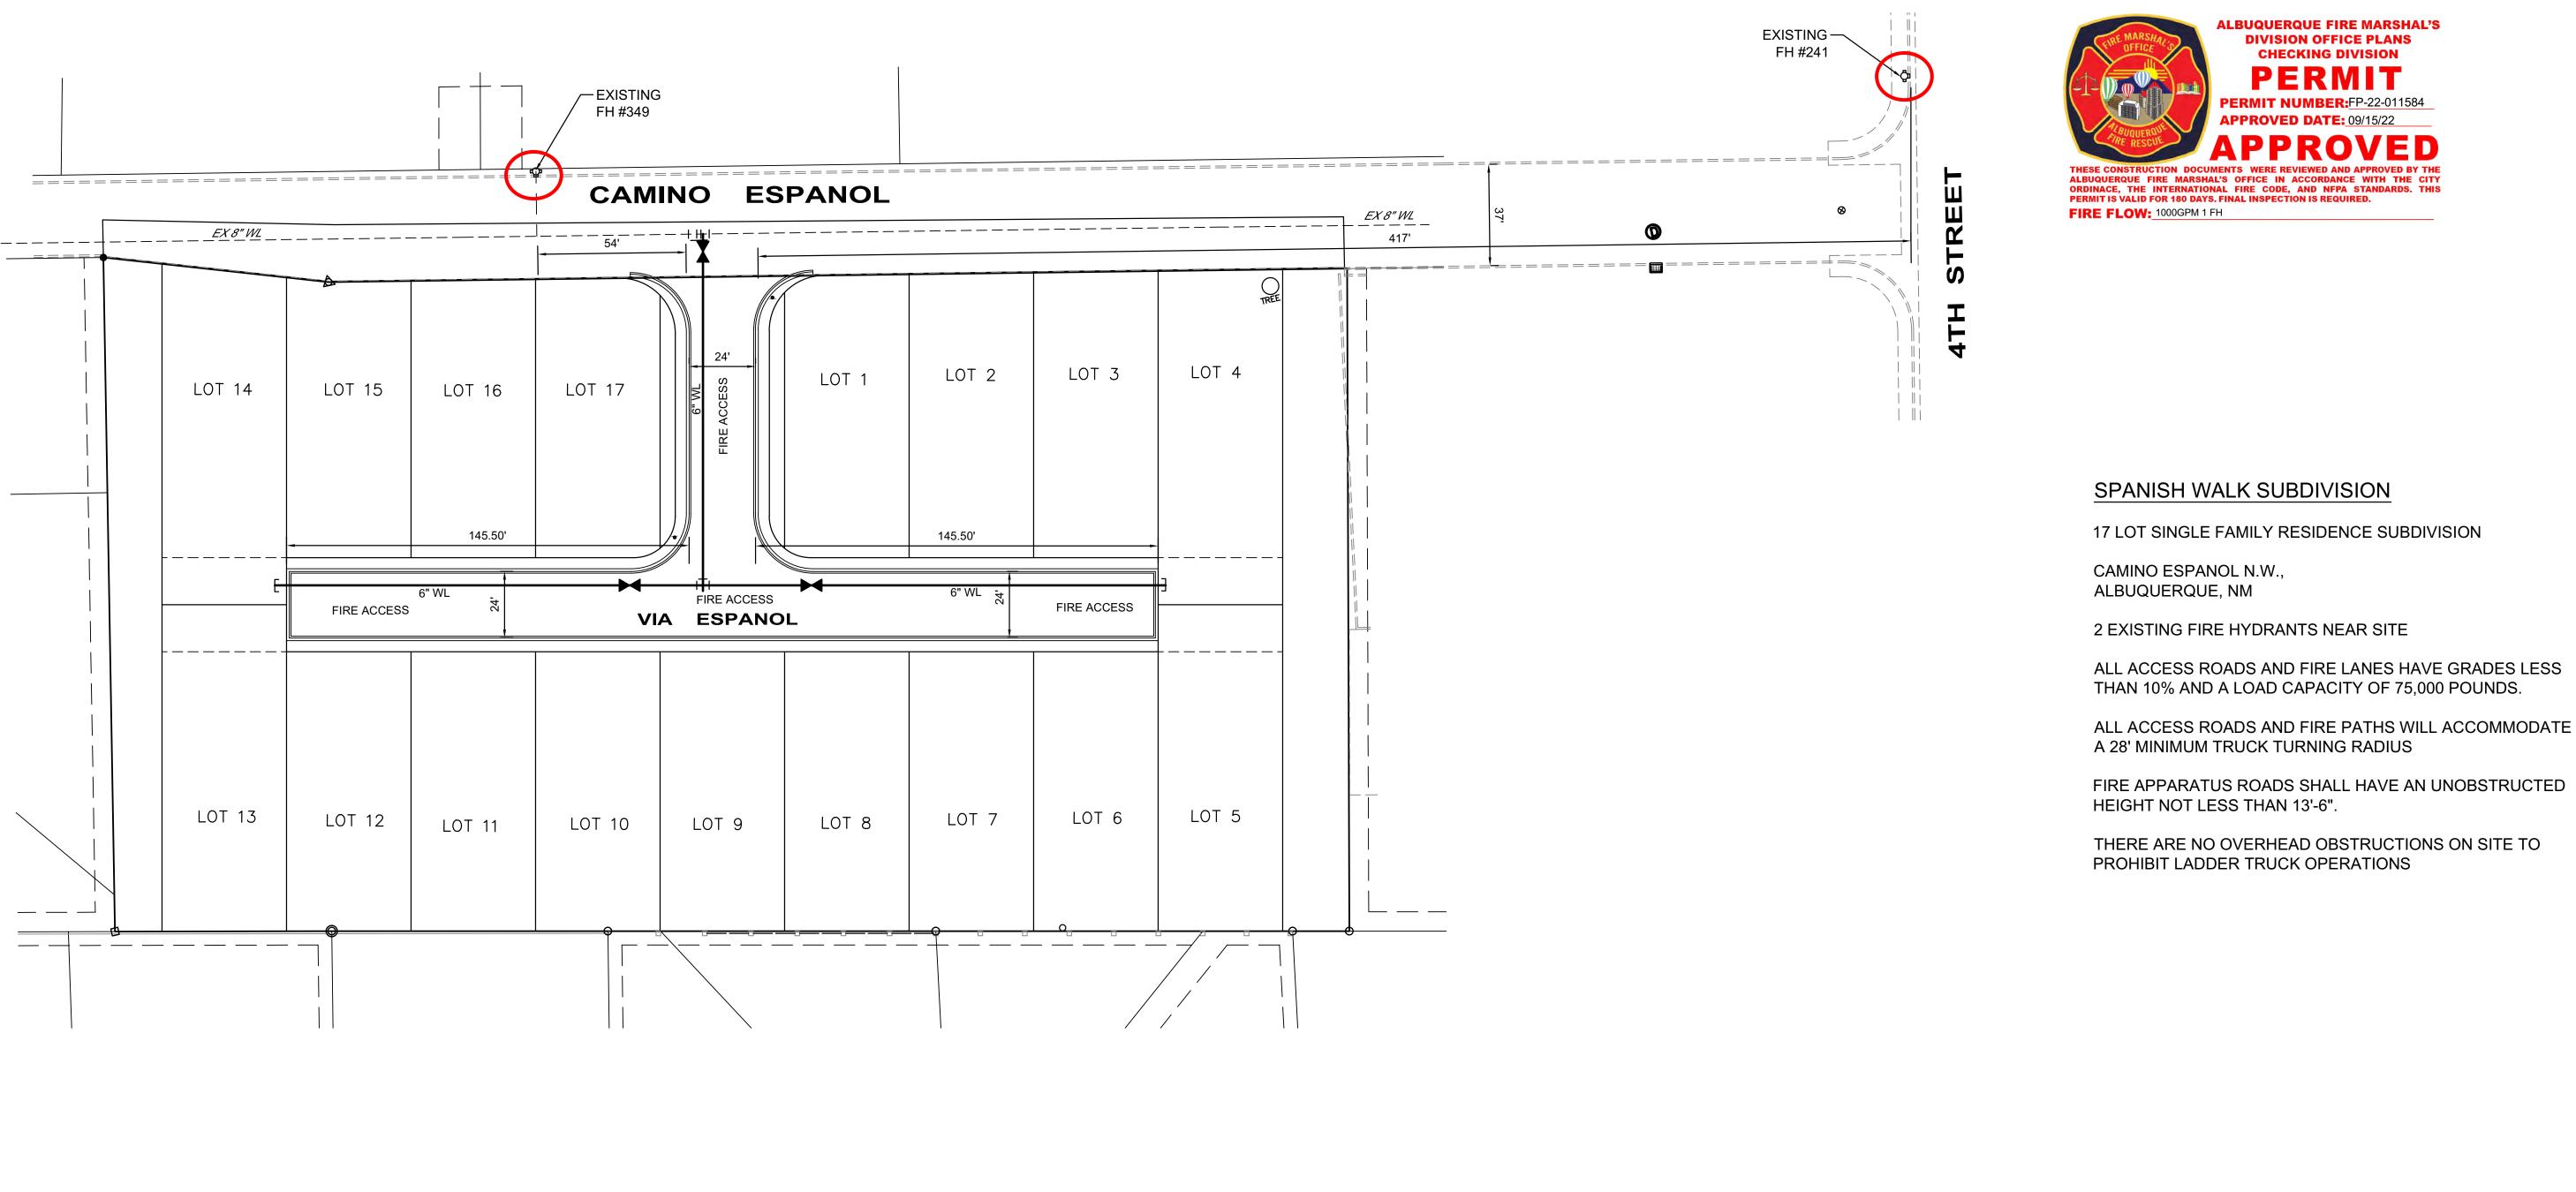





concepts are owned by and remain the property of Isaacson & Arfman, Inc. and no part thereof shall be utilized by any person, firm or corporation for any purpose whatsoever except with the written permission of Isaacson & Arfman, Inc.

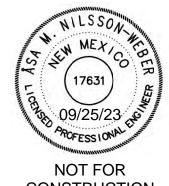

CONSTRUCTION

Engineer

HEIGHT NOT LESS THAN 13'-6". THERE ARE NO OVERHEAD OBSTRUCTIONS ON SITE TO SUBDIVISION


	<u></u>	ISSUE.		PROJECT NUMBER: IA 2539	FILE: -	DRAWN BY: DEC	CHECKED BY: ANW	CCUC-60
Description								
Date								
oN								
SF	SHEET TITLE							


SHEET TITLE


FIRE HYDRANT LOCATION & ACCESS PLAN


SHEET NUMBER

FIRE 1

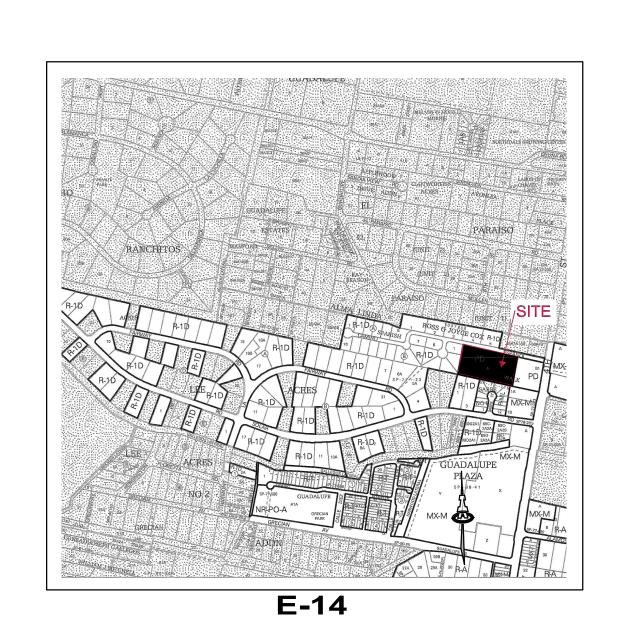

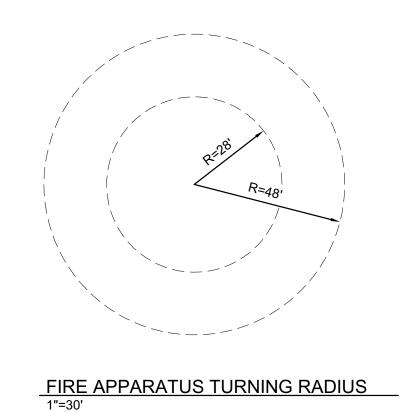

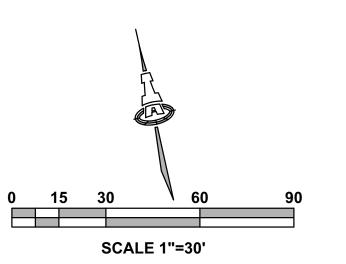

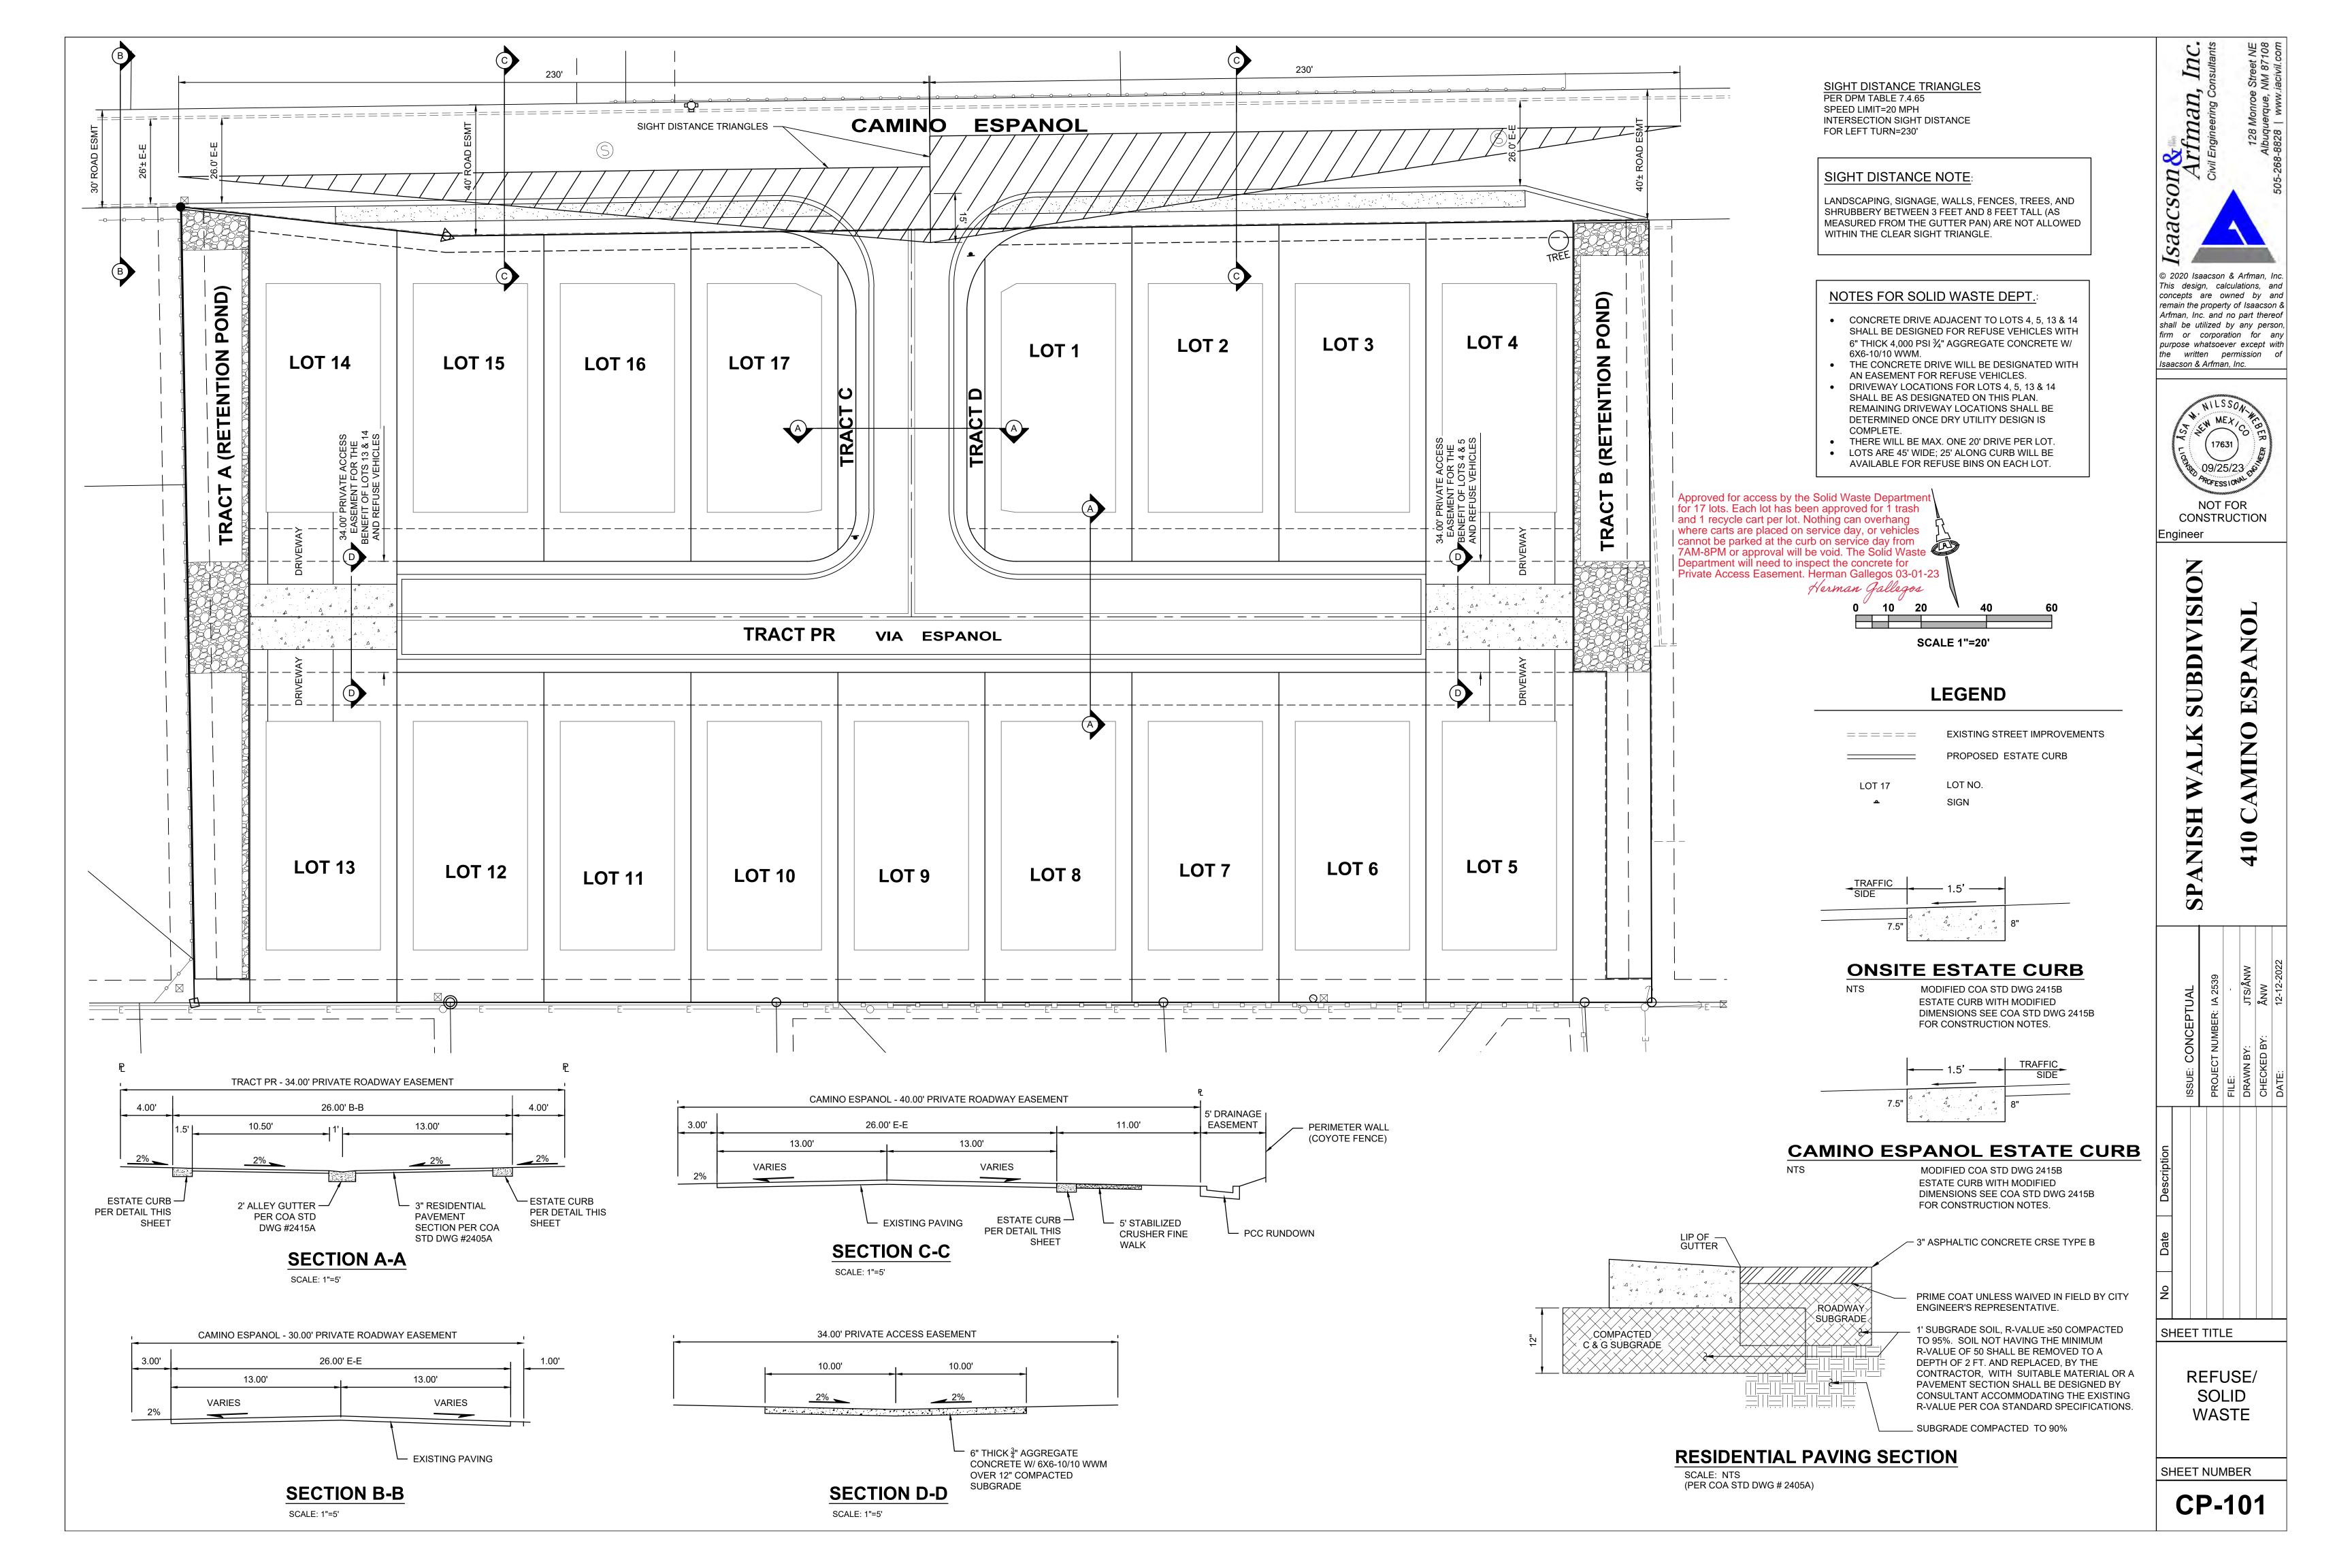

EXTERIOR FINISH SCHEDULE					
	TYPE M	ODEL/STYLE NUMBER	COLOR		
STUCCO	DRIVIT	SYNTHETIC	N/A	EARTH TONES TO COMPLY W/SPANISH TRAIL HOA GUIDELINES	
PAINT	PPG	EXTERIOR	N/A	MATCH STUCCO	
ROOF_(PITCHED)	METAL CENTER	NON-REFLECTIVE CORRUGATED METAL	N/A	SILVER OR RUST	
ROOF FLAT	CARLISLE	NON-REFLECTIVE TPO	N/A	TAN	
GARAGE DOOR	GARAGE DOOR CHI		STYLE # 2157	MATCH STUCCO	
FRONT DOOR	PELLA	METAL CLAD	LIFESTYLE	BLACK	
WINDOW FRAME	PELLA	METAL CLAD	LIFESTYLE	BLACK	
SLIDING GLASS DOORS	PELLA	METAL CLAD	LIFESTYLE	BLACK	





CONSULTANTS


ISAACSON & ARFMAN, Inc.
Consulting Engineering Associates

128 Monroe Street N.E.
Albuquerque, New Mexico 87108
Ph. 505-268-8828 www.iacivil.com

CAMINO ESPANOL

Building Design Standards pursuant to IDO Section 14—16—5—11 (C) Low Density Residential District are as follows:

- All windows shall be recessed not less than 2" and shall comply with IDO Section 5-11 (c) (2) WINDOWS:
- 2. Any accessory structure shall comply with IDO Section 5—11 (c) (4) ACCESSORY BUILDINGS

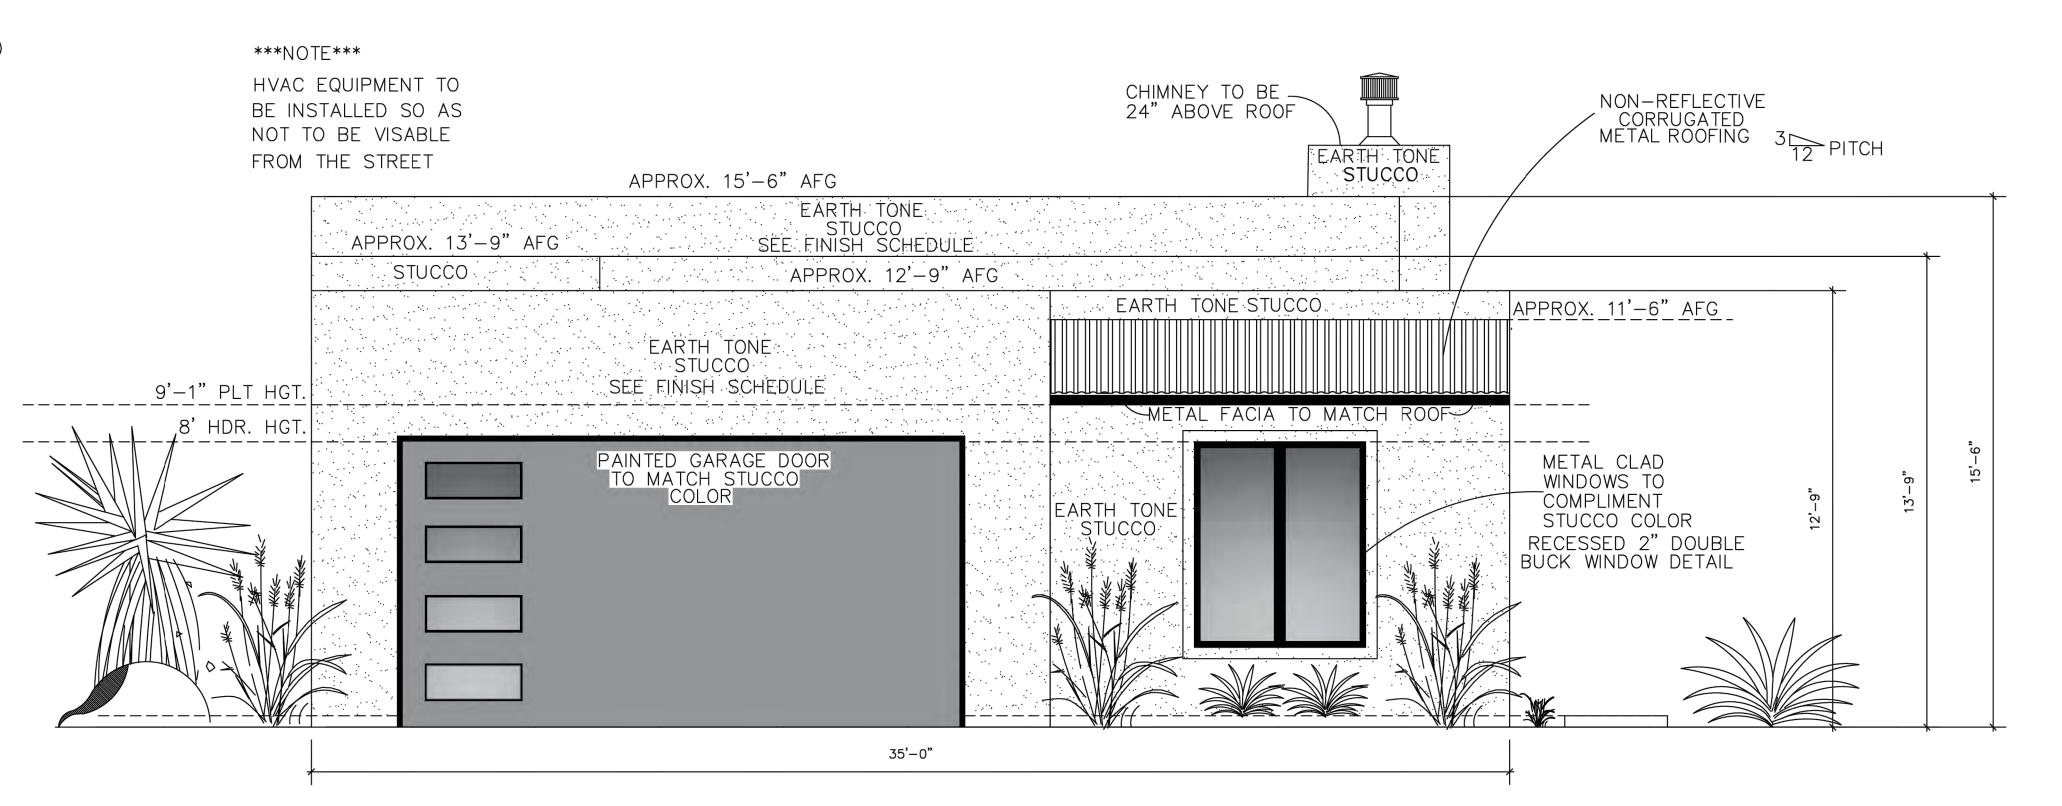

FRONT ELEVATION

SCALE = 1/4" = 1'-0"

SPANISH WALK ALBUQUERQUE, NM

SUB	SUBMITTAL: MARCH 28, 2023					
REV	'ISIONS	SIONS				
NO.	DATE	DESCRI	DESCRIPTION			
PRO	JECT NO:	1538-04				
CAD	DWG FIL	E:				
DES	ESIGNED BY: DATE: 3/28/23					
DRA	RAWN BY:		DATE: 3/28/23			
CHE	CKED BY		DATE: 3/28/23			
SHE	ET TITL	.E				

ELEVATIONS EPC

DRAWING SHEET

A101

CITY OF ALBUQUERQUE

Planning Department Alan Varela, Director



Mayor Timothy M. Keller

July 24, 2023

Justin Thor Simenson Isaacson & Arfman, Inc 128 Monroe St. NE Albuquerque, NM 87108

Re: Spanish Walk

410 Camino Espanol NW

Conceptual Traffic Circulation Layout for DFT Approval

Engineer's Stamp 07-05-23 (E14-D002A)

Dear Mr. Simenson,

The conceptual TCL submittal received 07-07-2023 is approved for DHO and/or DFT submittal. When submitting this project through the building permit process, a full Traffic Circulation Layout will need to be submitted and approved prior to building permit.

PO Box 1293

When the site construction is completed and an inspection for Certificate of Occupancy (C.O.) is requested, use the original City stamped approved TCL for certification. Redline any minor changes and adjustments that were made in the field. A NM registered architect or engineer must stamp, sign, and date the certification TCL along with indicating that the development was built in "substantial compliance" with the TCL. Submit this certification, the TCL, and a completed <u>Drainage and Transportation Information Sheet</u> to front counter personnel for log in and evaluation by Transportation. **Sidewalk will be determined at DFT.**

NM 87103

Albuquerque

Once verification of certification is completed and approved, notification will be made to Building Safety to issue Final C.O. To confirm that a final C.O. has been issued, call Building Safety at 924-3690.

www.cabq.gov

Sincerely,

Ernest Armijo, P.E.

Principal Engineer, Planning Dept. Development Review Services

C: CO Clerk, File




City of Albuquerque

Planning Department


Development & Building Services Division


DRAINAGE AND TRANSPORTATION INFORMATION SHEET

_EPC#_PR-2023-008085
City Address OR Parcel 410 Camino Espanol,
Contact: Justin Thor Simenson
Phone: 505-268-8828
<u> </u>
Contact:T. Scott Ashcraft
13 Phone:
_
ESIDENCE X DRB SITE ADMIN SITE:
_HYDROLOGY/DRAINAGE
E OF APPROVAL/ACCEPTANCE SOUGHT:
BUILDING PERMIT APPROVAL
CERTIFICATE OF OCCUPANCY
X CONCEPTUAL TCL DRB APPROVAL
PRELIMINARY PLAT APPROVAL
SITE PLAN FOR SUB'D APPROVAL
SITE PLAN FOR BLDG PERMIT APPROVAL
FINAL PLAT APPROVAL
SIA/RELEASE OF FINANCIAL GUARANTEE
FOUNDATION PERMIT APPROVAL
GRADING PERMIT APPROVAL
SO-19 APPROVAL
PAVING PERMIT APPROVAL
GRADING PAD CERTIFICATION
WORK ORDER APPROVAL
CLOMR/LOMR
FLOOD PLAN DEVELOPMENT PERMIT
OTHER (SPECIFY)

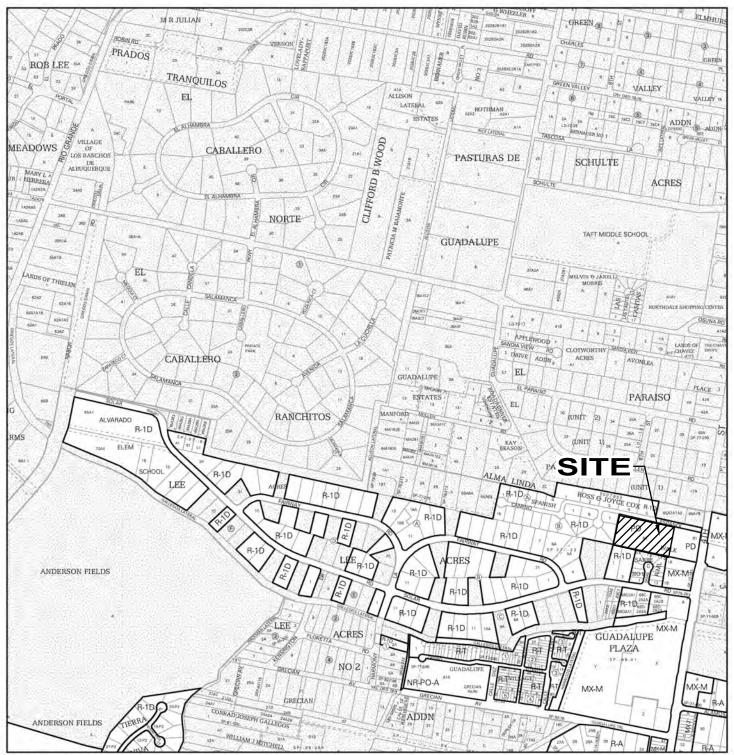

For more details about the Integrated Development Ordinance visit: http://www.cabq.gov/planning/codes-policies-regulations/integrated-development-ordinance

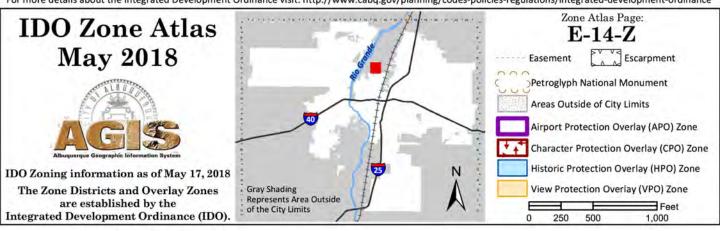

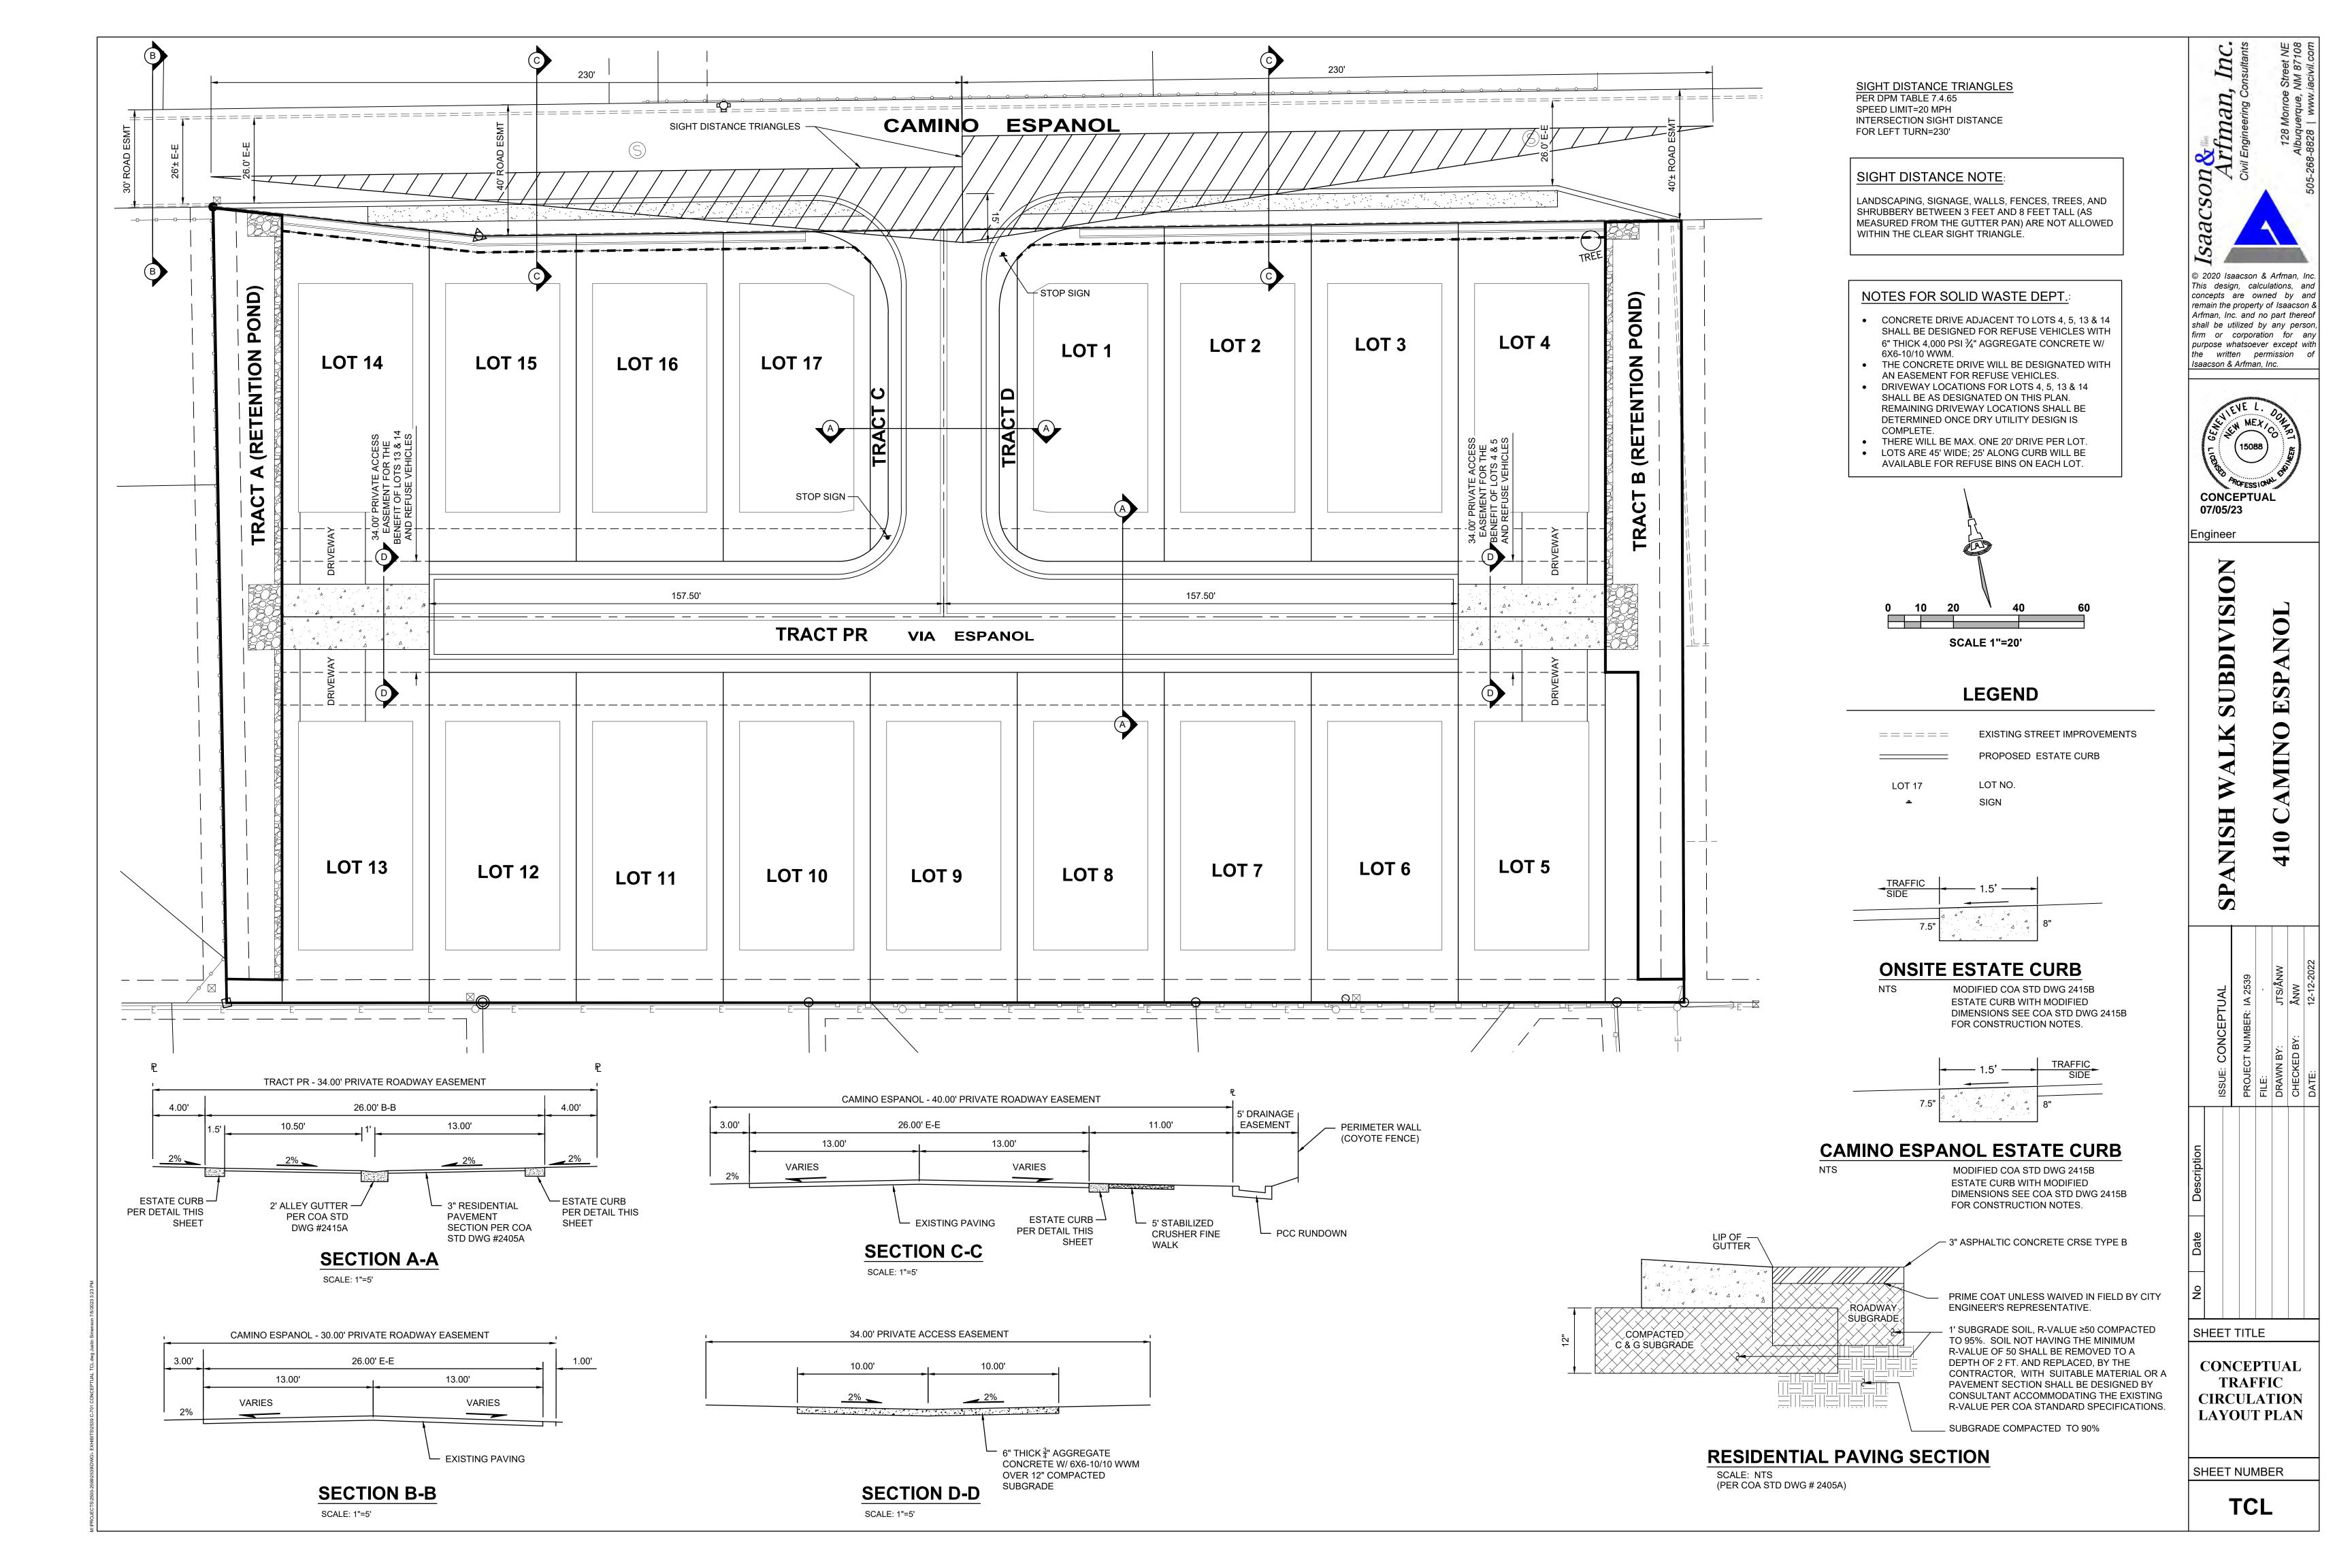

PR-2023-008085_SI-2023-01465_Site_Plan_Ap proved_11-6-23

Final Audit Report 2023-12-14

Created: 2023-11-13

By: Jay Rodenbeck (jrodenbeck@cabq.gov)

Status: Signed

Transaction ID: CBJCHBCAABAAex_PPeVihE30jYXejF8QxvA0S3fb7xi7

"PR-2023-008085_SI-2023-01465_Site_Plan_Approved_11-6-23 " History

- Document created by Jay Rodenbeck (jrodenbeck@cabq.gov) 2023-11-13 3:17:24 AM GMT- IP address: 198.206.237.4
- Document emailed to Jolene Wolfley (jwolfley@cabq.gov) for signature 2023-11-13 3:23:51 AM GMT
- Document emailed to Ernest Armijo (earmijo@cabq.gov) for signature 2023-11-13 3:23:51 AM GMT
- Document emailed to Tiequan Chen (tchen@cabq.gov) for signature 2023-11-13 3:23:51 AM GMT
- Document emailed to David G. Gutierrez (dggutierrez@abcwua.org) for signature 2023-11-13 3:23:51 AM GMT
- Document emailed to Jeff Palmer (jppalmer@cabq.gov) for signature 2023-11-13 3:23:51 AM GMT
- Document emailed to Whitney Phelan (wphelan@cabq.gov) for signature 2023-11-13 3:23:51 AM GMT
- Email viewed by Ernest Armijo (earmijo@cabq.gov) 2023-11-13 3:24:06 AM GMT- IP address: 40.94.29.155
- Email viewed by Tiequan Chen (tchen@cabq.gov) 2023-11-13 3:24:28 AM GMT- IP address: 40.94.28.147
- Email viewed by Jeff Palmer (jppalmer@cabq.gov)
 2023-11-13 1:54:29 PM GMT- IP address: 172.59.1.86



Document e-signed by Jeff Palmer (jppalmer@cabq.gov)

Signature Date: 2023-11-13 - 1:54:54 PM GMT - Time Source: server- IP address: 172.59.1.86

Document e-signed by Ernest Armijo (earmijo@cabq.gov)

Signature Date: 2023-11-13 - 2:35:09 PM GMT - Time Source: server- IP address: 143.120.132.81

Document e-signed by Tiequan Chen (tchen@cabq.gov)

Signature Date: 2023-11-13 - 2:55:37 PM GMT - Time Source: server- IP address: 143.120.132.88

Email viewed by Whitney Phelan (wphelan@cabq.gov)

2023-11-13 - 3:05:30 PM GMT- IP address: 172.59.1.148

Email viewed by Whitney Phelan (wphelan@cabq.gov)

2023-11-14 - 4:58:47 PM GMT- IP address: 143.120.170.188

Document e-signed by Whitney Phelan (wphelan@cabq.gov)

Signature Date: 2023-11-14 - 5:08:28 PM GMT - Time Source: server- IP address: 143.120.170.188

New document URL requested by Whitney Phelan (wphelan@cabq.gov)

2023-11-21 - 7:38:54 PM GMT- IP address: 143.120.170.188

Document e-signed by David G. Gutierrez (dggutierrez@abcwua.org)

Signature Date: 2023-12-13 - 8:57:56 PM GMT - Time Source: server- IP address: 165.225.36.92

Email viewed by Jolene Wolfley (jwolfley@cabq.gov)

2023-12-14 - 5:26:24 PM GMT- IP address: 143.120.133.169

New document URL requested by Jolene Wolfley (jwolfley@cabq.gov)

2023-12-14 - 5:26:28 PM GMT- IP address: 143.120.133.169

Document e-signed by Jolene Wolfley (jwolfley@cabq.gov)

Signature Date: 2023-12-14 - 5:29:14 PM GMT - Time Source: server- IP address: 143.120.133.169

Agreement completed.

2023-12-14 - 5:29:14 PM GMT