


B-18-Z ARCHITECT SEAL

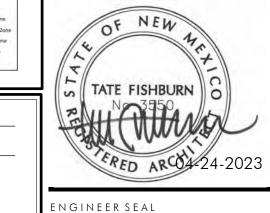

PROJECT

DATE

*ENVIRONMENTAL HEALTH DEPARTMENT (CONDITIONAL)

*ENVIRONMENTAL HEALTH, IF NECESSARY

//////// SITE DISTANCE AND SITE TRIANGLE BASED ON COA DPM riangleq 7-4(I)(5)(iii) and 7-4(I)(5)(iv), LANDSCAPING AND SIGNAGE WILL NOT INTERFERE WITH CLEAR SIGHT REQUIREMENTS, THEREFORE SIGNS, WALLS, TREES, AND SHRUBBERY BETWEEN 3 AND 8 FEET TALL (AS MEASURED FROM THE GUTTER PAN) WILL NOT BE ACCEPTABLE IN THE CLEAR SITE

HANDICAP PARKING PAVEMENT MARKING

EXISTING FIRE HYDRANT

- 1. THIS SITE PLAN MEETS THE REQUIREMENTS OF THE CITY OF
- 2. ALL SITE LIGHTING SHALL COMPLY WITH IDO SECTION 14-16-5-8. OUTDOOR AND SITE LIGHTING.
- 3. PLACEMENT OF FIXTURES & STANDARDS SHALL CONFORM TO STATE & LOCAL SAFETY & ILLUMINATION REQUIREMENTS.
- 4. ALL LIGHT FIXTURES SHALL BE FULLY SHIELDED HORIZONTAL LAMPS WITH NO LIGHT, LENS OR BULB PROTRUDING BELOW THE BOTTOM OF
- SOURCE SHALL BE VISIBLE FRO THE SITE PERIMETER ROOF TOP AND GROUND MOUNTED EQUIPMENT SHALL BE SCREENED FROM THE PUBLIC VIEW BY MATERIALS OF THE SAME NATURE AS THE BUILDINGS BASIC MATERIALS. THE TOP OF ALL ROOFTOP EQUIPMENT SHALL BE BELOW THE TOP OF THE PARAPET OR SCREENED FROM
- VIEW FROM PUBLIC RIGHTS-OF-WAY AND THE SITE ACCESS EASEMENT. SITE HANDICAP RAMPS SHALL BE BUILT BY COA STANDARD DRAWING

SITE DEVELOPMENT PLAN BUILDING EXTERIOR ELEVATIONS GRADING & DRAINAGE PLAN MASTER UTILITY PLAN LANDSCAPE PLAN IRRIGATION PLAN

APRIL 24, 2023


 O

1"=20'-0" OR AS NOTED

DRAWING NAME SITE DEVELOPMENT

PLAN

SHEETNUMBER

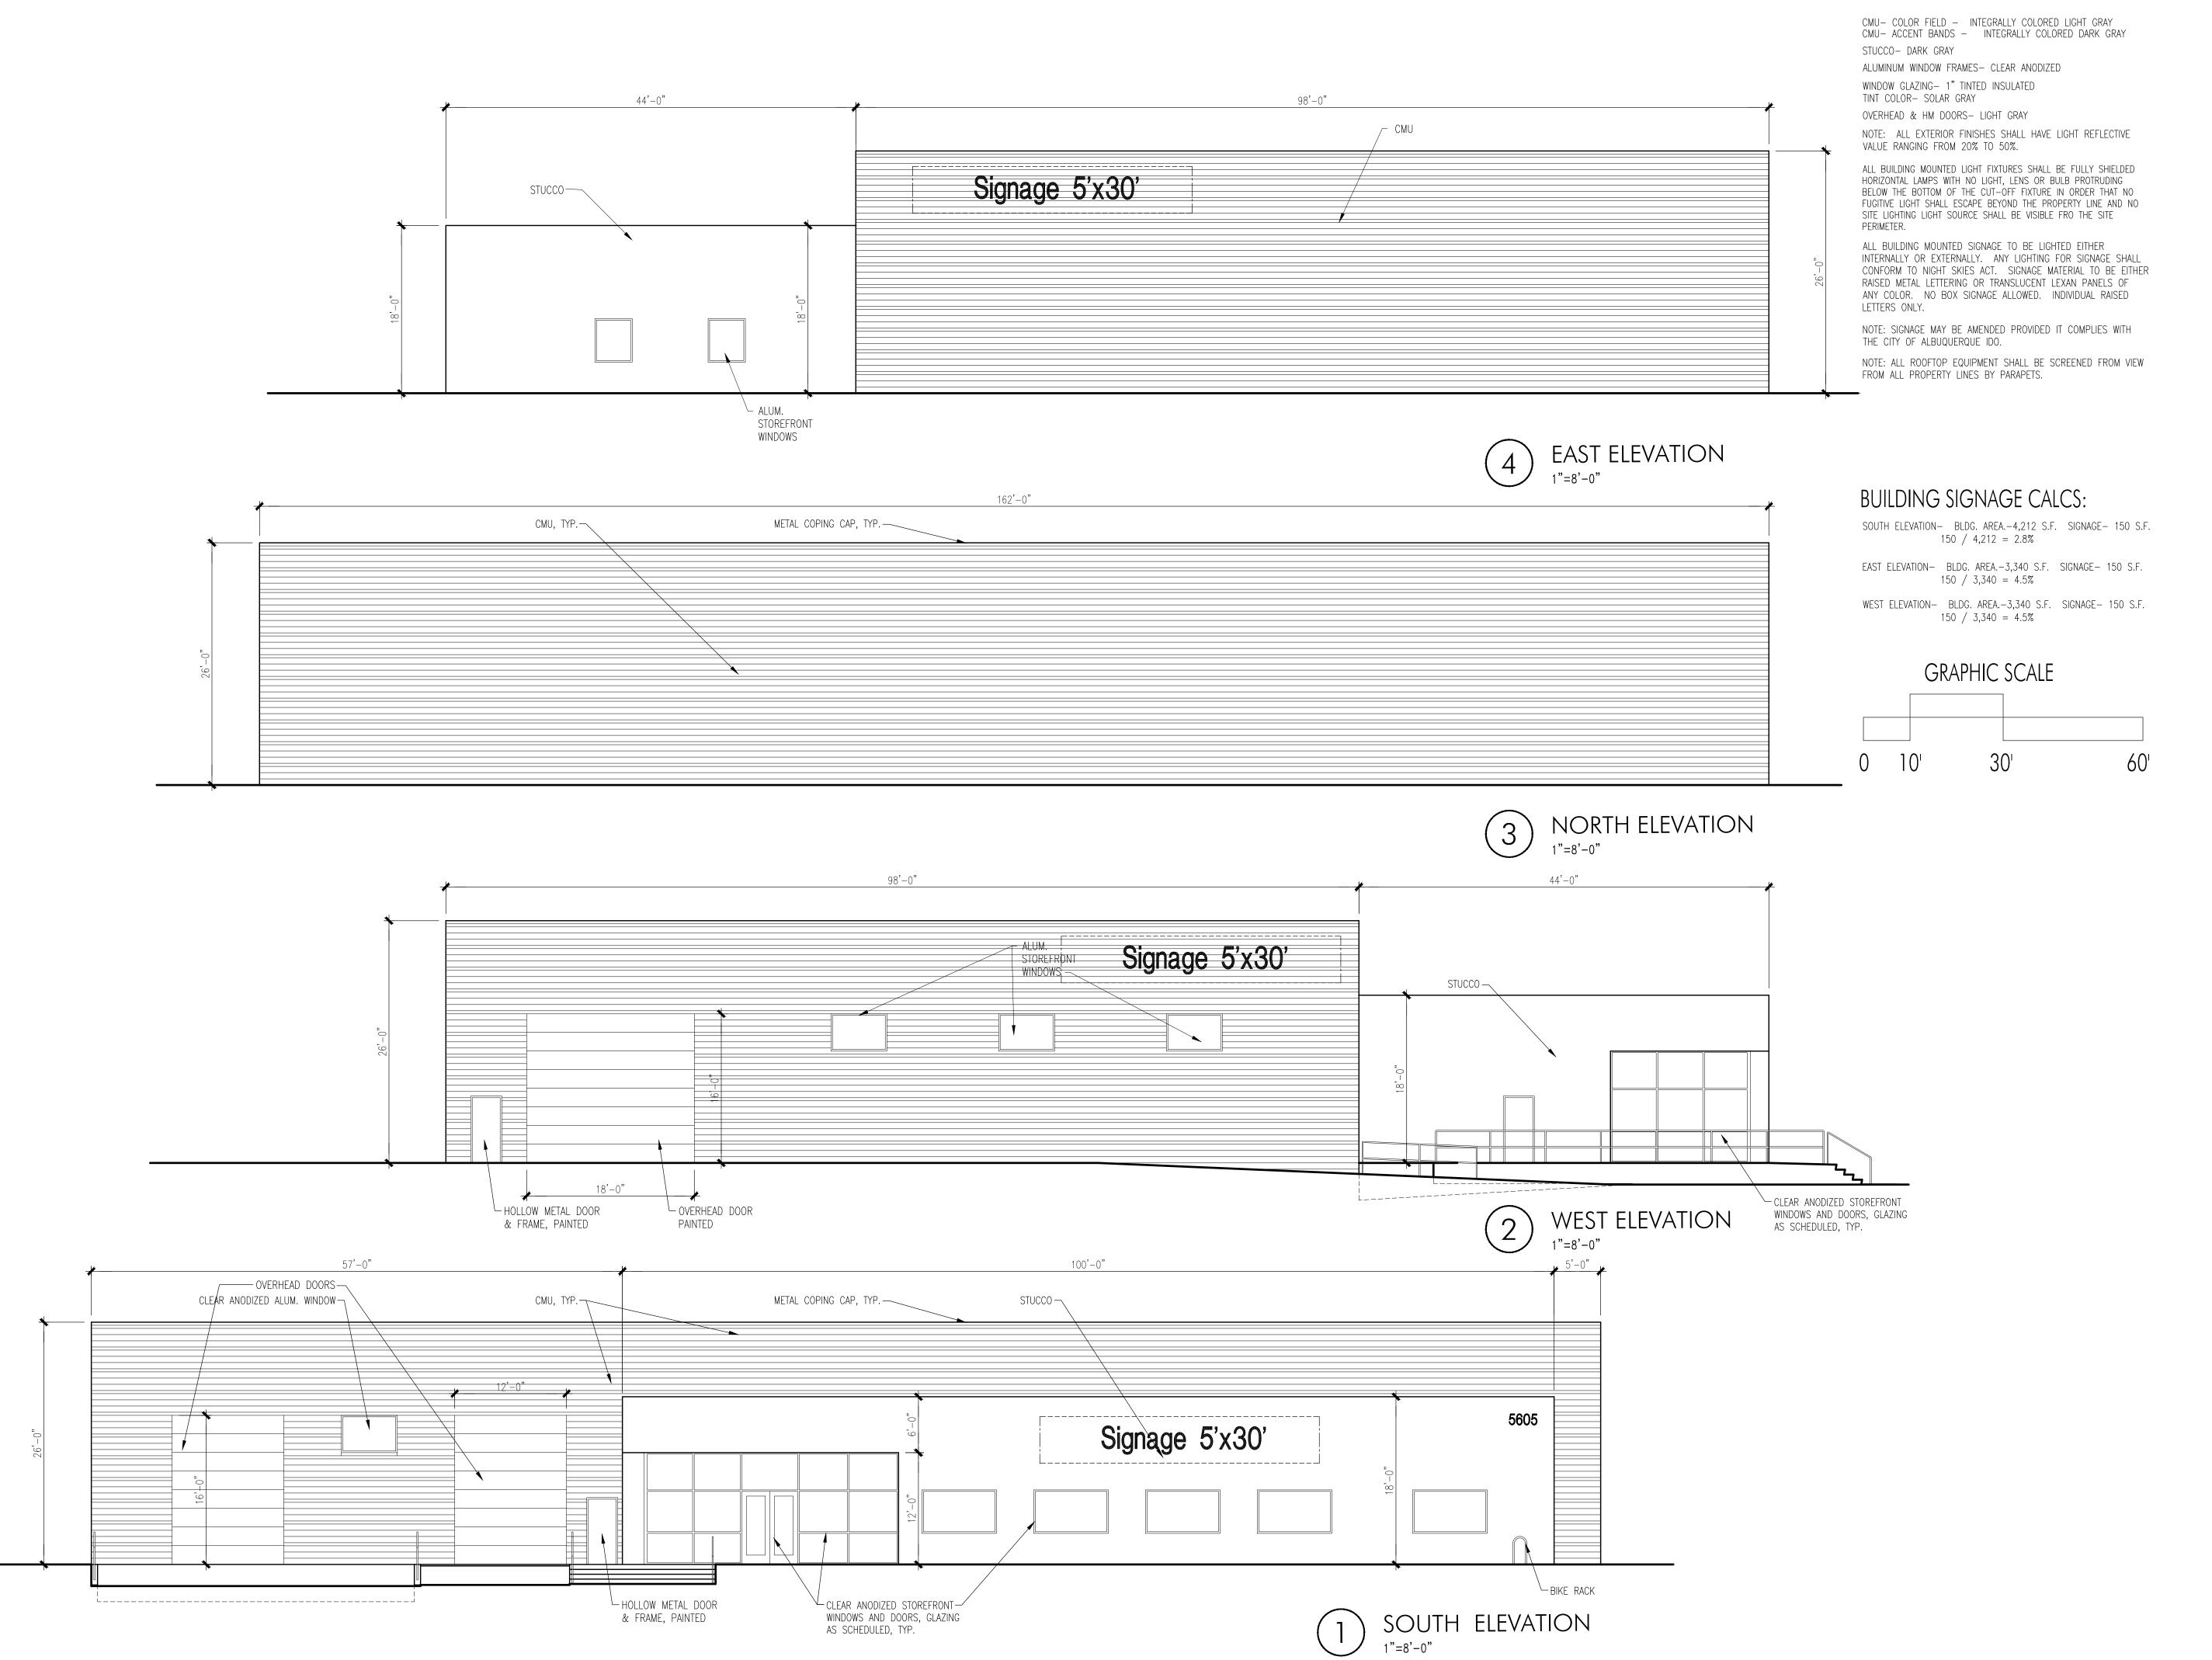

EXTERIOR FINISHES

TATE FISHBURN

NEW

STATE FISHBURN

NO 3950

FRED AROS-01-2023

ENGINEER SEAL

 $Z \vdash$

 \supset

В

 \perp

шΟ

 \vdash

S

PROJECT

NEW OFFICE/WAREHOUSE
5605 VENICE AVE., NE

REVISIONS

DATE APRIL 24, 2023


1/8" = 1'-0"

OR AS NOTED

BUILDING ELEVATIONS

SHEET NUMBER

SDP-2

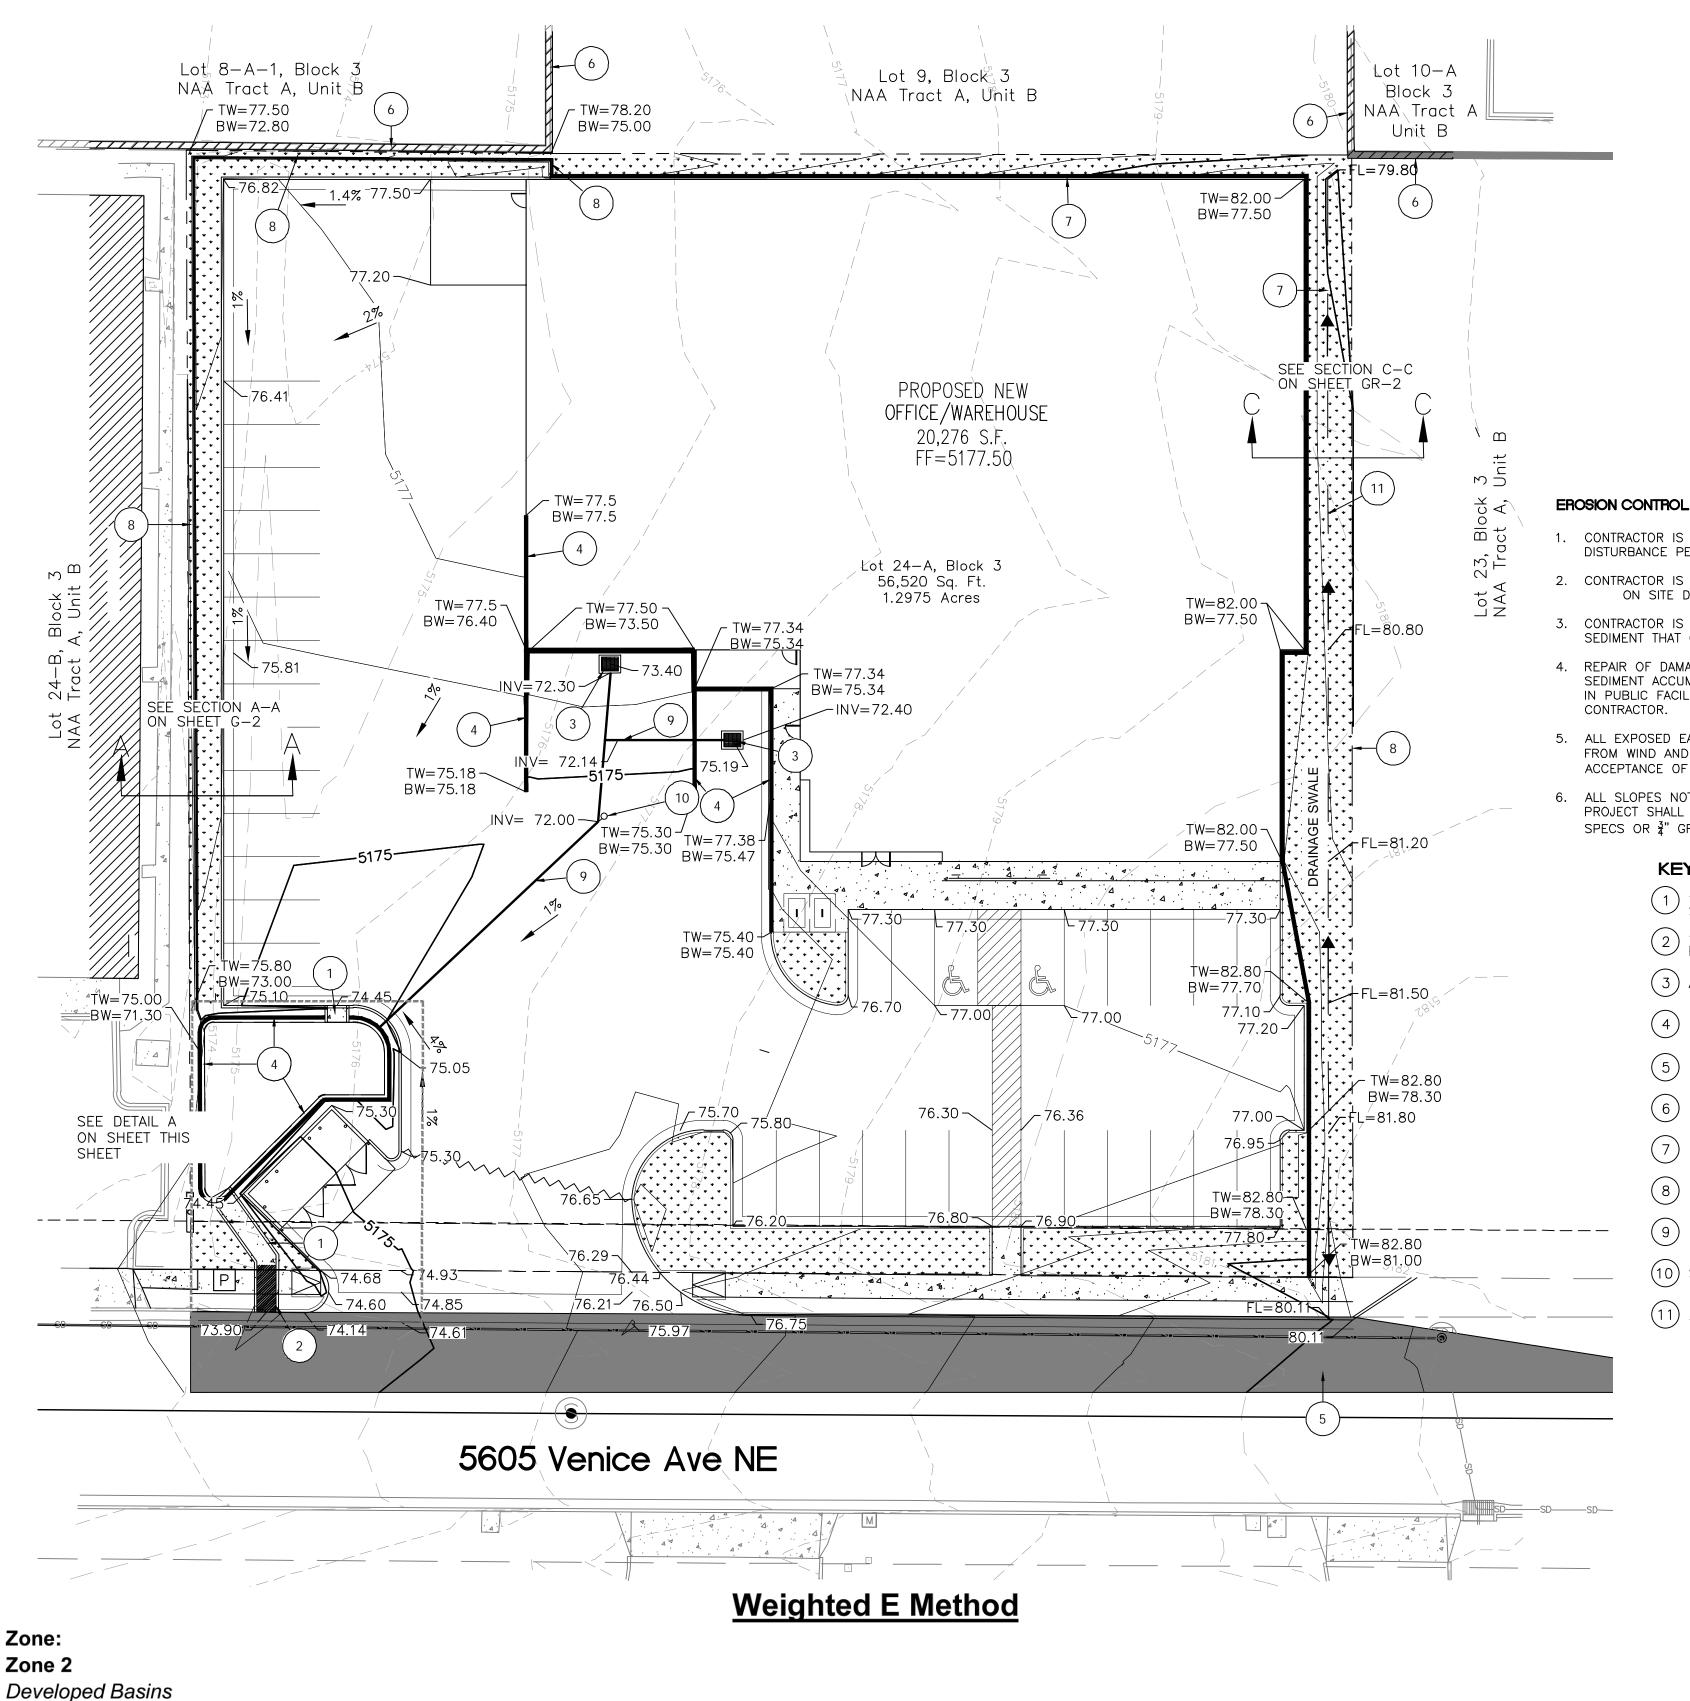

Zone: Zone 2

	Basin Area Treatments						100-Year							
Basin	Area	Area	Area	Treatr	Treatment A Treatment B Treatment C		Treatment D		Weighted E	Volume	Flow			
	(sf)	(acres)	(sq miles)	%	(acres)	%	(acres)	%	(acres)	%	(acres)	(ac-ft)	(ac-ft)	cfs
D-2W/75'	56,520.0	1.30	0.002	0%	0.00	0%	0.00	15%	0.19	75%	0.97	1.902	0.206	4.82
Total	56,520.0	1.298	0.00203		0.00		0.000		0.195		0.973		0.206	4.82

FIRST FLUSH VOLUME REQUIRED = 1554.37 Cu.Ft. < POND VOLUME PROVIDED = 1,700 Cu.Ft.

CAUTION

NARRATIVE:

THIS CURRENTLY VACANT SITE IS LOCATED IN THE DRAINGE BASIN ANALYZED WITHIN A MASTER DRAINAGE PLAN (B17D03).PER THE MASTER PLAN IT IS ALLOWED FREE DISCHARGE TO THE EXISTING STREET AND STORM DRAIN IN VENICE AVE., NE.THE PROPOSED ON-SITE IMPERVIOUS AREAS FIRST DRAIN TO A PROPOSED POND WHERE THE FIRST FLUSH VOLUME WILL BE RETAINED ON SITE.

LEGEND

CURB & GUTTER
 BOUNDARY LINE
 EASEMENT
 BUILDING
SIDEWALK
 EXISTING CURB & GUTTER
 EXISTING INDEX CONTOUR
 EXISTING CONTOUR
 PROPOSED INDEX CONTOUR
 PROPOSED CONTOUR
RETAINING WALL

EROSION CONTROL NOTES:

- 1. CONTRACTOR IS RESPONSIBLE FOR OBTAINING A TOPSOIL DISTURBANCE PERMIT PRIOR TO BEGINNING WORK.
- 2. CONTRACTOR IS RESPONSIBLE FOR MAINTAINING RUN-OFF ON SITE DURING CONSTRUCTION.
- 3. CONTRACTOR IS RESPONSIBLE FOR CLEANING ALL SEDIMENT THAT GETS INTO EXISTING RIGHT-OF-WAY.
- 4. REPAIR OF DAMAGED FACILITIES AND CLEANUP OF SEDIMENT ACCUMULATIONS ON ADJACENT PROPERTIES AND IN PUBLIC FACILITIES IS THE RESPONSIBILITY OF THE
- 5. ALL EXPOSED EARTH SURFACES MUST BE PROTECTED FROM WIND AND WATER EROSION PRIOR TO FINAL (CITY) ACCEPTANCE OF ANY PROJECT.
- 6. ALL SLOPES NOT STABILIZED AT THE END OF THE PROJECT SHALL BE STABILIZED IN ACCORDANCE WITH COA SPECS OR ¾" GRAVEL

KEYED NOTES

- 1 4' CONCRETE RUNDOWN, SEE DETAIL THIS SHEET
- 2 4' SIDEWALK CULVERT PER COA STD DWG 2236
- (3) AREA DRAIN
- (4) RETAINING WALL WITH RAILING
- NEW ASPHALT PAVEMENT
 (MATCH GRADES AT EXISTING PAVEMENT EDGE)
- (6) EXISTING RETAINING/PERIMETER WALL
- (7) EXTENDED STEM WALL/RETAINING WALL
- (8) RETAINING WALL WITHOUT RAILING
- 9 6" PVC SD
- (10) SD CLEAN OUT
- (11) 2' SWALE

ALL EXISTING UTILITIES SHOWN WERE OBTAINED FROM RESEARCH, AS-BUILTS, SURVEYS OR INFORMATION

NECESSARY FIELD INVESTIGATIONS PRIOR TO AND INCLUDING ANY EXCAVATION, TO DETERMINE THE ACTUAL


LOCATION OF UTILITIES AND OTHER IMPROVEMENTS, PRIOR TO STARTING THE WORK. ANY CHANGES FROM THIS

PROVIDED BY OTHERS. IT SHALL BE THE SOLE RESPONSIBILITY OF THE CONTRACTOR TO CONDUCT ALL


PLAN SHALL BE COORDINATED WITH AND APPROVED BY THE ENGINEER.


NOTICE TO CONTRACTORS

- 1. AN EXCAVATION/CONSTRUCTION PERMIT WILL BE REQUIRED BEFORE BEGINNING ANY WORK WITHIN CITY
- 2. ALL WORK DETAILED ON THESE PLANS TO BE PERFORMED, EXCEPT AS OTHERWISE STATED OR PROVIDED HERON, SHALL BE CONSTRUCTED IN ACCORDANCE WITH CITY OF ALBUQUERQUE INTERIM STANDARD SPECIFICATIONS FOR PUBLIC WORKS CONSTRUCTION, 1985.
- 3. TWO WORKING DAYS PRIOR TO ANY EXCAVATION, CONTRACTOR MUST CONTACT LINE LOCATING SERVICE, 765-1234, FOR LOCATION OF EXISTING UTILITIES.
- 4. PRIOR TO CONSTRUCTION, THE CONTRACTOR SHALL EXCAVATE AND VERIFY THE HORIZONTAL AND VERTICAL LOCATIONS OF ALL CONNECTIONS. SHOULD A CONFLICT EXIST, THE CONTRACTOR SHALL NOTIFY THE ENGINEER SO THAT THE CONFLICT CAN BE RESOLVED WITH A MINIMUM AMOUNT OF DELAY.
- 5. BACKFILL COMPACTION SHALL BE ACCORDING TO TRAFFIC/STREET USE.
- 6. MAINTENANCE OF THESE FACILITIES SHALL BE THE RESPONSIBILITY OF THE OWNER OF THE PROPERTY
- 7. WORK ON ARTERIAL STREETS SHALL BE PERFORMED ON A 24-HOUR BASIS.

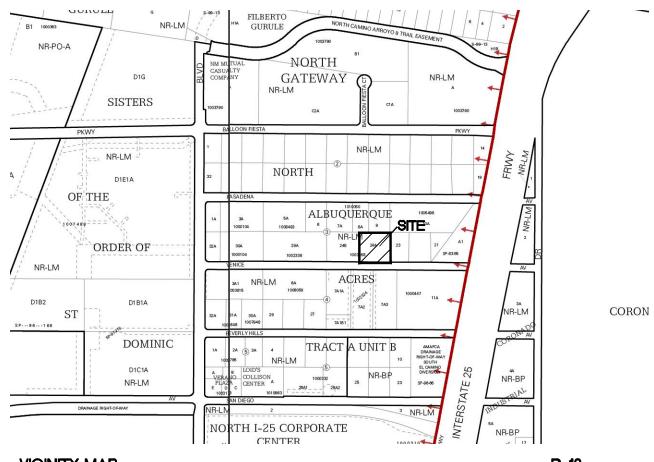




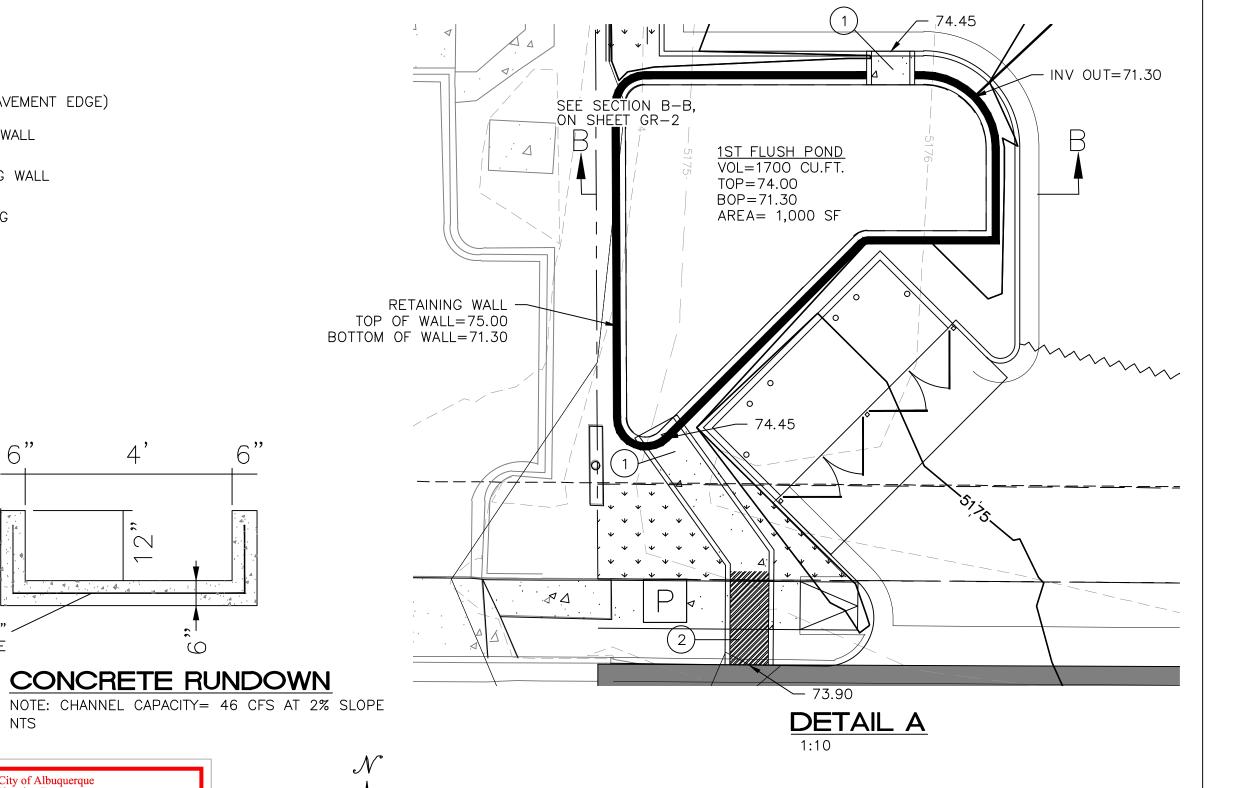

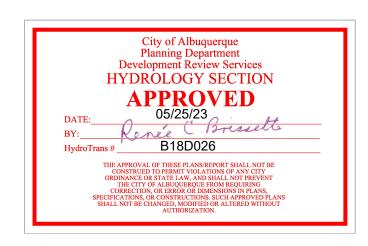

10"X10"X10" WOVEN WIRE **FABRIC**

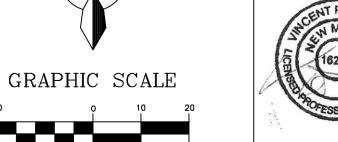

ENGINEER'S SEAL

FLOOD MAP

GLASS RITE DRAWN BY 5605 VENICE AVE 5/24/2023 GRADING AND DRAINAGE DRAWING **PLAN** SHEET # TIERRA WEST, LLC GR-1 5571 MIDWAY PARK PL NE

ALBUQUERQUE, NEW MEXICO 87109

JOB #


2022092


(505) 858-3100

www.tiérrawestllc.com

(IN FEET) 1 inch = 20 ft.

5/24/2023 VINCENT P. CARRICA P.E. #16212

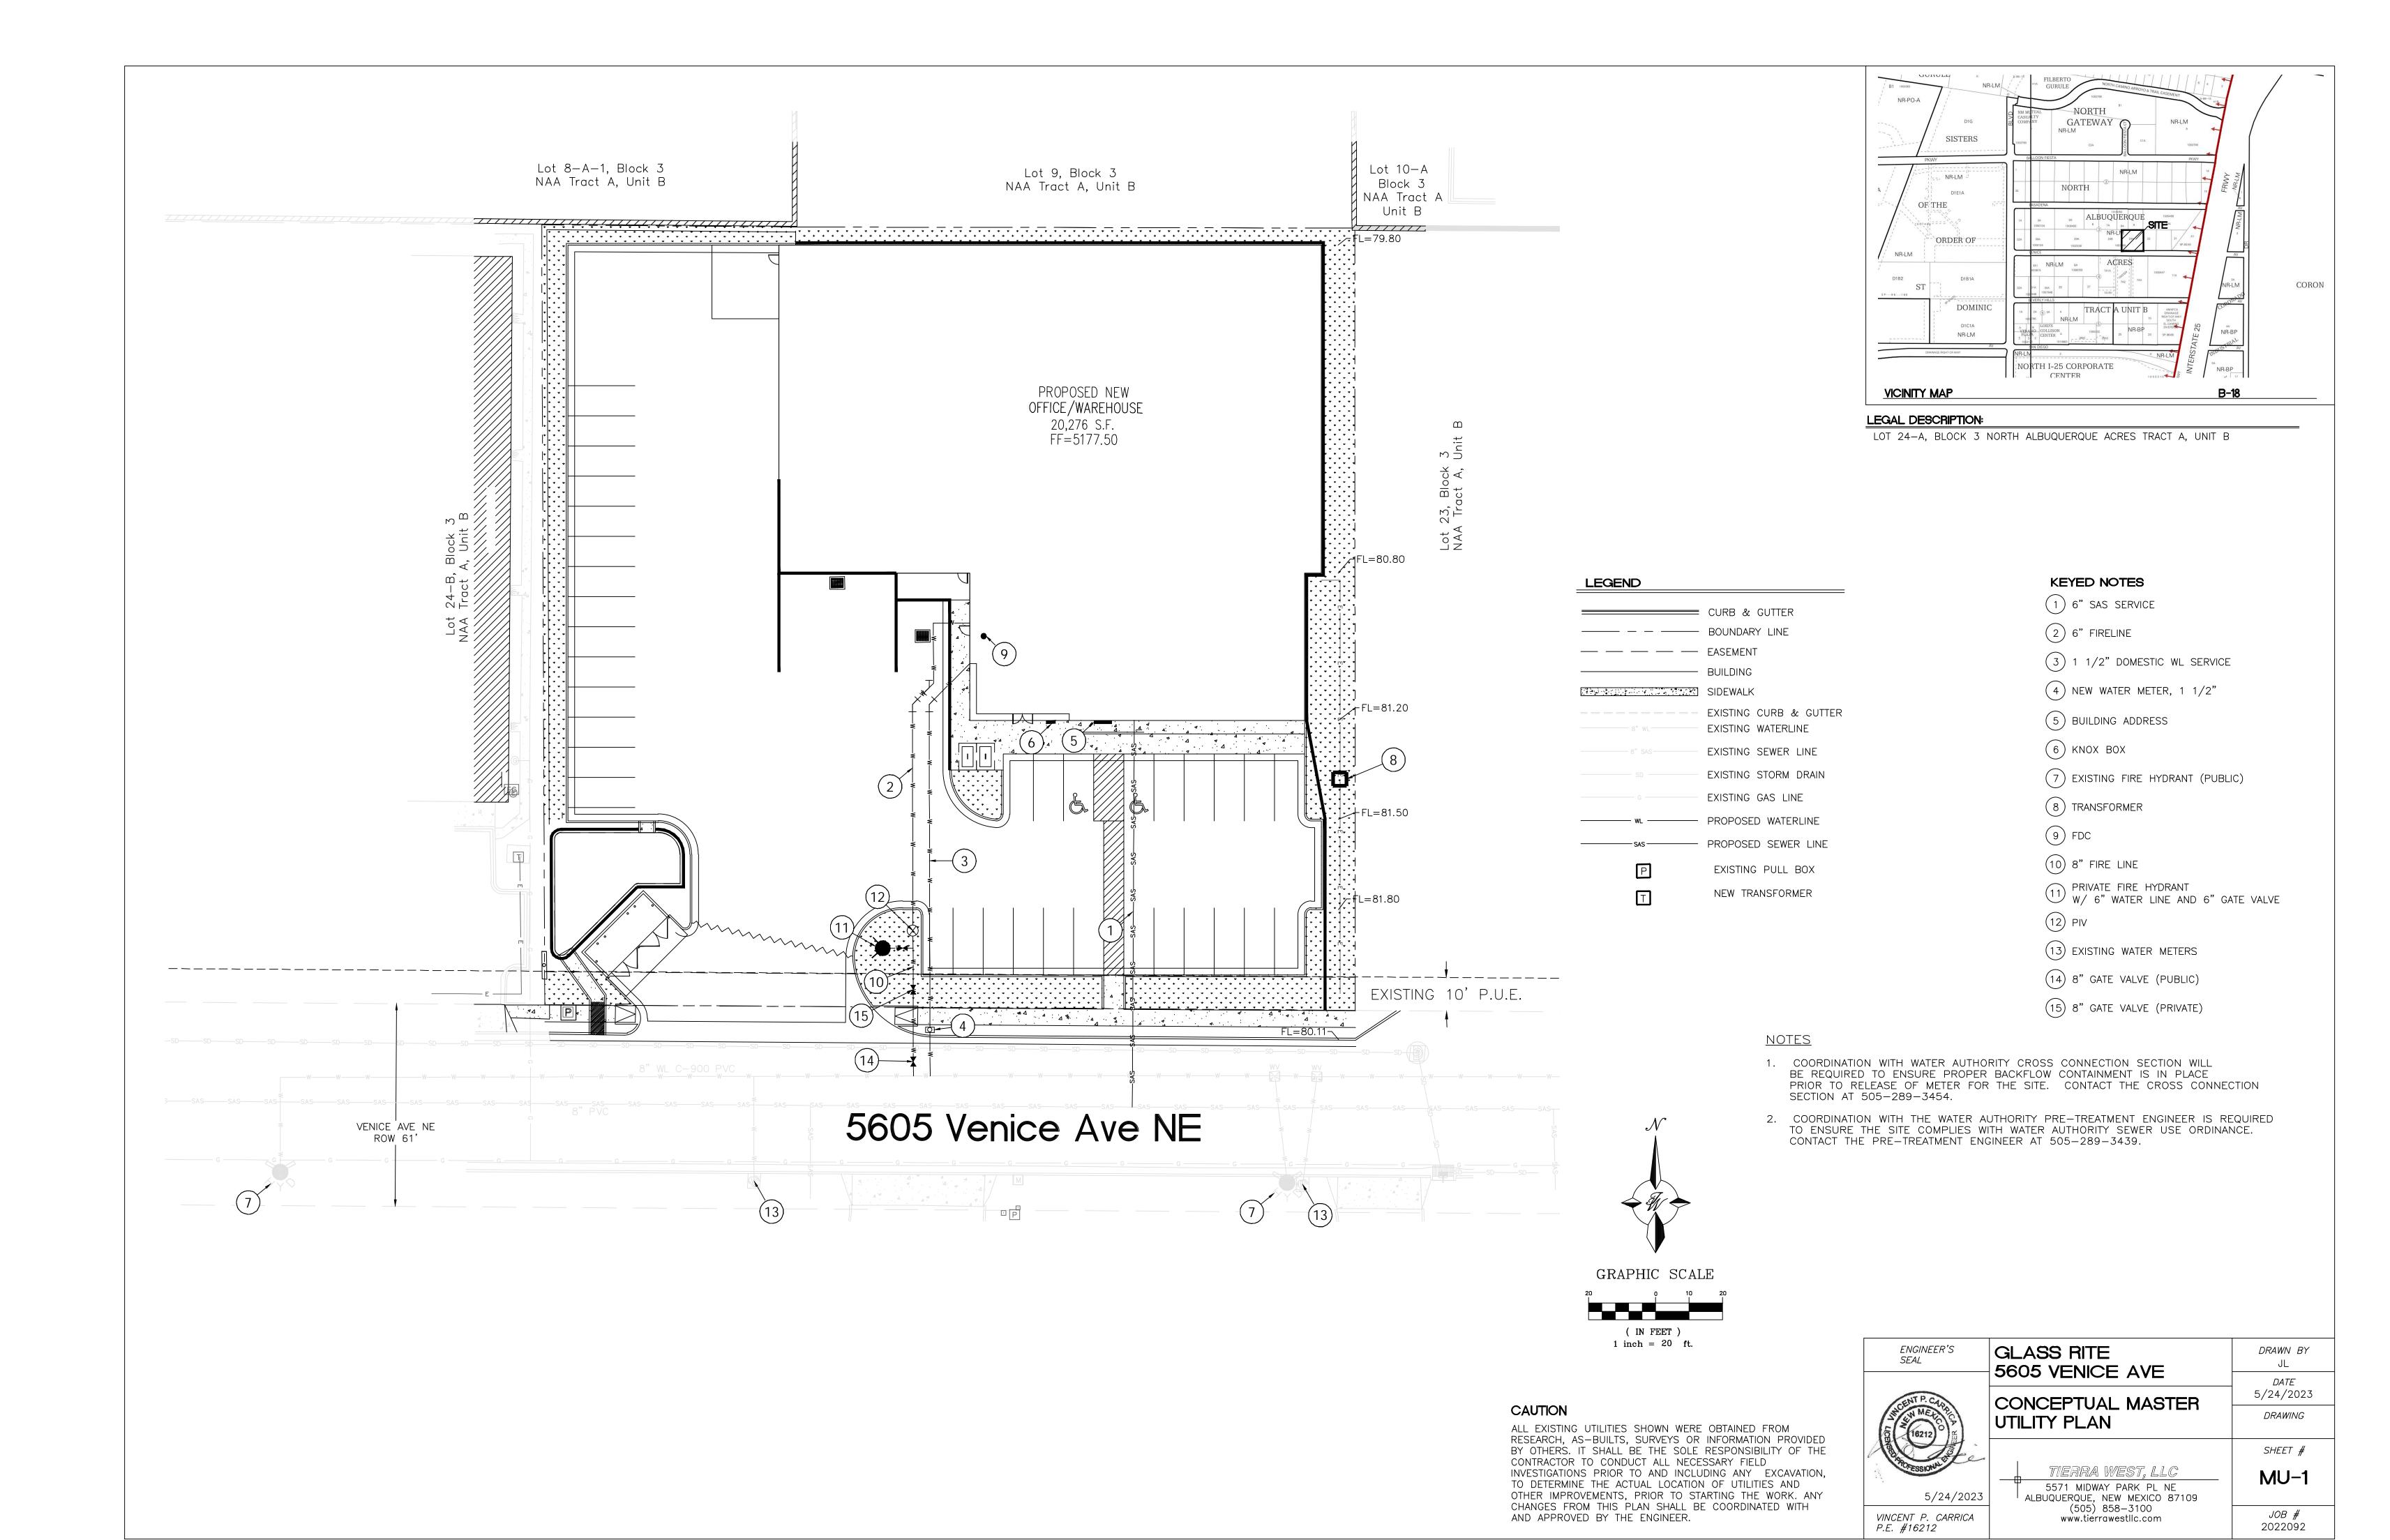

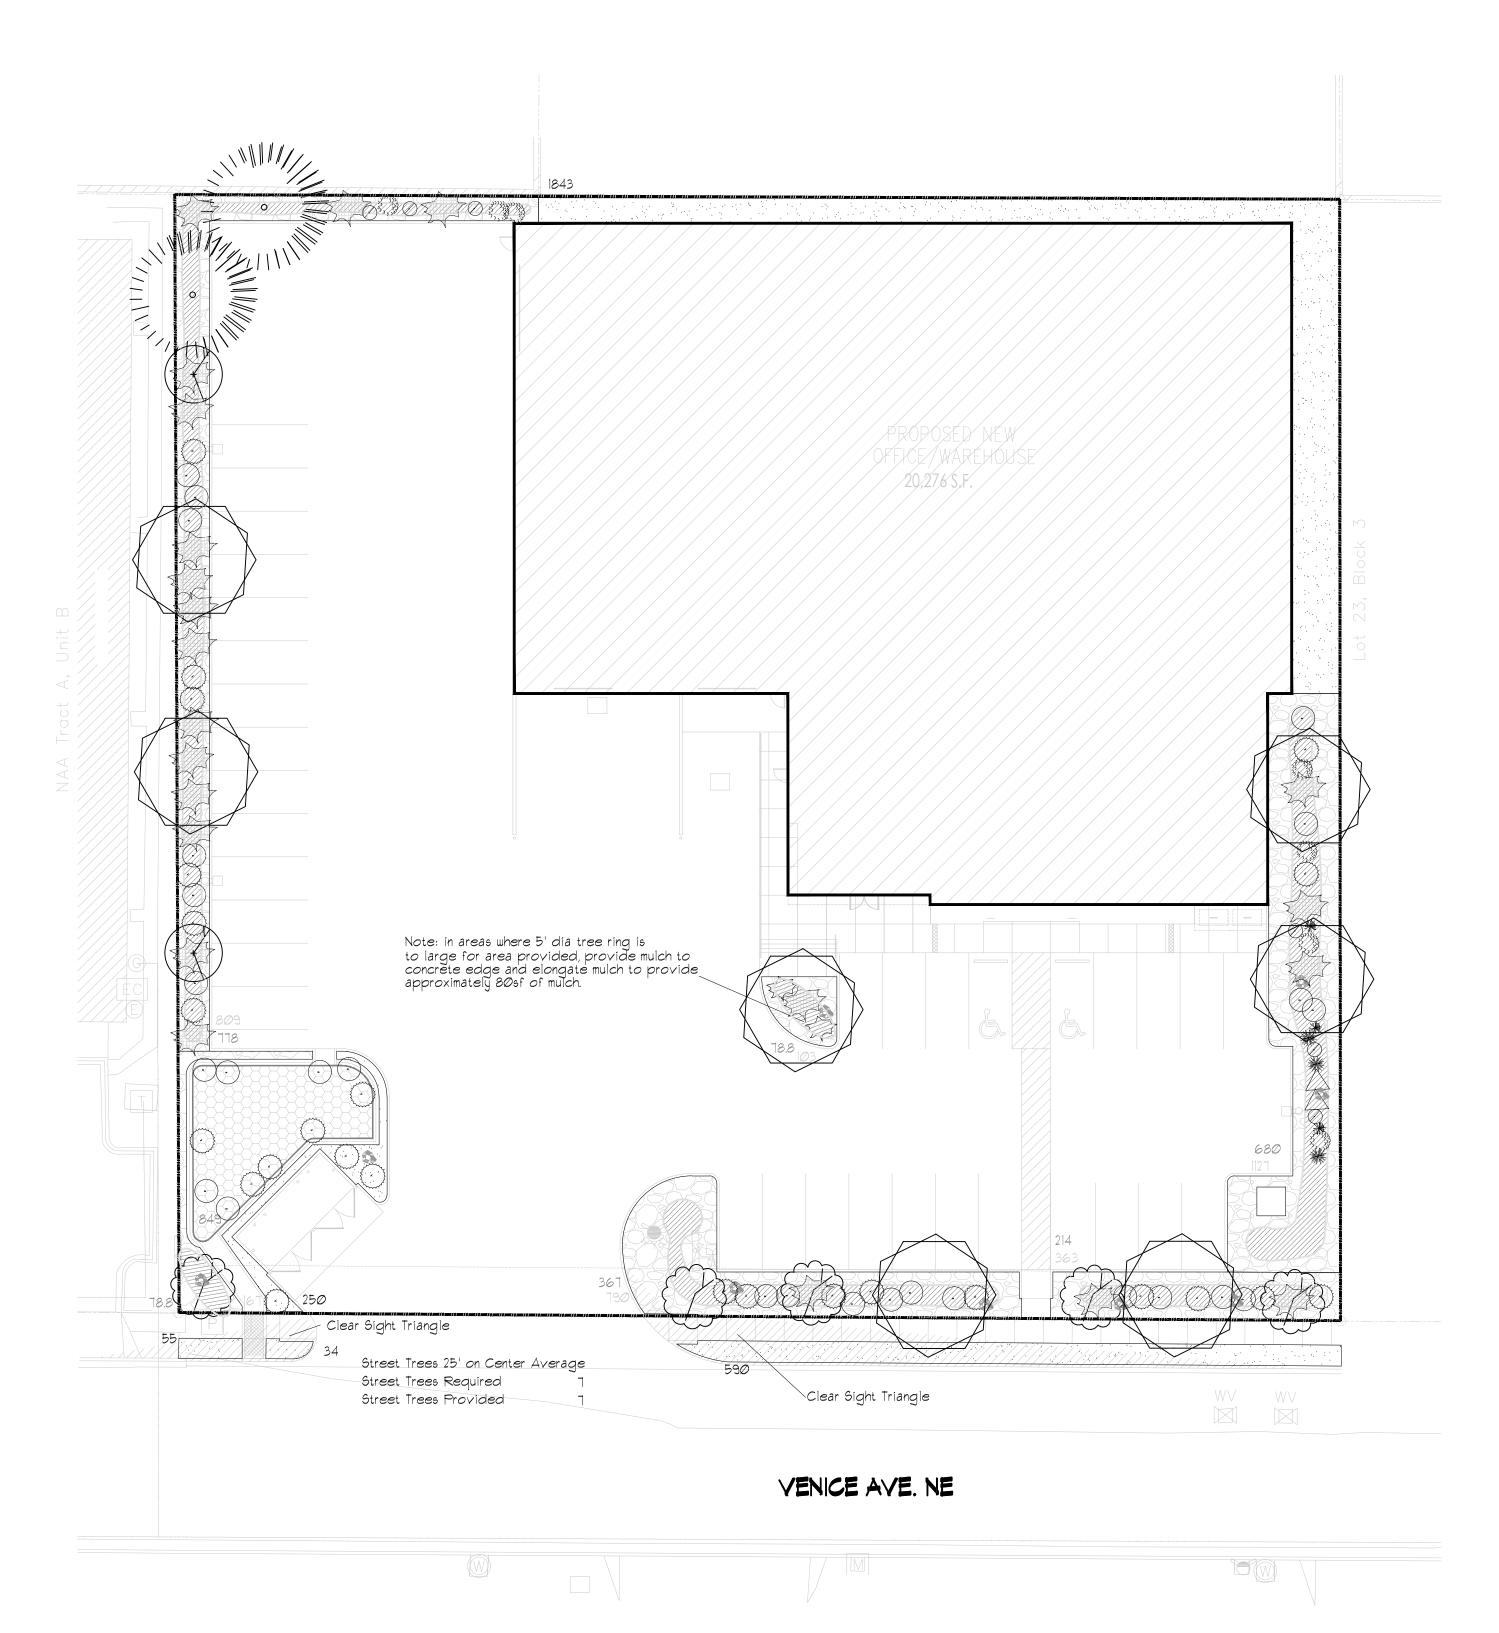

LANDSCAPE LEGEND

QTY SIZE COMMON/BOTANICAL H20 USE Trees Bradford Pear 35xl2 113 226 M Pyrus calleryana 6 - 8' Austrian Pine 35×25 491 982 M Pinus nigra 2" Cal Oklahoma Redbud 15x12 113 565 M 6-8' Cercis reniformis Cercis reniformis 2*0*×25 491 3437 M 2" Cal. Desert Willow 2 6-8' Chilopsis linearis TOTAL TREES TOTAL TREE COVERAGE 5210 SIZE CØMMON/BOTANICAL Shrubs & Groundcovers 5 Gal India Hawthorne 3x4 12.56 87.92 M Raphiolepis indica Apache Plume 4x5 19.625 490.625 L Fallugia paradoxa 5 Gal Chamisa 5×5 19.625 51*0.*25 L Chrhysothamnus nauseosus 5 Gal Blue Mist 2x3 7.065 42.39 L Panicum virgatum 'Rotstrahibuch' 5 Gal Buffalo Juniper 2x8 50.24 1105.28 M Juniperus sabina 'Buffalo' 5 Gal Butterfly Bush 5x7 38.465 76.93 M Buddleia davidii 5 Gal Dwarf Fountain Grass 2x2 3.14 9.42 M Pennisetum alopecuroides 'Hamelin' 5 Gal Karl Foerster Grass 30"x2" 3,14 9,42 M Calamogrostis acutiflora 'Karl Foerster'

TOTAL SHRUBS

70

2772

3359

5 Gal Carpet Roses 2x3 1.065 14.13 L Rosa 'Red Flower Carpet' TOTAL SHRUB COVERAGE 2346.31

2-3cf Boulders Bury 1/3, Moss Rock or Equal

Landscape Gravel / Filter Fabric 3/4" Crushed Grey

Sandy Soil Seed Mix

2-4" Adobe Rose

5' Rad. Organic Mulch, See Note

Oversize Landscape Gravel / Filter Fabric

Natural Edge, no steel edging

Drainage pond

Totsl Landscape Area

LANDSCAPE NOTES:

Landscape maintenance shall be the responsibility of the Property Owner. The Property Owner shall maintain street trees and shrubs in a living, healthy, and attractive condition.

Water management is the sole responsibility of the Property Owner. All landscaping will be in conformance with the City of Albuquerque Zoning Code. In general, water conservative, environmentally sound landscape principles will be followed in design and installation.

Landscape Gravel over Filter Fabric to a minimum depth of 3" shall be placed in all landscape areas, unless otherwise specified.

14-16-5-6(CX5Xe)Organic mulch is required as ground cover under trees within a 5-foot radius around the tree trunk, but not directly against the trunk. In these areas, weed barrier fabric is prohibited.

14-IPond stabilization to follow section 1013.

Organic Mulch is required as ground cover under trees within a 5' radius around the tree trunk, but not directly against the trunk, in these area weed barrier fabric is prohibited.

Note: in areas where 5' dia tree ring is to large for area provided, provide mulch to concrete edge and elongate mulch to provide approximately 80sf, see legend

5-6(CX5Xc) The use of gravel or crusher fines as ground cover is limited to a maximum of 15 percent of any landscaped area, or 50 percent in DT-UC-MS areas.

LANDSCAPE CALCULATIONS

TOTAL LOT AREA (sf)	51569
TOTAL BUILDING AREA (SF)	-20276
TOTAL NET LOT AREA (Sf)	31293
LANDSCAPE REQUIREMENT	× .15
TOTAL LANDSCAPE REQUIRED	4694
TOTAL ON-SITE LANDSCAPE PROVIDED	7648
TOTAL ORGANIC MULCH REQUIRED(25%)	1912
TOTAL ORGANIC MULCH PROVIDED	2197
TOTAL GROUNDCOVER REQUIRED	1912
TOTAL GROUNDCOVER PROVIDED	2346.37
TOTAL LIVE PLANTS REQUIRED	5736
TOTAL LIVE PLANTS PROVIDED	7556.37



ENGINEER SEAL

PROJECT

REVISIONS

June 06, 2023 1"=20'-0" OR AS NOTED

DRAWING NAME

Landscape Plan

SHEET NUMBER



SCALE: 1" = 20'-0"

danny@mitchellassociatesinc.com

505.639.9583

Mitchell Associates, inc



IRRIGATION LEGEND

COMPONENT POINT OF CONNECTION, PROVIDED BY OTHERS SEE CIVIL PLANS IRRIGATION CONTROLLERBACKFLOW PREVENTION DEVICE HUNTER FEBCO (OR EQUAL) HUNTER Sch 40 PVC ⊕ MASTERVALVE ASSEMBLY **===** MAINLINE ◆ ELECTRIC ZONE VALVE HUNTER Class 200 PVC ==== SLEEVES — Drip Line, Tree Netafim Rings Class 200 PVC Drip Line, Shrub Drip Emitter Line
Netafim Spiral Tree Irrigation Polypipe RAINBIRD,

Size Equipment as Required for Flow Rate

Smart Controller

_) | 1/2" RPA / Freeze Protection Required

1 1/2" 1 1/2" 1" Typ. 2 SIZES LARGER THAN PIPE TO BE SLEEVED.

SEE DETAIL

Landscape Architect

September 20, 2023

ENGINEER SEAL

IRRIGATION NOTES

- I. CONTRACTOR SHALL VERIFY ALL DIMENSIONS, ELEVATIONS, EQUIPMENT QUANTITIES, AND UTILITY LOCATIONS PRIOR TO BEGINNING WORK.
- CONTRACTOR SHALL NOTIFY LANDSCAPE ARCHITECT OF ANY DISCREPANCIES IN PLANS OR SPECIFICATIONS PRIOR TO BEGINNING OR CONTINUING WORK.
- 3. THE IRRIGATION CONTRACTOR SHALL MAKE NO SUBSTITUTIONS, DELETIONS, OR ADDITIONS TO THIS PLAN WITHOUT APPROVAL OF THE LANDSCAPE ARCHITECT.
- 4. ALL CONSTRUCTION SHALL CONFORM TO CITY, COUNTY, STATE, AND FEDERAL REQUIREMENTS. IT SHALL BE THE RESPONSIBILITY OF THE IRRIGATION CONTRACTOR TO ENSURE THAT ALL IRRIGATION EQUIPMENT MEETS GOVERNMENT REGULATIONS, CONTRACTOR SHALL ALSO BE RESPONSIBLE FOR OBTAINING ANY NECESSARY PERMITS OR APPROVALS.
- 5. THIS PLAN IS SCHEMATIC AND DUE TO THE NATURE OF CONSTRUCTION SLIGHT FIELD MODIFICATIONS MAY BE NECESSARY TO IMPLEMENT PLAN.
- 6. IRRIGATION SYSTEMS CONNECTED TO POTABLE WATER SUPPLY, SHALL HAVE A BACKFLOW PREVENTER INSTALLED.
- 1. IRRIGATION LATERAL LINES, MAIN LINES AND EQUIPMENT MAY BE SHOWN OUTSIDE PROPERTY LINES ON THIS PLAN, ALL IRRIGATION LINES AND EQUIPMENT ARE TO BE WITHIN AND INSTALLED WITHIN THE LIMITS OF THE PROPERTY LINE.
- 8. ALL IRRIGATION SLEEVING TO BE THE RESPONSIBILITY OF THE IRRIGATION CONTRACTOR. ELECTRICAL WIRES FOR IRRIGATION VALVES AND IRRIGATION LINES ARE TO BE PLACED IN SEPARATE SLEEVES. SEE SLEEVING DETAIL.
- 9. SUPPLY LINE AND WATER METER TO BE PROVIDED BY OWNERBACKFLOW PREVENTOR TO BE PROVIDED BY IRRIGATION CONTRACTOR. IRRIGATION CONTRACTOR'S POINT OF CONNECTION TO BEGIN DOWNSTREAM OF THE IRRIGATION WATER METER.
- 10. 5-6 (CX9Xc) WHERE LANDSCAPING IS INSTALLED IN THE PUBLIC RIGHT-OF-WAY, THE APPLICANT SHALL INSTALL AN ADEQUATE IRRIGATION SYSTEM THAT MEETS THE MINIMUM TECHNICAL REQUIREMENTS IN ARTICLE 6-6 OF ROA 1994 (TREES, YEGETATION AND LANDSCAPING) AND THE DPM, WITH A SEPARATE METER FOR THE LANDSCAPE AREA IN THE PUBLIC RIGHT-OF-WAY, OR A SEPARATE VALVE(S) AT THE PROPERTY LINE ALLOWING ISOLATION OF THE IRRIGATION TO THE LANDSCAPE WITHIN THE PUBLIC RIGHT-OF-WAY.
- 11. 5-6(C)(14)(a) IRRIGATION SYSTEMS SHALL COMPLY WITH SECTION 8 OF THE ABCWLA LEGISLATION AND ORDINANCES (CROSS CONNECTION PREVENTION AND CONTROL ORDINANCE).
- 12. 5-6(CX(14)/b) ALL IRRIGATION SYSTEMS SHALL BE DESIGNED TO MINIMIZE THE USE OF WATER.
- 13. 5-6(CX14Xc) ALL NON-RESIDENTIAL LANDSCAPE IRRIGATION SHALL HAVE AUTOMATIC TIMERS AND/OR PROGRAMMABLE SETTINGS TO AVOID OVERWATERING.
- 14. 5-6(C)(14)(d) THE IRRIGATION SYSTEM SHALL NOT SPRAY OR IRRIGATE IMPERVIOUS SURFACES, INCLUDING SIDEWALKS, DRIVEWAYS, DRIVE AISLES, STREETS, AND PARKING AND LOADING AREAS.

PROJECT

SEASS-RITE

NEW OFFICE/WAREHOUSE

5605 VENICE AVE NE

ALBUQUERQUE, NEW MEXIC

REVISIONS

DATE
June 06, 2023

NORTH SCALE

1"=20'-0"
OR AS NOTED

DRAWING NAME

Irrigation Plan

SHEET NUMBER

L5102




SCALE: 1" = 20'-0"

danny@mitchellassociatesinc.com

505.639.9583

Mitchell Associates, inc

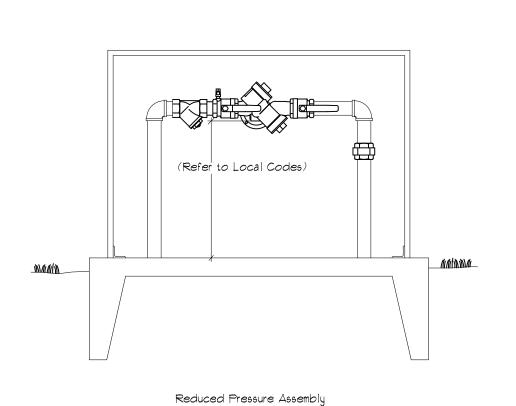

RPA, HOTBOX TYP.

MAIN SUPPLY

TRENCHING DETAIL

BALL DIA. +24"

P.V.C. LATERAL

(UFW) UNDERGROUND FEEDER WIRE

N.T.S.

5' Radius around trunk

TREE PLANTING DETAIL

DO NOT CUT LEADER. PRUNE DAMAGED OR DEAD WOOD AFTER PLANTING AND STAKING. KEEP CROWN SHAPE TYPICAL OF SPECIES.

TRUNK 4 "DEPTH SPECIFIED MULCH AT EDGE OF RING, INSIDE 4" WATERING SAUCER

ADD ROOR STIMULATOR TO NATIVE BACKFILL,

UNDISTURBED PIT BOTTOM FOR ROOTBALL BASE

DO NOT INSTALL TREES WITH PLANTING PIT SIDES GLAZED.

INITIAL STABILIZING BACKFILL 1/3 DEPTH, COMPACTED.

REMOVE ALL TWINE AND WIRE FROM BALL. REMOVE WIRE BASKETS.

NOTE: SCARIFY SIDES OF PLANTING PIT TO LOOSEN SOIL

SET TRUNK PLUMB.

PLANT TREE 2-4" ABOVE SURROUNDING GRADE LEVEL ON UNDISTURBED SOIL

MAIN SUPPLY, LATERAL, AND TUBING/WIRING

DETAIL NOTES:

1. ALL P.Y.C. PIPING SHALL BE SNAKED IN TRENCHES.

2. ALL WIRING TO BE INSTALLED PER LOCAL CODES.

3. ALL WIRING TO BE BUNDLED AND TAPED AT 10' INTERVALS.

5' Radius around trunk


+2" Mulch -

Gravel or Other—

Weed Barrier –

4. ALL MAIN SUPPLY LINES TO BE INSTALLED AS PER MANUFACTURER'S SPECIFICATIONS.
5. PROVIDE PIPE AND WIRE SLEEVING UNDER ALL PAVED SURFACES.
6. WIRE SHALL BE WITHIN SEPARATE 2" ELECTRICAL CHASE.

Outdoor Freeze Protection Installation

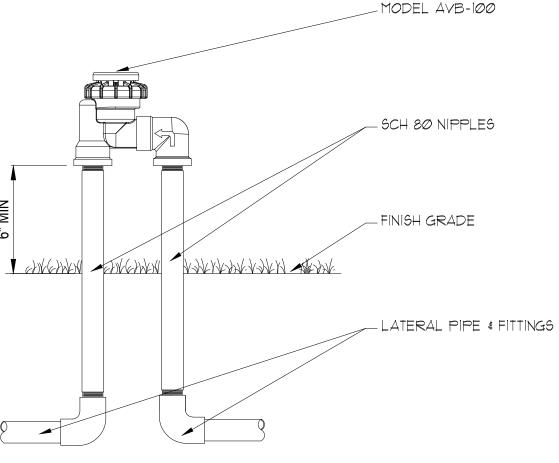


ATMOSPHERIC VACUUM BREAKERS SHOULD BE INSTALLED 6 - 12" ABOVE THE HIGHEST SPRINKLER HEAD WITHIN THE ZONE, OR, ACCORDING TO LOCAL CODE.

- I. INSTALLATION TO BE COMPLETED IN ACCORDANCE WITH MANUFACTURER'S SPECIFICATIONS. 2. DO NOT SCALE DRAWINGS.
- 3. CONTRACTORS NOTE: FOR PRODUCT AND COMPANY INFORMATION VISIT www.CADdetails.com/info REFERENCE NUMBER 901-085n.

VALVES: AVB VALVES

AVB W/ SCH 80 NIPPLE RISERS

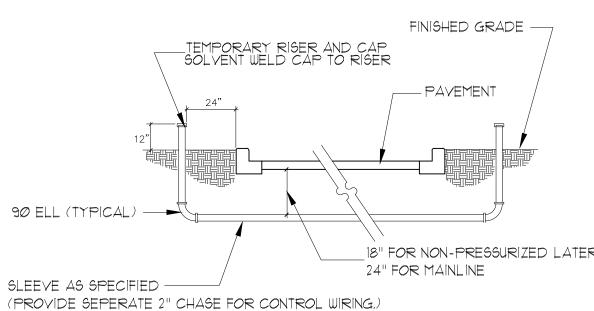

SLEEVE INSTALLATION DETAIL

BALL DIA. +12"

18" FOR NON-PRESSURIZED LATERAL


CONTROLLER DETAIL

FINISHED FLOOR ELEVATION.

ELECTRICAL POWER TO BE SUPPLIED BY OTHERS.

ALL WIRING TO BE INSTALLED PER LOCAL CODES.

SEE ELECTRICAL PLANS FOR LOCATION OF CONTROLLER. CONTROLLER TO BE MOUNTED APPROXIMATELY 5'-0" ABOVE

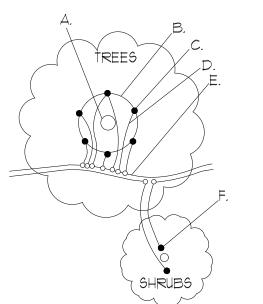

A. TREE TRUNK/ROOT CROWN

B. 24" CIRCLE FROM TRUNK C. EMITTERS

D. 1/8" DISTRIBUTION LINE E. PE DRIPLINE

F. EMITTER PLACED WITHIN 6" OF PLANT STEM NOTE: PLACE EMITTER ABOVE PLANT ON SLOPE

EMITTER PLACEMENT DETAIL

120 VOLT POWER AND GROUND

CONNECTIONS.

GROUNDING WIRE _

GROUNDING ROD -UF DIRECT BURIAL WIRES TO

REMOTE CONTROL VALVES

DETAIL NOTES:

ALLOW SHRUBS TO REACH FULL MATURE SIZE

APPLY SPECIFIED MULCH AT 3" DEPTH

- SET SHRUB AT GRADE GROWN IN CONTAINER OR GROWN IN NURSERY. SET TOP OF JUNIPER'S ROOTBALL TO FINISH GRADE OF MULCH

SCORE CONTAINER ROOTBALLS WITH ENCIRCLING ROOTS

- USE ROOT STIMULATOR WITH NATIVE SOIL BACKFILL ADD SLOW RELEASE FERTILIZER

REMOVE CONTAINER. PLACE ROOTBALL ON

WITH MINIMAL PRUNING

UNDISTURBED SOIL.

NOTE: SCARİFY SIDES OF PLANTING PIT TO LOOSEN SOIL DO NOT INSTALL SHRUBS WITH PLANTING PIT SIDES GLAZED.

SHRUB PLANTING DETAIL

N.T.S.

CONTROLLER AS SPECIFIED WITH KEYED LOCK OR PADLOCK.

_CONTROL WIRE AND COMMON WIRE CONNECTIONS

-FINISHED FLOOR ELEVATION

RISER AND "ELL" (BY GENERAL CONTRACTOR).

Landscape Architect September 20, 2023

ENGINEER SEAL

PROJECT

REVISIONS

June 06, 2023 SCALE NORTH

SHEET NUMBER

danny@mitchellassociatesinc.com

Danny Mitchell

Landscape Architecture

Mitchell Associates, inc

505.639.9583

1"=20'-0" OR AS NOTED DRAWING NAME

Detail Sheet