

Development Facilitation Team SUPPLEMENTAL SUBMITTAL

(Deadline is Friday at noon unless noted on DFT calendar – late submittals will not be accepted unless approved by the DFT)

PROJECT NO. PR-2023-008250 Application No. <u>S1-2023-00376</u>

TO: Planning Department Hydrology Transportation Development ABCWUA Code Enforcement Parks & Rec City Engineer

*(Please attach this sheet with each collated set for each DFT member)

NOTE: ELECTRONIC VERSION is Required. Submittal will not be accepted without.


SUBMITTAL Revised Infrastructure List, New Approved TCL, Updated Master Utility Plan, DESCRIPTION:


Updated Landscape Plan, Miscellaneous, Plan Adjustments


CONTACT NAME: Vince Carrica


08/18/23

TELEPHONE: 505-858-3100 EMAIL: vcarrica@tierrawestllc.com

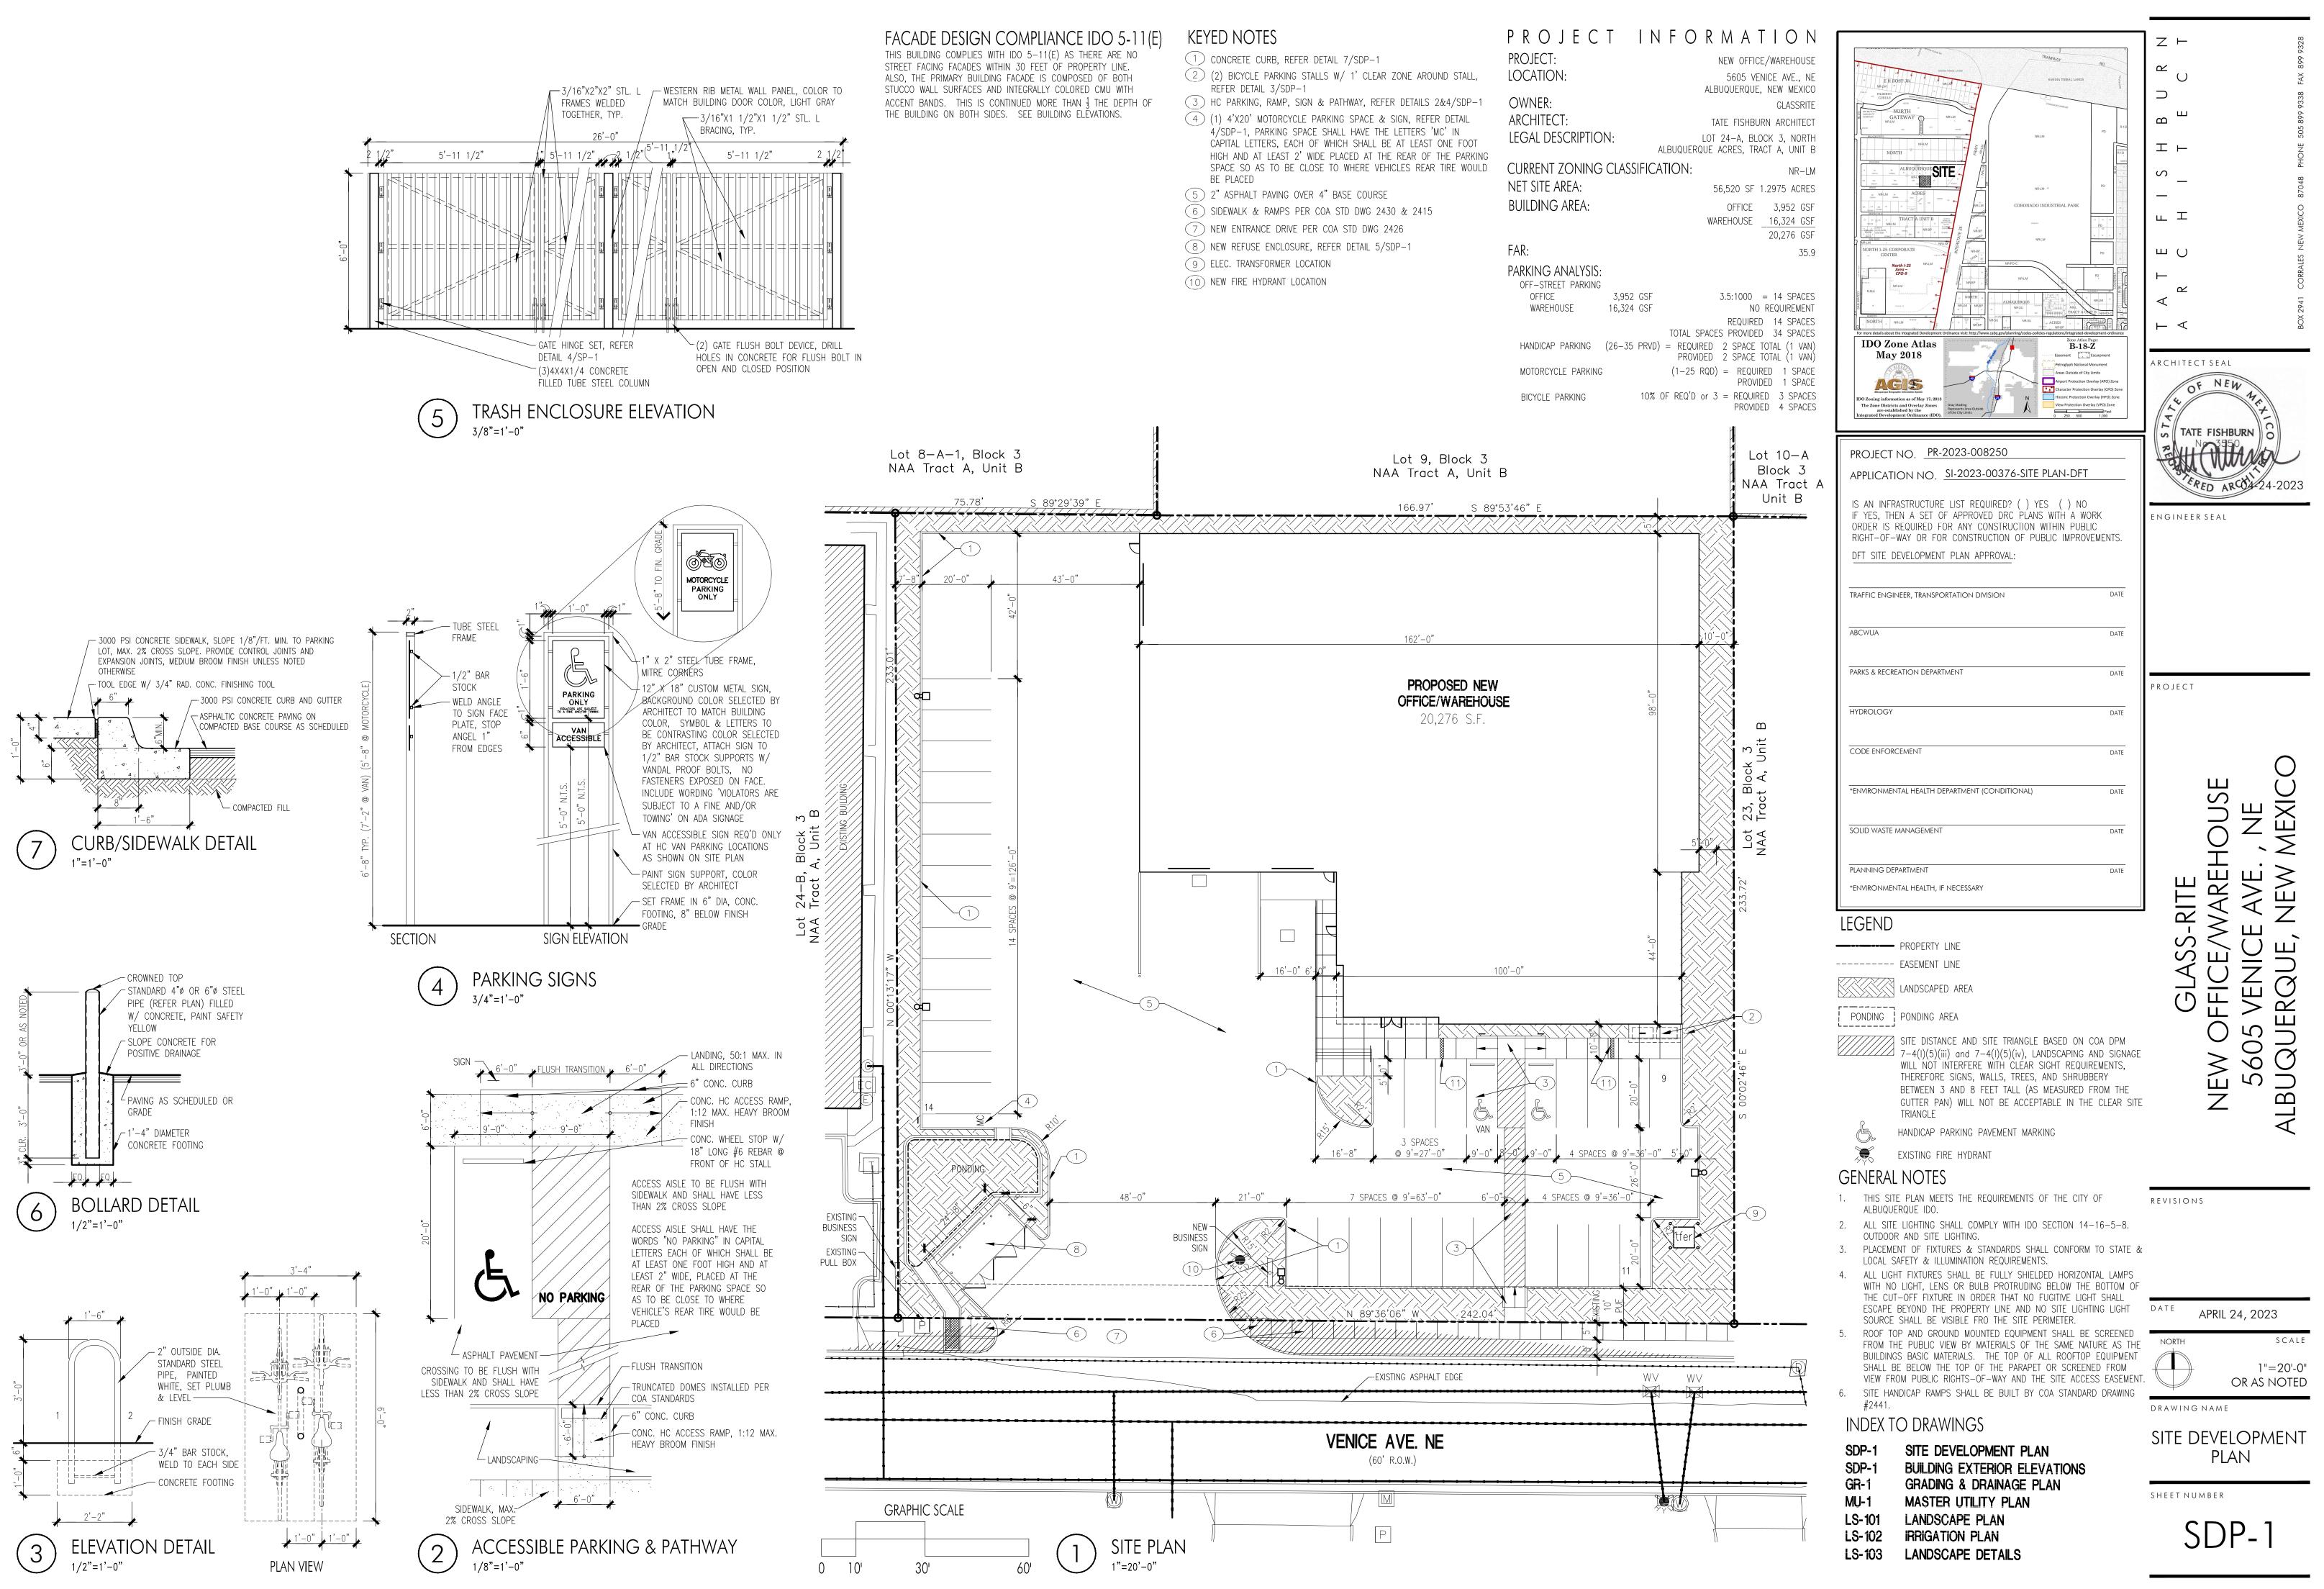

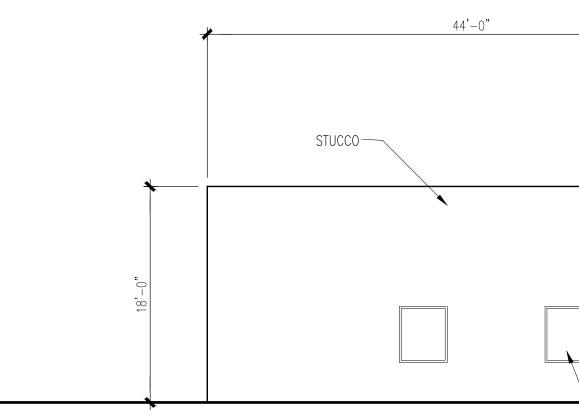

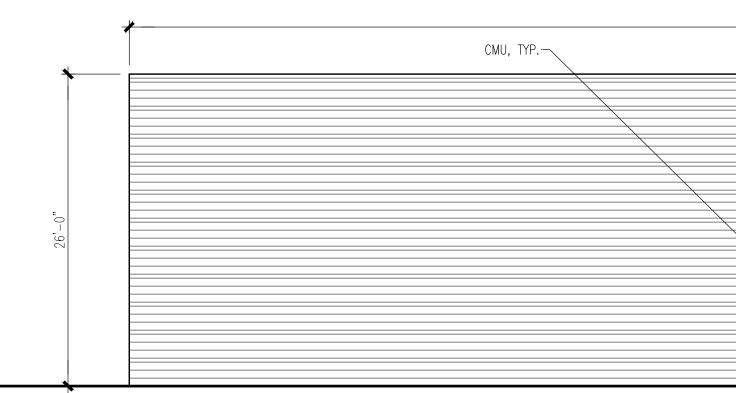

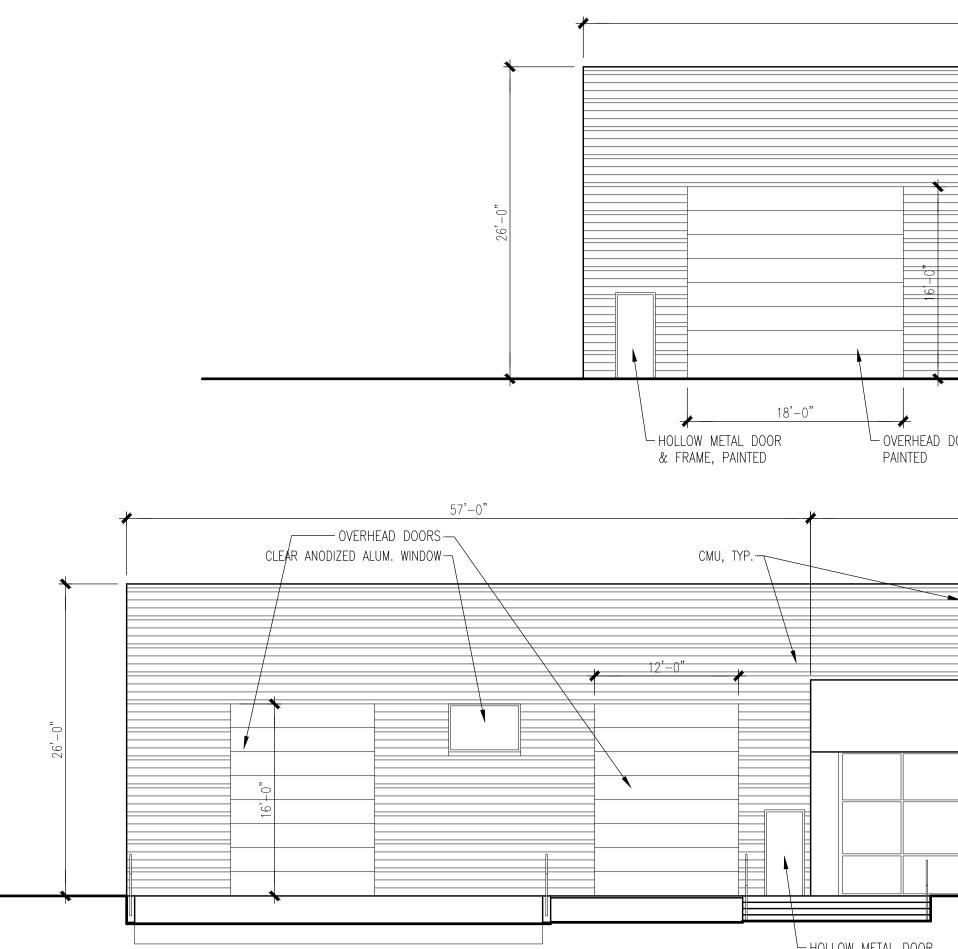

HOLLOW METAL DOOR & FRAME, PAINTED

		98'-0"	8'-0" CMU				
	Signage 5'x30'		/				
18,-0,							
ALUM. STOREFRONT WINDOWS METAL COPING CA	162'-0"			4	EAST [1"=8'-0"	ELEVATIO	
•							
	98'-0"			3	NORT 1"=8'-0" 44'-0"	'H ELEVAT	
	ALUM. STOREFRONT WINDOWS		18,-0,	STUCCO			
DOOR METAL COPING CA	100'-0" AP, TYP			2	WEST 1"=8'-0"	ELEVATIC	
	S ANODIZED STOREFRONT- DWS AND DOORS, GLAZING CHEDULED, TYP.		5 OU 1"=8'-0"	5605	BIKE RACK		

EXTERIOR FINISHES

CMU— COLOR FIELD — INTEGRALLY COLORED LIGHT GRAY CMU— ACCENT BANDS — INTEGRALLY COLORED DARK GRAY
STUCCO– DARK GRAY
ALUMINUM WINDOW FRAMES- CLEAR ANODIZED
WINDOW GLAZING— 1" TINTED INSULATED TINT COLOR— SOLAR GRAY
OVERHEAD & HM DOORS- LIGHT GRAY
NOTE: ALL EXTERIOR FINISHES SHALL HAVE LIGHT REFLECTIVE VALUE RANGING FROM 20% TO 50%.
ALL BUILDING MOUNTED LIGHT FIXTURES SHALL BE FULLY SHIELDED HORIZONTAL LAMPS WITH NO LIGHT, LENS OR BULB PROTRUDING BELOW THE BOTTOM OF THE CUT-OFF FIXTURE IN ORDER THAT NO FUGITIVE LIGHT SHALL ESCAPE BEYOND THE PROPERTY LINE AND NO

AND NO SITE LIGHTING LIGHT SOURCE SHALL BE VISIBLE FRO THE SITE PERIMETER.

ALL BUILDING MOUNTED SIGNAGE TO BE LIGHTED EITHER INTERNALLY OR EXTERNALLY. ANY LIGHTING FOR SIGNAGE SHALL CONFORM TO NIGHT SKIES ACT. SIGNAGE MATERIAL TO BE EITHER RAISED METAL LETTERING OR TRANSLUCENT LEXAN PANELS OF ANY COLOR. NO BOX SIGNAGE ALLOWED. INDIVIDUAL RAISED LETTERS ONLY.

NOTE: SIGNAGE MAY BE AMENDED PROVIDED IT COMPLIES WITH THE CITY OF ALBUQUERQUE IDO.

NOTE: ALL ROOFTOP EQUIPMENT SHALL BE SCREENED FROM VIEW FROM ALL PROPERTY LINES BY PARAPETS.


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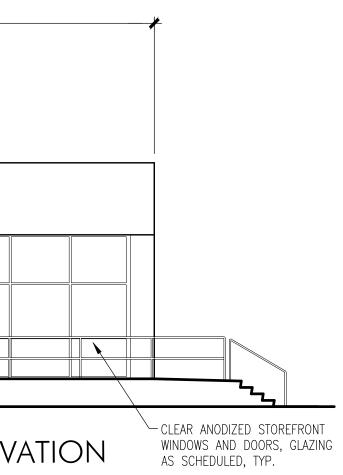
BUILDING SIGNAGE CALCS:

SOUTH ELEVATION- BLDG. AREA4,212 S.F. SIGNAGE- 150 S.F. 150 / 4,212 = 2.8%
EAST ELEVATION- BLDG. AREA3,340 S.F. SIGNAGE- 150 S.F. 150 / 3,340 = 4.5%
WEST ELEVATION- BLDG. AREA3,340 S.F. SIGNAGE- 150 S.F. 150 / 3,340 = 4.5%

GRAPHIC SCALE



LEVATION

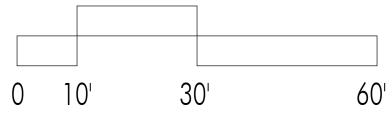

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ENGINEER SEAL

PROJECT



REVISIONS

DATE MARCH 1, 2023

SCALE


1/8" = 1'-0" Or AS NOTED

DRAWING NAME


building elevations

SHEET NUMBER

SDP-2

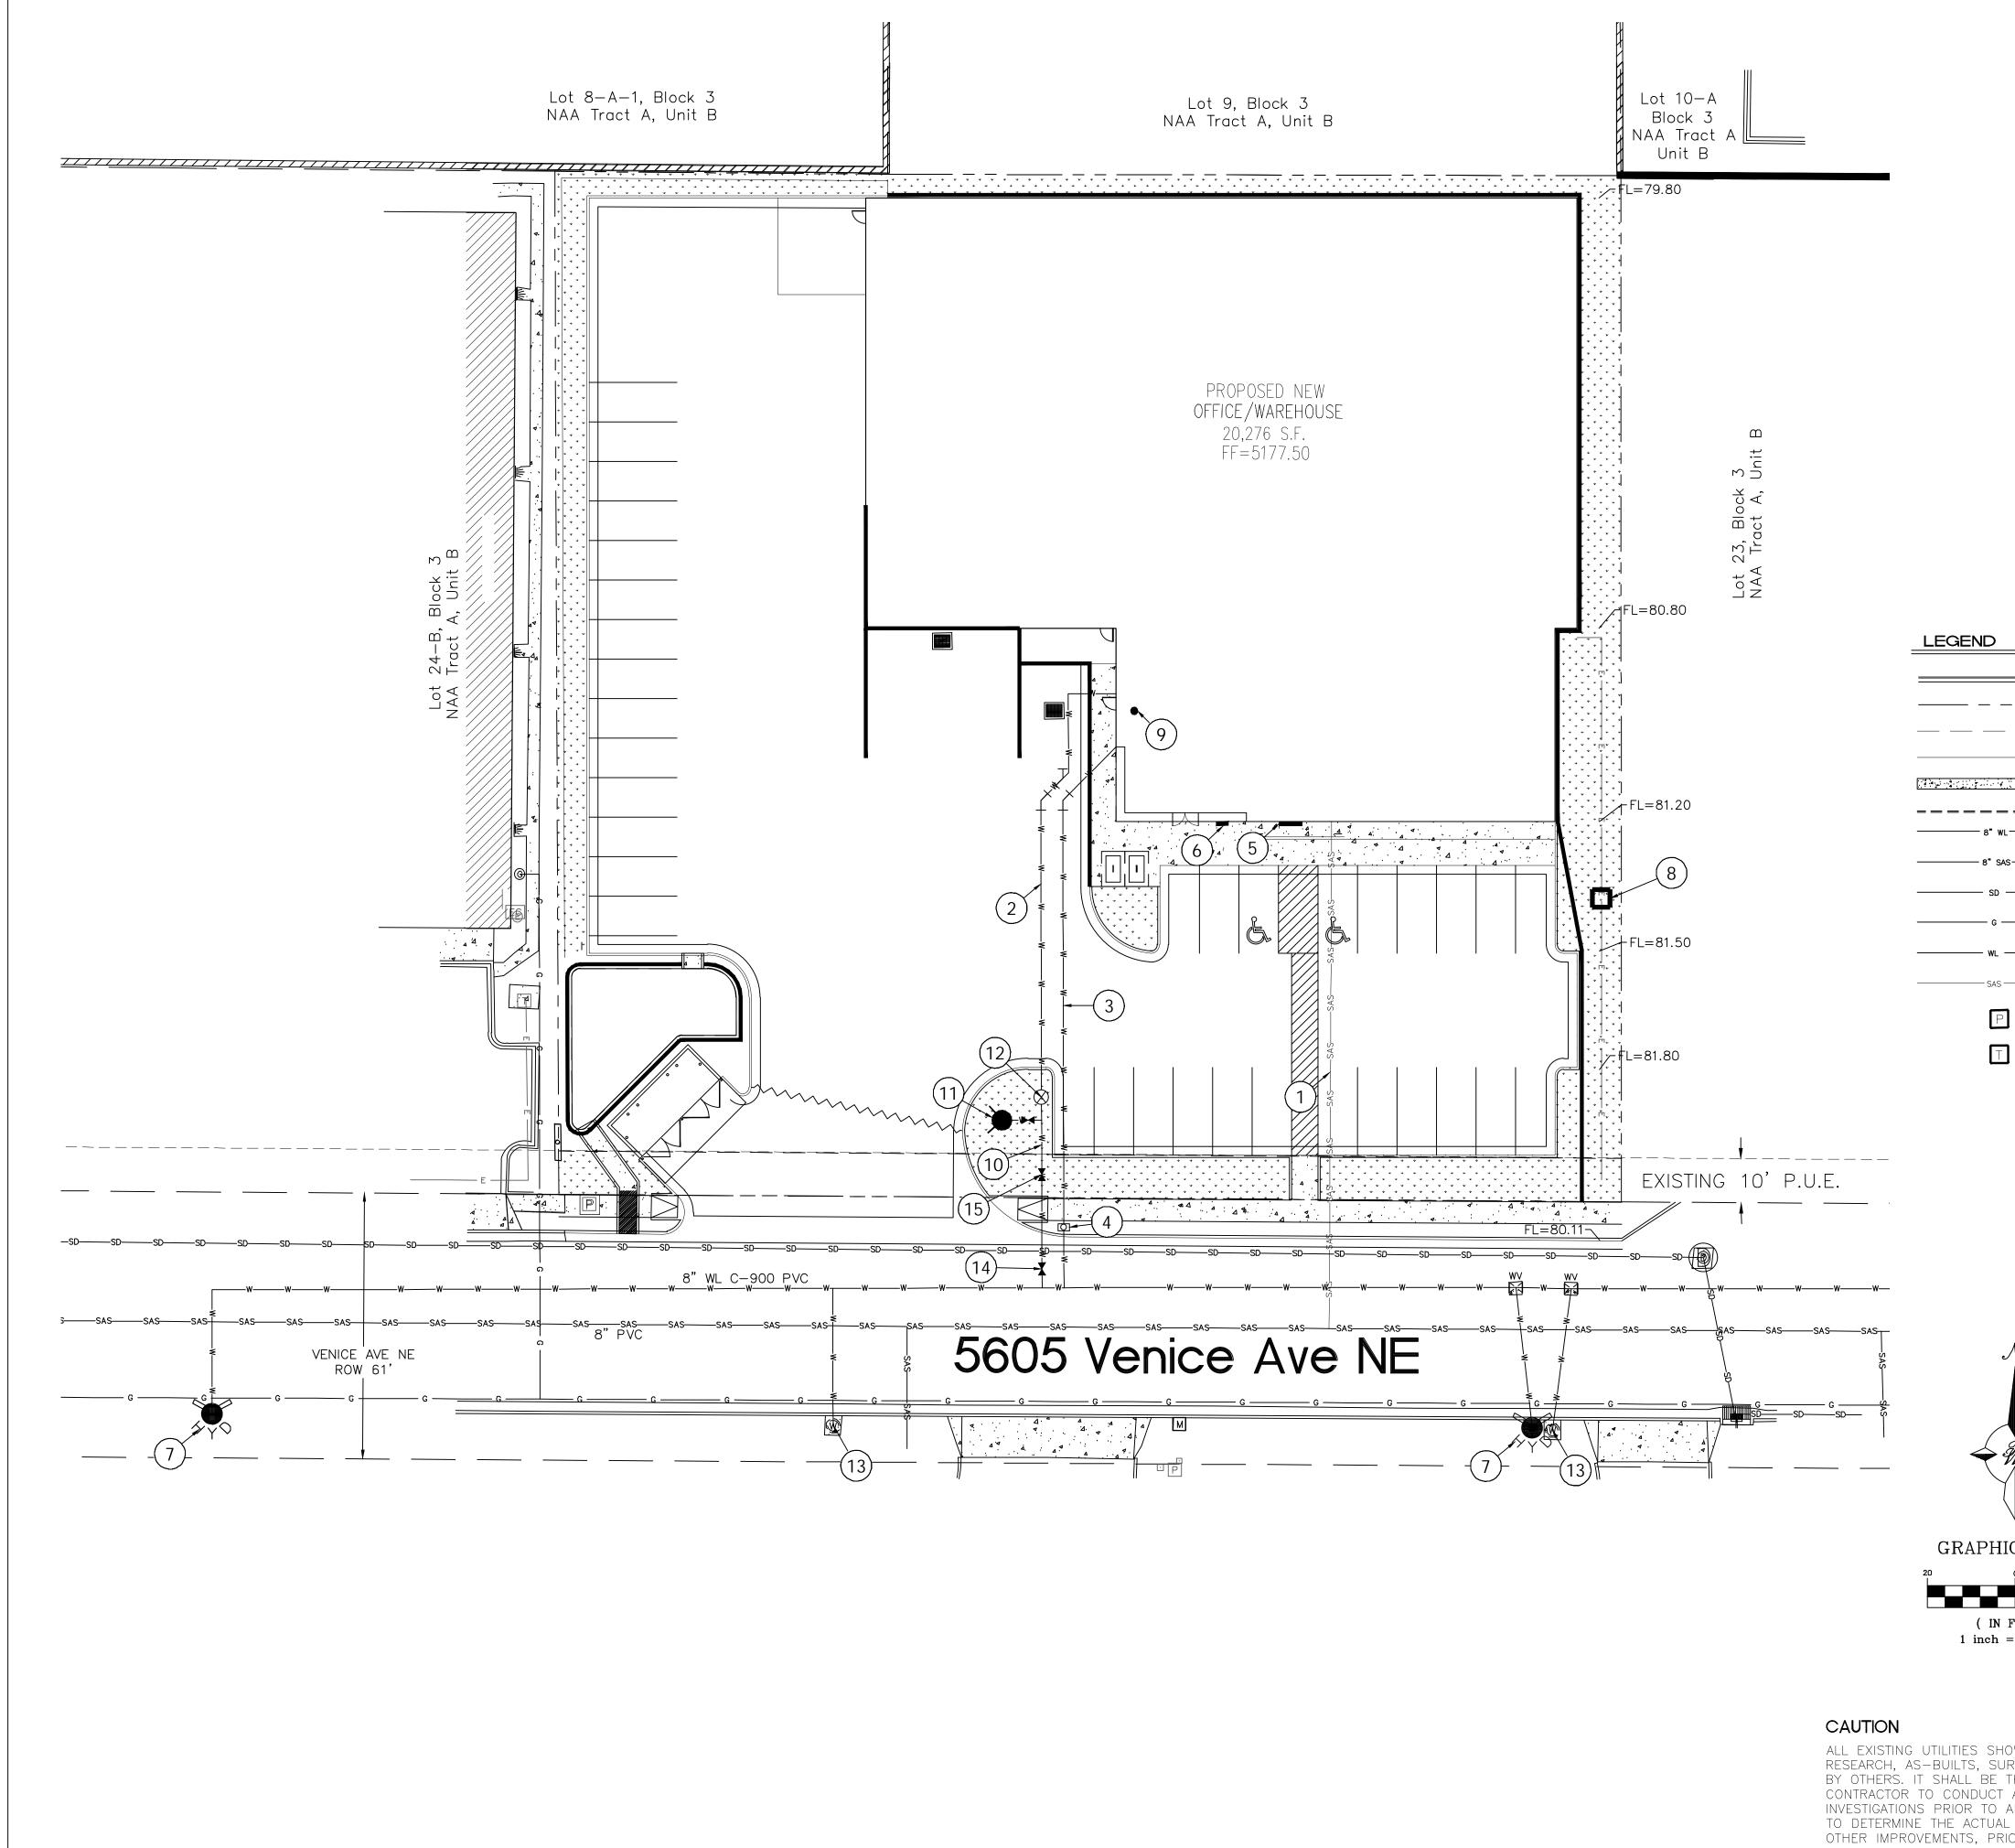


ALL EXISTING UTILITIES SHOWN WERE OBTAINED FROM RESEARCH, AS-BUILTS, SURVEYS OR INFORMATION PROVIDED BY OTHERS. IT SHALL BE THE SOLE RESPONSIBILITY OF THE CONTRACTOR TO CONDUCT ALL NECESSARY FIELD INVESTIGATIONS PRIOR TO AND INCLUDING ANY EXCAVATION, TO DETERMINE THE ACTUAL LOCATION OF UTILITIES AND OTHER IMPROVEMENTS, PRIOR TO STARTING THE WORK. ANY CHANGES FROM THIS PLAN SHALL BE COORDINATED WITH AND APPROVED BY THE ENGINEER.

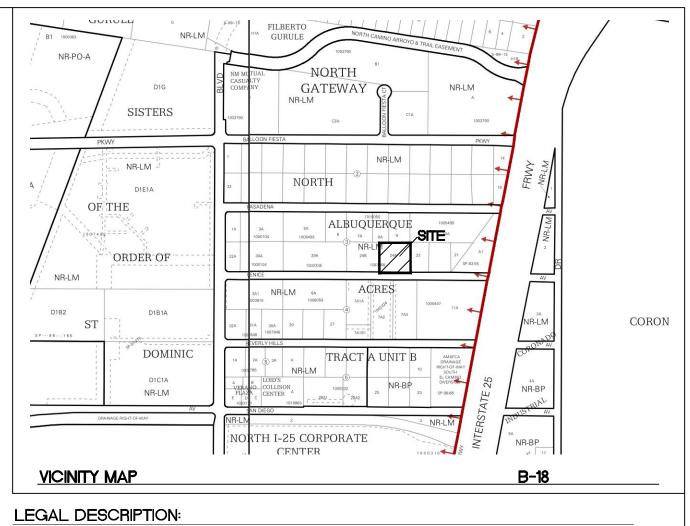

LOT 24-A, BLOCK 3 NORTH ALBUQUERQUE ACRES TRACT A, UNIT B

			KEYED NOTES	
	CURB & GUTTER		1 6" SAS SERVICE	
	BOUNDARY LINE		2 6" FIRELINE	
	EASEMENT		(3) 1 1/2" DOMESTIC WL SERVICE	_
	BUILDING		\sim	
	SIDEWALK EXISTING CURB & GUTTER		$\begin{pmatrix} 4 \end{pmatrix}$ NEW WATER METER, 1 1/2"	
- — — — — — — L — — — —	EXISTING WATERLINE		5 BUILDING ADDRESS	
4S	EXISTING SEWER LINE		6 KNOX BOX	
	EXISTING STORM DRAIN		(7) EXISTING FIRE HYDRANT (PUBL	IC)
	EXISTING GAS LINE		(8) TRANSFORMER	
	PROPOSED WATERLINE		\sim	
	PROPOSED SEWER LINE		(9) FDC	
	EXISTING PULL BOX		10 8" FIRE LINE	
]	NEW TRANSFORMER		$\begin{array}{c} \hline 1 \\ 1 \\ 1 \\ 1 \\ 1 \\ 1 \\ 1 \\ 1 \\ 1 \\ 1$	ATE VALVE
-			(12) PIV	
			(13) EXISTING WATER METERS	
			\sim	
			(14) 8" GATE VALVE (PUBLIC)	
			(15) 8" GATE VALVE (PRIVATE)	
\mathcal{N}				
₩÷				
Λ				
IC SCAI	ΞE			
0 10	20			
FEET) = 20 ft.		ENGINEER'S	GLASS RITE	DRAWN BY
		SEAL	- 5605 VENICE AVE	JL
		TD		<i>DATE</i> 5/24/2023
		NCENT P. CAR	CONCEPTUAL MASTER	, ,

ENGINEER'S SEAL	GLASS RITE 5605 VENICE AVE	<i>DRAWN BY</i> JL
ENT P. CAN	CONCEPTUAL MASTER	<i>DATE</i> 5/24/2023
IN METCOP	UTILITY PLAN	DRAWING
Alter		SHEET #
5/24/2023	5571 MIDWAY PARK PL NE ALBUQUERQUE, NEW MEXICO 87109	MU-1
VINCENT P. CARRICA P.E. #16212	(505) 858-3100 www.tierrawestllc.com	<i>JOB #</i> 2022092

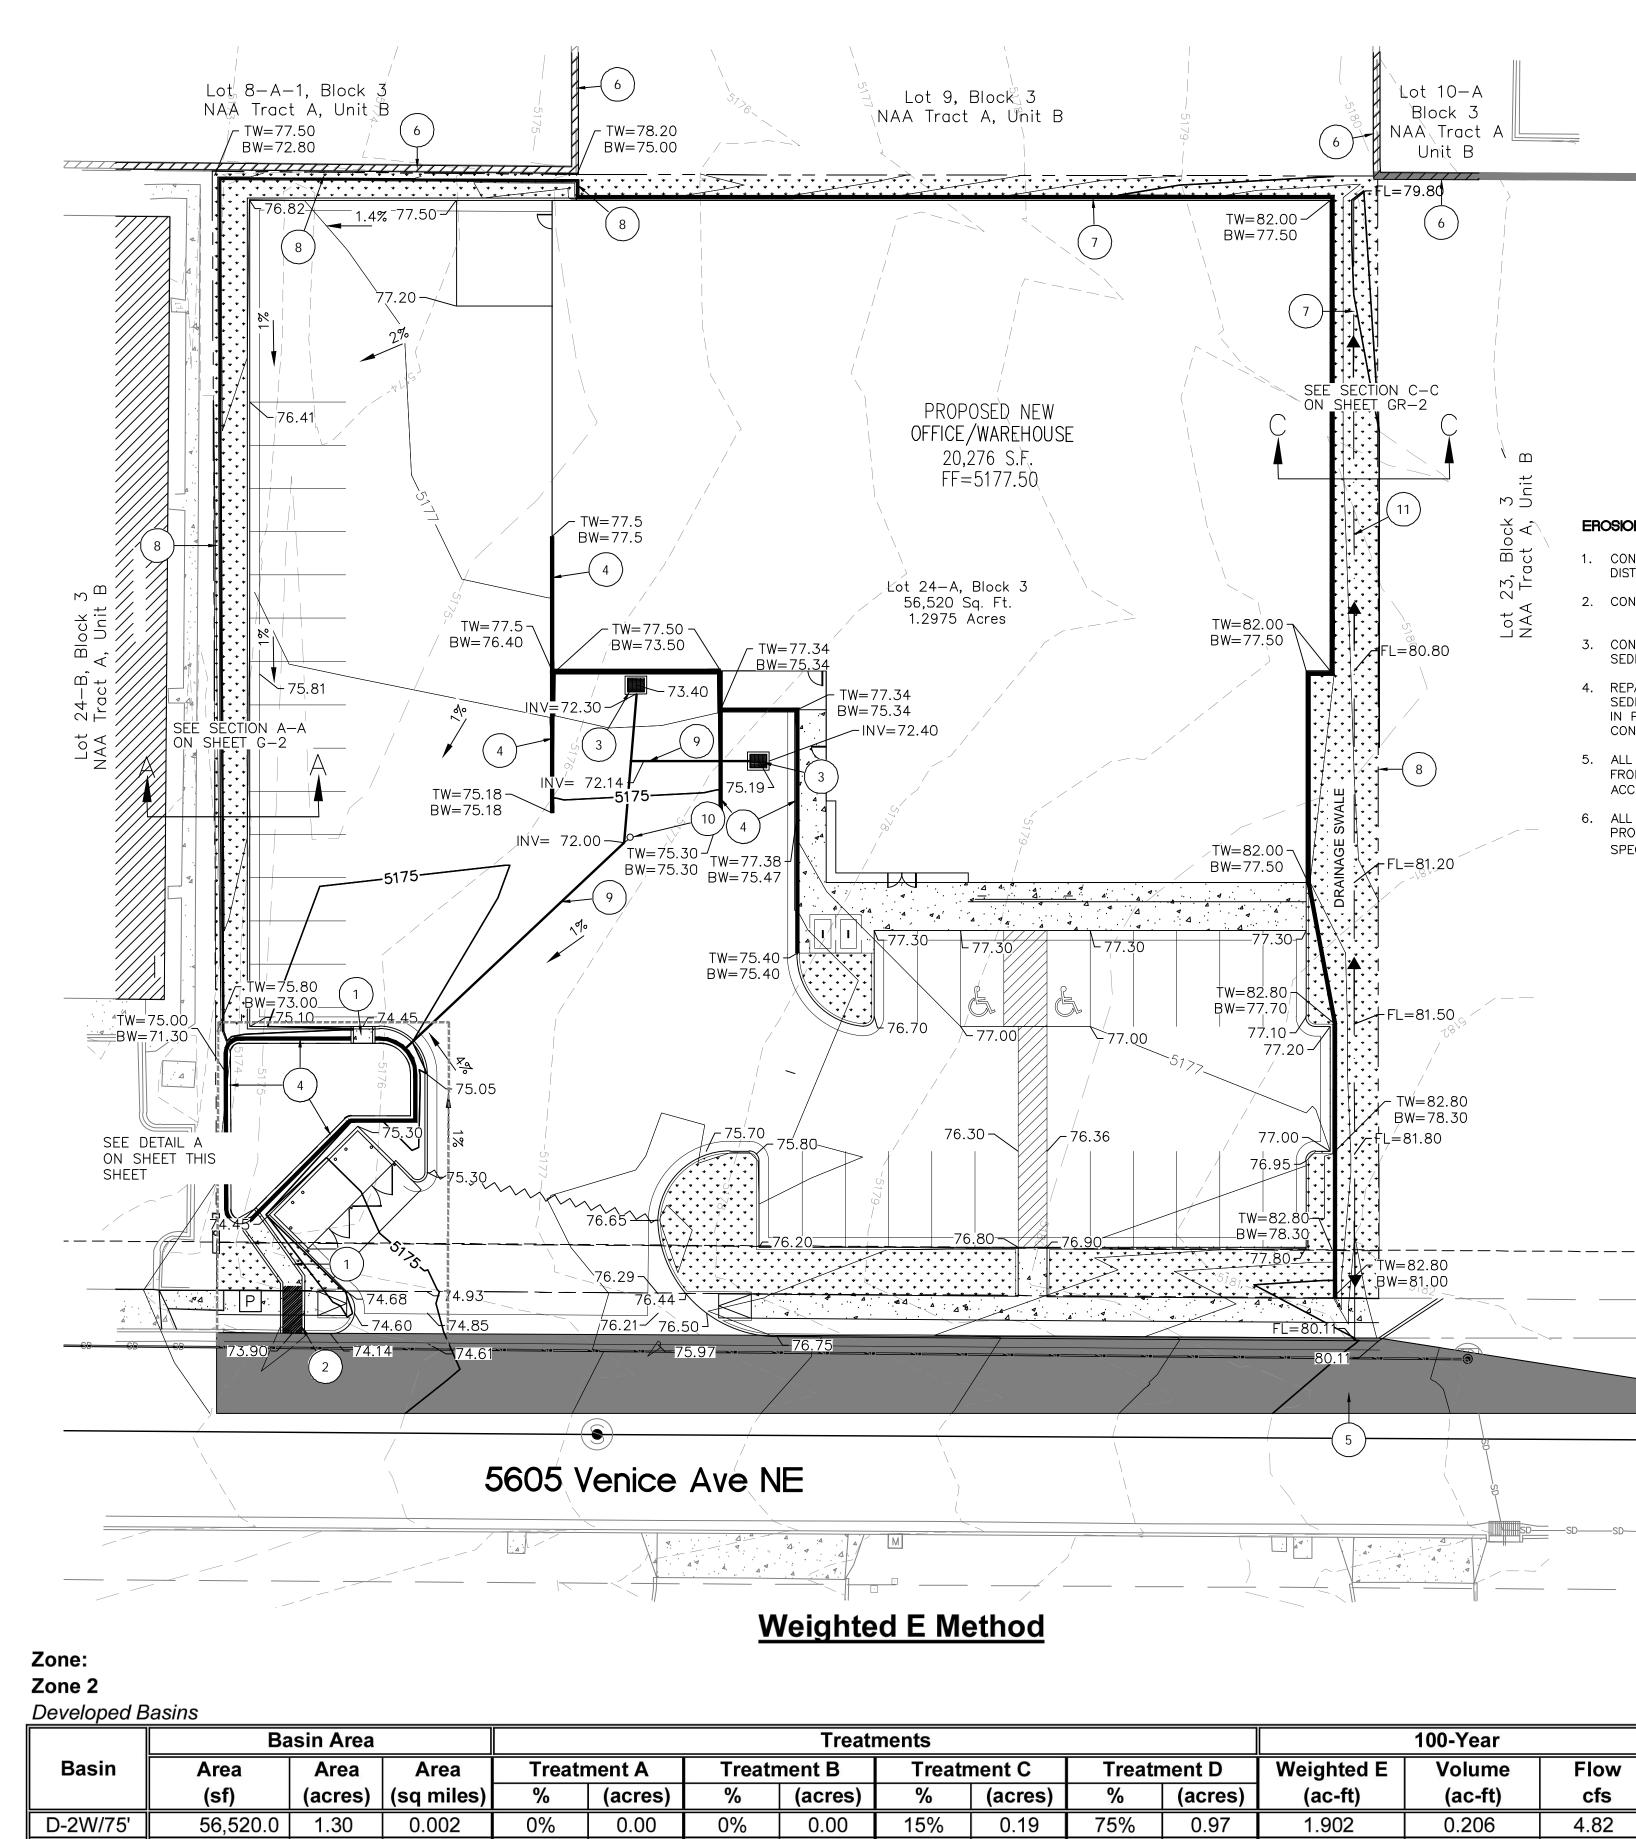

FIRST FLUSH VOLUME REQUIRED = 1554.37 Cu.Ft. < POND VOLUME PROVIDED = 1,700 Cu.Ft.

0.000

NARRATIVE:

Total

56,520.0 | 1.298 | 0.00203

THIS CURRENTLY VACANT SITE IS LOCATED IN THE DRAINGE BASIN ANALYZED WITHIN A MASTER DRAINAGE PLAN (B17D03). PER THE MASTER PLAN IT IS ALLOWED FREE DISCHARGE TO THE EXISTING STREET AND STORM DRAIN IN VENICE AVE., NE.THE PROPOSED ON-SITE IMPERVIOUS AREAS FIRST DRAIN TO A PROPOSED POND WHERE THE FIRST FLUSH VOLUME WILL BE RETAINED ON SITE.

0.00

				100-Year	
nent C Treatment D			Weighted E	Volume	Flow
(acres)	%	(acres)	(ac-ft)	(ac-ft)	cfs
0.19	75%	0.97	1.902	0.206	4.82
0.195		0.973		0.206	4.82

CAUTION

ALL EXISTING UTILITIES SHOWN WERE OBTAINED FROM RESEARCH, AS-BUILTS, SURVEYS OR INFORMATION PROVIDED BY OTHERS. IT SHALL BE THE SOLE RESPONSIBILITY OF THE CONTRACTOR TO CONDUCT ALL NECESSARY FIELD INVESTIGATIONS PRIOR TO AND INCLUDING ANY EXCAVATION, TO DETERMINE THE ACTUAL LOCATION OF UTILITIES AND OTHER IMPROVEMENTS, PRIOR TO STARTING THE WORK. ANY CHANGES FROM THIS PLAN SHALL BE COORDINATED WITH AND APPROVED BY THE ENGINEER.

LEGEND

	CURB & GUTTER
	BOUNDARY LINE
<u> </u>	EASEMENT
	BUILDING
	SIDEWALK
	EXISTING CURB & GUTTER
	EXISTING INDEX CONTOUR
	EXISTING CONTOUR
	PROPOSED INDEX CONTOUR
	PROPOSED CONTOUR
	RETAINING WALL

EROSION CONTROL NOTES:

- 1. CONTRACTOR IS RESPONSIBLE FOR OBTAINING A TOPSOIL DISTURBANCE PERMIT PRIOR TO BEGINNING WORK.
- 2. CONTRACTOR IS RESPONSIBLE FOR MAINTAINING RUN-OFF ON SITE DURING CONSTRUCTION.
- 3. CONTRACTOR IS RESPONSIBLE FOR CLEANING ALL SEDIMENT THAT GETS INTO EXISTING RIGHT-OF-WAY.
- 4. REPAIR OF DAMAGED FACILITIES AND CLEANUP OF SEDIMENT ACCUMULATIONS ON ADJACENT PROPERTIES AND IN PUBLIC FACILITIES IS THE RESPONSIBILITY OF THE CONTRACTOR.
- 5. ALL EXPOSED EARTH SURFACES MUST BE PROTECTED FROM WIND AND WATER EROSION PRIOR TO FINAL (CITY) ACCEPTANCE OF ANY PROJECT.
- 6. ALL SLOPES NOT STABILIZED AT THE END OF THE PROJECT SHALL BE STABILIZED IN ACCORDANCE WITH COA SPECS OR ₹ GRAVEL

KEYED NOTES


- 1 4' CONCRETE RUNDOWN, SEE DETAIL THIS SHEET
- 2 4' SIDEWALK CULVERT PER COA STD DWG 2236
- (3) AREA DRAIN
- (4) RETAINING WALL WITH RAILING
- 5 NEW ASPHALT PAVEMENT (MATCH GRADES AT EXISTING PAVEMENT EDGE)
- (6) EXISTING RETAINING/PERIMETER WALL
- (7) EXTENDED STEM WALL/RETAINING WALL
- (8) RETAINING WALL WITHOUT RAILING
- (9) 6" PVC SD
- (10) SD CLEAN OUT
- (11) 2' SWALE
- \sim 10"X10"X10" WOVEN WIRE FABRIC CONCRETE RUNDOWN NOTE: CHANNEL CAPACITY= 46 CFS AT 2% SLOPE NTS





NOTICE TO CONTRACTORS

- RIGHT-OF-WAY.

- EXIST, THE CONTRACTOR SHALL
- TRAFFIC/STREET USE.
- SERVED.
- 24-HOUR BASIS.

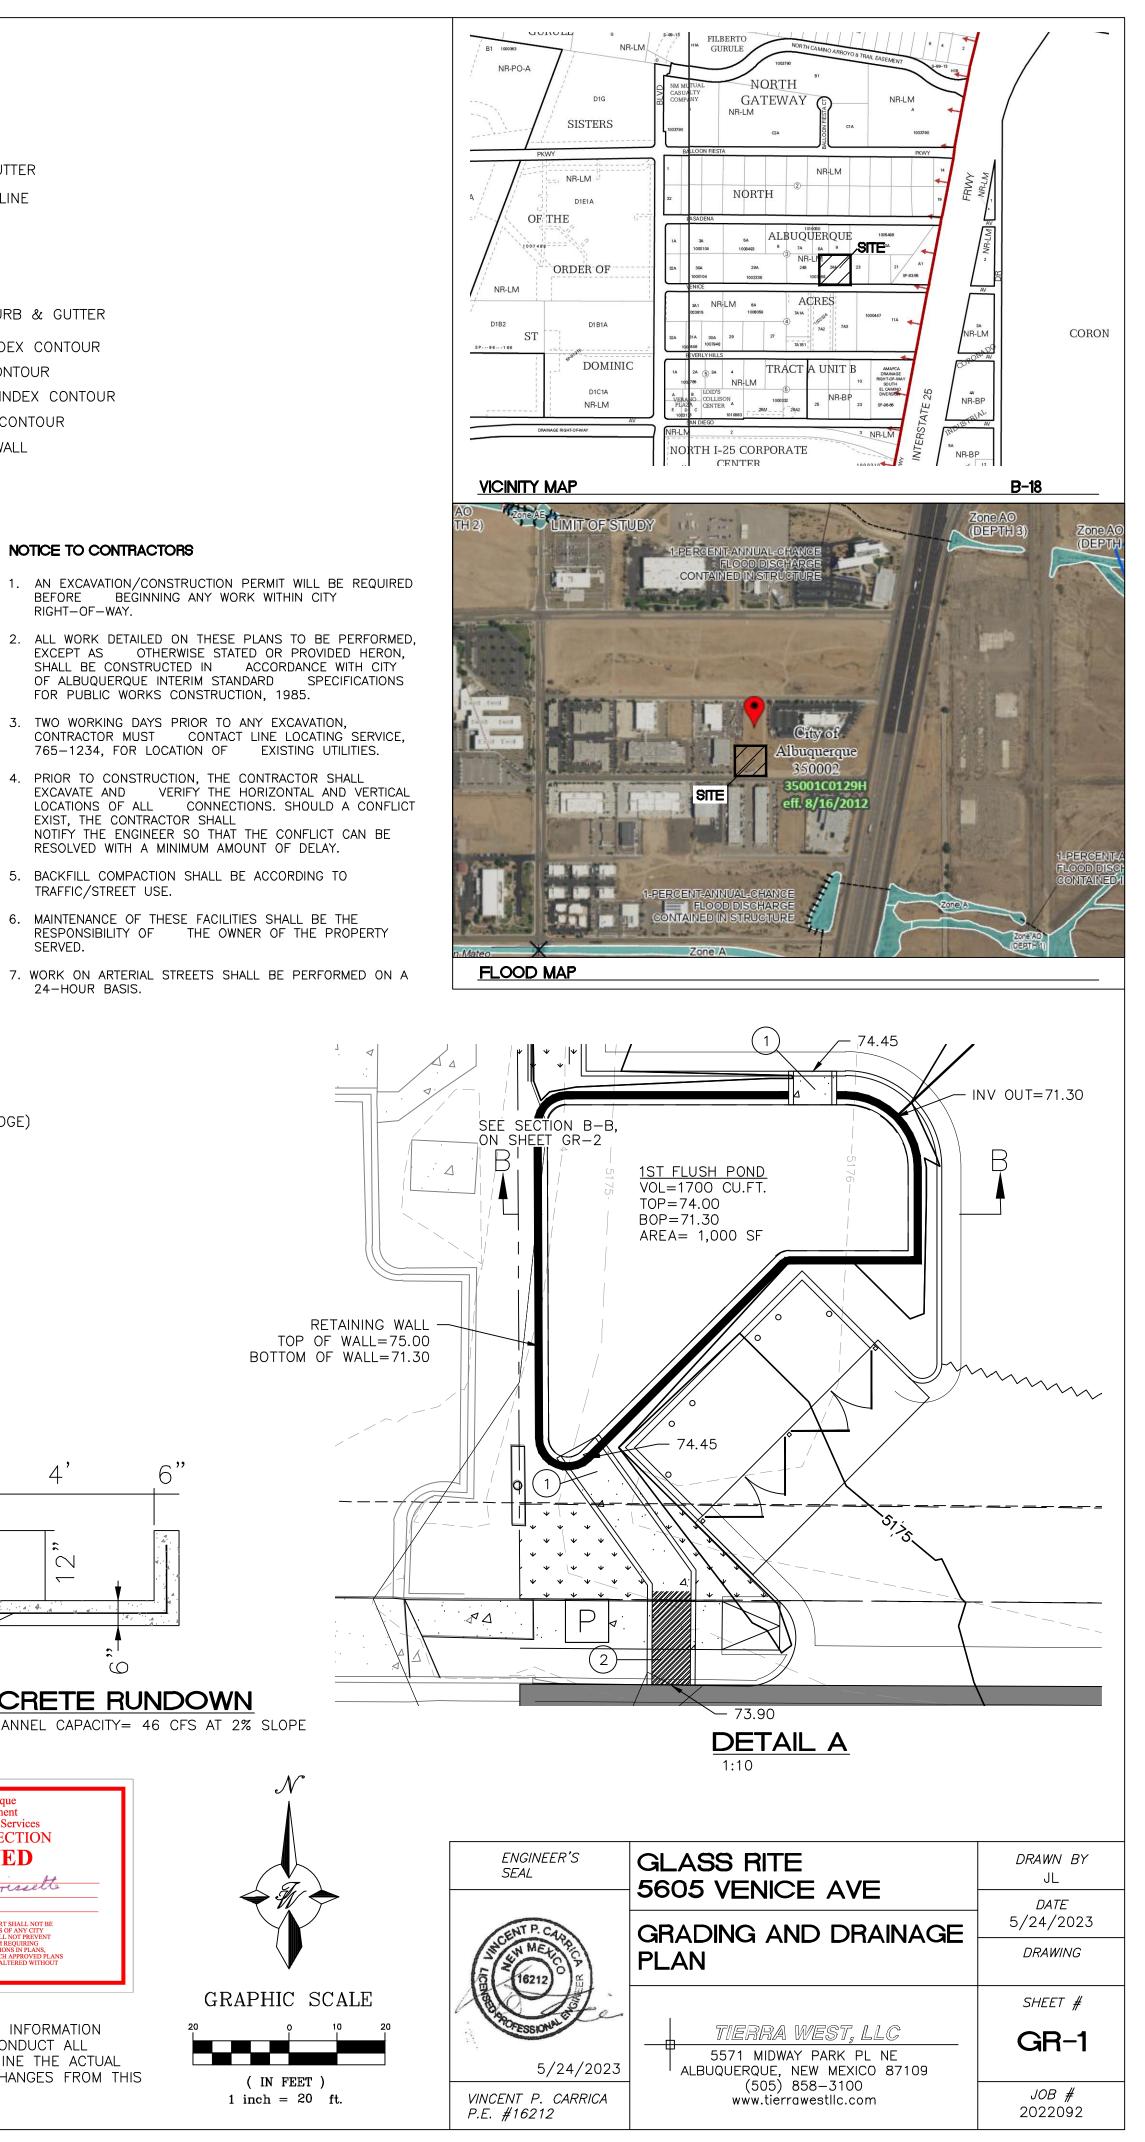

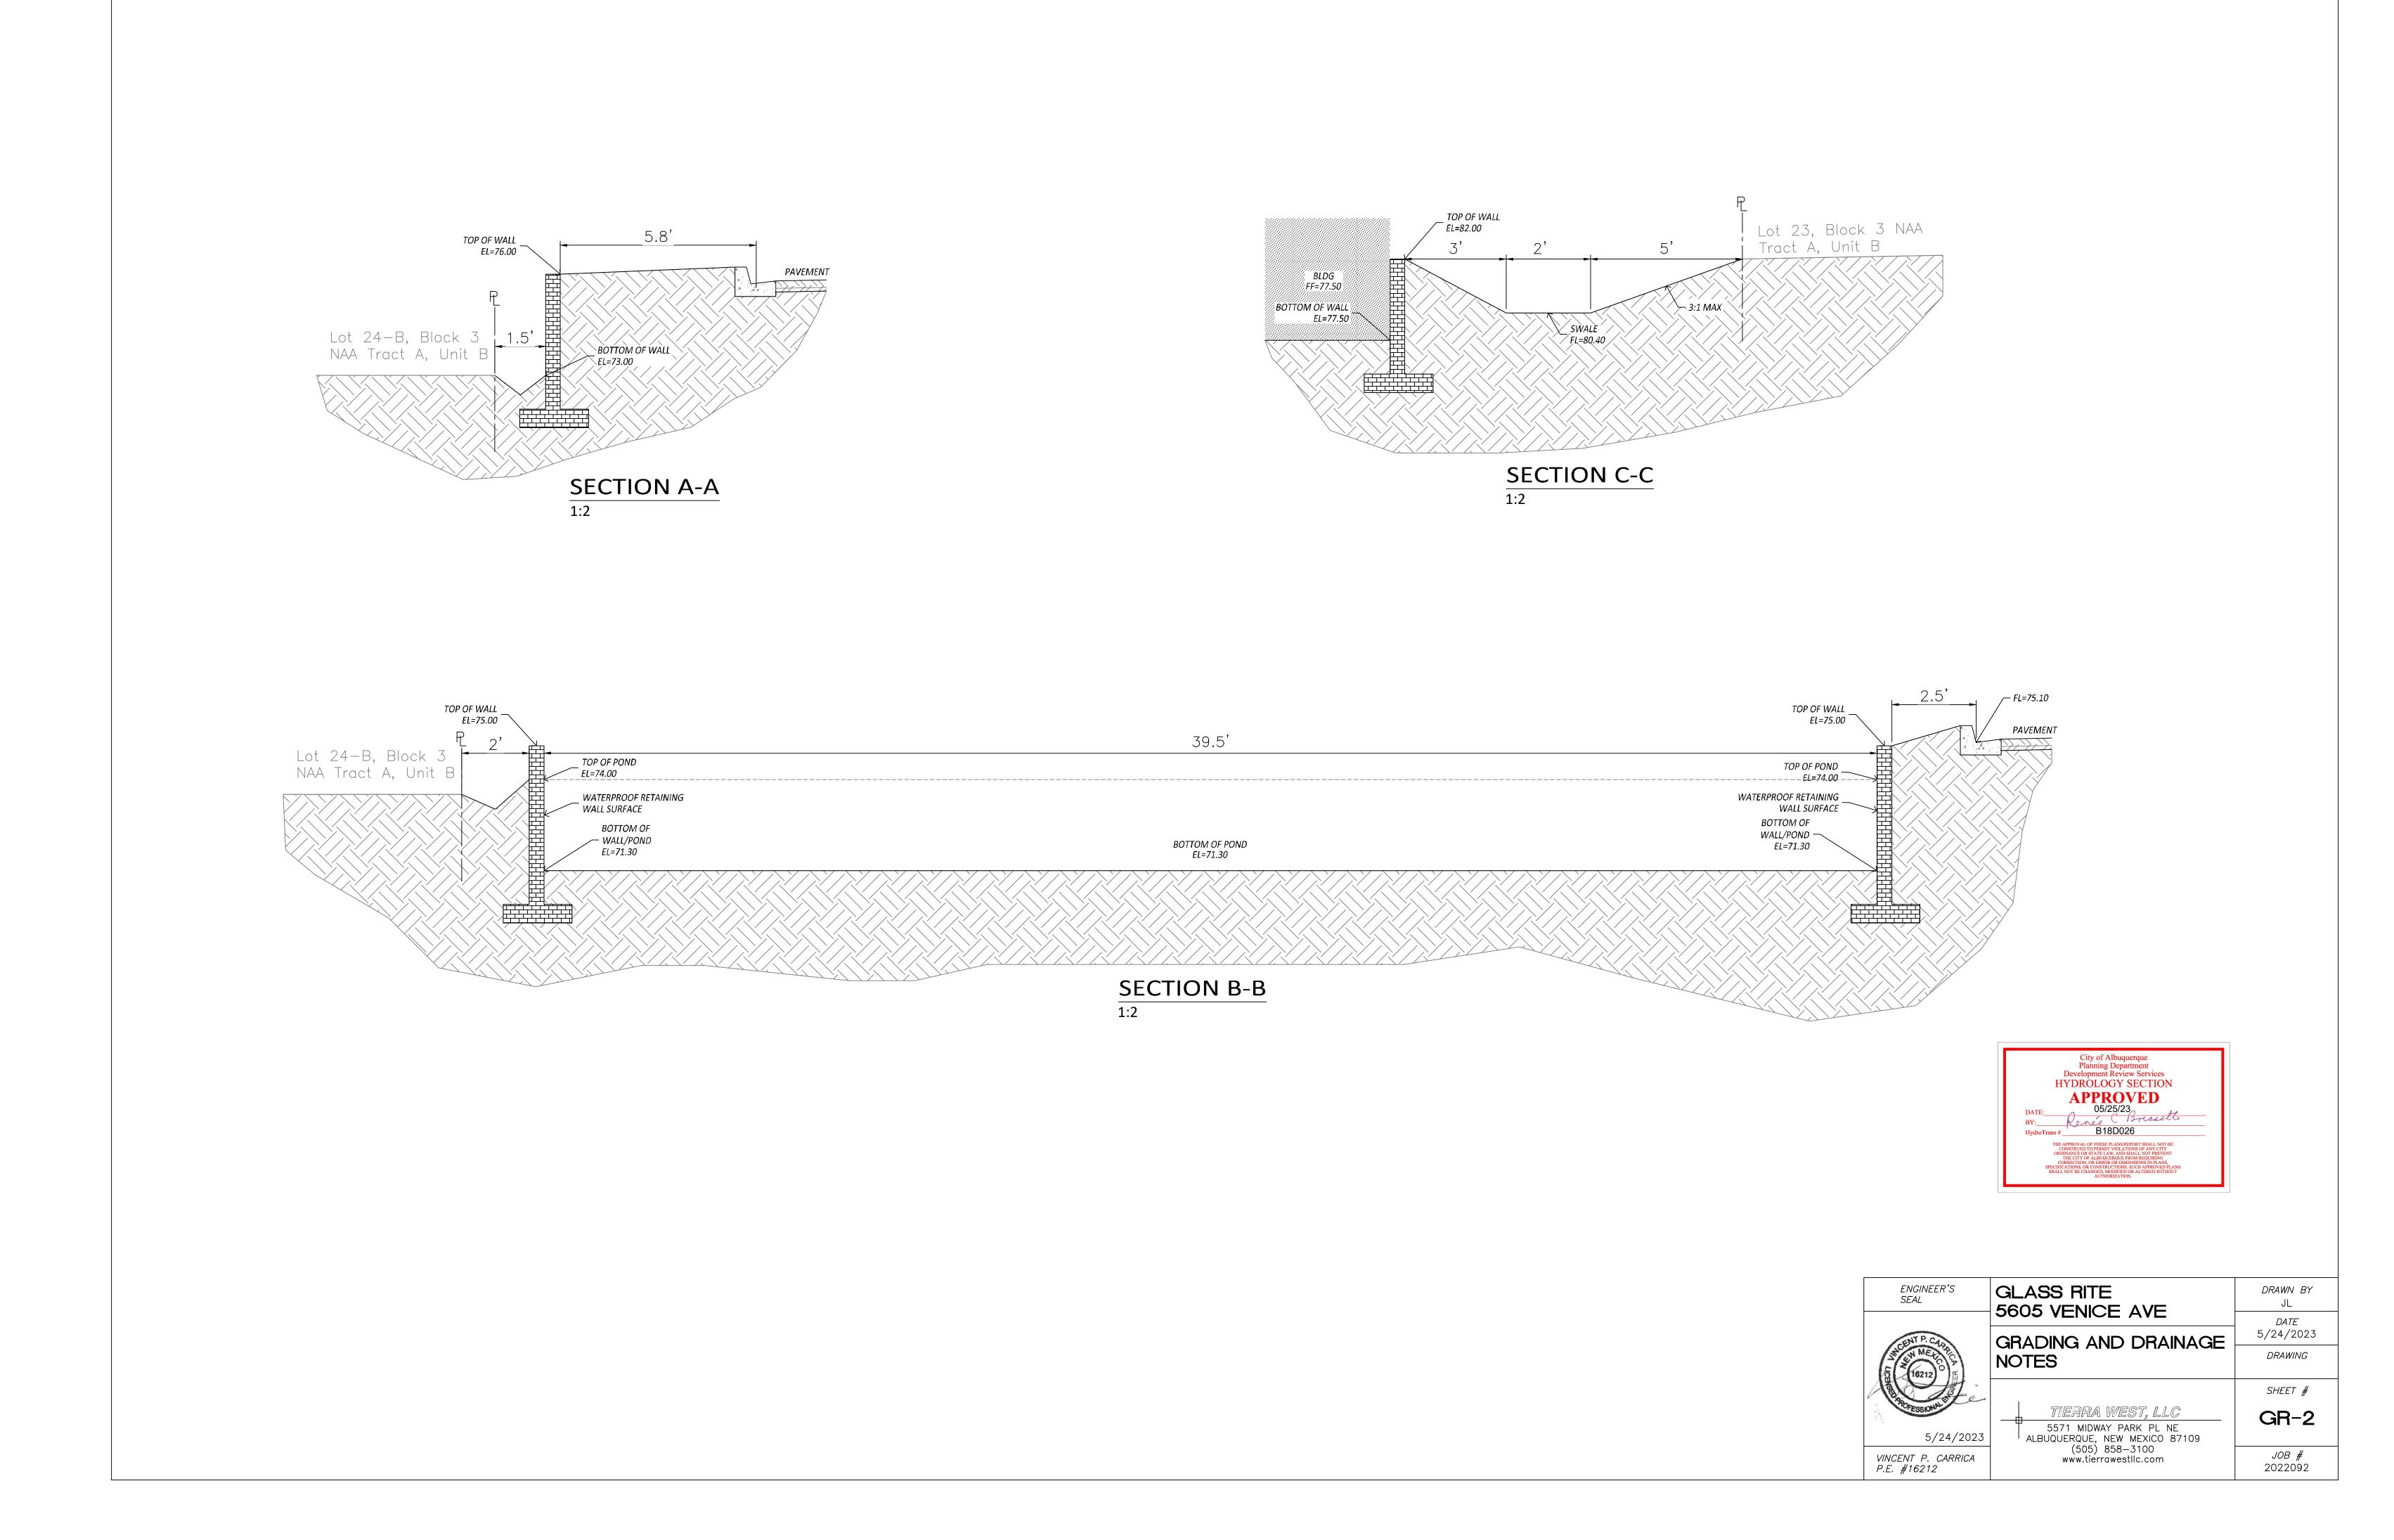


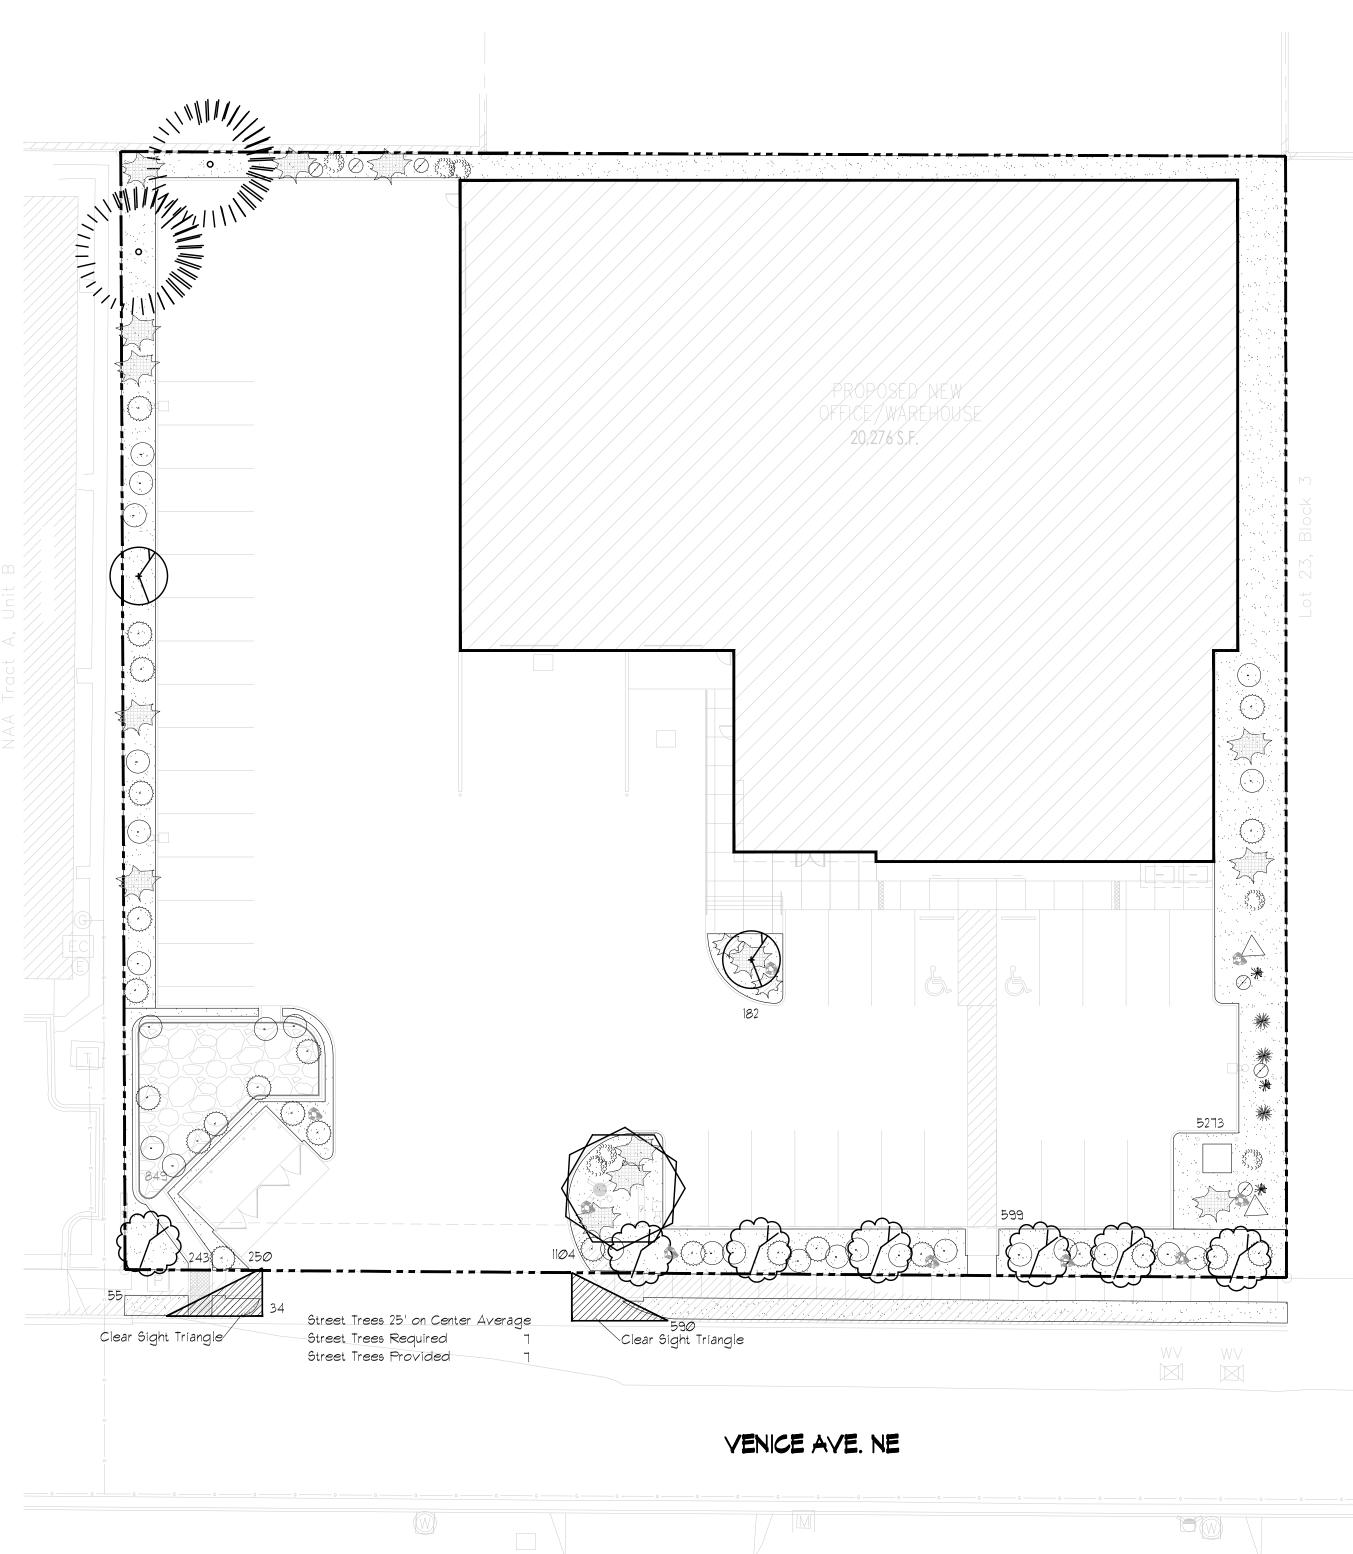

6 - 8' Bradford Pear Pyrus callerya in the second se 6 - 8' Austrian Pine Pinus nigra 2" Cal Oklahoma Redbud 6-8' Cercis renifor 2" Cal. Desert Willow 6-8' Chilopsis linea TOTAL TREES TOTAL TREE COVERAGE 12 QTY SIZE COMMON/BOTANICA Shrubs & Groundcov 3,333 5 Gal India Hawthorne Raphiolepis inc $\langle \cdot \rangle$ 5 Gal Apache Plume 25 Fallugia parad (\cdot) 5 Gal Chamisa 26 Chrhysothamr 5 Gal 🛛 Blue Mist Panicum virgatum 5 Gal Buffalo Juniper Juniperus' sabi \bigtriangleup 5 Gal Butterfly Bush Buddleia davidi 5 Gal Dwarf Fountain Gras Pennisetum al 5 Gal Karl Foerster Grass Calamogrostis \$75 5 Gal Carpet Roses TOTAL SHRUB COVERAGE TOTAL SHRUBS 88 2-3cf Boulders Bury 1/3, Moss Rock or Equal 70 9

QTY

Trees

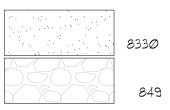

9179

LANDSCAPE NOTES:

Landscape maintenance shall be the responsibility of the Property Owner. The Property Owner shall maintain street trees and shrubs in a living, healthy, and attractive condition.

Totsl Landscape Area

Water management is the sole responsibility of the Property Owner. All landscaping will be in conformance with the City of Albuquerque Zoning Code. In general, water conservative, environmentally sound landscape principles will be followed in design and installation.

Landscape Gravel over Filter Fabric to a minimum depth of 3" shall be placed in all landscape areas, unless otherwise specified.

14-16-5-6(CX5Xe)Organic mulch is required as ground cover under trees within a 5-foot radius around the tree trunk, but not directly against the trunk. In these areas, weed barrier fabric is prohibited.

14-1Pond stabilization to follow section 1013.

LANDSCAPE CALCULATIONS


TOTAL LOT AREA (sf) TOTAL BUILDING AREA (sf) TOTAL NET LOT AREA (sf) LANDSCAPE REQUIREMENT TOTAL LANDSCAPE REQUIRED

TOTAL ON-SITE LANDSCAPE PROVIDED TOTAL GROUNDCOVER REQUIRED TOTAL GROUNDCOVER PROVIDED TOTAL LIVE PLANTS REQUIRED TOTAL LIVE PLANTS PROVIDED

	SIZE	COMMON/BOTANICAL				H2O USE
Tre	es					
	6 - 8'	<mark>Bradford Pear</mark> Pyrus calleryana	35x12	625	1250	Μ
	6 - 8'	Austrian Pine Pinus nigra	35x25	625	1250	Μ
	2" Cal 6-8'	Oklahoma Redbud Cercis reniformis		144	1008	Μ
	2" Cal. 6-8'	Desert Willow Chilopsis linearis	2Øx25	625	625	Μ
	TOTAL T	REE COVERAGE			4133	
	SIZE	CØMMON/BOTANICAL				H2 <i>O</i> USE
Sh		COMMON/BOTANICAL	S			H20 USE
Sh		Groundcover	3×4	14	98	H2 <i>O</i> USE
Sh	rubs ŧ	Groundcover India Hawthorne	3×4	14 25		
Sh	rubs # 5 Gal	Indía Hawthorne Raphiolepis indica	3x4 4x5 5x5	25 25	98 625	М
Sh	rubs 4 5 Gal 5 Gal	Groundcover India Hawthorne Raphiolepis indica Apache Plume Fallugia paradoxa Chamisa	3x4 4x5 5x5 nauseo 2x3	25 25 sus 9	98 625	M
Sh	F ubs 4 5 Gal 5 Gal 5 Gal	India Hawthorne Raphiolepis indica Apache Plume Fallugia paradoxa Chamisa Chrhysothamnus Blue Mist	3x4 4x5 5x5 nauseo 2x3 tstrahibu	25 25 9 ch' 64	98 625 650	L
Sh	rubs 4 5 Gal 5 Gal 5 Gal 5 Gal	India Hawthorne Raphiolepis indica Apache Plume Fallugia paradoxa Chamisa Chrhysothamnus Blue Mist Panicum virgatum 'Ro Buffalo Juniper	3x4 4x5 5x5 nauseo 2x3 tstrahibu	25 25 9 ch' 64	98 625 650 54	M L L
Sh	rubs 4 5 Gal 5 Gal 5 Gal 5 Gal 5 Gal	Groundcover India Hawthorne Raphiolepis indica Apache Plume Fallugia paradoxa Chamisa Chrhysothamnus Blue Mist Panicum virgatum 'Ro Buffalo Juniper Juniperus sabina	3x4 4x5 5x5 nauseo 2x3 tstrahibu 2x8 Buffalc 5x7 2x2	25 25 9 ch' 64 49	98 625 650 54 896 98	М Ц Ц М
Sh	rubs 4 5 Gal 5 Gal 5 Gal 5 Gal 5 Gal 5 Gal	India Hawthorne Raphiolepis indica Apache Plume Fallugia paradoxa Chamisa Chrhysothamnus Blue Mist Panicum virgatum 'Ro Buffalo Juniper Juniperus sabina Butterfly Bush Buddleia davidii	3x4 4x5 5x5 nauseo 2x3 tstrahibu 2x8 Buffalc 5x1 2x2 curoides	25 25 9 ch' 64 49	98 625 650 54 896 98	М Ц Ц Д М М

Landscape Gravel / Filter Fabric 3/4" Crushed Grey

Drainage po Sandy Soil Seed Mix

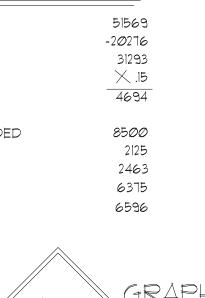



SCALE: |" = 20'-0"



Mitchell Associates, inc

with the state of the Landscape Architecture Danny Mitchell


danny@mitchellassociatesinc.com

505.639.9583




ENGINEER SEAL

PROJECT

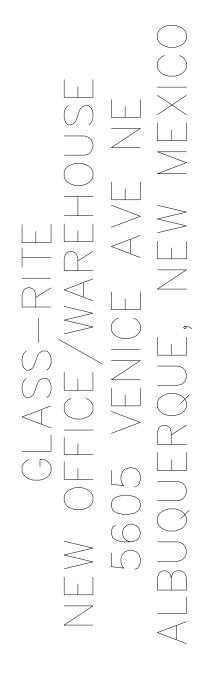

REVISIONS

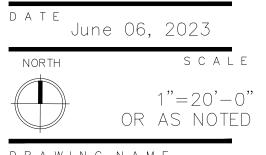

DRAWING NAME







COMPONENT
POINT OF CONNECTION, PROVIDED BY OTHE
IRRIGATION CONTROLLER
BACKFLOW PREVENTION DEVICE
MASTERVALVE ASSEMBLY
MAINLINE
ELECTRIC ZONE VALVE
SLEEVES
Drip Line, Tree Netafim Rings
Drip Line, Shrub Drip Emitter Line
Drip Line, Tree Netafim Rings Drip Line, Shrub Drip Emitter Line Netafim Spiral Tree Irrigation

Size Equipment as Required for Flow Rate

IRRIGATION NOTES

- 1. CONTRACTOR SHALL VERIFY ALL DIMENSIONS, ELEVATIONS, WORK.
- 2. CONTRACTOR SHALL NOTIFY LANDSCAPE ARCHITECT OF ANY OR CONTINUING WORK.
- 3. THE IRRIGATION CONTRACTOR SHALL MAKE NO SUBSTITUTIONS, LANDSCAPE ARCHITECT.
- 4. ALL CONSTRUCTION SHALL CONFORM TO CITY, COUNTY, STATE, THE IRRIGATION CONTRACTOR TO ENSURE THAT ALL IRRIGATION OR APPROVALS.
- PLAN.
- HAVE A BACKFLOW PREVENTER INSTALLED.
- 7. IRRIGATION LATERAL LINES, MAIN LINES AND EQUIPMENT MAY BE LIMITS OF THE PROPERTY LINE.
- 8. ALL IRRIGATION SLEEVING TO BE THE RESPONSIBILITY OF THE IRRIGATION CONTRACTOR. ELECTRICAL WIRES FOR IRRIGATION SLEEVES. SEE SLEEVING DETAIL.
- 9. SUPPLY LINE AND WATER METER TO BE PROVIDED BY BEGIN DOWNSTREAM OF THE IRRIGATION WATER METER.





ENGINEER SEAL

IRRIGATION LEGEND

	MANUFACTURER
HERS	SEE CIVIL PLANS
	HUNTER
	FEBCO (OR EQUAL)
	HUNTER
	Sch 4Ø PVC
	HUNTER
	Class 200 PVC
	Class 200 PVC
	Polypipe

SIZE / NOTES

Smart Controller _) | 1/2" RPA / Freeze Protection Required 1 1/2" 1 1/2"

1" Typ. 2 SIZES LARGER THAN PIPE TO BE SLEEVED.

SEE DETAIL RAINBIRD,

EQUIPMENT QUANTITIES, AND UTILITY LOCATIONS PRIOR TO BEGINNING

DISCREPANCIES IN PLANS OR SPECIFICATIONS PRIOR TO BEGINNING

DELETIONS, OR ADDITIONS TO THIS PLAN WITHOUT APPROVAL OF THE

AND FEDERAL REQUIREMENTS. IT SHALL BE THE RESPONSIBILITY OF EQUIPMENT MEETS GOVERNMENT REGULATIONS, CONTRACTOR SHALL ALSO BE RESPONSIBLE FOR OBTAINING ANY NECESSARY PERMITS

5. THIS PLAN IS SCHEMATIC AND DUE TO THE NATURE OF CONSTRUCTION SLIGHT FIELD MODIFICATIONS MAY BE NECESSARY TO IMPLEMENT

6. IRRIGATION SYSTEMS CONNECTED TO POTABLE WATER SUPPLY, SHALL

SHOWN OUTSIDE PROPERTY LINES ON THIS PLAN, ALL IRRIGATION LINES AND EQUIPMENT ARE TO BE WITHIN AND INSTALLED WITHIN THE

VALVES AND IRRIGATION LINES ARE TO BE PLACED IN. SEPARATE

OWNERBACKFLOW PREVENTOR TO BE PROVIDED BY IRRIGATION CONTRACTOR. IRRIGATION CONTRACTOR'S POINT OF CONNECTION TO

Mitchell Associates, inc

Autor of a state of the Landscape Architecture Danny Mitchell


danny@mitchellassociatesinc.com

505.639.9583

PROJECT




REVISIONS

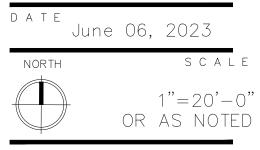

DRAWING NAME



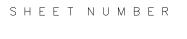




SCALE: |" = 20'-0"


GRAPHIC SCALE

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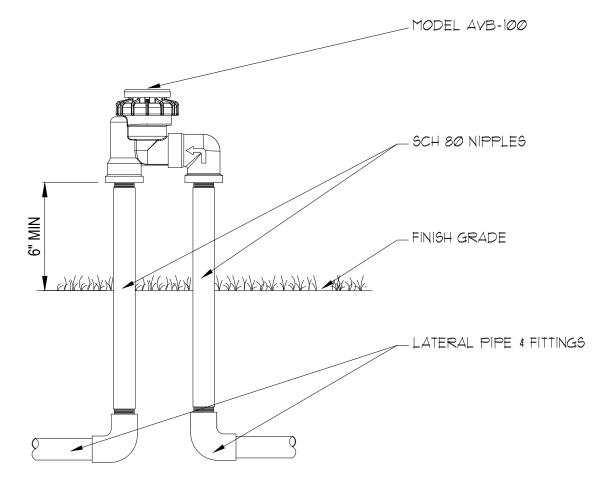
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NOTES: REFERENCE NUMBER 901-085n.




<u>NOTE:</u> ATMOSPHERIC VACUUM BREAKERS SHOULD BE INSTALLED 6 - 12" ABOVE THE HIGHEST SPRINKLER HEAD WITHIN THE ZONE, OR, ACCORDING TO LOCAL CODE.

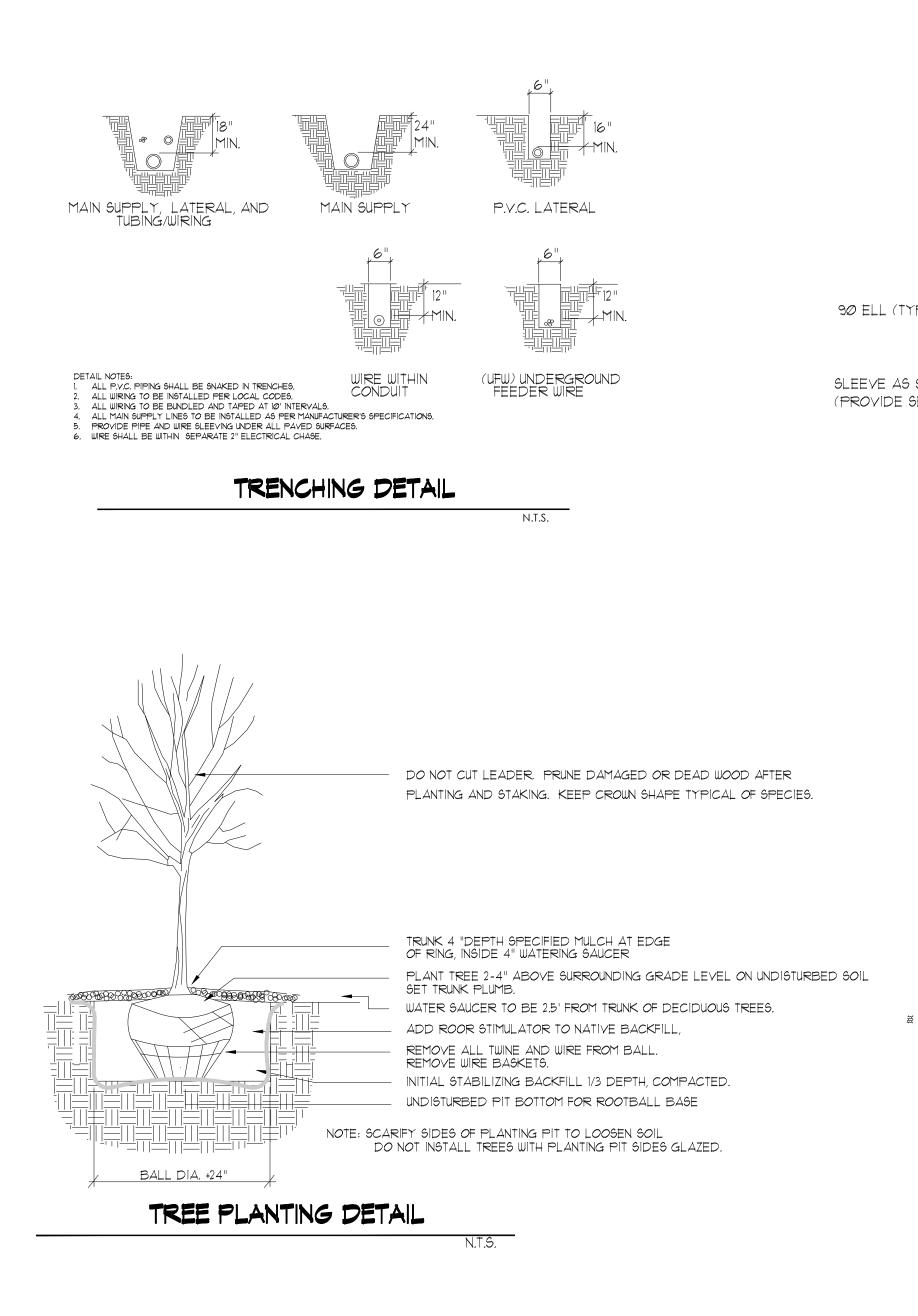I. INSTALLATION TO BE COMPLETED IN ACCORDANCE WITH MANUFACTURER'S SPECIFICATIONS. 2. DO NOT SCALE DRAWINGS. 3. CONTRACTORS NOTE: FOR PRODUCT AND COMPANY INFORMATION VISIT www.CADdetails.com/info

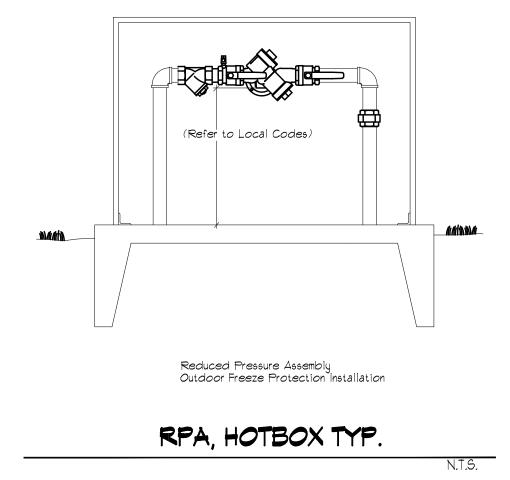N.T.S.


VALVES: AVB VALVES

AVB W/ SCH 80 NIPPLE RISERS

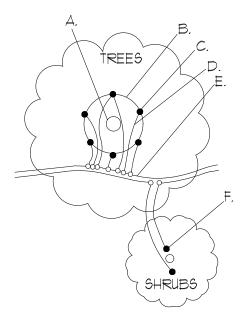


A. TREE TRUNK/ROOT CROWN B. 24" CIRCLE FROM TRUNK C. EMITTERS D. 1/8" DISTRIBUTION LINE E. PE DRIPLINE F. EMITTER PLACED WITHIN 6" OF PLANT STEM NOTE: PLACE EMITTER ABOVE PLANT ON SLOPE

EMITTER PLACEMENT DETAIL

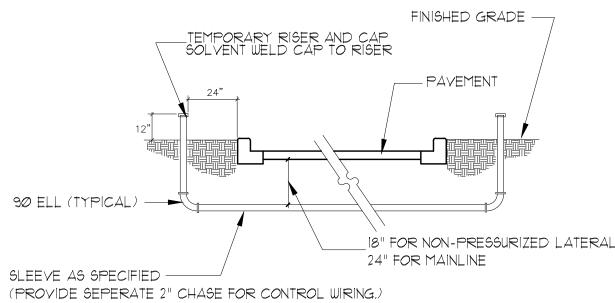




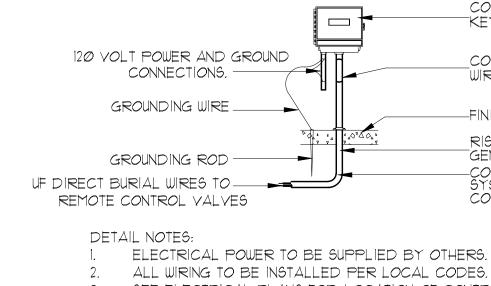

- SEE ELECTRICAL PLANS FOR LOCATION OF CONTROLLER.
- CONTROLLER TO BE MOUNTED APPROXIMATELY 5'-0" ABOVE 4 FINISHED FLOOR ELEVATION.

CONTROLLER DETAIL

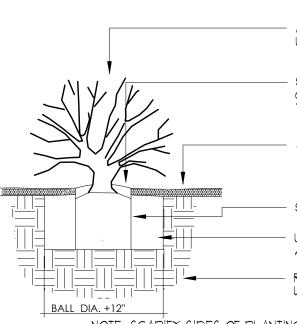

ALLOW SHRUBS TO REACH FULL MATURE SIZE WITH MINIMAL PRUNING

SET SHRUB AT GRADE GROWN IN CONTAINER OR GROWN IN NURSERY. SET TOP OF JUNIPER'S ROOTBALL TO FINISH GRADE OF MULCH

APPLY SPECIFIED MULCH AT 3" DEPTH

- SCORE CONTAINER ROOTBALLS WITH ENCIRCLING ROOTS USE ROOT STIMULATOR WITH NATIVE SOIL BACKFILL ADD SLOW RELEASE FERTILIZER REMOVE CONTAINER. PLACE ROOTBALL ON

UNDISTURBED SOIL.

NOTE: SCAR^IFY SIDES OF PLANTING PIT TO LOOSEN SOIL DO NOT INSTALL SHRUBS WITH PLANTING PIT SIDES GLAZED.


SHRUB PLANTING DETAIL

N.T.S.

N.T.S.


_]=	CONTROLLER AS SPECIFIED WITH "KEYED LOCK OR PADLOCK.
	_CONTROL WIRE AND COMMON WIRE CONNECTIONS
	-FINISHED FLOOR ELEVATION RISER AND "ELL" (BY GENERAL CONTRACTOR). -CONDUIT TO IRRIGATION SYSTEM (BY GENERAL CONTRACTOR).

N.T.S.

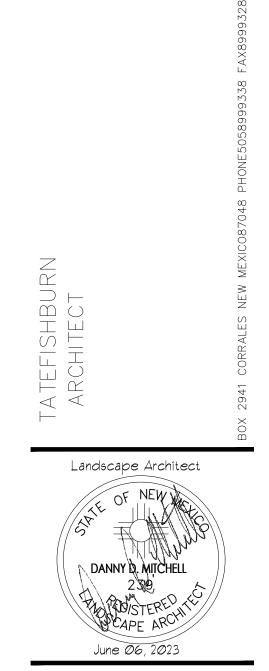


ENGINEER SEAL

PROJECT

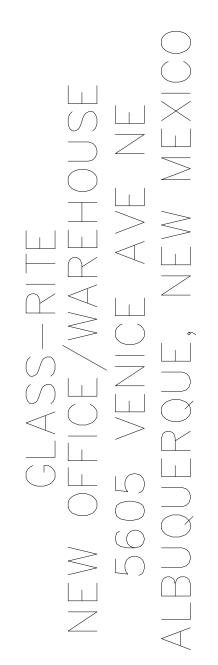

REVISIONS

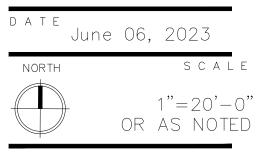

DRAWING NAME

Detail Sheet

SHEET NUMBER



Mitchell Associates, inc

The state of the state of the state Landscape Archítecture Danny Mitchell

danny@mitchellassociatesinc.com

505.639.9583

CITY OF ALBUQUERQUE

Planning Department Alan Varela, Director



Mayor Timothy M. Keller

August 8, 2023

Tate Fishburn, R.A Tate Fishburn Architect P.O. Box 2941 Corrales, NM 87048

Re: New Office Warehouse 5605 Venice Ave. NE Traffic Circulation Layout Architect's Stamp 04-24-23 (B18-D026)

Dear Mr. Fishburn,

The TCL submittal received 07-27-2023 is approved for Building Permit by Transportation. A copy of the stamped and signed plan will be needed for each of the building permit plans. Please keep the original to be used for certification of the site for final C.O. for Transportation.

^{PO Box 1293} When the site construction is completed and an inspection for Certificate of Occupancy (C.O.) is requested, use the original City stamped approved TCL for certification. Redline any minor changes and adjustments that were made in the field. A NM registered architect or engineer must stamp, sign, and date the certification TCL along with indicating that the development was built in "substantial compliance" with the TCL. Submit this certification, the TCL, and a completed <u>Drainage and Transportation Information Sheet</u> to the <u>PLNDRS@cabq.gov</u> for log in and evaluation by Transportation. AN APPROVED/ACCEPTED WORK ORDER IS A CONDITION OF RELEASING THE FINAL CO.

MWW.cabq.gov Once verification of certification is completed and approved, notification will be made to Building Safety to issue Final C.O. To confirm that a final C.O. has been issued, call Building Safety at 924-3690.

Sincerely,

Ernest Armijo, P.E. Principal Engineer, Planning Dept. Development Review Services

C: CO Clerk, File

AN APPROVED/ACCEPTED WORK ORDER IS A CONDITION OF RELEASING THE FINAL CO.

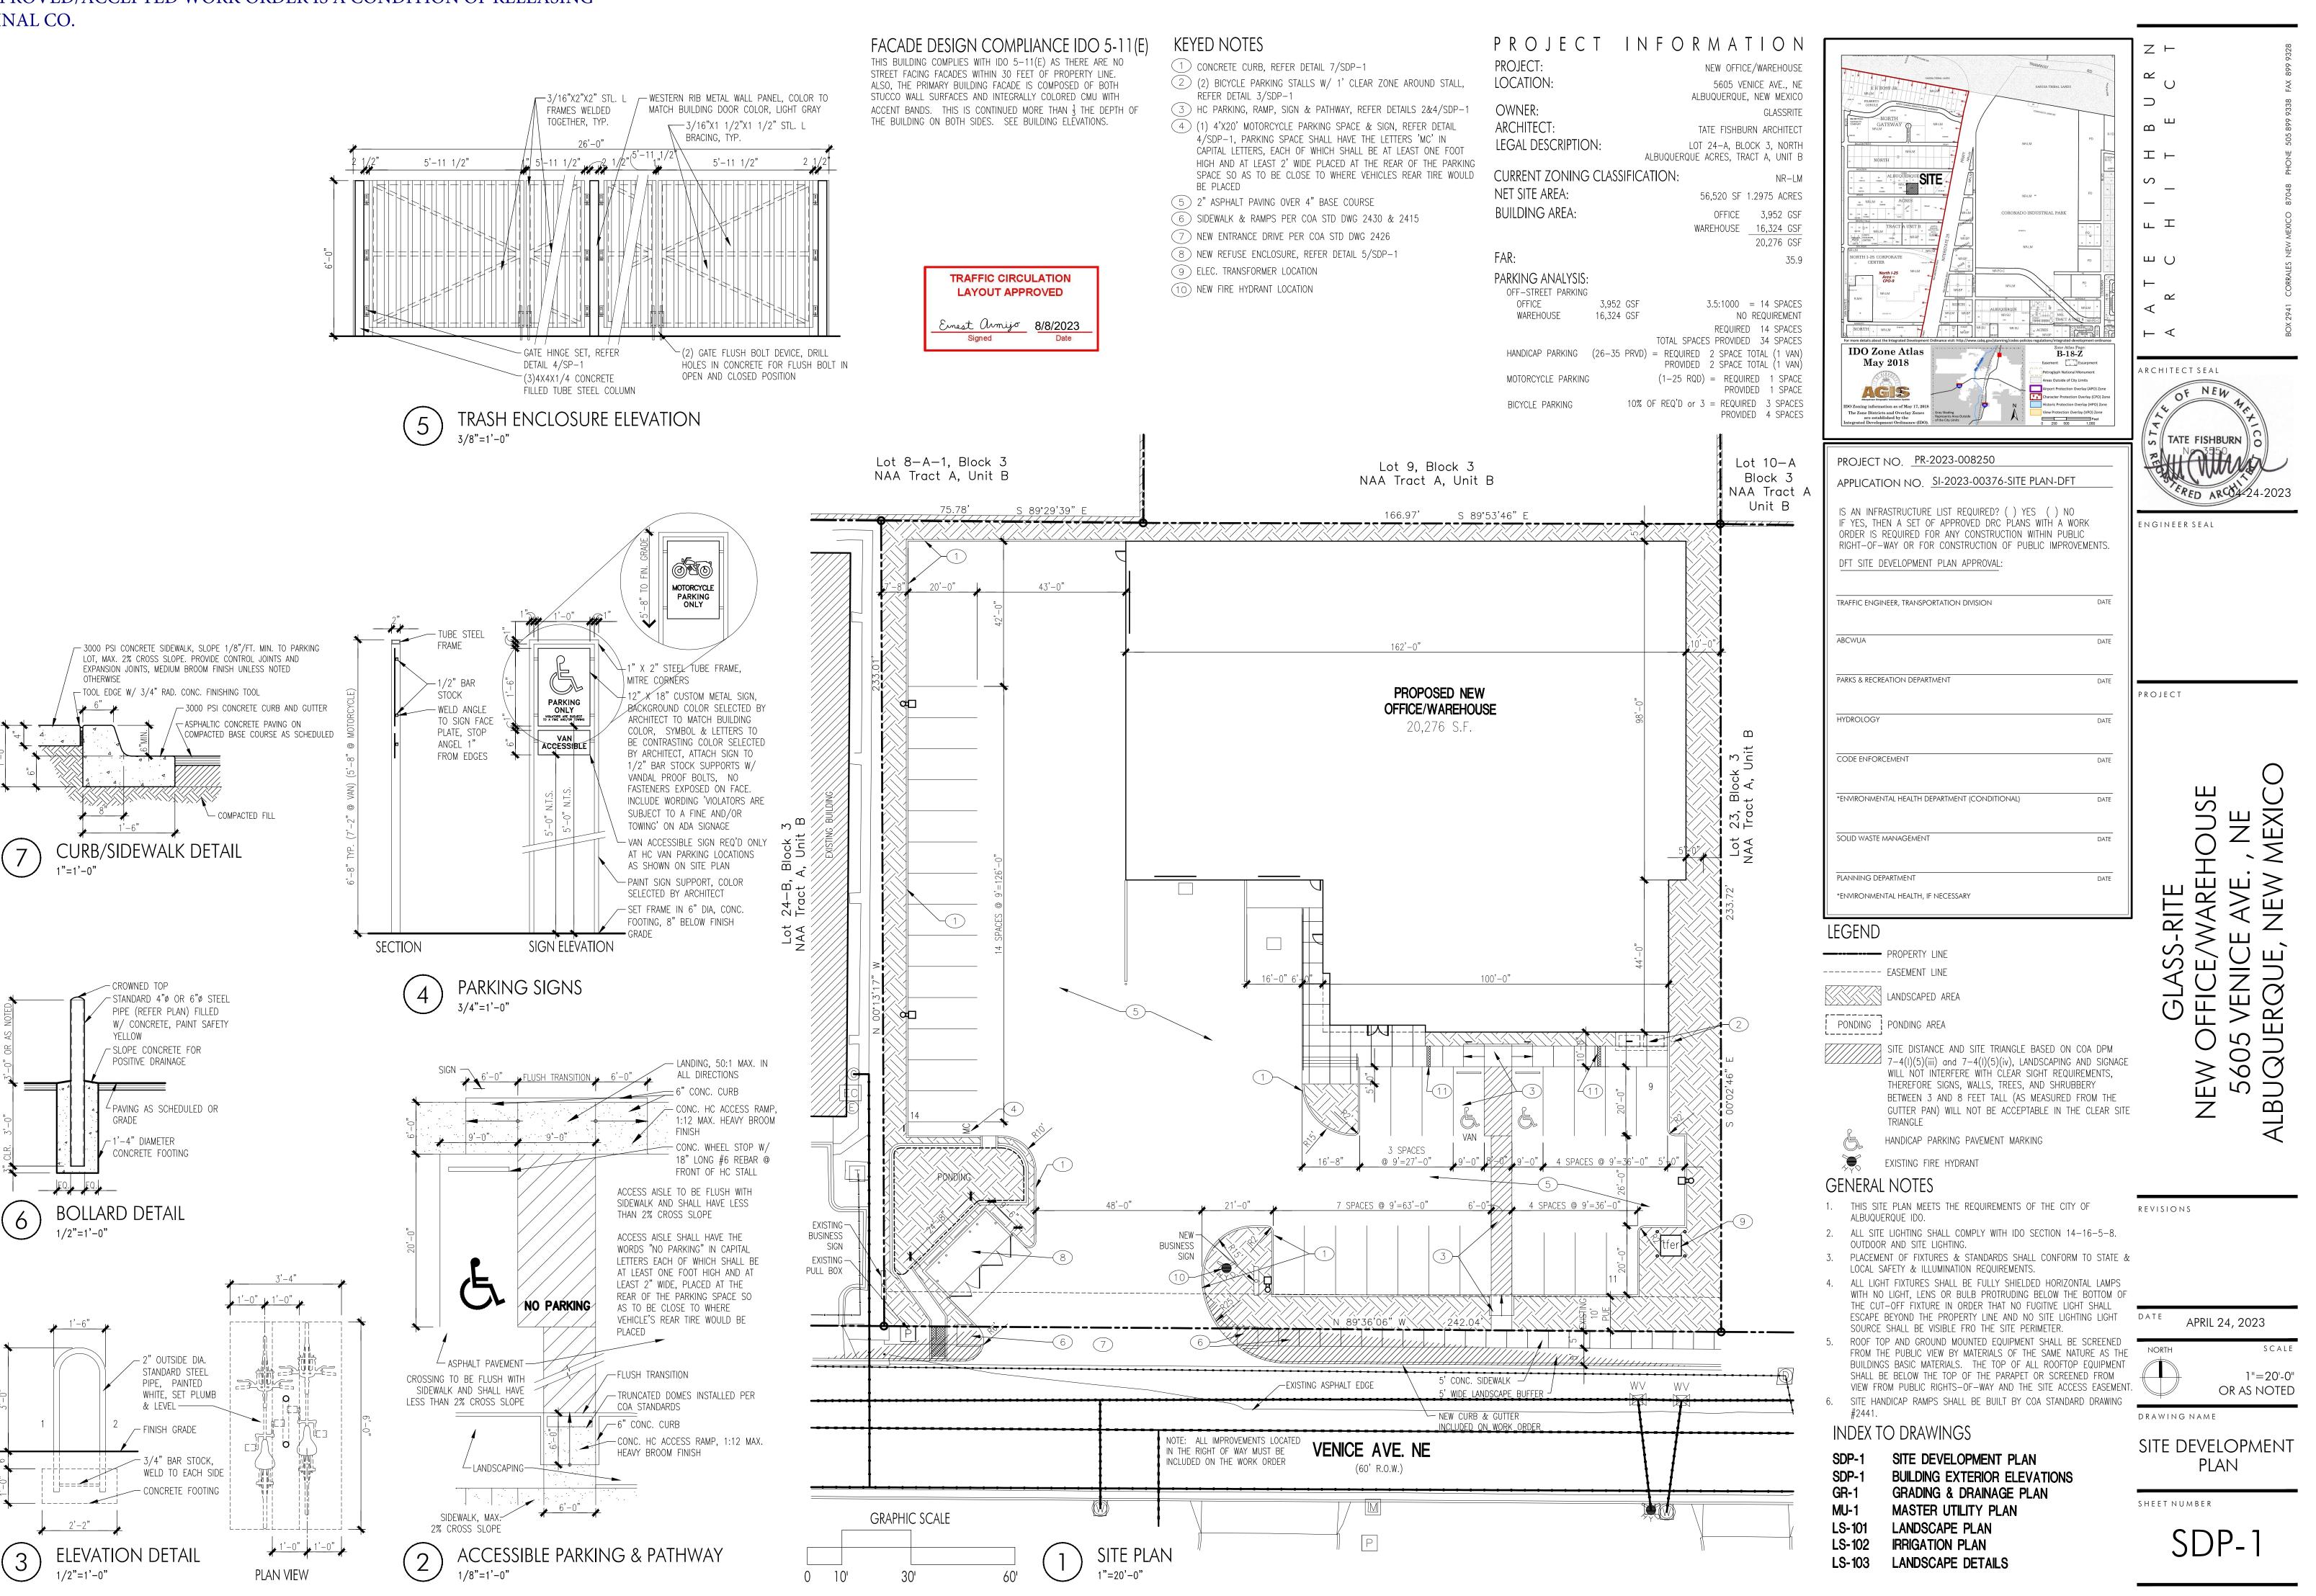


FIGURE 12

INFRASTRUCTURE LIST

(Rev. 2-16-18)

Date Submitted: 7/25/23

Date Site Plan Approved:_____

Date Preliminary Plat Approved:

Date Preliminary Plat Expires:

DFT Project No.: **PR-2023-008250**

DFT Application No .: SI-2023-00376-SITE PLAN -DFT

TO SUBDIVISION IMPROVEMENTS AGREEMENT DEVELOPMENT FACILITATION TEAM (DFT) REQUIRED INFRASTRUCTURE LIST

GLASS-RITE OFFICE/WAREHOUSE-5605 VENICE AVE., NE

PROPOSED NAME OF PLAT AND/OR SITE DEVELOPMENT PLAN

LOT 24-A, BLOCK 3, NORTH ALBUQUERQUE ACRES, TRACT A, UNIT B

EXISTING LEGAL DESCRIPTION PRIOR TO PLATTING ACTION

Following is a summary of PUBLIC/PRIVATE Infrastructure required to be constructed or financially guaranteed for the above development. This Listing is not necessarily a complete listing. During the SIA process and/or in the review of the construction drawings, if the DRC Chair determines that appurtenant items and/or unforeseen items have not been included in the infrastructure listing, the DRC Chair may include those items in the listing and related financial guarantees. Likewise, if the DRC Chair determines that appurtenant or non-essential items can be deleted from the listing, those items may be deleted as well as the related portions of the financial guarantees. All such revisions require approval by the DRC Chair, the User Department and agent/owner. If such approvals are obtained, these revisions to the listing will be incorporated administratively. In addition, any unforeseen items which arise during construction which are necessary to complete the project and which normally are the Subdivider's responsibility will be required as a condition of project acceptance and close out by the City.

	_					_	Construction Cer		
Financially	Constructed	Size	Type of Improvement	Location	From	То	Priva		City Cnst
Guaranteed	Under						Inspector	P.E.	Engineer
DRC #	DRC #								
			Maian Lagal Davian Curk & Cutton				,	,	,
		14' F-E	Major Local Paving, Curb & Gutter	VENICE AVE NE	WEST PROPERTY	EAST PROPERTY	/	/	/
			5' Sidewalk (north side)		LINE	LINE			
							,	,	,
		VARIES	TEMPORARY PAVING (TRANSITION)	VENICE AVE NE	EAST PROPERTY	50' EAST OF EAST	/	/	/
		14' TO 0'			LINE	PROPERTY LINE			
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inancially	Constructed						Construction Certification	
Guaranteed	Under	Size	Type of Improvement	Location	From	То	Private City	
DRC #	DRC #						Inspector P.E. Eng	
			Engineer's Certification for Grading & Drainage is r	equired for release of Financial Gu	arantee		/ /	
				Appr	Approval of Creditab	e Items:	Approval of Creditable Items:	
					Impact Fee Admistrat	or Signature Date	City User Dept. Signature	
		1		NOTES		Julio Dulo		
2								
<u>د</u> _								
2 								
	AGENT / OWNER			DEVELOPMENT RE	VIEW BOARD MEMBER	APPROVALS		
3				DEVELOPMENT RE	VIEW BOARD MEMBER	APPROVALS		
3	AGENT / OWNER ENT CARRICA NAME (print)	., PE	PLANN	DEVELOPMENT RE		APPROVALS RKS & RECREATION - c	date	

SIGNATURE - date

CITY ENGINEER - date

HYDROLOGY-date

DESIGN REVIEW COMMITTEE REVISIONS

REVISION	DATE	DRC CHAIR	USER DEPARTMENT	AGENT /OWNER