7600 CENTRAL AVE SW ALBUQUERQUE, NM 87121 LOT: 51 / BLOCK: 0000 SUBDIVISION: TOWN OF ATRISCO GRANT UNIT 6

UPC: 101005722814830517

LEGAL DESCRIPTION: ATRISCO GRANT W1/2 TR52 W2.39 AC

DRB PROJECT NUMBER: PR-2023-008589 aka PR-2024-009904 APPLICATION NUMBER: SI-2024-000136

# ADMINISTRATIVE SITE PLAN APPROVALS REF # : FP 23-014858 - APPROVED

# ALTERNATIVE LANDSCAPE PLAN APPROVAL

SOLID WASTE DEPARTMENT

DEVELOPMENT REVIEW DEPARTMENT

1.	FENCES, WALLS, SIGNS, AND ACCESSORY STRUCTURES ARE SUBJECT TO SEPERATE REVIEWS AND
	PERMITS.
2.	ANGLES SHOWN ARE EITHER 90 DEGREES OR A SUPPLEMENT OF THE ANGLE INDICATED.
3.	PRIVATE ROADWAYS WILL BE POSTED WITH "FIRE LANE" SIGNS AS REQUIRED BY THE DENVER FIRE DEPARTMENT.
4.	PARKING SPACES FOR PERSONS WITH DISABILITIES WILL BE CLEARLY DELINEATED WITH UPRIGHT SIGNS.
5.	APPROVAL FOR THIS PLAN DOES NO CONSTITUTE OR IMPLY COMPLIANCE WITH ADA
	REQUIREMENTS.
6.	SITE(S) SHALL BE LANDSCAPED PRIOR TO ISSUANCE OF A FINAL CERTIFICATE OF OCCUPANCY (CO)
	DURING THE GROWING SEASON OF APRIL 1ST TO OCTOBER 1ST, AT ALL OTHER TIMES THE
	INDIVIDUAL SITE SHALL BE LANDSCAPED WITHIN 45 (FORTY-FIVE) DAYS OF THE START OF THE
	FOLLOWING GROWING SEASON.
7.	AN ACCESS EASEMENT FOR EMERGENCY SERVICES IS HEREBY GRANTED ON AND ACROSS ALL
	AREAS FOR POLICE, FIRE, MEDICAL, AND OTHER EMERGENCY VEHICLES AND FOR THE PROVISION OF EMERGENCY SERVICES.
8.	ALL LANDSCAPED AREAS SHALL BE IRRIGATED WITH UNDERGROUND AUTOMATIC IRRIGATION
	SYSTEM. TREES, SHRUBS, AND DECORATIVE GRASS WILL BE IRRIGATED BY A SEPERATE ZONE FROM
	SOD/GRASS; THIS INCLUDES TREES PLANTED IN SOD/GRASS AREAS. THE IRRIGATION SYSTEM IS TO
	HAVE A RAIN SENSOR SHUTOFF INSTALLED.
9.	PRIVATE ROADWAYS ARE NON-DEDICATED STREETS AND WILL NOT BE MAINTAINED BY THE CITY
	AND COUNTY OF DENVER
10.	RESPONSIBILITY FOR THE MAINTENANCE OF THE COMMONLY OWNED LAND AND STORM WATER
	DETENTION FACILITY CONSTRUCTED AS PART OF THIS DEVELOPMENT WILL BE THAT OF THE HOME

**GENERAL NOTES** 

ble 6-1-1: Summaı	y of Development	<b>Review Procedu</b>
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DHO = Development Hearing Officer EPC = Environmental Planning Commission LC = Landmarks Commission ZHE = Zoning Hearing Examiner LUHO = Land Use Hearing Officer

### X = Required [] = Public Hearing <> = Quasi-judicial Hearing

R = Review/Recommend D = Review and Decide AR = Appeal Review / Recommend AD = Appeal Review and Decide

	Mt	gs		Pub	lic No	tice			Revie	w and	Decisio	n-makii	ng Bodie	es	
Subsection	6-4(B)	6-4(C)	6-4(K)(2)	6-4(K)(3)	6-4(K)(4)	6-4(K)(5)	6-4(K)(6)	6-2(B)	6-2(D)	6-2(E)	6-2(Н)	6-2(J)	6-2(1)	6-2(A)	rres
Application Type	Neighborhood	Pre-application	Email	Mailed	Posted Sign	Published	Web Posting	City Staff[1]	ОНО	ЭБ	27	ЗНЕ	онпт	City Council <sup>[2]</sup>	Specific Procedures
Site Plan – Administrative <sup>[4]</sup>	X <sup>[5]</sup>		Х		Х		Х	D					<ar></ar>	<ad></ad>	6-5(G)

6-4(B)(1)(b) NEIGHBORHOOD MEETING (NOT REQUIRED): THE APPLICATION IS A SITE PLAN - ADMINISTRATIVE PROPOSING A NEW BUILDING OR MULTIPLE BUILDINGS THAT INCLUDE A TOTAL OF ANY OF THE FOLLOWING:

1. MORE THAN 100 MULTI-FAMILY RESIDENTIAL DWELLING UNITS (N/A) 2. MORE THAN 50,000 SQUARE FEET OF NON-RESIDENTIAL DEVELOPMENT (N/A)

6-4(K)(2) ELECTRONIC MAIL: THE APPLICANT SHALL SEND AN ELECTRONIC MAIL NOTICE TO THE EMAIL ADDRESSES ON FILE WITH THE ONC FOR EACH NEIGHBORHOOD ASSOCIATION WHOSE BOUNDARIES INCLUDE OR ARE

6-4(K)(4) POSTED SIGN: THE APPLICANT SHALL POST AT LEAST 1 SIGN ON EACH STREET ABUTTING THE PROPERTY THAT IS THE SUBJECT OF THE APPLICATION, AT A POINT CLEARLY VISIBLE FROM THAT STREET, FOR AT LEAST 15 CALENDAR DAYS BEFORE THE PUBLIC HEARING AND FOR THE REQUIRED APPEAL PERIOUD FOLLOWING ANY FINAL DECISION (NOT APPLICABLE)

IDO ZONE AT	LAS MAP
MERIDIAN BUSINESS PARK	NR-BP
3) 12 21A NR-BP 16 5 7 - 12 0 100	NR-BP  AMAZCI
NR BP a link SP-98-64 ATRISCO BUSINESS BUSINESS	NR-BP  R-ML  Coors  Boulevard – CPO-2  PARK  PARK  SP
ATRISCO  NR-BP  OF THE SECOND	AIAIAI HUBBELL PLAZA  NR-BP  MECTER
(UNT 2)  10 ATRISCO GRANT  HUBBELL A  10 TOWN OF ATRISCO GRANT  ATRISCO GRANT  WEST POLITICISM  BI  WEST POLITICIS	SHIP CHURCH  A D1 SOROHS  A SHADAM  B18
7600 (  100 100 100 100 100 100 100 100 100 10	CT SITE CENTRAL AVE SW  COORS PLAZA  ATRISCO GRANT  UNIT 6  TOWN OF ATRISCO
1007704   SKYVIEW   PARK	R-1B TOWNER OF THE TOWNER OF T
MX-L  BARRETT_V E  NR-C 1003228  A H-1B  PALM  23  34  35  37  38  39  30  30  30  30  30  30  30  30  30	NR-C
For more details about the Integrated Development Ordinance visit: http://www.cabo	WEST SEED TOWN NR-PO-A NR-PO-A ROY Policies regulations/integrated-development-ordinance
IDO Zone Atlas	Zone Atlas Page: K-10-Z

Petroglyph National Monument Areas Outside of City Limits

Airport Protection Overlay (APO) Zone Character Protection Overlay (CPO) Zone Historic Protection Overlay (HPO) Zone

View Protection Overlay (VPO) Zone

PREMIUM TRANSIT STATION

May 2018

IDO Zoning information as of May 17, 2018

are established by the Integrated Development Ordinance (IDO).

The Zone Districts and Overlay Zones

Gray Shading
Represents Area Outside

			PROGRAM	/I M	ATRIX			
PERCENT of TTL	Bed / Bath	Name	CONCEPTUA Av NLA		GRAM TTL	Balcony	TTL	NOTES
91.7%	1/1	Unit 1.0	500	44	22,000	0	0	
6.3% 2.1%	1/12/1	Unit 1.0 Unit 2.0	520 775	3	1,560 775	0	0	Type A units Property Manager Unit
			nily Average SF 506.98	48	24,335	0	0	Total
Apartment RSF Core / Circulation Leasing / Lobby / Amenity Maintenance	Lvi 1-3 Lvi 1 Lvi 1				24,335 7,949 3,000 600			Floorplate Efficiency 5'-2" corridors, MEP Includes all space on Level 1 Include Bedbug & Shed
GLA					35,884			Parking & Balconies not included
					0			
GBA					35,884			
					On-Si	te Parking		_
Zone District	MX-M and R-T				Reduction	Req'd	Provided	
Parking		54140704100000		Units		Cars	Cars	
Zoning Requirement	1.2 / unit 1.6 / unit	1 bedroom 2 bedroom		47 1		56 1		
Amenity	3 / 1,000sf	3,000= 3 x 3				9		calculations round down
Total required (max allowed reductions)	50%				33	66		
EV Stalls (10%)								Provide panel space, conduit,
(2 car reduction per station)	-1				6 stalls	-6		208/240 volt and 40 amp circuit EV chargers installed
Proximity to Transit								
(30% reduction)					20	-20 40	40	reductions round up
Motorcycle parking		1 per 25 cars				2	2	
Bicycle parking	10%					7	24	
	10 /	).					24	
Loading Space / NA								
Open space 1 bedroom- 225SF	221			47		10 F7F		
2 bedroom- 285SF	225 285			47 1		10,575 285 10,860		

RIII	LDING & CODE INFORMATION
DOI	EDING & CODE IN CHINATION
OCCUPANCY CONSTRUCTION TYPE SPRINKLER SYSTEM NUMBER OF STORIES GROSS BUILDING AREA	R-2, A-3, B V-A NFPA 13R 3 35,884 SF
ZONING / MULTIFAMILY CENTER TYPE CITY DEVELOPMENT AREA MAJOR TRANSIT CORRIDOR CITY COUNCIL MRA W/ ADOPTED PLAN	MX-M (IDO: 4-3(B)(8) & R-T (IDO: 4-3(D)(1) ACTIVITY (IDO: 14-16-7-1) AREA OF CHANGE (IDO: 14-16-7-1) YES (IDO: 14-16-7-1) DISTRICT 3 WEST CENTRAL
OVERLAY ZONE PRIMARY ST	N/A CENTRAL AVE SW / RTE 66
DWELLING UNITS TOTAL	(47) 1 BEDROOM, (1) 2 BEDROOM 48
SURFACE PARKING TOTALS	40 SPACES 2 MOTORCYCLE SPACES 24 BICYCLE SPACES
JURISDICTION	ALBUQUERQUE
BUILDING CODES	2021 NEW MEXICO RESIDENTIAL BLDG CODE 2021 NEW MEXICO MECH CODE 2021 NEW MEXICO PLUMB CODE 2020 NEW MEXICO ELEC CODE
LOCAL AMENDMENTS	2022 UNIFORM ADMINISTRATIVE CODE OF THE CITY OF ALBUQUERQUE
ENERGY REQUIREMENTS:	2018 INTERNATIONAL ENERGY CONSERVATION CODE Bernalillo County, Climate Zone 4B
	MFA DESIGN STANDARDS FOR FUNDING HERS certification of 55 or less

	RMATION	
ZONE DISTRICT	MX-M & R-T	
GENERAL ZONE LOT INFORMATION	SQ. FT.	ACRES
ZONE LOT SIZE (GROSS PROJECT AREA)	103,679 GSF	2.38 ACRES
AREA TO BE DEEDED FOR ADDITIONAL RIGHT OF WAY	N\A	N\A
NET LOT AREA (AREA WITHIN PROPERTY LINE, MINUS BUILDING FOOTPRINT)	91,995 - 14,072 = 77,923 SF	-
PRIMARY AND SIDE STREET DESIGNATIONS	PRIMARY ST = CEN	TRAL AVE. SW
PROPOSED USES	AFFORDABLE	HOUSING
NUMBER OF DWELLING UNITS (RESIDENTIAL ONLY)	48 UNITS LEVEL 01 : 15 UNITS LEVEL 02 : 17 UNITS LEVEL 03 : 16 UNITS	
GROSS FLOOR AREA FOR EACH USE (FOR NON RESIDENTIAL AND MIXED USE PROJECTS)	35,884 GSF	
COMMUNITY GARDEN	6,000 SF	
BUILDING FORM USED	GENI	ERAL
DESIGN ELEMENTS (PER IDO TABLE 5-1-2)	REQUIRED	PROVIDED
BUILDING HEIGHT, FEET (MAX)	48 FT	36'-3"
USABLE OPEN SPACE (MIN) - 1BR: 225 SF/UNIT, 2BR: 285 SF/UNIT	225 x 47 = 10,575 SF 285 x 1 = 285 SF	TOTAL PROVIDED : 49,950 SF
	TOTAL REQ : 10,860 SF	
IDO 5-3(D)(3)(b): PEDESTRIAN WALKWAYS FOR STREET FACING FACADES WITH PEDESTRIAN ENTRANCE	PER TABLE 5-3-1: MIN WIDTH: 10FT	10'-0" AVERAGE: 10' + 11 + 10' = 10'-4
SETBACKS (PER IDO TABLE 5-1-2)	REQUIRED	PROVIDED
FRONT (MIN/MAX)	5 FT / N/A	44'-0"
INTERIOR SIDE (MIN/MAX) STREET SIDE : NOT APPLICABLE	0 FT	N/E : 17'-3" N/W : 60'-5"
REAR (MINIMUM)	15 FT	299'-5"
PARKING	REQUIRED	PROVIDED
STANDARD SPACES (1 BEDROOM : 1.2 / UNIT)	$1.2 \times 47 = 56$	FNOVIDED
STANDARD SPACES (2 BEDROOM : 1.6 / UNIT)	$1.6 \times 1 = 1$	
STANDARD SPACES (AMENITY: 3 / 1000 SF @ 3,000 SF)	$3 \times 3 = 9$	
ACCESSIBLE (2%)	$40 \times 2\% = 0.8$	5 SPACES
TOTAL REQUIRED:	66 SPACES	
TRANSIT CORRIDOR REDUCTION (30% RED.)	66 x 30% = 20.1	
EV SPACES (2 CAR REDUCTION PER STALL - 10% MAX)	66 x 10% = 6.6	6 STALLS
TOTAL REQUIRED AFTER REDUCTIONS:	40 SPACES	40 STALLS
BICYCLE (3 SPACES OR 10% OF REQUIRED PARKING, GREATER)	10% OF 67 = 6.7	24 SPACES
MOTORCYCLE (1 PER 25 CARS)	67 / 25 = 2.68	4
,	REQUIRED	PROVIDED
,	HEGOIIED	
GROUND STORY ACTIVATION (TRANSPARENCY)	20% x 1264SF	352 554
,	20% x 1264SF = 252.8SF	352.5SF N/A


APPLI	CABLE IDO STANDARDS
ALLOWABLE USES	TABLE 4-2-1 RESIDENTIAL USE - DWELLING, MULTI-FAMILY (MX-M) TABLE 4-2-1 COMMERCIAL USE - COMMUNITY GARDEN (R-T)
USE SPECIFIC STANDARDS	IDO SECTION 4-3(B)(8)(a) / IDO SECTION 4-3(D)(1)(a)
DIMENSIONAL STANDARDS - TABLES & EXCEPTIONS	IDO SECTION 5-1(D)(1) MIXED-USE ZONE DISTRICT, TABLE 5-1-2 (MX-M) IDO SECTION 5-1(C)(1) RESIDENTIAL ZONE DISTRICT, TABLE 5-1-1 (R-T STANDARDS)
SITE DESIGN & SENSITIVE LANDS	N/A
SUBDIVISION OF LAND	N/A
PARKING AND LOADING	IDO SECTION 5-5(C)(1) OFF-STREET PARKING CALCULATIONS TABLE 5-5-1 MINIMUM O FF-STREET PARKING REQUIREMENTS IDO SECTION 5-5(C)(5)(c) REDUCTION FOR PROXIMITY TO TRANSIT IDO SECTION 5-5(C)(6)(a) ELECTRIC VEHICLE CHARGING CREDIT IDO SECTION 5-5(F)(2)(b) DESIGN, ACCESS & CIRCULATION
WALLS AND FENCES	TABLE 5-7-1 MAXIMUM WALL HEIGHT IDO SECTION 5-7(E)(1)(b) MATERIALS AND DESIGN
OUTDOOR AND SITE LIGHTING	IDO SECTION 5-8(D)(1) GENERAL DESIGN AND ILLUMINATION
NEIGHBORHOOD EDGES	N/A
SOLAR ACCESS	IDO SECTION 5-10(C) BUILDING HEIGHTS TABLE 5-10-1 SOLAR RIGHTS MAXIMUM BUILDING HEIGHTS
BUILDING DESIGN	IDO SECTION 5-11(D) MULTI-FAMILY RESIDENTIAL DEVELOPMENT FOR MULTI-FAMILY OUTSIDE OF UC-MS-PT AREAS IDO SECTION 5-11(E)(2)(b) FACADE DESIGN FOR ACTIVITY CENTERS
SIGNS	IDO SECTION 5-12(F)(2) SIGNS IN MIXED-USED AND NON-RESIDENTIAL ZONE DISTRICTS TABLE 5-12-2 ON-PREMISES SIGNS IN MIXED-USE AND NON-RESIDENTIAL ZONE DISTRICTS IDO SECTION 5-12(E)(5)(c) ILLUMINATION AND MOTION
OPERATION & MAINTENANCE	IDO SECTION 5-13(B)(2) BUILDING AND STRUCTURES

ITF 66 FI ATS
H DESERT HOUSING
ENTRAL AVE SW

REVIEWED: EP PROJECT #: 21018 FILE: SHEET TITLE: **COVER SHEET** 


SCALE: 12'' = 1'-0''

SITE-0.0

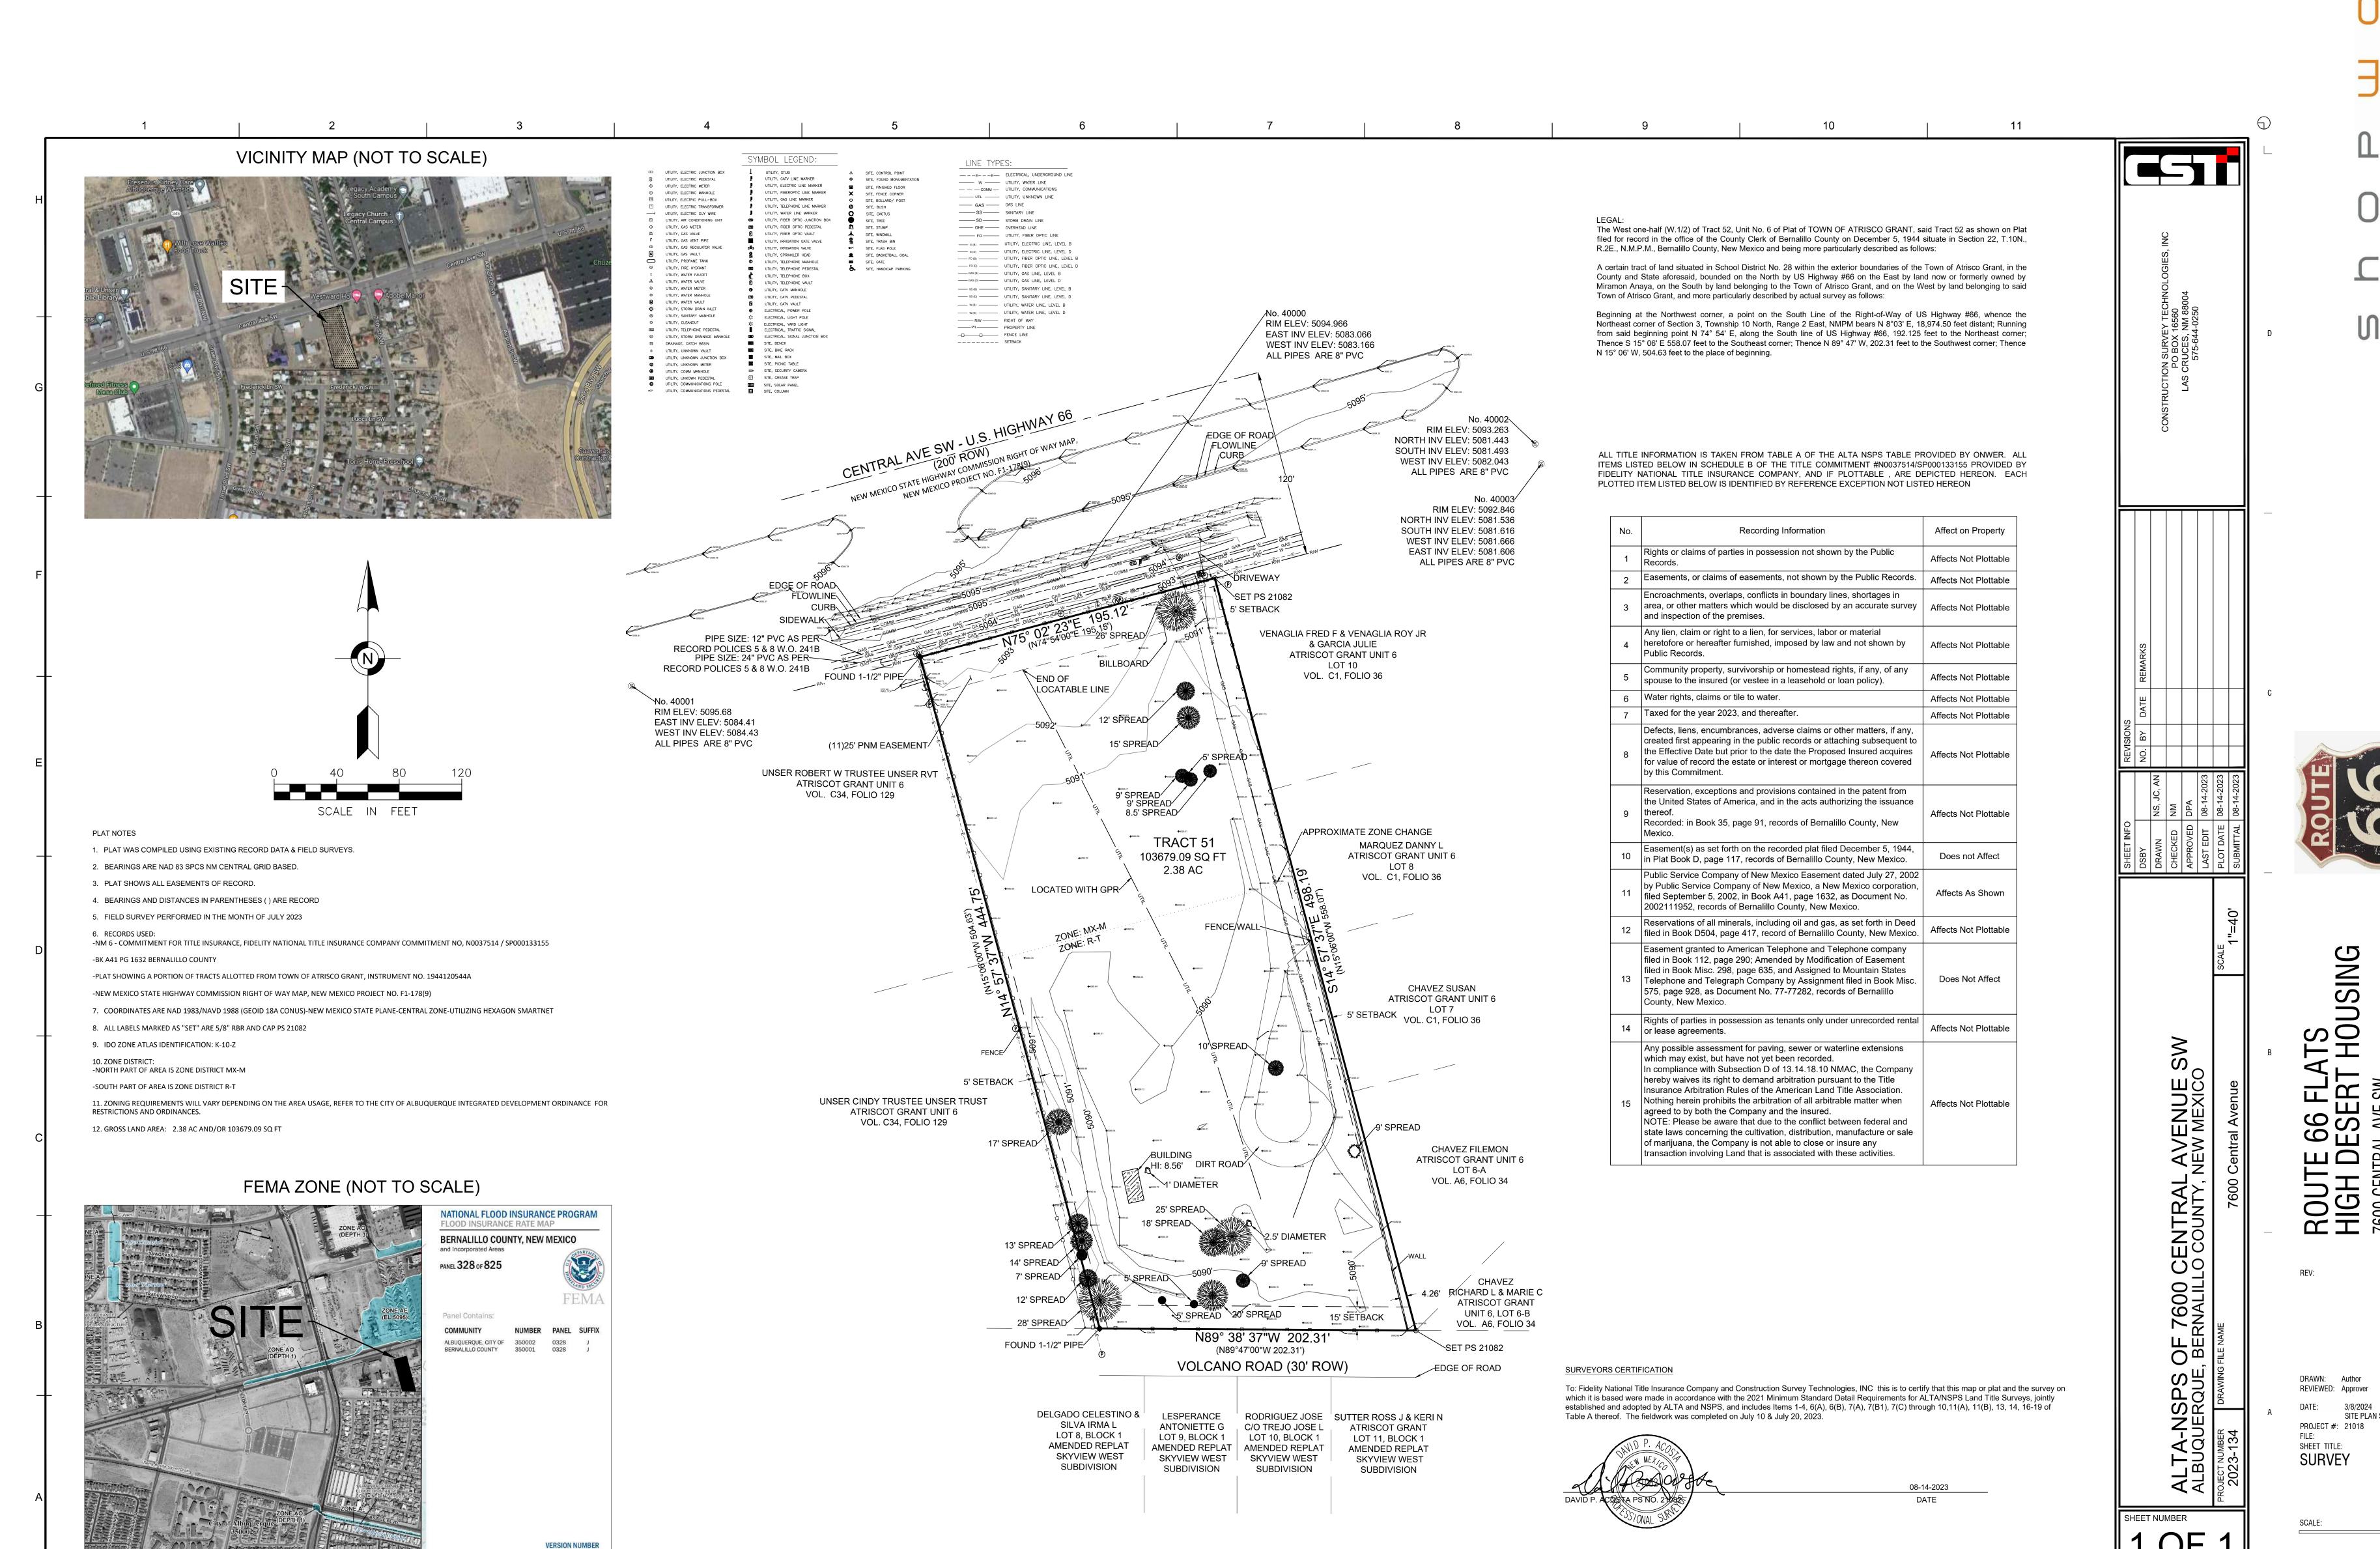


2.3.3.2

SITE PLAN SUBMITTAL

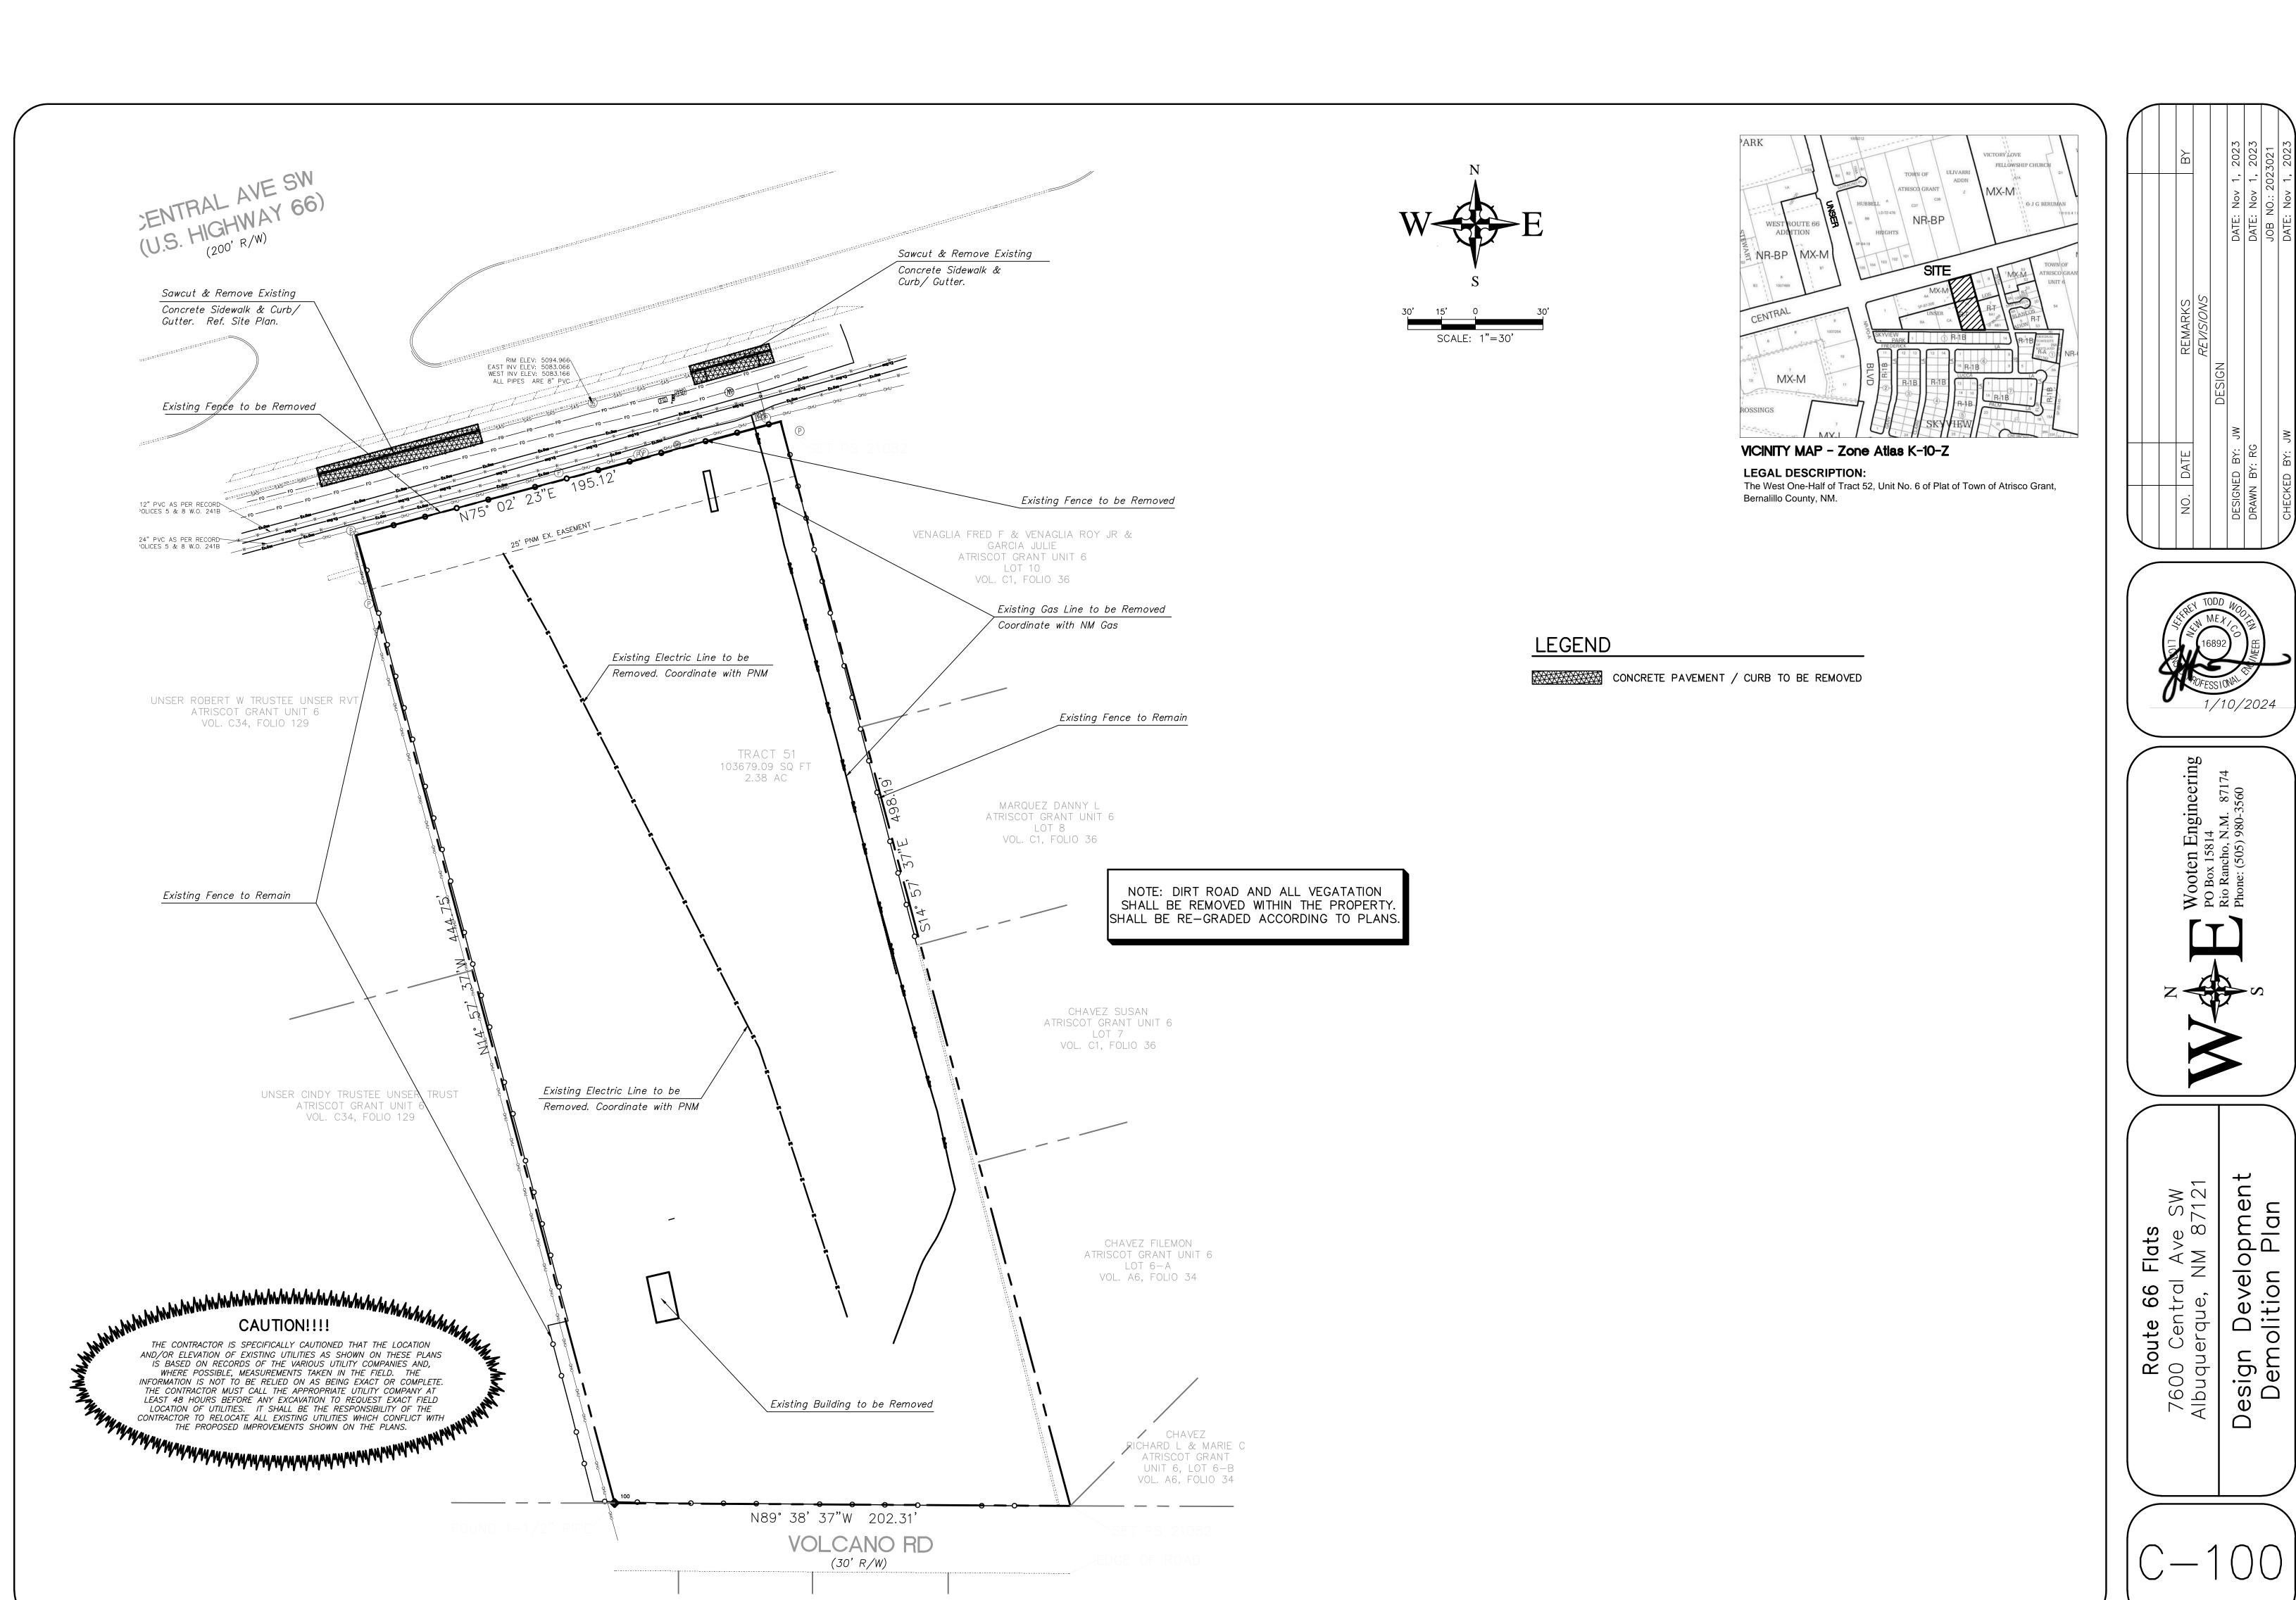

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ROUTE 66 FLATS
HIGH DESERT HOUSING
7600 CENTRAL AVE SW
ALBUQUERQUE, NEW MEXICO

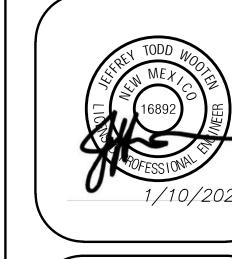
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DEMOLITION PLAN

SCALE:

C100

REVIEWED: Approver SITE PLAN SUBMITTAL PROJECT #: 21018 SHEET TITLE: SITE PLAN

C101

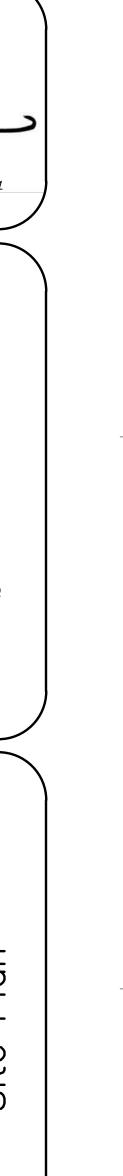

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VICINITY MAP - Zone Atlas K-10-Z **LEGAL DESCRIPTION:** The West One-Half of Tract 52, Unit No. 6 of Plat of Town of Atrisco Grant, Bernalillo County, NM.

# KEYED NOTES

EV STALLS (1 CAR REDUCTIONS PER STALL) -6 spaces

PARKING CALCULATIONS

BUILDING AREA:

DWELLING, MULTI-FAMILY

PARKING REQUIREMENTS

1.2 / UNIT 1 BEDROOM: 47 UNITS

AMENITY 3 / 1,000 SF: 3,070 SF

TRANSIT CORRIDOR (30% REDUCTIONS)

1.6 / UNIT 2 BEDROOM: 1 UNIT

PARKING REDUCTIONS

HANDICAP PARKING

BICYCLE PARKING

MOTORCYCLE PARKING

1. PROPOSED TRASH ENCLOSURE TO COMPLY WITH MINIMUM COA SOLID WASTE STANDARDS. CONTRACTOR SHALL COORDINATE WITH THE SOLID WASTE DEPARTMENT FOR THE REQUIRED INSPECTIONS DURING CONSTRUCTION. REF. ARCHITECTURAL DETAILS.

AREA (SQUARE FEET)

40 spaces 40 spaces

2 spaces 2 spaces

6 spaces 36 spaces

PROVIDED

5 spaces

+/- 36,680 SF

REQUIRED

56 spaces

1 spaces

9 spaces 66 spaces

-20 spaces


REQUIRED


2 spaces


- 2. INSTALL MEDIAN CURB/GUTTER (6" HIGH) PER COA STD DWG 2415B. GUTTER PAN SHALL BE SLOPED TO MATCH THE ADJACENT PAVEMENT.
- 3. INSTALL CONCRETE SIDEWALK PER COA STD DWG 2430. SIDEWALK CROSS SLOPE SHALL BE 2% MAX AND SLOPE AWAY FROM CURB.
- 4. INSTALL ASPHALT PAVEMENT PER GEOTECHNICAL REPORT. RECOMMENDATIONS & DETAIL ON SHEET C102.
- 5. INSTALL CONCRETE PAVEMENT PER GEOTECHNICAL REPORT. RECOMMENDATIONS & DETAIL ON SHEET C102.
- 6. INSTALL 4" WIDE PAINT STRIPES AT 45° ANGLE TO PARKING STRIPES OR DRIVEWAY, SPACED AT 1'-6" (WHITE PAINT IN PARKING LOT, BLUE PAINT IN ACCESSIBLE PARKING AREAS). MIN. TWO COATS.
- 7. PAINTED INTERNATIONAL WHEELCHAIR SYMBOL (BLUE) PER ADA STANDARDS. MIN. TWO COATS. INDICATE VAN ONLY SPACE AS SHOWN ON PLAN.
- 8. INSTALL H/C SIGNAGE PER DETAIL, SHEET C102. ADD VAN ACCESSIBLE SIGNAGE WHERE NOTED. H/C SIGN MUST INCLUDE LANGUAGE PER 66-7-352.4C NMSA 1978 "VIOLATORS ARE SUBJECT TO A FINE AND/OR TOWING." REF DETAIL ON SHEET
- 9. INSTALL 4" WIDE PAINT STRIPES (WHITE) FOR ALL PARKING SPACES. MIN. TWO
- 10. PAINT WORDS 'NO PARKING', 'VAN' & 'EV' WITH LETTERS AT LEAST ONE FOOT HIGH AND 2 INCHES WIDE. MIN. TWO COATS.
- 11. INSTALL BIKE RACK(S) PER DETAIL, SHEET C-102.
- 12. INSTALL PRE-CAST WHEEL STOP PER DETAIL, SHEET C-102.
- 13. INSTALL PARALLEL CURB RAMP PER COA STD DWGS 2440-2446. TRUNCATED DOMES SHALL BE INSTALLED PER COA STD DWG 2446.
- 14. LANDSCAPE AREA. REF. LANDSCAPE PLANS.
- 15. MOTORCYCLE PARKING; 2 SPACES. ADD PAINT LABEL (2 COATS) AND SIGNAGE PER COA CODE. SIGN DETAIL ON SHEET C102.
- 16. INSTALL STAMPED CONCRETE CROSSWALK PER DETAIL, SHEET C102.
- 17. INSTALL ELECTRIC VEHICLE CHARGING STATIONS. REF. ARCHITECTURAL PLANS FOR DETAILS.
- 18. INSTALL TRANSFORMER. REF. MEP PLANS FOR DETAILS.
- 19. NATURE TRAIL. REF. LANDSCAPE PLANS FOR DETAILS.
- 20. COMMUNITY GARDEN AREA. REF. LANDSCAPE PLANS FOR DETAILS.
- 21. BIKE STORAGE RACK. REF. ARCHITECTURAL PLANS FOR DETAILS.
- 22. NOT USED.


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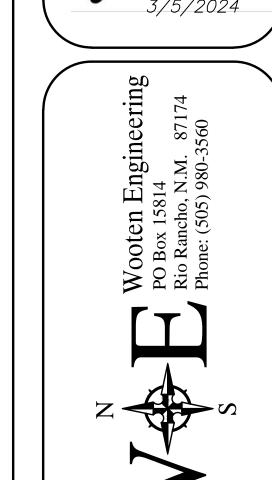
- 23. INSTALL 3' WIDE VALLEY GUTTER. DETAIL ON SHEET C102.
- 24. INSTALL 3' WIDE CONCRETE FLUME. DETAIL ON SHEET C102.
- 25. INSTALL 24" WIDE SIDEWALK CULVERT PER COA STD DWG 2236.
- 26. CLEAR SIGHT TRIANGLES (15'x590' LEFT, 15'x480' RIGHT). LANDSCAPING, FENCING, AND SIGNAGE WILL NOT INTERFERE WITH CLEAR SIGHT REQUIREMENTS. THEREFORE; SIGNS, WALLS, TREES, AND SHRUBBERY BETWEEN 3 AND 8 FEET TALL (AS MEASURED FROM THE GUTTER PAN) WILL NOT BE ACCEPTABLE IN THE CLEAR SIGHT TRIANGLE.
- 27. GARDEN WASTE & COMPOST AREA. REF. LANDSCAPE PLANS FOR DETAILS.
- 28. INSTALL ADD'L 4.5' WIDE CONCRETE SIDEWALK ADJACENT TO EXISTING SIDEWALK FOR 10' TOTAL BETWEEN EXISTING BACK OF CURB AND EDGE OF NEW SIDEWALK. SIDEWALK CROSS SLOPE SHALL BE 2% MAX TO MATCH EXISTING. SIDEWALK PER COA STD DWG 2430. INSTALL DOWELS PER CONCRETE SIDEWALK BUTT JOINT DETAIL, SHEET C102. TOOLED JOINTS SHALL MATCH EXISTING.
- 29. ADJUST EXISTING UTILITY BOXES TO GRADE IN NEW SIDEWALK AS MAY BE REQUIRED.



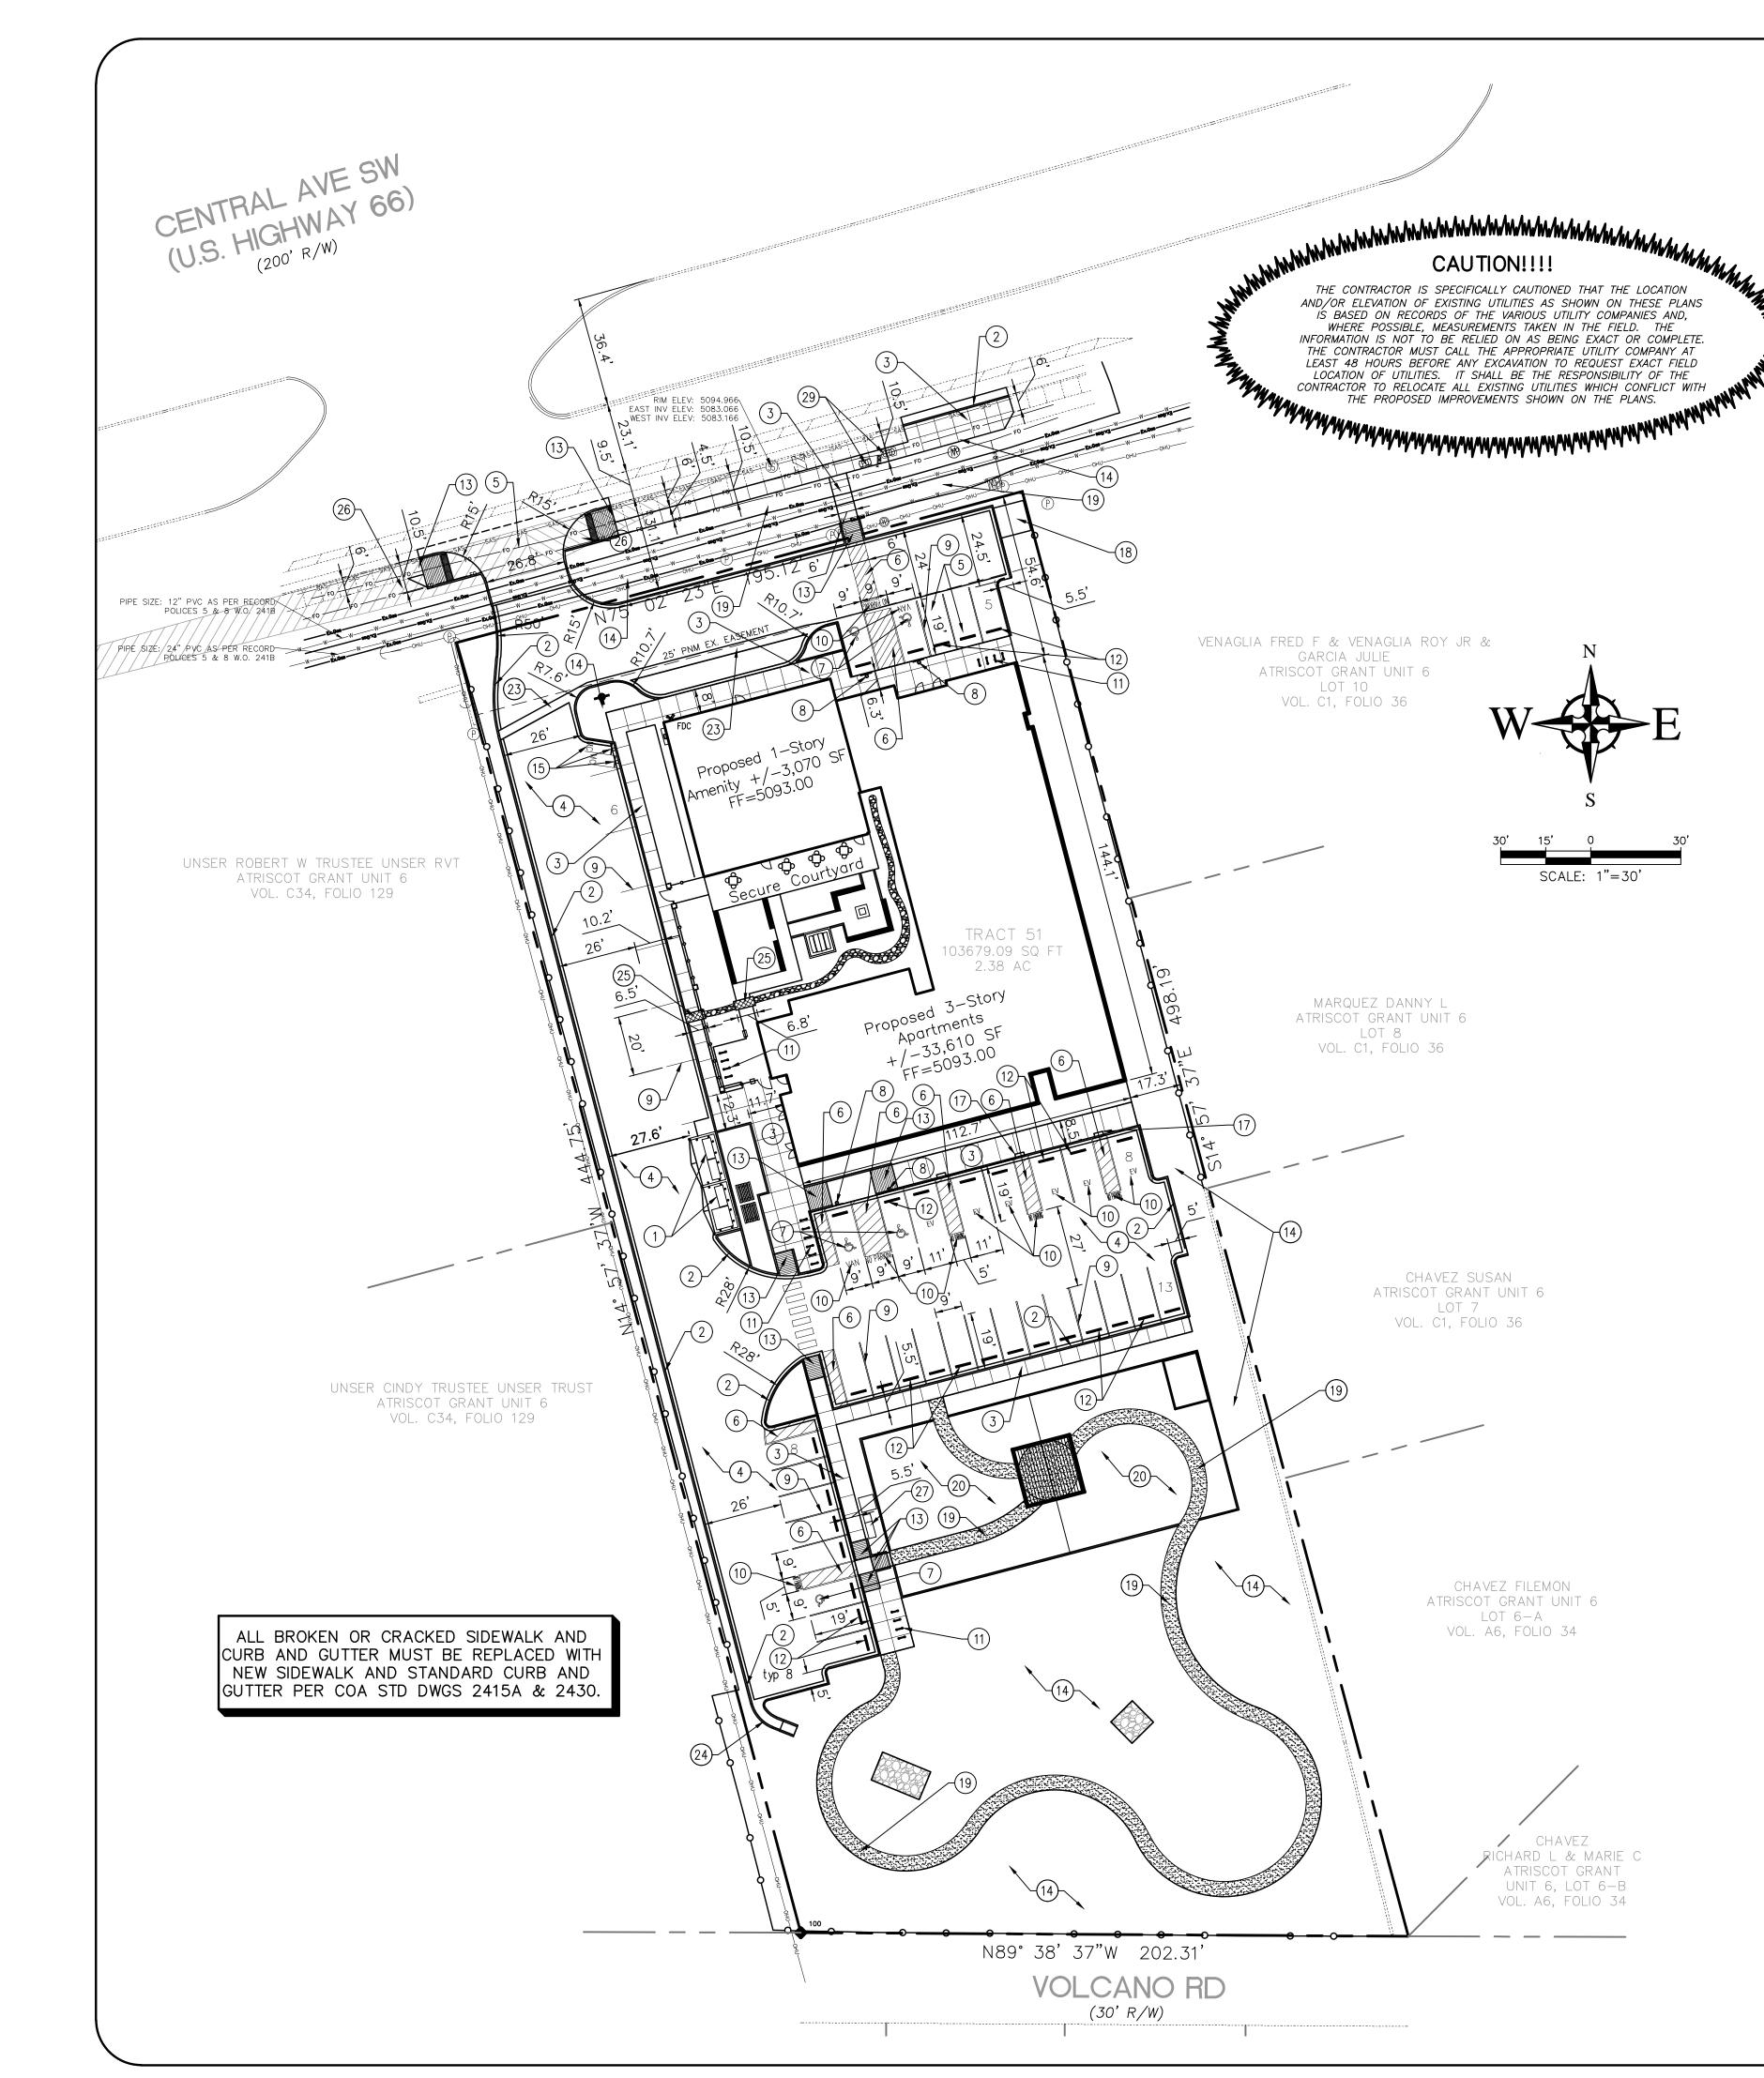

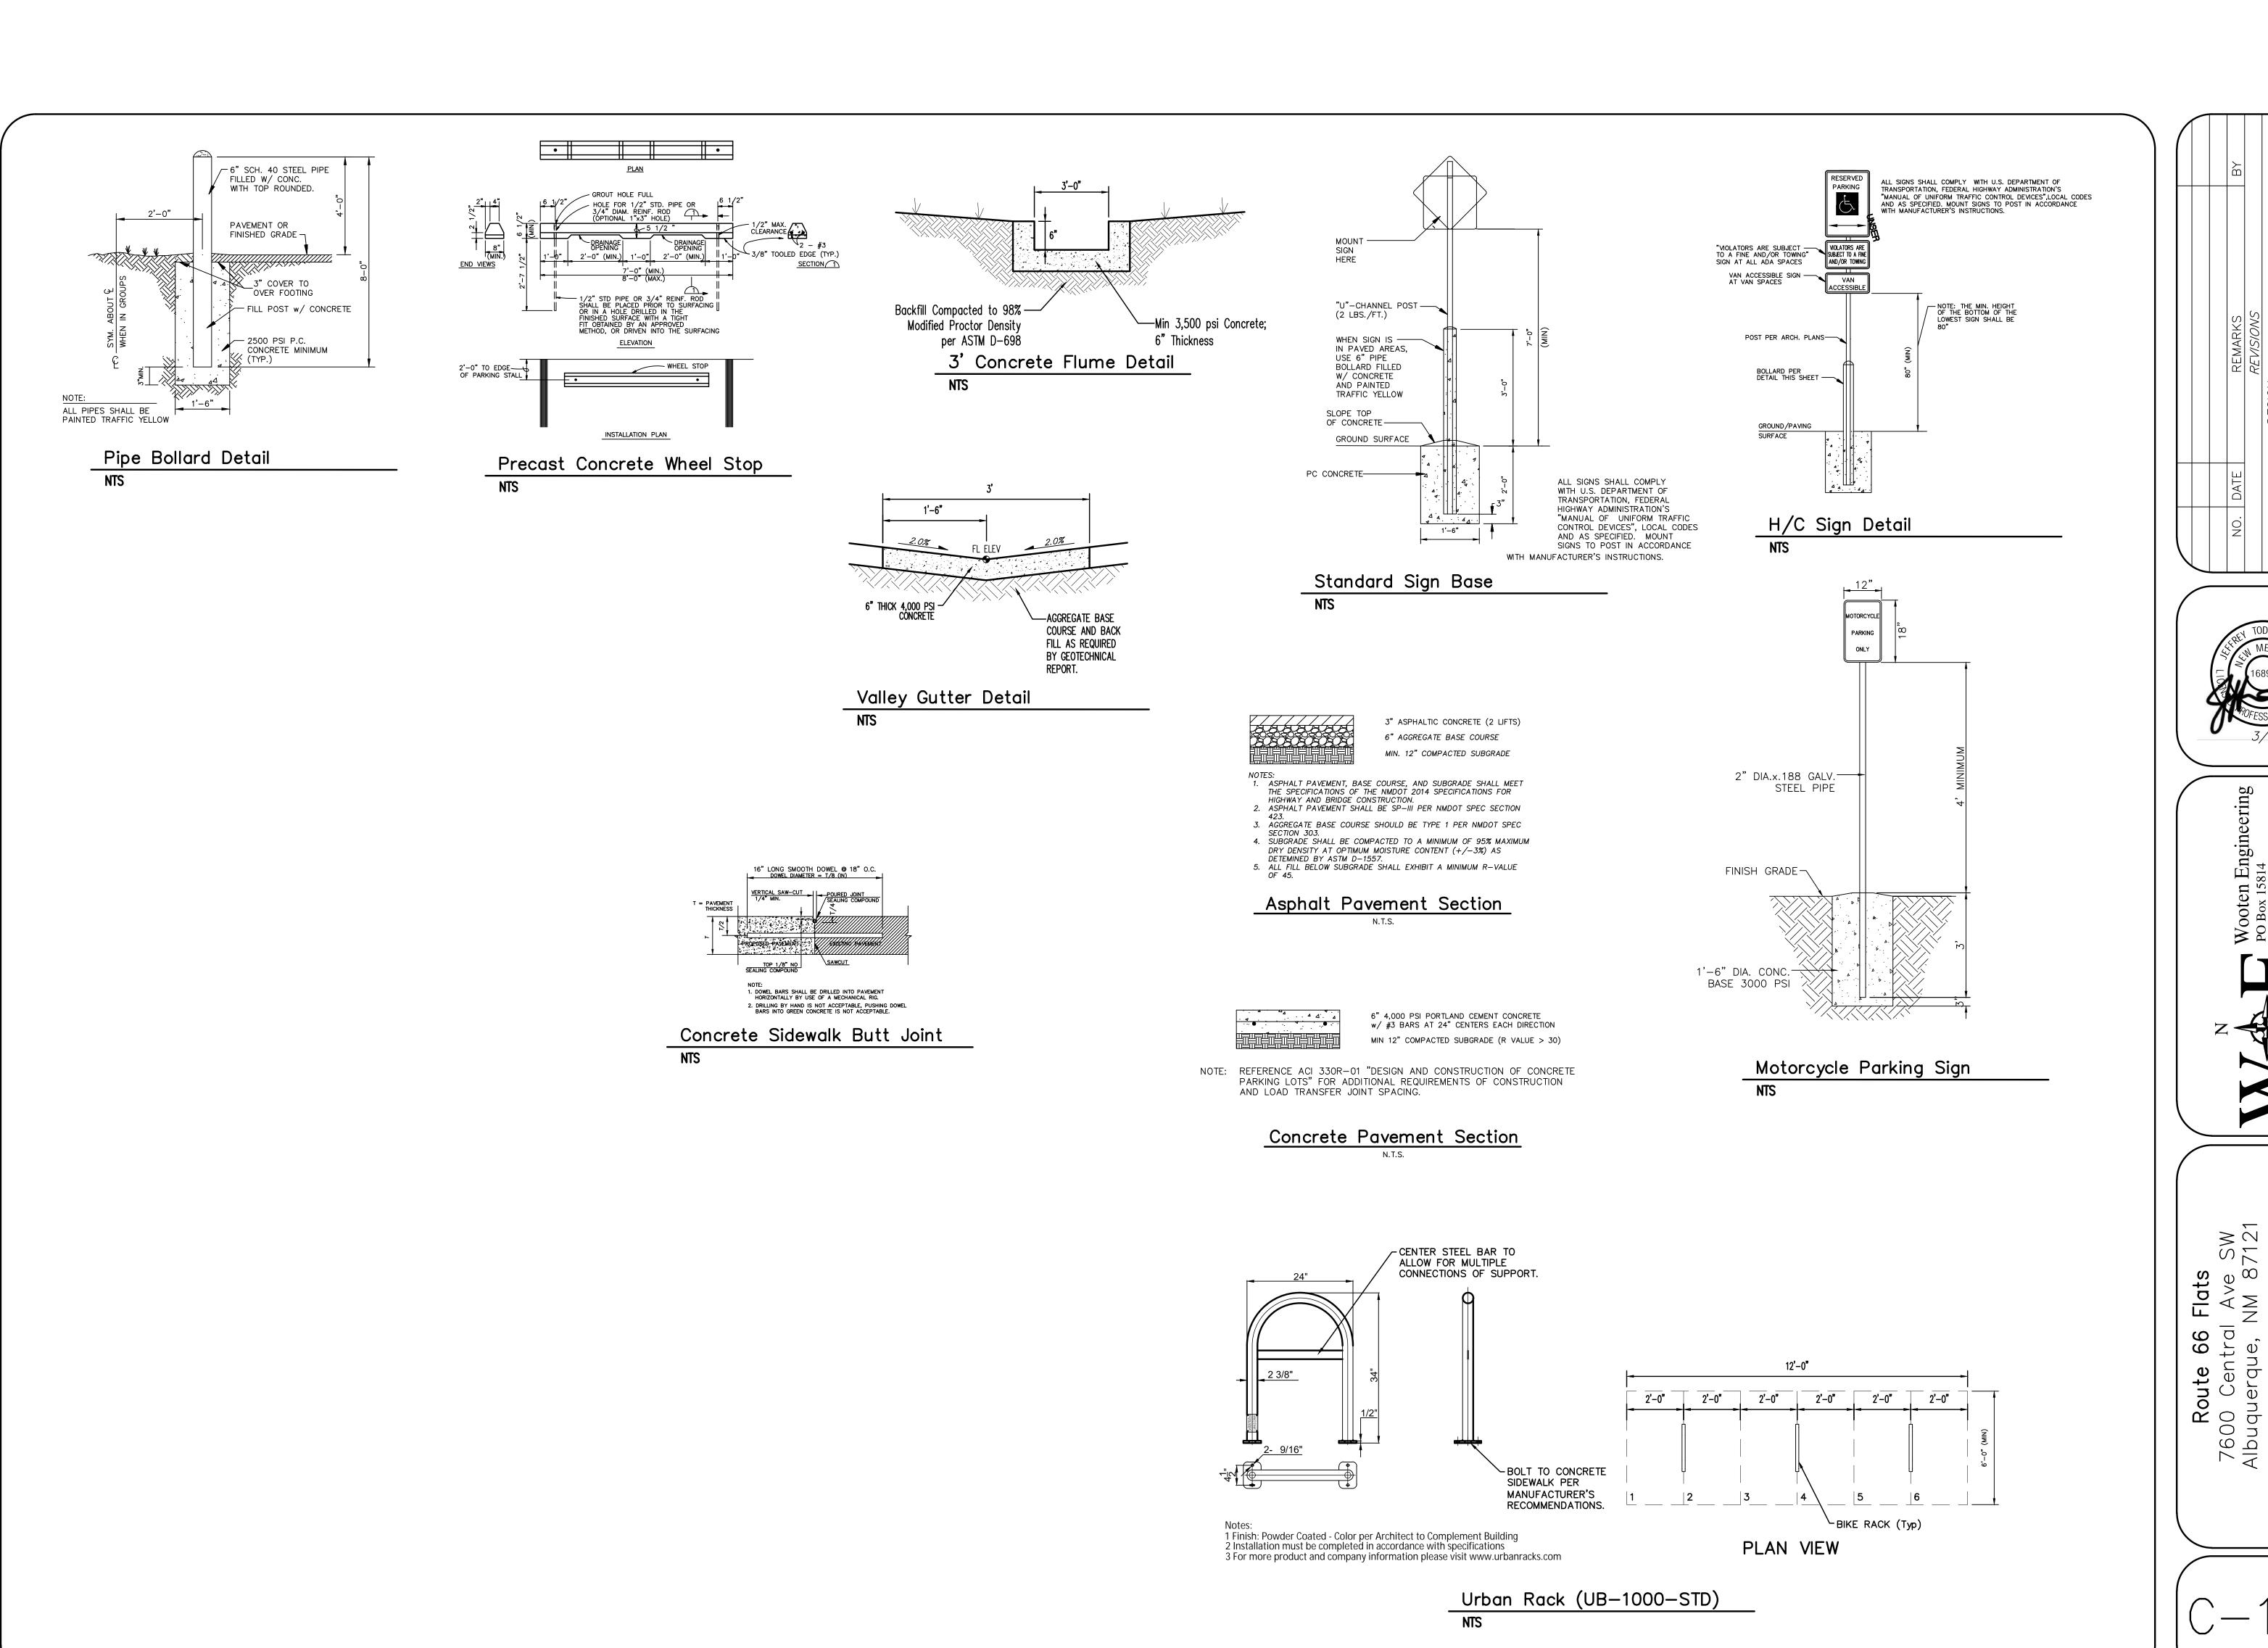

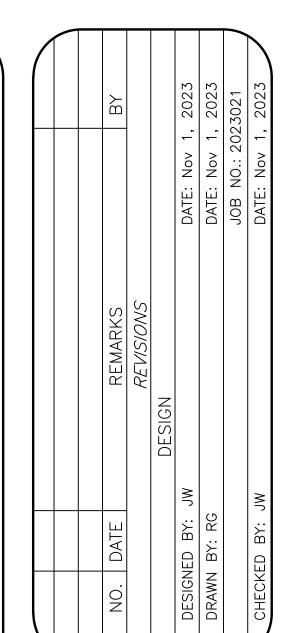

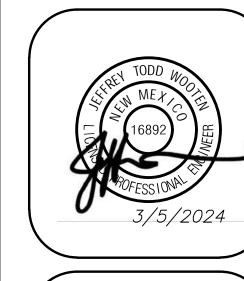


ROUTE 66 FLATS
HIGH DESERT HOUSING
7600 CENTRAL AVE SW
ALBUQUERQUE, NEW MEXICO tail ite

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> FILE:
> SHEET TITLE:
> SITE DETAILS

SCALE:

C102



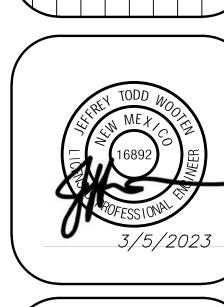

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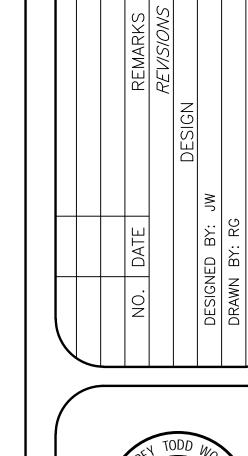
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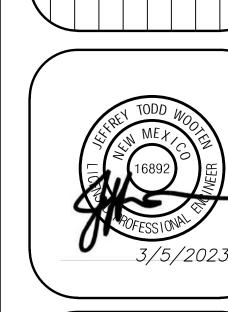
sign Gr

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understanding that this road will remain unpaved.

CONCLUSION This drainage management plan provides for grading and





FIRM MAP 35001C0328J

VICINITY MAP - Zone Atlas K-10-Z

The West One-Half of Tract 52, Unit No. 6 of Plat of Town of Atrisco Grant,

**LEGAL DESCRIPTION:** 

Bernalillo County, NM.

Per FIRM Map 35001C0328J, dated November 04, 2016, the site is not located in the Floodplain and determined to be outside the 0.2% chance Annual Floodplain.'

DRAINAGE MANAGEMENT PLAN

INTRODUCTION The purpose of this submittal is to provide a grading and drainage plan for a new multifamily project located at 7600 Central Ave SW. The site is currently undeveloped. The property consists of approximately 2.11 acres and is legally described as the West 1/2 of Tract 52, Unit No 6, Town of Atrisco Grant.


EXISTING HYDROLOGIC CONDITIONS The site currently slopes from north to south into minor low areas that pond. The drainage either infiltrates into the existing sandy soils or drains to the east into the Volcano Road Right-of-Way. Volcano Rd is not paved and it is our

PROPOSED HYDROLOGIC CONDITIONS The proposed site will drain into a new retention pond located on the south side of the property. Per the Calculations Table this sheet, the site generates 12,928 CF of drainage during the 100-Yr, 6-Hr Storm. 23,570 CF of volume is provided in the proposed pond, which should discharge in approximately 7 hours via percolation into the soil.\*\*

drainage elements which are capable of safely passing the 100 year storm and meets city requirements. The proposed improvements for the site should not have any negative impacts to facilities downstream. With this submittal, we are requesting approval of both Grading Permit and Building Permit.

		Exis	ting Dr	ainage (	Calcula	ations							
This	table is based on t	he COA DPM	Chapter 6.2	2 (A), Zone:	1								
BASIN	Area	Land	Treatment P	ercentages	(%)	Weighted C	Tc	I (100)	Q(100)	Q(100)	WTE	V(100) <sub>380</sub>	V(100) <sub>10day</sub>
	(AC.)	Α	В	С	D		(min)	(in/hr)	(cfs/ac.)	(CFS)	(inches)	(CF)	(CF)
SITE	2.11	0.0	0.0	100.0	0.0	0.63	12.00	2.87	1.81	3.82	0.95	7276	7276
TOTAL	2.11									3.82		7276	7276
		Prop	osed Di	rainage	Calcul	ations							
		Ultim ate	Deve lopme	ent Conditio	ns Basin	Data Table							
This	table is based on	the COA DPM	Chapter 6.	2(A), Zone:	1								
BASIN	Area	Land	Treatment F	ercentages	(%)	Weighted C	Tc	I (100)	Q(100)	Q(100)	WTE	V(100) <sub>380</sub>	V(100) <sub>10day</sub>
	(AC.)	A	В	С	D		(m in)	(in/hr)	(cfs/ac.)	(CFS)	(inches)	(CF)	(CF)
SITE	2.11	0.0	0.0	42.8	57.2	0.78	12.00	3.59	2.81	5.93	1.69	12928**	19368
TOTAL	2.11									5.93		12928	19368

DRAIN AT A RATE OF 9 MINUTES PER INCH. THIS EQUATES TO 6.67 INCHES PER HOUR. THE POND BOTTOM IS 1,920 SF WHICH MEANS THAT THE POND CAN DRAIN 1,067CF/HR (25,613 CF/DAY).SINCE THE 100 YR — 6 HR STORM VOLUME FOR BASIN A IS 2,553 CF, THE POND SHOULD BE ABLE TO COMPLETELY DRAIN IN JUST OVER 7

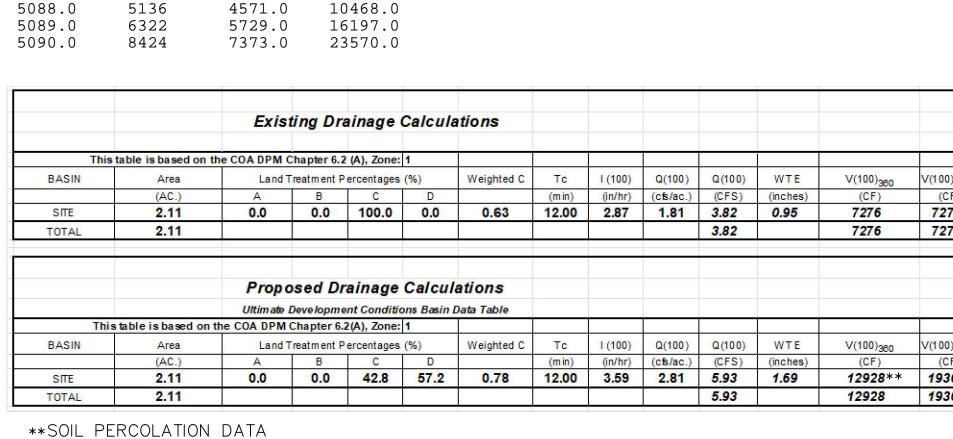

<u>LEGEND</u>

27.8 PROPOSED TOP OF GRADE/PVMT ELEVATIONS

FL27.8 PROPOSED FLOW LINE/GUTTER ELEVATIONS

TC27.8 PROPOSED TOP OF CURB ELEVATIONS

FGL27.8 PROPOSED GRADE AT BOTTOM OF WALL

FGH27.8 PROPOSED GRADE AT TOP OF WALL

FLOW ARROW

\_\_ \_ 515\_\_ \_ EXISTING CONTOUR

\_ \_ \_ RIDGE LINE

GRADING NOTES

SHOWN OTHERWISE.

EXISTING STORM DRAIN

1. EXCEPT AS PROVIDED HEREIN, GRADING SHALL BE PERFORMED AT THE ELEVATIONS AND IN ACCORDANCE WITH THE DETAILS SHOWN ON THIS PLAN.

2. THE COST FOR REQUIRED CONSTRUCTION DUST AND EROSION CONTROL MEASURES SHALL BE INCIDENTAL TO THE PROJECT COST.

ALL WORK RELATIVE TO FOUNDATION CONSTRUCTION, SITE PREPARATION, AND

PAVEMENT INSTALLATION, AS SHOWN ON THIS PLAN, SHALL BE CONSTRUCTED IN

ACCORDANCE WITH THE "GEOTECHNICAL INVESTIGATION," AS PROVIDED BY THE ARCHITECT OR OWNER. ALL OTHER WORK SHALL, UNLESS OTHERWISE STATED OR PROVIDED FOR HEREON, BE CONSTRUCTED IN ACCORDANCE WITH THE PROJECT,

(FIRST PRIORITY) SPECIFICATIONS, AND/OR THE CITY OF ALBUQUERQUE (COA)

4. EARTH SLOPES SHALL NOT EXCEED 3 HORIZONTAL TO 1 VERTICAL UNLESS

5. IT IS THE INTENT OF THESE PLANS THAT THIS CONTRACTOR SHALL NOT

7. A DISPOSAL SITE FOR ANY & ALL EXCESS EXCAVATION MATERIAL, AND UNSUITABLE MATERIAL AND/OR A BORROW SITE CONTAINING ACCEPTABLE FILL MATERIAL SHALL BE OBTAINED BY THE CONTRACTOR IN COMPLIANCE WITH

PERFORM ANY WORK OUTSIDE OF THE PROPERTY BOUNDARIES EXCEPT AS REQUIRED

6. THE CONTRACTOR IS TO ENSURE THAT NO SOIL ERODES FROM THE SITE ONTO ADJACENT PROPERTY OR PUBLIC RIGHT—OF—WAY. THIS SHOULD BE ACHIEVED BY CONSTRUCTING TEMPORARY BERMS OR SILT FENCE AT THE PROPERTY LINES AND

APPLICABLE ENVIRONMENTAL REGULATIONS AND APPROVED BY THE OBSERVER. ALL

COSTS INCURRED IN OBTAINING A DISPOSAL OR BORROW SITE AND HAUL TO OR FROM SHALL BE CONSIDERED INCIDENTAL TO THE PROJECT AND NO SEPARATE

8. PAVING AND ROADWAY GRADES SHALL BE +/- 0.05' FROM PLAN ELEVATIONS.

9. ALL PROPOSED CONTOURS AND SPOT ELEVATIONS REFLECT TOP OF PAVEMENT ELEVATIONS IN THE PARKING AREA AND MUST BE ADJUSTED FOR PAVEMENT,

10. VERIFY ALL ELEVATIONS SHOWN ON PLAN FROM BASIS OF ELEVATION CONTROL

11. THE CONTRACTOR SHALL PROVIDE THE SWPPP DOCUMENT (IF NECESSARY) AND SHALL ABIDE BY ALL LOCAL, STATE, AND FEDERAL LAWS, RULES AND REGULATIONS WHICH APPLY TO THE CONSTRUCTION OF THESE IMPROVEMENTS, INCLUDING EPA

STORMWATER QUALITY VOLUME CALCULATION

SWQ VOLUME REQ'D = 52,616\*0.42" / 12 = 1.842 CF

Volume

2427.0

3470.0

\_\_\_\_\_

(cu-ft) (cu-ft)

Volume Sum

2427.0

5897.0

0.0

PAD ELEVATION SHALL BE +/- 0.05' FROM BUILDING PLAN ELEVATION.

STATION (IF APPLICABLE) PRIOR TO BEGINNING CONSTRUCTION.

REQUIREMENTS WITH RESPECT TO STORM WATER DISCHARGE.

IMPERVIOUS AREA CALCULATIONS

PERVIOUS AREA: 39,379 SF (42.80%)

IMPERVIOUS AREA: 52,616 SF (57.20%)

TOTAL IMPERVIOUS AREA = 52,616 SF

TOTAL VOLUME PROVIDED = 23.570 CF

Pond Volume Calculations

1920

2934

4006

(ft) (sq.ft)

Elevation Area

5085.0

5086.0

5087.0

PROPOSED SITE CONDITIONS

TOTAL SITE AREA: 91,995 SF

STANDARD SPECIFICATIONS FOR PUBLIC WORKS (SECOND PRIORITY).

WETTING THE SOIL TO PROTECT IT FROM WIND EROSION.

MEASUREMENT OR PAYMENT SHALL BE MADE.

5

Install 24" Nyloplast Drain

Top Dome=5092.00

Inv=5087.90

N89° 38′ 37″W 202.31′

VOLCANO RD

(30' R/W)

ZE: 12" PVC AS PER RECORD POLICES 5 & 8 W.O. 241B

ZE: 24" PVC AS PER RECORD POLICES 5 & 8 W.O. 241B

ALLEINOLITICALI ELEMANIMANIMANIA

THE CONTRACTOR IS SPECIFICALLY CAUTIONED THAT THE LOCATION

AND/OR ELEVATION OF EXISTING UTILITIES AS SHOWN ON THESE PLANS

IS BASED ON RECORDS OF THE VARIOUS UTILITY COMPANIES AND,

WHERE POSSIBLE, MEASUREMENTS TAKEN IN THE FIELD. THE INFORMATION IS NOT TO BE RELIED ON AS BEING EXACT OR COMPLETE. THE CONTRACTOR MUST CALL THE APPROPRIATE UTILITY COMPANY AT

LEAST 48 HOURS BEFORE ANY EXCAVATION TO REQUEST EXACT FIELD

LOCATION OF UTILITIES. IT SHALL BE THE RESPONSIBILITY OF THE
CONTRACTOR TO RELOCATE ALL EXISTING UTILITIES WHICH CONFLICT WITH
THE PROPOSED IMPROVEMENTS SHOWN ON THE PLANS.

·Curb (Beyond

Typical Flume Cross Section

CONTRACTOR I. THE PROPOSED IMIL...

UNSER ROBERT W TRUSTEE UNSER RVT

ATRISCOT GRANT UNIT 6

VOL. C34, FOLIO 129

Install 24" Sidewalk Culvert

(2) per COA Std Dwg 2236.

UNSER CINDY TRUSTEE UNSER TRUST

ATRISCOT GRANT UNIT 6

VOL. C34, FOLIO 129

└\_3"-6" Fractured Rip-Rap

(9" Mat) over LS Fabric.

FL91.95

Install 20 SY 3"-6" Fractured

Rip-Rap over Landscape Fabric. Ref Landscape Plan.

Basin w/ Locking 24" Dome Grate. Top Inlet=5091.50

> Install 24" Nyloplast Drain Basin w/ Locking 24" Dome Grate. Top Inlet=5089.90

> > Install 24" Nyloplast Drain

Top Dome=5090.10

Inv=5086.20

Basin w/ Locking 24" Dome Grate. Top Inlet=5089.60

Top Dome=5090.40

Inv=5086.55

VENAGLIA FRED F & VENAGLIA ROY JR &

GARCIA JULIE

ATRISCOT GRANT UNIT 6

VOL. C1, FOLIO 36

MARQUEZ DANNY L

ATRISCOT GRANT UNIT 6

VOL. C1, FOLIO 36

Install 24" Nyloplast Drain

Top Dome=5089.50

Inv=5085.65

Basin w/ Locking 24" Dome Grate. Top Inlet=5089.00

CHAVEZ SUSAN

ATRISCOT GRANT UNIT 6

VOL. C1, FOLIO 36

NOTE THAT ALL NYLOPLAS

DRAIN BASINS REQUIRE AN

CHAVEZ FILEMON ATRISCOT GRANT UNIT 6 LOT 6-A

VOL. A6, FOLIO 34

PICHARD L & MARIE C

ATRISCOT GRANT

VOL. A6, FOLIO 34

UNIT 6, LOT 6-B

ADDITIONAL DEPTH OF 6

INCHES FOR THE SUMP.

Install 10 SY 3"-6" Fractured Rip-Rap over Landscape Fabric. Ref Landscape Plan

Install 24" Nyloplast Drain

Basin w/ Locking 24" Dome

Grate. Top Inlet=5088.00

Top Dome=5088.50

Inv=5085.30

PER PERCOLATION TESTS CONDUCTED BY GEO-TEST, INC. (PATRICK WHORTON, PE), THE SOILS AT THE SOUTH POND

300 CENTRAL BUQUERQUE

DRAWN: Author REVIEWED: Approver SITE PLAN SUBMITTAL PROJECT #: 21018 FILE: SHEET TITLE:

GRADING PLAN

SCALE:


C200




DRAWN: Author REVIEWED: Approver SITE PLAN SUBMITTAL PROJECT #: 21018

FILE: SHEET TITLE: UTILITY PLAN

SCALE:

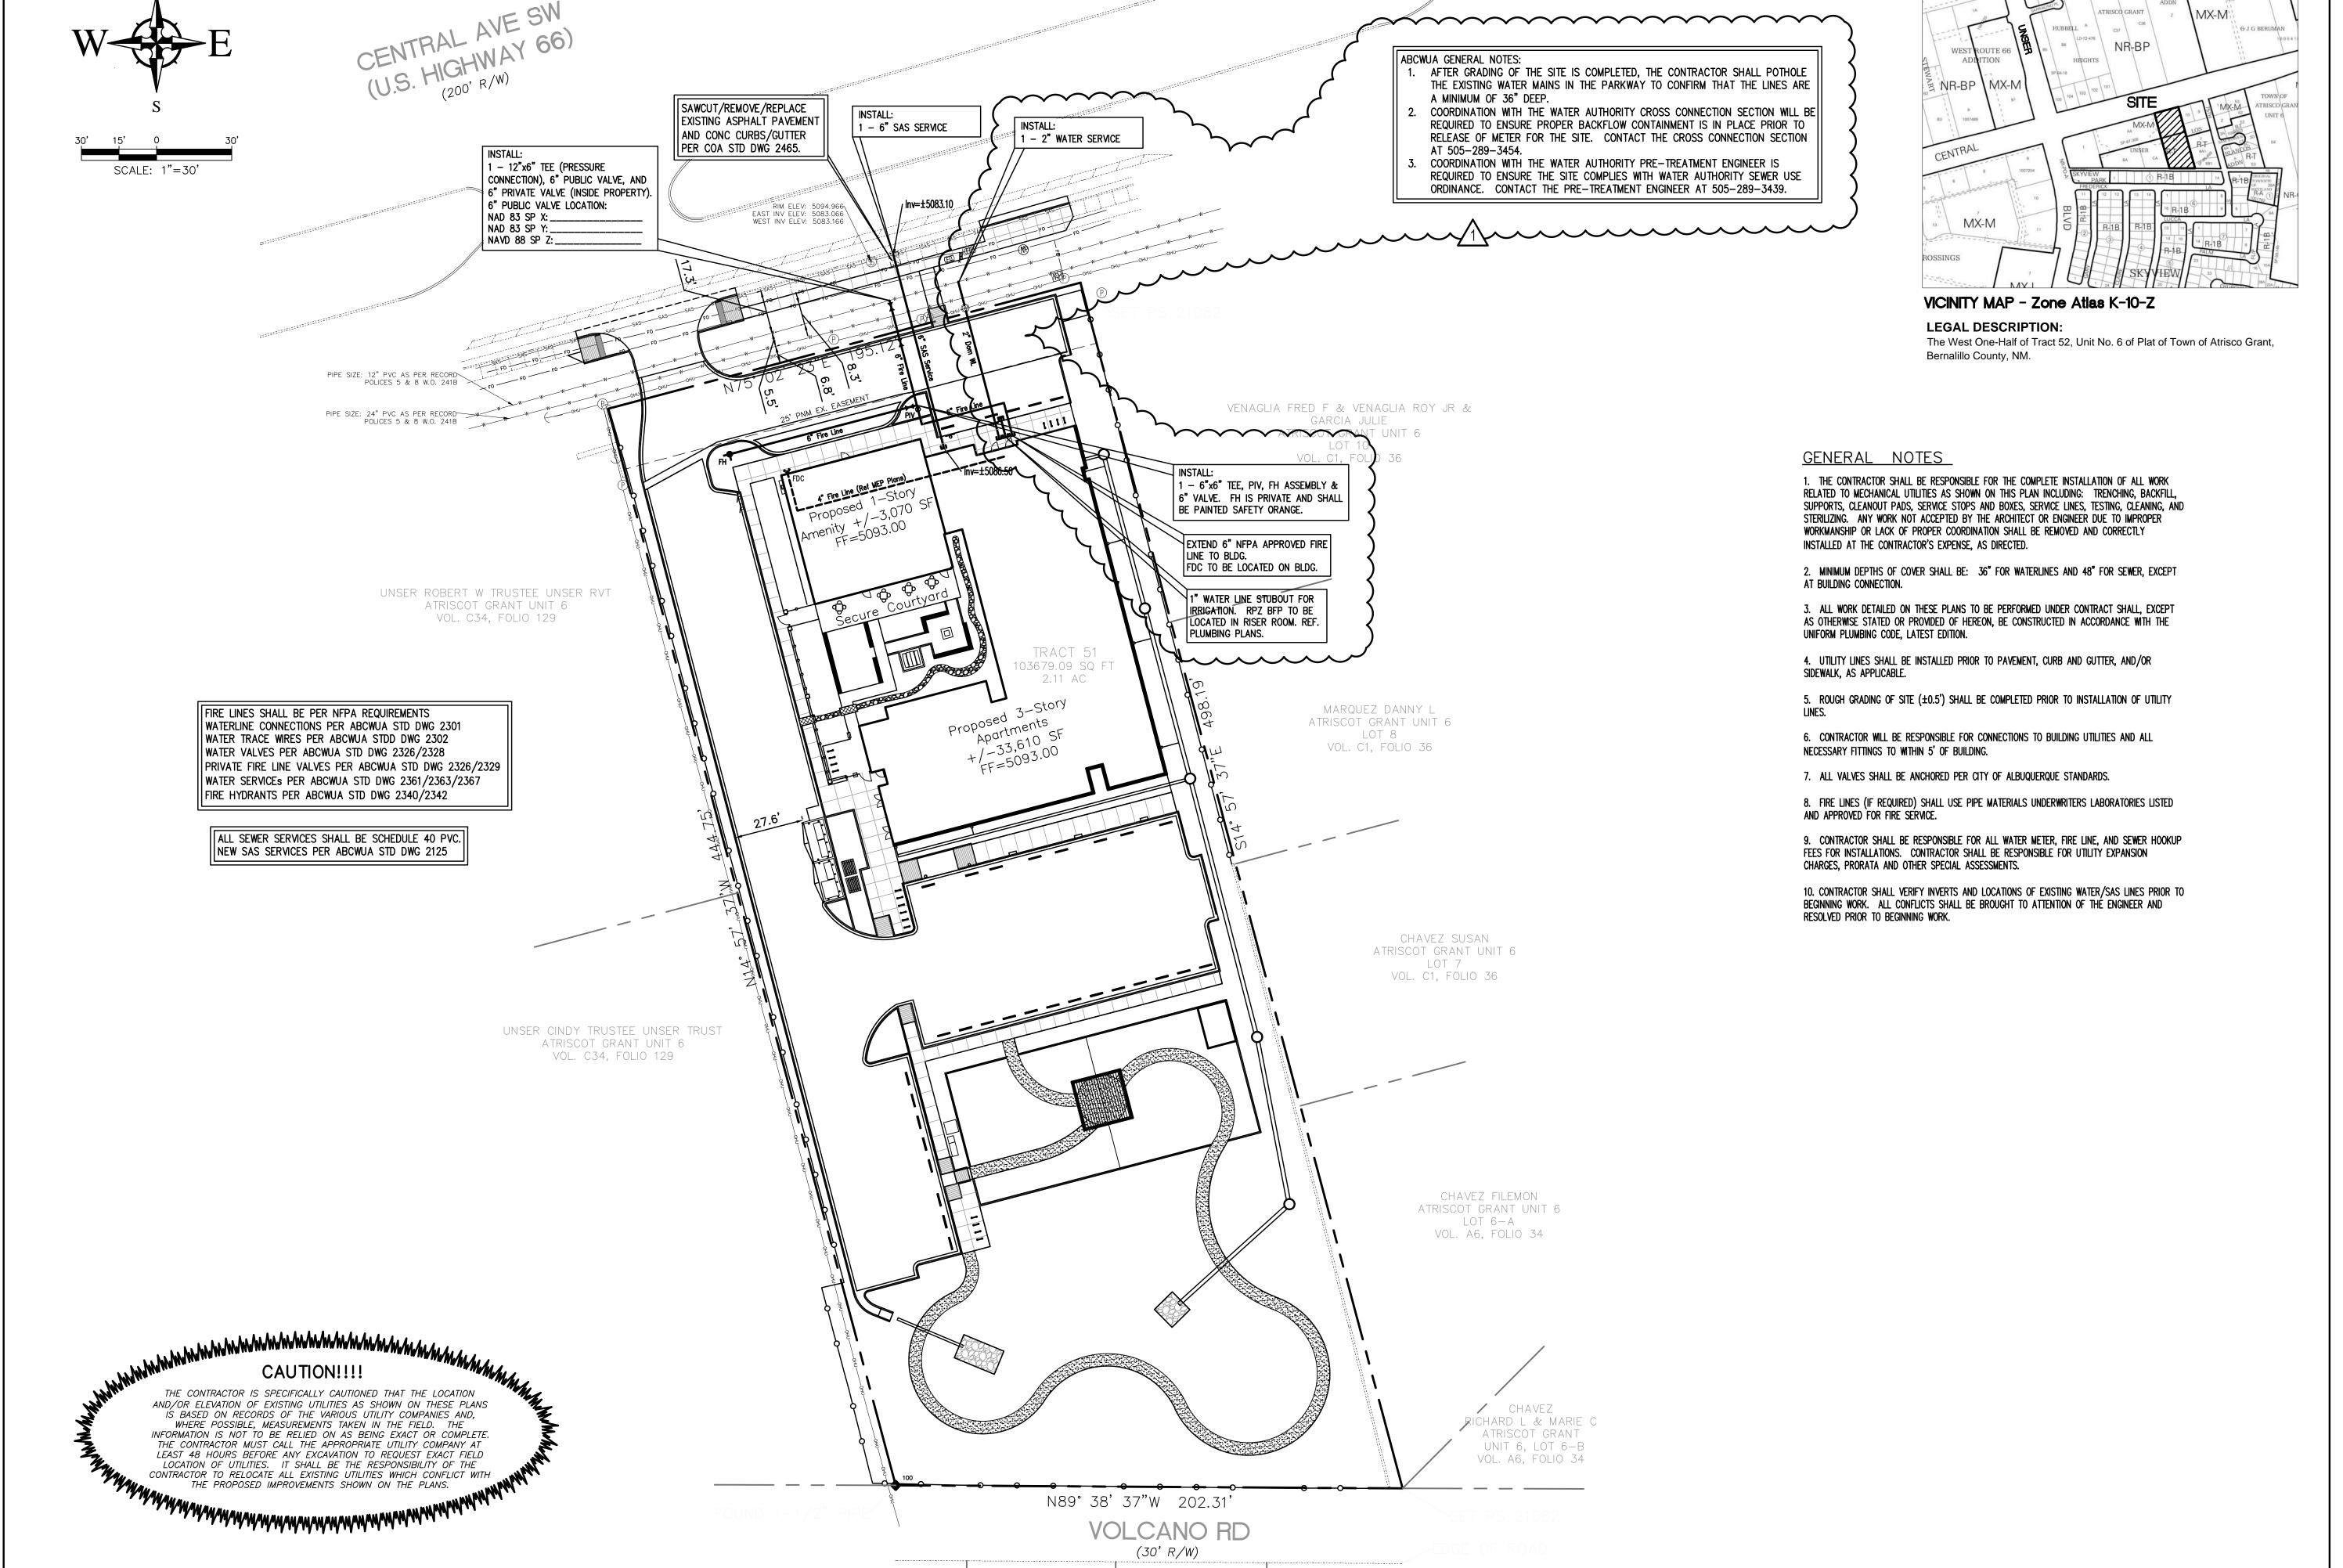

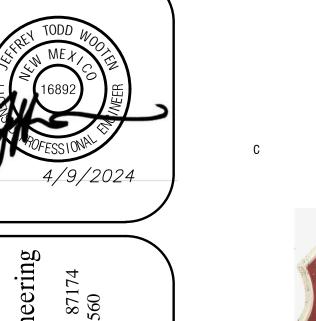

elopm Plan **66** tral **ute** Cen


Rol 7600 Albuque Design

**SOLID WASTE CALCS:** 48 UNITS  $\times$  0.55 = 26 CUBIC YARDS


RECYCLING CALCS: 48 UNITS X 0.12 = 6 CUBIC YARDS

• RECYCLING CONTAINERS LOCATED ADJACENT TO THE REFUSE **ENCLOSURE** 


- NO DEVELOPMENT GATES
- DUMPSTERS LOCATED AT SAME LEVEL AS DRIVE
- NO TRASH COMPACTOR
- NO TRASH CHUTES
- NO OVERHEAD CLEARANCE RESTRICTIONS (MIN 14'-2" AT ACCESS, MIN 30' AT SERVICE)
- PROJECT WILL NOT ALTER EXISTING TRASH SERVICE FOR THE
- SURROUNDING BUSINESSES DURING CONSTRUCTION
- ACCESS TO REFUSE ALONG FIRE LANE, AMPLE TURN AROUND SPACE
- TRASH ENCLOSURES SIZED PER CITY REQUIREMENTS
- DUMPSTERS INCLUDE LIDS

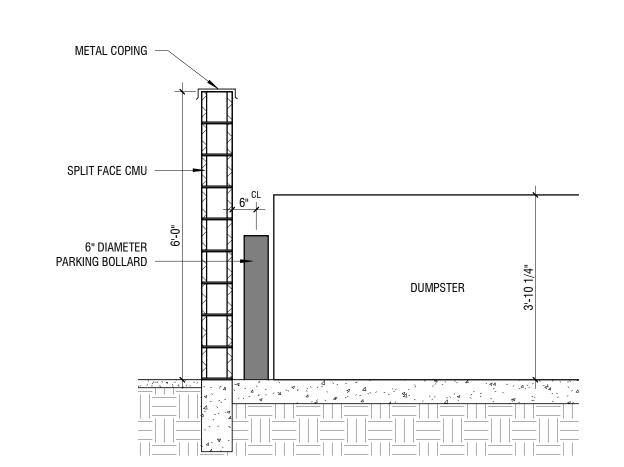


TRASH ENCLOSURE WALL SECTION

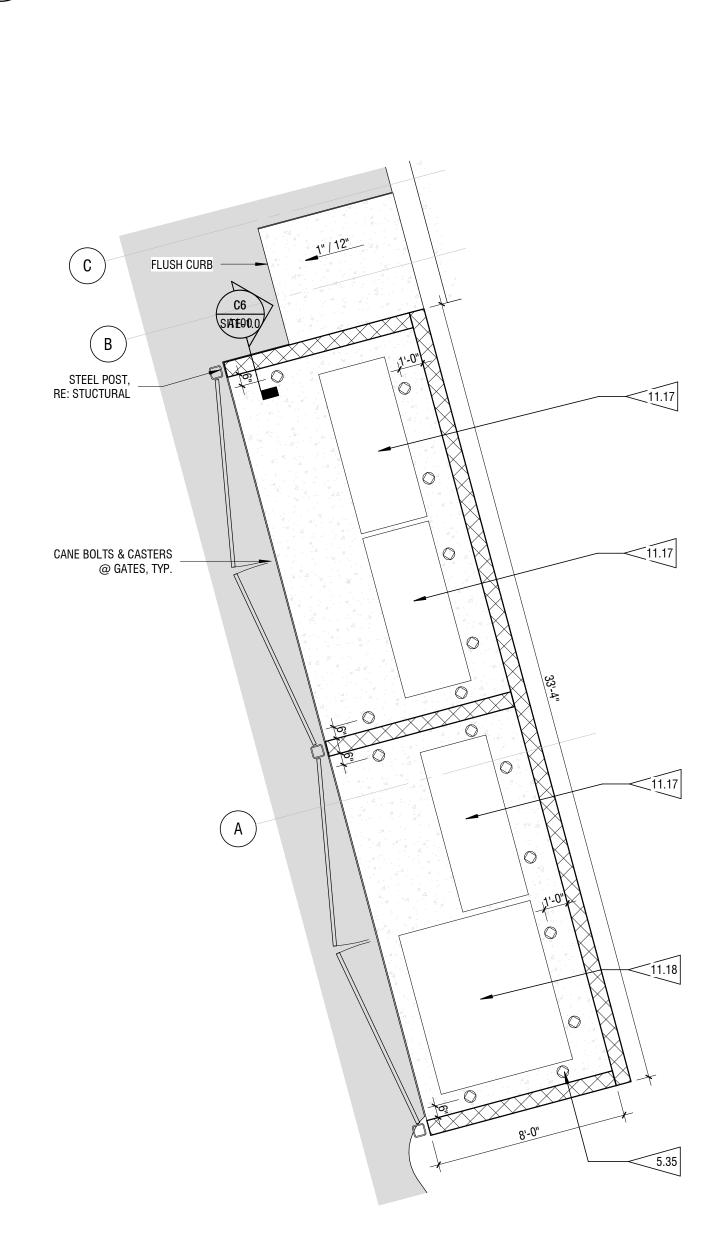



TRASH ENCLOSURE ENLARGED PLAN

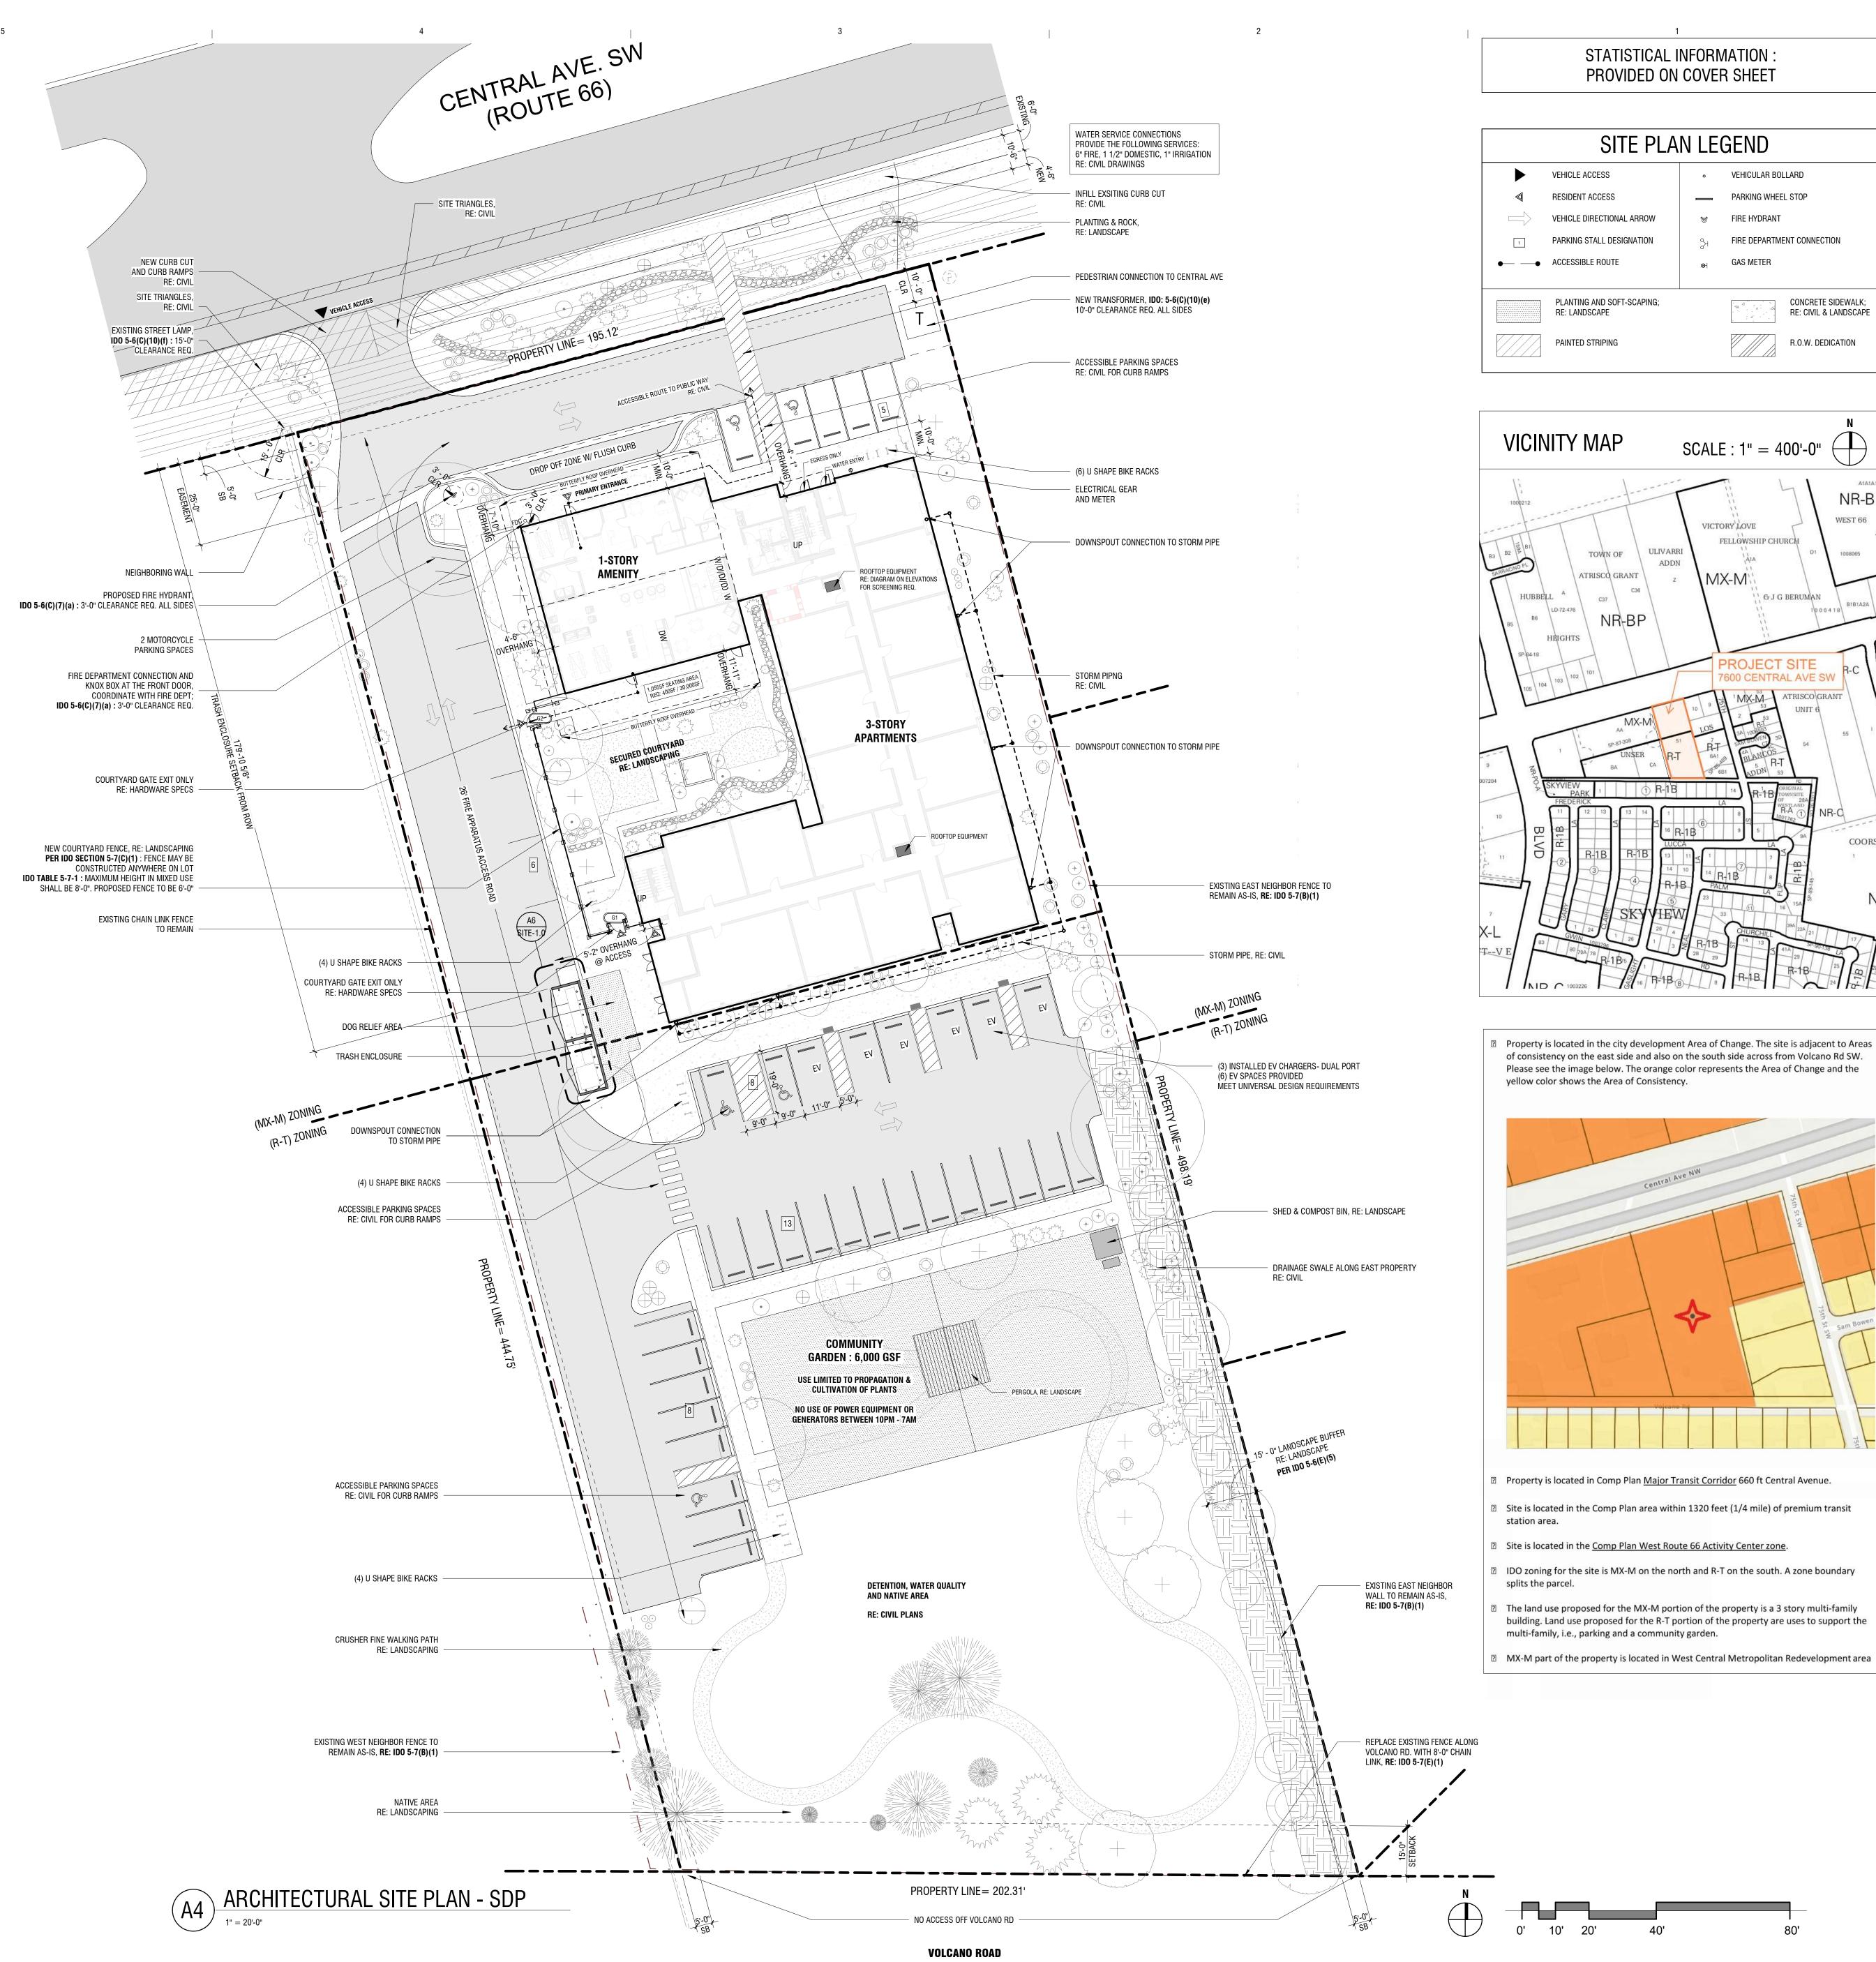

STATISTICAL INFORMATION PROVIDED ON COVER SHEET

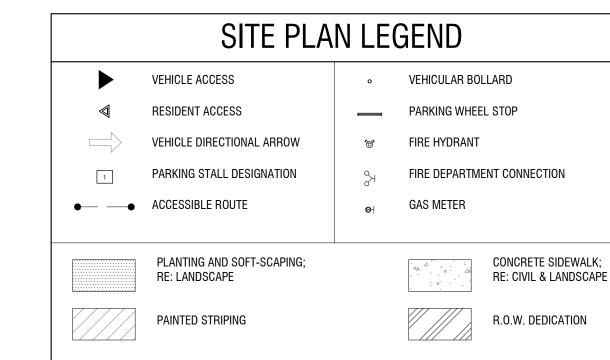

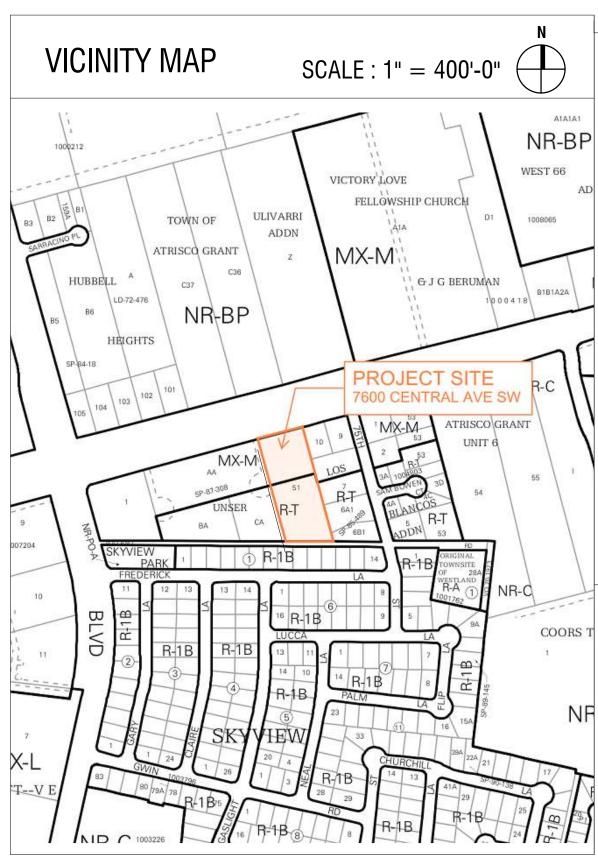

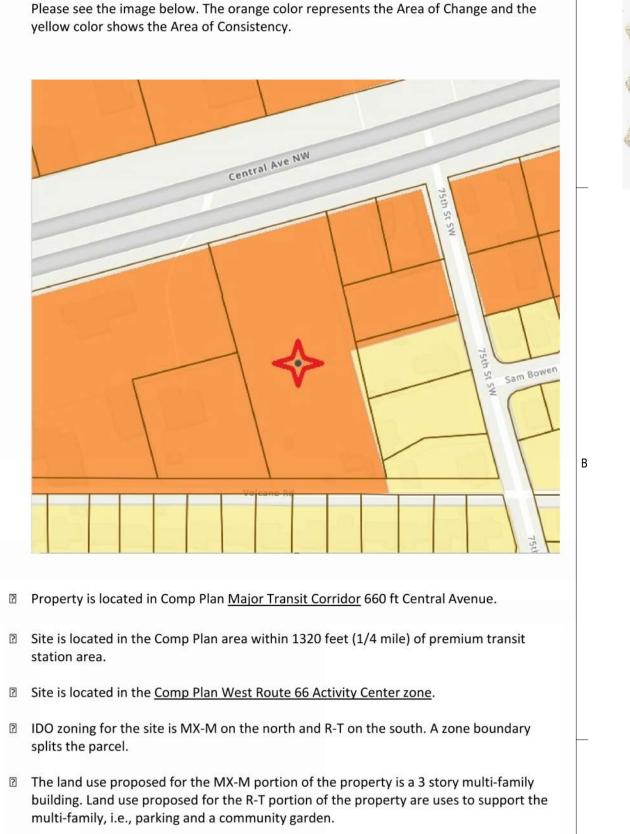



CHAD H. HOLTZINGER NO. 6016

REVIEWED: EP SHEET TITLE: ARCHITECTURAL SITE PLAN

SITE-1.0

### **GENERAL NOTES**

- 1. A KICK-OFF MEETING WITH THE LANDSCAPE ARCHITECT IS REQUIRED PRIOR TO BEGINNING ANY SITE OR LANDSCAPE WORK.
- 2. OBTAIN NECESSARY PERMITS FROM ALL JURISDICTIONS AS REQUIRED TO CONSTRUCT THE WORK OF THIS PROJECT. ALL WORK SHALL BE PERFORMED IN ACCORDANCE WITH PLANS APPROVED BY CITY OF ALBUQUERQUE.
- 3. REFER TO SURVEY DRAWINGS AND OTHER AVAILABLE DOCUMENTS FOR PROPERTY LIMITS, EXISTING CONDITIONS, AND HORIZONTAL AND VERTICAL CONTROL.
- 4. PROVIDE AND MAINTAIN UTILITY LOCATES DURING ALL PHASES OF WORK. DO NOT DAMAGE UTILITY LINES/STRUCTURES. NOTIFY OWNER'S REPRESENTATIVE OF ANY DISCREPANCIES BEFORE STARTING ANY WORK. CONTRACTOR SHALL BE RESPONSIBLE FOR LOCATION OF UNDERGROUND UTILITIES OR STRUCTURES, WHETHER OR NOT SHOWN OR DETAILED AND INSTALLED BY ANY OTHER CONTRACT.
- 5. RESTORATION OF UTILITIES DAMAGED BY THE CONTRACTOR SHALL BE AT THE CONTRACTOR'S EXPENSE.
- 6. THOROUGHLY REVIEW AND DOCUMENT THE SITE CONDITIONS PRIOR TO CONSTRUCTION.
- 7. THOROUGHLY REVIEW DRAWINGS, AND TECHNICAL SPECIFICATIONS AND NOTIFY OWNER'S REPRESENTATIVE OF ANY DISCREPANCIES PRIOR TO CONSTRUCTION.
- 8. CONSTRUCTION INSTALLATION, MATERIALS, TESTING, AND INSPECTION SHALL COMPLY WITH APPLICABLE CODES AND ORDINANCES.
- 9. TAKE NECESSARY STEPS TO PROTECT AND MAINTAIN ALL FINISHED WORK FOR THE DURATION OF THE CONTRACT UNTIL FINAL ACCEPTANCE.
- 10. CONTRACTOR SHALL PROVIDE ALL MOCK-UPS, SUBMITTALS AND SHOP DRAWINGS FOR APPROVAL PER SPECIFICATIONS PRIOR TO CONSTRUCTION.
- 11. THE WORK OF THIS CONTRACT WILL NOT BE CONSIDERED COMPLETE UNTIL ALL AREAS HAVE BEEN CLEANED OF ALL DIRT AND DEBRIS AND ALL DAMAGED ITEMS ARE REPAIRED.
- 12. UNLESS OTHERWISE NOTED, EXISTING TREES WITHIN THE LIMIT OF WORK TO BE PROTECTED. VEHICLES, EQUIPMENT AND MATERIALS SHOULD NOT INTERFERE WITH THE LIMITS OF THE PROTECTED TREES AND REMAIN OUTSIDE OF THE DRIPLINE OR TREE PROTECTION LIMITS.
- 13. THE CONTRACTOR SHALL BE SOLELY AND COMPLETELY RESPONSIBLE FOR THE SAFETY OF ALL PERSONS AND PROPERTY DURING PERFORMANCE OF THE WORK. THE CONTRACTOR SHALL PROVIDE ALL LIGHTS, SIGNS, BARRICADES, FLAGMEN, OR OTHER DEVICES NECESSARY TO PROVIDE FOR PUBLIC SAFETY. THIS REQUIREMENT SHALL APPLY CONTINUOUSLY AND NOT BE LIMITED TO NORMAL WORKING HOURS.
- 14. THE CONTRACTOR SHALL BE RESPONSIBLE FOR THE REMOVAL AND REPLACEMENT OF ALL MATERIALS WITHIN DEDICATED RIGHT-OF-WAYS AND ALL MATERIALS AND WORKMANSHIP SHALL MEET THE ROADWAY DESIGN AND CONSTRUCTION STANDARDS OF THE APPROPRIATE GOVERNING AGENCY.
- 15. THE CONTRACTOR IS RESPONSIBLE FOR THE REPAIR, AT NO ADDITIONAL COST TO THE OWNER, FOR DAMAGE OF PROPERTY OUTSIDE OF THE LIMIT OF WORK INDICATED ON THE DRAWINGS, AND FOR ANY DAMAGE CAUSED TO SITE ELEMENTS THAT ARE TO BE PROTECTED OR REINSTALLED.
- 16. PER 5-6(C)(15)(C) ANY DAMAGE TO UTILITY LINES RESULTING FROM THE NEGLIGENCE OF THE ABUTTING PROPERTY OWNER OR THE PROPERTY OWNER'S AGENTS OR EMPLOYEES IN THE INSTALLATION AND MAINTENANCE OF ANY LANDSCAPING, SCREENING, OR BUFFERING IN A PUBLIC RIGHT-OF-WAY, PRIVATE WAY, OR EASEMENT SHALL BE THE RESPONSIBILITY OF SUCH PROPERTY OWNER. ANY DAMAGE TO UTILITY LINES RESULTING FROM THE GROWTH OF PLANT MATERIALS THAT HAVE BEEN APPROVED BY THE APPLICABLE PUBLIC UTILITY AS PART OF A PLAN FOR LANDSCAPING, SCREENING, OR BUFFERING ON THE PUBLIC RIGHT OF WAY SHALL BE THE RESPONSIBILITY OF SUCH PUBLIC UTILITY. IF A PUBLIC UTILITY DISTURBS LANDSCAPING, SCREENING, OR BUFFERING IN A PUBLIC RIGHT-OF-WAY, PRIVATE WAY, OR EASEMENT, IT SHALL MAKE EVERY REASONABLE EFFORT TO PRESERVE THE LANDSCAPING MATERIALS AND RETURN THEM TO THEIR PRIOR LOCATIONS AFTER THE UTILITY WORK. IF THE PLANT MATERIALS DIE DESPITE THOSE EFFORTS, IT IS THE OBLIGATION OF THE ABUTTING PROPERTY OWNER TO REPLACE THE PLANT MATERIALS.
- 17. PER 5-6(C)(15)(D) PROPERTY OWNERS ACKNOWLEDGE THAT APPROVED LANDSCAPING AND TREES INSTALLED AND MAINTAINED IN A PUBLIC RIGHT-OF-WAY, PRIVATE WAY, OR EASEMENT ABUTTING PRIVATE PROPERTIES ARE THE PROPERTY OF THE CITY, AND THAT THAT THE CITY RESERVES THE RIGHT TO REMOVE THEM IF NECESSARY FOR A TRANSPORTATION PROJECT WITHOUT COMPENSATION, BUT AT NO COST TO THE PROPERTY OWNER. LANDSCAPING INSTALLED IN AN ABUTTING PUBLIC RIGHT-OF-WAY, PRIVATE WAY, OR EASEMENT BY PROPERTY OWNERS AND LATER REMOVED BY THE CITY SHALL NOT IMPACT PREVIOUSLY APPROVED NET LOT AREA CALCULATIONS FOR REQUIRED LANDSCAPING.
- 18. PER 5-6(E)(2)(A) IF A WALL AT LEAST 3 FEET IN HEIGHT IS PROVIDED OR EXISTS ALONG THE PROPERTY LINE BETWEEN THE 2 PROPERTIES, 1
  TREE AT LEAST 8 FEET HIGH AT THE TIME OF PLANTING SHALL BE PROVIDED EVERY FOR 15 FEET ALONG THE WALL, WITH SPACING DESIGNED
  TO MINIMIZE SOUND AND LIGHT IMPACTS OF THE PROPOSED DEVELOPMENT ON THE ADJACENT PROPERTY.
- 19. PER 4-3(D)(1)(D) OPERATION OF POWER EQUIPMENT OR GENERATORS SHALL NOT OCCUR BETWEEN THE HOURS OF 10:00 P.M AND 7:00 A.M.
- 20. PER 4-3(D)(1)(F) A COMPOSITE SAMPLE OF THE NATIVE SOIL, CONSISTING OF NO LESS THAN 5 INDIVIDUAL SAMPLES WILL BE TESTED FOR METAL CONTENT USING THE US EPA 3050B, 3051, OR A COMPARABLE METHOD AND THAT THE METALS ARSENIC, CADMIUM, MERCURY, MOLYBDENUM, NICKEL, SELENIUM, AND ZINC ARE AT OR BELOW THE THRESHOLDS LISTED IN TABLE 4-3-1

# **PLANTING PLAN NOTES**

- 1. PER 5-6(C)(4)(H) ALL REQUIRED PLANT MATERIALS SHALL BE FREE OF DISEASE AND INSECTS AND SHALL CONFORM TO THE AMERICAN STANDARD FOR NURSERY STOCK (ASNA) OF THE AMERICAN NURSERY AND LANDSCAPE ASSOCIATION.
- 2. STAKE ALL TREES BASED ON THESE DRAWINGS. LOCATIONS OF PLANT MATERIALS TO BE APPROVED BY THE OWNER'S REPRESENTATIVE IN THE FIELD PRIOR TO INSTALLATION. THE CONTRACTOR SHALL FOLLOW THE LANDSCAPE PLAN. ANY DISCREPANCIES BETWEEN THE PLAN AND FIELD CONDITIONS SHALL BE REPORTED TO THE OWNER'S REPRESENTATIVE AND LANDSCAPE ARCHITECT BEFORE PROCEEDING WITH WORK.
- 3. NOTIFY OWNER'S REPRESENTATIVE OF ANY CONFLICTS BETWEEN UTILITIES AND PLANTINGS TO COORDINATE FIELD ADJUSTMENTS.
- 4. TREES SHALL BE A MINIMUM OF 10' FROM ALL UTILITIES, UNLESS NOTED OTHERWISE
- IF THERE IS A DISCREPANCY BETWEEN THE PLANT COUNTS ON THE CALLOUTS AND/OR SCHEDULES ON THE PLANS AND THE ACTUAL NUMBER OF PLANTS DEPICTED ON THE PLANS, THE CONTRACTOR IS RESPONSIBLE FOR INSTALLING THE ACTUAL NUMBER OF PLANTS DEPICTED ON THE DRAWINGS.
- 6. THE CONTRACTOR IS RESPONSIBLE FOR WEED CONTROL FOR ALL LANDSCAPE AREAS UNTIL FINAL PROJECT ACCEPTANCE.
- 7. FINE GRADING MUST BE APPROVED BY OWNER'S REPRESENTATIVE PRIOR TO SEEDING, SODDING, AND PLANTING.
- 8. PER 5-6(C)(6) ALL PLANT MATERIAL TO MEET THE SIZES SPECIFIED IN THE PLANT SCHEDULE.
- 9. POND STABILIZATION TO FOLLOW SECTION 1013
- 10. ALL VEGETATION SHALL MEET THE MINIMUM SIZE REQUIREMENTS IN TABLE 5-6-1 OF ALBUQUERQUE IDO.
- 11. PER 5-6(C)(9)(A) ALL PLANTING OF VEGETATED MATERIAL OR INSTALLATION OF ANY LANDSCAPING, BUFFERING, OR SCREENING MATERIAL IN THE PUBLIC RIGHT-OFWAY SHALL REQUIRE THE PRIOR APPROVAL OF THE CITY. THE PROPERTY OWNER SHALL BE RESPONSIBLE FOR THE MAINTENANCE, REPAIRS, OR LIABILITY FOR ALL THE LANDSCAPING PLACED IN OR OVER THE PUBLIC RIGHT-OF-WAY.
- 12. PER 5-6(C)(9)(B) ANY TREES THAT OVERHANG A PUBLIC SIDEWALK OR MAJOR PUBLIC OPEN SPACE SHALL BE TRIMMED TO MAINTAIN AN 8 FOOT CLEARANCE OVER THE SIDEWALK. ANY TREES THAT OVERHANG A PUBLIC STREET SHALL BE TRIMMED TO MAINTAIN A 9 FOOT CLEARANCE OVER THE STREET SURFACE.
- 13. PER 5-6(C)(9)(C), WHERE LANDSCAPING IS INSTALLED IN THE PUBLIC RIGHT-OF-WAY, THE APPLICANT SHALL INSTALL AN ADEQUATE IRRIGATION SYSTEM THAT MEETS THE MINIMUM TECHNICAL REQUIREMENTS IN ARTICLE 6-6 OF ROA 1994 (TREES, VEGETATION AND LANDSCAPING) AND THE DPM, WITH A SEPARATE METER FOR THE LANDSCAPE AREA IN THE PUBLIC RIGHT-OF-WAY, OR A SEPARATE VALVE(S) AT THE PROPERTY LINE ALLOWING ISOLATION OF THE IRRIGATION TO THE LANDSCAPE WITHIN THE PUBLIC RIGHT-OF-WAY. DRIP IRRIGATION SYSTEMS AND
- 14. PER 5-6(C)(4)(G) ALL VEGETATION SHALL COMPLY WITH ARTICLE 9-12 AND PARTS 6-1-1 AND 60602 OF ROA 1994 (POLLEN CONTROL, WATER CONSERVATION LANDSCAPING AND WATER WASTE, AND STREE TREES) AND SECTION 4 OF THE ALBUQUERQUE BERNALILLO COUNTY WATER AUTHORITY (ABCWUA) LEGISLATION AND ORDINANCE (WATER WASTE REDUCTION ORDINANCE) AS APPLICABLE
- 15. PER 5-6(C)(5)(A) ALL VEGETATED MATERIAL REQUIRED BY THIS SECTION 14-16-5-6 SHALL BE PLANTED IN UNCOMPACTED SOIL
- 16. PER 5-6(C)(5)(B) IF USED, WEED BARIER SHALL BE PERMEABLE TO OPTIMIZE STORMWATER INFILTRATION AND PREVENT RUNOFF
- 17. PER 5-6(C)(7)(A), VEGETATION REQUIRED BY THIS SECTION 14-16-5-6 SHALL BE LOCATED AT LEAST 3 FEET IN ANY DIRECTION FROM ANY FIRE HYDRANTS, VALVE VAULTS, HOSE BIBS, MANHOLES, HYDRANTS, AND FIRE DEPARTMENT CONNECTIONS. PLEASE CONFIRM COMPLIANCE WITH THIS CODE
- 18. PER 5-6(C)(5)(D), A MINIMUM OF 2 INCHES OF ORGANIC MULCH IS REQUIRED IN ALL PLANTING AREAS, WITH 3-4 INCHES RECOMMENDED.

### LAYOUT NOTES


- 1. CONTRACTOR TO IMMEDIATELY NOTIFY THE LANDSCAPE ARCHITECT AND PROJECT MANAGER OF ANY DISCREPANCIES BETWEEN THE SITE SURVEY AND ACTUAL SITE CONDITIONS.
- 2. ADDITIONAL LAYOUT INFORMATION MAY BE PROVIDED TO THE CONTRACTOR PRIOR TO CONSTRUCTION AS NEEDED. ELECTRONIC FILES MAY BE OBTAINED BY THE CONTRACTOR FOR LAYOUT PURPOSES.
- FINAL LOCATION OF ALL SITE FURNISHINGS, TREES & LANDSCAPE BOULDERS TO BE COORDINATED WITH LANDSCAPE ARCHITECT PRIOR TO FINAL INSTALLATION.
- 4. WRITTEN DIMENSIONS SHALL PREVAIL. DO NOT SCALE DIRECTLY FROM DRAWINGS.
- 5. ALL PAVED SURFACES SHALL HAVE SMOOTH, CONTINUOUS LINES OR CURVES AS INDICATED ON PLANS AND SHALL CONFORM TO GRADES INDICATED ON THE GRADING PLANS. ALL LINES OF PAVING TO BE PARALLEL UNLESS OTHERWISE NOTED
- 6. ALL ANGLES TO MATCH THOSE NOTED ON DRAWING
- 7. ADJUSTMENTS: IF THE CONTRACTOR BELIEVES IT IS NECESSARY TO MAKE AN ADJUSTMENT IN THE LAYOUT OF PROPOSED IMPROVEMENTS, SUCH ADJUSTMENT SHALL BE PROPOSED TO THE OWNER'S REPRESENTATIVE. NO ADJUSTMENTS WILL BE PERMITTED UNTIL IT HAS FIRST BEEN APPROVED BY THE OWNERS REPRESENTATIVE.
- 8. REFER TO CIVIL PLANS FOR ADDITIONAL SITE LAYOUT INFORMATION.

LANDSCAPE AREAS BREAKDOWN (TABLE 2)								
AREA	DESCRIPTION	PROPOSED						
PLANTING BEDS	GRAVEL/ORGANIC MULCHED AREA	12,894 SF GRAVEL, 4,292 SF ORGANIC MULCH, 17,166 SF TOTAL						
NATIVE SEED AREA	AREAS SPRAYED WITH NATIVE SEED	9,853 SF						
SEATING/GATHERING AREAS	COURTYARD, NORTH GATHERING AREA	2,182 SF						
COMMUNITY GARDEN	GARDEN, SHADED AREA	6,288 SF						


NET LOT A	REA BREAKDO	NWN
CALCULATION	DESCRIPTION	NET LOT AREA
91,995 SF - 14,072 SF	AREA WITHIN PROPERTY LINE MINUS BUILDING FOOTPRINT	77,923 SF

USABLE OPEN SPACE AREAS BREAKDOWN (TABLE 5)				
AREA	DESCRIPTION	PROPOSED		
PLANTING BEDS	GRAVEL/ORGANIC MULCHED AREA	17,166 SF		
NATIVE SEED AREA	AREAS SPRAYED WITH NATIVE SEED	9,853 SF		
SEATING/GATHERING AREAS	COURTYARD, NORTH GATHERING AREA	2,182 SF		
COMMUNITY GARDEN	GARDEN, SHADED AREA	6,288 SF		
WALKS	CONCRETE WALKS, CRUSHER FINES WALKING PATH AROUND DETENTION AREA	7,316 SF		

# **SAMPLE KEYNOTE DRAWING CALL-OUT:**

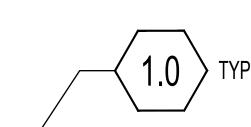

# **SITE DETAIL KEYNOTES:**

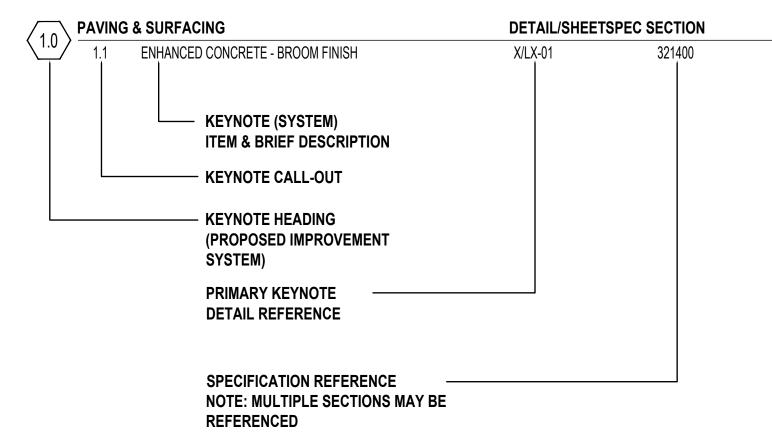


THE FOLLOWING LIST OF KEYNOTE HEADINGS (PROPOSED IMPROVEMENT SYSTEMS) HAVE BEEN INCORPORATED WITHIN THIS DRAWING SET:


- 0.0 EXISTING CONDITIONS
  1.0 PAVING & SURFACING
- 2.0 STEPS & RAMPS3.0 WALL, CURBS & EDGERS
- 4.0 RAILINGS, BARRIERS & FENCING 5.0 SITE FURNISHINGS & SIGNS
- 6.0 DRAINAGE
  7.0 SITE LIGHTING & ELECTRICAL
- 8.0 PLANTING & LANDSCAPE
- 9.0 MISCELLANEOUS

NOTE: IF A KEYNOTE HEADING IS NOT INCORPORATED IN THE PROJECT, A "NOT USED AT THIS TIME" REFERENCE HAS BEEN PROVIDED.

# SAMPLE REFERENCE NOTE DRAWING CALL-OUT:

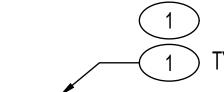

### "X" REFERENCE NOTES

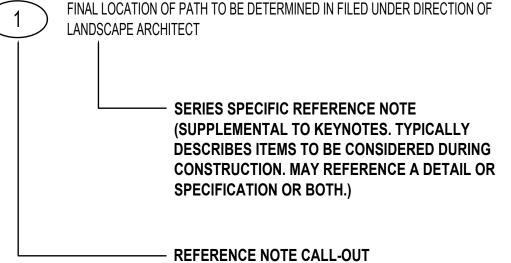

NOTE: "X" REFERS TO DRAWING SERIES (i.e. SITE DEMOLITION REFERENCE NOTES). THERE SHOULD BE SPECIFIC REFERENCE NOTES FOR EACH DRAWING SERIES. HOWEVER, SOME NOTES MAY APPEAR ON MULTIPLE SERIES.

LANDSC	APE REQUIRE	MENTS (TABLE	1)
REQUIREMENT	CALCULATION	REQUIRED	PROPOSED
25% OF NET LOT AREA SHALL BE LANDSCAPED <b>5-6(C)(2)</b>	.25 X (77,923 SF) =	22,402 SF	35,489 SF (SEE TABLE 2)
75% OF LANDSCAPED AREA TO BE COVERED WITH VEGETATION 5-6(C)(2)(c)	35,489 SF X .75 =	26,616 SF	30,147 SF
25% OF REQUIRED VEGETATION TO BE GROUND COVERS, SHRUBS, ORNAMENTAL GRASSES 5-6(C)(2)(c)	26,616 X .25 =	6,654 SF	13,882 SF
LANDSCAPE ROW-1 TREE PER 25 LF 5-6(C)(4)(i)	199LF / 25FT	8 TREES	0 TREES*
1 TREE PER GROUND FLOOR UNIT, 1 TREE PER 2ND FLOOR UNIT 4-3(B)(8)(c)	1 x 15 GROUND FLOOR UNITS 1 x 17 2ND FLOOR UNITS	32 TREES	32 TREES
AREA OF CHANGE BUFFER REQUIREMENT, 1 TREE PER 15' ALONG 6' WALL 5-6(E)(2)(a)	257 ft / 15 ft	17 TREES	17 TREES
USABLE OPEN SPACE MINIMUM TABLE 5-1-2	225 SF X 47 1BR = 285 SF X 1 2BR	10,575 SF + 285 SF =10,860 SF	42,805 SF (SEE TABLE 5)
NO MORE THAN 40% OF USABLE OPEN SPACE CAN BE PRIVATE TO A HOUSEHOLD 4-3(B)(8)(a)	.40 X 43,950 SF =	<17,580 SF PRIVATE TO HOUSEHOLD	NO OPEN SPACE IS PRIVATE TO A HOUSEHOLD
CRUSHER FINES LIMITED TO 75% OF LANDSCAPED AREA 5-6(C)(5)(C)	.75 X 35,489 SF =	<26,616 SF OF GRAVEL	12,874 SF OF GRAVEL
SEATING/GATHERING AREAS LIMITED TO $\frac{1}{3}$ OF REQUIRED LANDSCAPING 5-6(C)(3)(e)	.33 X 19,470 SF =	<6,425 SF OF GATHERING AREAS	2,182 SF OF GATHERING AREAS
COOL SEASON GRASSES RESTRICTED TO 20% OF	00 // 05 400 65	<7.097 SF OF COOL	0 SF OF COOL

<7,097 SF OF COOL 0 SF OF COOL

SEASON GRASSES SEASON GRASSES

\*DUE TO WATER LINES IN THE ROW, REQUIRED ROW TREES ARE RELOCATED ELSEWHERE ON SITE

THE LANDSCAPE AREA .20 X 35,489 SF =

4-3(B)(8)(c)

COMMUNITY	CARDENIBEOL	UDEMENTS (TA	DI E 2)
		JIREMENTS (TA	,
REQUIREMENT	CALCULATION	REQUIRED	PROPOSED
MAX SIZE 3 ACRES			6,288 SF = .14
4-3(D)(1)(a)			ACRES
LIMITED TO PROPOGATION			
AND CULTIVATION OF			REQUIREMENT
PLANTS			MET
4-3(D)(1)(b)			
ACCESSORY STRUCTURES			
SHALL BE NOT EXCEED 25%	400 SF/6,288 SF =	<1,572 SF	60/
OF OF THE GARDEN AREA	6%	\1,312 SF	6%
4-3(D)(1)(c)			


PARKING LOT LA	NDSCAPING R	EQUIREMENTS	(TABLE 4)
REQUIREMENT	CALCULATION	REQUIRED	PROPOSED
% OF PARKING LOT AREA LANDSCAPED 5-6-(F)(2)(a)	.10 X 36,147 SF =	3,614.7 SF	5,973 SF
TREE PER 10 PARKING SPACES <b>5-6(F)(2)(c)</b>	40 SPACES/10	4 TREES	10 TREES
IO PARKING SPACE MAY BE MORE THAN 100 FT IN ANY DIRECTION FROM A TREE TRUNK 5-6(F)(2)(c)			REQUIREMENT MET
AT LEAST 75% OF EQUIRED TREES SHALL BE ECIDUOUS SHADE TREES 5-6(F)(2)(c)	10/10 TREES = 100%	75% DECIDUOUS SHADE TREES	100% DECIDUOUS SHADE TREES


5-6(F)(2)(c)					
OUTDOOR SEATING AND GATHERING AREAS REQUIREMENTS					
	(TABLE	4)			
REQUIREMENT	CALCULATION	REQUIRED	PROPOSED		
400 SF AREA PER 30,000 SF OF GROSS FLOOR AREA	GFA = 35,884, 400SF x 2	800 SF	2,182 SF		
25% OF REQUIRED SEATING/GATHERING SHADED FROM THE SUN	.25 X 800 SF	200 SF	794 SF		

99

LANDSCAPE NOTES

LS100

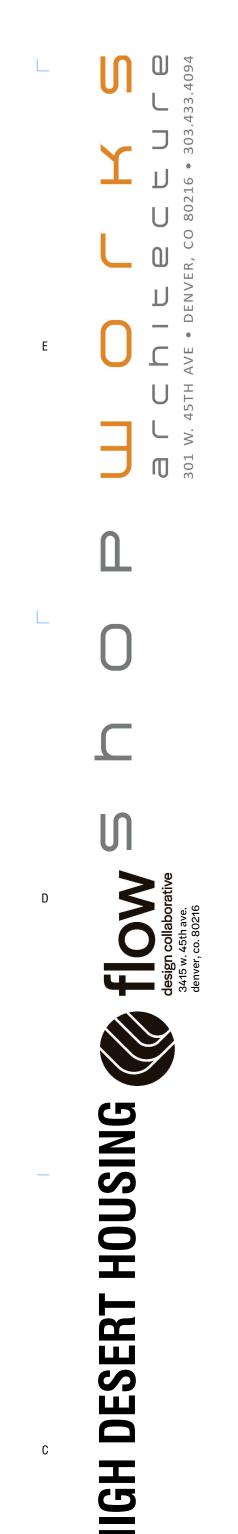

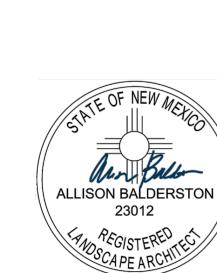

ALLISON BALDERSTO 23012

AND SCAPE ARCHITECT

MS

ROUTE 7600 CENTRA ALBUQUERQI

ORAWN: Author
REVIEWED: Approver


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PROJECT #: 21018

GILE:
GHEET TITLE:

OVERALL LANDSCAPE SITE PLAN
SCALE:

NO. LS101



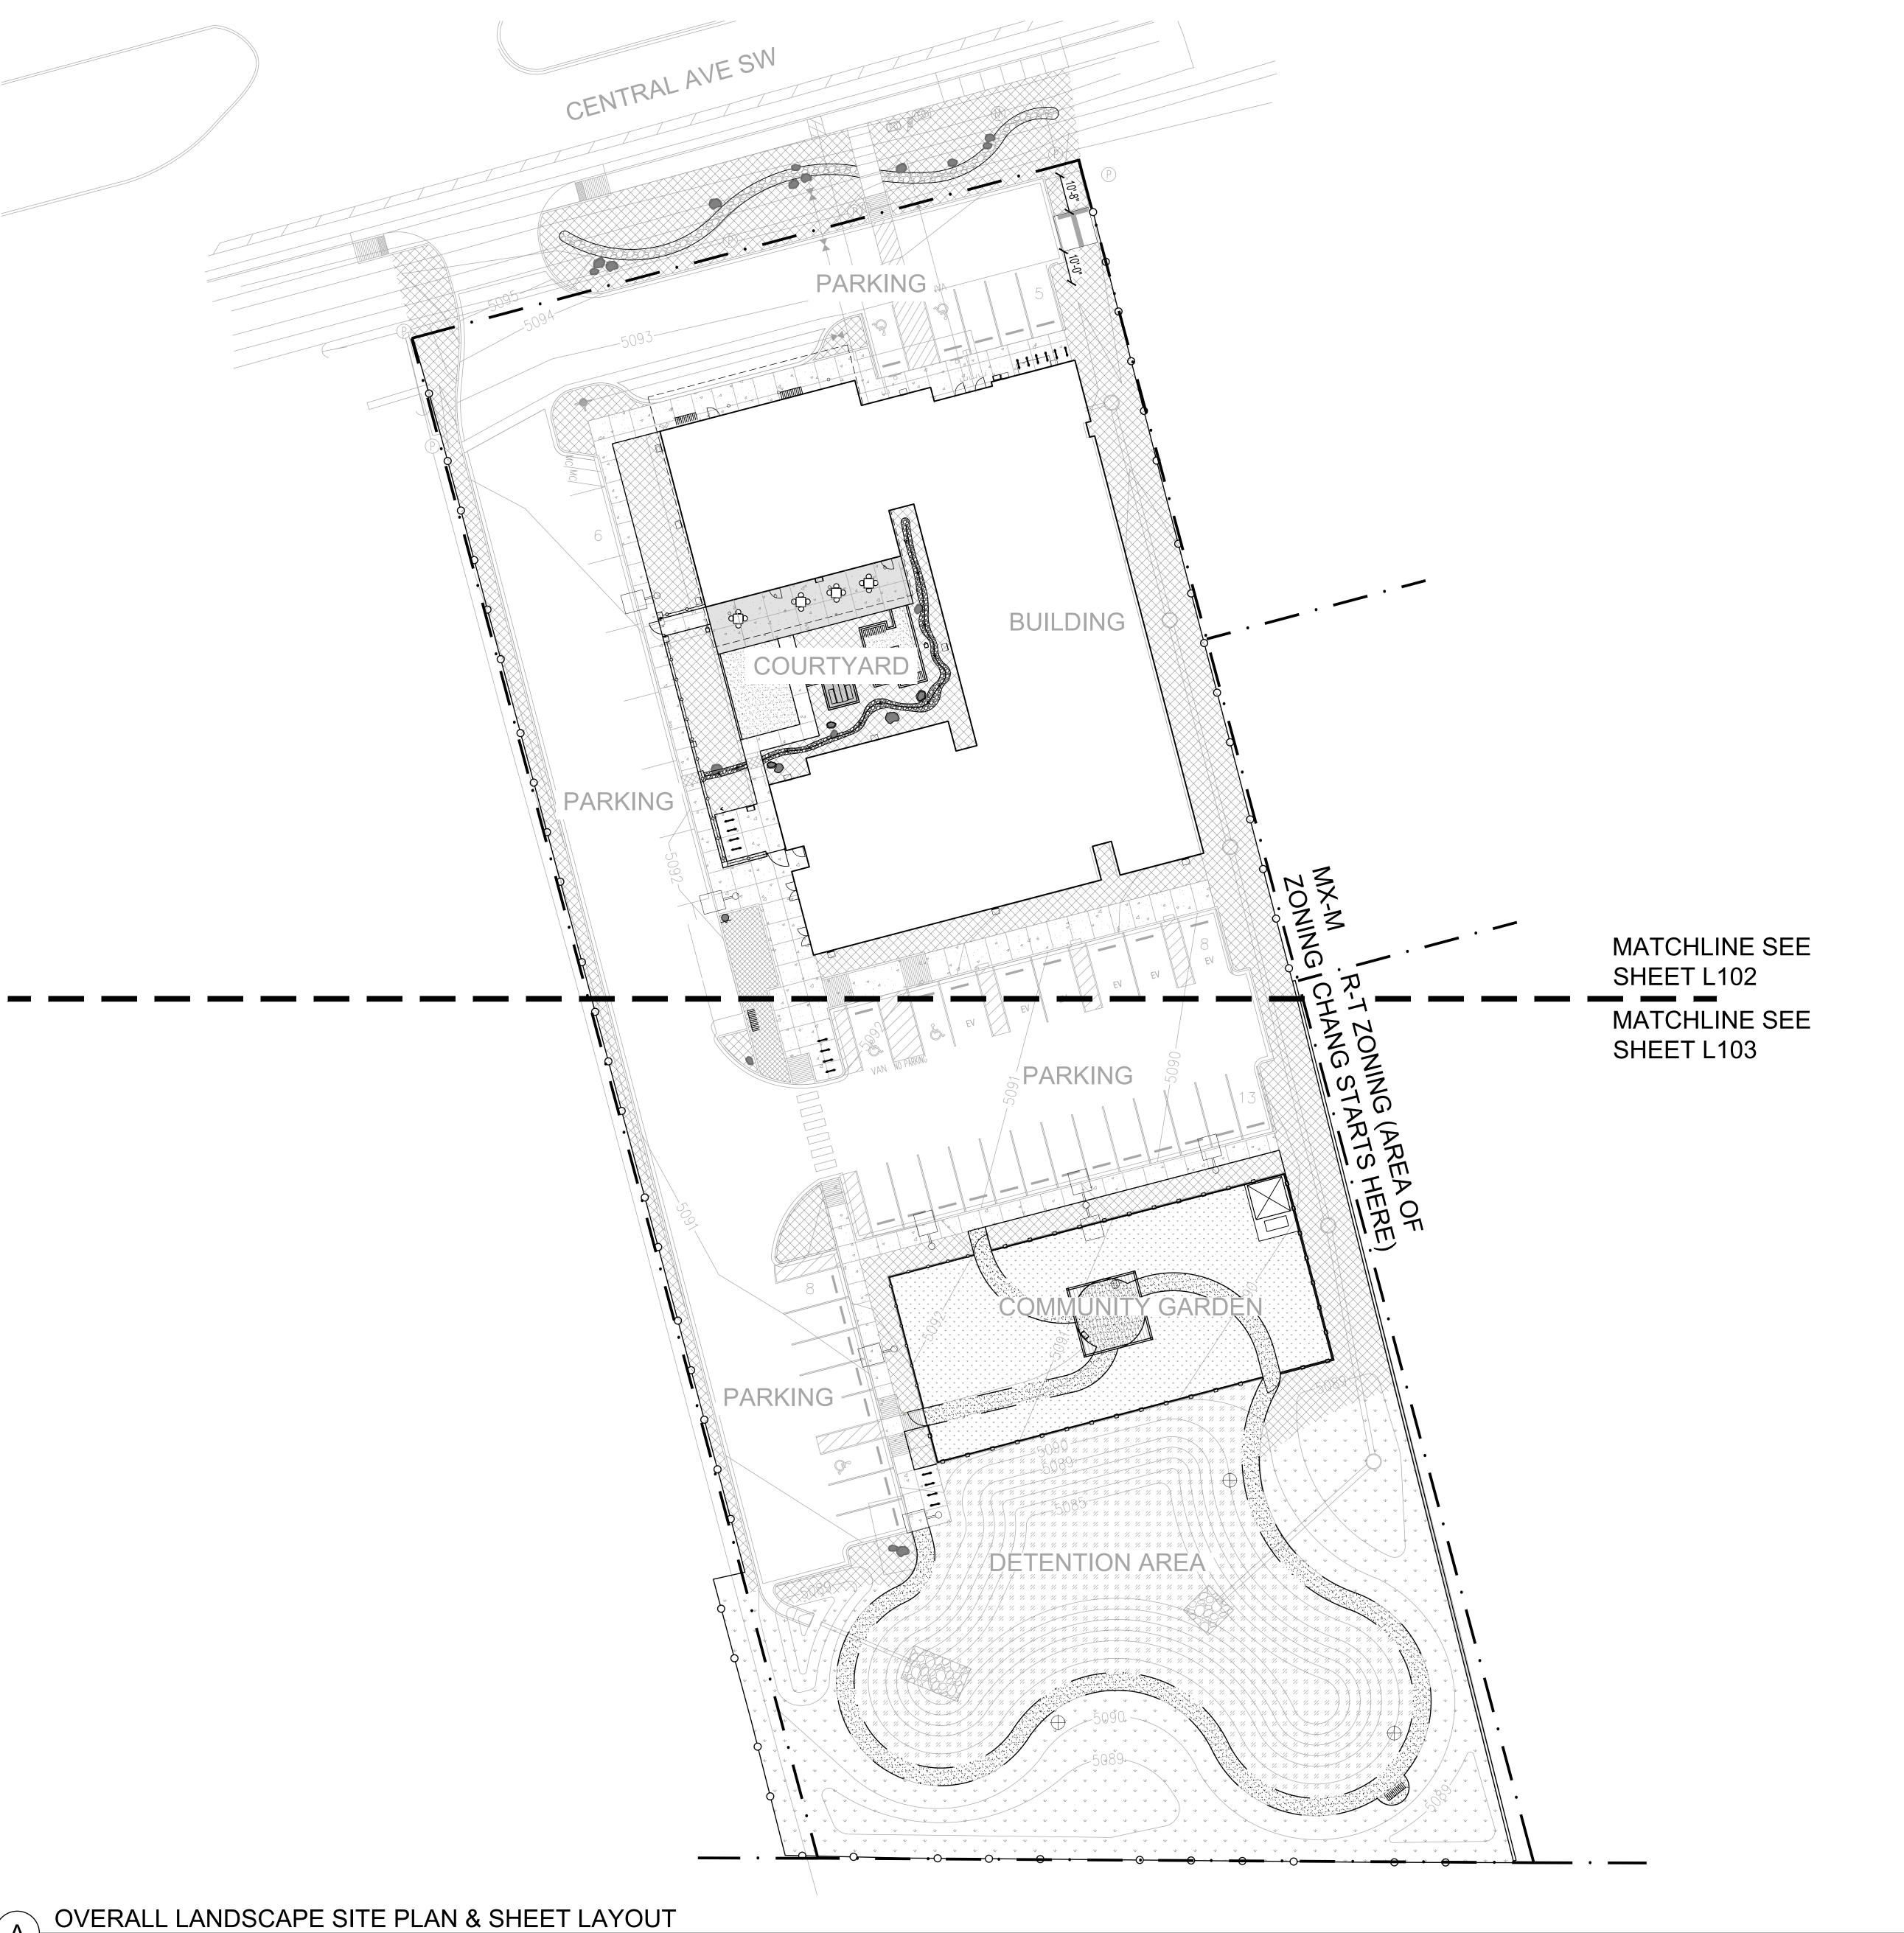














REVIEWED: Approver

FILE: SHEET TITLE:

LANDSCAPE SITE PLAN LS102

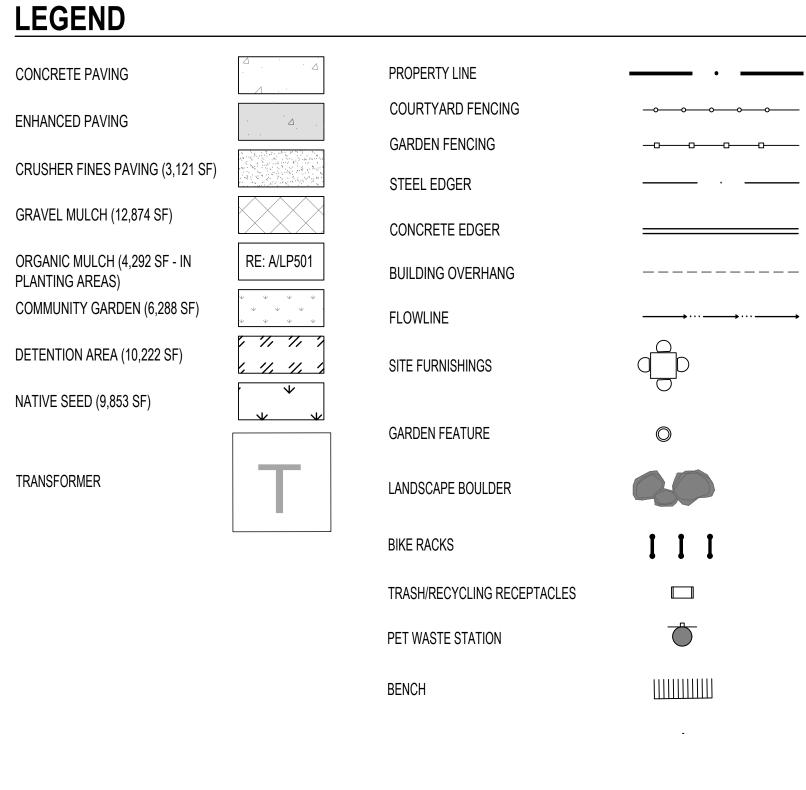

$\langle 0.0 \rangle \frac{27.05}{0.1}$	TING CONDITIONS  EXISTING FENCE	
0.1		
PΔV	ING & SURFACING	DETAIL/SHEETSPEC SECTION
$\langle 1.0 \rangle \frac{1.0}{1.0}$		RE: CIVIL
1.		A/LS501
1.2		7020001
1.3		
1.4	· · · · · · · · · · · · · · · · · · ·	
1.5		
—\ STEP	S & RAMPS	DETAIL
$\frac{2.0}{2.X}$	NOT USED	
$\overline{0}$	LS, CURBS & EDGERS	DETAIL
3.0	FLUSH CONCRETE HEADER	B/LS501
3.1	STEEL EDGER	H/LS502
RAIL	NGS, BARRIERS & FENCING	DETAIL
$0 \rightarrow \frac{10 \text{ m}}{4.0}$	COURTYARD FENCING	C/LS501
4.1	NORTHERN COURTYARD GATE	D/LS501
4.2	SOUTHERN COURTYARD GATE	E/LS501
4.3	GARDEN FENCE	C/LS502
4.4	GARDEN GATE	D/LS502
4.5	COURTYARD FENCE COLUMN	C/LS501
$\frac{1}{2}$ SITE	FURNISHINGS & SIGNS	DETAIL
$\frac{1}{5.0}$	BIKE RACK	J/LS501
5.1	LITTER & RECYCLING RECEPTACLE	
5.2	SITE FURNISHINGS	
5.3	SITE FURNISHINGS	
5.4	COURTYARD GARDEN FEATURE	
5.5	DOG WASTE STATION	
5.6	BENCH	
5.7	SHADE STRUCTURE-COMMUNITY GARDEN	B/LS502
5.8	SHADE STRUCTURE-WORK BOOTH	F/LS501
5.9		
5.10		DETAIL
$6.0$ $\frac{\text{DRA}}{6.1}$	COBBLE SWALE	G/LS501,
	LIGHTING & ELECTRICAL	DETAIL
$7.0 > \frac{3112}{7.0}$		RE: ELECTRICAL
		RE: ELECTRICAL
7.2		RE: ELECTRICAL
7.3		RE: ELECTRICAL
_\ PIΔI	NTING & LANDSCAPE	
$0 > \frac{1.271}{8.0}$	DECIDUOUS TREE IN PLANTING AREA	A/LP501
,		B/LP501
8.2		C/LP501
8.3		E/LS502
MISC	ELLANEOUS	DETAIL
9.0		PEINE


SITE DETAIL KEYNOTES: SITE PLAN

# 9.0 MISCELLANEOUS 9.X NOT USED **REFERENCE NOTES:**


- CHAISE DRAIN TO EXTEND UNDER FENCE
- COBBLE MULCH IS PURELY DECORATIVE AND NOT INTENDED TO ACT AS A SWALE
- DO NOT USE EDGER BETWEEN SQUEEGEE MULCH AND COBBLE
- CLEAR AND GRUB ENTIRE SITE RE: DEMO PLAN
- EXISTING FENCE TO REMAIN
- 7 DO NOT INSTALL LANDSCAPE FABRIC UNDER DOG RUN GRAVEL DETENTION POND TREATMENT IS TO FOLLOW CITY OF ALBUQUERQUE STANDARD SPECIFICATIONS FOR PUBLIC WORKS CONSTRUCTION SECTION 1013 AS OUTLINED IN SPEC 32990 'NATIVE SEEDING'





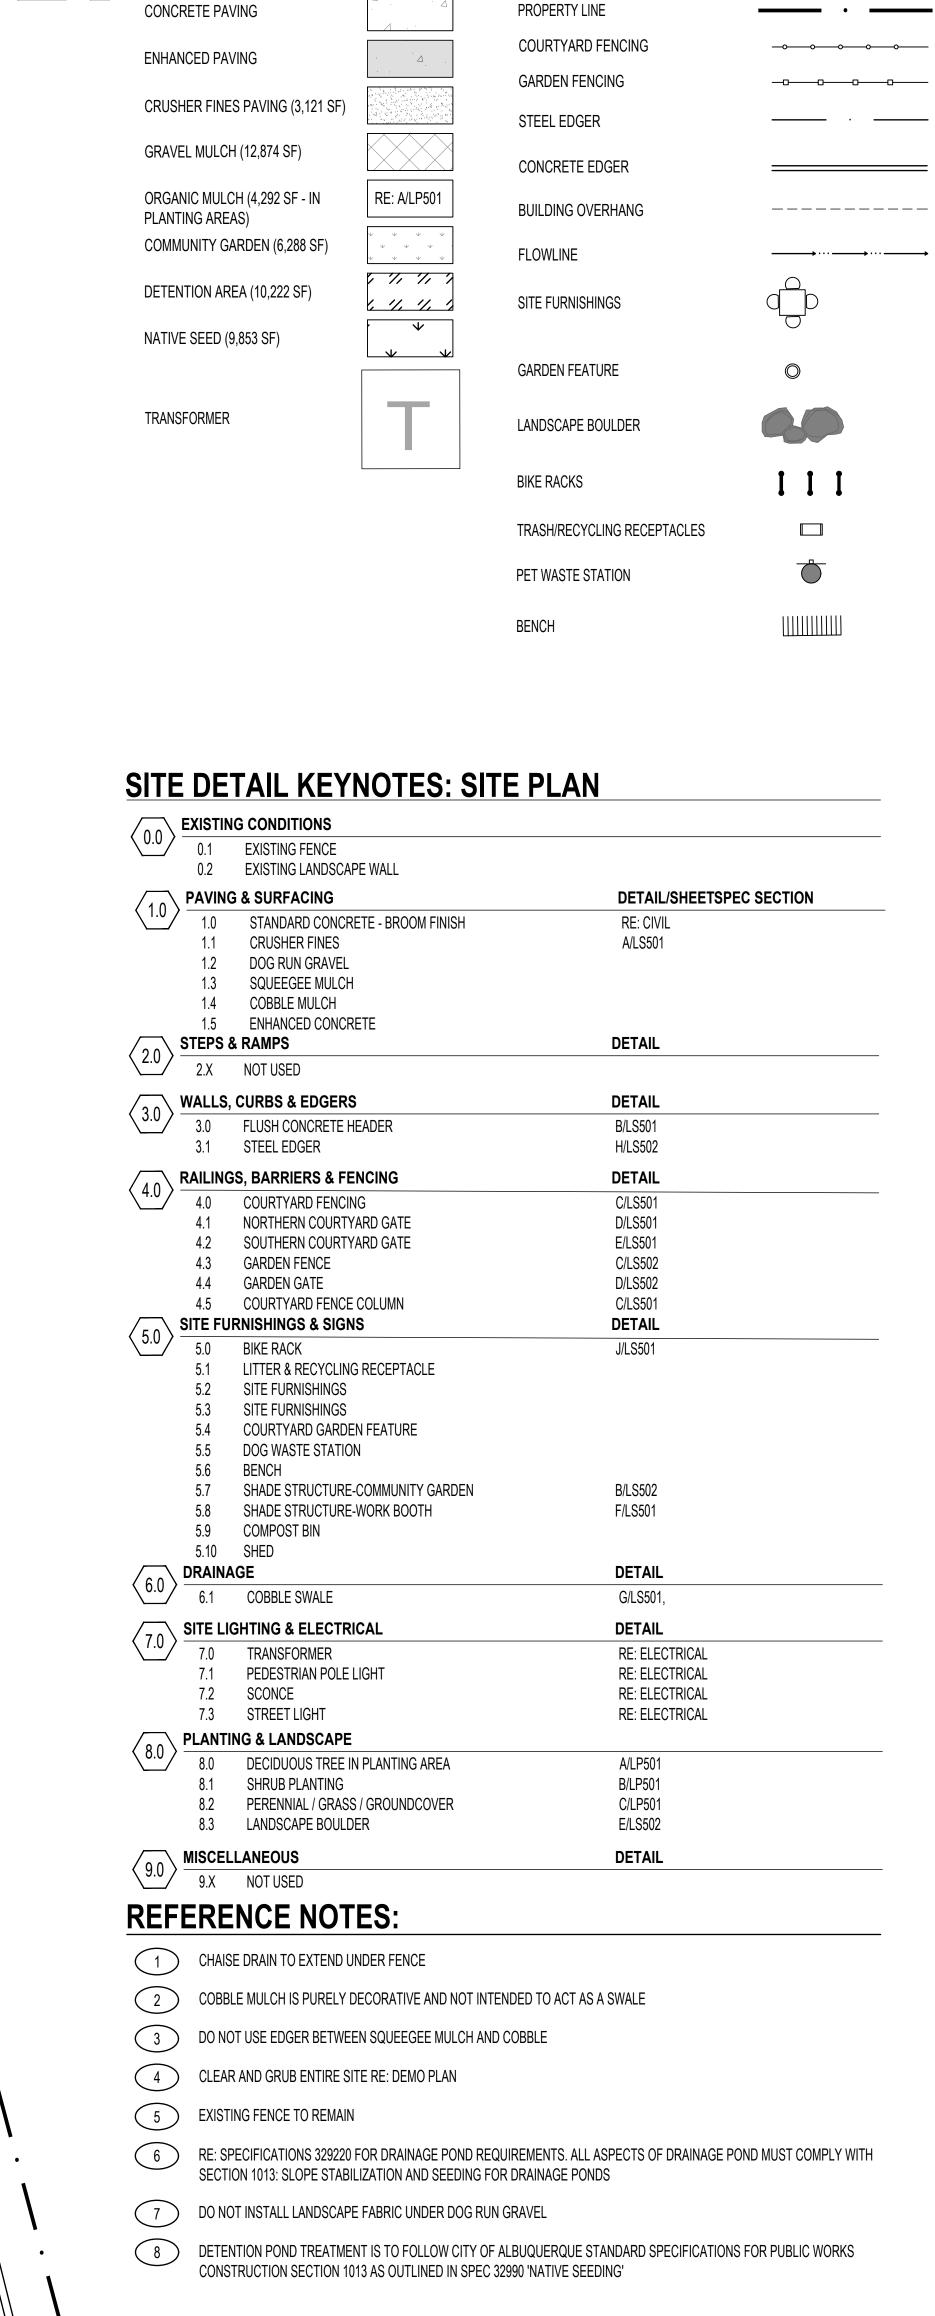


**LEGEND** 

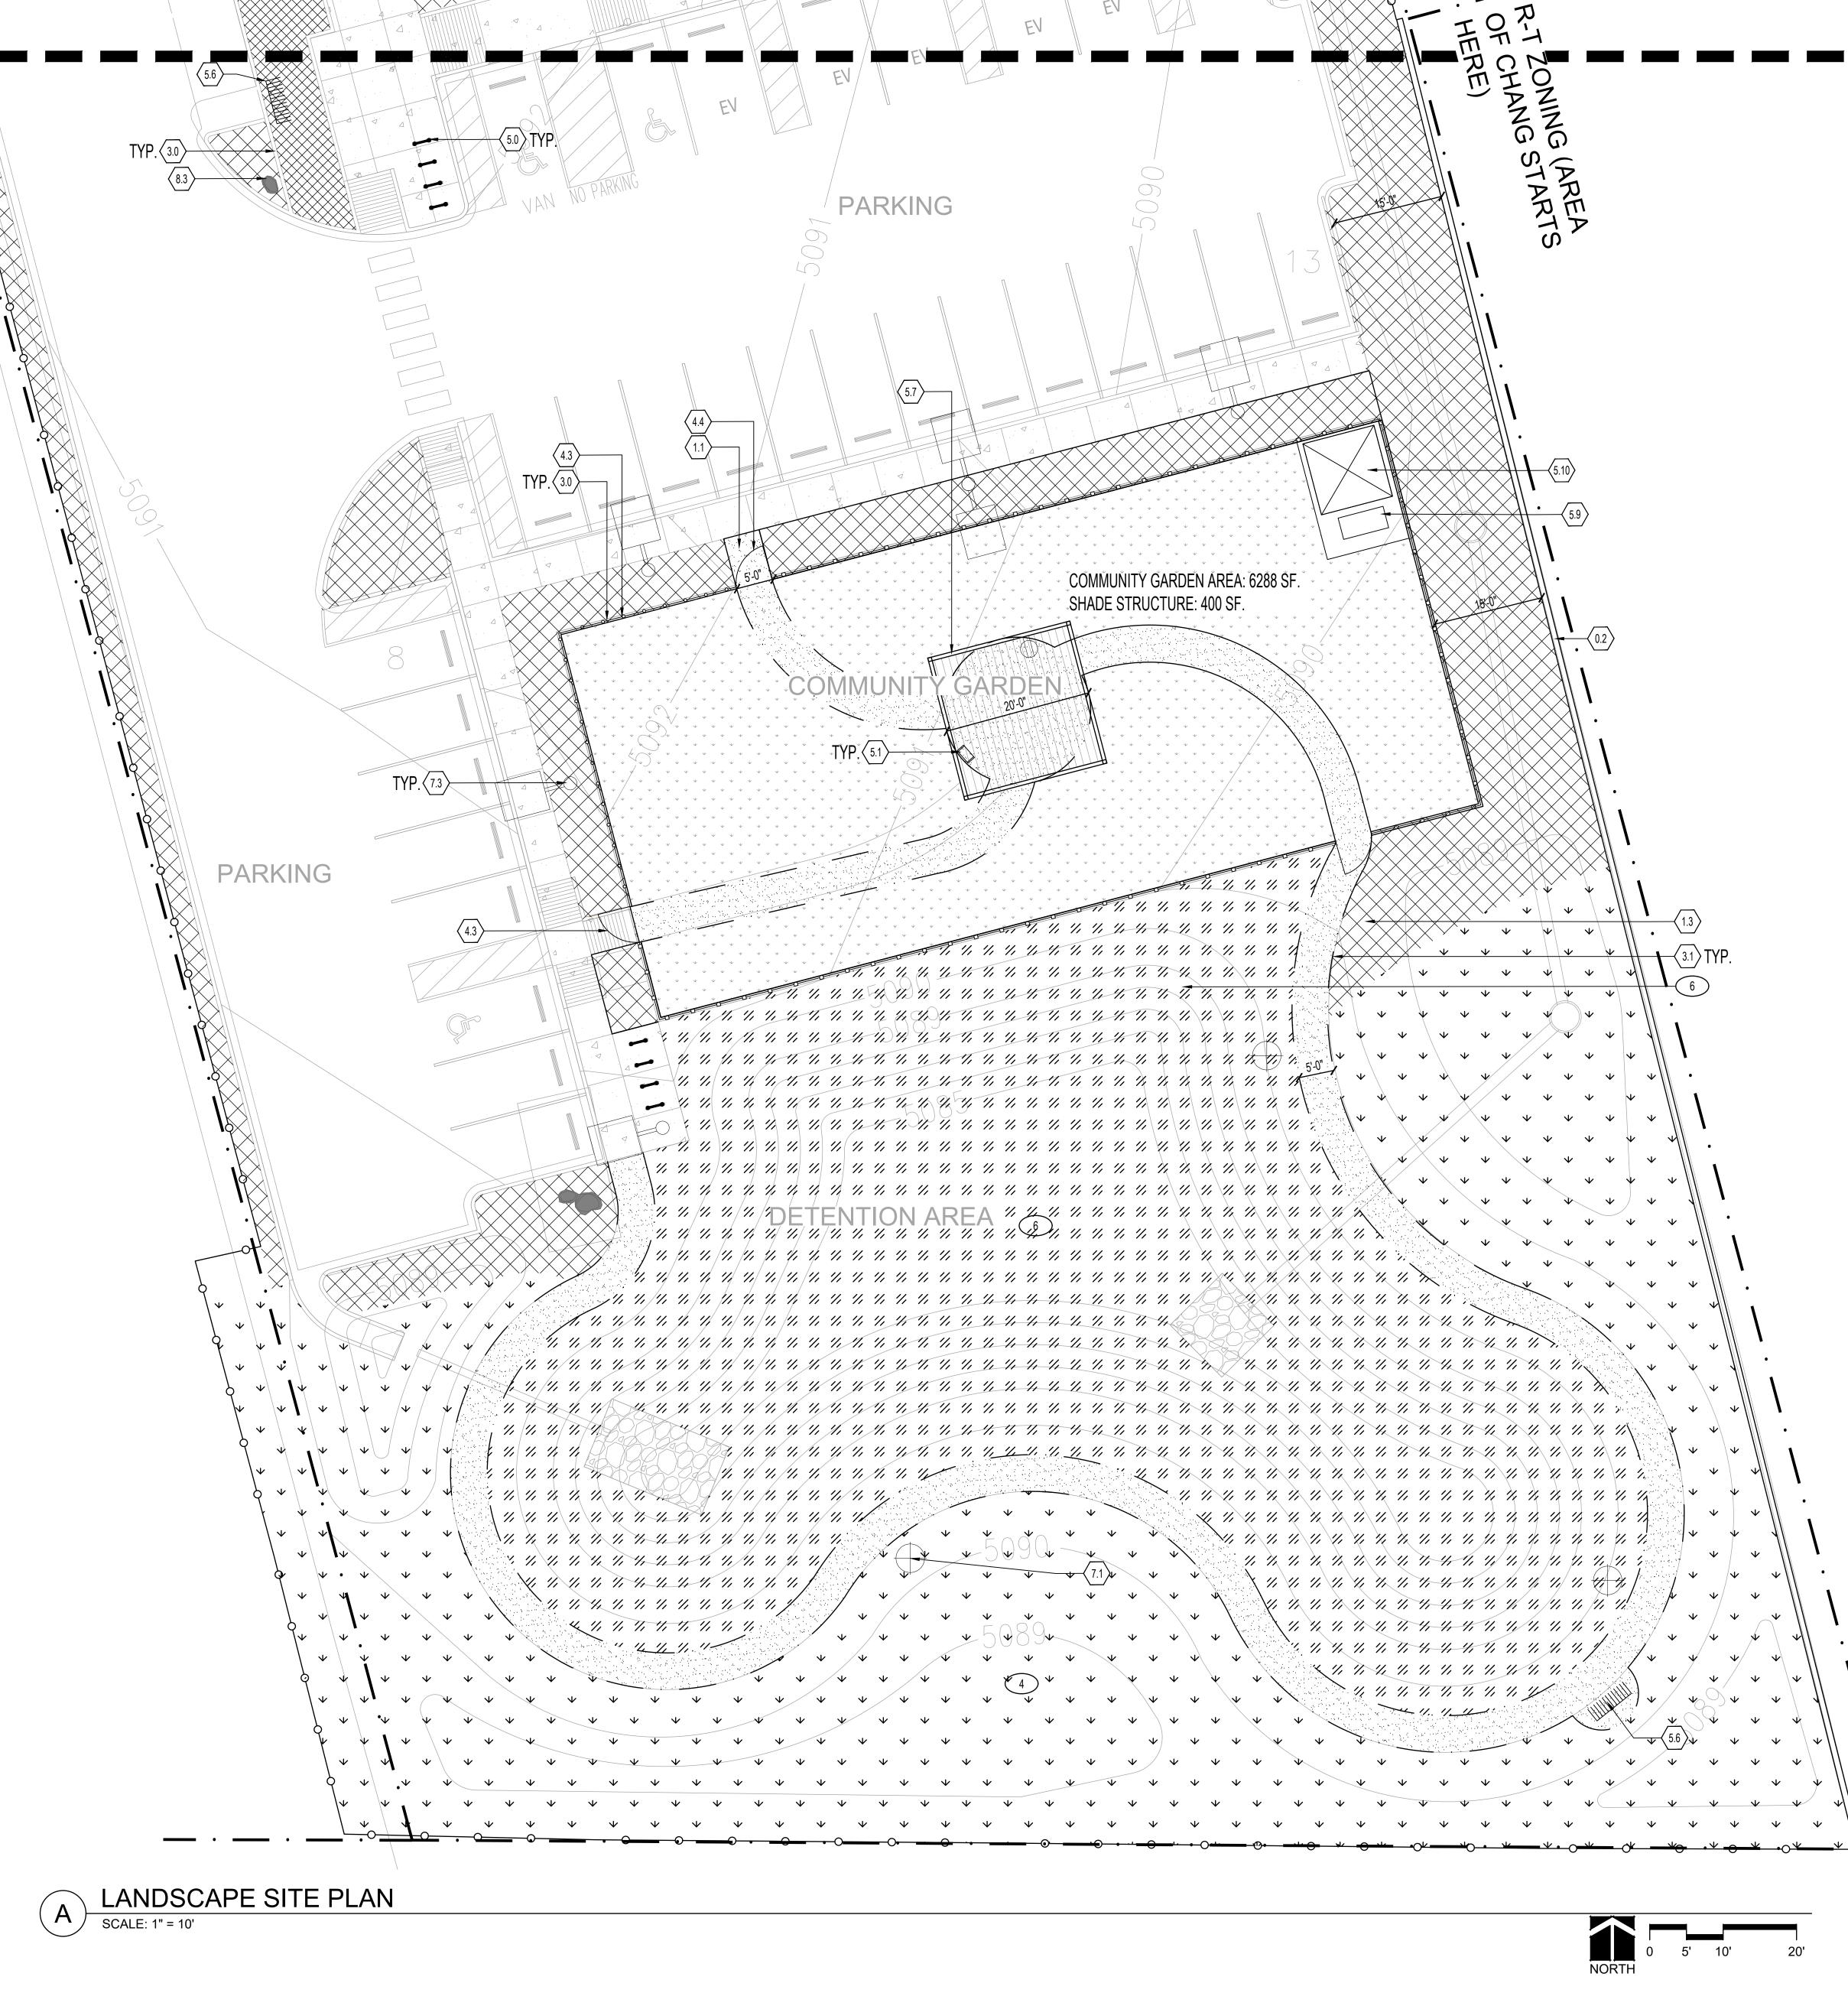

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SHEET TITLE: LANDSCAPE SITE PLAN

LS103

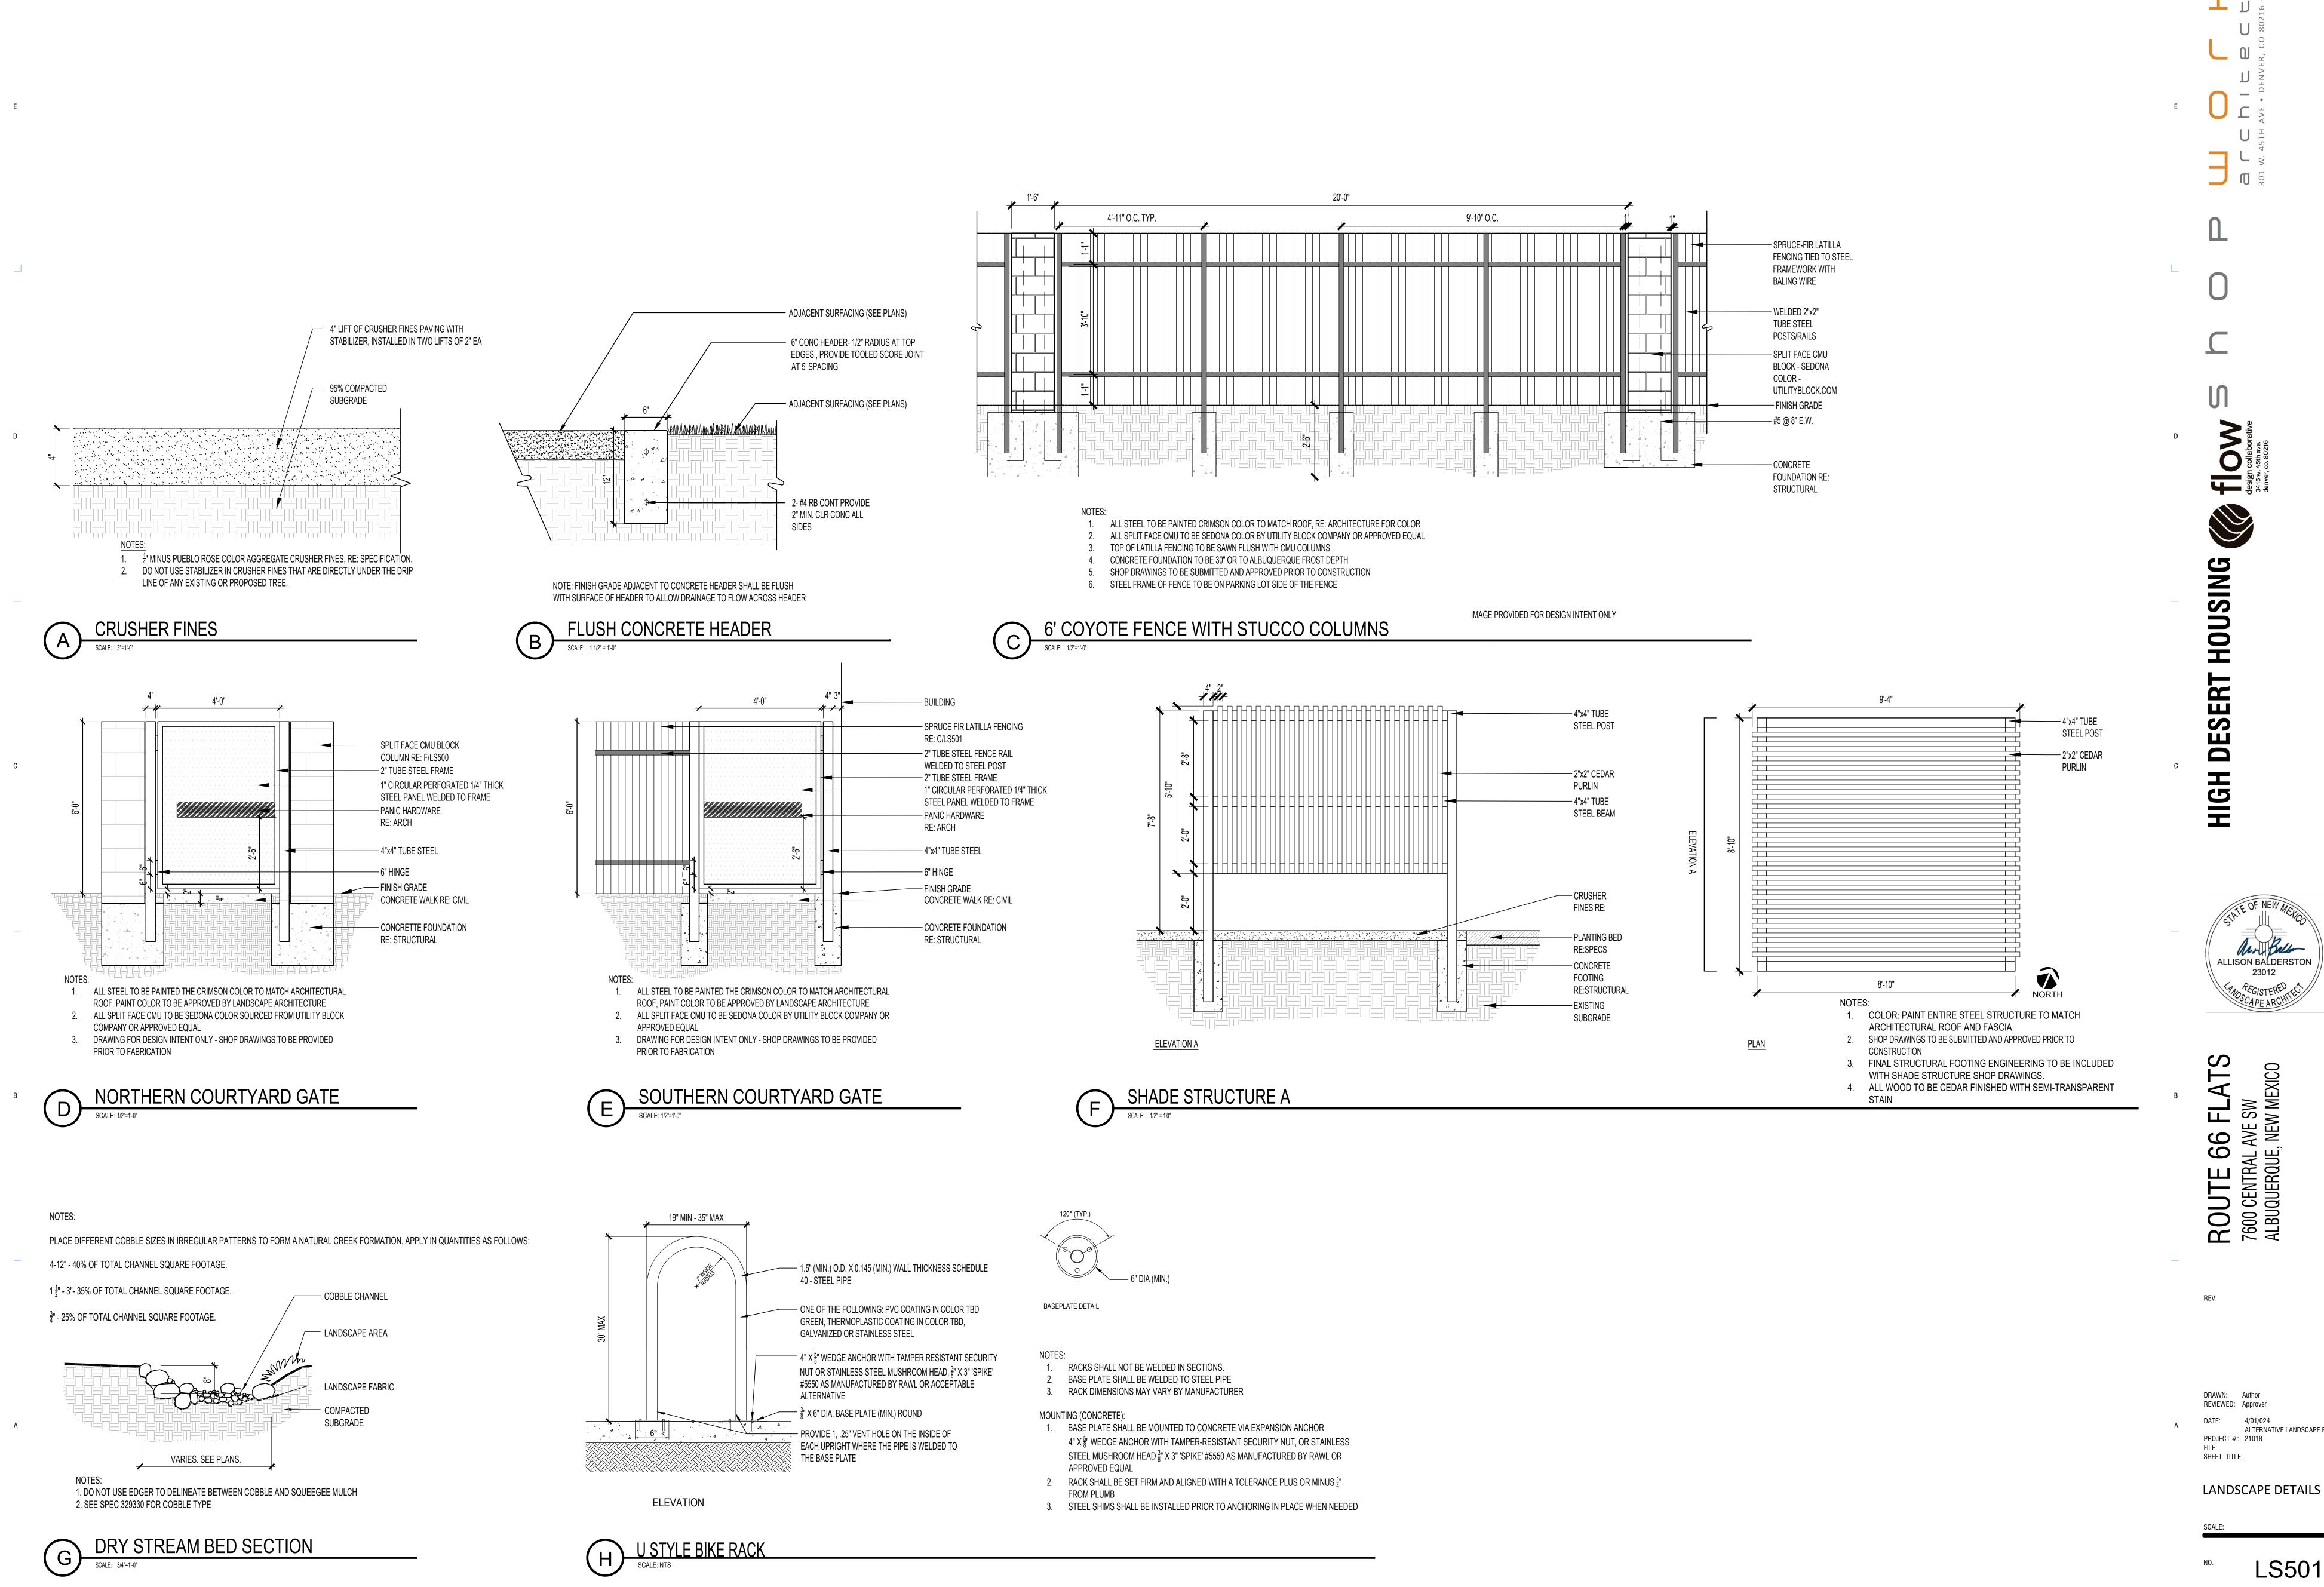

LS501

ALTERNATIVE LANDSCAPE PLAN

23012


























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**HIGH DESERT** 


ALLISON BALDERSTON 23012

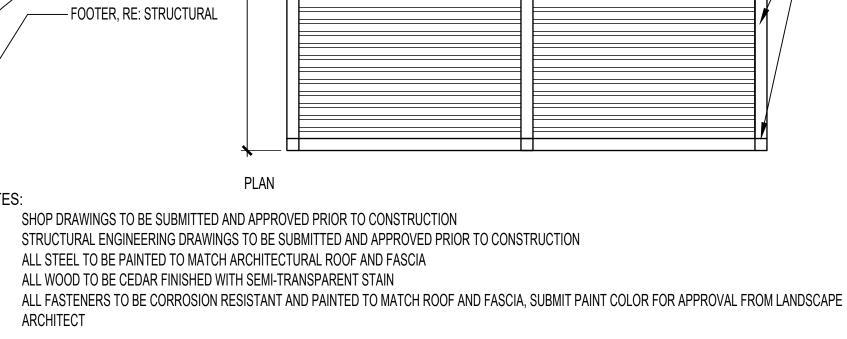

— 2X6 CEDAR RAFTER


— 6X6 TUBE STEEL POST


9'-3"

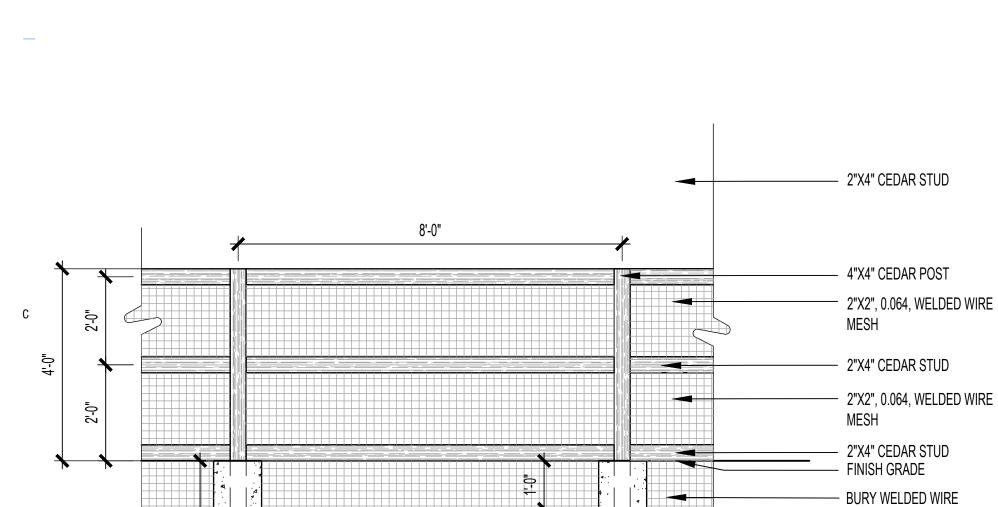

— 4" ROLL TOP STEEL LANDSCAPE EDGER 14 GAUGE MINIMUM PAINTED GREEN

- PLANTING BED OR CRUSHER FINES

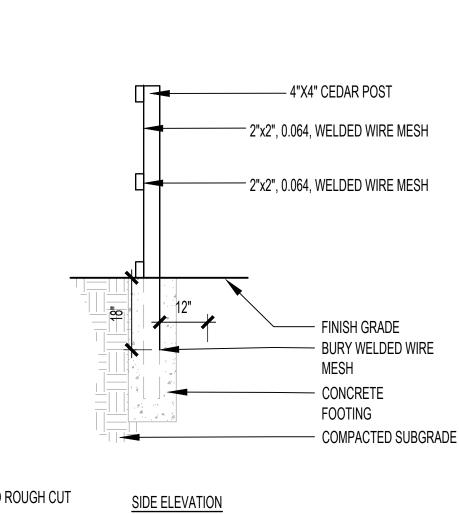

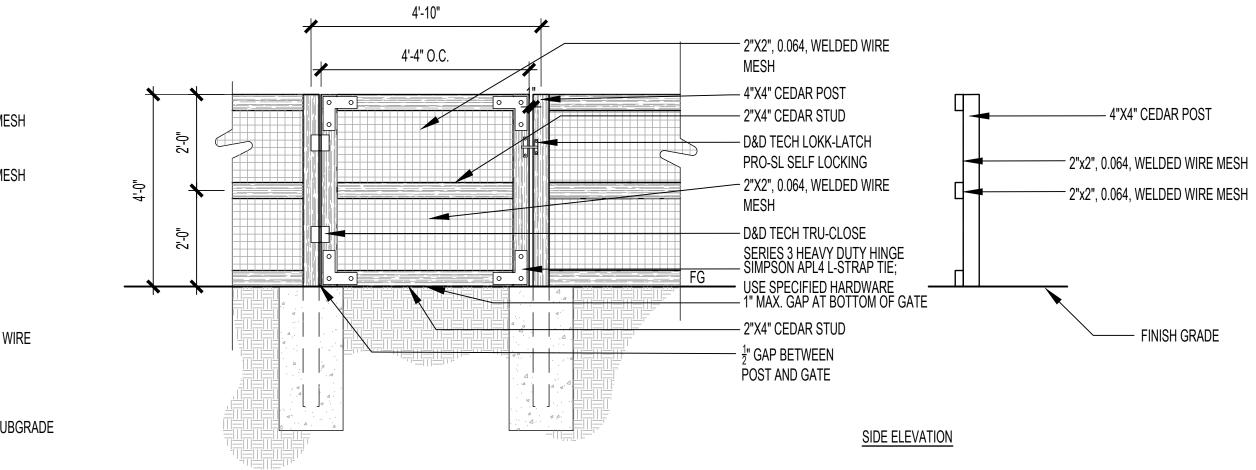

\_\_\_\_\_ 2X6 CEDAR RAFTER

----- 6X6 TUBE STEEL BEAM ----- 6X6 TUBE STEEL POST

NOTE: ALL FENCING MATERIAL TO BE STAINED ROUGH CUT CEDAR.

STAPLE MESH TO FRAME AND RAILS @ EVERY POINT OF

CONNECTION

FRONT ELEVATION GARDEN FENCING

STEEL EDGER TO BE LEVEL WITH FINISH GRADE

SCALE: 3"=1'-0"

SQUEEGEE MULCH —

NOTE: ALL FENCING MATERIAL TO BE STAINED ROUGH CUT STAPLE MESH TO FRAME AND RAILS @ EVERY POINT OF CONNECTION

MESH


- COMPACTED SUBGRADE

- CONCRETE FOOTING

FRONT ELEVATION

- SET BOULDERS IN AN BOULDER HEIGHT. BACK LESS THAN 3 1/2" AND GREATER TO FINISH GRADE OF THAN 9" VARIES-SEE PLANS ADJACENT AREA. / FINISH GRADE



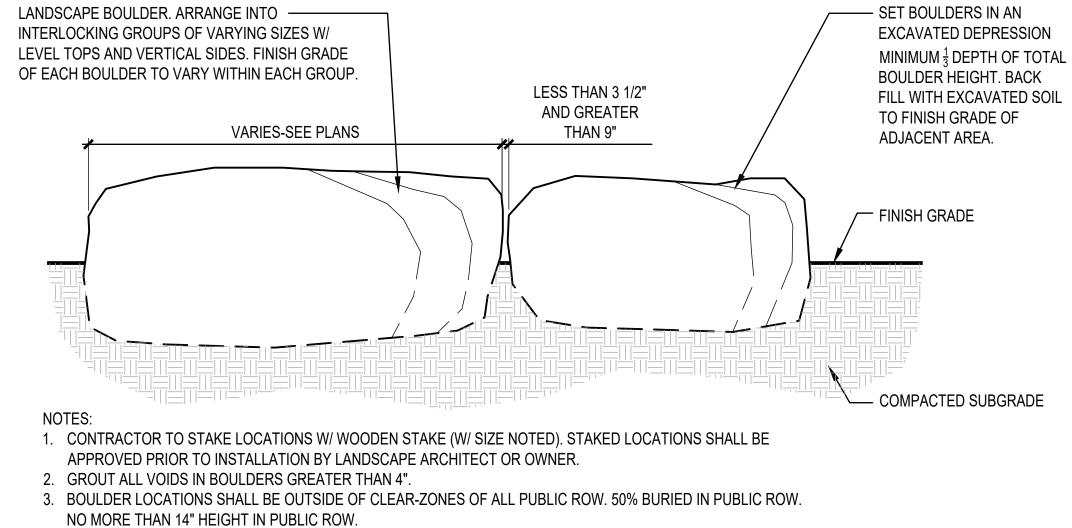

99 ROUTE 6 7600 CENTRAL A ALBUQUERQUE,

> REVIEWED: Approver ALTERNATIVE LANDSCAPE PLAN PROJECT #: 21018 SHEET TITLE:

LANDSCAPE DETAILS



































**HIGH DESERT** 


4/01/024 ALTERNATIVE LANDSCAPE PLAN


LANDSCAPE DETAILS


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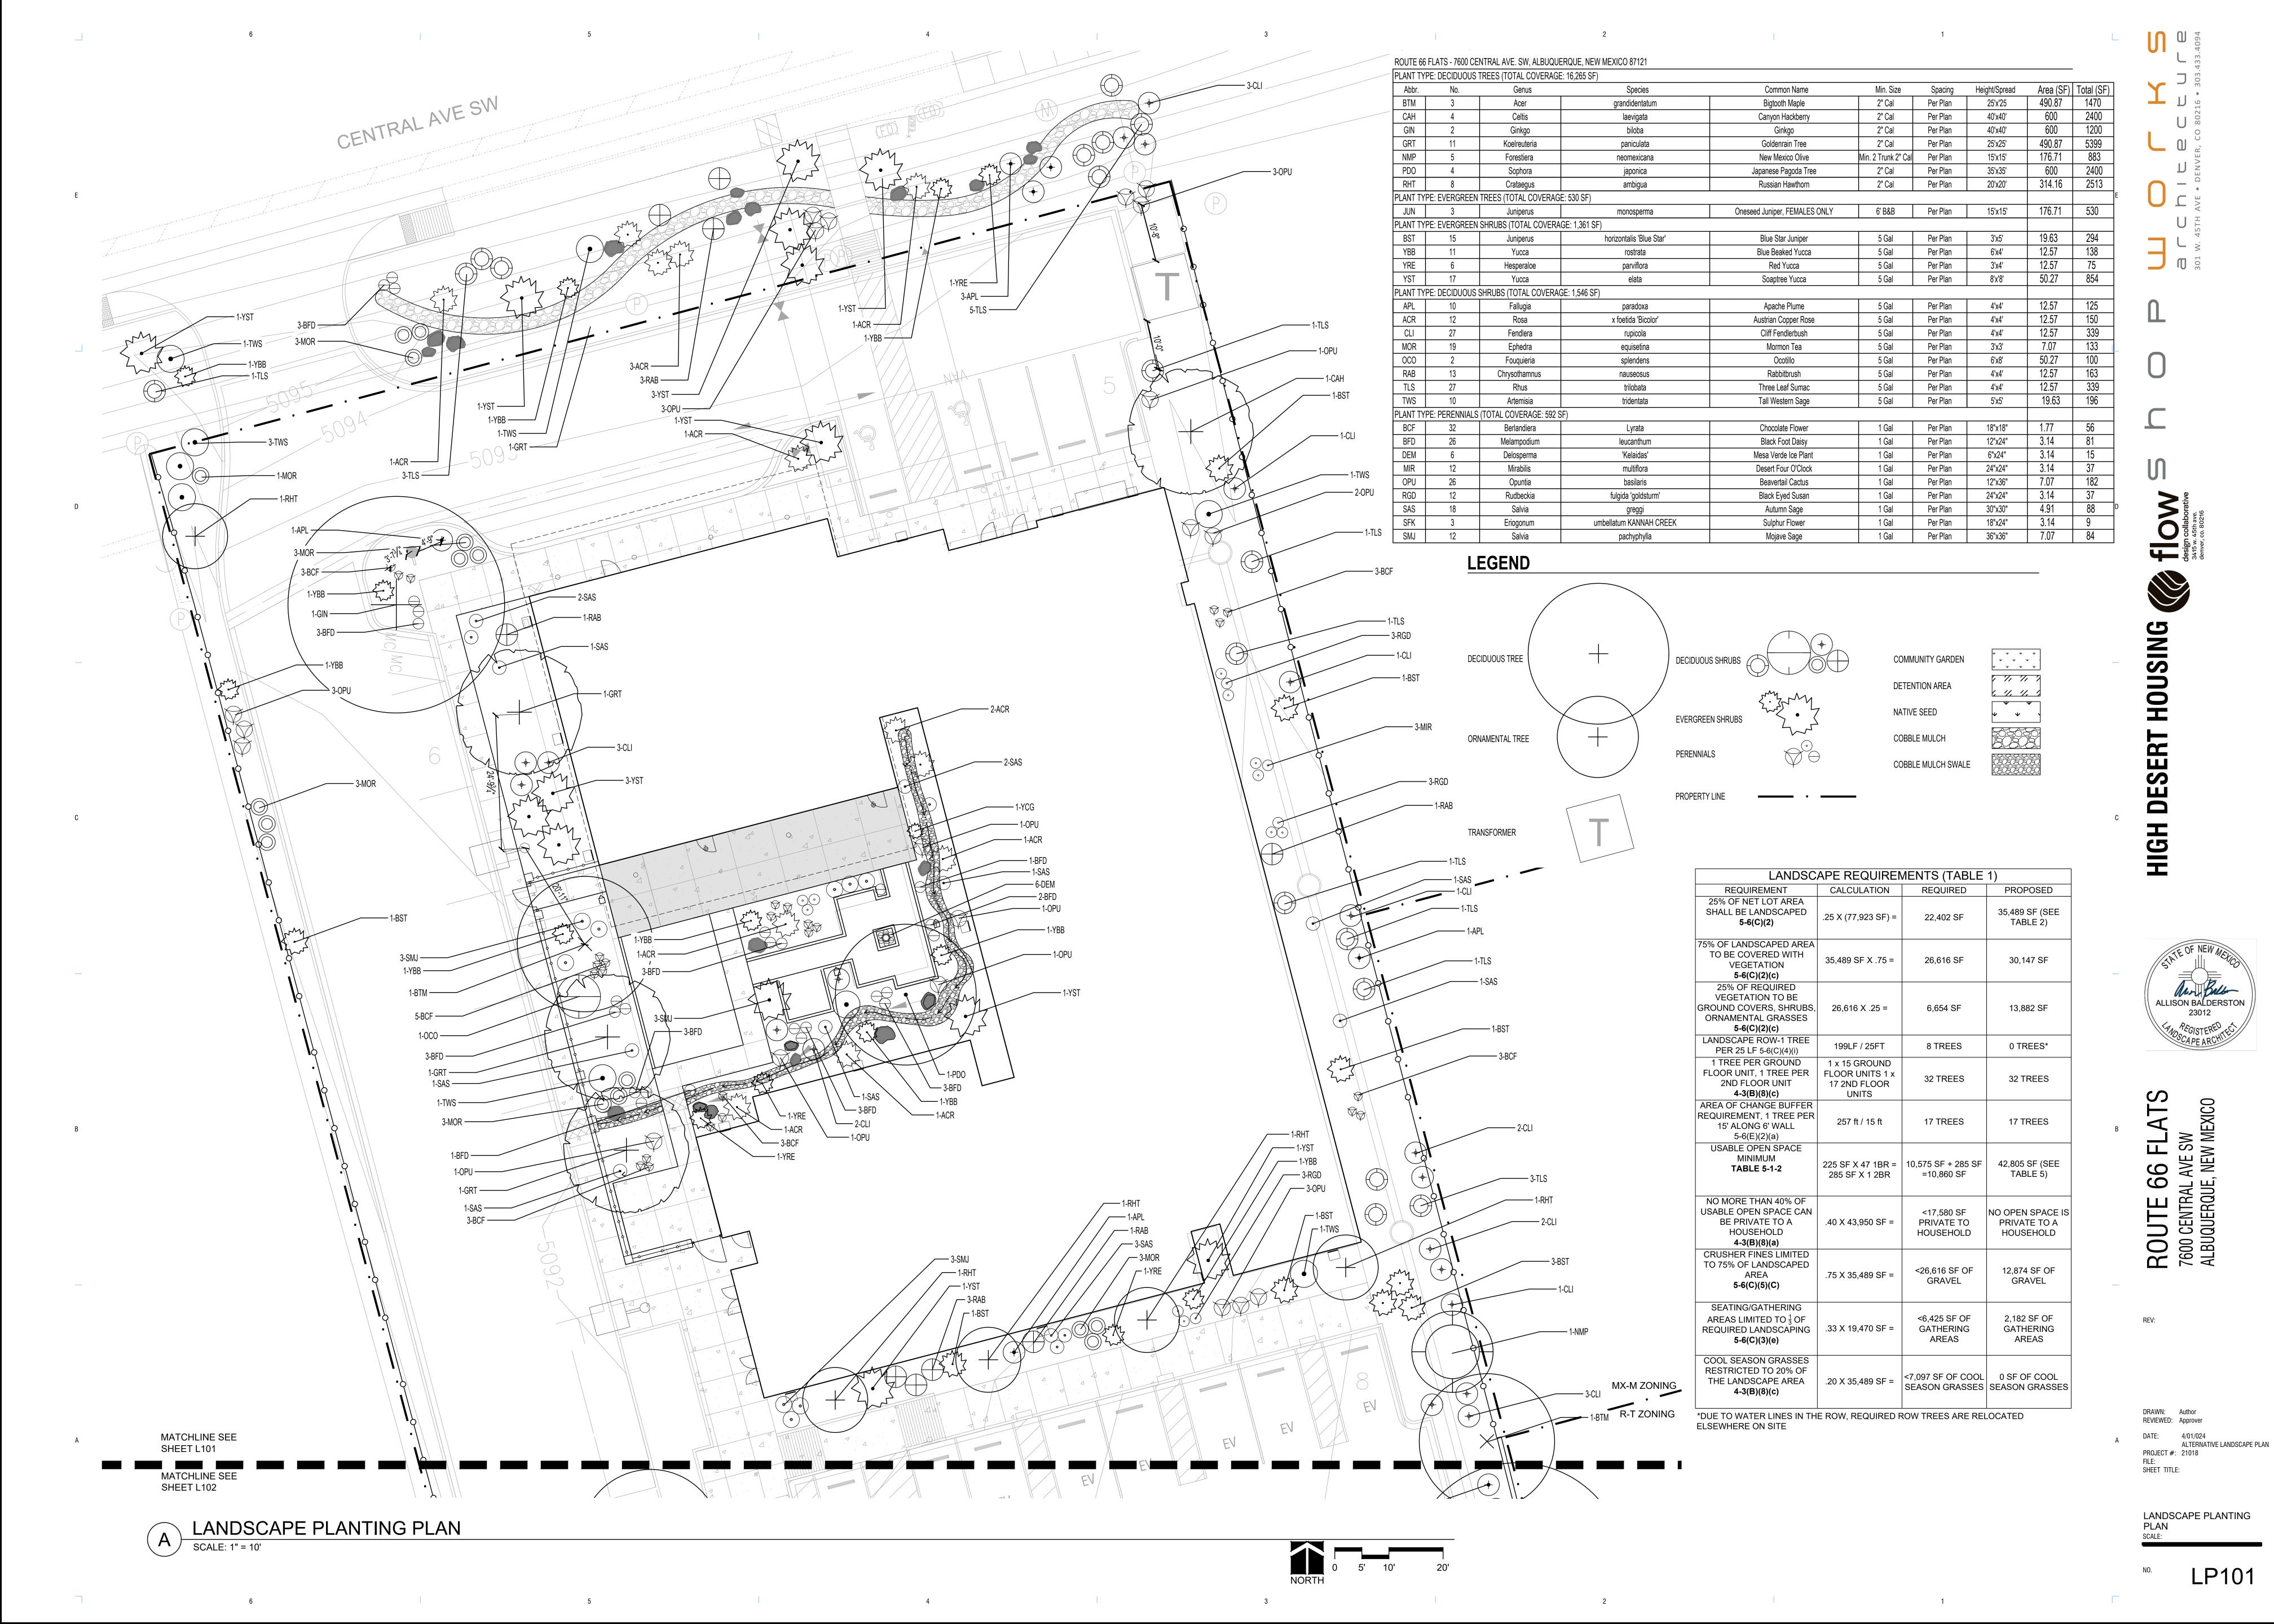








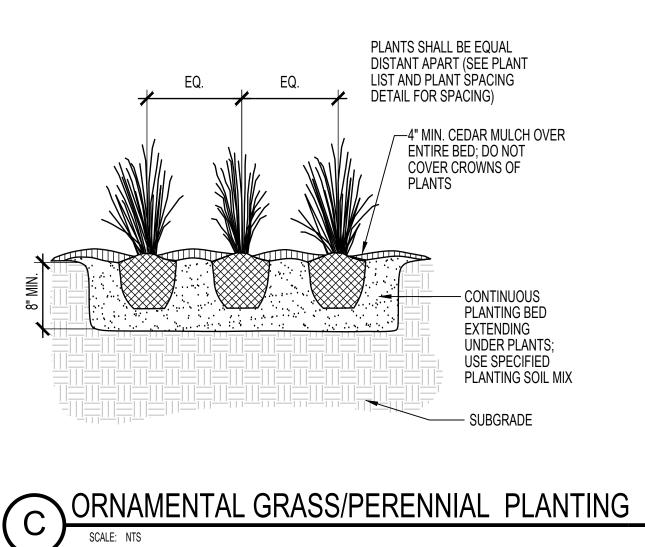

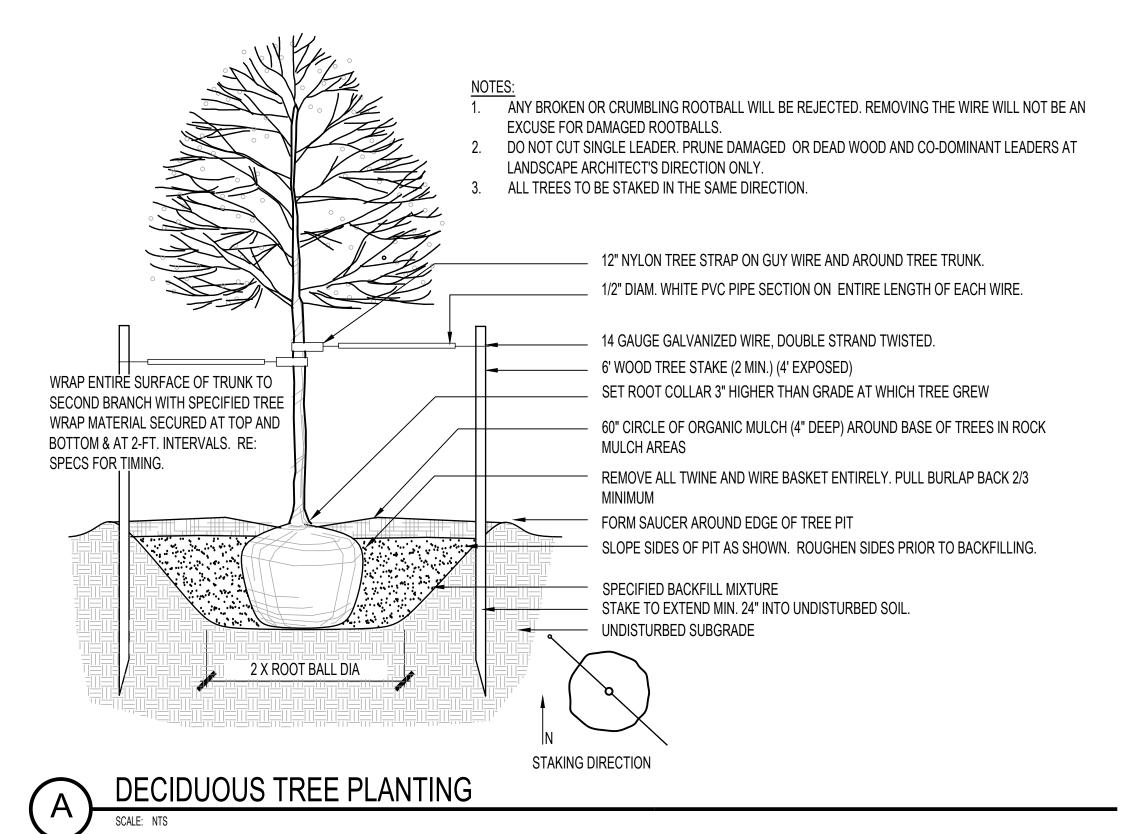

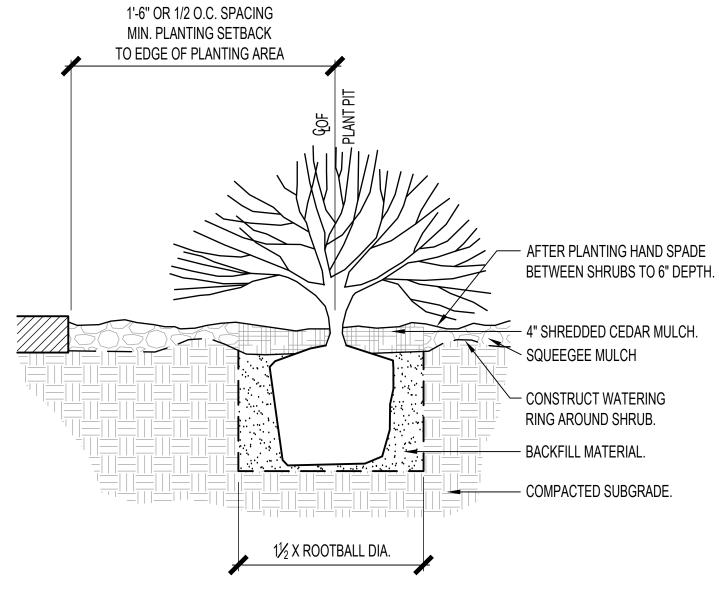

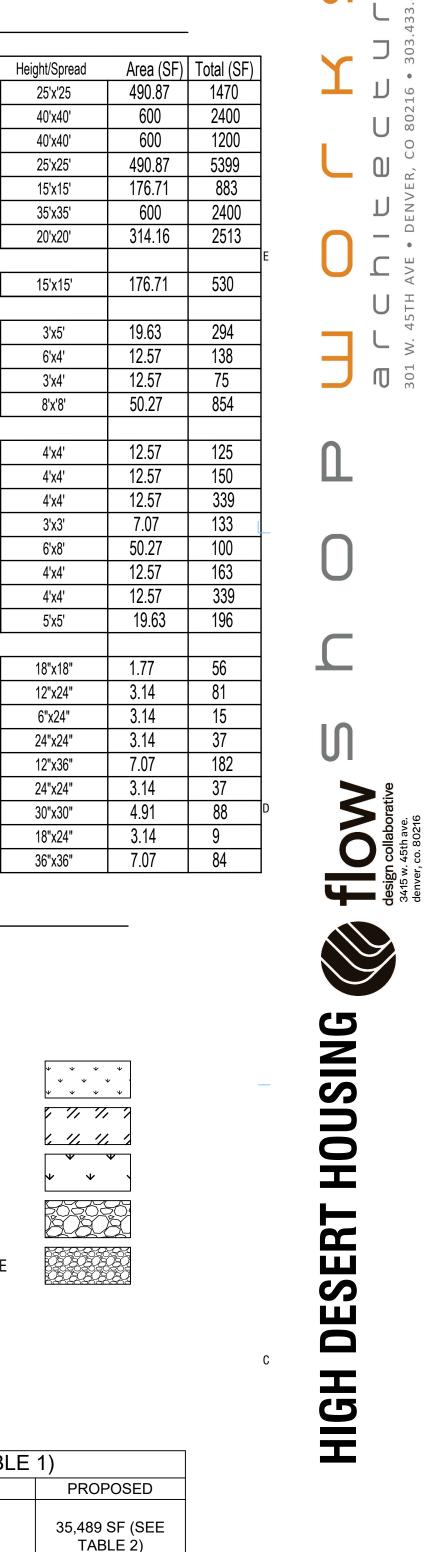

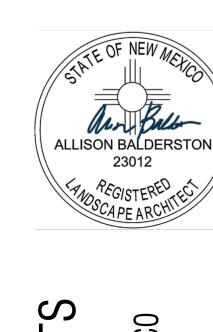




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LP102

FILE: SHEET TITLE: LANDSCAPE PLANTING

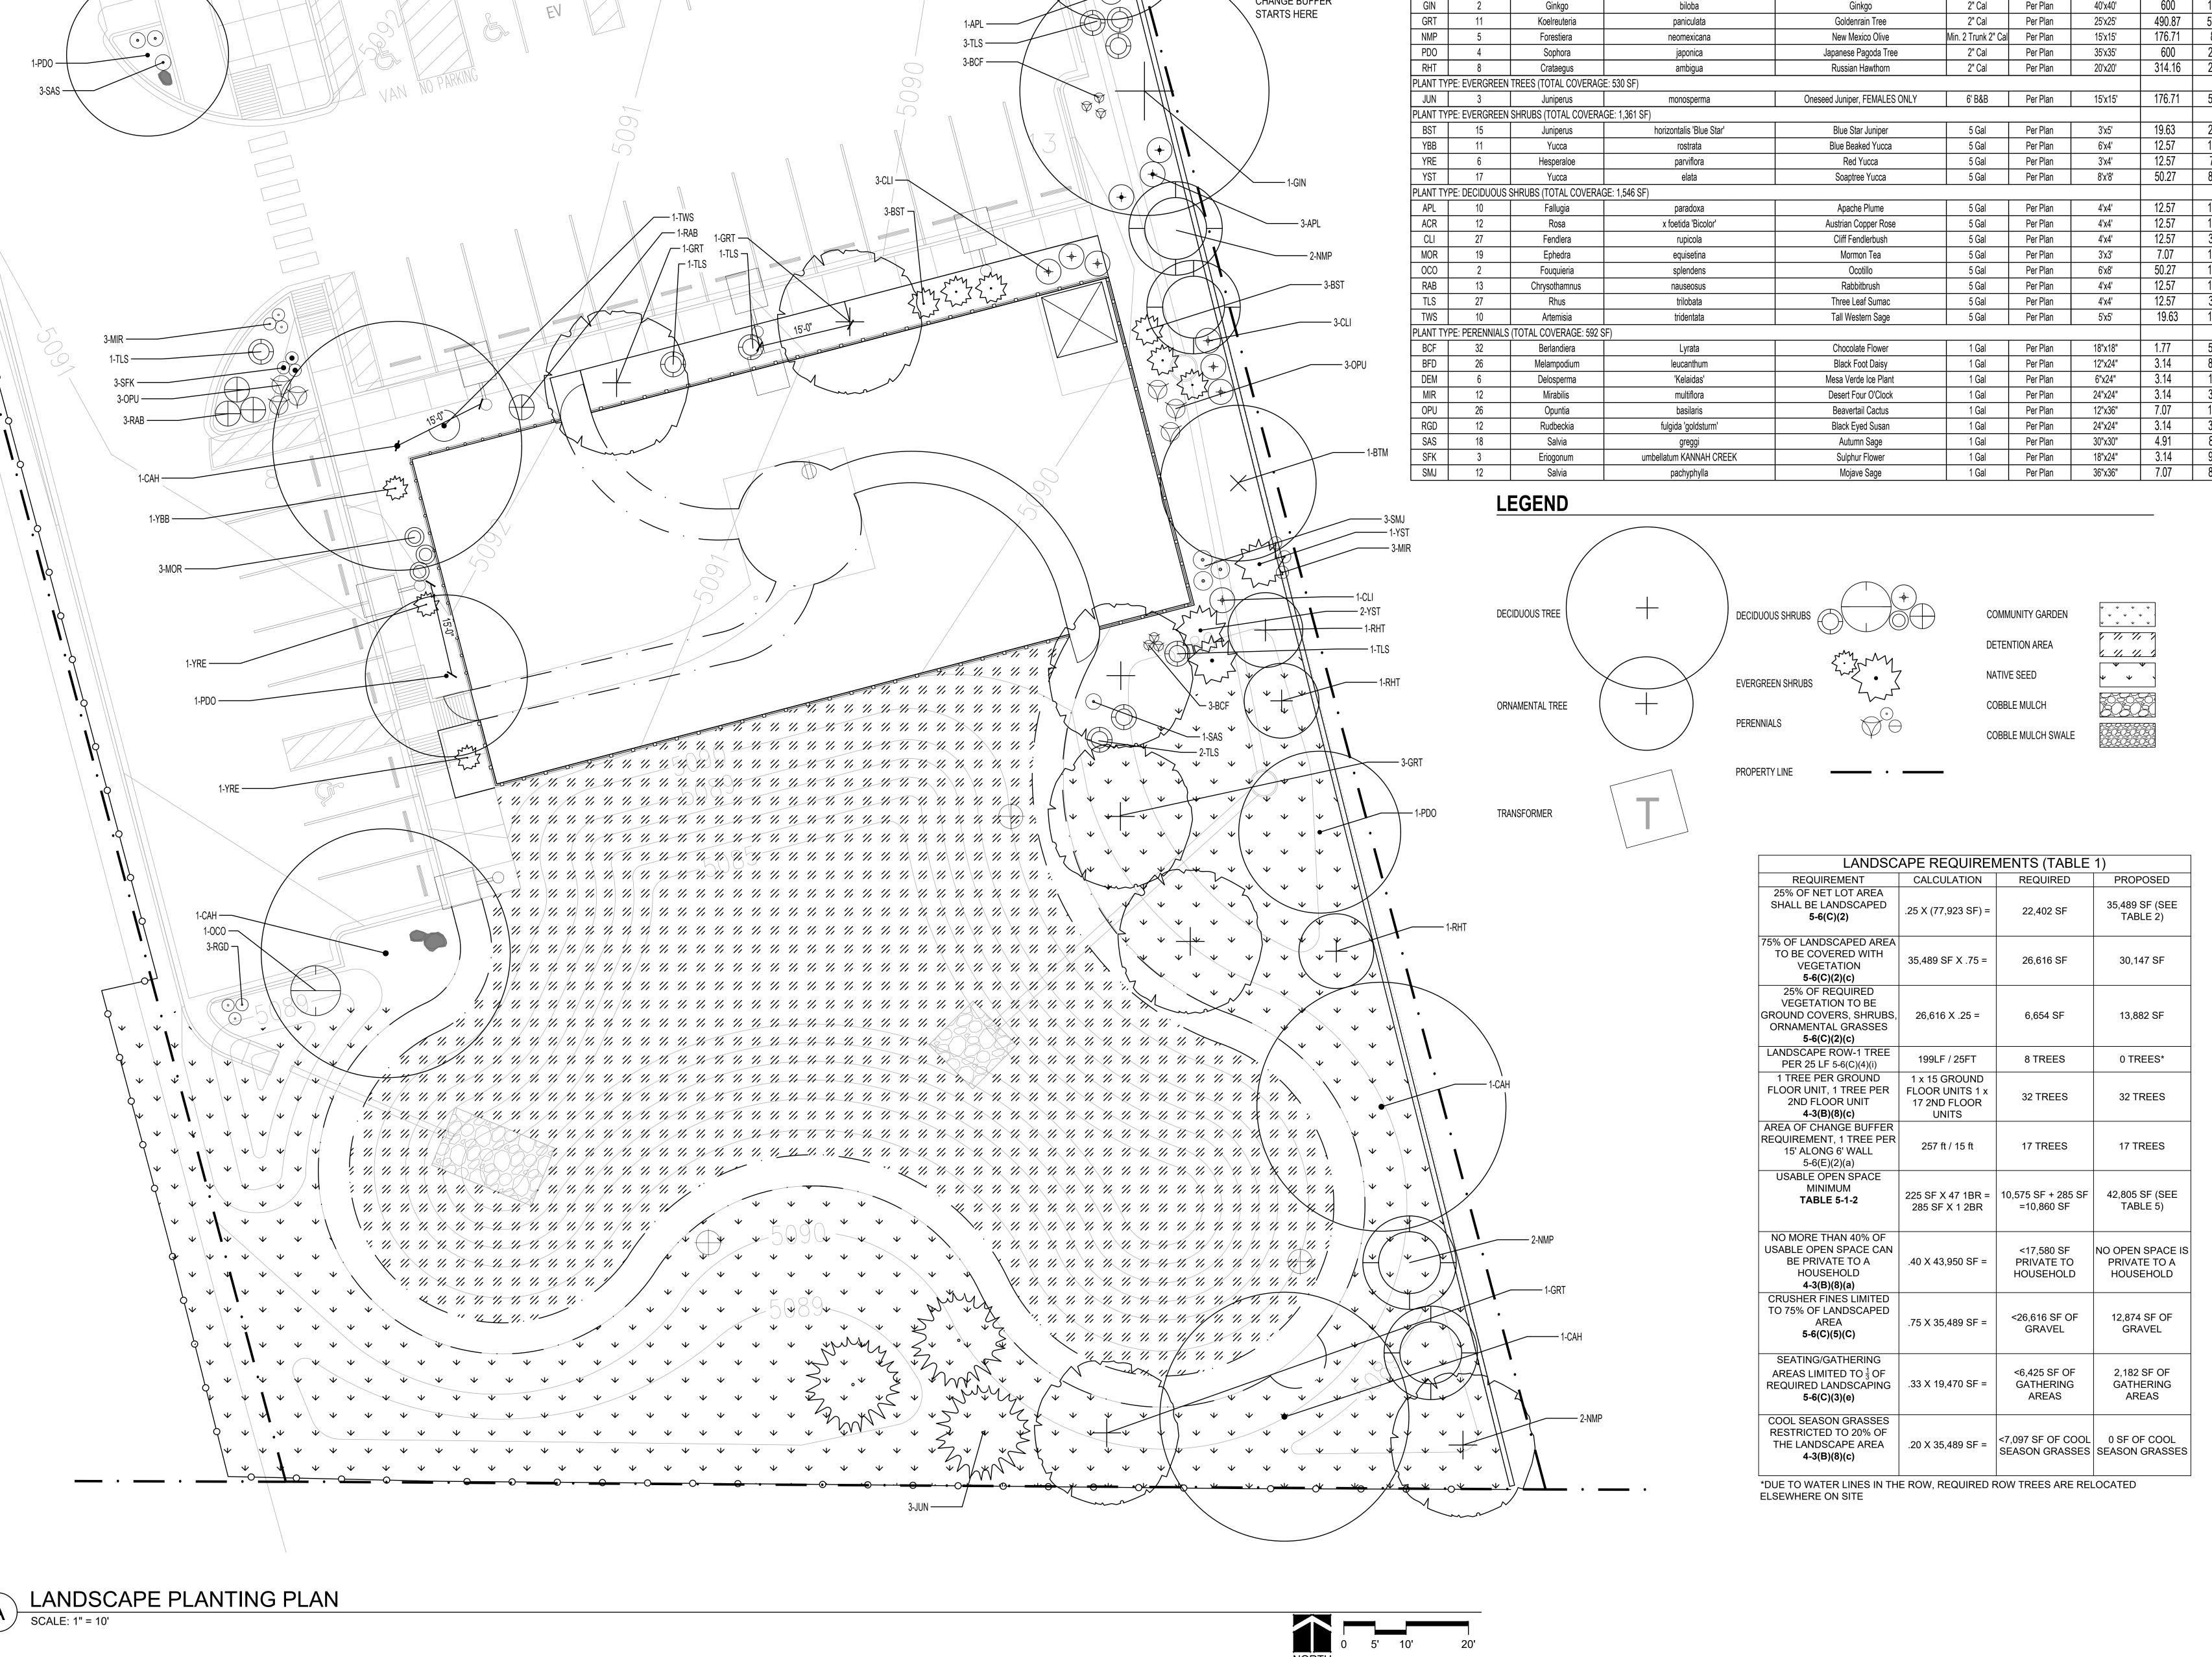

MATCHLINE SEE

SHEET L101

MATCHLINE SEE

SHEET L102

ROUTE 66 FLATS - 7600 CENTRAL AVE. SW, ALBUQUERQUE, NEW MEXICO 87121

Acer

Celtis

Species

grandidentatum

Common Name

Bigtooth Maple

Canyon Hackberry

Min. Size

2" Cal

2" Cal

Spacing

25'x'25

40'x40'

Per Plan

Per Plan

PLANT TYPE: DECIDUOUS TREES (TOTAL COVERAGE: 16,265 SF)

BTM

CAH

- R-T ZONE AREA OF

CHANGE BUFFER

### GENERAL IRRIGATION NOTES

- 1. THE IRRIGATION CONTRACTOR SHALL BECOME THOROUGHLY FAMILIAR WITH THE SPECIFICATIONS FOR THIS AND RELATED WORK PRIOR TO CONSTRUCTION.
- 2. THE CONTRACTOR SHALL PROVIDE FOR UNINTERRUPTED LANDSCAPE WATERING/IRRIGATION THROUGHOUT THE CONSTRUCTION PERIOD UNTIL SITE IS TRANSFERRED TO THE OWNER AND PER WRITTEN SPECIFICATIONS.
- 3. IF DISCREPANCIES EXIST BETWEEN THE DRAWINGS AND THE ACTUAL CONDITIONS IT IS THE CONTRACTORS RESPONSIBILITY TO NOTIFY THE LANDSCAPE ARCHITECT.
- 4. INSTALL POP-UP TYPE SPRINKLER HEADS IN LAWN AREAS SO THAT TOP OF SPRINKLER HEAD IS 1.5" AWAY FROM ADJACENT SIDEWALK OR CURB.
- 5. SET SPRINKLER HEADS PERPENDICULAR TO FINISH GRADE OF AREA TO BE IRRIGATED UNLESS OTHERWISE INDICATED ON DRAWINGS.
- 6. WHEN VERTICAL OBSTRUCTIONS (FIRE HYDRANTS, TREES, LIGHTS, ETC.) INTERFERE WITH SPRAY PATTERN OF SPRINKLER HEADS SO AS TO PREVENT PROPER COVERAGE, ADJUST SPRINKLER SYSTEM BY INSTALLING A QUARTER CIRCLE, HALF CIRCLE, OR ADJUSTABLE CIRCLE SPRINKLER HEAD ON EACH SIDE OF OBSTRUCTION SO AS TO PROVIDE PROPER COVERAGE. PERFORM ADJUSTMENTS AT NO COST TO OWNERS AUTHORIZED REPRESENTATIVE..
- 7. SPRINKLER SYSTEM DESIGN IS BASED ON MINIMUM OPERATING PRESSURE AND MAXIMUM FLOW DEMAND SHOWN ON IRRIGATION DRAWINGS AT THE PROPOSED POINT OF CONNECTION. VERIFY WATER PRESSURE PRIOR TO CONSTRUCTION. REPORT DIFFERENCES BETWEEN WATER PRESSURE INDICATED ON DRAWINGS AND ACTUAL PRESSURE READING AT IRRIGATION POINT-OF-CONNECTION TO OWNER'S AUTHORIZED REPRESENTATIVE. IN THE EVENT PRESSURE DIFFERENCES ARE NOT REPORTED PRIOR TO START OF CONSTRUCTION, CONTRACTOR ASSUMES FULL RESPONSIBILITY FOR REVISIONS.
- 8. THIS DESIGN IS DIAGRAMMATIC. PIPING, VALVES, ETC. MAY BE SHOWN WITHIN PAVED AREAS FOR DESIGN CLARIFICATION ONLY AND SHALL BE INSTALLED IN PLANTING AREAS WHERE POSSIBLE. AVOID CONFLICTS BETWEEN SPRINKLER SYSTEM, PLANTING, AND ARCHITECTURAL FEATURES. VALVE BOXES SHALL BE LOCATED TO BE AS INCONSPICUOUS AS POSSIBLE, WHILE STILL FULFILLING THE DESIGN INTENT. NO VALVE BOXES SHALL BE PLACED WITHIN PLAY FIELD AREAS.
- 9. FLUSH AND ADJUST SPRINKLER HEADS FOR OPTIMUM PERFORMANCE AND TO PREVENT OVER SPRAY ONTO WALKS, ROADWAYS, AND BUILDINGS. THIS INCLUDES SELECTING THE BEST DEGREE OF ARC TO FIT SITE CONDITIONS AND TO THROTTLE FLOW CONTROL AT EACH VALVE TO OBTAIN OPTIMUM PRESSURE FOR EACH SYSTEM.
- 10. DO NOT WILLFULLY INSTALL SPRINKLER SYSTEM AS INDICATED ON DRAWINGS WHEN IT IS OBVIOUS IN FIELD THAT OBSTRUCTIONS OR GRADE DIFFERENCES IN AREA DIMENSIONS EXIST THAT MIGHT NOT HAVE BEEN CONSIDERED DURING DESIGN. BRING SUCH OBSTRUCTIONS OR DIFFERENCES TO THE ATTENTION OF OWNER'S AUTHORIZED REPRESENTATIVE. IN EVENT THIS NOTIFICATION IS NOT PERFORMED, CONTRACTOR ASSUMES FULL RESPONSIBILITY FOR REVISIONS.
- 11. INSTALL PIPE MATERIALS AND EQUIPMENT AS SHOWN IN DETAILS. USE TEFLON TAPE ON PVC MALE PIPE THREADS ON SPRINKLER SWING JOINT AND VALVE ASSEMBLIES.
- 12. IT IS THE CONTRACTOR'S RESPONSIBILITY TO BECOME FAMILIAR WITH GRADE DIFFERENCES, LOCATION OF WALLS, RETAINING WALLS, ETC. COORDINATE WORK WITH GENERAL CONTRACTOR AND OTHER SUB-CONTRACTORS FOR LOCATION AND INSTALLATION OF PIPE SLEEVES THROUGH WALLS, UNDER ROADWAYS, PAVING, STRUCTURES, ETC.
- 13. IN ADDITION TO SLEEVES SHOWN ON THE DRAWINGS, CONTRACTOR IS RESPONSIBLE FOR THE INSTALLATION OF PIPE SLEEVING AND SEPARATE CONTROL WIRE SLEEVES OF SUFFICIENT SIZE UNDER PAVED AREAS.
- 14. THE FOLLOWING SHOULD BE NOTED REGARDING PIPE SIZING: IF A SECTION OF UN-SIZED LATERAL IS LOCATED BETWEEN TWO IDENTICALLY SIZED SECTIONS THE UN-SIZED SECTION SHALL BE OF THE SAME SIZE. IN NO CASE SHALL A SECTION OF PIPE BE SMALLER THAN ANY DOWNSTREAM SECTION LOCATED ON THE SAME LATERAL
- 15. PER 5-6(C)(14)(A) IRRIGATION SYSTEMS SHALL COMPLY WITH SECTION 8 OF THE ABCWUA LEGISLATION AND ORDINANCES (CROSS CONNECTION PREVENTION AND CONTROL ORDINANCE).
- 16. PER 5-6(C)(14)(B) ALL IRRIGATION SYSTEMS SHALL BE DESIGNED TO MINIMIZE THE USE OF WATER.
- 17. PER 5-6(C)(14)(C) ALL NON-RESIDENTIAL LANDSCAPE IRRIGATION SHALL HAVE AUTOMATIC TIMERS AND/OR PROGRAMMABLE SETTINGS TO AVOID OVERWATERING.
- 18. PER 5-6(C)(14)(D) THE IRRIGATION SYSTEM SHALL NOT SPRAY OR IRRIGATE IMPERVIOUS SURFACES, INCLUDING SIDEWALKS, DRIVEWAYS, DRIVE AISLES, STREETS, AND PARKING AND LOADING AREAS.
- 19. PER 5-6(C)(15)(C) ANY DAMAGE TO UTILITY LINES RESULTING FROM THE NEGLIGENCE OF THE ABUTTING PROPERTY OWNER OR THE PROPERTY OWNER'S AGENTS OR EMPLOYEES IN THE INSTALLATION AND MAINTENANCE OF ANY LANDSCAPING, SCREENING, OR BUFFERING IN A PUBLIC RIGHT-OF-WAY, PRIVATE WAY, OR EASEMENT SHALL BE THE RESPONSIBILITY OF SUCH PROPERTY OWNER. ANY DAMAGE TO UTILITY LINES RESULTING FROM THE GROWTH OF PLANT MATERIALS THAT HAVE BEEN APPROVED BY THE APPLICABLE PUBLIC UTILITY AS PART OF A PLAN FOR LANDSCAPING, SCREENING, OR BUFFERING ON THE PUBLIC RIGHT-OF-WAY, SHALL BE THE RESPONSIBILITY OF SUCH PUBLIC UTILITY. IF A PUBLIC UTILITY DISTURBS LANDSCAPING, SCREENING, OR BUFFERING IN A PUBLIC RIGHT-OF-WAY, PRIVATE WAY, OR EASEMENT, IT SHALL MAKE EVERY REASONABLE EFFORT TO PRESERVE THE LANDSCAPING MATERIALS AND RETURN THEM TO THEIR PRIOR LOCATIONS AFTER THE UTILITY WORK. IF THE PLANT MATERIALS DIE DESPITE THOSE EFFORTS, IT IS THE OBLIGATION OF THE ABUTTING PROPERTY OWNER TO REPLACE THE PLANT MATERIALS.
- 20. PER 5-6(C)(15)(D) PROPERTY OWNERS ACKNOWLEDGE THAT APPROVED LANDSCAPING AND TREES INSTALLED AND MAINTAINED IN A PUBLIC RIGHT-OF-WAY, PRIVATE WAY, OR EASEMENT ABUTTING PRIVATE PROPERTIES ARE THE PROPERTY OF THE CITY, AND THAT THAT THE CITY RESERVES THE RIGHT TO REMOVE THEM IF NECESSARY FOR A TRANSPORTATION PROJECT WITHOUT COMPENSATION, BUT AT NO COST TO THE PROPERTY OWNER. LANDSCAPING INSTALLED IN AN ABUTTING PUBLIC RIGHT-OF-WAY, PRIVATE WAY, OR EASEMENT BY PROPERTY OWNERS AND LATER REMOVED BY THE CITY SHALL NOT IMPACT PREVIOUSLY APPROVED NET LOT AREA CALCULATIONS FOR REQUIRED LANDSCAPING.

# PLANTING IRRIGATION NOTES

- 1. PROVIDE PIPE AND SPACING PER SCHEDULE TO ALL PLANT MATERIAL SERVED BY DRIP LINE IRRIGATION SYSTEM.
- 2. DRIPPERLINE IS INTENDED TO IRRIGATE PLANT MATERIAL BY PLANT TYPE IN ORDER TO APPLY APPROPRIATE AMOUNTS OF WATER AS NEEDED FOR PROPER PLANT GROWTH AND PLANT CARE. EXCEPTIONS TO PLANT MATERIAL SYSTEM SEPARATIONS ARE NOTED WITH VALVE CALLOUTS ON PLAN. ADJUSTMENTS MAY BE NECESSARY AS PLANT MATERIAL ESTABLISHES.
- 3. IRRIGATION AREAS ARE SHOWN DIAGRAMMATIC FOR CLARITY. INSTALL ALL PIPING IN LANDSCAPE PLANTING AREAS.
- 4. INSTALL SUPPLY LATERAL WITHIN PVC SLEEVE WHEN ROUTING THROUGH PAVED SURFACES OR THROUGH PLANTER'S WALLS.
- 5. PROVIDE ONE (1) FLUSH-VALVE ASSEMBLY AT EACH END OF DRIP SYSTEM OR AS SHOWN ON DETAILS. LOCATE FLUSH-VALVE ASSEMBLY BOXES ADJACENT TO PLANTING BORDERS OR PAVING EDGES FOR MAINTENANCE CONVENIENCE.
- 6. EACH EMITTER SHALL HAVE THE ABILITY TO INDEPENDENTLY REGULATE DISCHARGE RATES, WITH AN INLET PRESSURE RANGE OF 14.5 58 POUNDS PER SQUARE INCH (PSI), AT A CONSTANT FLOW AND WITH A MANUFACTURER'S COEFFICIENT OF VARIABILITY (CV) OF 0.03 OR LESS.

# LANDSCAPE IRRIGATION NARRATIVE


- 1. PLANT MATERIAL WILL BE GROUPED INTO LATERAL ZONES BASED ON SIMILAR WATER REQUIREMENTS TO REDUCE OVERALL WATER CONSUMPTION WHILE ALLOWING PLANTS TO SUSTAIN HEALTHY, VIGOROUS GROWTH.
- 2. TURF AREAS WILL BE IRRIGATED USING 6" POP-UP ROTATOR TYPE SPRINKLER HEADS.
- 3. ALL AREAS LOCATED OFF-SITE DISTURBED THROUGH PROJECT INFRASTRUCTURE CONSTRUCTION ARE TO BE RE-SEEDED. ALL RE-SEEDED AREAS TO BE IRRIGATED BY WATER TRUCK OR OTHER MEANS OF SUPPLEMENTAL WATERING UNTIL FINAL ESTABLISHMENT.

# EQUIPMENT SCHEDULE

SYMBOL	DESCRIPTION
	SLEEVING: CLASS 200 PVC PROVIDE SEPARATE 2" MIN. SLEEVE FOR WIRING
	MAINLINE PIPE: CLASS 200 BE PVC - 1.5"
	- DRIPPER LINE SUPPLY LATERAL PIPE: CLASS 200 BE PVC (1-INCH UNLESS OTHERWISE INDICATED)
	UNCONNECTED PIPE CROSSING
BF	BACKFLOW DEVICE RE:PLUMBIING
D	DRAIN VALVE
H	FROST FREE GARDEN HYDRANT
	ISOLATION GATE VALVE ASSEMBLY
Q	QUICK COUPLING VALVE ASSEMBLY
•	REMOTE CONTROL VALVE ASSEMBLY FOR SPRINKLER LATERALS (RAIN BIRD PESB-R - SIZED AS INDICATED)
	REMOTE CONTROL VALVE ASSEMBLY FOR DRIPPER LINE LATERALS (RAIN BIRD XCZ-100-PBR-LC) DRIP SUPPLY LATERAL
	PLANT IRRIGATION RING: SIZED PER PLANT NETAFIM TECHLINE CV - TLHCVXR-RW11-12
$\langle A \rangle$	IRRIGATION CONTROLLER: RAIN BIRD ESP-ME3
A 12 1.5 55	INDICATES CONTROLLER AND CONTROLLER STATION NUMBER INDICATES LATERAL DISCHARGE IN GPM OR DRIP INDICATES REMOTE CONTROL VALVE SIZE IN INCHES
WS	WEATHER SENSOR: RAIN BIRD WR-2 RAIN FREEZE

# PIPE SCHEDULE

MAXIMUM FLOW RATE - PVC PLASTIC PIPE
PIPE SIZE MAXIMUM FLOW (GPM)
1" 16

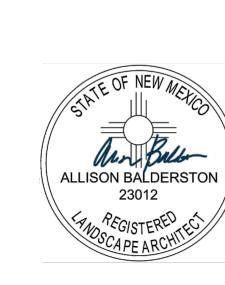

0

H G

OUTE 66 FLAT

REV:

DRAWN: Author
REVIEWED: Approver

DATE: 4/01/024
ALTERNATIVE
PROJECT #: 21018
FILE:
SHEET TITLE:

RIGATION NOT


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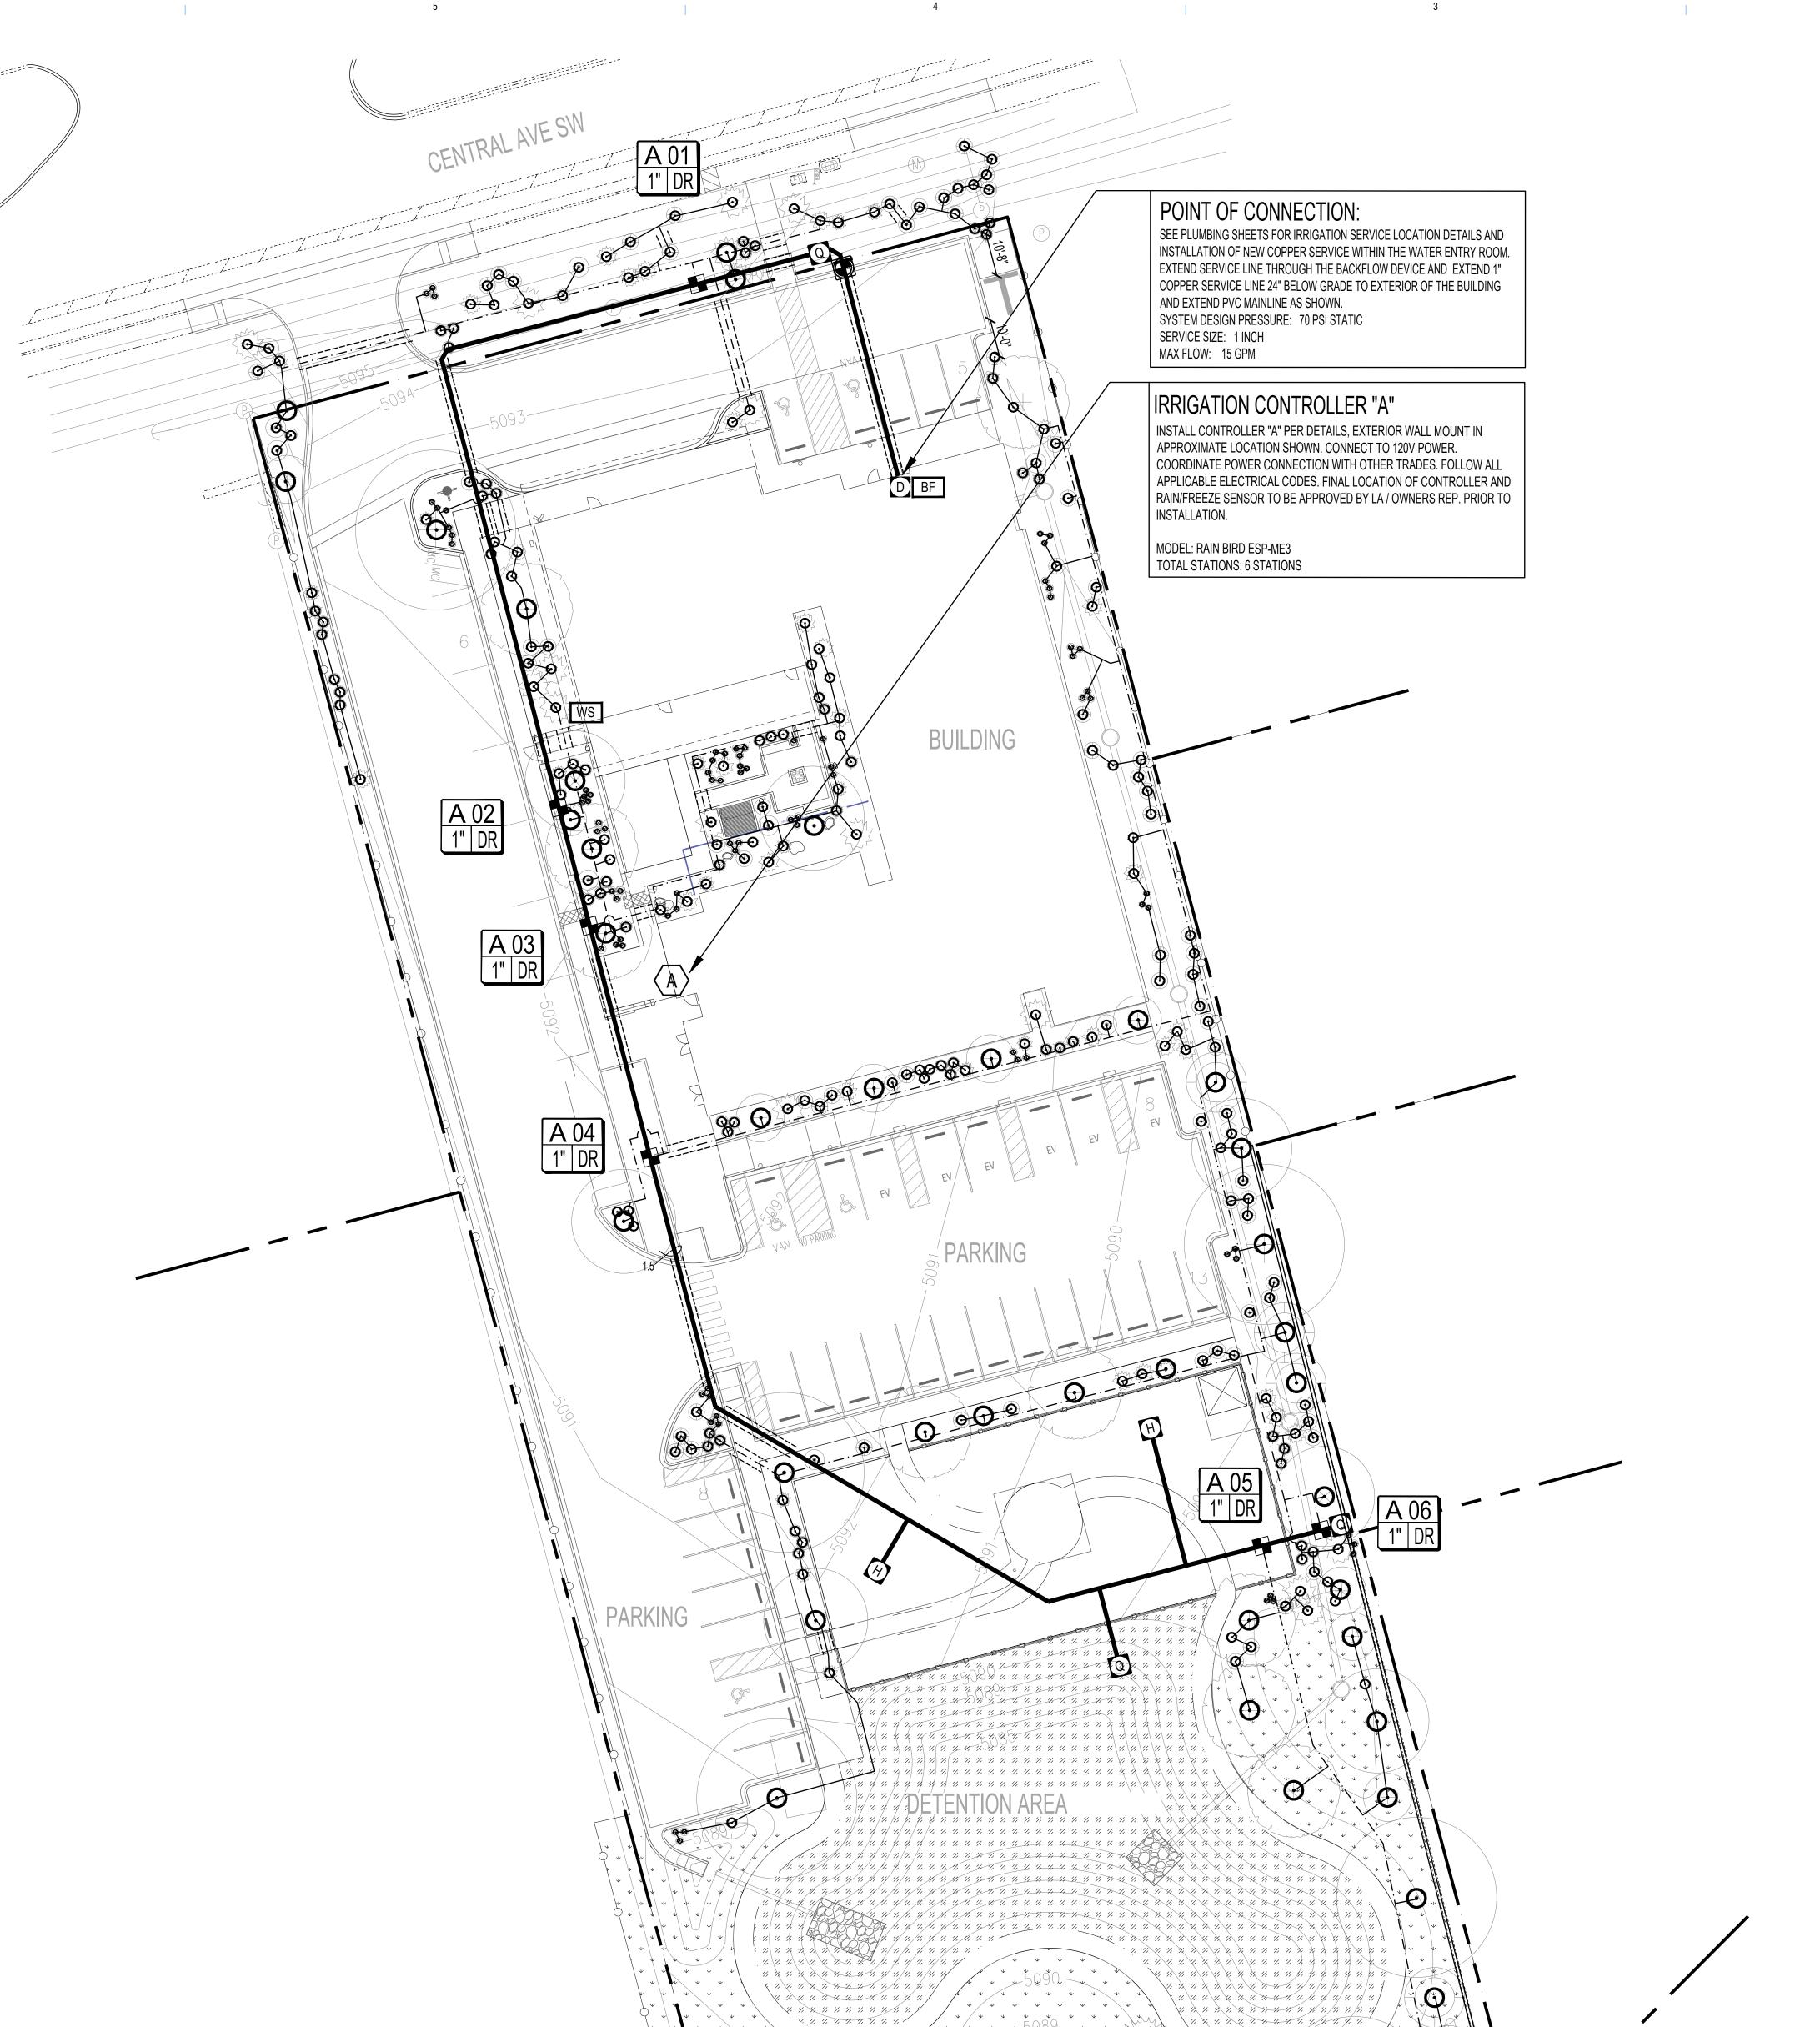
IRRIGATION PLAN


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IR101



PIPE SCH	IEDULE
MAXIMUM FLOW R	ATE - PVC PLASTIC PIPE
PIPE SIZE	MAXIMUM FLOW (GF
1"	16



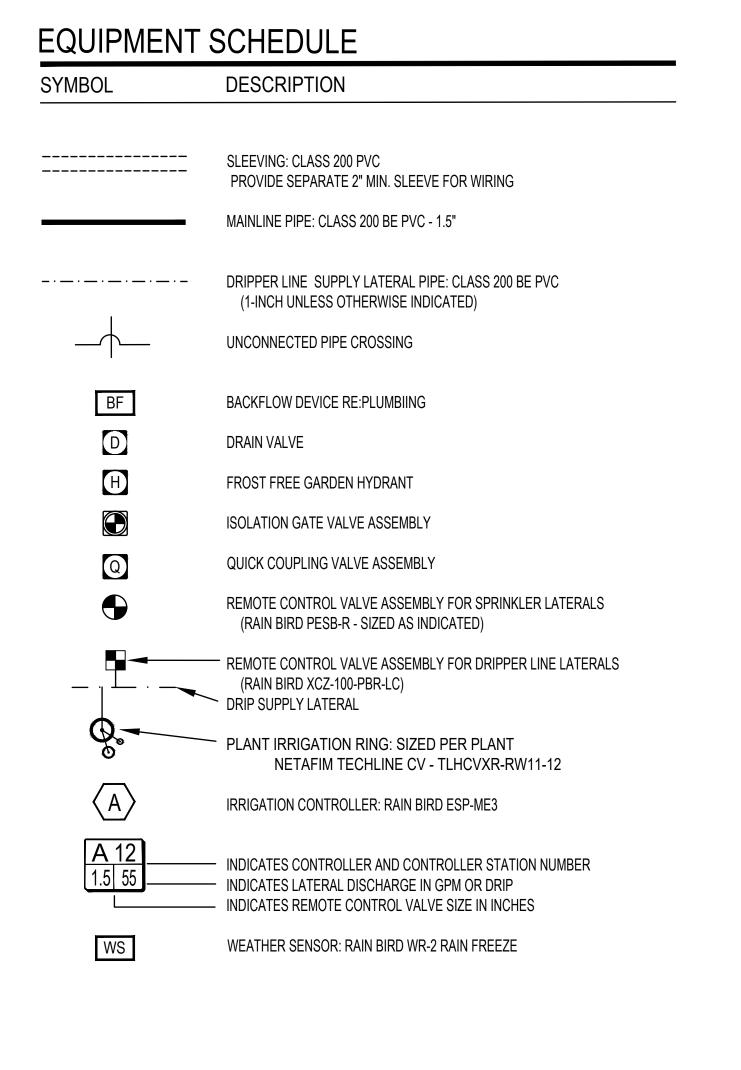

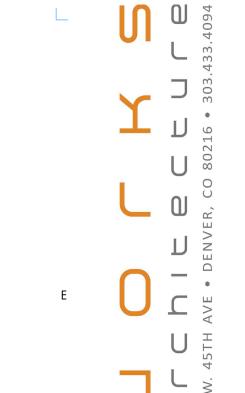




























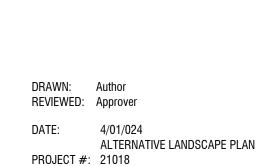


FILE:

SHEET TITLE:

**IRRIGATION DETAILS** 

IR501



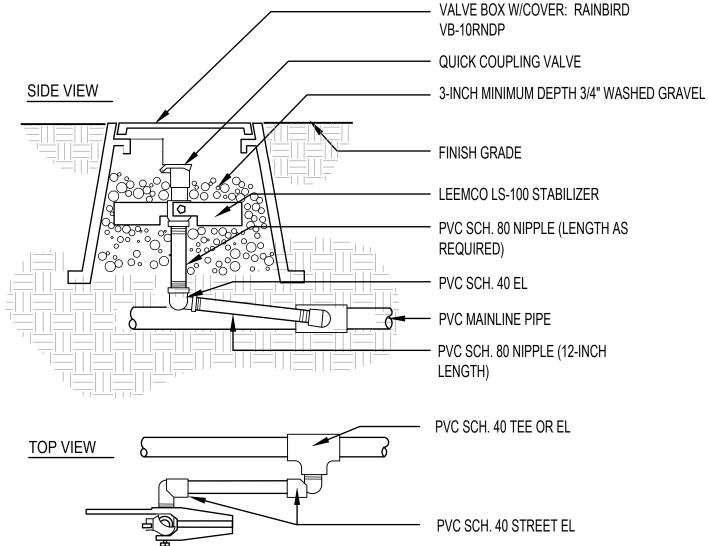

MANUAL FLUSH VALVE ----

MODEL: TLSOV

EXHAUST HEADER ----

- EXTERIOR WALL OR POST

FINAL LOCATION TO BE APPROVED BY THE LANDSCAPE ARCHITECT PRIOR TO INSTALLATION.


INSTALL IN A LOCATION WHERE RAINFALL WILL NOT BE OBSTRUCTED.

- RAIN BIRD WR-2 WIRELESS

RAIN/FREEZE SENSOR

— SPACING FROM

CENTER OF SHRUB

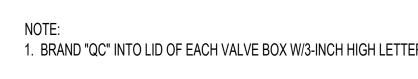


Techline® CV DRIPLINE, ———

0.26 GPH CLAY

0.4 GPH LOAM

0.6 GPH SANDY LOAM

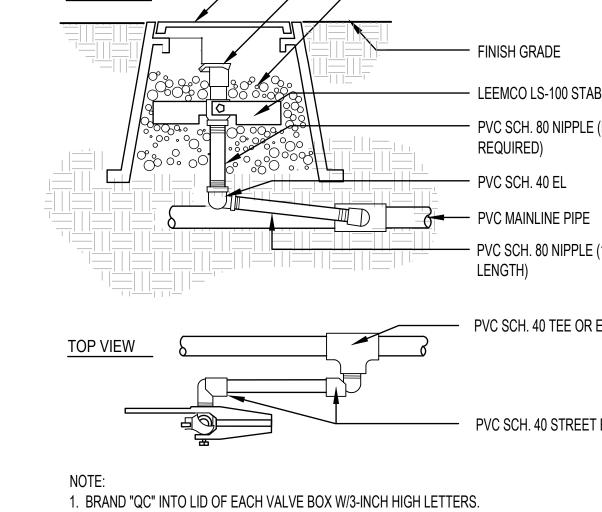



1 - 2"

1 - 3"

PIPE SIZE OR WIRE

1-25 CONTROL WIRES

26-75 CONTROL WIRES

3/4"-1 1/4" PIPE

1 1/2 - 2" PIPE 2 1/2 - 3" PIPE

6" PIPE

8" PIPE


QUANTITY REQUIRED SLEEVE

SLEEVE LOCATION

HARD SURFACE

CL200 PVC SLEEVE. SIZE

MARKING

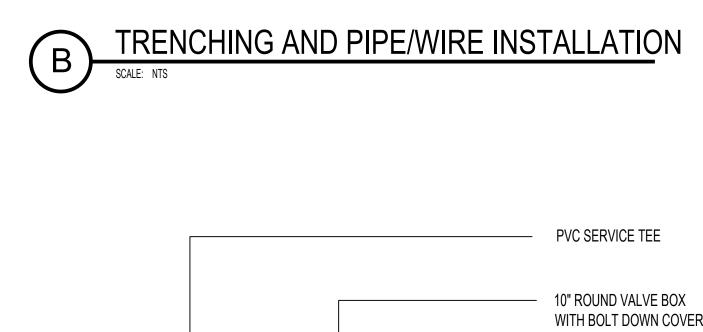

MARKING RIBBON

2. ALL MAINLINE PIPING TO BE INSTALLED IN ACCORDANCE WITH MANUFACTURER'S INSTALLATION SPECIFICATIONS.

3. ROUTE TRENCH MINIMUM 6 FEET FROM ANY TREE PLANTING AND OUTSIDE THE DRIP LINE OF EXISTING TREES.

4. TIE A 20-INCH LOOP IN ALL WIRING AT CHANGES OF DIRECTIONS GREATER THAN 30 DEGREES. UNTIE AFTER ALL


5. BACK FILL MATERIAL TO BE FREE OF ALL DEBRIS AND ROCKS LARGER THAN  $\frac{3}{4}$ " IN DIAMETER.

MAINLINE, LATERAL,


AND WIRING

1. TAPE AND BUNDLE WIRING AT 10-FOOT INTERVALS.


CONNECTIONS HAVE BEEN MADE.

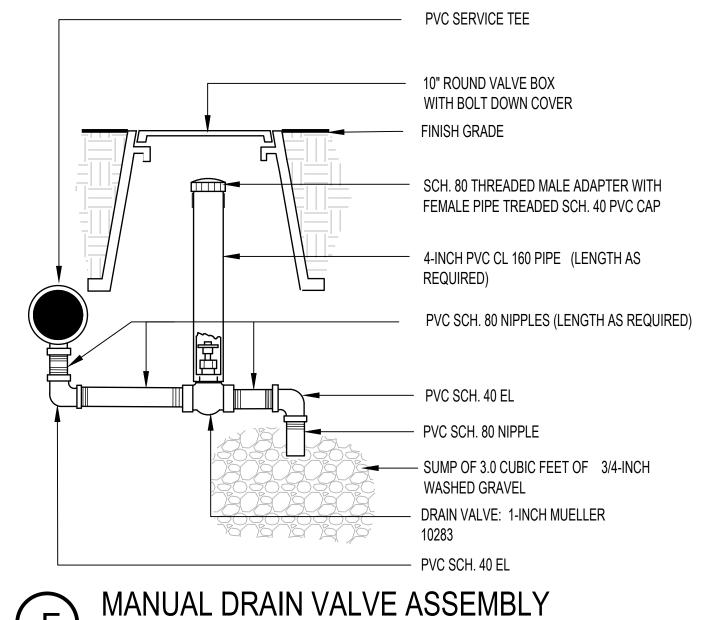


MAINLINE

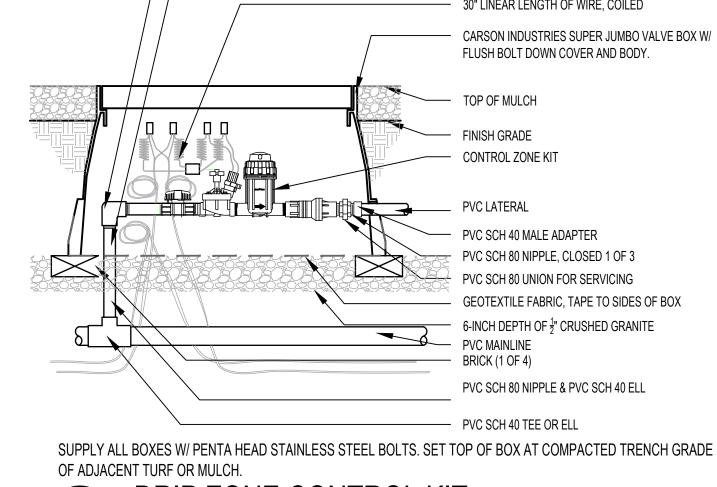





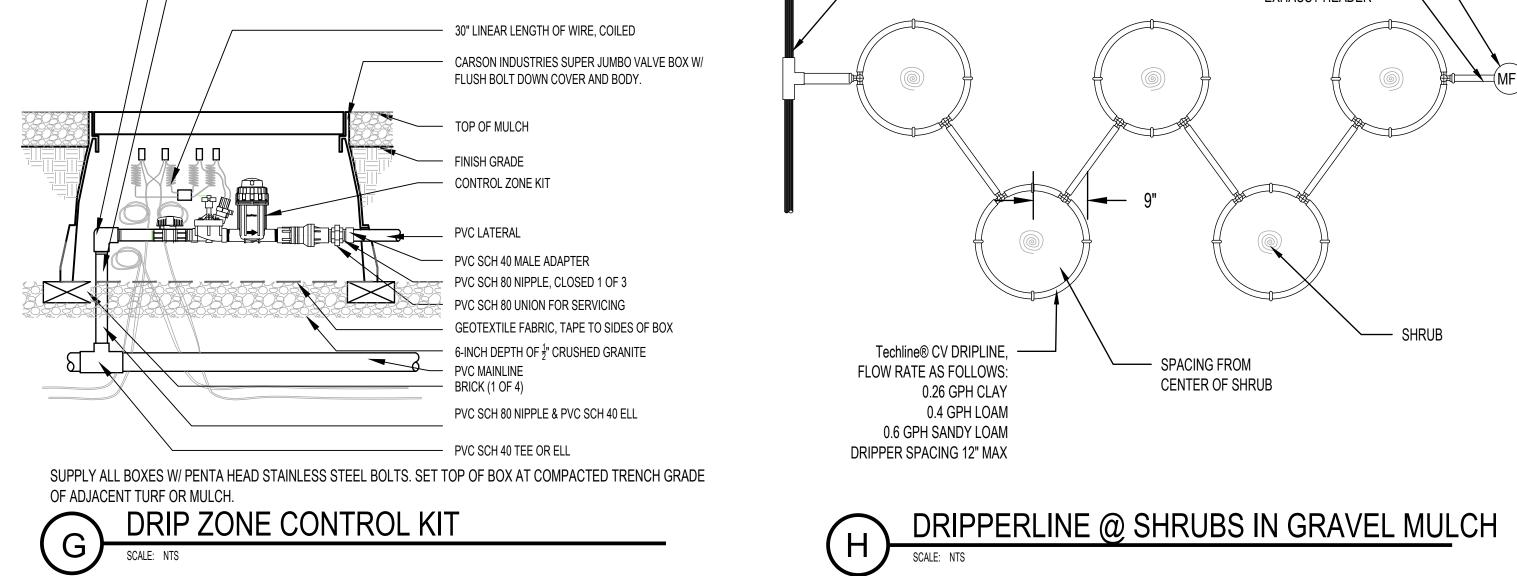


PVC SCH 80 NIPPLE (TYP, LENGTH AS REQUIRED)

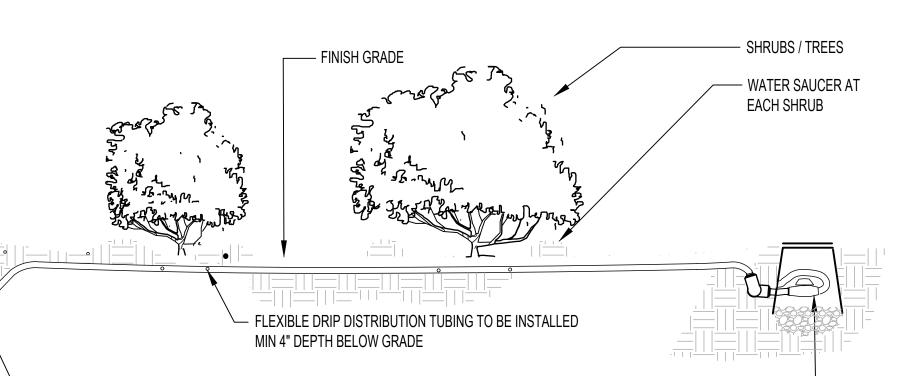


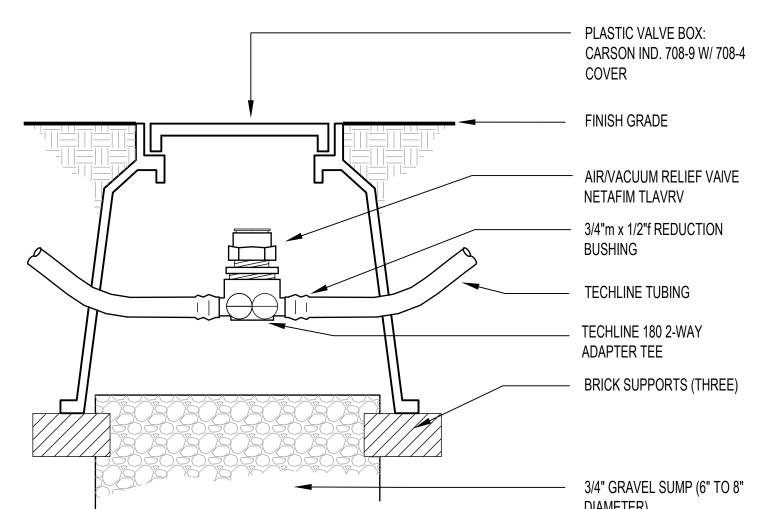

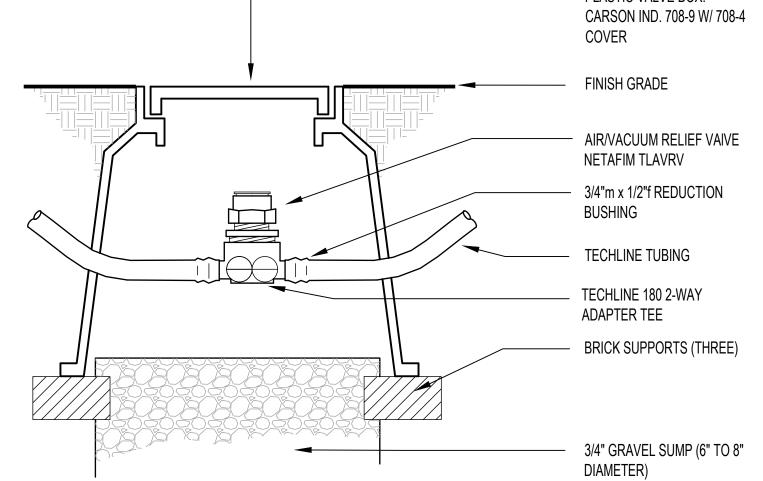

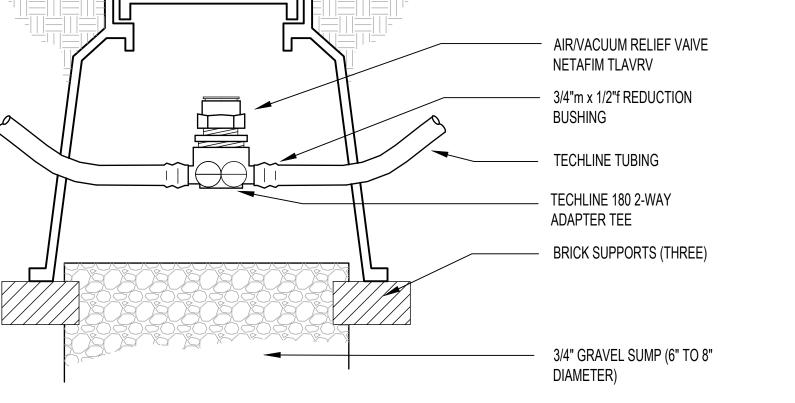



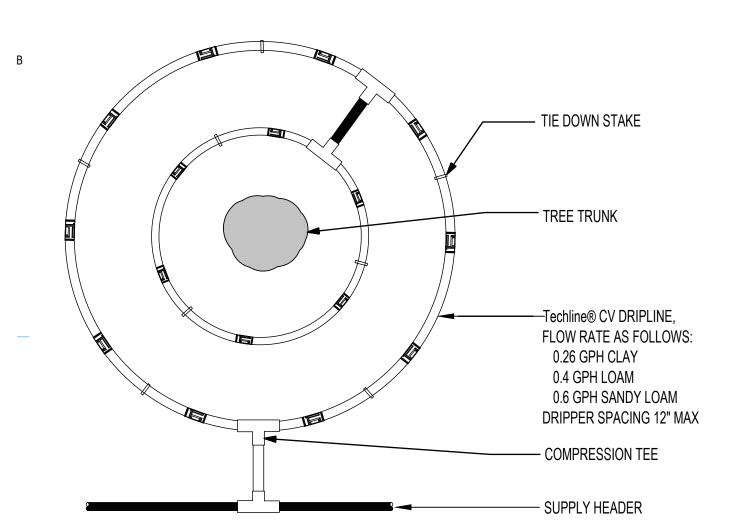

1. LOCATE GATE VALVE AT LEAST 12" FROM, AND ALIGN WITH ADJACENT WALLS OR EDGES OF PAVED

ISOLATION GATE VALVE ASSEMBLY

CONTROLLER: INSTALL PER MANUFACTURERS

CONTROL WIRING & MASTER VALVE WIRES

- BARE COPPER WIRE (#10 AWG MIN.)

SHOULD BE AS STRAIGHT AS POSSIBLE.

WALLMOUNT CONTROLLER INSTALLATION
SCALE: NTS

— 5/8" X 8' COPPER CLAD GROUNDING ROD OR PLATE

FINISH GRADE

REQUIRED)

GATE VALVE

--- PVC MAINLINE PIPE

WASHED GRAVEL

PVC SCH. 40 MALE ADAPTER

- ELECTRICAL CONDUIT W. JUNCTION BOX FOR POWER AND

CONNECT TO GROUNDING BUSS IN CONTROLLER CABINET AND ROUTE TO GROUND ROD. PATH TO GROUND ROD

- VALVE BOX W/COVER: RAINBIRD

— 2-INCH MINIMUM DEPTH OF 3/4-INCH WASHED

- 2-INCH PVC CL 200 PIPE (LENGTH AS

3-INCH MINIMUM DEPTH OF 3/4-INCH

RECOMMENDATIONS.

CONTROL WIRING CONDUIT

- POWER WIRING

GROUND ROD ASSEMBLY

2. BRAND "GV" INTO LID OF EACH VALVE BOX W/3-INCH HIGH LETTERS.

DRIPPERLINE @ TREE IN GRAVEL MULCH

SECTION VIEW

DRIPLINE INSTALLATION @ GRAVEL PLANTING AREAS

SCALE: NTS

- SUPPLY HEADER, 1 FOOT BELOW

FINISH GRADE MINIMUM

- DRIP CONTROL VALVE ASSEMBLY

DRIPLINE TERMINATES AT-

EXHAUST HEADER & FLUSH

RAIN SENSOR
SCALE: NTS

10.7.4.2.A.1.

OUTPUT TO PREVENT GLARE PROBLEMS AND SHALL NOT EXCEED NATIONAL I.E.S. LIGHTING STANDARDS FOR DISABILITY GLARE. ALL PROVIDED EXTERIOR FIXTURES SHALL BE FULL

CUT-OFF TYPE FIXTURES TO COMPLY WITH SEC.


ORIENTED IN SUCH A MANNER OR LIMITED IN LUMEN

EXTERIOR LIGHT FIXTURES SHALL BE DIMMED AS REQUIRED TO COMPLY WITH BUILDING DEPARTMENT 8 FOOT CANDLE MAX AND 2 FOOT CANDLE AT THE ZONE LOT LINE REQUIREMENTS.

B.U.G. RATING OF FIXTURES IS BELOW BUILDING DEPT. MAXIMUM PER LUMINAIRE SCHEDULE BELOW.

Statistics						
Description	Symbol	Avg	Max	Min	Max/Min	Avg/Mii
Calc Zone #1	+	0.7 fc	4.1 fc	0.0 fc	N/A	N/A

			VOLTS	MOUNTING	LUMENS	MAX	B.U.G. RATING
		COLOR TEMP.		INFORMATION		WATTS	
ARCHITECTURAL AREA LIGHT	INVUE LUXESCAPE	LED	120	20'-0" AFG.	8500	114	B3-U0-G3
	LXS-VA3-830-U-ASC-A-BK	3000K					
PEDESTRIAN LIGHT	INVUE LUXESCAPE	LED	120	15'-0" AFG	4500	55	B3-U0-G2
	LXS-VA2-830-U-SYM-S-BK	3000K					
PEDESTRIAN LIGHT  ABBREVIATIONS			120	15'-0" AFG	4500	55	

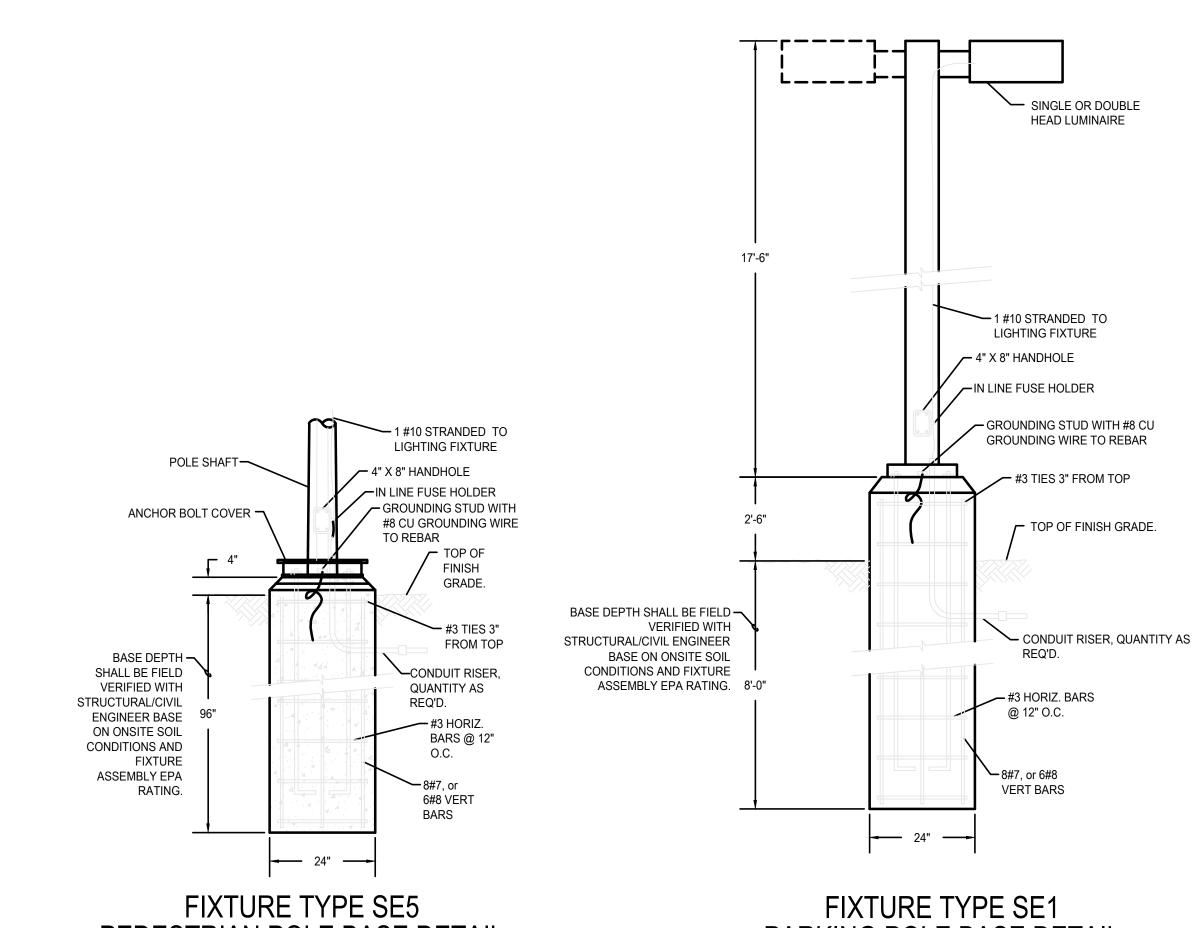

PEDESTRIAN POLE BASE DETAIL NO SCALE

PARKING POLE BASE DETAIL NO SCALE







2ND SITE PLAN SUBMITTAL PROJECT #: 2023-034-00 FILE: SHEET TITLE:

SITE PLAN SUBMITTAL

NO. PH-01

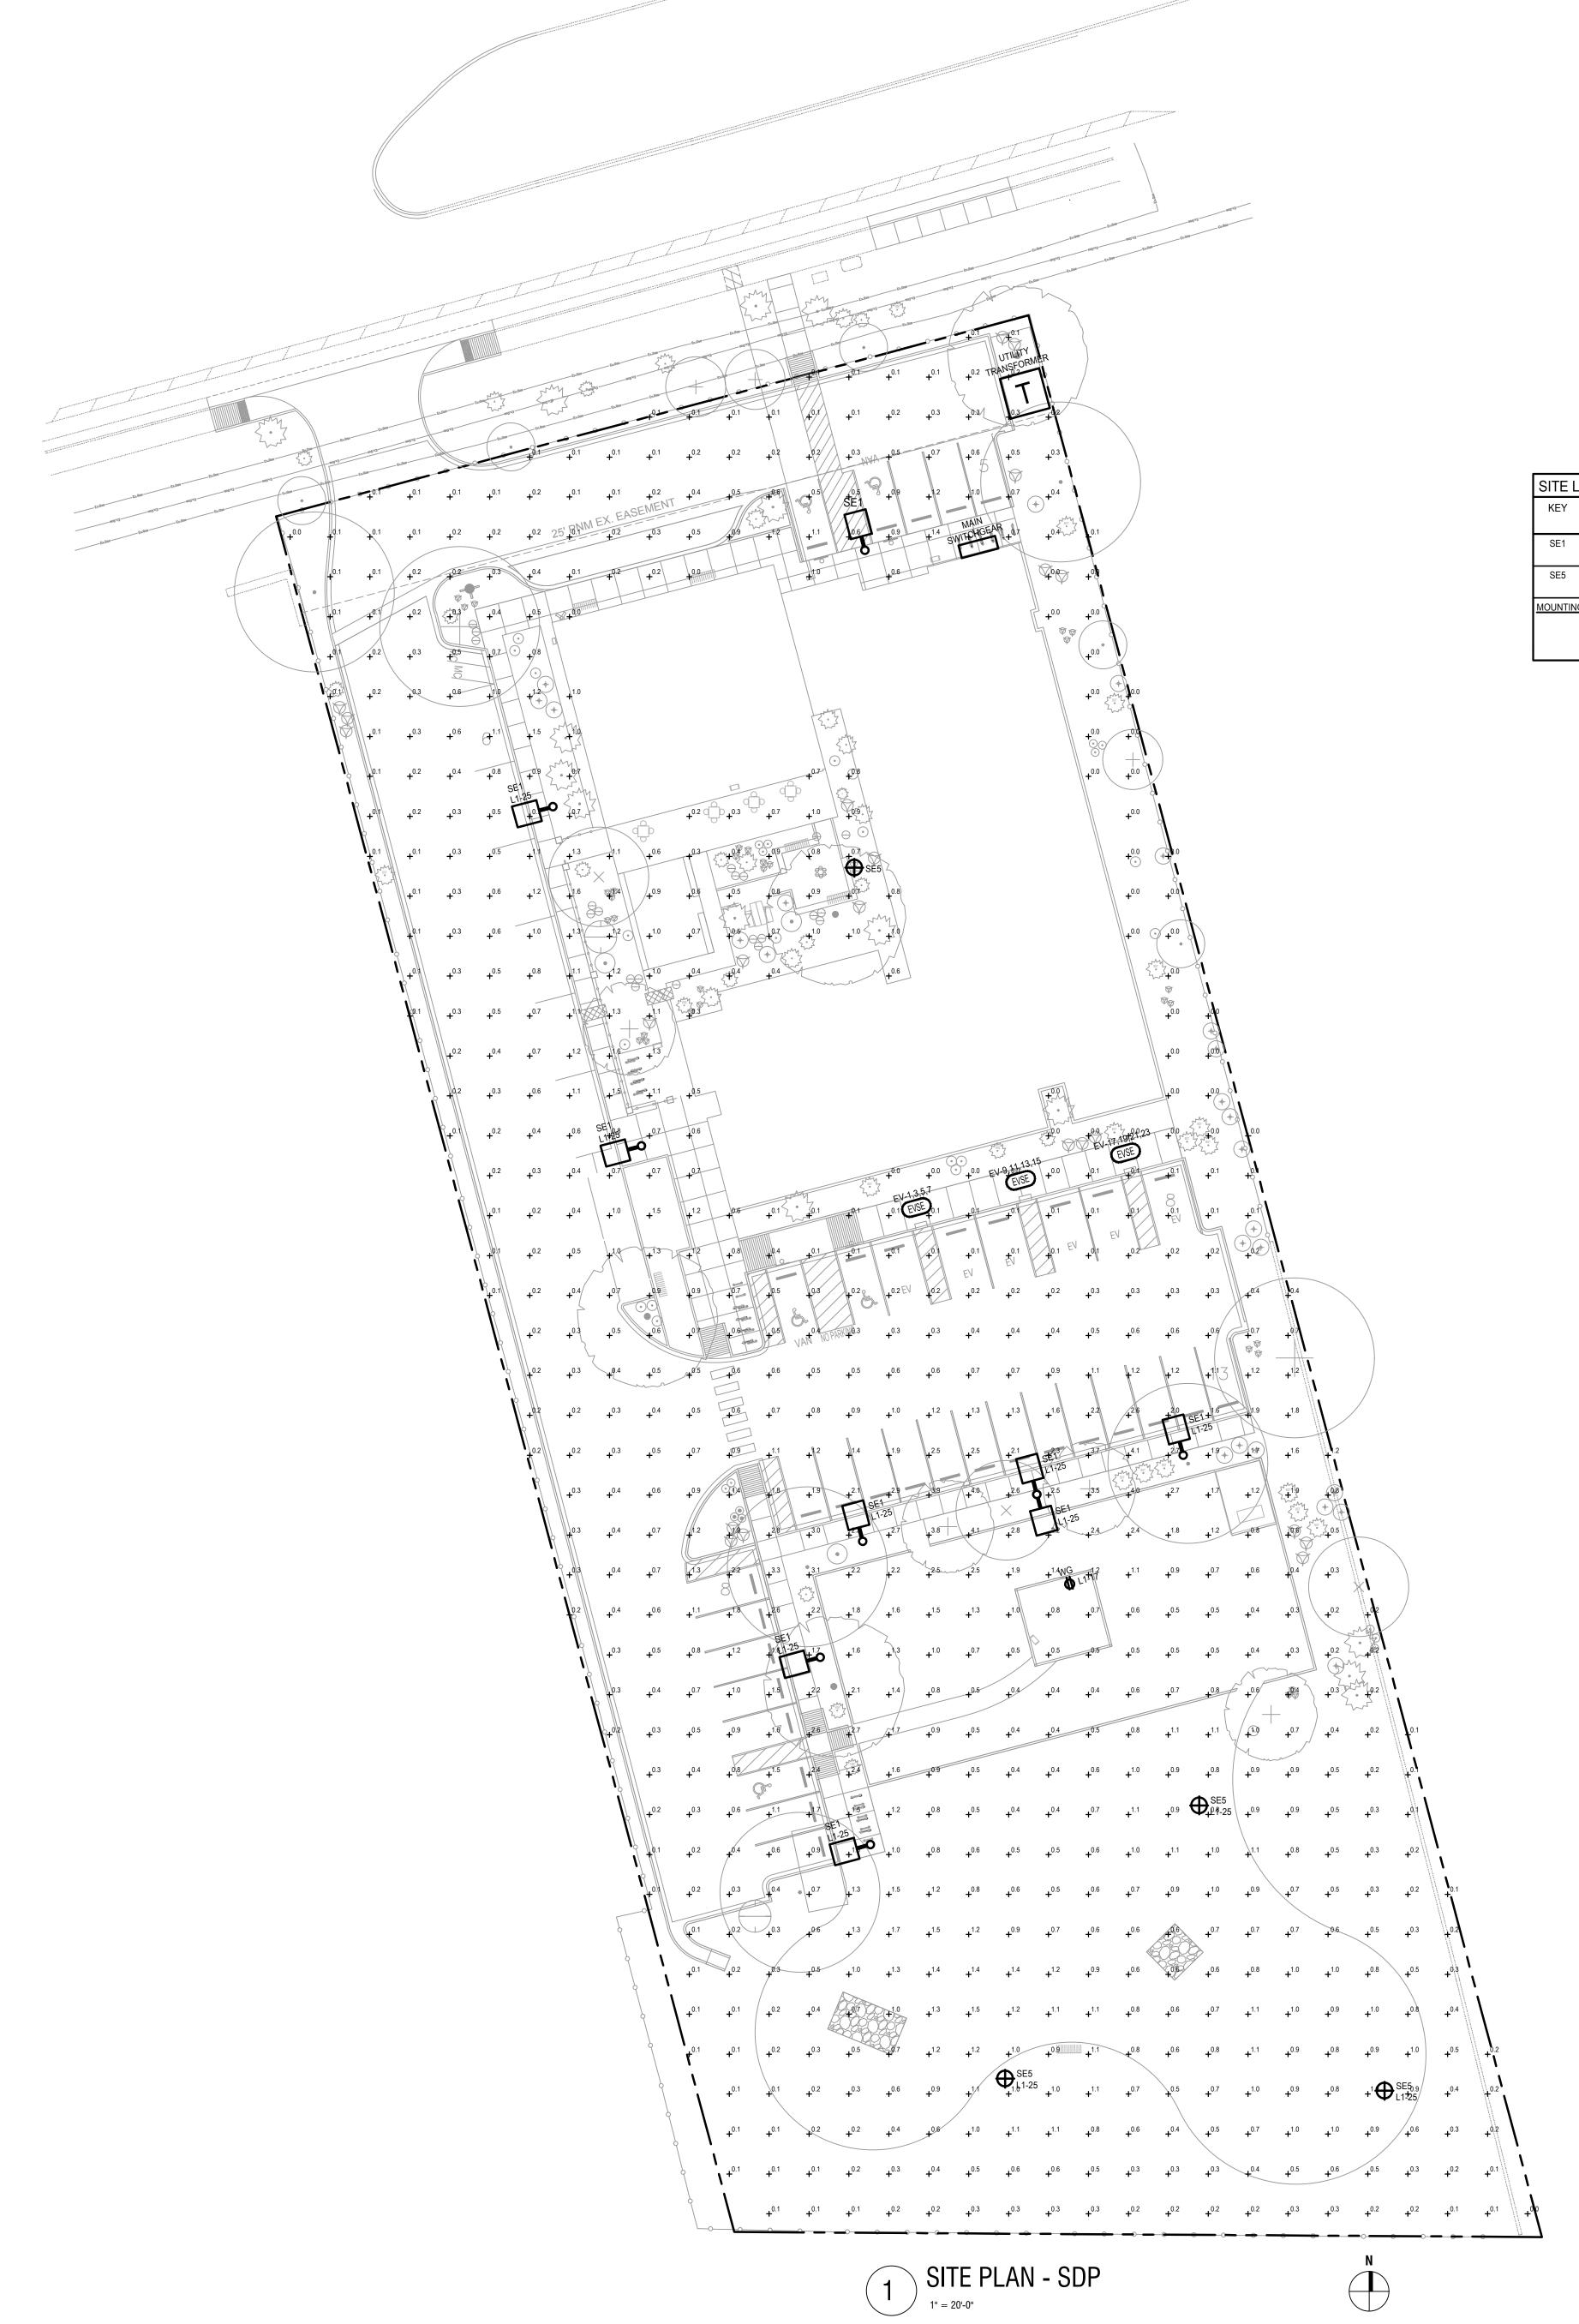

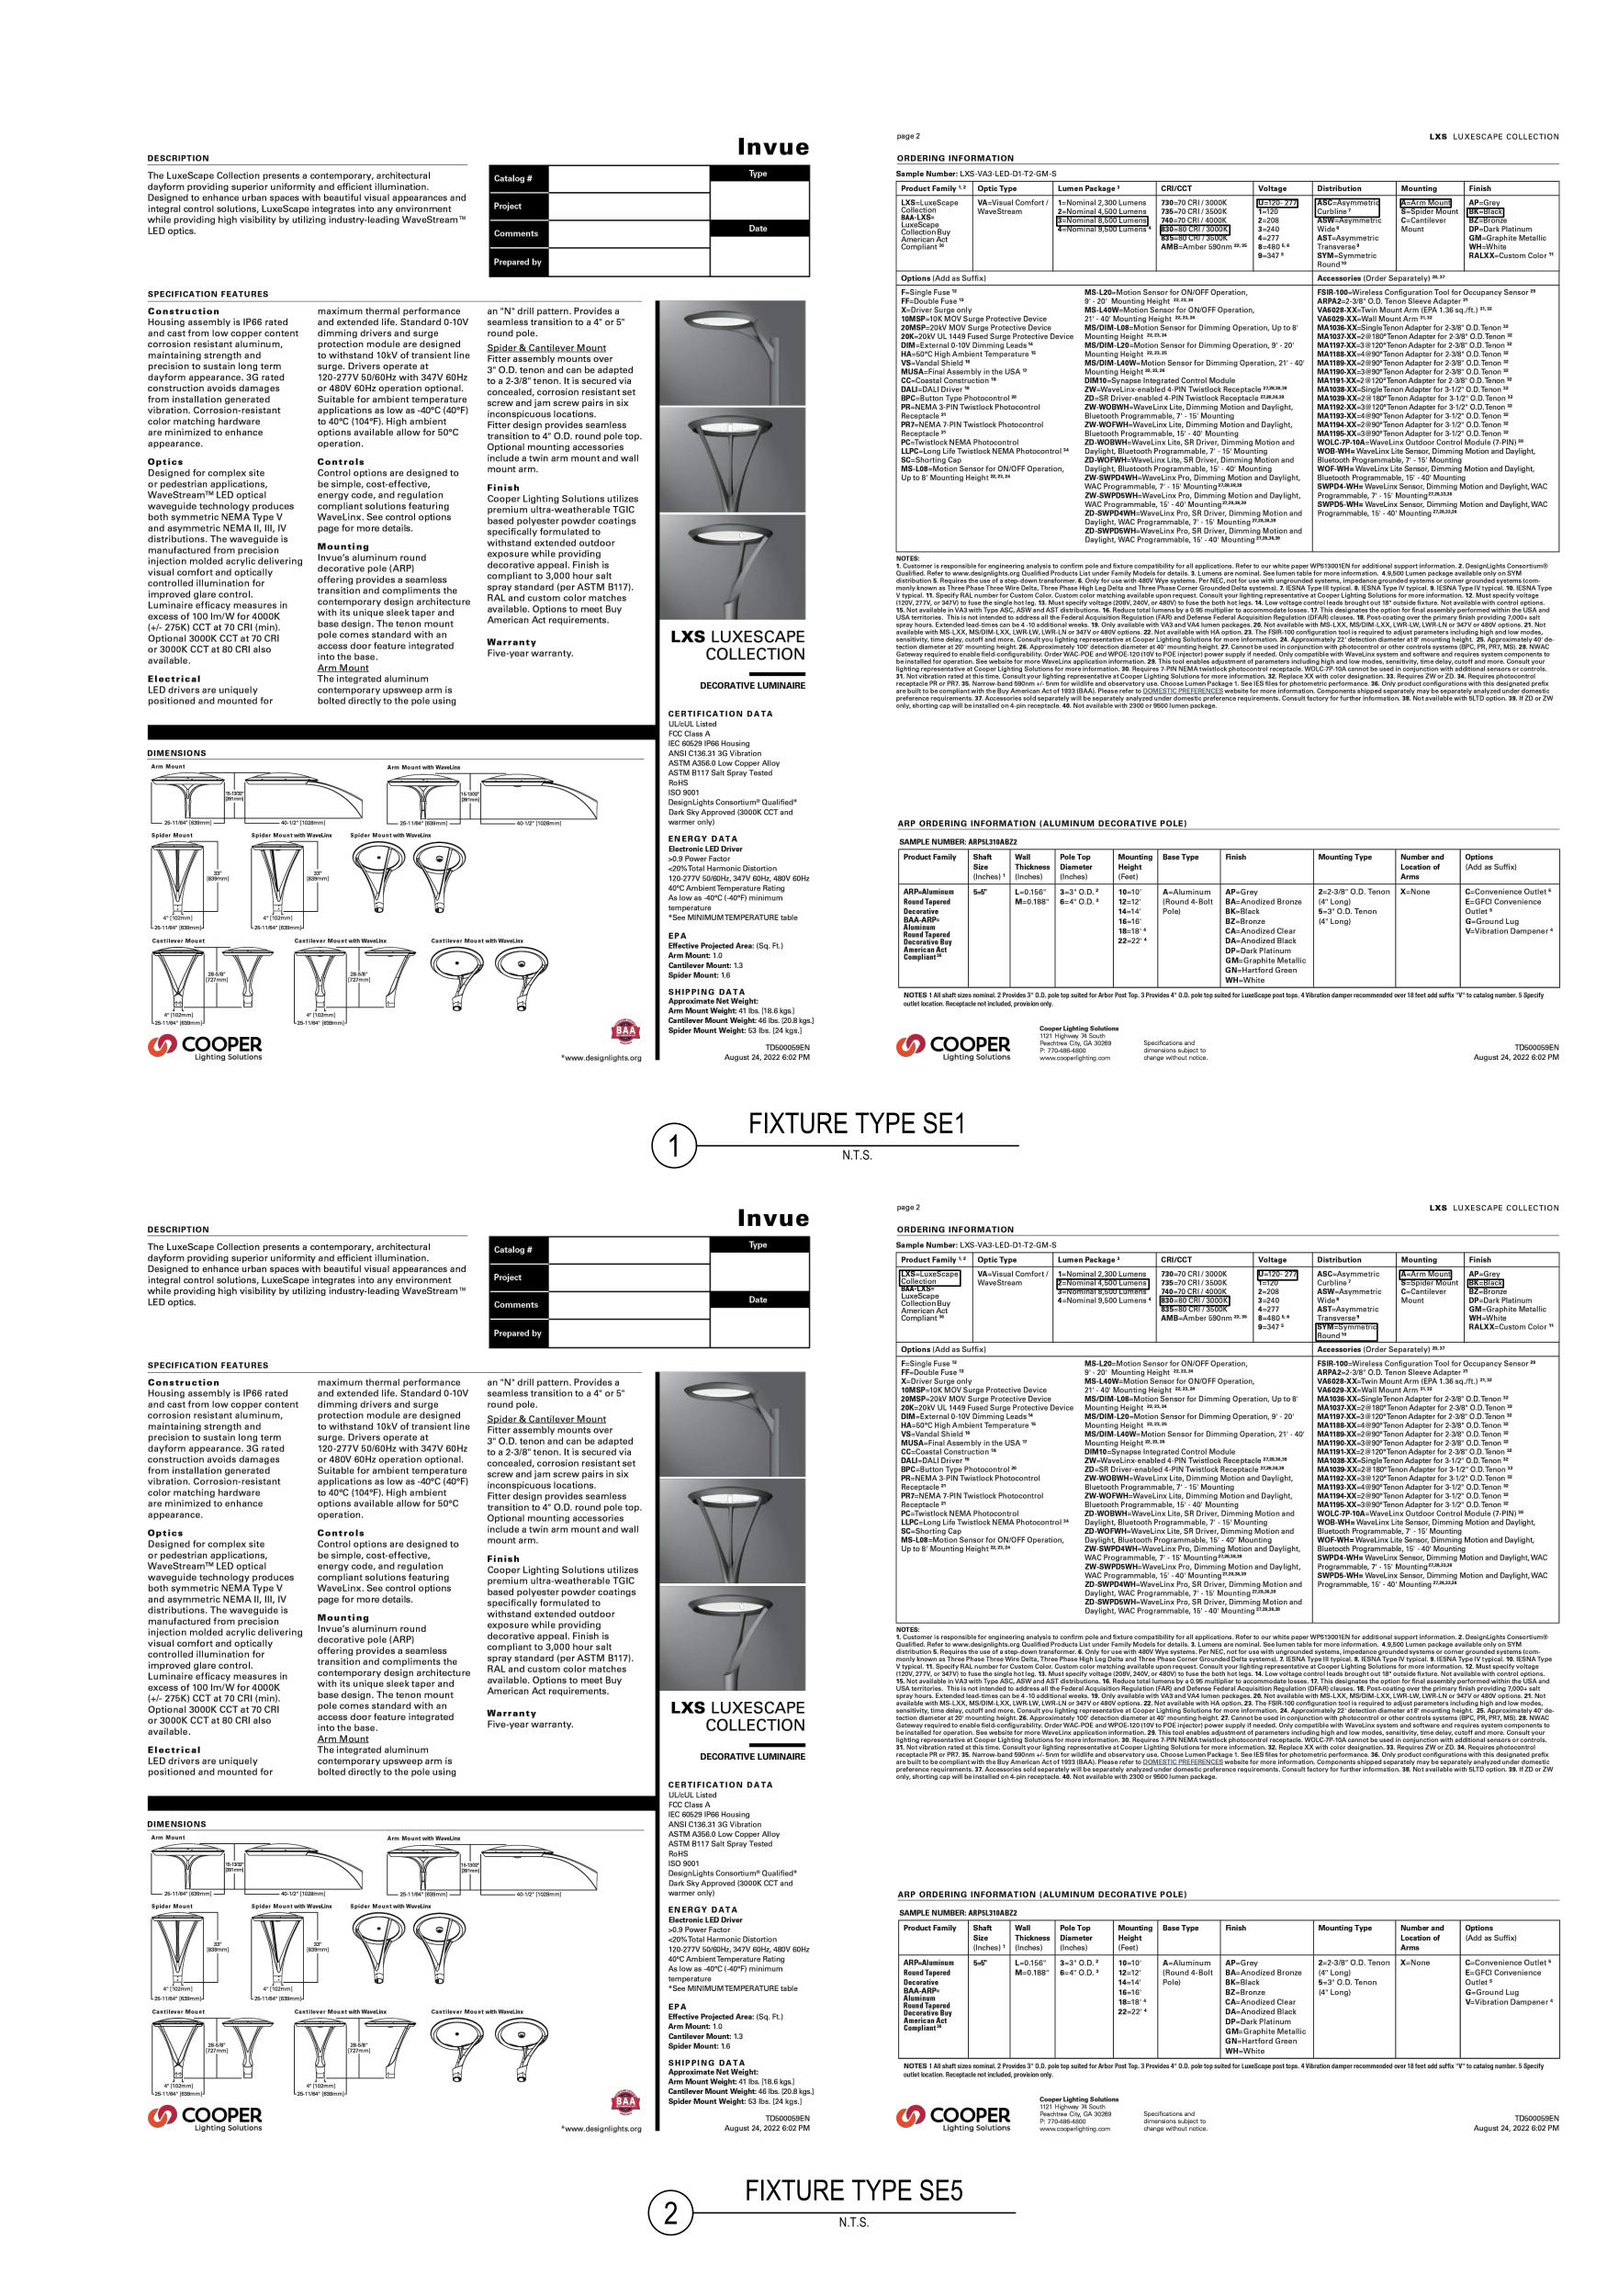



ROUTE 66 FLATS
HIGH DESERT HOUS
7600 CENTRAL AVE SW
ALBUQUERQUE, NEW MEXICO

REV:

SITE LIGHTING DETAILS

NO. PH-02



 $\neg$ 

0





HIGH DESERT HOUSING

REV: 1 04/03/2024 CITY RESPONSE #1

DRAWN: TB
REVIEWED: EP

DATE: 3/29/2024

PROJECT #: 21018
FILE:
SHEET TITLE:
BUILDING
ELEVATIONS

SCALE: As indicated

SITE-5.0

**ELEVATIONS MATERIAL LEGEND** STUCCO; COLOR 7, TBD STUCCO: COLOR 1, TBD THIN BRICK COLOR, TBD STUCCO: COLOR 2, TBD STUCCO; COLOR 8, TBD PAINTED CEMENT BOARD; COLOR 1, TBD STUCCO: COLOR 3, TBD STUCCO; COLOR 9, TBD PAINTED CEMENT BOARD; COLOR 2, TBD DECORATIVE METAL MESH / STUCCO; COLOR 4, TBD STEEL SECURITY FENCE, RE: LANDSCAPE STUCCO; COLOR 5, TBD STUCCO; COLOR 6, TBD

1. ALL WINDOWS TO BE VINYL WITH A 2" RECESS

 ALL WINDOWS TO BE VINYL WITH A 2" RECESS
 HORIZONTAL CONTROL JOINT AT STUCCO COLOR BANDING, TYPICAL.

TOTAL SIDE FACADE LENGTH 59'-6 3/4"

IDO 5-11(D)(3): BUILDING HEIGHT CHANGE EVERY 60' 57'-7 1/4"

IDO 5-11(D)(3): BUILDING HEIGHT CHANGE EVERY 60' PRE-FINISHED CONTINUOUS
 METAL PARAPET WALL CAP 4' - 0" 30' - 0" 4' - 0" 25' - 7" 27' - 11" 4' - 0" 4' - 0" 18' - 11" 25' - 8" IDO 5-11(D)(2)(b) 6" PROJECTION IDO 5-11(D)(2)(b)-1 IDO 5-11(D)(2)(b)-1 IDO 5-11(D)(2)(b)-1 IDO 5-11(D)(2)(b) 1'-6" RECESS IDO 5-11(D)(2)(b)-1 IDO 5-11(D)(2)(b)-1 HORIZONTAL PLANE CHANGE EVERY 30' HIGH PARAPET 136' - 3" LOW PARAPET 134' - 3" IDO 5-11(D)(2)(a)-2 VINYL WINDOWS RECESSED 2" -00 00 WITH 2" CASING, TYPICAL. 130' - 6 1/4" CEMENT PLASTER CEMENT PLASTER (STUCCO) COLOR 6 (STUCCO) COLOR 2 IDO 5-11(D)(2)(a)-2 - VINYL WINDÓWS RECESSED 2" CEMENT PLASTER BANDING \_ (STUCCO) COLOR 7, TYPICAL WITH 2" CASING, TYPICAL. LEVEL 3 121' - 6 1/4" 00 VINYL WINDOWS, TYPICAL CEMENT PLASTER (STUCCO) COLOR 5 CEMENT PLASTER BANDING (STUCCO) COLOR 8 \_\_\_\_\_110' - 9 1/8" 00 CEMENT PLASTER \_ (STUCCO) COLOR 4 CEMENT PLASTER (STUCCO) COLOR 3 LEVEL 1 100' - 0" CEMENT PLASTER (STUCCO) COLOR 2 THROUGH-WALL PTAC UNIT - CEMENT PLASTER - CEMENT PLASTER CEMENT PLASTER — PRE-FINISHED METAL SCUPPER W/ PRE-FINISHED LOUVER, TYPICAL (STUCCO) COLOR 2 WITH DOWNSPOUT, TYPICAL (STUCCO) COLOR 7 (STUCCO) COLOR 7

2 EAST ELEVATION (SIDE)

3/16" = 1'-0"

0' 4' 8' 16'



CHAD H. HOLTZINGER NO. 6016

HIGH DESERT HOUSING
7600 CENTRAL AVE SW
ALBUQUERQUE, NEW MEXICO

REV: 1 04/03/2024 CITY RESPONSE #1


DRAWN: Author
REVIEWED: Approver


DATE: 3/29/2024

PROJECT #: 21018
FILE:
SHEET TITLE:
BUILDING
ELEVATIONS


SCALE: As indicated


SITE-5.1

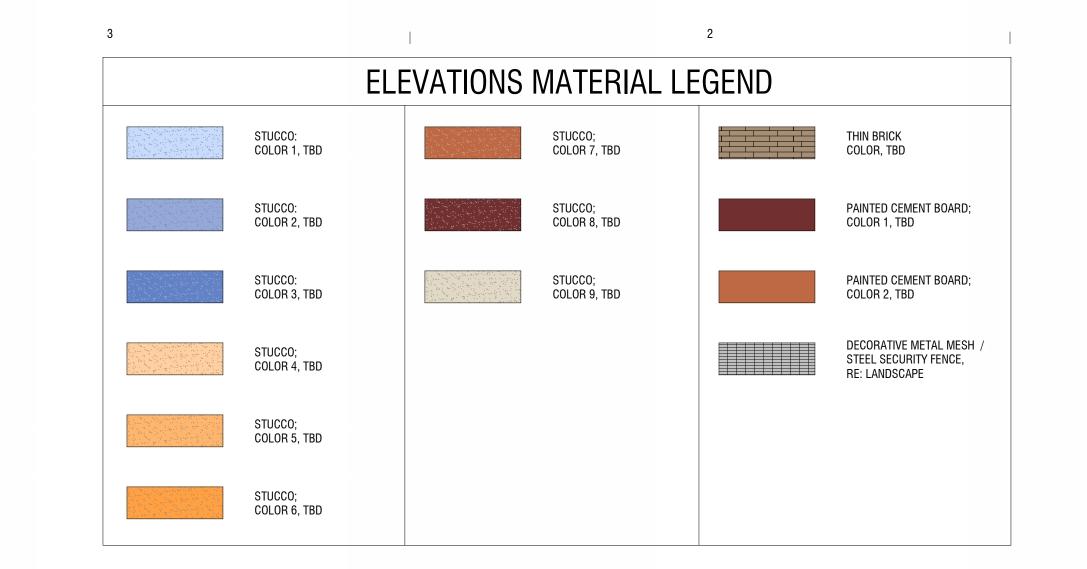

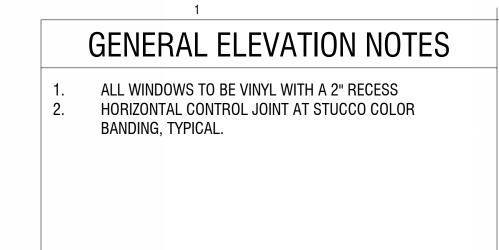



TRANSPARENCY		
PRIMARY STREET - CENTRAL AVE.	REQUIRED	PROVIDED
BUILDING LENGTH = 118.60' FIRST FLOOR SURFACE SQFT = 1264 SF		
IDO 5-11(D)(2)(a) WINDOWS: 20% TRANSPARENCY REQUIRED AT STREET FACING FACADE	20% x 1264SF =252.8SF	352.5SF

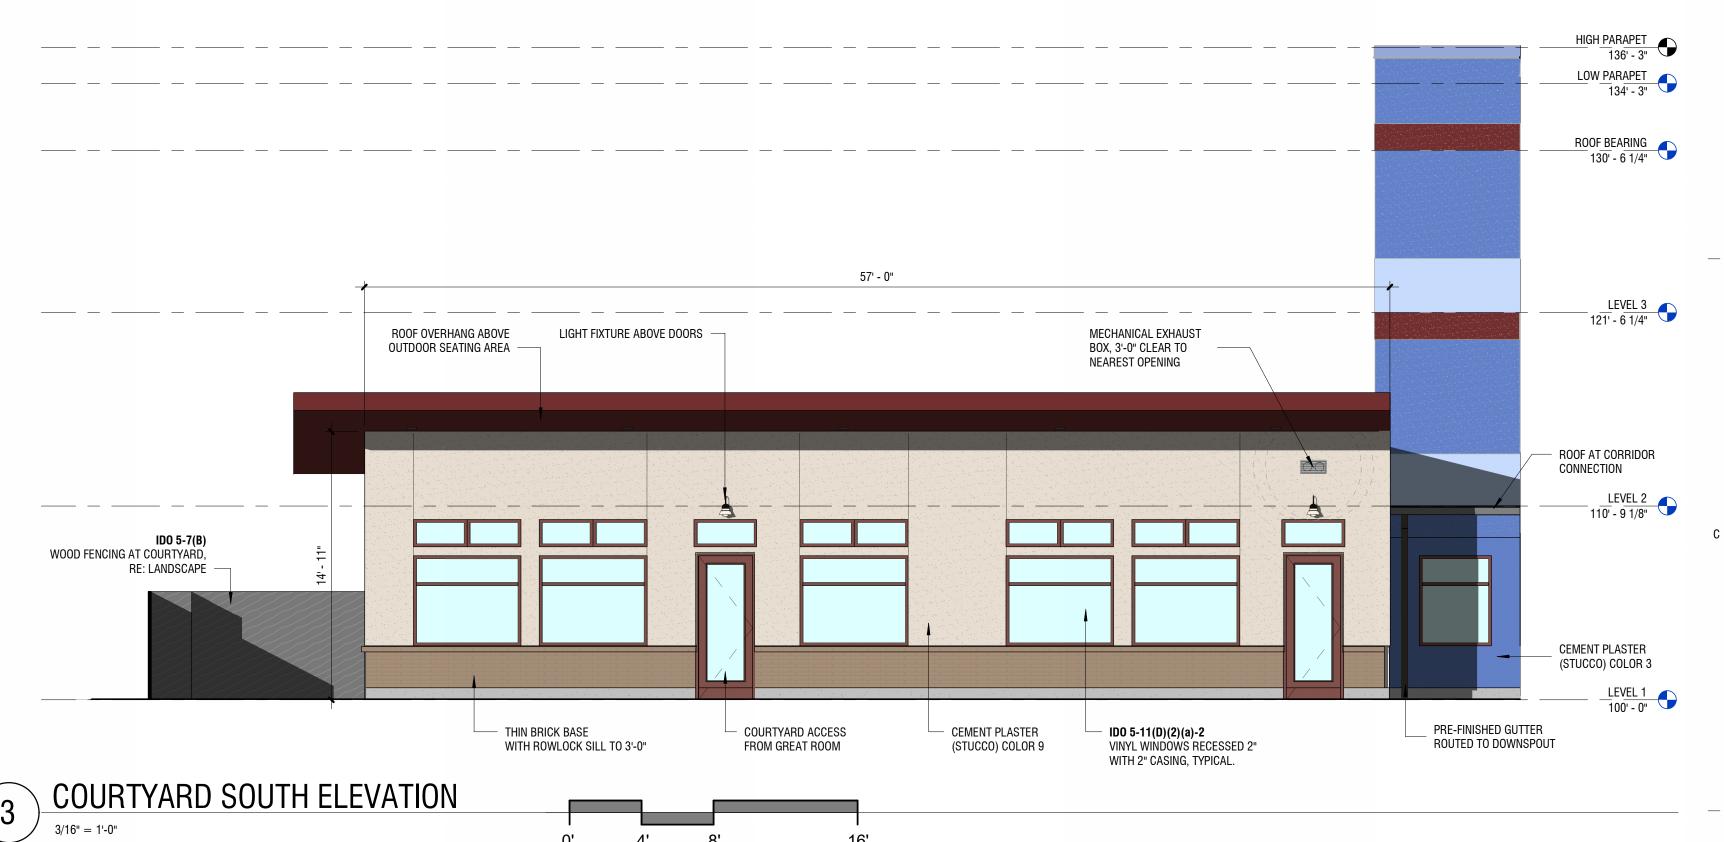

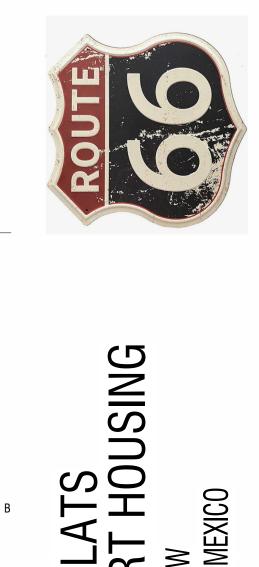


HOLTZINGER

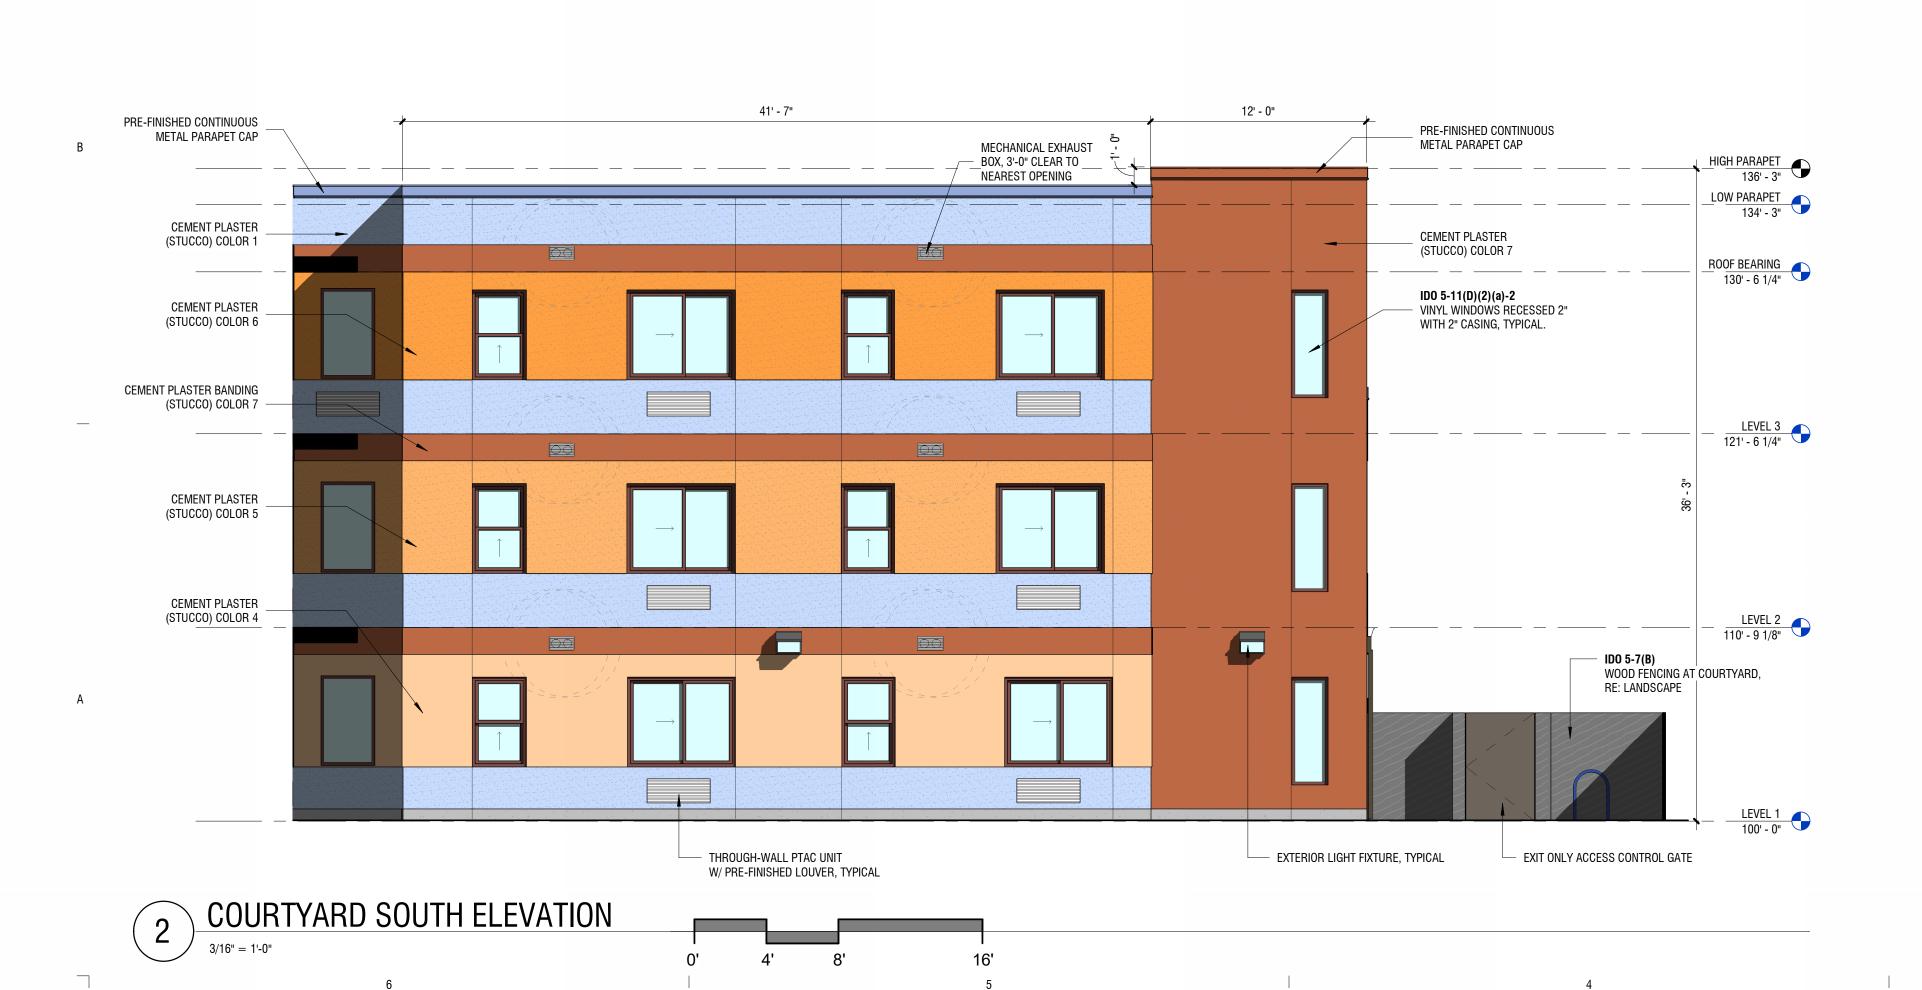

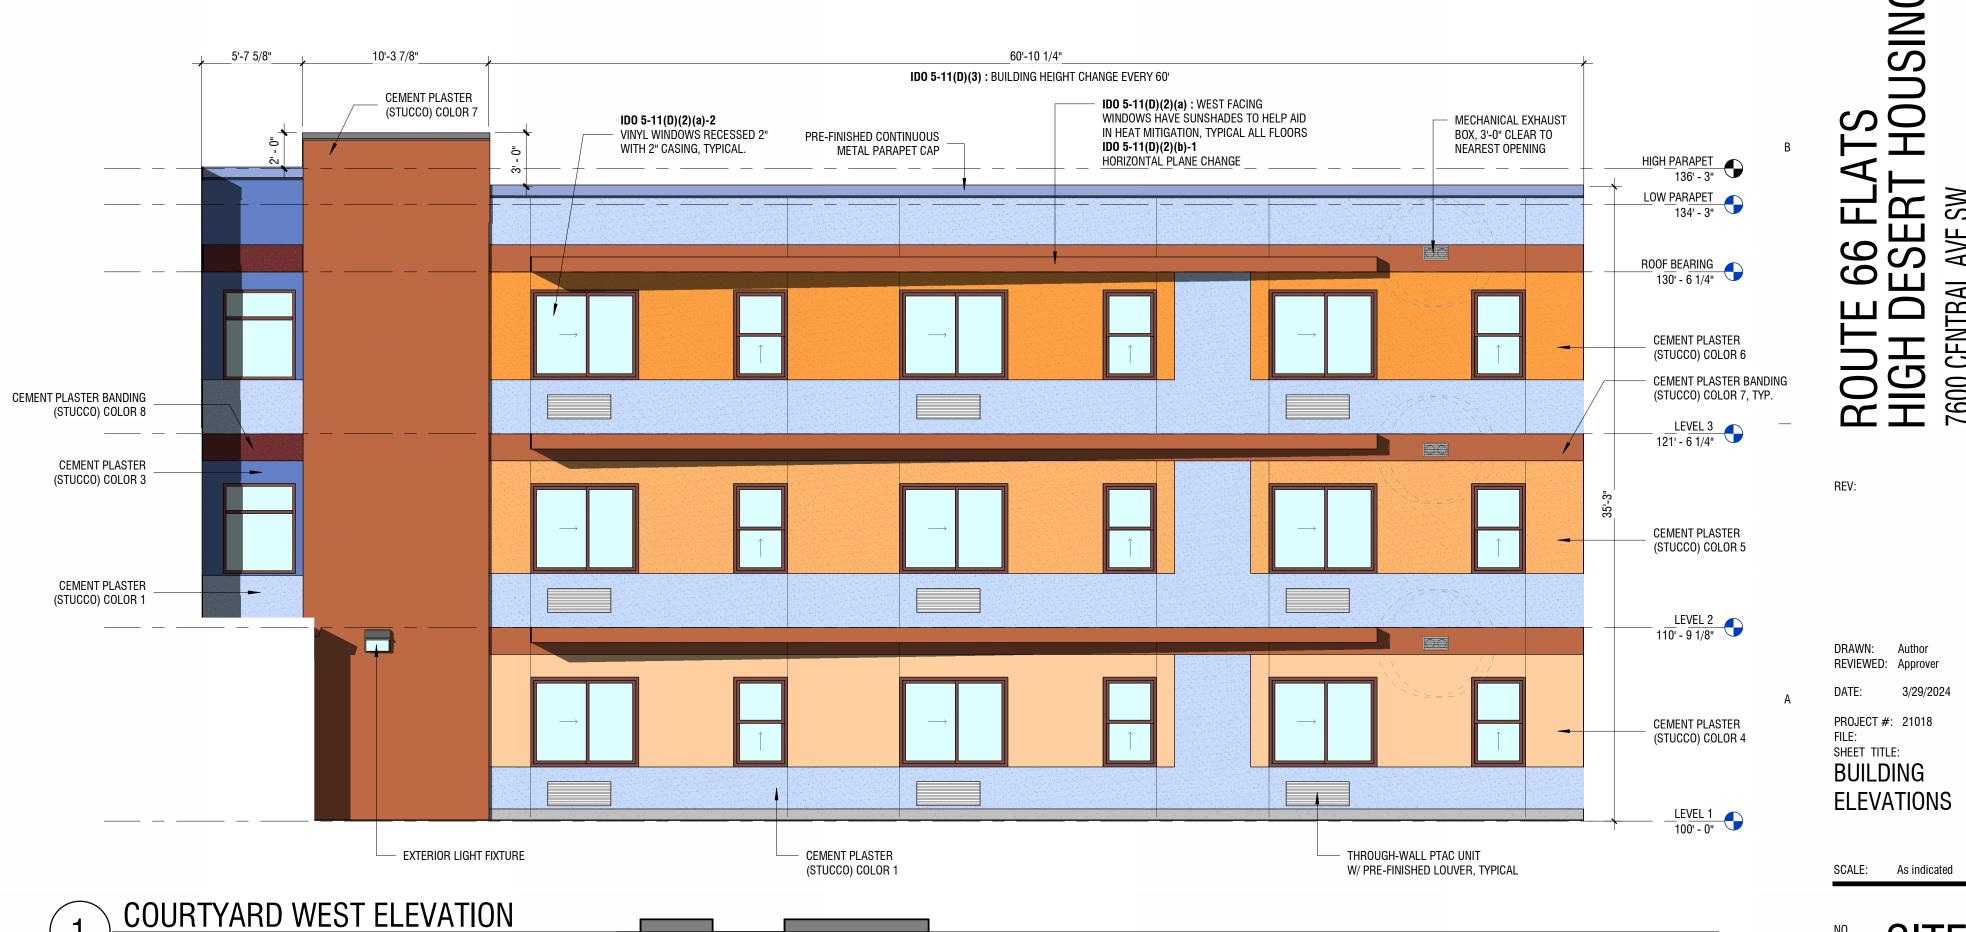

ROUTE 66 FLATS
HIGH DESERT HO
7600 CENTRAL AVE SW
ALBUQUERQUE, NEW MEXICO DRAWN: Author REVIEWED: Approver PROJECT #: 21018 SHEET TITLE: BUILDING **ELEVATIONS** 

SITE-5.2

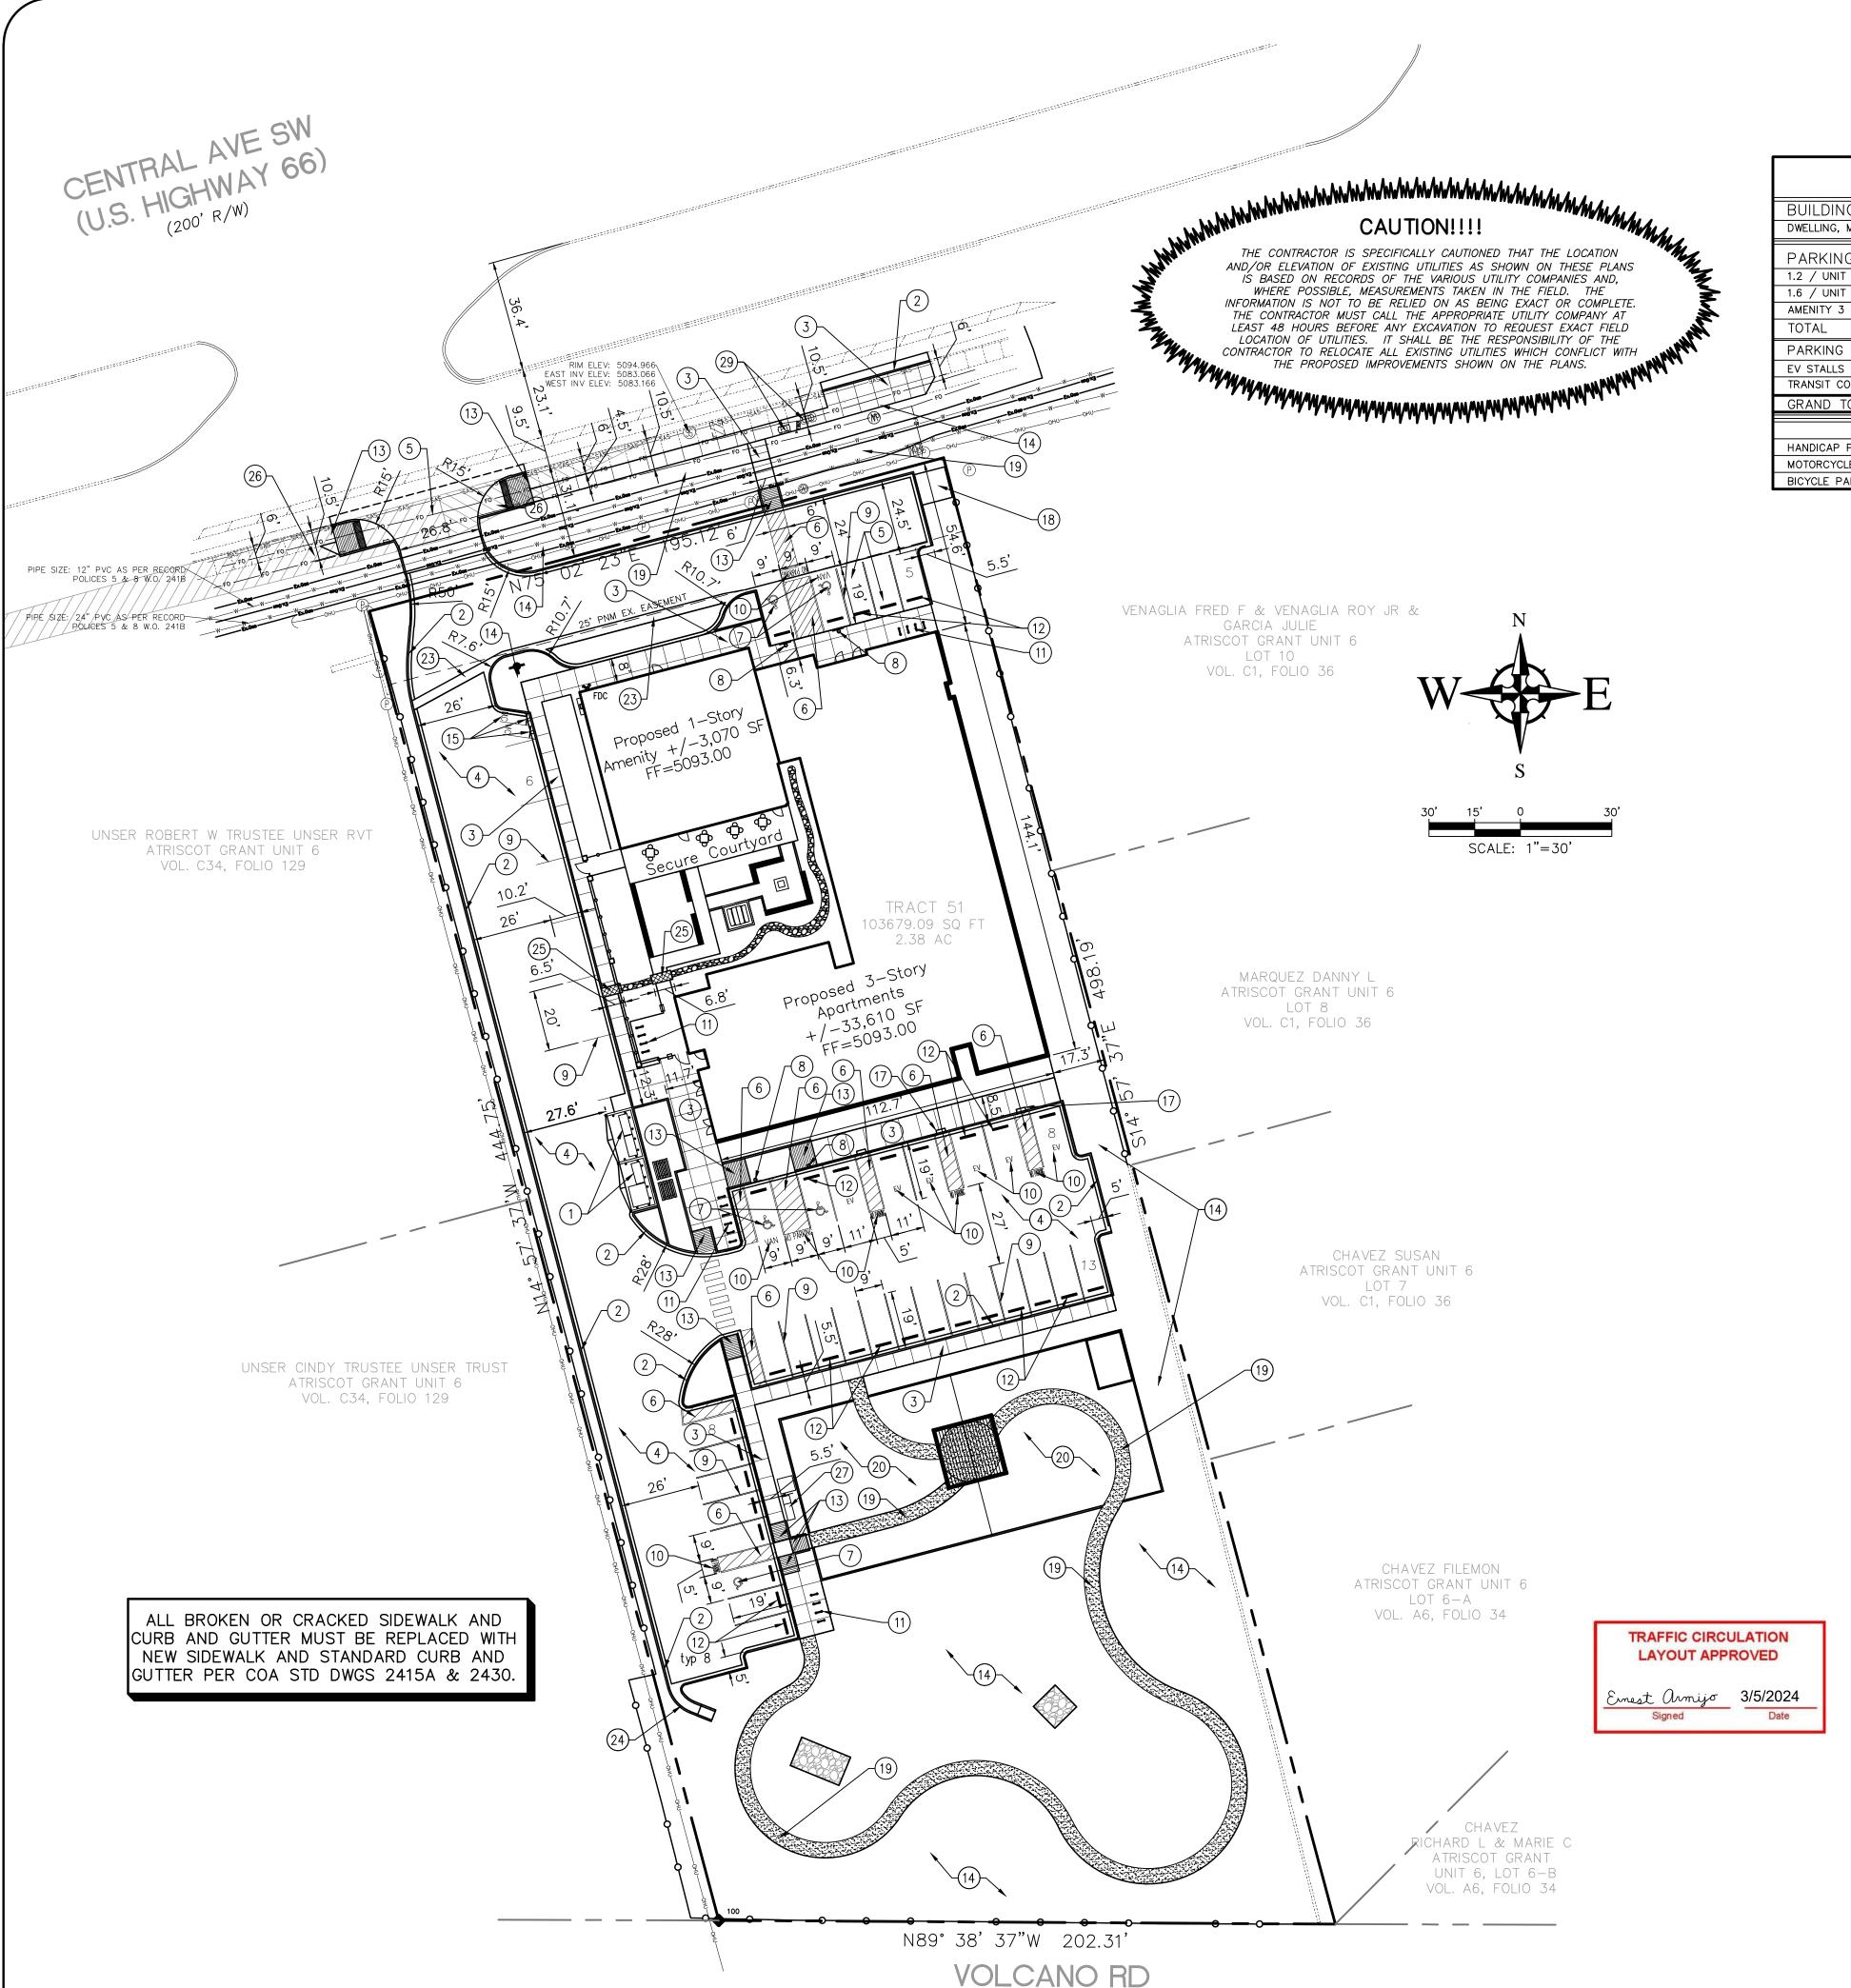

PARKING CALCUL	ATIONS			
BUILDING AREA:	AREA (SQL	JARE FEET)		
DWELLING, MULTI-FAMILY	+/- 36,680 SF			
PARKING REQUIREMENTS:	REQUIRED	PROVIDED		
1.2 / UNIT 1 BEDROOM: 47 UNITS	56 spaces			
1.6 / UNIT 2 BEDROOM: 1 UNIT	1 spaces			
AMENITY 3 / 1,000 SF: 3,070 SF	9 spaces			
TOTAL	66 spaces			
PARKING REDUCTIONS				
EV STALLS (1 CAR REDUCTIONS PER STALL)	-6 spaces			
TRANSIT CORRIDOR (30% REDUCTIONS)	-20 spaces			
GRAND TOTAL	40 spaces	40 spaces		
-	REQUIRED	PROVIDED		
HANDICAP PARKING	2 spaces	5 spaces		
MOTORCYCLE PARKING	2 spaces	2 spaces		
BICYCLE PARKING	6 spaces	36 spaces		

PARK	
	VICTORY LOVE FELLOWSHIP CHURCH
H2A B3 B2 \$\begin{picture}(\begin{picture}(\beta \) \\ \\ \\ \\ \\ \\ \\ \\ \\ \\ \\ \\	(N OF ULIVARRI ADDN ADDN DI
1A SARRACINO PL ATRISC	GRANT Z MX-M
HUBBELL ^	GJ G BERUMAN
LD-72-476	1) 100041
WEST ROUTE 66 HEIGHTS	NR-BP \
ADDITION HEIGHTS	
B NR-RP MX-M	
92 105 104 103 102	SITE TOWN OF ATRISCO GRAM
	10 9 53 INJIT 6
B3 1 1007489	MX-M 108 141 181
	SP-87-308
CENTRAL	UNSER SAT SAT SALANCOS
7	4 8B1 ADDN 53
5 6 SKYVIEW PARK 1 FREDERICK	14 R-1B 14 R-1B TOWNSTE SOF 28A S
10 11 12 1	3 13 14 1 8 0 R-TB TIONNSTE OF 28AP WISTLAND BE RA 1001262 1 5 NR-
MY M	16 R-1B 9 5
13 \ IVIA-IVI \ ) \ \ R-11	B R-1B (13 11)
2	14 10 14 R 1R
ROSSINGS	PALM LA
	SKYVIEW 33 16 15A 5
MY I	30 CHURCUM 33
VICINITY MAP - Zone Atlas K	

VICINITY MAR - ZONE AUGS N-10-Z

**LEGAL DESCRIPTION:** The West One-Half of Tract 52, Unit No. 6 of Plat of Town of Atrisco Grant, Bernalillo County, NM.

#### KEYED NOTES

- 1. PROPOSED TRASH ENCLOSURE TO COMPLY WITH MINIMUM COA SOLID WASTE STANDARDS. CONTRACTOR SHALL COORDINATE WITH THE SOLID WASTE DEPARTMENT FOR THE REQUIRED INSPECTIONS DURING CONSTRUCTION. REF. ARCHITECTURAL DETAILS.
- 2. INSTALL MEDIAN CURB/GUTTER (6" HIGH) PER COA STD DWG 2415B. GUTTER PAN SHALL BE SLOPED TO MATCH THE ADJACENT PAVEMENT.
- 3. INSTALL CONCRETE SIDEWALK PER COA STD DWG 2430. SIDEWALK CROSS SLOPE SHALL BE 2% MAX AND SLOPE AWAY FROM CURB.
- 4. INSTALL ASPHALT PAVEMENT PER GEOTECHNICAL REPORT. RECOMMENDATIONS & DETAIL ON SHEET C102.
- 5. INSTALL CONCRETE PAVEMENT PER GEOTECHNICAL REPORT. RECOMMENDATIONS & DETAIL ON SHEET C102.
- 6. INSTALL 4" WIDE PAINT STRIPES AT 45° ANGLE TO PARKING STRIPES OR DRIVEWAY, SPACED AT 1'-6" (WHITE PAINT IN PARKING LOT, BLUE PAINT IN ACCESSIBLE PARKING AREAS). MIN. TWO COATS.
- 7. PAINTED INTERNATIONAL WHEELCHAIR SYMBOL (BLUE) PER ADA STANDARDS. MIN. TWO COATS. INDICATE VAN ONLY SPACE AS SHOWN ON PLAN.
- 8. INSTALL H/C SIGNAGE PER DETAIL, SHEET C102. ADD VAN ACCESSIBLE SIGNAGE WHERE NOTED. H/C SIGN MUST INCLUDE LANGUAGE PER 66-7-352.4C NMSA 1978 "VIOLATORS ARE SUBJECT TO A FINE AND/OR TOWING." REF DETAIL ON SHEET
- 9. INSTALL 4" WIDE PAINT STRIPES (WHITE) FOR ALL PARKING SPACES. MIN. TWO
- 10. PAINT WORDS 'NO PARKING', 'VAN' & 'EV' WITH LETTERS AT LEAST ONE FOOT HIGH AND 2 INCHES WIDE. MIN. TWO COATS.
- 11. INSTALL BIKE RACK(S) PER DETAIL, SHEET C-102.
- 12. INSTALL PRE-CAST WHEEL STOP PER DETAIL, SHEET C-102.
- 13. INSTALL PARALLEL CURB RAMP PER COA STD DWGS 2440-2446. TRUNCATED DOMES SHALL BE INSTALLED PER COA STD DWG 2446.
- 14. LANDSCAPE AREA. REF. LANDSCAPE PLANS.
- 15. MOTORCYCLE PARKING; 2 SPACES. ADD PAINT LABEL (2 COATS) AND SIGNAGE PER COA CODE. SIGN DETAIL ON SHEET C102.
- 16. INSTALL STAMPED CONCRETE CROSSWALK PER DETAIL, SHEET C102.
- 17. INSTALL ELECTRIC VEHICLE CHARGING STATIONS. REF. ARCHITECTURAL PLANS FOR
- 18. INSTALL TRANSFORMER. REF. MEP PLANS FOR DETAILS.
- 19. NATURE TRAIL. REF. LANDSCAPE PLANS FOR DETAILS.
- 20. COMMUNITY GARDEN AREA. REF. LANDSCAPE PLANS FOR DETAILS.
- 21. BIKE STORAGE RACK. REF. ARCHITECTURAL PLANS FOR DETAILS.
- 22. NOT USED.
- 23. INSTALL 3' WIDE VALLEY GUTTER. DETAIL ON SHEET C102.
- 24. INSTALL 3' WIDE CONCRETE FLUME. DETAIL ON SHEET C102.
- 25. INSTALL 24" WIDE SIDEWALK CULVERT PER COA STD DWG 2236.
- 26. CLEAR SIGHT TRIANGLES (15'x590' LEFT, 15'x480' RIGHT). LANDSCAPING, FENCING, AND SIGNAGE WILL NOT INTERFERE WITH CLEAR SIGHT REQUIREMENTS. THEREFORE; SIGNS, WALLS, TREES, AND SHRUBBERY BETWEEN 3 AND 8 FEET TALL (AS MEASURED FROM THE GUTTER PAN) WILL NOT BE ACCEPTABLE IN THE CLEAR SIGHT TRIANGLE.
- 27. GARDEN WASTE & COMPOST AREA. REF. LANDSCAPE PLANS FOR DETAILS.
- 28. INSTALL ADD'L 4.5' WIDE CONCRETE SIDEWALK ADJACENT TO EXISTING SIDEWALK FOR 10' TOTAL BETWEEN EXISTING BACK OF CURB AND EDGE OF NEW SIDEWALK. SIDEWALK CROSS SLOPE SHALL BE 2% MAX TO MATCH EXISTING. SIDEWALK PER COA STD DWG 2430. INSTALL DOWELS PER CONCRETE SIDEWALK BUTT JOINT DETAIL, SHEET C102. TOOLED JOINTS SHALL MATCH EXISTING.
- 29. ADJUST EXISTING UTILITY BOXES TO GRADE IN NEW SIDEWALK AS MAY BE REQUIRED.



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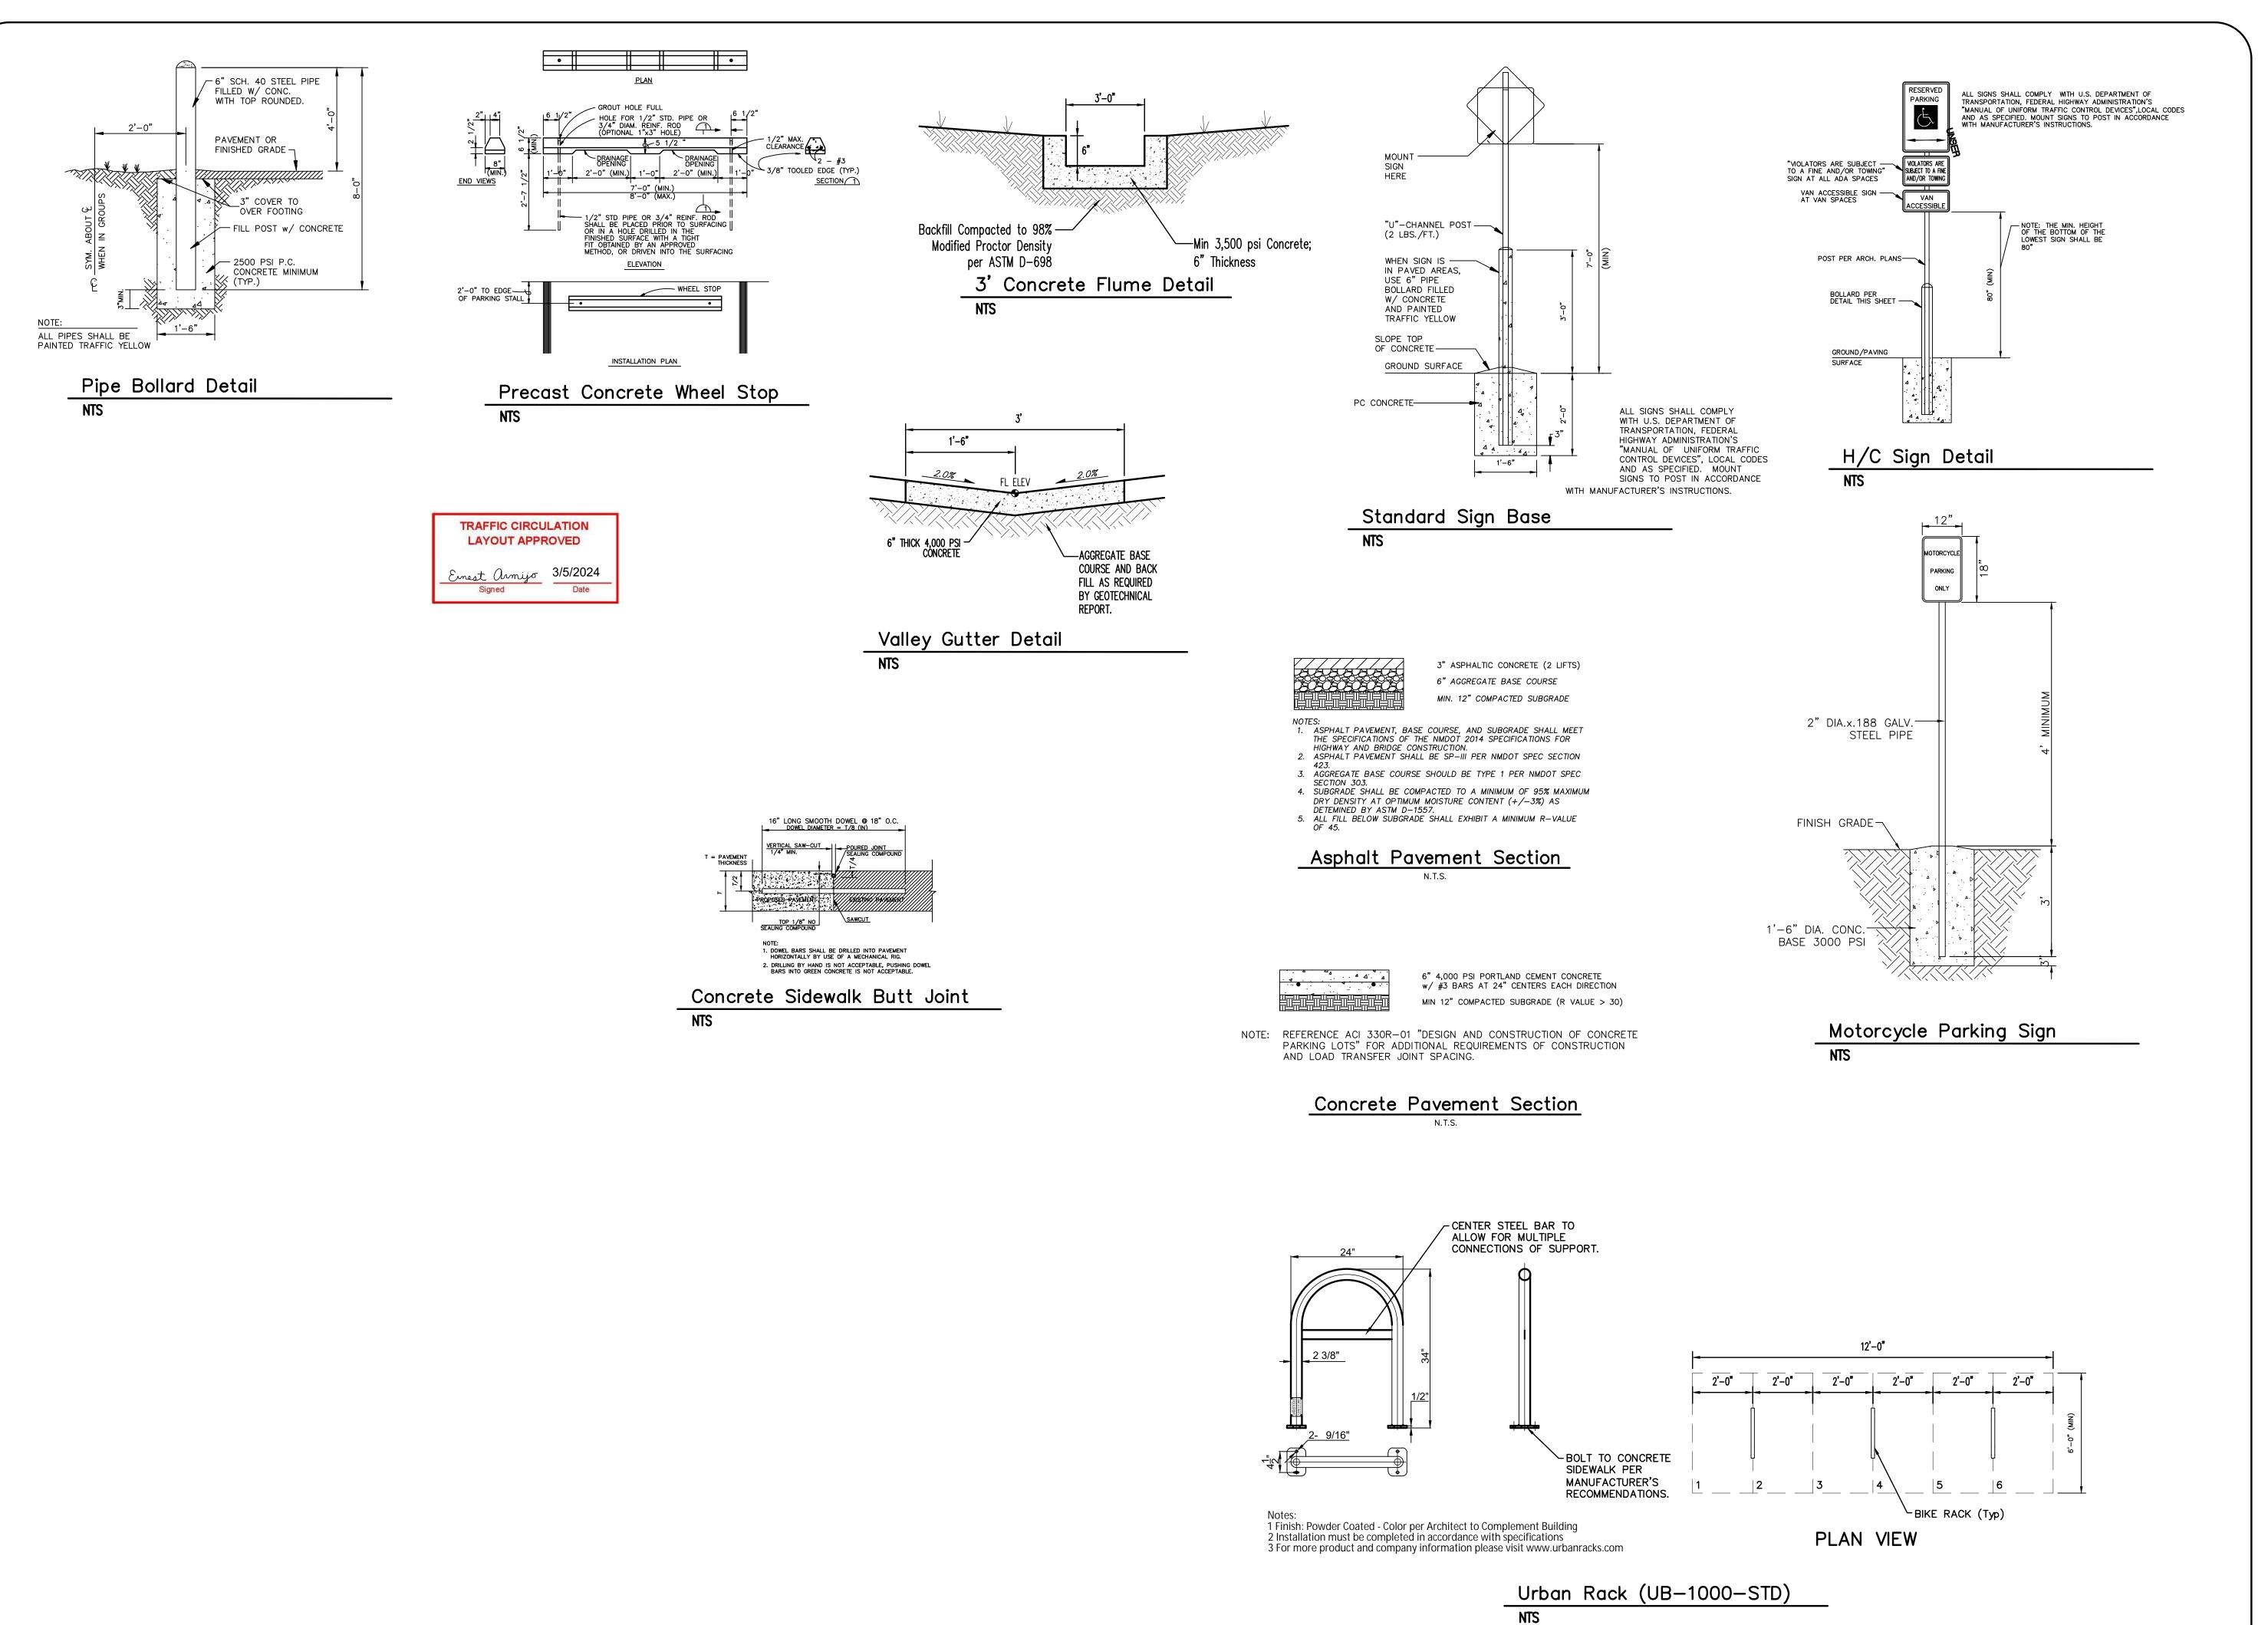
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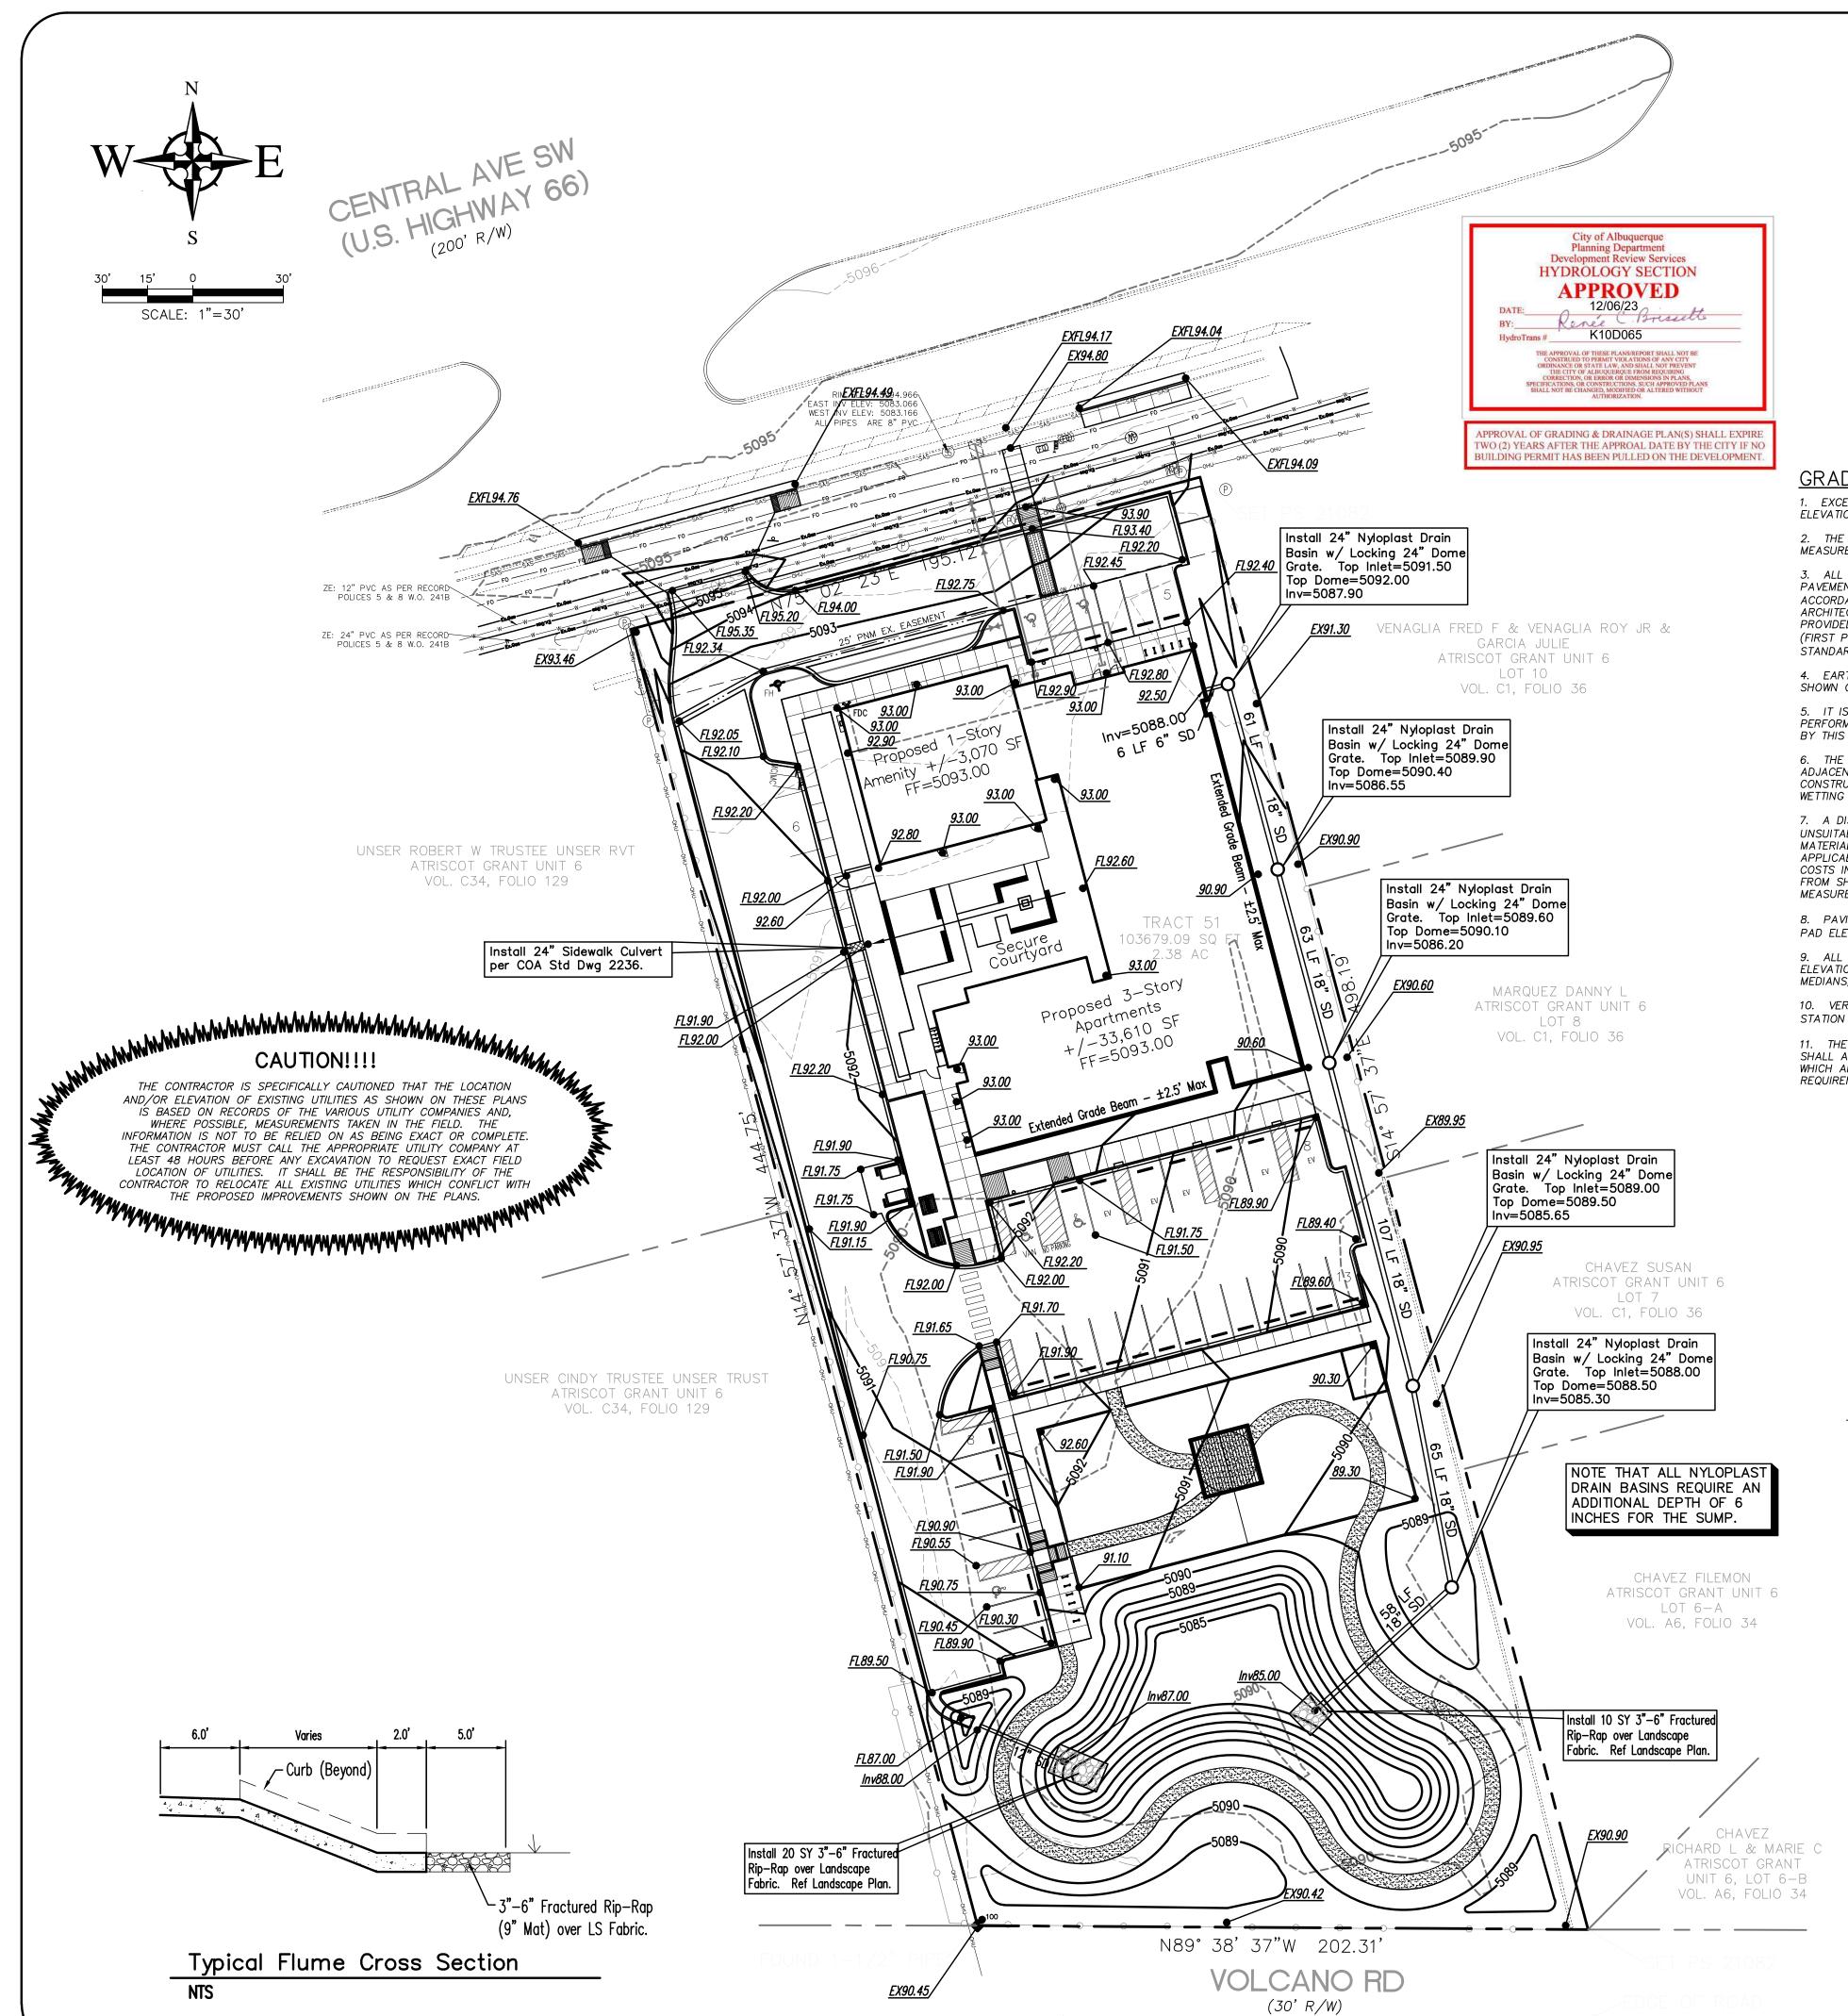
C-102

SW 712

te 66 entral rque, N

Route 7600 Cent Albuquerque tail

Flats



### LEGEND

---- FLOW ARROW PROPOSED TOP OF GRADE/PVMT ELEVATIONS PROPOSED FLOW LINE/GUTTER ELEVATIONS PROPOSED TOP OF CURB ELEVATIONS PROPOSED GRADE AT TOP OF WALL PROPOSED GRADE AT BOTTOM OF WALL EXISTING CONTOUR PROPOSED CONTOUR EXISTING STORM DRAIN

## GRADING NOTES

\_ \_\_ RIDGE LINE

1. EXCEPT AS PROVIDED HEREIN, GRADING SHALL BE PERFORMED AT THE ELEVATIONS AND IN ACCORDANCE WITH THE DETAILS SHOWN ON THIS PLAN. 2. THE COST FOR REQUIRED CONSTRUCTION DUST AND EROSION CONTROL MEASURES SHALL BE INCIDENTAL TO THE PROJECT COST.

3. ALL WORK RELATIVE TO FOUNDATION CONSTRUCTION, SITE PREPARATION, AND PAVEMENT INSTALLATION, AS SHOWN ON THIS PLAN, SHALL BE CONSTRUCTED IN ACCORDANCE WITH THE "GEOTECHNICAL INVESTIGATION," AS PROVIDED BY THE ARCHITECT OR OWNER. ALL OTHER WORK SHALL, UNLESS OTHERWISE STATED OR PROVIDED FOR HEREON, BE CONSTRUCTED IN ACCORDANCE WITH THE PROJECT, (FIRST PRIORITY) SPECIFICATIONS, AND/OR THE CITY OF ALBUQUERQUE (COA) STANDARD SPECIFICATIONS FOR PUBLIC WORKS (SECOND PRIORITY).

4. EARTH SLOPES SHALL NOT EXCEED 3 HORIZONTAL TO 1 VERTICAL UNLESS SHOWN OTHERWISE.

5. IT IS THE INTENT OF THESE PLANS THAT THIS CONTRACTOR SHALL NOT PERFORM ANY WORK OUTSIDE OF THE PROPERTY BOUNDARIES EXCEPT AS REQUIRED

6. THE CONTRACTOR IS TO ENSURE THAT NO SOIL ERODES FROM THE SITE ONTO ADJACENT PROPERTY OR PUBLIC RIGHT-OF-WAY. THIS SHOULD BE ACHIEVED BY CONSTRUCTING TEMPORARY BERMS OR SILT FENCE AT THE PROPERTY LINES AND WETTING THE SOIL TO PROTECT IT FROM WIND EROSION.

7. A DISPOSAL SITE FOR ANY & ALL EXCESS EXCAVATION MATERIAL, AND UNSUITABLE MATERIAL AND/OR A BORROW SITE CONTAINING ACCEPTABLE FILL MATERIAL SHALL BE OBTAINED BY THE CONTRACTOR IN COMPLIANCE WITH APPLICABLE ENVIRONMENTAL REGULATIONS AND APPROVED BY THE OBSERVER. ALL COSTS INCURRED IN OBTAINING A DISPOSAL OR BORROW SITE AND HAUL TO OR FROM SHALL BE CONSIDERED INCIDENTAL TO THE PROJECT AND NO SEPARATE MEASUREMENT OR PAYMENT SHALL BE MADE.

8. PAVING AND ROADWAY GRADES SHALL BE +/- 0.05' FROM PLAN ELEVATIONS. PAD ELEVATION SHALL BE +/- 0.05' FROM BUILDING PLAN ELEVATION.

9. ALL PROPOSED CONTOURS AND SPOT ELEVATIONS REFLECT TOP OF PAVEMENT ELEVATIONS IN THE PARKING AREA AND MUST BE ADJUSTED FOR PAVEMENT, MEDIANS, AND ISLANDS.

10. VERIFY ALL ELEVATIONS SHOWN ON PLAN FROM BASIS OF ELEVATION CONTROL STATION (IF APPLICABLE) PRIOR TO BEGINNING CONSTRUCTION.

11. THE CONTRACTOR SHALL PROVIDE THE SWPPP DOCUMENT (IF NECESSARY) AND SHALL ABIDE BY ALL LOCAL, STATE, AND FEDERAL LAWS, RULES AND REGULÁTIONS WHICH APPLY TO THE CONSTRUCTION OF THESE IMPROVEMENTS, INCLUDING EPA REQUIREMENTS WITH RESPECT TO STORM WATER DISCHARGE.

#### IMPERVIOUS AREA CALCULATIONS PROPOSED SITE CONDITIONS


TOTAL SITE AREA: 91,995 SF PERVIOUS AREA: 39,379 SF (42.80%) IMPERVIOUS AREA: 52,616 SF (57.20%)

STORMWATER QUALITY VOLUME CALCULATION

TOTAL IMPERVIOUS AREA = 52,616 SF SWQ VOLUME REQ'D = 52,616\*0.42" / 12 = 1.842 CFTOTAL VOLUME PROVIDED = 23.570 CF

### Pond Volume Calculations

5085.0 1920 0.0 0.0	Sum
5086.0 2934 2427.0 2427.0	t)
5086.0       2934       2427.0       2427.0         5087.0       4006       3470.0       5897.0         5088.0       5136       4571.0       10468.0         5089.0       6322       5729.0       16197.0         5090.0       8424       7373.0       23570.0	0 0 0 0

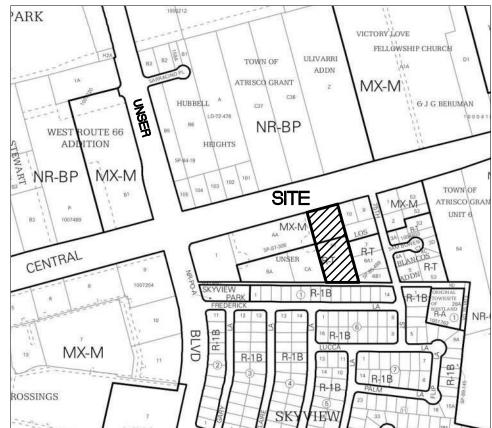

### VICINITY MAP - Zone Atlas K-10-Z

### **LEGAL DESCRIPTION:**

The West One-Half of Tract 52, Unit No. 6 of Plat of Town of Atrisco Grant, Bernalillo County, NM.



### FIRM MAP 35001C0328J

Per FIRM Map 35001C0328J, dated November 04, 2016, the site is not located in the Floodplain and determined to be outside the 0.2% chance Annual Floodplain.'

DRAINAGE MANAGEMENT PLAN

### INTRODUCTION

The purpose of this submittal is to provide a grading and drainage plan for a new multifamily project located at 7600 Central Ave SW. The site is currently undeveloped. The property consists of approximately 2.11 acres and is legally described as the West 1/2 of Tract 52, Unit No 6, Town of Atrisco Grant.

### EXISTING HYDROLOGIC CONDITIONS

The site currently slopes from north to south into minor low areas that pond. The drainage either infiltrates into the existing sandy soils or drains to the east into the Volcano Road Right-of-Way. Volcano Rd is not paved and it is our understanding that this road will remain unpaved.

### PROPOSED HYDROLOGIC CONDITIONS

The proposed site will drain into a new retention pond located on the south side of the property. Per the Calculations Table this sheet, the site generates 12,928 CF of drainage during the 100-Yr, 6-Hr Storm. 23,570 CF of volume is provided in the proposed pond, which should discharge in approximately 7 hours via percolation into the soil.\*\*


### CONCLUSION


This drainage management plan provides for grading and drainage elements which are capable of safely passing the 100 year storm and meets city requirements. The proposed improvements for the site should not have any negative impacts to facilities downstream. With this submittal, we are requesting approval of both Grading Permit and Building Permit.

		Exis	tina Dr	ainage	Calcula	ations							
This	able is based on	the COA DPM (	Chapter 6.2	2 (A), Zone:	1								
BASIN	Area	Land Treatment Percentages (%)				Weighted C	Tc	I (100)	Q(100)	Q(100)	WTE	V(100) <sub>380</sub>	V(100) <sub>10da</sub>
	(AC.)	Α	В	С	D		(min)	(in/hr)	(cfs/ac.)	(CFS)	(inches)	(CF)	(CF)
SITE	2.11	0.0	0.0	100.0	0.0	0.63	12.00	2.87	1.81	3.82	0.95	7276	7276
TOTAL	2.11									3.82		7276	7276
		Propo	sed Di	ainage	Calcul	ations							
		Ultim ate	Deve lopme	ent Conditio	ns Basin I	Data Table							
This	table is based on	the COA DPM	Chapter 6.	2(A), Zone:	1								
BASIN	Area	Land Treatment Percentages (%)				Weighted C	Tc	I (100)	Q(100)	Q(100)	WTE	V(100) <sub>380</sub>	V(100) <sub>10da</sub>
	(AC.)	Α	В	С	D		(min)	(in/hr)	(cfs/ac.)	(CFS)	(inches)	(CF)	(CF)
SITE	2.11	0.0	0.0	42.8	57.2	0.78	12.00	3.59	2.81	5.93	1.69	12928**	19368
TOTAL	2.11									5.93		12928	19368

### \*\*SOIL PERCOLATION DATA

PER PERCOLATION TESTS CONDUCTED BY GEO-TEST, INC. (PATRICK WHORTON, PE), THE SOILS AT THE SOUTH POND DRAIN AT A RATE OF 9 MINUTES PER INCH. THIS EQUATES TO 6.67 INCHES PER HOUR. THE POND BOTTOM IS 1,920 SF WHICH MEANS THAT THE POND CAN DRAIN 1,067CF/HR (25,613 CF/DAY).SINCE THE 100 YR - 6 HR STORM VOLUME FOR BASIN A IS 2,553 CF, THE POND SHOULD BE ABLE TO COMPLETELY DRAIN IN JUST OVER 7

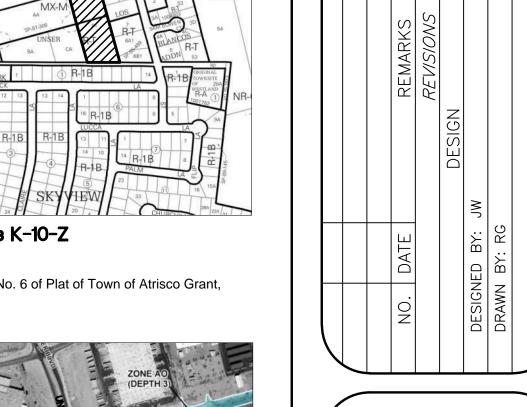

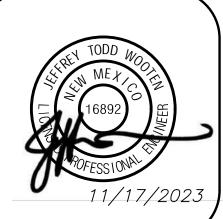


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FIRE 1




C METAL COPING -SPLIT FACE CMU —

6" DIAMETER

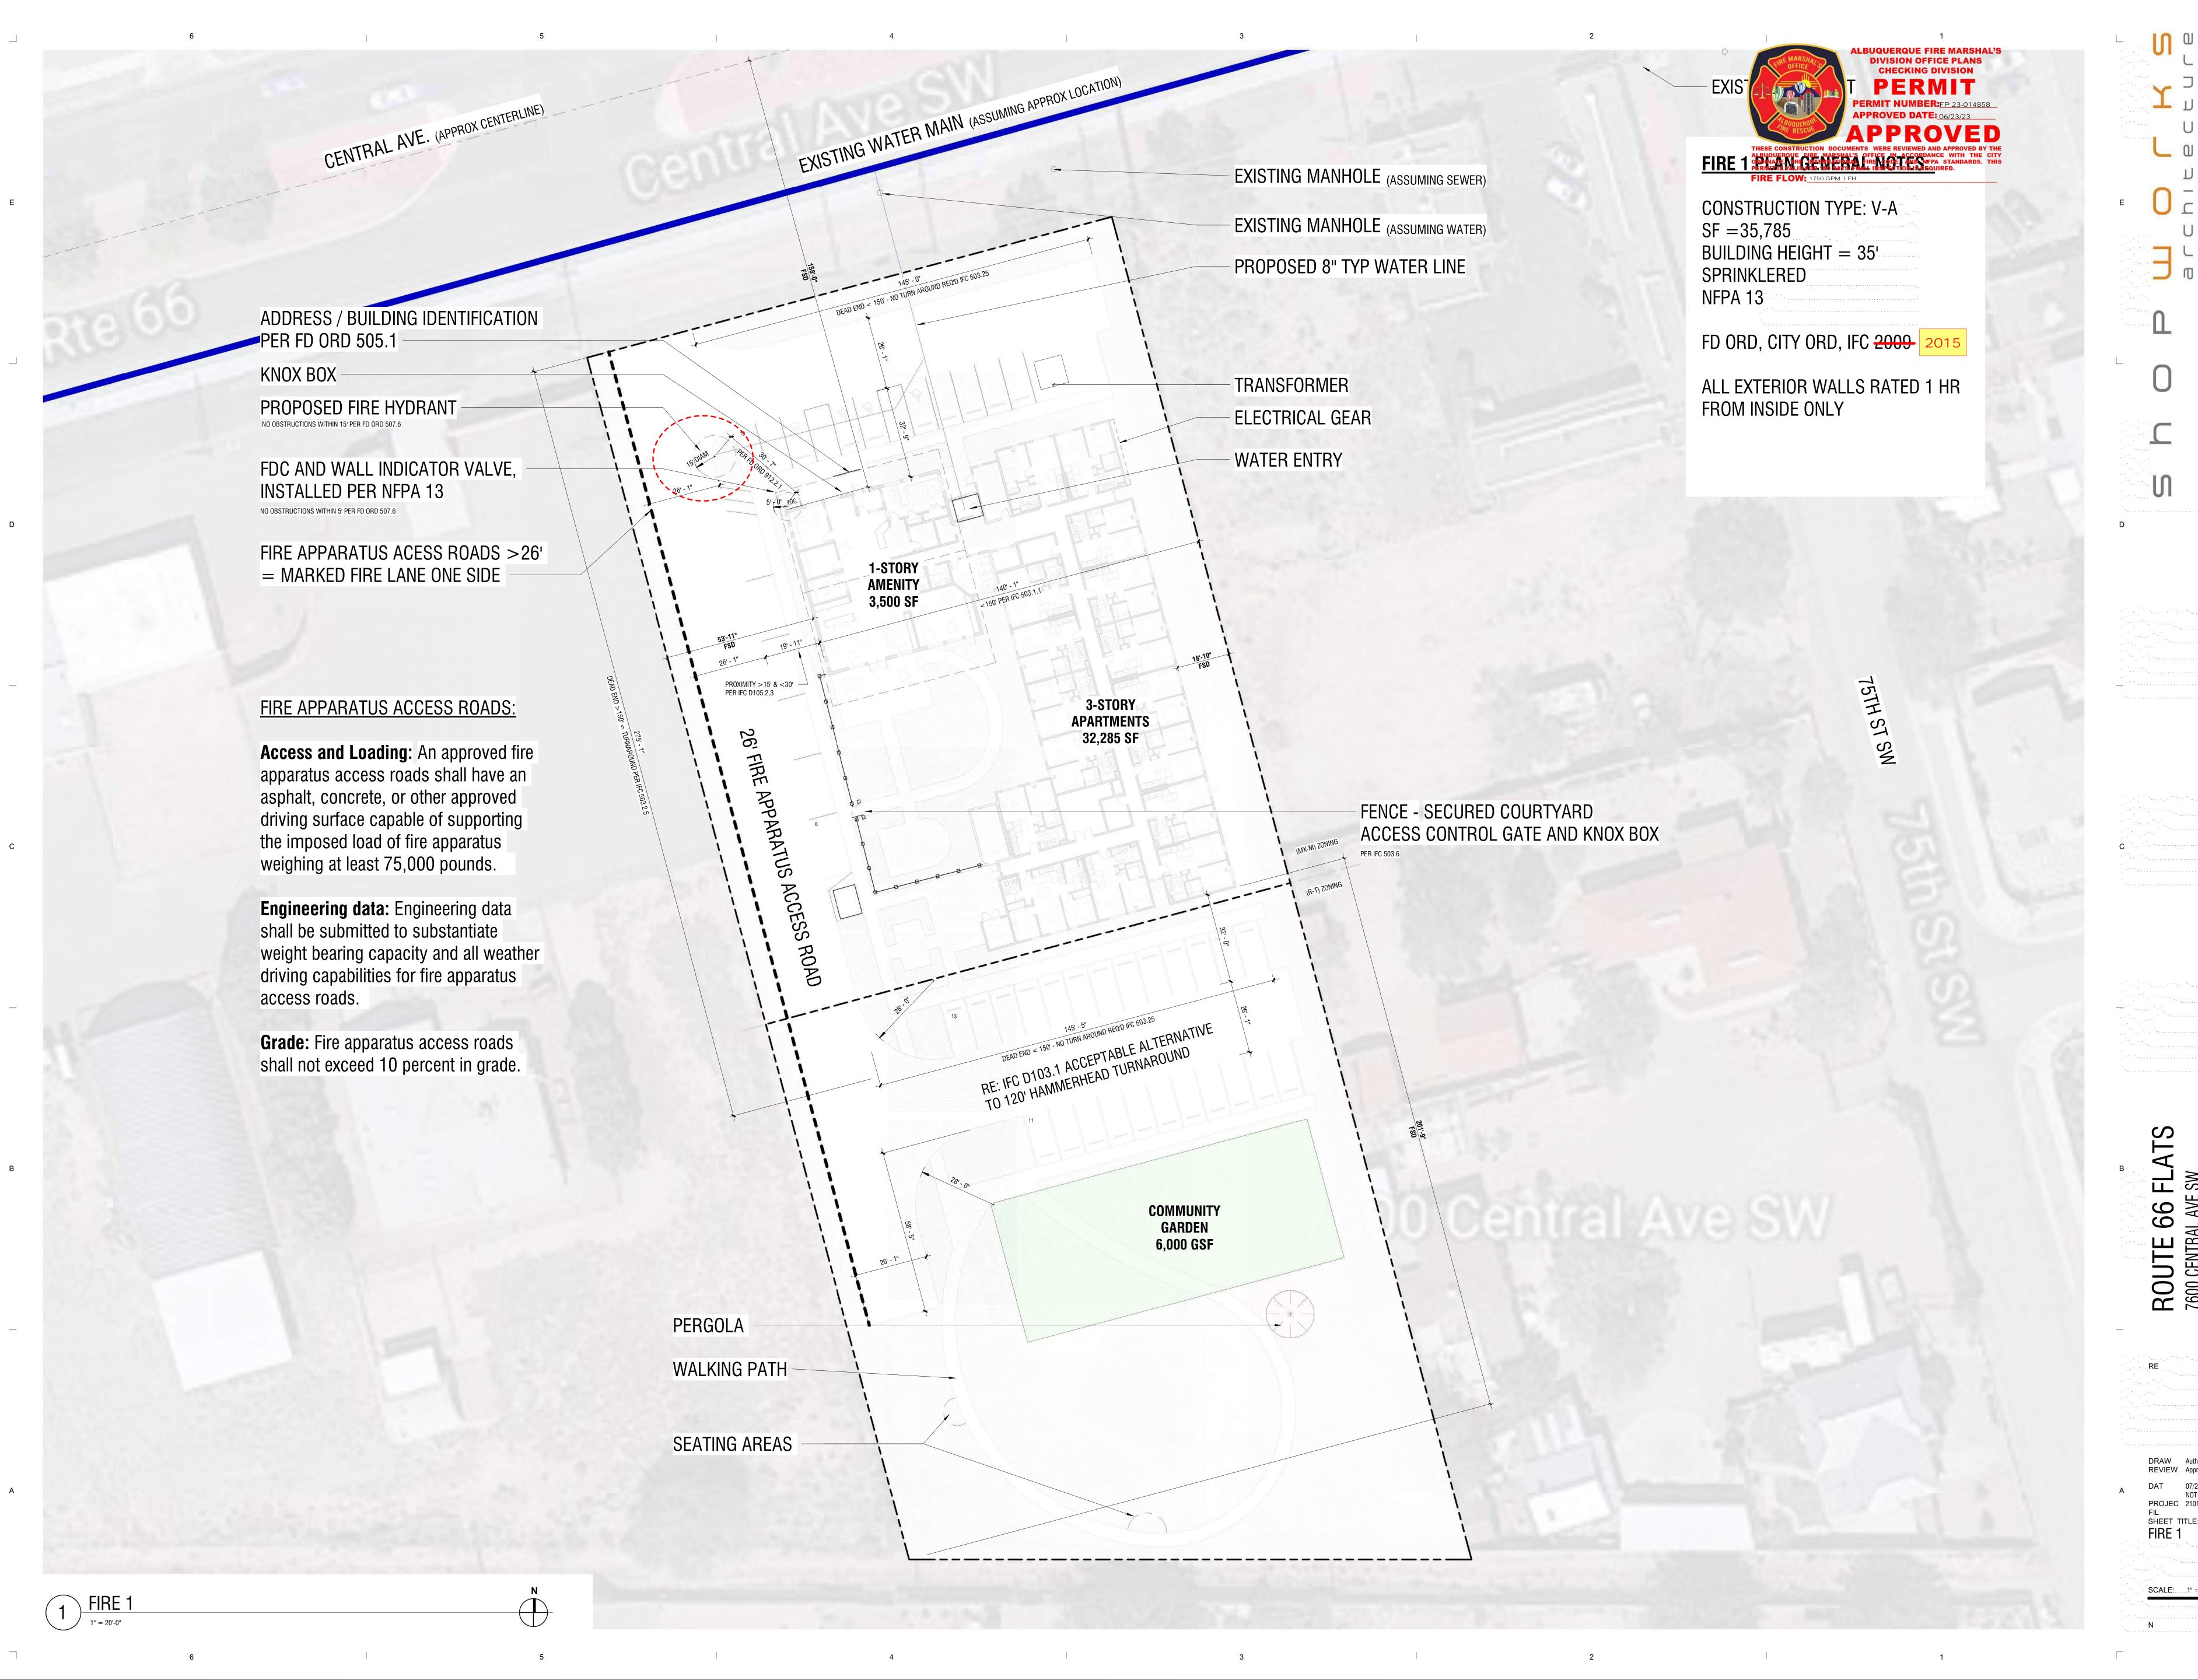PARKING BOLLARD

TRASH ENCLOSURE WALL SECTION

1/2" = 1'-0"

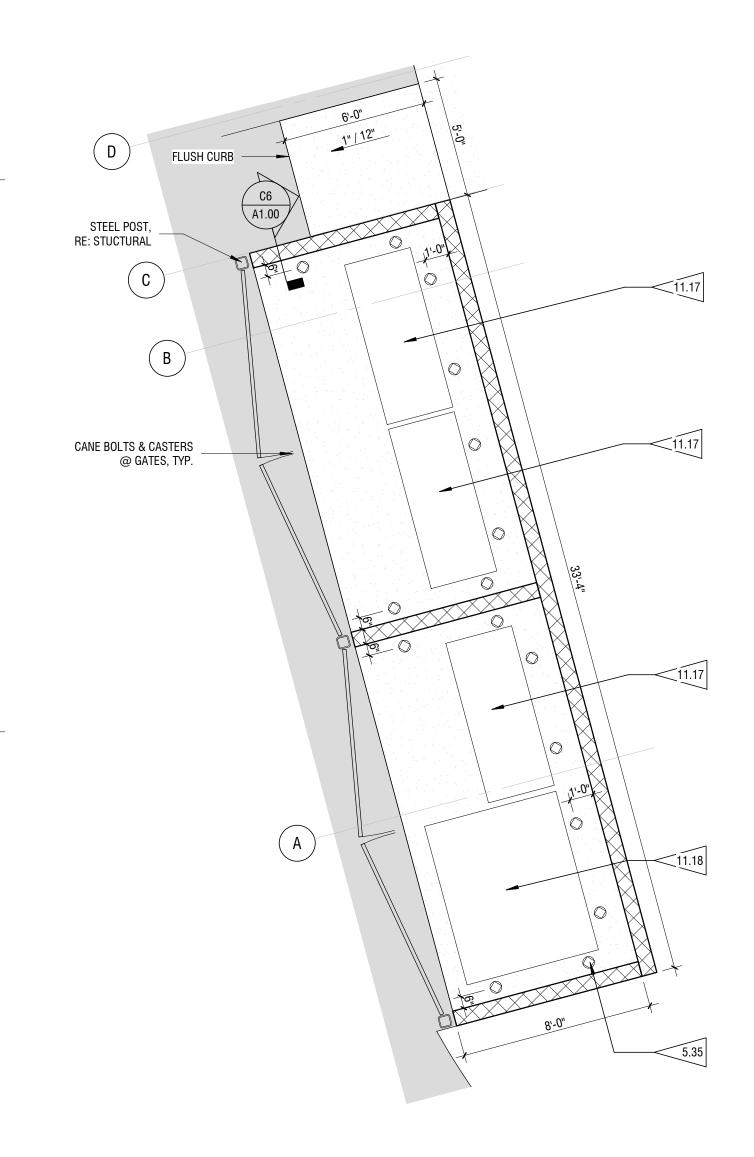

TRASH ENCLOSURE ENLARGED PLAN