

PARKING CALCULATIONS

PARKING	G CALCULATIONS		G		View Additional D	etails
	THE HUMAN BEAN (PROPOSED PAD SITE B	UILDING "A") CURR	ENT PHASE			
USE	IDO PARKING REQUIREMENT	GFA	CALCULATION	REQUIRED SPACES	_	
Restaurant	8 spaces / 1000 sq. ft.	640	(640/1000) 🛚 8	5		
Outdoor Seating	3 spaces / 1000 sq. ft.	385	(385/1000) X 3	1		
	TOTAL OF	REQUIRED:	~\\ 6 ~\\	710		
	TOTAL PROVIDED OF	PROVIDED:	12			
	NMBC Table 1106.1 - Number of Access	ble Parking Spaces		1		
	Number of Van Accessible Parking S	paces (IBC 1106.5)		1		
IDO Table 5-5-4: Moto	rcycle Parking Requirements	1-25		1 space		
IDO Table 5-5-5: Bicvcl	e Parking Requirements			3		

Non-residential uses not listed in this table: 3 spaces or 10% of required off-street parking spaces, whichever is greater.

Bernalillo County Parcels

UPC: 101906221851121543

CENTER CONT 36,647 SQ FT M/L

Acres: 0.8413

Tax Year: 2022

EXISTING

EXISTING

CURVE = C1 LENGTH = 120.13'

RADIUS = 800.00'

CHORD = 120.02'

 $DELTA = 8^{\circ}36'13''$

CHORD BEARING = S76°21'00"E



97' - 0"

8' - 0"

36' - 6" (43) ___

LOADING AND UNLOADING

COVERED OUTDOOR SEATING


PROPOSED BUILDING PAD SITE BLDG. "A"

ONE-STORY (20'-0" TALL)

front setback 5-ft

PROPERTY LINE

-EXISTING-

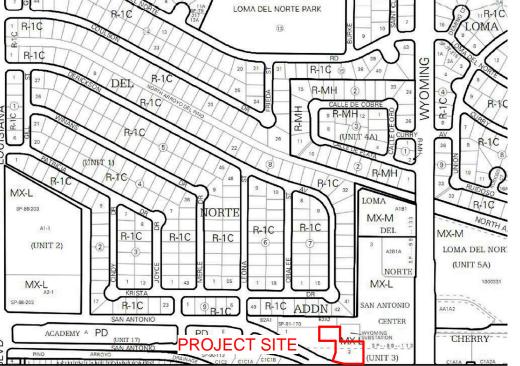


ZONE ATLAS PAGE D-19-Z

8' - 6"


order waiting space

12' - 8"

28'-11 1/2"

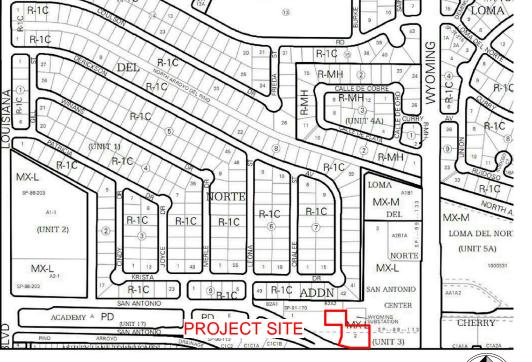

NOT TO SCALE

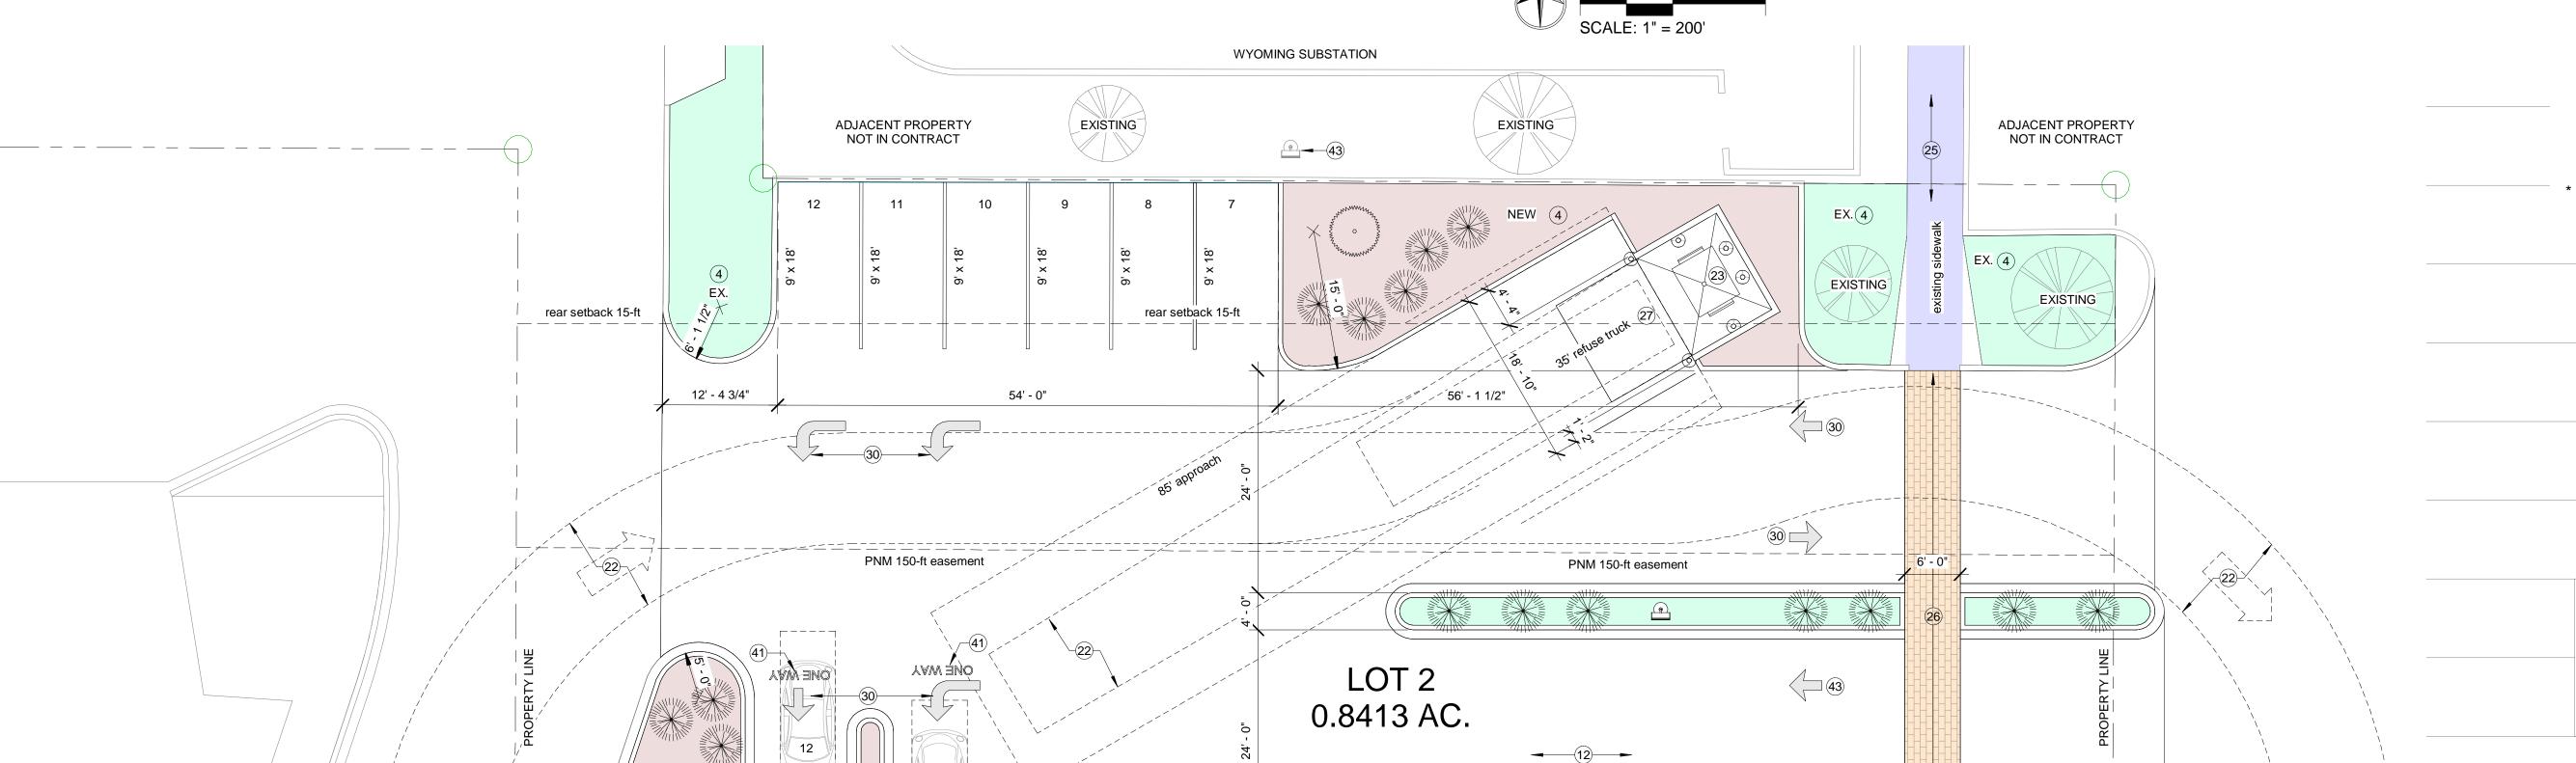

→ (7) **→**

9' - 0"

SAN ANTONIO DR. N.E. 86-FT PUBLIC RIGHT OF WAY

PROJECT NUMBER:

This plan is consistent with the specific Site Development Plan approved by the Environmental Planning Commission (EPC), dated _ Findings and Conditions in the Official Notification of Decision are satisfied.

Is an Infrastructure List required? () Yes () No If yes, then a set of approved DRC plans with a work order is required for any construction within Public Right-of-Way or for construction of public improvements.

DFT SITE DEVELOPMENT PLAN APPROVAL:

Traffic Engineering, Transportation Division	Date
ABCWUA	Date
Parks and Recreation Department	Date
Hydrology	Date
Code Enforcement	Date
* Environmental Health Department (conditional)	Date
Solid Waste Management	Date
Planning Department	 Date

* Environment Health, if necessary

PROJECT ADDRESS:

7101 San Antonio Drive N.E. Albuquerque, NM 87109 Bernalillo County, New Mexico

LEGAL DESCRIPTION

Lot numbered Two (2) as shown on the Plat of Lots 1, 2, & 3, SAN ANTONIO CENTER, Albuquerque, New Mexico as the same is shown and designated on said plat, filed in the Office of the County Clerk of Bernalillo County, New Mexico on April 24, 1989 in Bk. C39, Pg. 16.

UPC: 1-019-062-218-511-21543

CURRENT OWNER: American Stores Properties, Inc. OWNER ADDRESS: 7830 Orlando Ave. Lubbock, Tx 79423 SITUS ADDRESS: 7301 San Antonio Dr NE, Albuquerque, NM

ZONING

Zoning Map: D-19-Z IDO Zone District: MX-L

IDO District Definition: Mixed-use Zone District IDO Category: Non-Residential Proposed Permissive Uses: Restaurant Total Site Area: 0.8413 acres / 36,644 SF

BUILDING ON LOT:

Minimum front yard setback = 5 feet Actual Front "South" Setback depth is 35'-5 1/2"

Minimum side yard depth = 0 feet
Actual Side yard "East" depth is 25'-4" Actual Side yard "West" depth is 107'-8 1/2" Minimum rear yard depth = 15 feet Actual Rear yard "North" is 100'-1 1/2"

Building Coverage Maximum = 50% Building: 640 GSF = 0.01469 acres Site: 36,644 GSF = 0.8413 acres 1.75% Actual Building Coverage

TRAFFIC CIRCULATION:

Quantity (2) two-way traffic ingress/egress site entrances from San Antonio Drive NE.

CODES AND STANDARDS

This project shall be in accordance with the following Building Codes including all local ammendments:

- 2015 New Mexico Mechanical Code; including Appendixes A, B, C, and D 2015 New Mexico Plumbing Code; including Appendixes A, B, D, E, F, I, and
- 2018 International Energy Conservation Code 2015 New Mexico Commercial Building Code including Appendix Chapters H, J, K, M, R, and S, but not including Appendix Chapters A, B, C, D, E, F, G, I,
- L, N, O, P, and Q 2015 International Code Council Performance Code for Buildings and Facilities, including all Appendix Chapters as published by the International
 - 2015 International Building Code
 - 2015 International Mechanical Code 2015 International Plumbing Code
 - 2015 International Fire Code
- 2015 International Energy Conservation Code 2017 New Mexico Electrical Code 2012 New Mexico Electrical Safety Code

Errata sheets to the adopted portions of Codes promulgated by the International Code Council, International Association of Plumbing and Mechanical Officials and National Electrical Code
ARE AS FOLLOWS:

Title 14, Chapter 5 of the New Mexico Building Code has been deleted and replaced with Chapter 1, on the following pages. Sections from various other parts of the Technical Codes have been amended, added, or deleted. These changes are noted on the pages following the Administrative Chapter No. 1.

OTHER GUIDELINES, REGULATIONS & STANDARDS Americans with Disabilities Act Accessibility Guidlines (ADAAG)

2015 INTERNATIONAL FIRE CODE

CHAPTER 5 FIRE SERVICE FEATURES SECTION 503 FIRE APPARATUS ACCESS ROADS

503.1.1. Approved fire apparatus access roads shall be provided for every facility, building or portion of building...and shall extend to within 150 feet of all portions of the facility... 503.2.1 Dimensions. Unobstructed width of not less than 20 feet and unobstructed vertical clearance of not less than 13 feet 6 inches

503.2.4 Turning radius. The required turning radius of a fire apparatus access road shall be determined by the fire code official SECTION 506 KEY BOXES 506.1 - 506.2: Provide approved type Key Box as required by the fire code

APPENDIX J - BUILDING INFORMATION SIGN

Per Figure J101.1.3 Top Wing: "VB" Right Wing: "NS" Bottom Wing: "B"

> Left Wing: "LH" Center Circle: "TC" or designation as defined by Albuquerque Fire Dept.

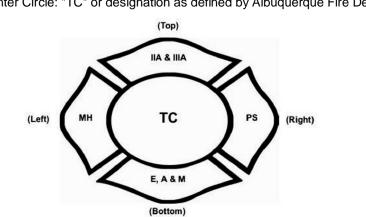


FIGURE J101.1.3 EXAMPLE OF COMPLETED BUILDING INFORMATION SIGN

Keyed Notes: #

- . Proposed building structure. . Private ingress / egress location, width of drive aisle as indicated.
- . Buffer landscaping. Landscaping. Menu display board, see detail 9 / A1.
- 6. Menu display board with speaker / microphone ordering station, see detail 9 /
- 7. Drive-through lanes asphaltic concrete. 8. New concrete sidewalk, max. cross slope 1:50.
- 9. ADA concrete ramp, slope 1:12 maximum, heavy broom finish.
- 10. Concrete landing, 1:50 max. cross slope. 11. Detectable warning with truncated domes (2-ft x width of ramp), safety yellow. 12. New asphaltic concrete drive apron.
- 13. Concrete curb and gutter, see detail 2 / A1. 14. ADA van accessible parking space with universal accessibility symbol.
- 15. Motorcycle parking space. 16. Bicycle parking rack (typ. of 2), see detail 14 / A1. 17. Pavement markings "white".
- 18. 6' long pre-cast concrete parking stop, centered in parking space, set 24" from sidewalk edge.
- 19. New pole light, steel pole, 20' tall, "bronze". Final location(s) determined by lighting consultant or electrical engineer, see detail 15 / A1.
- 20. Monument sign (4'-4" high x 6'-0" wide), integral color "brown" CMU with text "the HUMAN BEAN" and logo, see detail 6a / DFT1.
- 21. Header curb, integral with ramp and / or landing, see CABQ dwg. 2415C. 22. Refuse truck maneuvering and circulation route (40-ft inside, 52-ft outside
- 23. Traffic sign, "ONE WAY DO NOT ENTER", see detail 8 / A1. 24. Traffic sign, "DRIVE THRU ENTRY", see detail 8 / A1.
- 25. ADA pedestrian access to site (6-ft wide) shaded "blue". 26. Integral color textured concrete - brick paver pattern, color "Terra Cota".
- 27. Refuse container concrete pad with drain, apron, bollards and gate. See enlarged plan and details on A1.
- 28. Pipe bollard, painted traffic yellow (6"Ø x 7'-0" high).
- 29. Pipe bollard, painted traffic yellow (6"Ø x 4'-6" high). 30. Pavement markings, see detail 7 / A1.
- 31. New corner access ramp per CABQ dwg. 2441.
- 32. Existing concrete sidewalk. Replace any and all broken or cracked sidewalks, see General Note B.
- 33. Electrical metering equipment. 34. Flared sides, 1:10 maximum slope.
- 35. Building information sign per IFC 2015 Appendix J, See G0 2015 International
- Fire Code notes. 36. Provide "Knox-box" brand key box.
- https://www.knoxbox.com/Products/Commercial-KnoxBoxes.
- 37. Van accessible parking sign, see detail 12 / A1. 38. Motorcycle parking sign, see detail 12 / A1.
- 39. Existing "mature" tree, see Landscaping Plan. 40. New "screening" tree, see Landscaping Plan.
- 41. Pavement marking, 12" high lettering, text as shown, "white" fast dry waterborne traffic marking paint. 42. Pavement marking, 12" high lettering, text as shown, "red" fast dry waterborne
- traffic marking paint.
- 43. Existing pole light, 16-ft. tall, "dark bronze" to remain.

General Notes:

- A. ALL ADA RAMPS SHALL HAVE A RUNNING SLOPE NOT TO EXCEED 1:12.
- ALL RAMPS, SIDEWALKS AND LANDINGS SHALL HAVE A CROSS SLOPE NOT TO EXCEED 1:50. B. ALL BROKEN OR CRACKED SIDEWALKS MUST BE REPLACED WITH
- SIDEWALK AND CURB & GUTTER. CONFORM TO CABQ SIDEWALK DRG. 2720 AND CURB AND GUTTER DWG. 2415A. C. LANDSCAPING AND SIGNAGE WILL NOT INTERFERE WITH CLEAR SIGHT REQUIREMENTS, THEREFORE, SIGNS, WALLS, TREES, AND
- SHRUBBERY BETWEEN 3 AND 8 FEET TALL (AS MEASURED FROM THE GUTTER PAN) WILL NOT BE ACCEPTABLE IN THE CLEAR SIGHT



Date No. Description DFT APPLICATION 5-2-2023 DFT COMMENTS 6-5-2023 TCL SUBMISSION 6-7-2023 **BUILDING PERMIT** 6-9-2023 6-25-2023 TCL RESUBMISSION DFT RESUBMISSION 6-28-2023 ISSUED FOR BLDG PERMIT 8-7-2023 DFT COMMENTS 8-21-2023


OWNER: KEITH GRIEGO

HUMAN BEAN - SAN **ANTONIO & WYOMING**

SITE PLAN -ARCHITECTURAL

Project Number Project Number 8-21-2023 J. SANCHEZ Drawn By K. GRIEGO Checked By

Scale

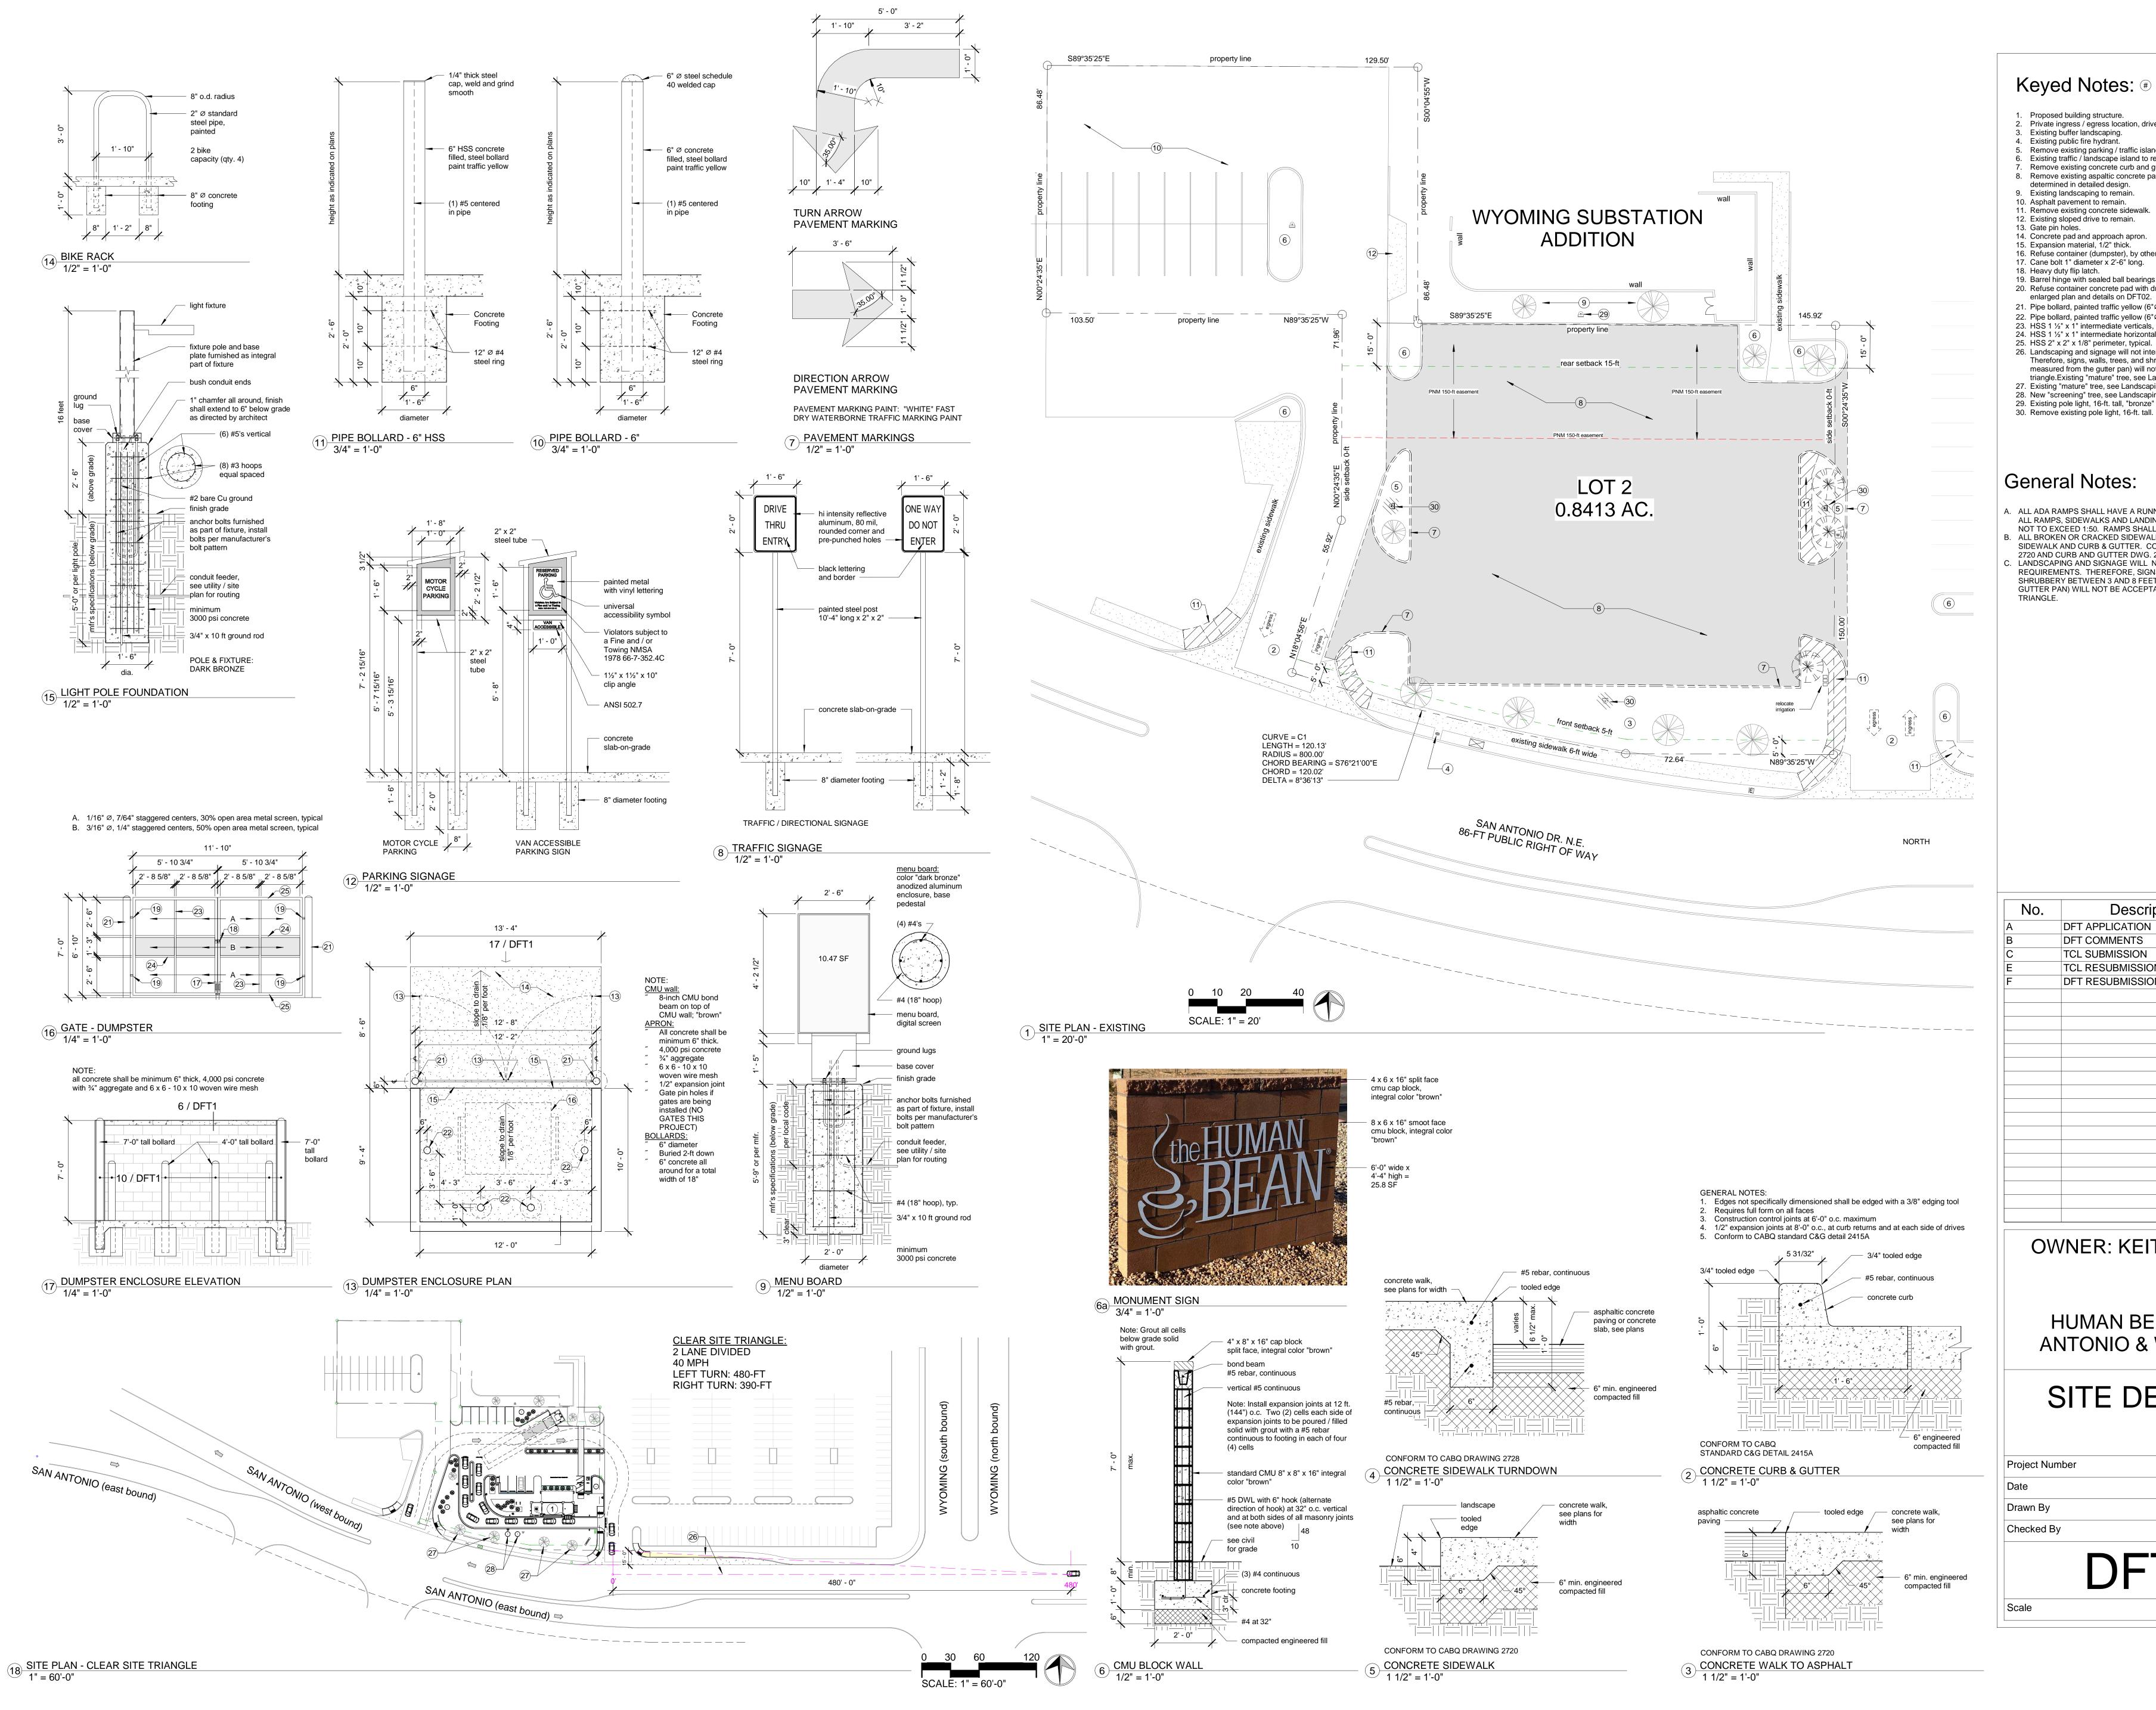

Keyed Notes:

- 1. Proposed building structure. Private ingress / egress location, drive aisle.
 Existing buffer landscaping.
- 4. Existing public fire hydrant.
- 5. Remove existing parking / traffic island. 6. Existing traffic / landscape island to remain.
- 7. Remove existing concrete curb and gutter. 8. Remove existing aspaltic concrete paving. Extent of removal to be determined in detailed design.
- 9. Existing landscaping to remain. 10. Asphalt pavement to remain.
- 11. Remove existing concrete sidewalk. 12. Existing sloped drive to remain.
- 13. Gate pin holes. 14. Concrete pad and approach apron.
- 15. Expansion material, 1/2" thick. 16. Refuse container (dumpster), by others
- 17. Cane bolt 1" diameter x 2'-6" long.
- 18. Heavy duty flip latch. 19. Barrel hinge with sealed ball bearings. 20. Refuse container concrete pad with drain, apron, bollards and gate. See
- enlarged plan and details on DFT02.
- 21. Pipe bollard, painted traffic yellow (6"Ø x 7'-0" high). 22. Pipe bollard, painted traffic yellow (6"Ø x 4'-6" high).
- 23. HSS 1 ½" x 1" intermediate verticals, typical.
 24. HSS 1 ½" x 1" intermediate horizontals, typical.
 25. HSS 2" x 2" x 1/8" perimeter, typical.
- 26. Landscaping and signage will not interfere with clear sight requirements. Therefore, signs, walls, trees, and shrubbery between 3 and 8 feet tall (as measured from the gutter pan) will not be acceptable in the clear sight
- triangle.Existing "mature" tree, see Landscaping Plan. 27. Existing "mature" tree, see Landscaping Plan.
- 28. New "screening" tree, see Landscaping Plan. 29. Existing pole light, 16-ft. tall, "bronze" to remain.

General Notes:

- A. ALL ADA RAMPS SHALL HAVE A RUNNING SLOPE NOT TO EXCEED 1:12. ALL RAMPS, SIDEWALKS AND LANDINGS SHALL HAVE A CROSS SLOPE
- NOT TO EXCEED 1:50. RAMPS SHALL HAVE HEAVY BROOM FINISH. B. ALL BROKEN OR CRACKED SIDEWALKS MUST BE REPLACED WITH SIDEWALK AND CURB & GUTTER. CONFORM TO CABQ SIDEWALK DRG.
- 2720 AND CURB AND GUTTER DWG. 2415A. LANDSCAPING AND SIGNAGE WILL NOT INTERFERE WITH CLEAR SIGHT REQUIREMENTS. THEREFORE, SIGNS, WALLS, TREES, AND SHRUBBERY BETWEEN 3 AND 8 FEET TALL (AS MEASURED FROM THE GUTTER PAN) WILL NOT BE ACCEPTABLE IN THE CLEAR SIGHT




No.	Description	Date
	DFT APPLICATION	5-2-2023
	DFT COMMENTS	6-5-2023
	TCL SUBMISSION	6-7-2023
	TCL RESUBMISSION	6-25-2023
	DFT RESUBMISSION	6-28-2023
	•	<u>'</u>

OWNER: KEITH GRIEGO

HUMAN BEAN - SAN **ANTONIO & WYOMING**

SITE DETAILS

Date	6-28-2023
Drawn By	J. SANCHEZ
Checked By	K. GRIEGO

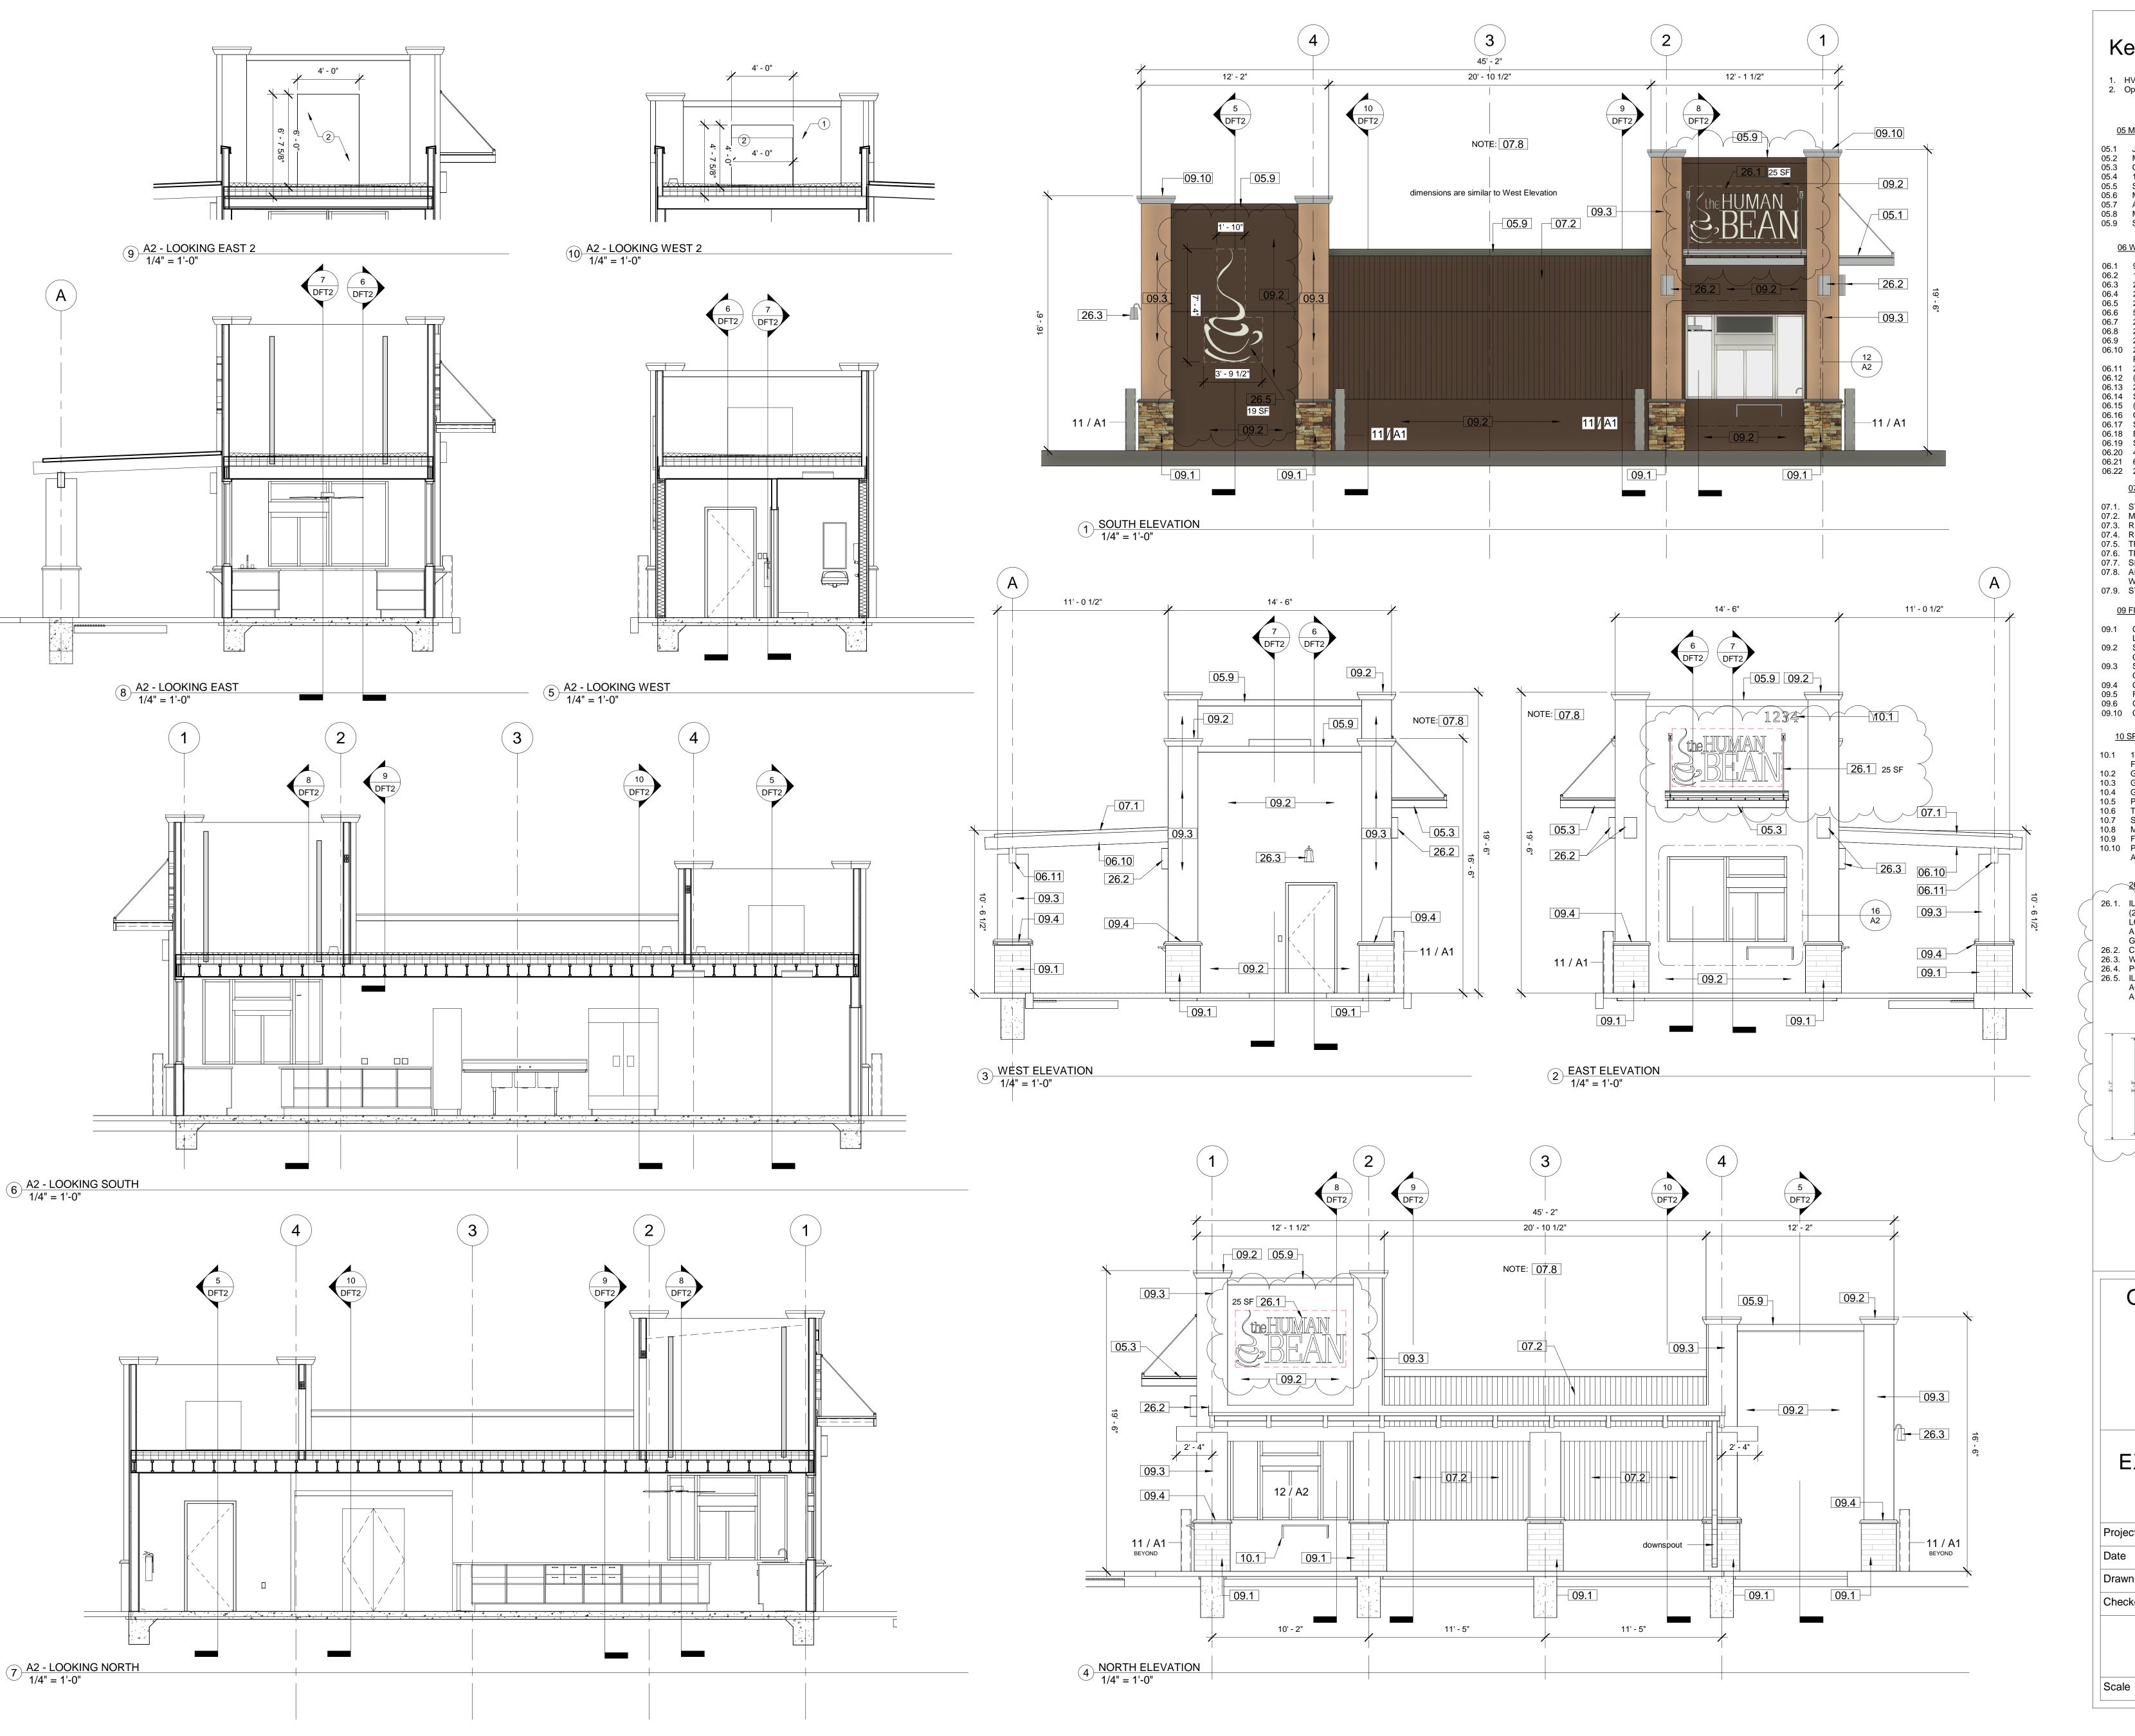

Keyed Notes:

 HVAC rooftop equipment. Opening in wall.

05 METALS:

05.1 JOIST HANGER.05.2 METAL CORNER BEAD.05.3 CUSTOM BUILT METAL AWNING.

05.4 1/2" X 12" J-HOOK ANCHOR BOLT.

05.5 SLAB REINFORCEMENT, WWF 6 X 6 W 10 X 10 PER ASTM A185. 05.6 METAL FLASHING. 05.7 ANGLE 2 x 2 x 1/8" - MECHANICALLY FASTENED. 05.8 METAL DRIP EDGE ALL-AROUND.

05.9 SNAP-ON METAL COPING COVER.

06 WOODS, PLASTICS AND COMPOSITES:

9 1/2 ROSEBURG, 4000 RFPI, 16" O.C. TYPICAL.
 1.4E RIDGERIM LVL, RIM JOIST.

06.3 2 X 6 TREATED SILL PLATE.

06.4 2 X 6 WOOD FRAMING, 16" O.C. 06.5 2 X 6 DOUBLE TOP PLATE.

06.6 5/8" PLYWOOD ROOF DECK. 06.7 2 X 10 ROOF JOISTS.

06.8 2 X 6 ROOF JACKS, 16" O.C. 06.9 2 X 6 BLOCKING.

06.10 2 X 10 BLOCKING (2 BAYS DEEP) AT PANEL EDGES WITH PLYWOOD INFILL ON BCI'S FOR BRACING.

06.11 2 X 10 WOOD BLOCKING. 06.12 (2) 2 X 4 TOP PLATES.

06.13 2 X 4 FRAMING, 16" O.C. 06.14 SOFFIT BOARD, ALL AROUND. 06.15 (2) 2 X 10 HEADER.

06.16 CORNER KEY, FRY REGLET - TYPICAL AT ALL OUTSIDE CORNER. 06.17 STUCCO J-MOLD, FRY REGLET

06.18 EXTERIOR SHEATHING, 5/8" THICK. 06.19 SHIM, 1/4" OR AS REQUIRED. 06.20 4 X 10 WOOD JOIST - 12'-6" LENGTH.

06.21 6 X 12 WOOD BEAM. 06.22 2" NOMINAL TONGUE AND GROOVE WOOD DECK.

07 THERMAL AND MOISTURE PROTECTION: 07.1. STANDING SEAM METAL ROOF, DARK BRONZE.

07.2. METAL PANEL, RIBBED, DARK BRONZE. 07.3. RIGID INSULATION, 2" THICK.

07.4. RIGID INSULATION, 3 1/2" THICK.

07.5. TPO MEMBRANE, 60 MIL 07.6. TPO MEMBRANE, 60 MIL

07.7. SEALANT AND BACKER ROD. 07.8. AIR & WATER BARRIER BUILDING ENVELOPE, TYVEK® COMMERCIAL WRAP - ALL EXTERIOR SURFACES OF BLDG.

07.9. SYNTHETIC ROOF UNDERLAYMENT.

09 FINISHES:

09.1 CULTURED STONE CLADDING - EL DORADO, RUSSET MOUNTAIN LEDGE PANEL OR OWNER APPROVED EQUAL.

09.2 STUCCO FINISH MAIN BODY - MATCH SHERWIN WILLIAMS CUSTOM COLOR (DARK BRONZE) MC-29065.
09.3 STUCCO FINISH PILASTER - MATCH SHERWIN WILLIAMS CUSTOM

COLOR (DORMER BROWN) SW-7521.

09.4 CULTURED STONE CAP STONE - MATCH STONE CLADDING.

09.5 FIBERGLASS REINFORCED PANELS.

09.6 GYPSUM WALLBOARD, 5/8" THICK. 09.10 CONCRETE CAPSTONE.

10 SPECIALTIES:

10.1 12" x 36" 18 GA. STAINLESS STEEL WALL MOUNT SHELF ROUNDED FRONT EDGE 230 LB CAPACITY MODEL WS-1236.

GRAB BAR, STAINLESS STEEL 18"

GRAB BAR, STAINLESS STEEL 36"

GRAB BAR, STAINLESS STEEL 42"

PAPER TOWEL DISPENSER, WALL MOUNT M/N: ASI0210 INTRA.

TOILET PAPER DISPENSER SOAP DISPENSER, M/N: LTX-12 GOJO.

10.8 MIRROR, 18 x 36 WITH STAINLESS STEEL FRAME.
10.9 FIRE EXTINGUISHER, BRACKET MOUNTED 2A:10B:C GENERIC. 10.10 PREMISE IDENTIFICATION, 12" HIGH ALUMINUM NUMBERS. ADDRESS TO BE DETERMINED.

(25 SQUARE FEET). LOGO AND LETTER FACES "WHITE" ACRYLIC;

LOGO AND LETTER SIDE RETURNS, 5" DEPTH, PRE-FINISHED "BLACK"


ALUMINUM; INTERNALLY ILLUMINATED WITH "WHITE" LED LAMPS. SE

GRAPHIC IMAGE BELOW.

26.2. CUSTOM WALL SCONCE LIGHT FIXTURE.

26.3. WALL MOUNTED LIGHT FIXTURE.

26.4. POLE LIGHT, 20-FT TALL - SEE SITE PLAN. 26.5. ILLUMINATED LOGO, ~19 SQUARE FEET. LOGO FACE "WHITE" ACRYLIC; LOGO SIDE RETURNS, 5" DEPTH, PRE-FINISHED "BLACK" ALUMINUM; INTERNALLY ILLUMINATED WITH "WHITE" LED LAMPS

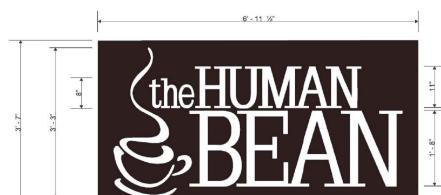




OWNER: KEITH GRIEGO


HUMAN BEAN - SAN ANTONIO & WYOMING

EXTERIOR ELEVATIONS & BUILDING SECTIONS

Project Number Project Number 8-21-2023 J. SANCHEZ Drawn By K. GRIEGO Checked By

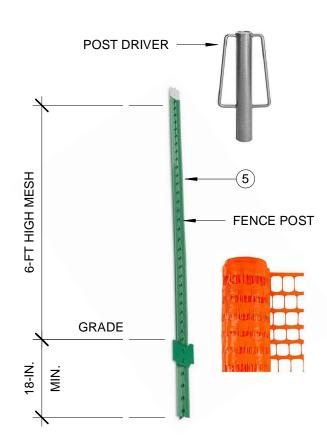

4 TREE PROTECTION DETAIL
3" = 1'-0"

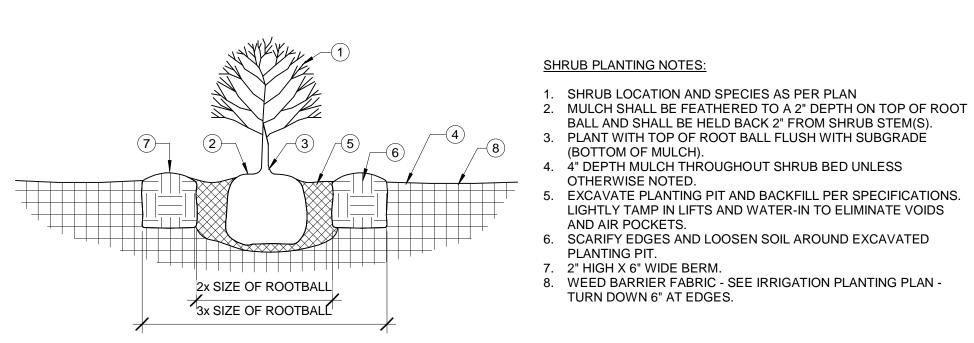

(BOTTOM OF MULCH).

OTHERWISE NOTED.

AND AIR POCKETS.

TURN DOWN 6" AT EDGES.


TREE PLANTING NOTES: 1. TREE LOCATION AND SPECIES AS PER PLAN 2. MULCH SHALL BE HELD BACK 4" FROM TREE TRUNK. 3. REMOVE EXISTING SOIL (FROM NURSERY) AS NEEDED TO

BALL AND SHALL BE HELD BACK 2" FROM SHRUB STEM(S).


EXCAVATE PLANTING PIT AND BACKFILL PER SPECIFICATIONS.

LIGHTLY TAMP IN LIFTS AND WATER-IN TO ELIMINATE VOIDS


- EXPOSE ROOT FLARE. INSTALL WITH ROOT FLARE FLUSH WITH SUBGRADE (BOTTOM OF MULCH). 4. MULCH - SEE PLANTING PLAN.
- 5. WEED BARRIER FABRIC SEE IRRIGATION PLANTING PLAN -TURN DOWN 6" AT EDGES. 6. INSTALL TREE PLUMB. REMOVE WIRE BASKET, WOOD BOX, PLASTIC, TWINE, AND / OR ROPE PRIOR TO BACKFILL. REMOVE BURLAP EXCEPT FROM BOTTOM OF ROOT BALL. 7. EXCAVATE PLANTING PIT AND BACKFILL PER SPECIFICATIONS.
- LIGHTLY TAMP IN LIFTS AND WATER-IN TO ELIMINATE VOIDS AND AIR POCKETS. 8. SCARIFY EDGES AND LOOSEN SOIL AROUND EXCAVATED
- 9. 4" HIGH X 12" WIDE BERM, 6-FT MINIMUM DIAMETER OR AS SHOWN ON THE PLANS.

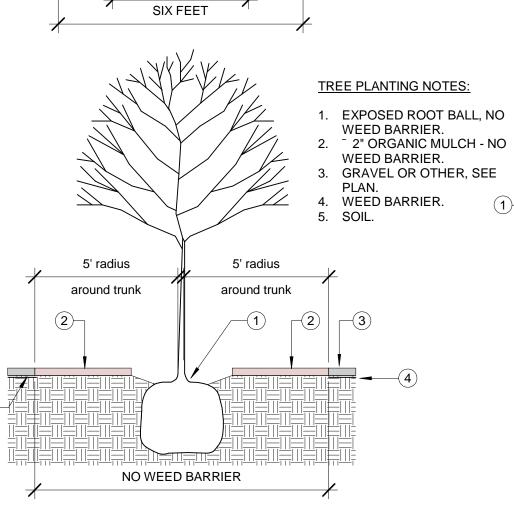

FOUR FEET

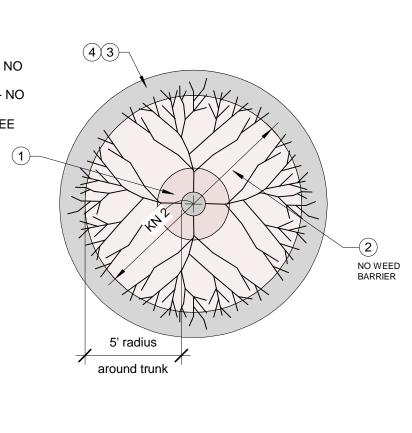

2 L1 - PLANTING 3/4" = 1'-0"

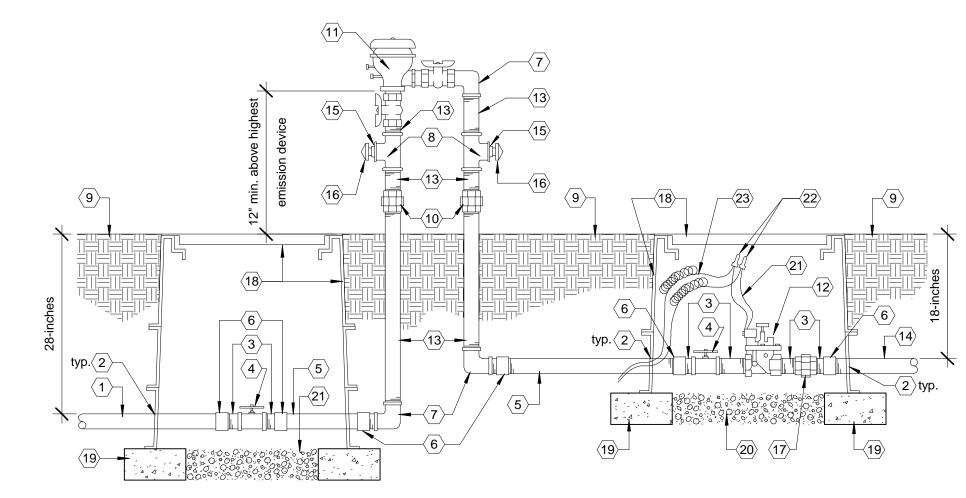

5-6 (C) (14) Irrigation Systems:

5-6 (C) (14) (a) Irrigation systems shall comply with Section 8 of the ABCWUA Legislation and Ordinances (Cross Connection Prevention and Control Ordinance.

5-6 (C) (14) (b) Irrigation systems shall be designed to minimize the use of water. 5-6 (C) (14) (c) All non-residential landscape

irrigation shall have automatic timers and/or programmable settings to avoid overwatering. 5-6 (C) (14) (d) Irrigation systems shall not spray or

irrigate impervious surfaces, including sidewalks, driveways, drive aisles, streets, and parking and

CONSTRUCTION NOTES: (#)

- 2. DRILLED HOLE THROUGH VALVE BOX
- EXTENSION. DIAMETER SHALL BE 1/2" LARGER THAN PIPE. 3. SCHEDULE 80 PVC NIPPLE.
- 4. SCHEDULE 80 PVC TRUE UNION BALL
- 5. CONSTANT PRESSURE IRRIGATION
- 6. SCHEDULE 80 TOE NIPPLE WITH SLIP GALVANIZED ELL
- 11. PRESSURE VACUUM BREAKER SEE IRRIGATION LEGEND.

8. GALVANIZED TEE.

9. FINISH GRADE.

12. AUTOMATIC MASTER VALVE - SEE IRRIGATION LEGEND. 13. GALVANIZED NIPPLE.


10. GALVANIZED UNION (MIN. 4" ABOVE FINISH

- 14. NON-CONSTANT PRESSURE IRRIGATION MAINLINE. 15. GALVANIZED REDUCER BUSHING.
- 16. GALVANIZED DRAIN PLUG. 17. SCHEDULE 80 PVC UNION. 18. 17" x 30" VALVE BOX WITH T-STYLE BOLT DOWN COVER AND EXTENSIONS AS
- 19. 4" x 8" x 16" SOLID CMU BLOCK, EIGHT PER VALVE BOX. 20. 6" DEPTH OF 1" DIAMETER WASHED
- GRAVEL OF ANY EQUIPMENT OR PIPING.

- REQUIRED SEE IRRIGATION LEGEND.
- 21. MASTER VALVE CONTROL WIRE. 22. WATERPROOF WIRE CONNECTOR. 23. 36" LENGTH WIRE EXPANSION LOOPS.

3 L1 - IRRIGATION BACKFLOW / VALVES 3/4" = 1'-0"

OTALS	GROSS LOT AREA 36,647	BUILDING AREA 640	NET LOT AREA 36,007	TOTAL LANDSCAPE AREA 7,129	15% NET LOT AREA (REQUIRED) LANDSCAPE AREA 5,401	PARKING LOT INCLUDING DRIVE- THROUGH LANES 24,379		Toposion Processor Land	TREE CANOPY COVERAGE 5,221	TREE TYPES	GROUND LEVEL PLANT COVERAGE (INCLUDING TURF) 3,897	PLANTING TYPES
		100000		.,,		11,940	EXIST. PARKING AREA	(((((((((((((((((((942	* PURPLE PLUM	68	* turf coverage
	3	12			10	12,439	NEW PARKING AREA		3,535	** ASH	208	* turf coverage
									254	AFGHAN PINE	300	* turf coverage
	3.1	77		4.5				1	490	DESERT WILLOW	214	* turf coverage
		7			10				1001		2,063	* turf coverage
											1,044	ground level plant coverage
					·				** NEW AND E	XISTING TO REMAI	N	* EXISTING TO REMAI

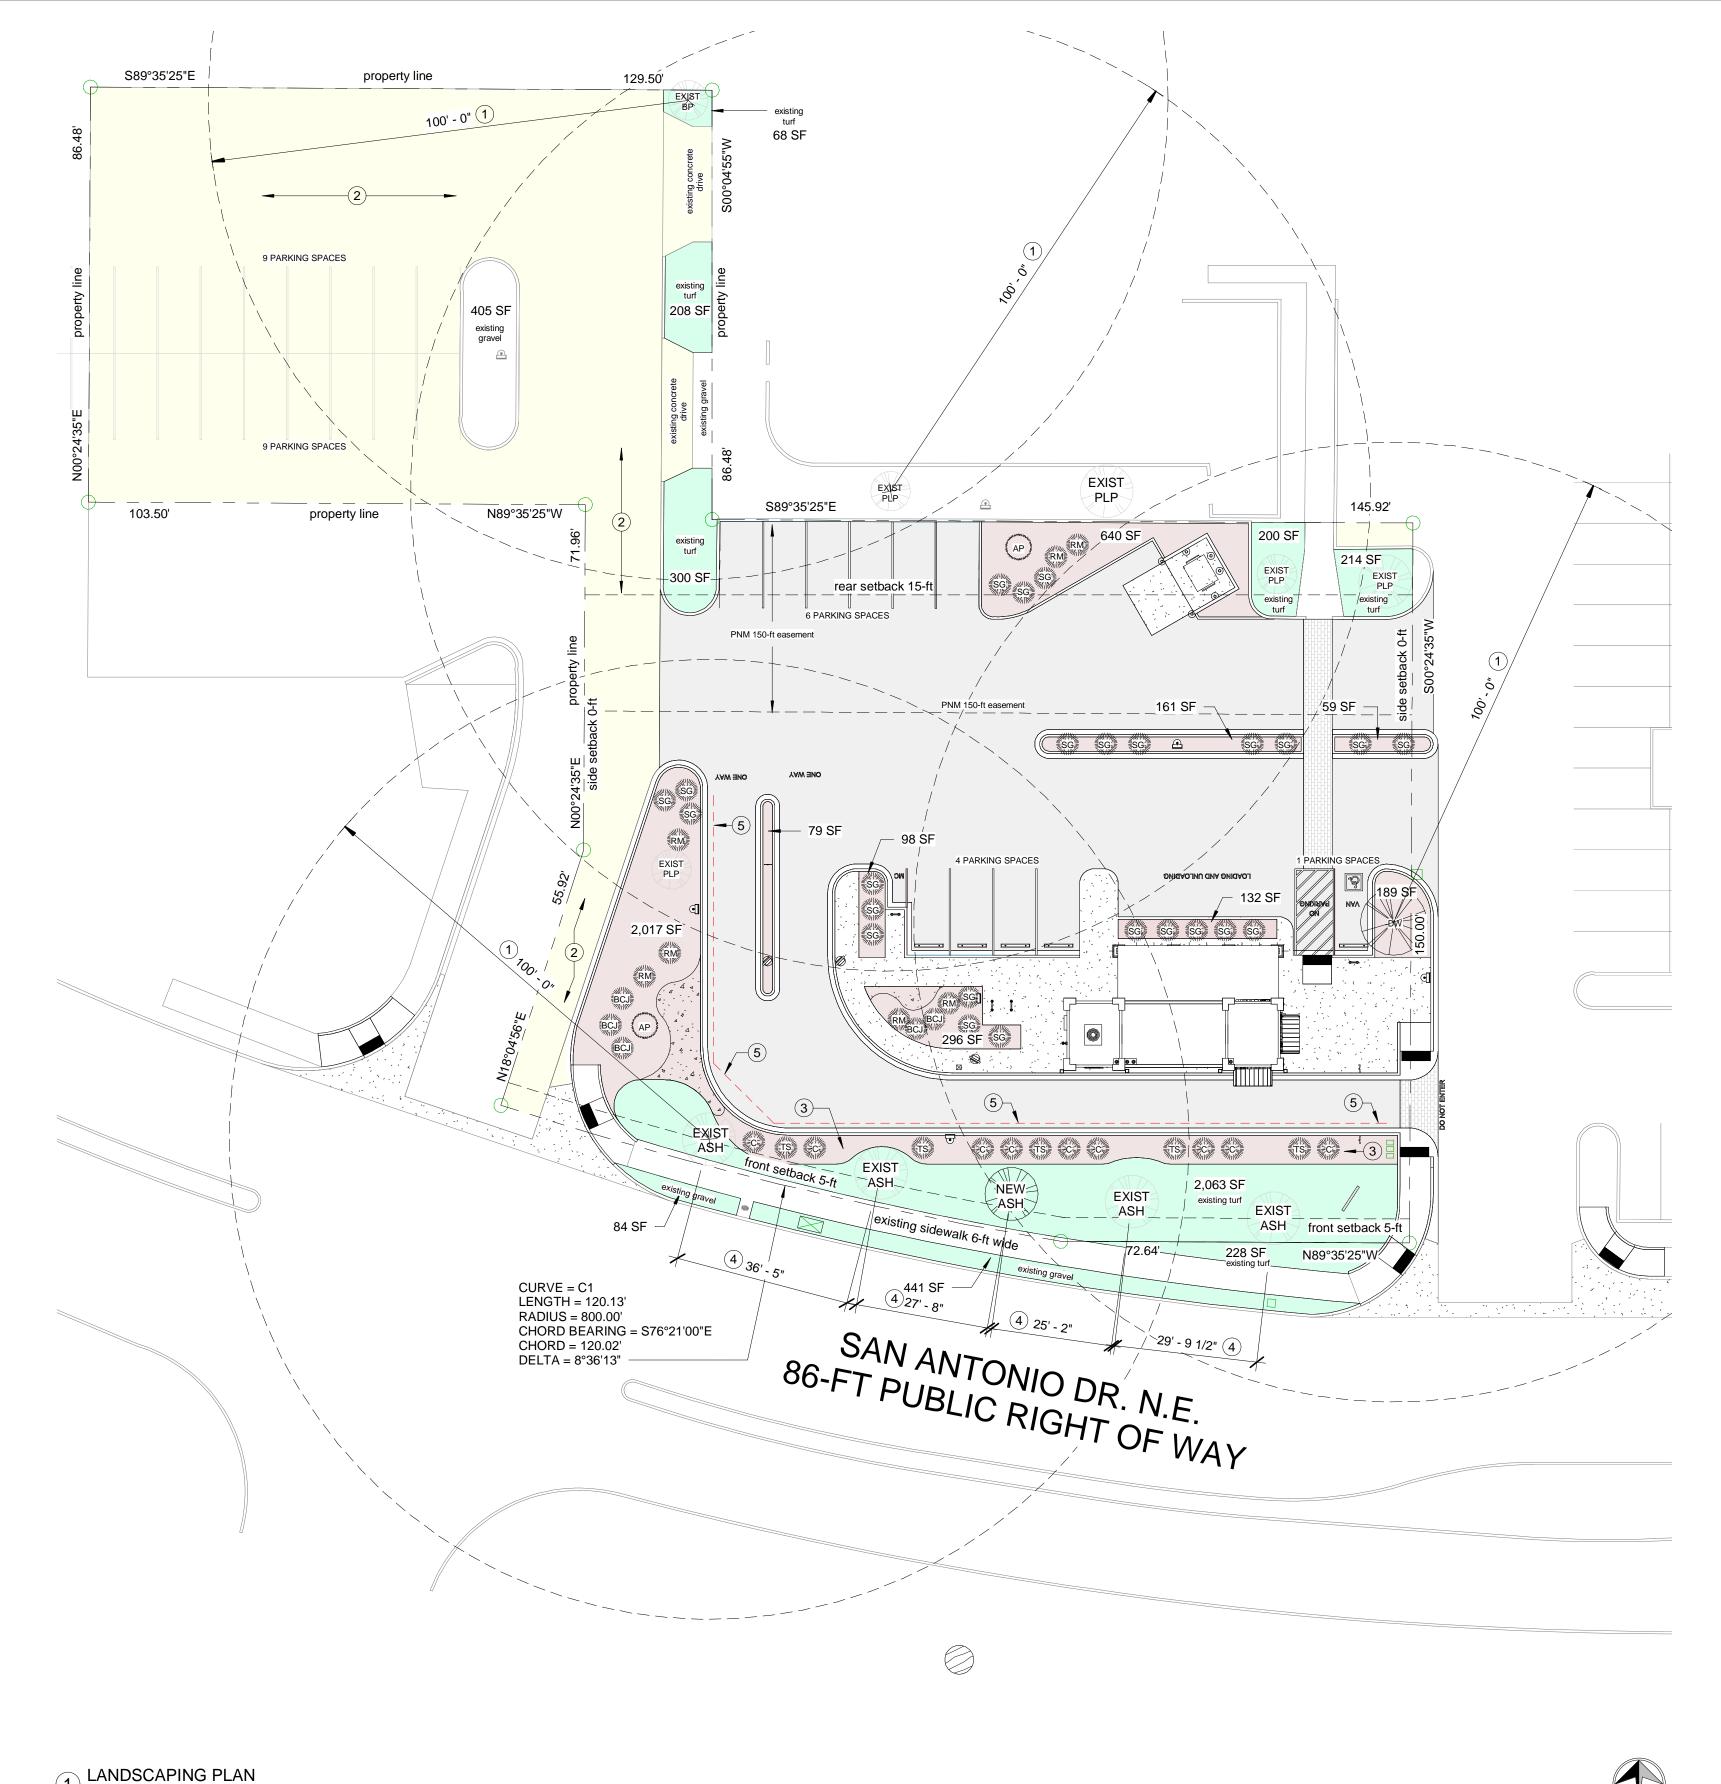

LANDSCAPE CALCULATIONS:

5-6 (C) (2) (c) Required vegetative coverage TREE CANOPY AND GROUND-LEVEL PLANTS COVERAGE: Total Landscaped Area = 7,339 SF Tree coverage = 4,514 SF Ground level plant coverage = 3,697 SF Total Vegetative Coverage = 8,211 SF 8,211 SF / 7,339 SF = 112% (> 75%)

GROUND-LEVEL PLANTS COVERAGE: 3,698 SF / 7,339 SF = 50% (> 25%)

5-6 (F) (2) Parking Lot Interior: Parking lot area including drive-through lanes = 24,379 SF Required landscape = 15% x 24,379 or 3,657 SF TOTAL LANDSCAPED AREA = 7,129 SF (29%)

WATERING NOTE:

1" = 20'-0"

DRIP SYSTEM RUN CYCLES:

ESTABLISHMENT AND SUMMER: 1 HOUR / 4 DAYS A WEEK

SPRING: 1 HOUR / 2-3 DAYS A WEEK

FALL: 1 HOUR / 2-3 DAYS A WEEK

WINTER: 1 HOUR / 2 DAYS PER MONTH

DI ANT I ECENID.

	NI LEGEND:		MATURE SIZE:	QUANTITY:	COVERAGE:
EXIST	EXISTING: PURPLELEAF PLUM		Approx. height = 20 ft. Approx. width = 20 ft. Coverage = 314 SF	3	942 SF
ASH	NEW OR EXISTING: ASH		Approx. height = 30 ft. Approx. width = 30 ft. Coverage = 707 SF	5	3,535 SF
(AP)	PINUS ELDARICA AFGHAN PINE	2" CALIPER, BALLED & BURLAPPED, 6-FT TALL	Approx. height = 40 ft. Approx. width = 18 ft. Coverage = 254 SF	1	254 SF
DW	CHILOPSIS LINEARIS DESERT WILLOW	2" CALIPER, BALLED & BURLAPPED, 6-FT TALL	Approx. height = 20 ft. Approx. width = 25 ft. Coverage = 490 SF	1	490 SF
			TOTAL TREE COVE	ERAGE:	5,221 SF
RM RM	ROSMARINUS OFFICINALIS ROSEMARY	5-GALLON	Approx. height = 6 ft. Approx. width = 6 ft. Coverage = 28 SF	7	196 SF
SG	PANICUM SWITCH GRASS	1-GALLON	Approx. height = 3-6 ft. Approx. spread = 2-3 ft. Coverage = 7 SF	24	168 SF
BCJ:	JUNIPERUS HORIZONTALIS BLUE CHIP JUNIPER (FEMALE ONLY)	5-GALLON	Approx. height = 2 ft. Approx. width = 5-8 ft. Coverage = 50 SF	5	250 SF
C	ERICAMERIA NAUSEOSA CHAMISA OR RABBITBRUSH	1-GALLON	Approx. height = 3-5 ft. Approx. width = 3-5 ft. Coverage = 20 SF	9	180 SF
TS.	LEUCOPHYLLUM FRUTESCENS TEXAS SAGE SHRUB	1-GALLON	Approx. height = 4-6 ft. Approx. width = 8 ft. Coverage = 50 SF	5	250 SF
	EXISTING TURF TO REMAIN		Coverage = Continuous		2,063 SF
		TOTAL GROUN	ID LEVEL PLANT COVE	ERAGE:	3,107 SF

STONE GRAVEL: 2" - 4" PUEBLO ROSE

STONE GRAVEL: 7/16" PUEBLO ROSE

EXISTING ASPHALT or CONCRETE DRIVEWAYS TO REMAIN

Site Plan Keyed Notes:

1. 100-ft. distance from nearest tree (parking space requirement). 2. Existing asphalt or concrete drives to remain. 3. 6-ft wide landscape buffer with vegetative screen for drive-through lanes adjacent to public right-of-way. Vegetative screen shall be maintained at 3-ft height, as per IDO 5-5 (I) (2). 4. Trees do not meet the 25-ft o.c. along San Antonio Drive. Based on the maturity, condition and coverage of the trees, adequate screening and buffering

close to the required 25-ft o.c. Provide tree protection for existing trees and vegetation during construction.

Fencing shall consist of 8-ft steel posts at 12 ft o.c. max. with 6 ft high "orange" reusable plastic mesh safety fencing. Locate fence one foot beyond the drip line of the vegetation. See detail 4 / L1.

is achieved. Added one tree to match existing species, bringing the spacing

36,647 SF

19.8%

2,853 SF

LANDSCAPE DATA:

GROSS LOT AREA (0.8413 acres) LESS BUILDING NET LOT AREA REQUIRED LANDSCAPE: 15% OF NET LOT AREA 5,401 SF EXISTING LANDSCAPE TO REMAIN 4,666 SF NEW LANDSCAPE 2,673 SF TOTAL LANDSCAPE AREA 7,129 SF PERCENT OF NET LOT AREA

HIGH WATER USE TURF: EXISTING

PROPOSED EXISTING: TOTAL 4 MATURE ASH TREES

TOTAL REQUIRED TREES = 7

PARKING LOT TREES

TOTAL PROPOSED TREES = 10 NOTE: EXISTING TREES WILL BE EVALUATED TO DETERMINE IF THEY NEED TO BE REMOVED AND / OR REPLACED. SEE

PROVIDE AT LEAST 1 PER 10 SPACES (29 SPACES / 10) = 2.9

GENERAL NOTE "G" BELOW. REQUIRED LANDSCAPE COVERAGE

75% LIVE VEGETATIVE MATERIAL 5,001 SF X 75% OR 5,001 X 0.75 = 3,751 SF MINIMUM **GENERAL NOTES:**

A. MAINTENANCE OF LANDSCAPE AND IRRIGATION IS THE

RESPONSIBILTY OF THE OWNER. B. PLANTINGS TO BE WATERED BY AUTOMATIC DRIP IRRIGATION SYSTEM AND PROTECTED WITH REDUCED PRESSURE BACKFLOW PREVENTER (WILKINS MODEL 975).

C. WATER MANAGEMENT IS THE RESPONSIBILITY OF THE PROPERTY OWNER. D. THIS PLAN SHALL PROVIDE 75% LIVE GROUNDCOVER OF

LANDSCAPE AREAS AT FULL MATURITY. E. LANDSCAPE AREAS TO MULCHED WITH 7/16" PUEBLO

ROSE FIELD AND 2" - 4" PUEBLO ROSE ACCENTS AS SHOWN ON PLAN TO A DEPTH OF 3" OVER FILTER FABRIC. F. DO NOT PLACE TREES IN PUBLIC UTILITY EASEMENTS.

G. IF EXISTING TREES MUST BE REMOVED, THEY SHALL BE REPLACED WITH SIMILAR SPECIES FROM THE OFFICIAL ALBUQUERQUE PLANT PALETTE THAT IS CAPABLE OF ACHIEVING A SIMILAR MATURE SIZE.

H. ALL EXISTING VEGETATION PRESERVED AND USED FOR CREDIT AGAINST THE REQUIREMENTS FOR NEW VEGETATION SHALL BE PROTECTED DURING CONSTRUCTION BY A FENCE ERECTED ONE FOOT BEYOND THE DRIP LINE OF THE VEGETATION.

0 10 20

SCALE: 1" = 20'


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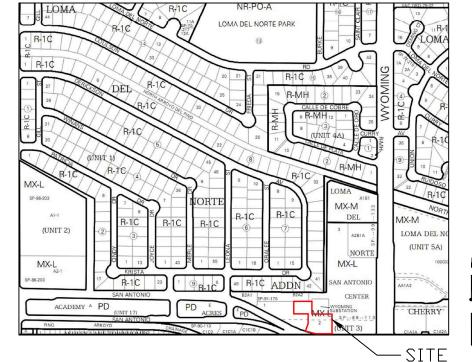
OWNER: KEITH GRIEGO

HUMAN BEAN - SAN **ANTONIO & WYOMING**

LANDSCAPING PLAN

Project Number	Project Number
Date	10-31-2023
Drawn By	J. SANCHEZ
Checked By	K. GRIEGO
L1	



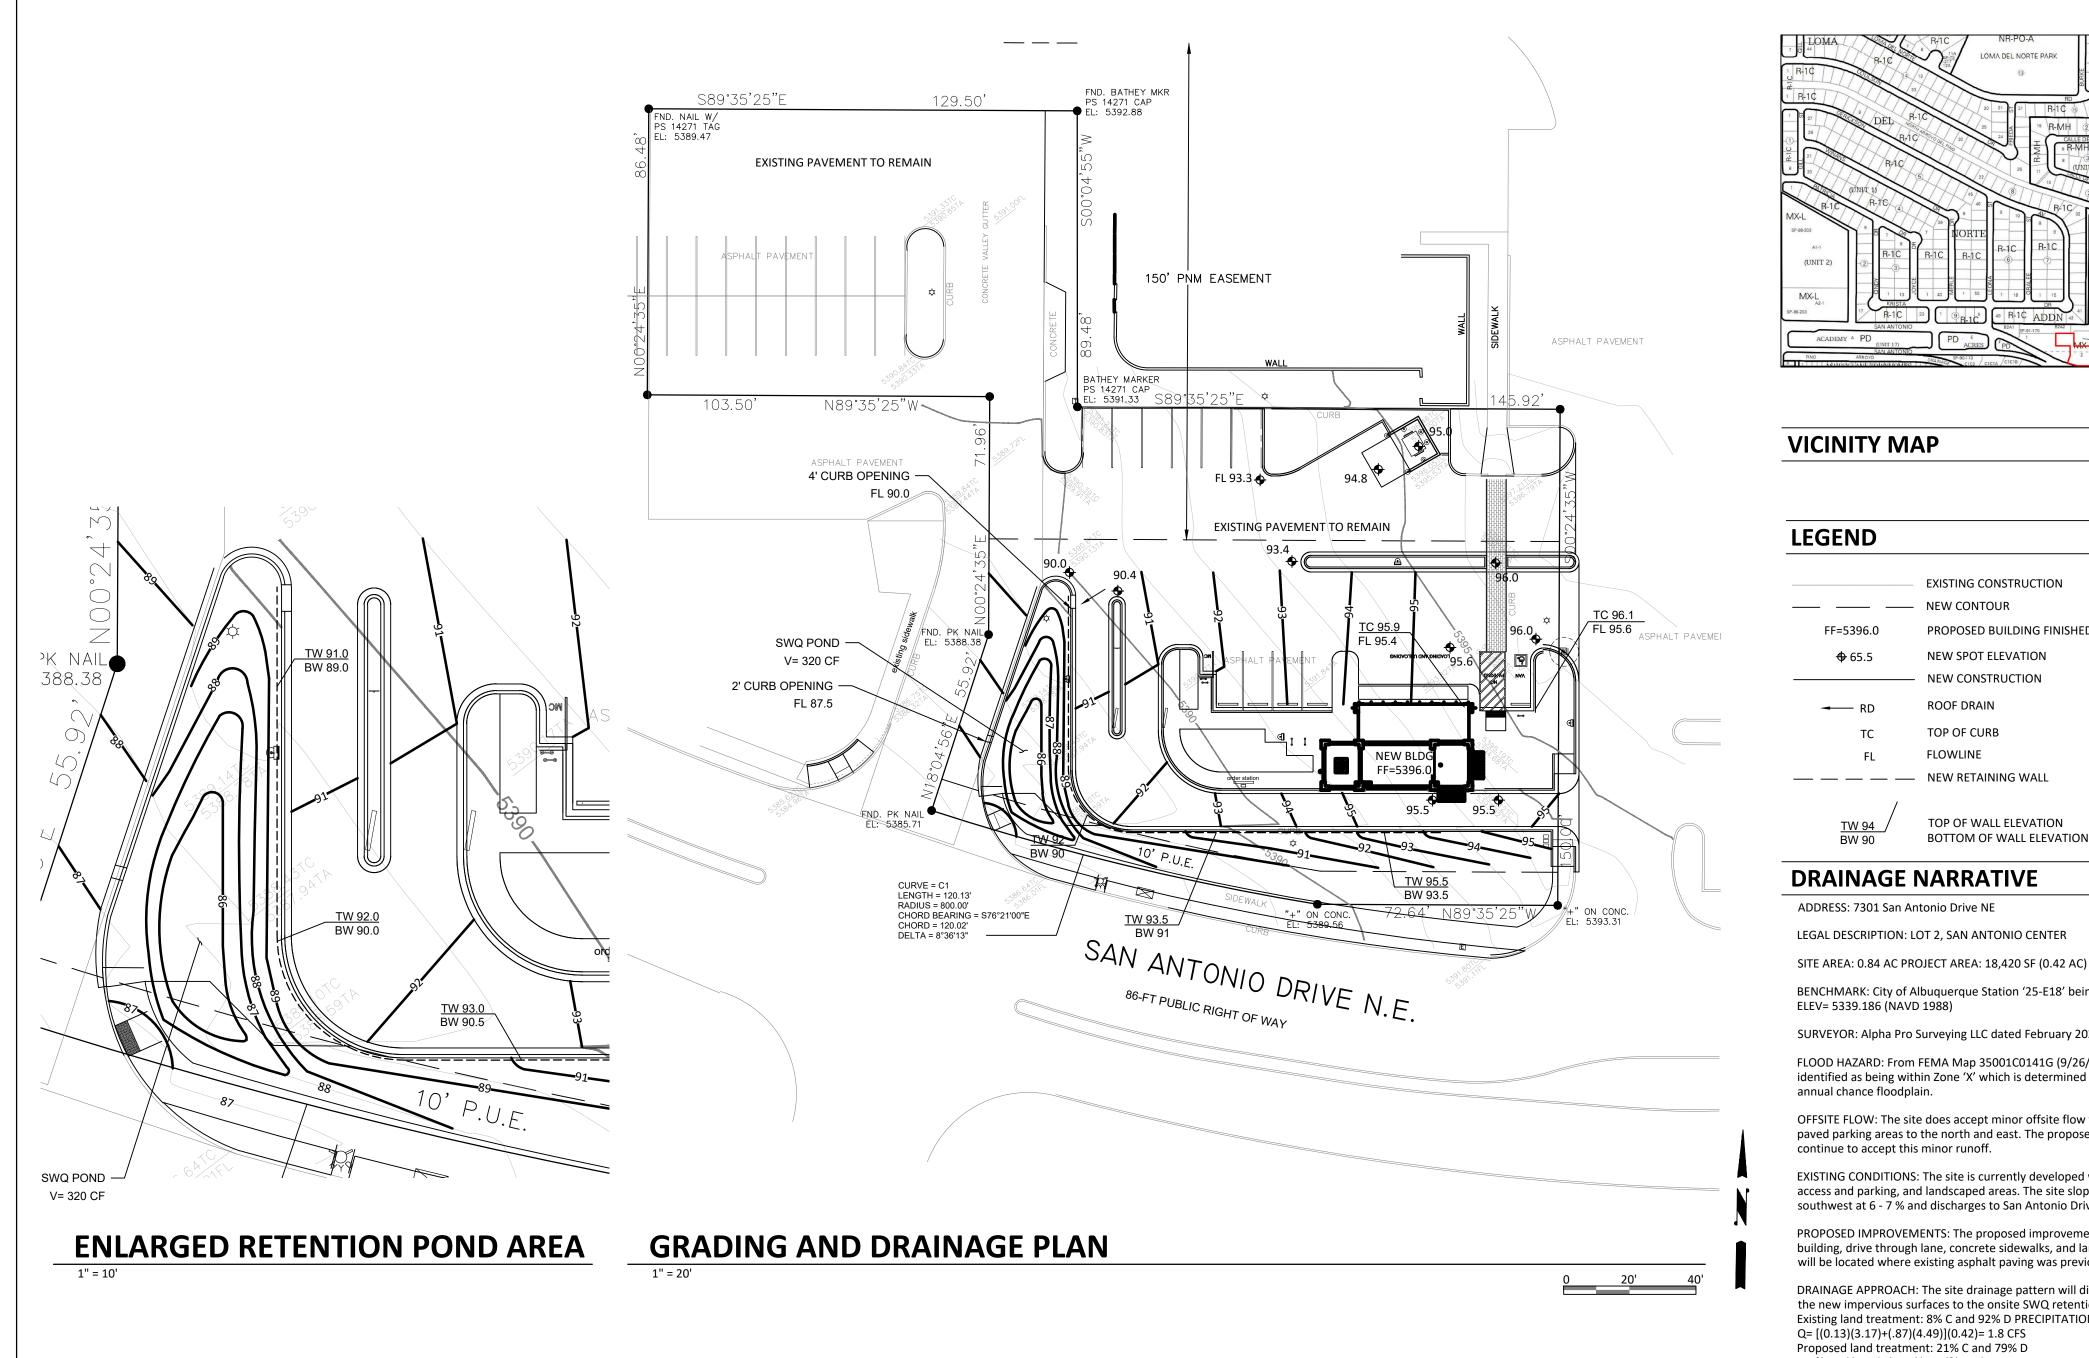

VICINITY MAP

D-19-Z

LEGEND

	EXISTING CONSTRUCTION
	NEW CONTOUR
FF=5396.0	PROPOSED BUILDING FINISHED FLOOR
• 65.5	NEW SPOT ELEVATION
	NEW CONSTRUCTION
→ RD	ROOF DRAIN
TC	TOP OF CURB
FL	FLOWLINE
	NEW RETAINING WALL
,	

TOP OF WALL ELEVATION BOTTOM OF WALL ELEVATION

DRAINAGE NARRATIVE

ADDRESS: 7301 San Antonio Drive NE

LEGAL DESCRIPTION: LOT 2, SAN ANTONIO CENTER

BENCHMARK: City of Albuquerque Station '25-E18' being a brass cap. ELEV= 5339.186 (NAVD 1988)

SURVEYOR: Alpha Pro Surveying LLC dated February 2023

FLOOD HAZARD: From FEMA Map 35001C0141G (9/26/2008), this site is identified as being within Zone 'X' which is determined to be outside the 0.2% annual chance floodplain.

OFFSITE FLOW: The site does accept minor offsite flow from existing adjacent paved parking areas to the north and east. The proposed development will continue to accept this minor runoff.

EXISTING CONDITIONS: The site is currently developed with existing paved access and parking, and landscaped areas. The site slopes down to the southwest at 6 - 7 % and discharges to San Antonio Drive NE.

PROPOSED IMPROVEMENTS: The proposed improvements include a 640 SF building, drive through lane, concrete sidewalks, and landscaping. This building will be located where existing asphalt paving was previously.

DRAINAGE APPROACH: The site drainage pattern will direct developed flow from the new impervious surfaces to the onsite SWQ retention pond. Existing land treatment: 8% C and 92% D PRECIPITATION ZONE: 3 Q= [(0.13)(3.17)+(.87)(4.49)](0.42)= 1.8 CFS Proposed land treatment: 21% C and 79% D Q= [(0.21)(3.17)+(0.79)(4.49)](0.42)= 1.8 CFS Redevelopment SWQ V= (14,100)(0.26/12)= 305 CF This flow will discharge to an onsite retention ponding area located at the SW corner of the site. The SWQ volume of 320 CF shall be retained in the onsite

bottom and the site discharge will remain unchanged.

No.	Description	Date

OWNER: KEITH GRIEGO

HUMAN BEAN - SAN ANTONIO & WYOMING


> **GRADING AND** DRAINAGE

ı		
	Project Number	Project Numbe
	Date	06-29-202
	Drawn By	Autho
	Checked By	Checke

GD0

1" = 20'-0"



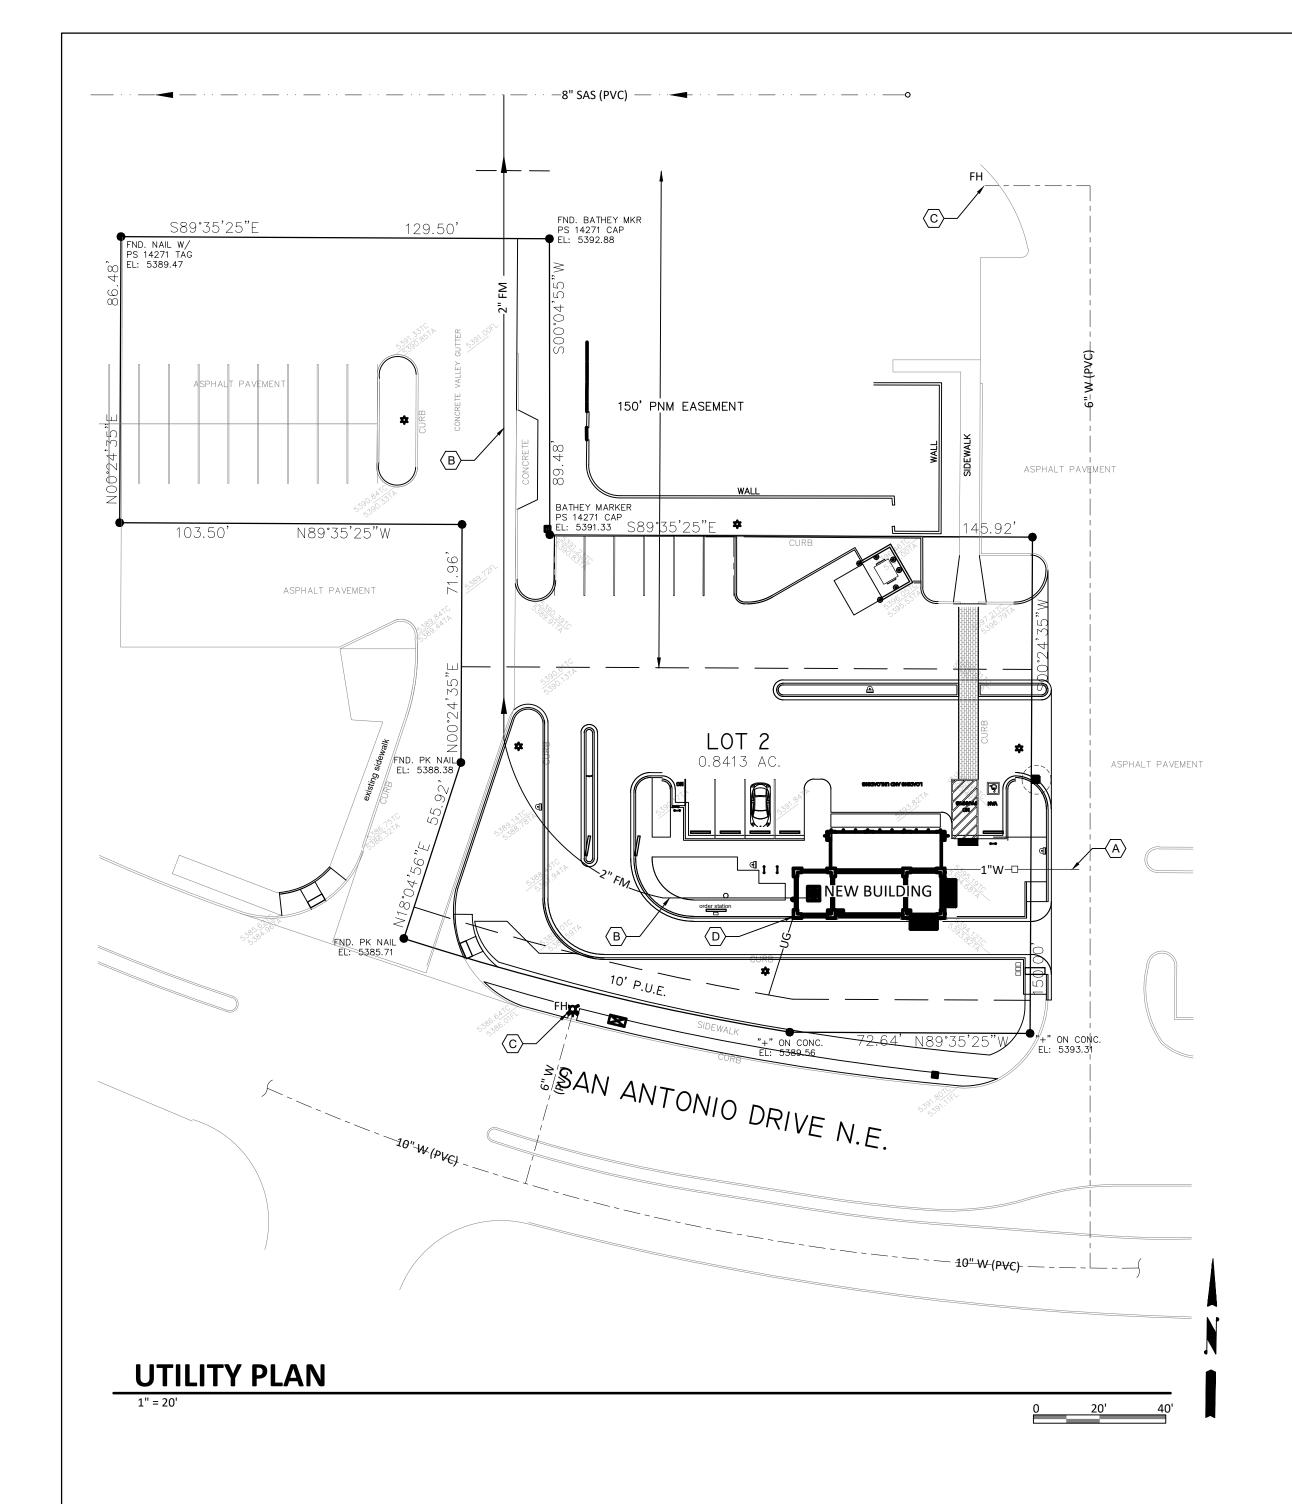

GENERAL NOTES

XXX

○ KEYED NOTES

- A. NEW 1" WATER SERVICE FROM EXISTING 6" MAIN TO BUILDING AS SHOWN.

 B. NEW DUPLEX PUMP STATION WITH TWO ZOELLER 807 GRINDER PUMPS
 IN A 30"x36" BASIN WITH 108 GALLON CAPACITY. INSTALL NEW 2" PVC
 FORCE MAIN (MIN. 24" COVER WITH CHECK VALVE 5' FROM PUMP
 STATION) FROM PUMP BASIN AND CONNECT WITH 4" TAP TO EXISTING
- 8" PUBLIC SEWER MAIN AS SHOWN.
 C. EXISTING PUBLIC FIRE HYDRANT TO REMAIN.

LEGEND

— - — -W - — — EXISTING WATER LINE
— SAS — EXISTING SEWER LINE
— SAS — NEW SEWER LINE
— 2" FM — FORCE MAIN
— W — NEW WATER LINE
— UG — UNDERGROUND GAS
— FH FIRE HYDRANT
— CLEAN OUT

No.	Description	Date

OWNER: KEITH GRIEGO
HUMAN BEAN COFFEE SHOP
7301 SAN ANTONIO DR NE

UTILITY PLAN


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Checked By	Chec
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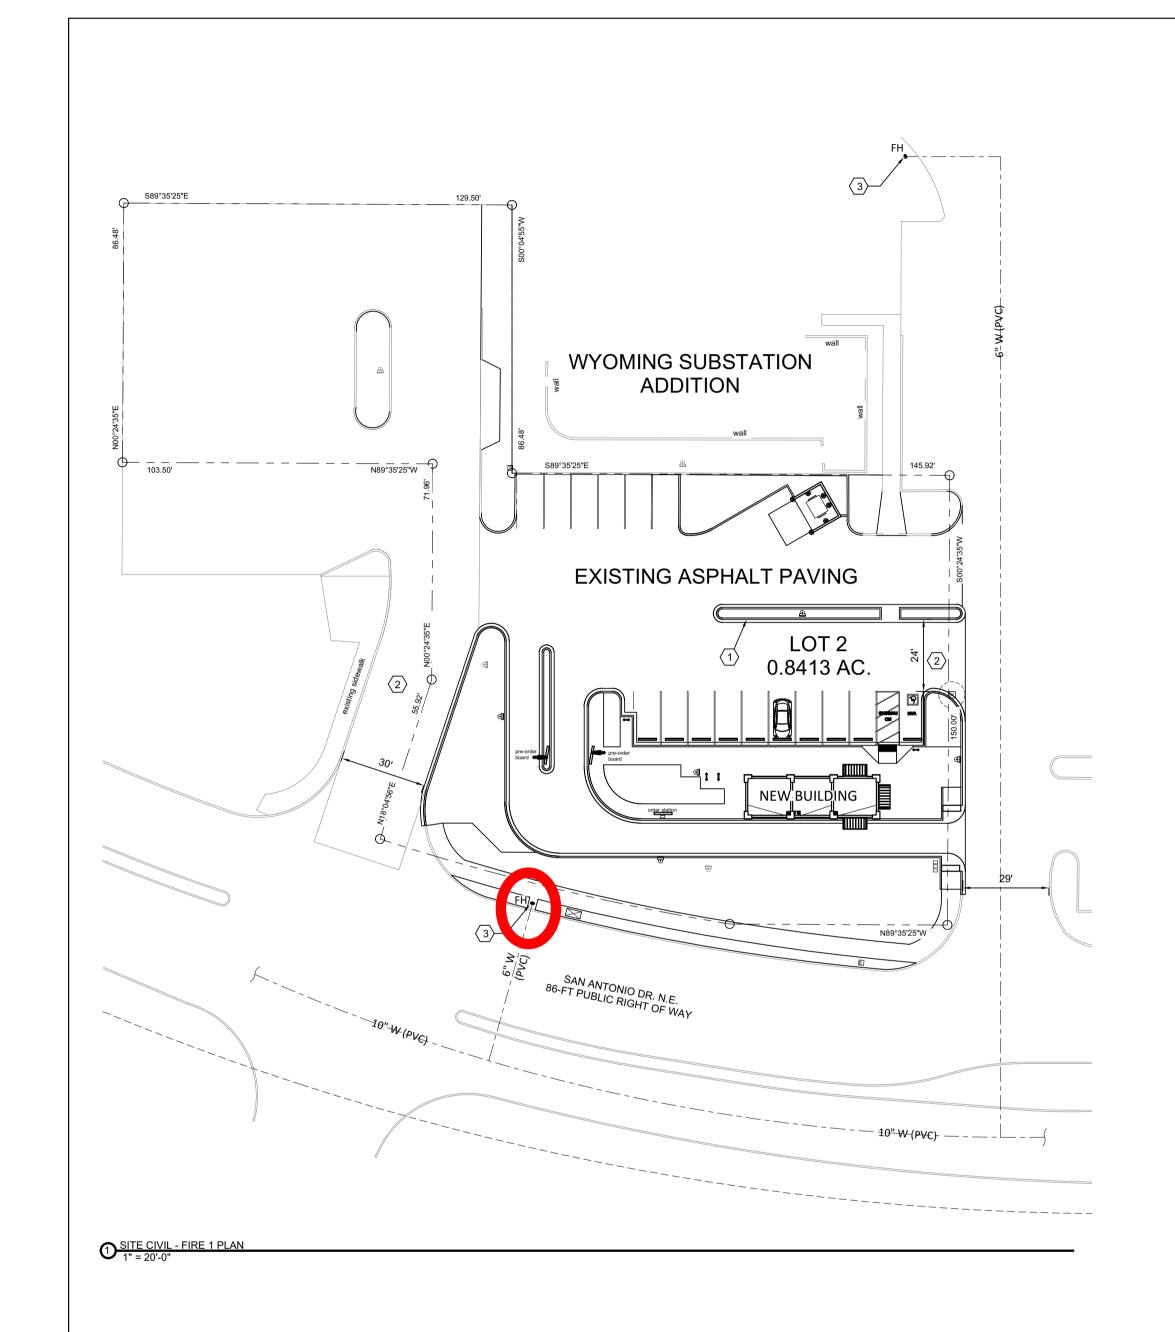
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1" = 20'-0"



or er 0"





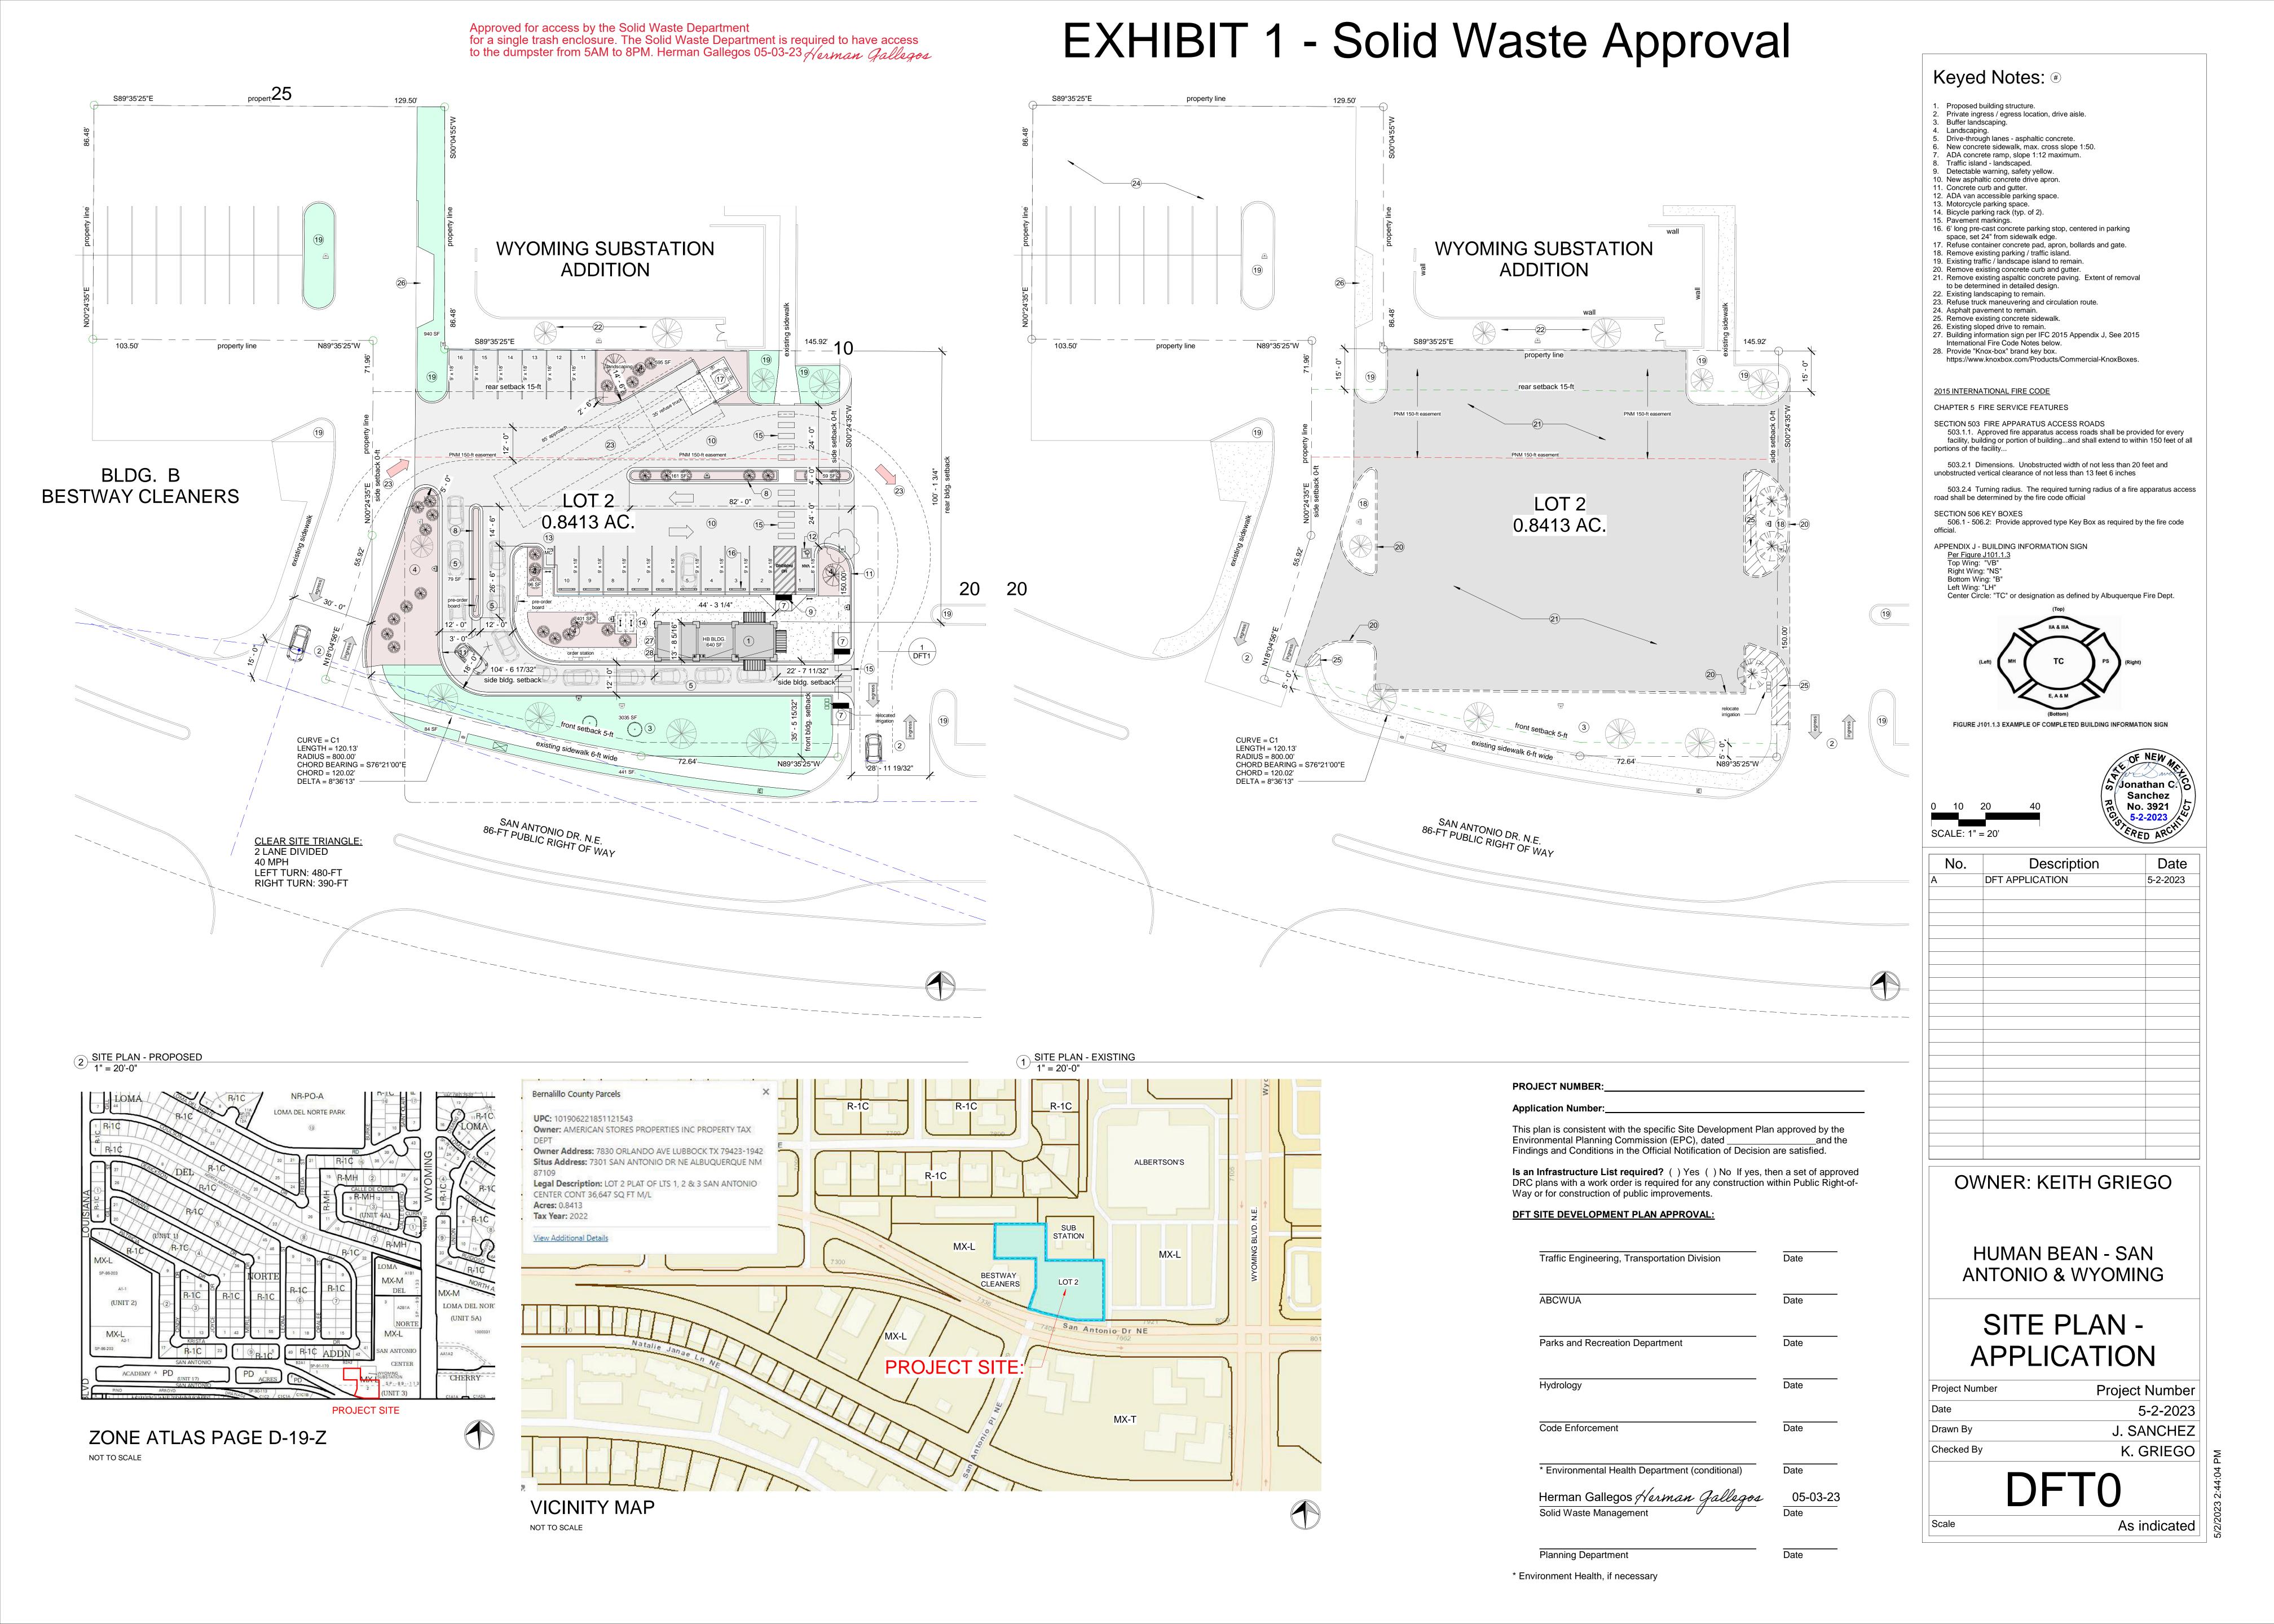

RIC NR-PO-A LOMA DEL NORTE PARK

RIC DEL NORTE

VICINITY MAP

D-19-Z

GENERAL NOTES

THE PROPOSED BUILDING IS 630 SF TYPE V-B CONSTRUCTION. THE REQUIRED FIRE FLOW IS FF=1,500 GPM WITH NO BUILDING SPRINKLER SYSTEM

○ KEYED NOTES

- ALL DRIVE AISLE CURBS TO BE PAINTED RED AND MARKED 'NO PARKING FIRE LANE'.
- ACCESS ROAD: 24'-WIDE DRIVE AISLE SHALL BE 4" ASPHALT PAVEMENT OVER 6" COMPACTED BASE COURSE ENGINEERED TO SUPPORT THE LOAD OF FIRE APPARATUS WEIGHING 75,000 POUNDS. DRIVE SHALL NOT EXCEED 10% GRADE.
- 3. EXISTING FIRE HYDRANT

LEGEND

— – — –W– – — EXISTING WATER LINE

FIRE HYDRANT

Description	Date
	Description


OWNER: KEITH GRIEGO


HUMAN BEAN COFFEE SHOP 7301 SAN ANTONIO DR NE

FIRE 1 PLAN

Project Number	Project Numb
Date	3-14-20
Drawn By	Auth
Checked By	Check

Author Checker 1" = 20'-0"

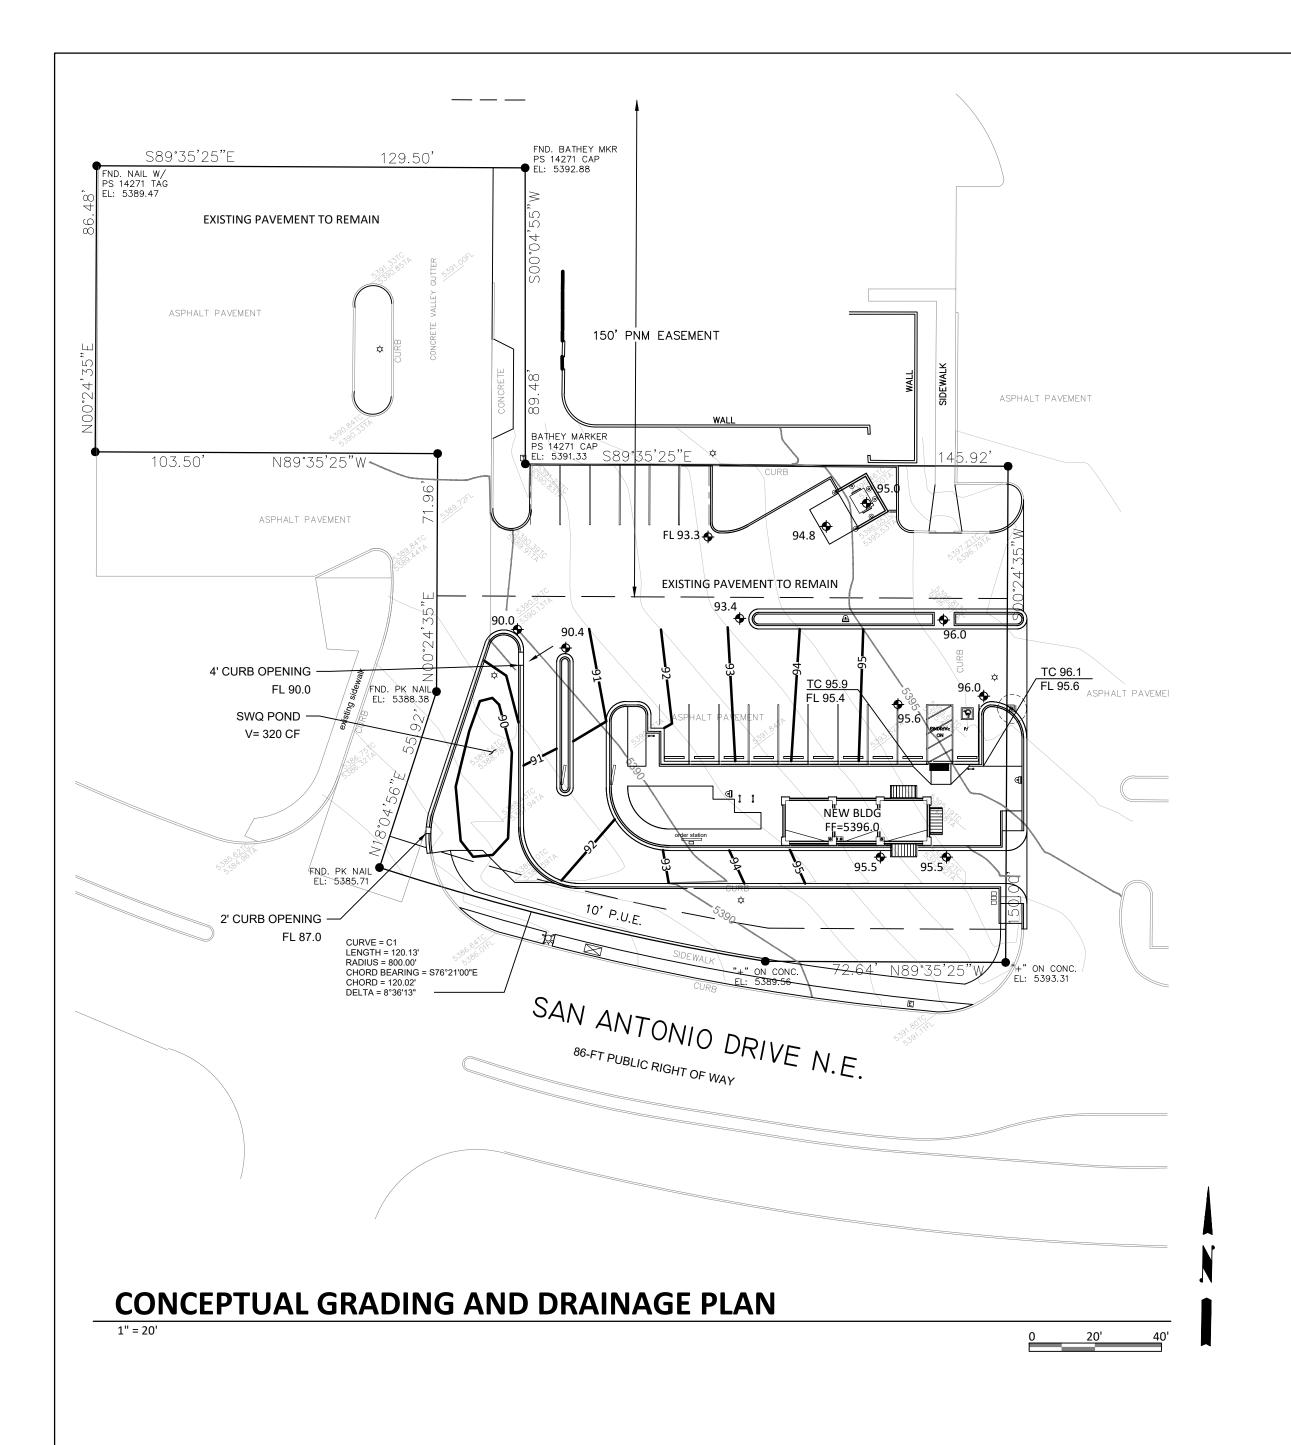

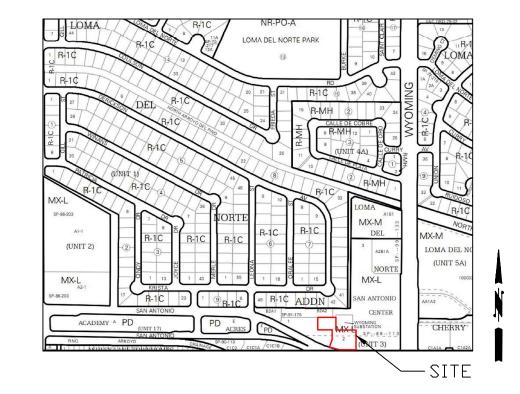

VICINITY MAP

D-19-Z

LEGEND

	EXISTING CONSTRUCTION
	NEW CONTOUR
FF=5396.0	PROPOSED BUILDING FINISHED FLOOR
• 65.5	NEW SPOT ELEVATION
	NEW CONSTRUCTION
→ RD	ROOF DRAIN
TC	TOP OF CURB
El	FLOWLINE

DRAINAGE NARRATIVE

ADDRESS: 7301 San Antonio Drive NE

LEGAL DESCRIPTION: LOT 2, SAN ANTONIO CENTER

SITE AREA: 0.84 AC PROJECT AREA: 18,420 SF (0.42 AC)

BENCHMARK: City of Albuquerque Station '25-E18' being a brass cap. ELEV= 5339.186 (NAVD 1988)

SURVEYOR: Alpha Pro Surveying LLC dated February 2023

FLOOD HAZARD: From FEMA Map 35001C0141G (9/26/2008), this site is identified as being within Zone 'X' which is determined to be outside the 0.2% annual chance floodplain.

OFFSITE FLOW: The site does accept minor offsite flow from existing adjacent paved parking areas to the north and east. The proposed development will continue to accept this minor runoff.

EXISTING CONDITIONS: The site is currently developed with existing paved access and parking, and landscaped areas. The site slopes down to the southwest at 6 - 7 % and discharges to San Antonio Drive NE.

PROPOSED IMPROVEMENTS: The proposed improvements include a 640 SF building, drive through lane, concrete sidewalks, and landscaping. This building will be located where existing asphalt paving was previously.

DRAINAGE APPROACH: The site drainage pattern will direct developed flow from the new impervious surfaces to the onsite SWQ retention pond. Existing land treatment: 8% C and 92% D PRECIPITATION ZONE: 3 Q= [(0.13)(3.17)+(.87)(4.49)](0.42)=1.8 CFS Proposed land treatment: 21% C and 79% D Q= [(0.21)(3.17)+(0.79)(4.49)](0.42)=1.8 CFS

Redevelopment SWQ V= (14,100)(0.26/12)= 305 CF
This flow will discharge to an onsite retention ponding area located at the SW corner of the site. The SWQ volume of 320 CF shall be retained in the onsite bottom and the site discharge will remain unchanged.



OWNER: KEITH GRIEGO

HUMAN BEAN - SAN ANTONIO & WYOMING


CONCEPTUAL
GRADING AND
DRAINAGE

		DRAINAGE		
	Project Number	Project Numbe		
	Date	3-14-202		
ŀ	Drawn By	Auth		
	Checked By	Checke		

GD0



Author Checker 1" = 20'-0"

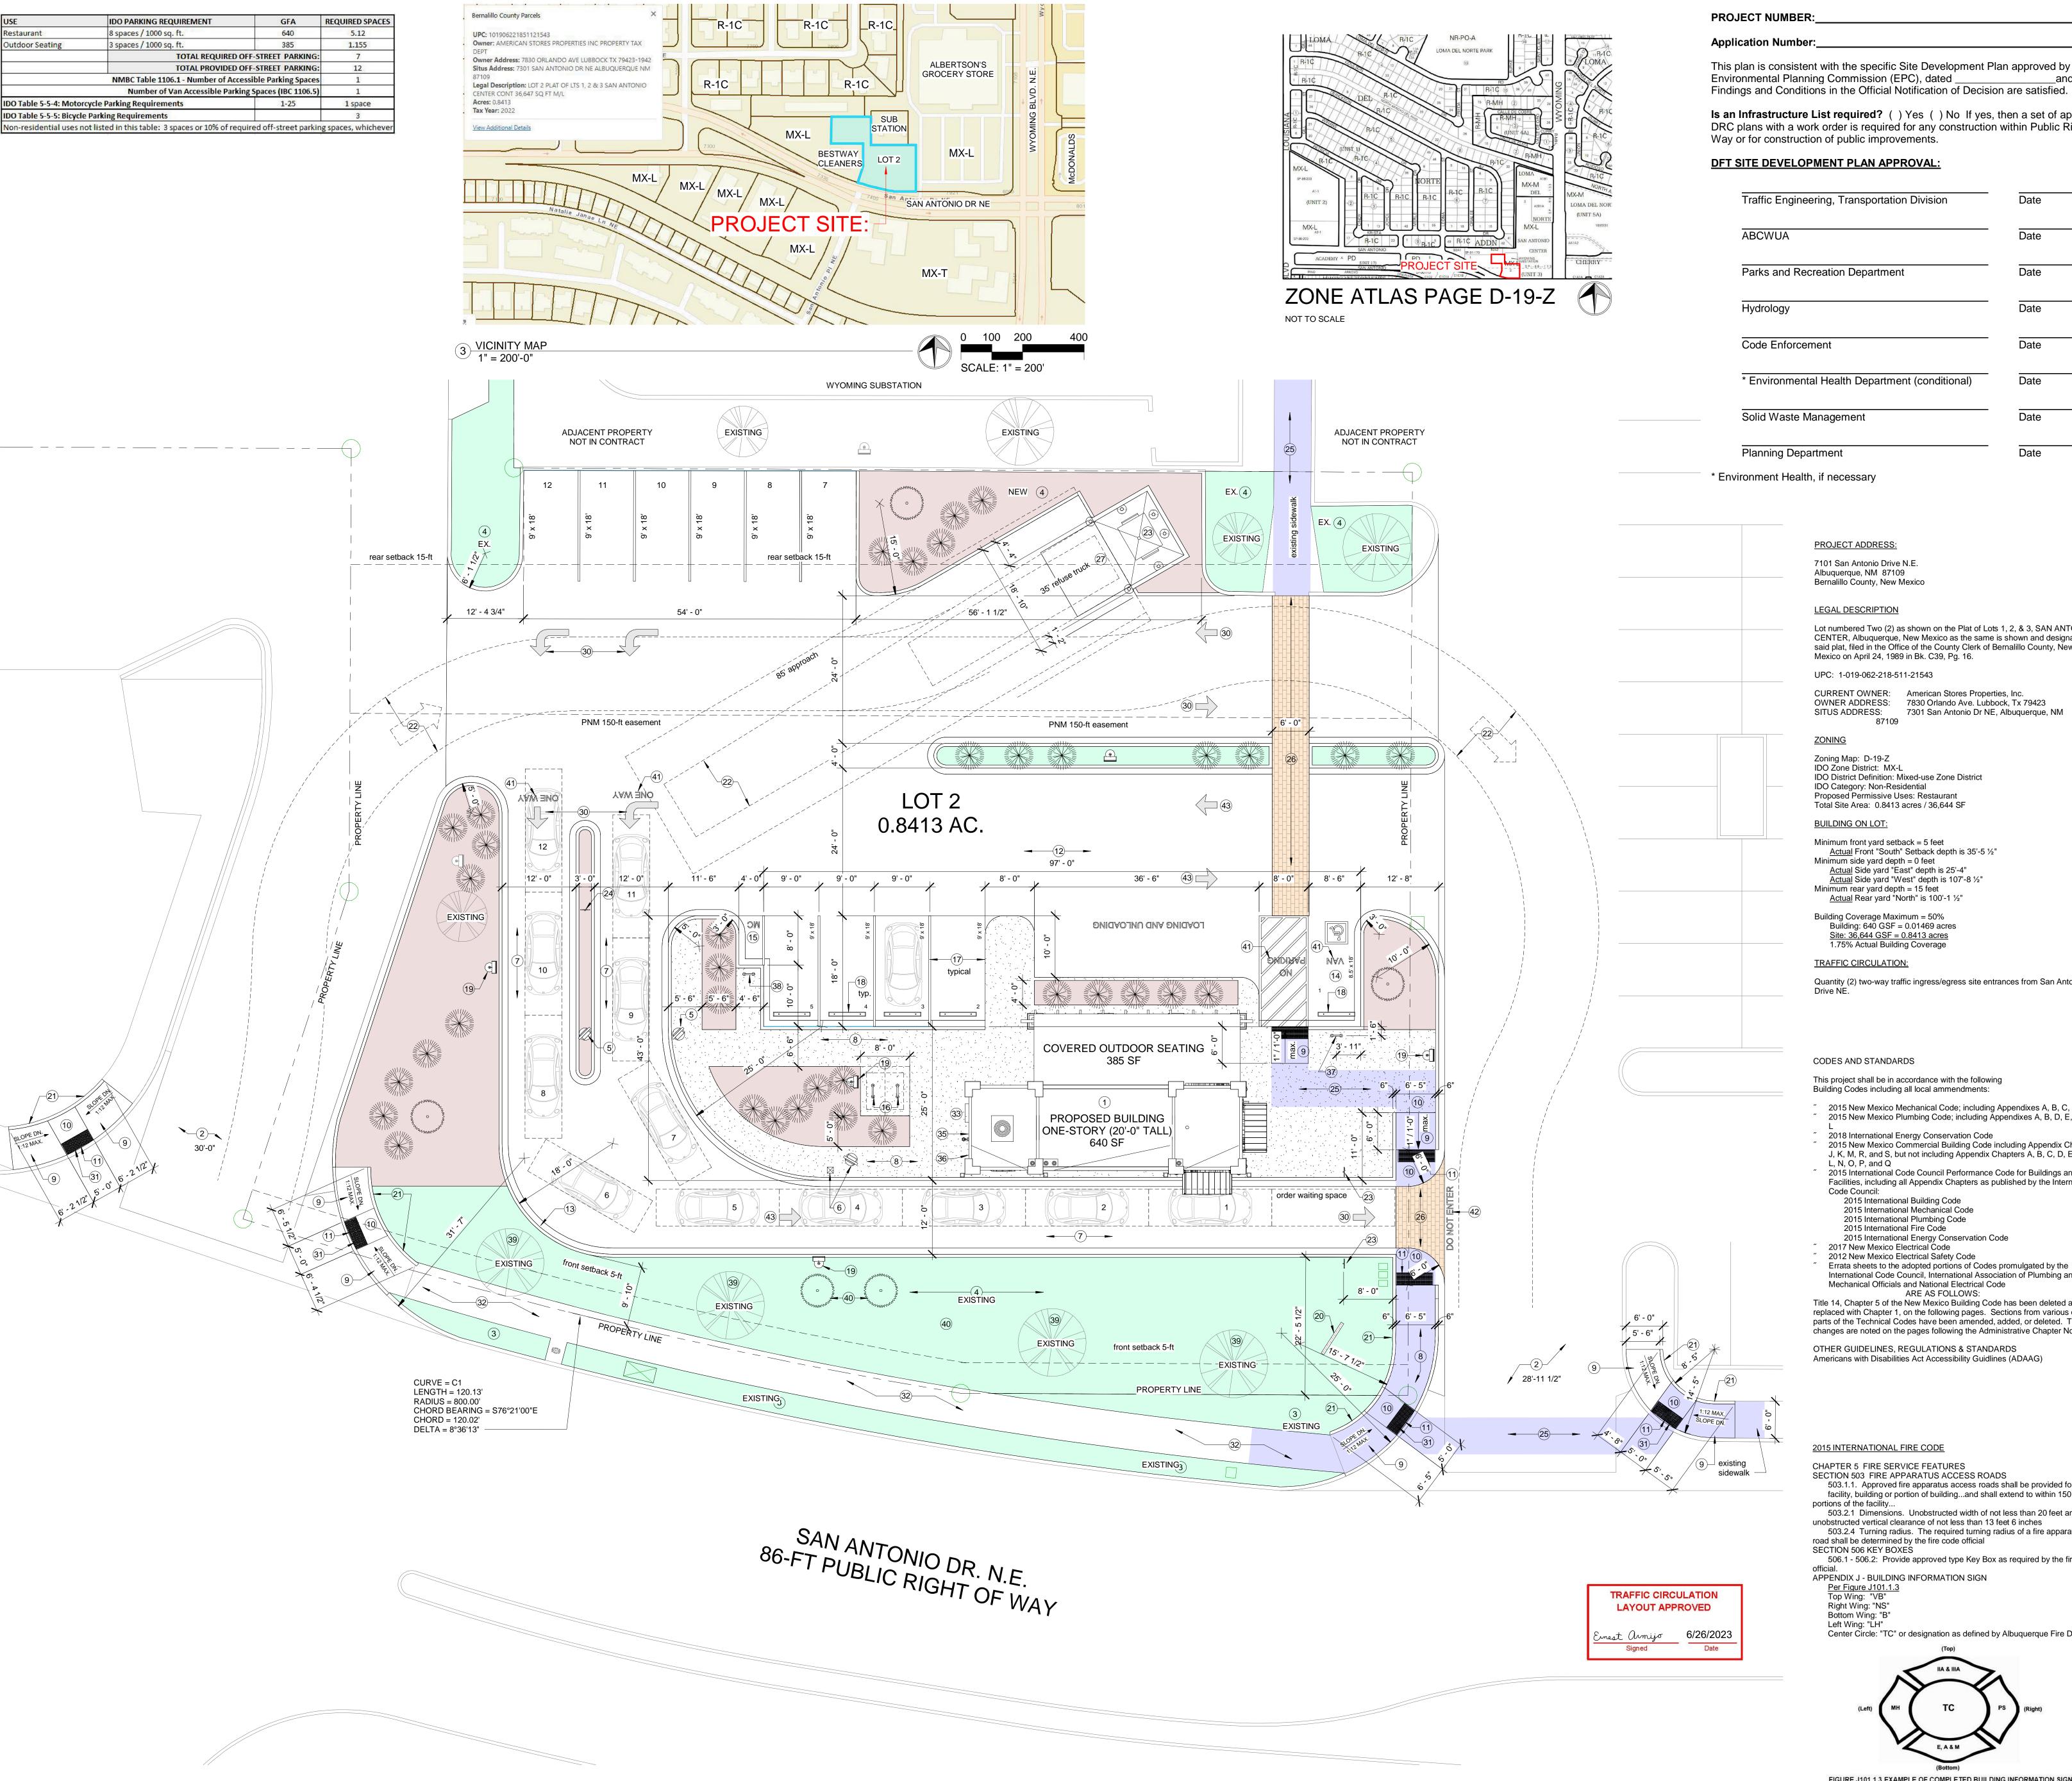

This plan is consistent with the specific Site Development Plan approved by the Environmental Planning Commission (EPC), dated

Is an Infrastructure List required? () Yes () No If yes, then a set of approved DRC plans with a work order is required for any construction within Public Right-of-Way or for construction of public improvements.

DFT SITE DEVELOPMENT PLAN APPROVAL:

Traffic Engineering, Transportation Division	Date
ABCWUA	Date
Parks and Recreation Department	Date
Hydrology	Date
Code Enforcement	Date
* Environmental Health Department (conditional)	Date
Solid Waste Management	Date
Planning Department	Date

* Environment Health, if necessary

PROJECT ADDRESS:

7101 San Antonio Drive N.E. Albuquerque, NM 87109 Bernalillo County, New Mexico

LEGAL DESCRIPTION

Lot numbered Two (2) as shown on the Plat of Lots 1, 2, & 3, SAN ANTONIO CENTER, Albuquerque, New Mexico as the same is shown and designated on said plat, filed in the Office of the County Clerk of Bernalillo County, New Mexico on April 24, 1989 in Bk. C39, Pg. 16.

UPC: 1-019-062-218-511-21543

CURRENT OWNER: American Stores Properties, Inc. OWNER ADDRESS: 7830 Orlando Ave. Lubbock, Tx 79423 SITUS ADDRESS: 7301 San Antonio Dr NE, Albuquerque, NM

ZONING

Zoning Map: D-19-Z IDO Zone District: MX-L

IDO District Definition: Mixed-use Zone District IDO Category: Non-Residential Proposed Permissive Uses: Restaurant Total Site Area: 0.8413 acres / 36,644 SF

BUILDING ON LOT:

Minimum front yard setback = 5 feet Actual Front "South" Setback depth is 35'-5 ½"

Minimum side yard depth = 0 feet

Actual Side yard "East" depth is 25'-4"

Actual Side yard "West" depth is 107'-8 ½"

Minimum rear yard depth = 15 feet Actual Rear yard "North" is 100'-1 1/2"

Building Coverage Maximum = 50%
Building: 640 GSF = 0.01469 acres
Site: 36,644 GSF = 0.8413 acres
1.75% Actual Building Coverage

TRAFFIC CIRCULATION:

Quantity (2) two-way traffic ingress/egress site entrances from San Antonio Drive NE.

CODES AND STANDARDS

This project shall be in accordance with the following Building Codes including all local ammendments:

- 2015 New Mexico Mechanical Code; including Appendixes A, B, C, and D 2015 New Mexico Plumbing Code; including Appendixes A, B, D, E, F, I, and
- 2018 International Energy Conservation Code 2015 New Mexico Commercial Building Code including Appendix Chapters H, J, K, M, R, and S, but not including Appendix Chapters A, B, C, D, E, F, G, I,
- L, N, O, P, and Q 2015 International Code Council Performance Code for Buildings and Facilities, including all Appendix Chapters as published by the International
 - 2015 International Building Code
 - 2015 International Mechanical Code 2015 International Plumbing Code
 - 2015 International Fire Code
- 2015 International Energy Conservation Code 2017 New Mexico Electrical Code 2012 New Mexico Electrical Safety Code

International Code Council, International Association of Plumbing and Mechanical Officials and National Electrical Code
ARE AS FOLLOWS:

Errata sheets to the adopted portions of Codes promulgated by the

Title 14, Chapter 5 of the New Mexico Building Code has been deleted and replaced with Chapter 1, on the following pages. Sections from various other parts of the Technical Codes have been amended, added, or deleted. These changes are noted on the pages following the Administrative Chapter No. 1.

OTHER GUIDELINES, REGULATIONS & STANDARDS Americans with Disabilities Act Accessibility Guidlines (ADAAG)

2015 INTERNATIONAL FIRE CODE

CHAPTER 5 FIRE SERVICE FEATURES SECTION 503 FIRE APPARATUS ACCESS ROADS

503.1.1. Approved fire apparatus access roads shall be provided for every facility, building or portion of building...and shall extend to within 150 feet of all portions of the facility... 503.2.1 Dimensions. Unobstructed width of not less than 20 feet and unobstructed vertical clearance of not less than 13 feet 6 inches

503.2.4 Turning radius. The required turning radius of a fire apparatus access road shall be determined by the fire code official SECTION 506 KEY BOXES 506.1 - 506.2: Provide approved type Key Box as required by the fire code

APPENDIX J - BUILDING INFORMATION SIGN

Per Figure J101.1.3
Top Wing: "VB"
Right Wing: "NS"
Bottom Wing: "B"

Left Wing: "LH" Center Circle: "TC" or designation as defined by Albuquerque Fire Dept.

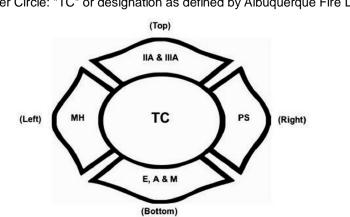


FIGURE J101.1.3 EXAMPLE OF COMPLETED BUILDING INFORMATION SIGN

Keyed Notes:

- 1. Proposed building structure. 2. Private ingress / egress location, width of drive aisle as indicated. 3. Buffer landscaping.
- Landscaping. 5. Menu display board, see detail 9 / TCL1.
- 6. Menu display board with speaker / microphone ordering station. 7. Drive-through lanes - asphaltic concrete.
- 8. New concrete sidewalk, max. cross slope 1:50. 9. ADA concrete ramp, slope 1:12 maximum, heavy broom finish. 10. Concrete landing, 1:50 max. cross slope.
- 11. Detectable warning with truncated domes (2-ft x width of ramp), safety yellow. 12. New asphaltic concrete drive apron.
- 13. Concrete curb and gutter, see detail 2 / TCL1. 14. ADA van accessible parking space with universal accessibility symbol.
- 15. Motorcycle parking space. 16. Bicycle parking rack (typ. of 2), see detail 14 / TCL1.
- 17. Pavement markings "white". 18. 6' long pre-cast concrete parking stop, centered in parking space, set 24" from
- sidewalk edge. 19. Pole light, 20' tall. Final location(s) determined by lighting consultant or electrical
- engineer, see detail 15 / TCL1. 20. Monument sign (4'-4" high x 6'-0" wide), integral color "brown" CMU with text "the HUMAN BEAN" and logo, see detail 6a / TCL1.
- 21. Header curb, integral with ramp and / or landing, see CABQ dwg. 2415C.
- 22. Refuse truck maneuvering and circulation route (40-ft inside, 52-ft outside
- 23. Traffic sign, "ONE WAY DO NOT ENTER", see detail 8 TCL1.
- 24. Traffic sign, "DRIVE THRU ENTRY", see detail 8 TCL1.25. ADA pedestrian access to site (6-ft wide) shaded "blue". 26. Integral color textured concrete - brick paver pattern, color "Terra Cota".

27. Refuse container concrete pad with drain, apron, bollards and gate. See

- enlarged plan and details on TCL1. 28. Pipe bollard, painted traffic yellow (6"Ø x 7'-0" high).
- 29. Pipe bollard, painted traffic yellow (6"Ø x 4'-6" high). 30. Pavement markings, see detail 7 / TCL1. 31. New corner access ramp per CABQ dwg. 2441.
- 32. Existing concrete sidewalk. Replace any and all broken or cracked sidewalks, see General Note B.
- 33. Electrical metering equipment.
- 34. Flared sides, 1:10 maximum slope. 35. Building information sign per IFC 2015 Appendix J, See G0 2015 International
- Fire Code notes.
- 36. Provide "Knox-box" brand key box. https://www.knoxbox.com/Products/Commercial-KnoxBoxes.
- 37. Van accessible parking sign, see detail 12 / TCL1. 38. Motorcycle parking sign, see detail 12 / TCL1.
- 39. Existing "mature" tree, see Landscaping Plan.
- 40. New "screening" tree, see Landscaping Plan.
- 41. Pavement marking, 12" high lettering, text as shown, "white" fast dry waterborne traffic marking paint. 42. Pavement marking, 12" high lettering, text as shown, "red" fast dry waterborne


General Notes:

traffic marking paint.

- A. ALL ADA RAMPS SHALL HAVE A RUNNING SLOPE NOT TO EXCEED 1:12. ALL RAMPS, SIDEWALKS AND LANDINGS SHALL HAVE A CROSS SLOPE
- NOT TO EXCEED 1:50. B. ALL BROKEN OR CRACKED SIDEWALKS MUST BE REPLACED WITH
- SIDEWALK AND CURB & GUTTER. CONFORM TO CABQ SIDEWALK DRG. 2720 AND CURB AND GUTTER DWG. 2415A. C. LANDSCAPING AND SIGNAGE WILL NOT INTERFERE WITH CLEAR SIGHT REQUIREMENTS, THEREFORE, SIGNS, WALLS, TREES, AND SHRUBBERY BETWEEN 3 AND 8 FEET TALL (AS MEASURED FROM THE

GUTTER PAN) WILL NOT BE ACCEPTABLE IN THE CLEAR SIGHT



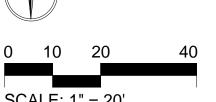



No.	Description	Date
A	DFT APPLICATION	5-2-2023
В	DFT COMMENTS	6-5-2023
С	TCL SUBMISSION	6-7-2023
D	BUILDING PERMIT	6-9-2023
E	TCL RESUBMISSION	6-25-2023

OWNER: KEITH GRIEGO

HUMAN BEAN - SAN **ANTONIO & WYOMING**


SITE PLAN -ARCHITECTURAL

Project Number Project Number 6-26-2023 J. SANCHEZ Drawn By K. GRIEGO Checked By

Scale

As indicated

1 SITE PLAN - ENLARGED
1" = 10'-0"

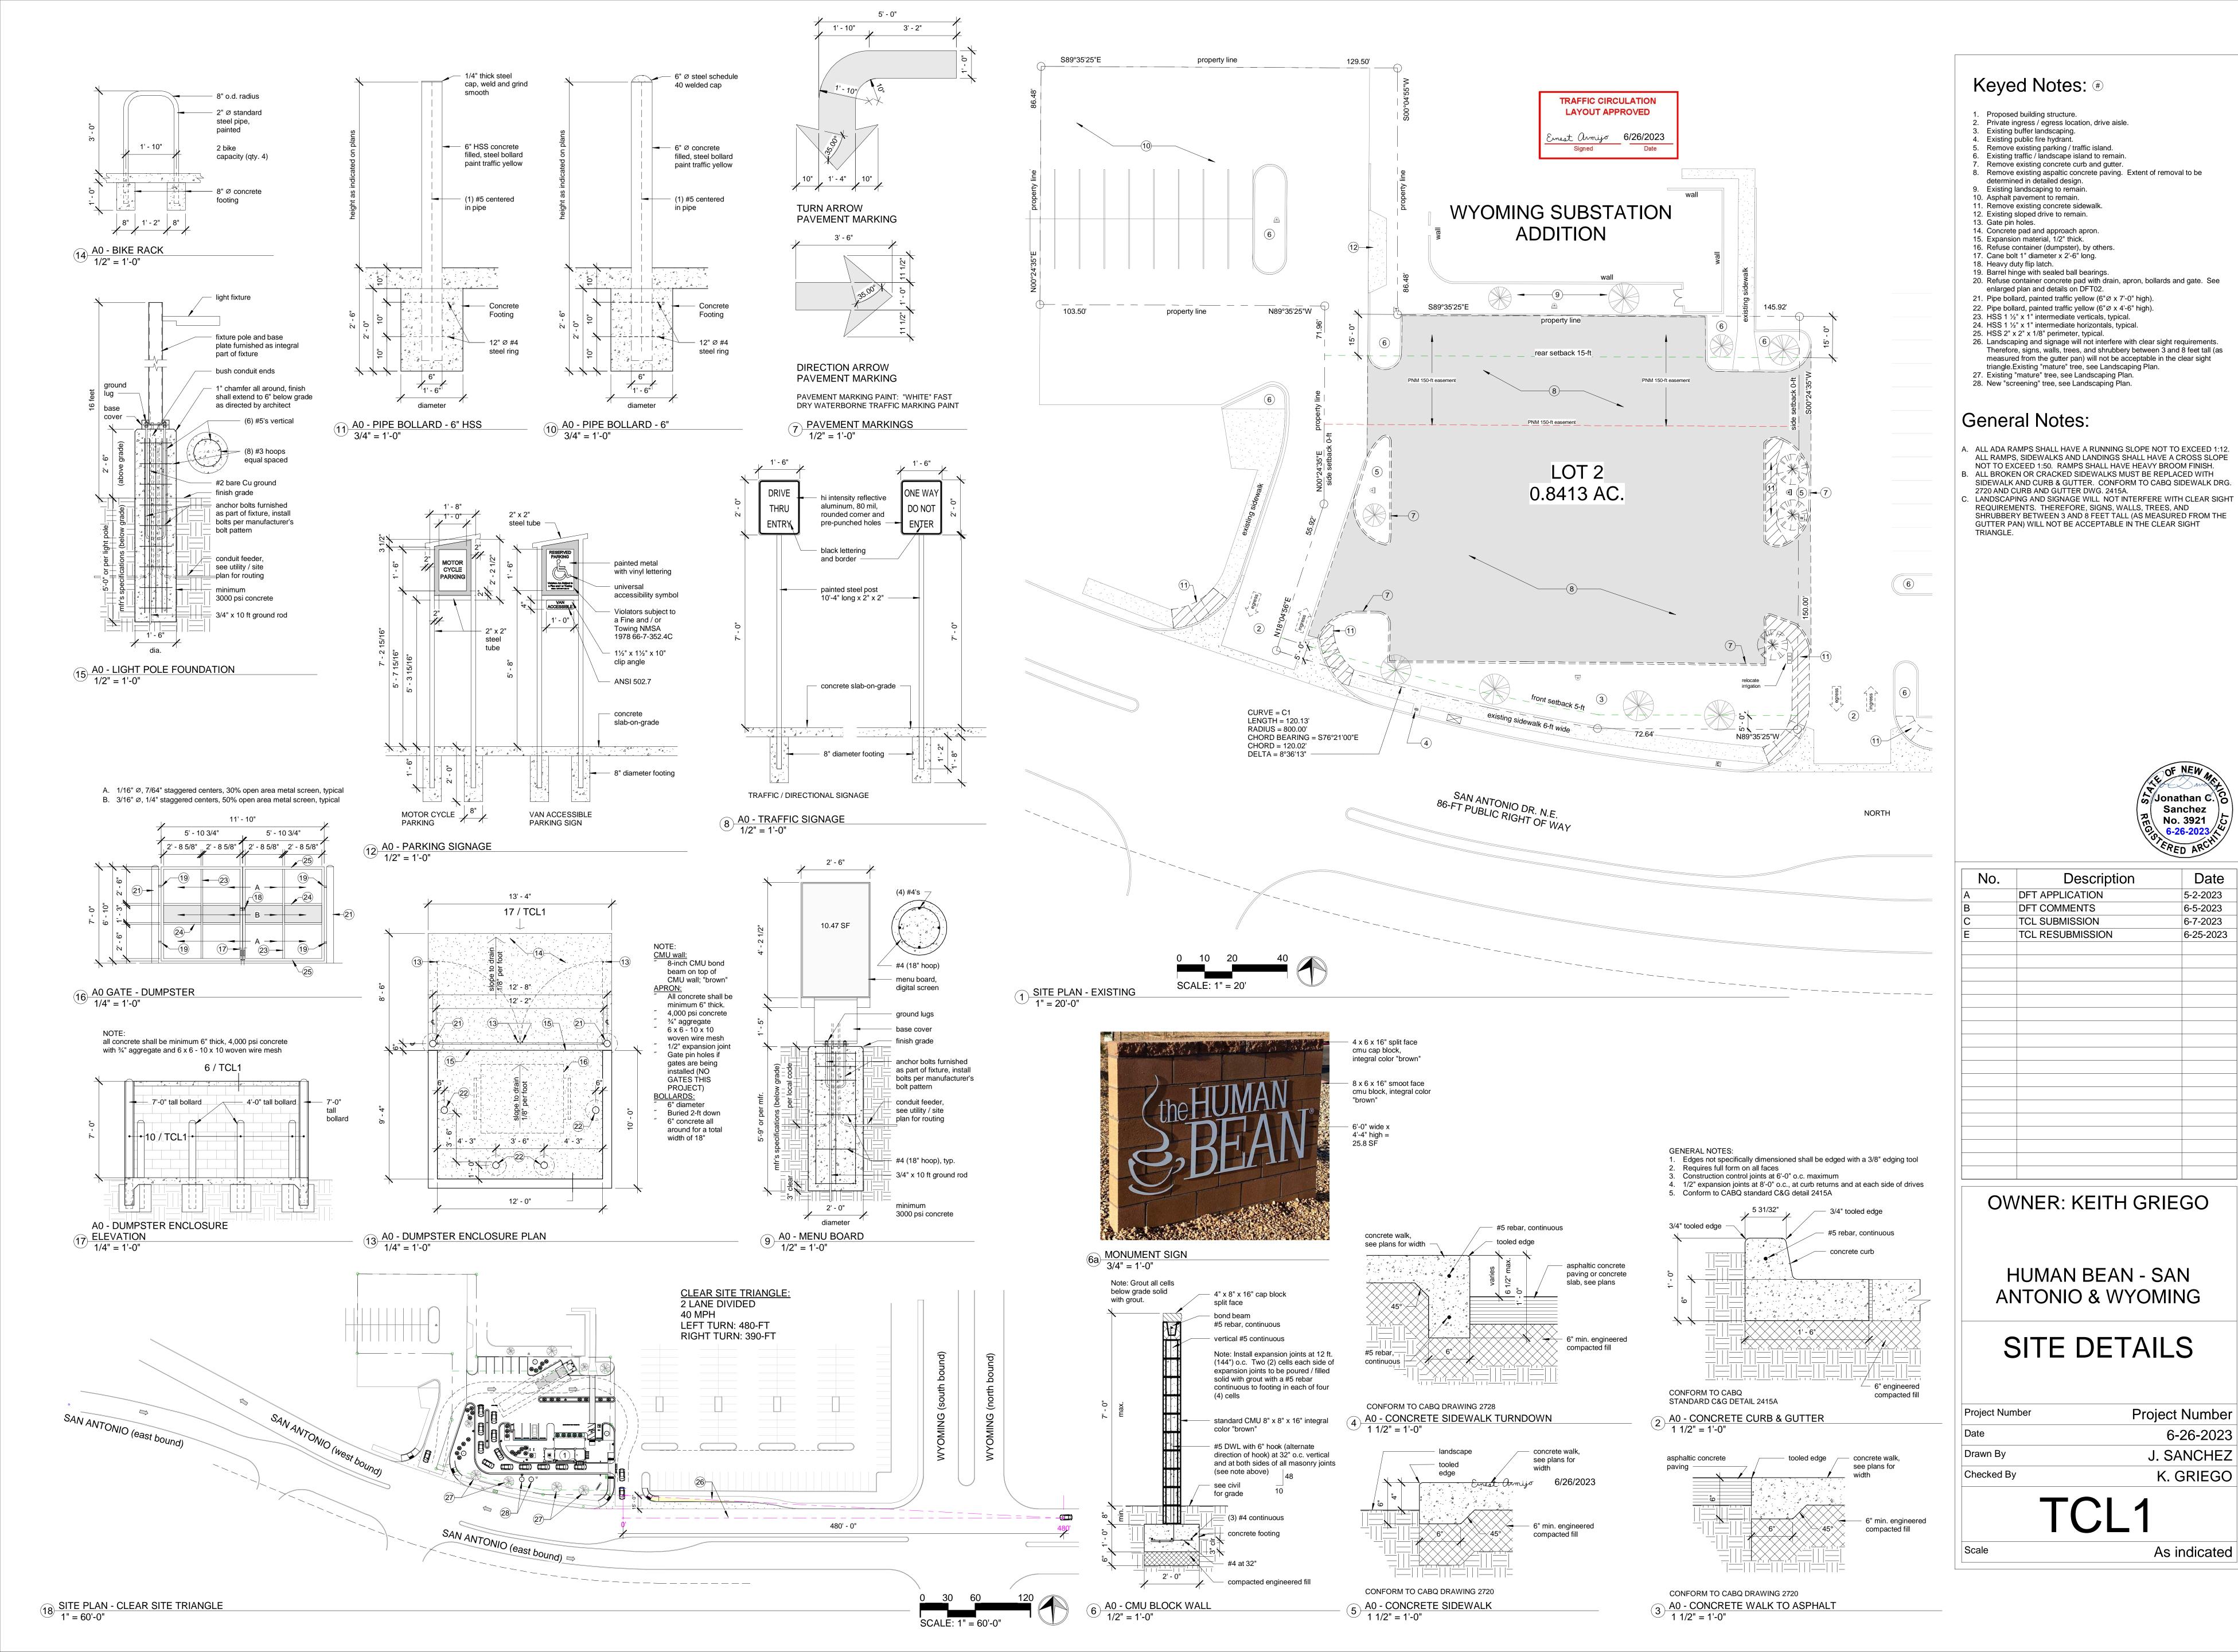

Date

PR-2023-008615_SI-2023-01429_Site Plan_Ap proved_11-22-23_Sheet_1

Final Audit Report 2023-11-30

Created: 2023-11-27

By: Jay Rodenbeck (jrodenbeck@cabq.gov)

Status: Signed

Transaction ID: CBJCHBCAABAAudmFizdM7FCB_KX0BztzK6MSD9SMGnkJ

"PR-2023-008615_SI-2023-01429_Site Plan_Approved_11-22-2 3_Sheet_1" History

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