DFT APPLICATION





DEVELOPMENT FACILITATION TEAM (DFT) APPLICATIONS

Effective 12/15/2022

Please check the appropriate box(es) and refer to supplemental forms for submittal requirements. All fees must be paid at the time of application.				
MISCELLANEOUS APPLICATION	ıs	☐ Extension of Infrastructure Lis	st or IIA (Form S3)	
☐ Site Plan Administrative DFT (Forms P & P2)		PR	E-APPLICATIONS	
Final EPC Sign-off for Master Development/Site Plans - EPC (Form P2)		ment (Form S3)		
☐ Amendment to Infrastructure List (Form S3)		☐ Sketch Plan Review and Com	ment (Form S3)	
☐ Temporary Deferral of S/W (Form S3)			APPEAL	
☐ Extension of IIA: Temp. Def. of S/W (Form S3)		☐ Administrative Decision (Form	A)	
BRIEF DESCRIPTION OF REQUEST				
APPLICATION INFORMATION				
Applicant/Owner:			Phone:	
Address:		T	Email:	
City:		State:	Zip:	
Professional/Agent (if any): Phone:				
Address:		T -	Email:	
City:		State:	Zip:	
Proprietary Interest in Site: List <u>all</u> owners:				
SITE INFORMATION (Accuracy of the existing lega	-	-		
Lot or Tract No.: TRACT IN N 1/2 NW 1/4 NW Subdivision Addition M/LTRACT IN N 1/2 NW 1/4		0	Unit:	
AC M/L		MRGCD Map No.:	UPC Code: Proposed Zoning	
Zone Atlas Page(s):	Existing Zoning:		<u> </u>	
# of Existing Lots: # of Proposed Lots: Total Area of Site (Acres): LOCATION OF PROPERTY BY STREETS			Total Area of Site (Acres).	
Site Address/Street:	Between:		d :	
CASE HISTORY (List any current or prior project a				
, , , , , , , , , , , , , , , , , , ,	(-,	,	,	
I certify that the information have included here and sent in the required notice was complete, true, and accurate to the extent of my knowledge.				
Signature: Date:				
Printed Name:			☐ Applicant or ☐ Agent	

FORM P2

FORM P2 Page 1 of 3

FORM P2: SITE PLAN ADMINISTRATIVE – Development Facilitation Team (DFT) as of 12/25/2022 _ SITE PLAN ADMINISTRATIVE – DFT

A Single PDF file of the complete application including all documents being submitted must be emailed to PLNDRS@cabq.gov. Zipped files or those over 9 MB cannot be delivered via email, in which case the PDF must be provided to City Staff using other online resources such as Dropbox or FTP. The PDF shall be organized in the number order below. Divide the PDF with a title sheet for each of the three documentation sections in **bold** below.

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SITF PI	$\Delta N I I$	 11-13114	111111111

1) DFT Application form completed, signed, and dated
2) Form P2 with all the submittal items checked/marked
3) Form P with signatures from Hydrology, Transportation, and ABCWUA
4) Zone Atlas map with the entire site clearly outlined and labeled
5) Site Plan and related drawings (include a Site Plan key of the sheets submitted)
6) Copy of the original approved Site Plan or Master Development Plan (for amendments to or Extensions of the Site Plan)
7) Infrastructure List, if required for building of public infrastructure
8) Sensitive Lands Site Analysis for new site design in accordance with IDO Section 5-2(C) (The Sensitive Lands Site Analysis form can be obtained online at): https://documents.cabq.gov/planning/development-review-board/Sensitive_lands_analysis_form.pdf
9) Responses to climatic and geographic responsive design considerations (Recommended to promote sustainability, but not required. The Climatic and Geographic Responsiveness form can be obtained online at): https://documents.cabq.gov/planning/IDO/SubmittalFormIDO5-2(D)ClimaticGeographic Responsiveness.pdf
SUPPORTIVE DOCUMENTATION
10) Completed Site Plan Checklist
11) Letter of authorization from the property owner if application is submitted by an agent
12) Justification letter describing and justifying the request per the criteria in IDO Section 16-6-5(G)(3)
13) Explanation and justification of requested deviations, if any, in accordance with IDO Section 14 16-6-4(P). Note: If requesting more than allowed by deviation, a Variance – ZHE or Waiver –DHO will be required, as applicable
14) Sites 5 acres or greater: Archaeological Certificate in accordance with IDO Section 14-16-6-5(A) (not required for Extension)

15) Landfill disclosure statement per IDO Section 14-16-6-4(S)(5)(d)(2)(d) if site is within a designated landfill buffer zone 16) Architectural Review Committee approval letter if the site is located within a Master Development Plan area or a Framework Plan area **PUBLIC NOTICE DOCUMENTATION** ____ 17) Sign Posting Agreement _____ 18) Proof of a Pre-Submittal Neighborhood Meeting per IDO 6-4(C)(1)(b) for new building or multiple new buildings that include a total of more than 100 multi-family residential dwelling units or more than 50,000 square feet of non-residential development Office of Neighborhood Coordination neighborhood meeting inquiry response __ Proof of email with read receipt OR Certified Letter offering meeting to applicable associations __ Completed neighborhood meeting request form(s) If a meeting was requested or held, copy of sign-in sheet and meeting notes 19) Required Content of Notice at Submittal per IDO Section 14-16-6-4(K)(1) (not required for an extension) Office of Neighborhood Coordination notice inquiry response

__ Completed notification form(s), proof of additional information provided in accordance with

Proof of emailed notice to affected Neighborhood Association representatives

IDO Section 6-4(K)(1)(b)

FORM P2

Page 2 of 3

FORM P2 Page **3** of **3**

_ FINAL SIGN-OFF FOR MASTER DEVELOPMENT PLANS AND SITE PLANS — EPC

A Single PDF file of the complete application including all documents being submitted must be emailed to PLNDRS@cabq.gov prior to making a submittal. Zipped files or those over 9 MB cannot be delivered via email, in which case the PDF must be provided to City Staff using other online resources such as Dropbox or FTP. The PDF shall be organized in the number order below.

1) DFT Application form completed, signed, and dated
2) Form P2 with all the submittal items checked/marked
3) Zone Atlas map with the entire site clearly outlined and labeled
4) Site Plan and related drawings
5) Infrastructure List, if require
6) Copy of EPC Notice of Decision and letter explaining how each EPC condition has been met
7) Letter of authorization from the property owner if application is submitted by an agent
8) Solid Waste Department signature on Site Plan
9) Signed Form DRWS Drainage Report, Grading and Drainage Plan, and Water & Sewer Availability Statement filing information
10) Approved Grading and Drainage Plan
11) Copy of Site Plan with Fire Marshal's stamp, i.e. "Fire 1" plan (not required for Master Development Plans)




FORM P: PRE-APPROVALS/SIGNATURES


Legal Description & Location: 10501 CENTRAL AV NE	
TRACT IN N 1/2 NW 1/4 NW 1/4 CONT 2.2860 AC M/LTRACT IN N 1/2 NW 1/4 NW 1/4 CONT 2.2860 A	СМ
Job Description: New 4-story multifamily development with resident amenities, parking and landscaping.	
□ <u>Hydrology:</u>	
 Grading and Drainage Plan AMAFCA Bernalillo County NMDOT MRGCD X Approved Approved X NA X NA X NA Approved X NA Approved X NA NA 	
Hydrology Department Date	
□ <u>Transportation:</u>	
 Traffic Circulations Layout (TCL) Traffic Impact Study (TIS) Neighborhood Impact Analysis (NIA) Bernalillo County MRCOG NMDOT MRGCD MRGCD Approved Approved Approved X NA MRGCD MRGCD MPIZ/2023 	
Transportation Department Date	
□ Albuquerque Bernalillo County Water Utility Authority (ABCWUA):	
 Water/Sewer Availability Statement/Serviceability Letter ABCWUA Development Agreement ABCWUA Service Connection Agreement Approved Approved NA 	
9/25/2023 ABCWUA Date	
□ Infrastructure Improvements Agreement (IIA*) Approved NA □ Solid Waste Department Signature on the plan Approved NA □ Fire Marshall Signature on the plan Approved NA	

^{*} Prior to Final Site Plan approval submittals (include a copy of the recorded IIA)

ZONE ATLAS MAP

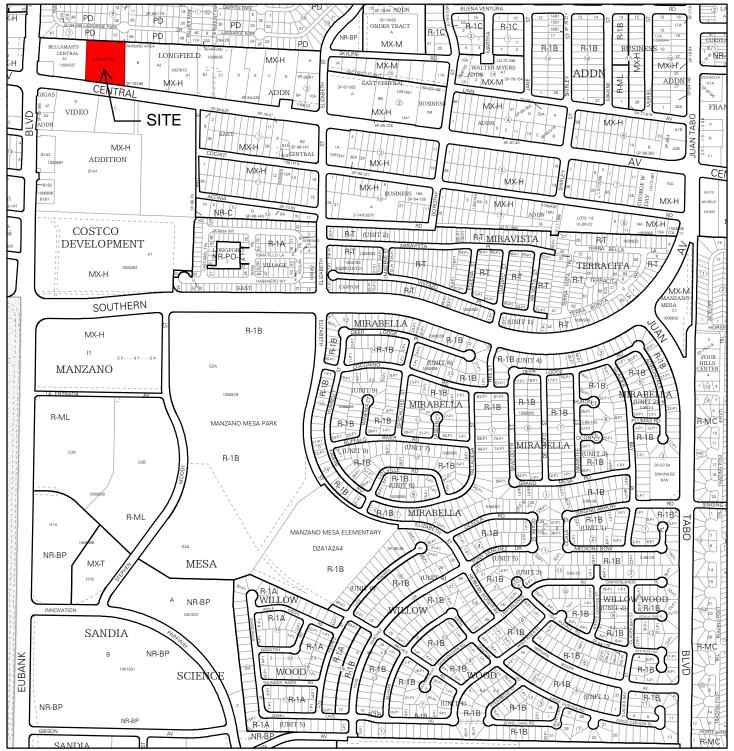

For more details about the Integrated Development Ordinance visit: http://www.cabq.gov/planning/codes-policies-regulations/integrated-development-ordinance

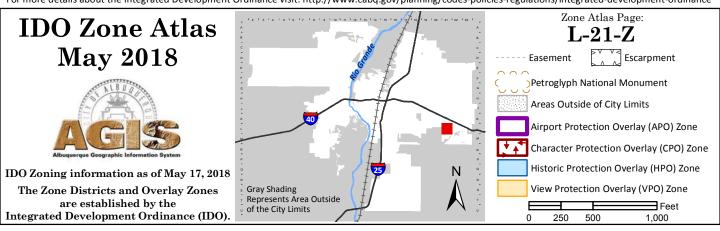


SITE PLAN

DRAWING INDEX


SITE DEVELOPMENT PLAN
SITE DETAILS
SITE DETAILS
LANDSCAPE PLAN
GRADING AND DRAINAGE PLAN
EXTERIOR ELEVATIONS
EXTERIOR ELEVATIONS
FIRE HYDRANT LOCATION AND ACCESS PLAN SDP 1.2 SDP 1.3 SDP 2.1 C-1.1

Architecture in Progress

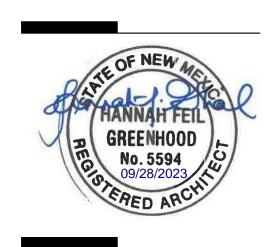

ARCHITECT

VICINITY MAP

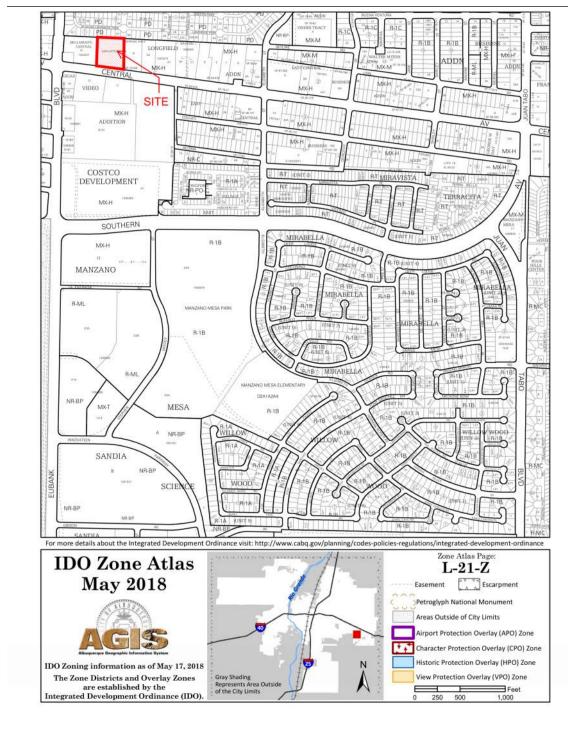


FAROLITO SENIOR COMMUNITY

PROJECT TEAM OWNER FAROLITO APARTMENTS LIMITED PARTNERSHIP LLLP 320 GOLD AVENUE SW ALBUQUERQUE, NM 87102 (505) 244-1614


ARCHITECT DEKKER PERICH SABATINI 7601 JEFFERSON NE, SUITE 100 ALBUQERQUE, NM 87109 (505) 761-9700

LANDSCAPE ARCHITECT DEKKER PERICH SABATINI 7601 JEFFERSON NE, SUITE 100 ALBUQERQUE, NM 87109 (505) 761-9700

CIVIL ENGINEER ISAACSON & ARFMAN, INC. 128 MONROE STREET NE ALBUQUERQUE, NM 87108 (505) 268-8828

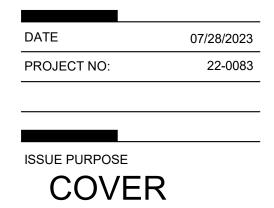

10501 CENTRAL A ALBUQUERQUE,

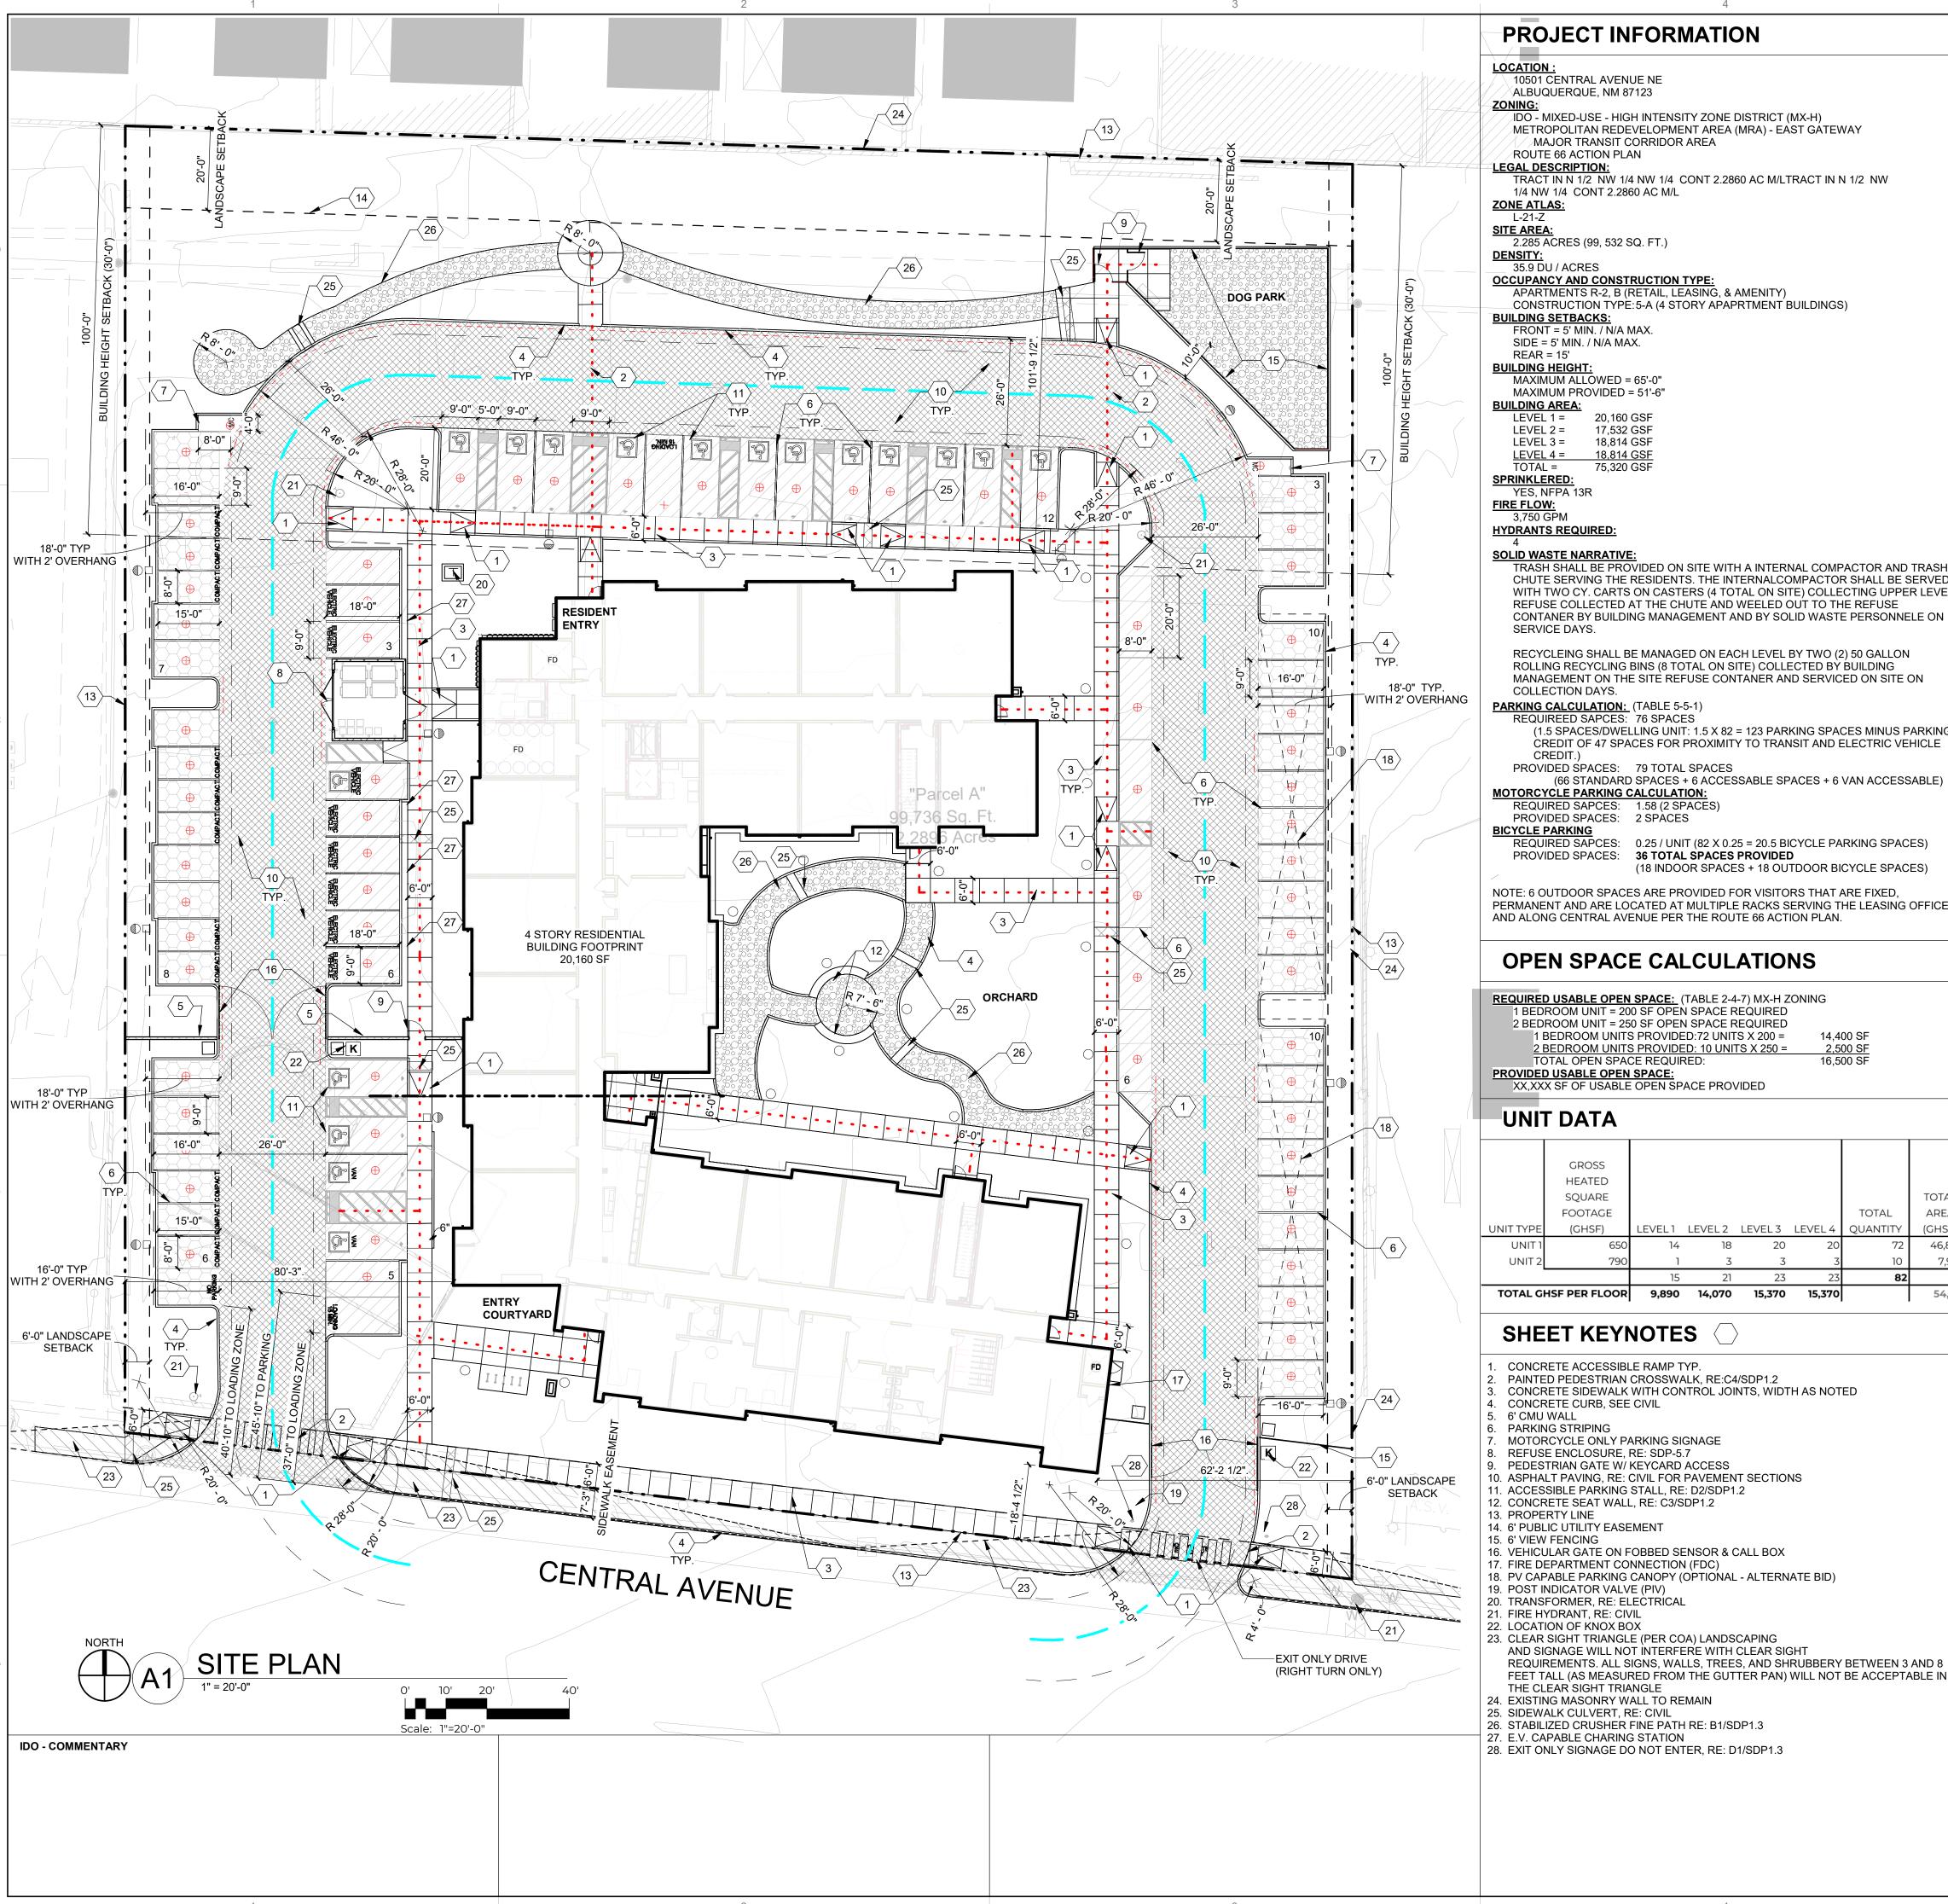

GENERAL SHEET NOTES

ALBUQUERQUE, NM 87123

IDO - MIXED-USE - HIGH INTENSITY ZONE DISTRICT (MX-H)
METROPOLITAN REDEVELOPMENT AREA (MRA) - EAST GATEWAY

MAJOR TRANSIT CORRIDOR AREA

TRACT IN N 1/2 NW 1/4 NW 1/4 CONT 2.2860 AC M/LTRACT IN N 1/2 NW

1/4 NW 1/4 CONT 2.2860 AC M/L

OCCUPANCY AND CONSTRUCTION TYPE:

APARTMENTS R-2, B (RETAIL, LEASING, & AMENITY)

_CONSTRUCTION TYPE:5-A (4 STORY APAPRTMENT BUILDINGS)

MAXIMUM ALLOWED = 65'-0"

17,532 GSF

75,320 GSF

TRASH SHALL BE PROVIDED ON SITE WITH A INTERNAL COMPACTOR AND TRASH CHUTE SERVING THE RESIDENTS. THE INTERNALCOMPACTOR SHALL BE SERVED WITH TWO CY. CARTS ON CASTERS (4 TOTAL ON SITE) COLLECTING UPPER LEVEL REFUSE COLLECTED AT THE CHUTE AND WEELED OUT TO THE REFUSE

RECYCLEING SHALL BE MANAGED ON EACH LEVEL BY TWO (2) 50 GALLON ROLLING RECYCLING BINS (8 TOTAL ON SITE) COLLECTED BY BUILDING MANAGEMENT ON THE SITÈ REFUSE CONTANER AND SERVICED ON SITE ON

PARKING CALCULATION: (TABLE 5-5-1)

(1.5 SPACES/DWELLING UNIT: 1.5 X 82 = 123 PARKING SPACES MINUS PARKING CREDIT OF 47 SPACES FOR PROXIMITY TO TRANSIT AND ELECTRIC VEHICLE

PROVIDED SPACES: 79 TOTAL SPACES (66 STANDARD SPACES + 6 ACCESSABLE SPACES + 6 VAN ACCESSABLE)

REQUIRED SAPCES: 1.58 (2 SPACES) PROVIDED SPACES: 2 SPACES

PROVIDED SPACES: 36 TOTAL SPACES PROVIDED

(18 INDOOR SPACES + 18 OUTDOOR BICYCLE SPACES)

NOTE: 6 OUTDOOR SPACES ARE PROVIDED FOR VISITORS THAT ARE FIXED, PERMANENT AND ARE LOCATED AT MULTIPLE RACKS SERVING THE LEASING OFFICE, AND ALONG CENTRAL AVENUE PER THE ROUTE 66 ACTION PLAN.

OPEN SPACE CALCULATIONS

REQUIRED USABLE OPEN SPACE: (TABLE 2-4-7) MX-H ZONING 1 BEDROOM UNIT = 200 SF OPEN SPACE REQUIRED

2 BEDROOM UNIT = 250 SF OPEN SPACE REQUIRED 1 BEDROOM UNITS PROVIDED:72 UNITS X 200 = 14,400 SF 2 BEDROOM UNITS PROVIDED: 10 UNITS X 250 = 2,500 SF

PROVIDED USABLE OPEN SPACE: XX,XXX SF OF USABLE OPEN SPACE PROVIDED

FOOTAGE TOTAL A UNIT TYPE (GHSF) LEVEL 1 LEVEL 2 LEVEL 3 LEVEL 4 QUANTITY (C	AREA GHSF) 46,800 7,900
FOOTAGE TOTAL A UNIT TYPE (GHSF) LEVEL 1 LEVEL 2 LEVEL 3 LEVEL 4 QUANTITY (CI UNIT 1 650 14 18 20 20 72	CHSF) 46,800
FOOTAGE TOTAL A UNIT TYPE (GHSF) LEVEL 1 LEVEL 2 LEVEL 3 LEVEL 4 QUANTITY (C	GHSF)
FOOTAGE TOTAL A	
	AREA
SQUARE	
	OTAL
HEATED	
GROSS	

SHEET KEYNOTES

- CONCRETE ACCESSIBLE RAMP TYP.
 PAINTED PEDESTRIAN CROSSWALK, RE:C4/SDP1.2
- CONCRETE SIDEWALK WITH CONTROL JOINTS, WIDTH AS NOTED
- PEDESTRIAN GATE W/ KEYCARD ACCESS 10. ASPHALT PAVING, RE: CIVIL FOR PAVEMENT SECTIONS
- 11. ACCESSIBLE PARKING STALL, RE: D2/SDP1.2

- 16. VEHICULAR GATE ON FOBBED SENSOR & CALL BOX
- 19. POST INDICATOR VALVE (PIV)
- 23. CLEAR SIGHT TRIANGLE (PER COA) LANDSCAPING
- AND SIGNAGE WILL NOT INTERFERE WITH CLEAR SIGHT REQUIREMENTS. ALL SIGNS, WALLS, TREES, AND SHRUBBERY BETWEEN 3 AND 8 FEET TALL (AS MEASURED FROM THE GUTTER PAN) WILL NOT BE ACCEPTABLE IN
- THE CLEAR SIGHT TRIANGLE 24. EXISTING MASONRY WALL TO REMAIN
- 25. SIDEWALK CULVERT, RE: CIVIL
- 26. STABILIZED CRUSHER FINE PATH RE: B1/SDP1.3
- 28. EXIT ONLY SIGNAGE DO NOT ENTER, RE: D1/SDP1.3

- A. SITE PLAN DIMENSIONS ARE IN DECIMAL UNITS. DIMENSIONS ARE TO FACE OF CURB, OR WALL, OR EDGE OF PAVEMENT UNLESS OTHERWISE NOTED. B. SITE PLAN SHALL COMPLY WITH LOCAL, FEDERAL AND ACCESSIBILITY STANDARDS
- & GUIDELINES, INCLUDING THE INTERNATIONAL FIRE CODE (IFC) 2015. C. VERIFY EXISTING UTILITY LOCATIONS BEFORE EXCAVATION.
- D. COORDINATE WITH OWNER FOR ALLOWABLE STAGING AREAS DURING E. REPAIR AREAS TO MATCH PRE-CONSTRUCTION CONDITION WHERE UTILITY
- WORK, GRADING AND/OR STAGING OCCURS, INCLUDING AREAS OUTSIDE OF LIMIT
- F. ALL EXISTING ASPHALT AND CONCRETE TO BE REMOVED PRIOR TO
- CONSTRUCTION
- G. REMOVE EXISTING TREES PRIOR TO CONSTRUCTION H. UTILITIES AND ASSOCIATED EQUIPMENT SHOWN FOR REFERENCE ONLY.
- COORDINATE LOCATION AND INSTALLATION. SEE CIVIL ALL CURBS AND ACCESSIBLE RAMPS WILL BE DESIGNED AND BUILT ACCORDING TO THE CITY OF ALBUQUERQUE STANDARDS.
- AN ACCESSIBLE ROUTE, IN COMPLIANCE WITH ACCESSIBILITY STANDARDS OF THE PROJECT, CONNECTS FROM THE BUILDING TO ACCESSIBLE PARKING SPACES AND TO ALL SITE AMENITIES AS REQUIRED
- ALL LIGHT FIXTURES AND LIGHTING DESIGN SHALL COMPLY WITH THE CITY OF ALBUQUERQUE INTEGRATED DEVELOPMENT ORDINANCE (IDO): SECTION 14-16-5-8 OUTDOOR LIGHTING.
- .. REFER TO CIVIL AND ELECTRICAL FOR DEMOLITION ITEMS.
- M. REFER TO CIVIL FOR PAVING PLAN AND PAVING DETAILS. N. STREETS, PARKING SPACES AND ASSOCIATED DRIVES TO BE ASPHALT UNLESS
- NOTED OTHERWISE. O. SIDEWALK JOINTS SHALL FOLLOW PATTERN AS SHOWN ON SITE PLAN. P. PROVIDE POURABLE SEALANT AT ALL EXPANSION JOINTS IN CONCRETE
- SIDEWALK, WHERE EXPANSION JOINT MATERIAL IS PROVIDED BETWEEN WALLS AND SIDEWALKS AND BETWEEN ASPHALT AND CONCRETE JOINTS. Q. PROVIDE AIR ENTRAINED CONCRETE WITH MEDIUM BROOM FINISH AT ALL SITE
- CONCRETE. SLOPE ALL CONCRETE SIDEWALKS TO DRAIN, TYP. RE: CIVIL FOR SPOT ELEVATIONS, AND GRADING AND DRAINAGE REQUIREMENTS. R. EXISTING LANDSCAPE AREAS ADJACENT TO THE PROJECT SITE ARE TO BE
- PROTECTED A DEMOLITION AND CONSTRUCTION. LANDSCAPE AND SIGNAGE WILL NOT INTERFERE WITH CLEAR SIGHT
- REQUIREMENTS. THEREFORE SIGNS, WALLS AND PLANTING BETWEEN 3 FEET AND 8 FEET TALL (AS MEASURED FROM THE GUTTER PAN) WILL NOT BE PERMITTED IN THE CLEAR SIGHT TRIANGLE. WORK WITHIN THE PUBLIC RIGHT OF WAY REQUIRES A WORK ORDER WITH DRC
- APPROVED PLANS PER CITY OF ALBUQUERQUE. ALL RAMPS, SIDEWALKS, CURBS AND GUTTERS IN THE R.O.W. SHALL BE
- INSTALLED PER CITY OF ALBUQUERUQE STANDARD DRAWINGS. SOLID WASTE CONNECTION IS THE RESPONSIBILITY OF THE CITY OF ALBUQUERQUE SOLID WASTE DEPARTMENT
- W. DURING CONSTRUCTION, COORDINATE WITH CITY OF ALBUQUERQUE'S MEDIAN LANDSCAPING PROJECT AT THIS LOCATION.

PROJECT NUMBER:

Application Number:

Is an Infrastructure List required? () Yes ()No If yes, then a set of approved DRC plans with a work order is required for any construction within Public Right-of-Way or for construction of public improvements.

DFT SITE DEVELOPMENT PLAN APPROVAL

Traffic Engineering, Transportation Division	Date
ABCWUA	 Date
Parks and Recreation Department	 Date
Hydrology	Date
Code Enforcement	 Date
* Environmental Health Department (conditional)	Date
Solid Waste Management	Date


LEGEND

	LANDSCAPED AREA
	HEAVY DUTY ASPHALT (RATED FOR UP TO 75,000 LBS)
	LIGHT DUTY ASPHALT
)	STABALIZED DECOMPOSED GRANITE PATH (ACCESABLE)
	PERMIABLE PAVING
	PROPERTY LINE
	SETBACK (SEE DEMENTION FOR ADDITIONAL DETAILS)
	ACCESSIBLE ROUTE
	FIRELANE STRIPPING MARKING FIRE ACCESS LANE, RE: XX/SDP 1
	REFUSE TRUCK ROUTE
	EXISTING FIRE HYDRANT LOCATION
⟨ ⟩	PROPOSED FIRE HYDRANT LOCATION
Y	FIRE DEPARTMENT CONNECTION (FDC) WALL MOUNTED
Т	PROPOSED TRANSFORMER LOCATION
	PROPOSED 20' LIGHT POLE

OPTIONAL PHOTOVOLTAIC (PV) CARPORT,

BIKE RACK (4 BIKE CAPACITY) RE: XX/SDP 1.2

(SEPERATE PERMIT REQUIRED)

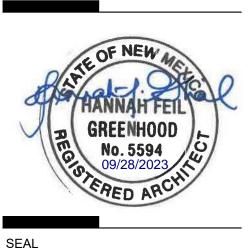

PROJECT

ISSUED FOR **PERMIT**

DRAWN BY **REVIEWED BY** CWW DATE 05/12/23 PROJECT NO: 22-0083


DRAWING NAME

REVISIONS

SITE **DEVELOPMENT** PLAN

SHEET NO

SDP 1.1

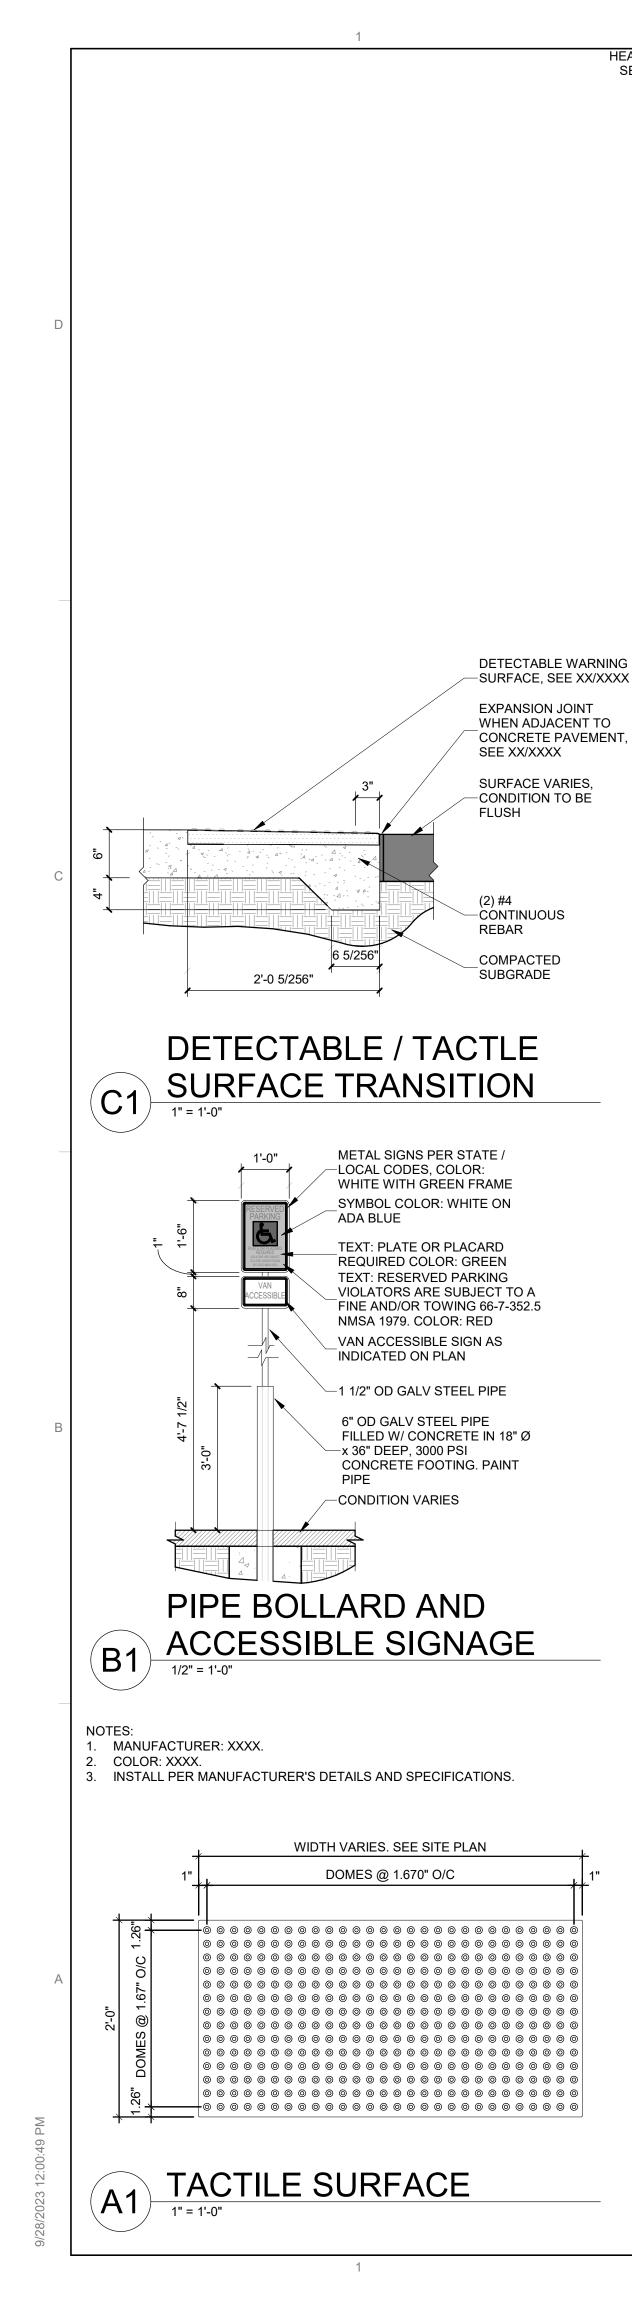

(C2)

1. BASIS OF DESIGN, ANOVA U-BIKE RACK, COLOR: TBD

1'-0"

ARROW

4'-0" MIN


CONCRETE PAD


2'-0"

1. PAINT ARROWS WHERE SHOWN IN PLAN. COLOR: WHITE

BICYCLE RACK PLAN

2. WHERE CONDITION OCCURS IN RIGHT OF WAY, USE REFLECTIVE PAINT

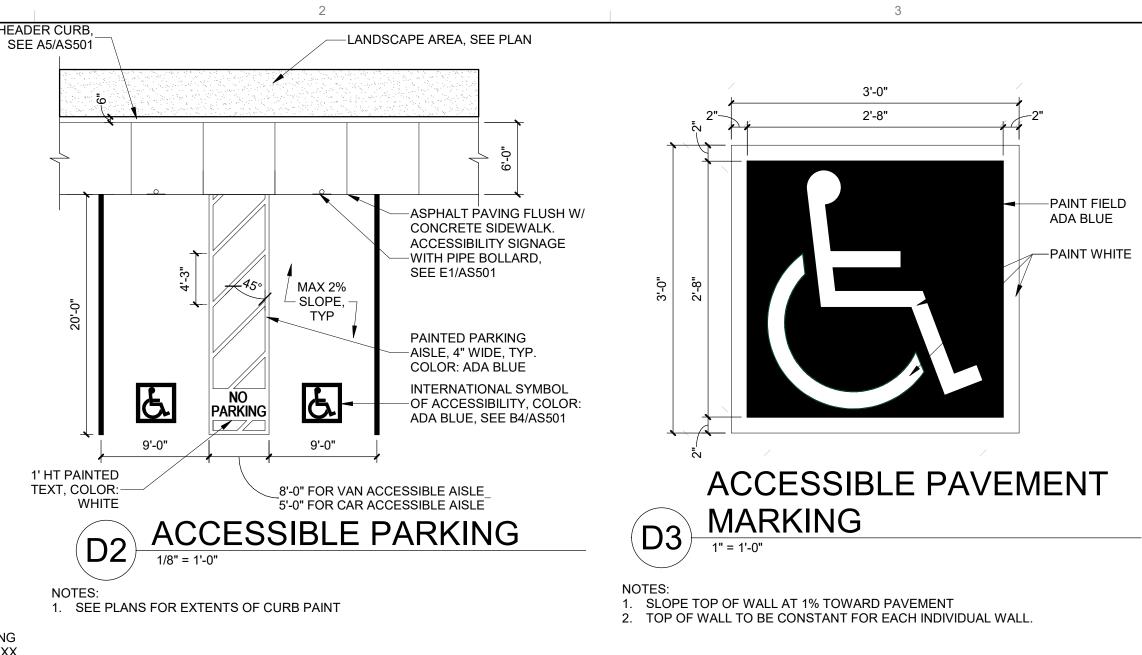

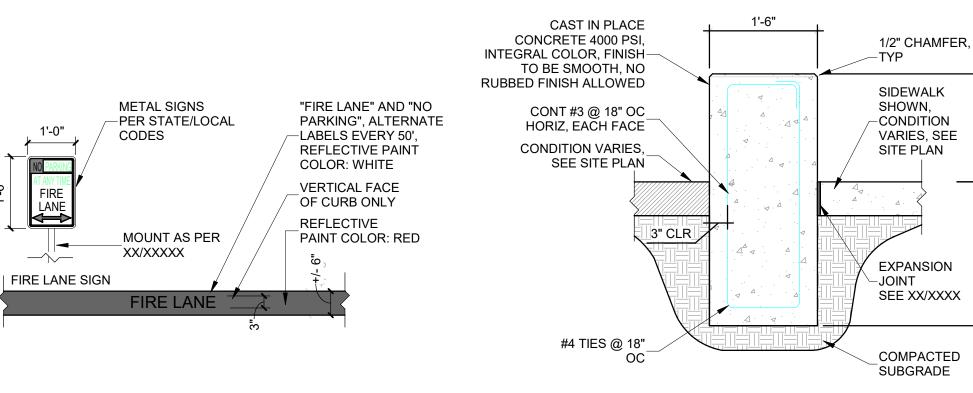

-2"Ø BICYCLE RACK

ANCHORED TO


CONCRETE PAD


AROUND BICYCLE

STALL PER COA

—1' CLEAR ZONE




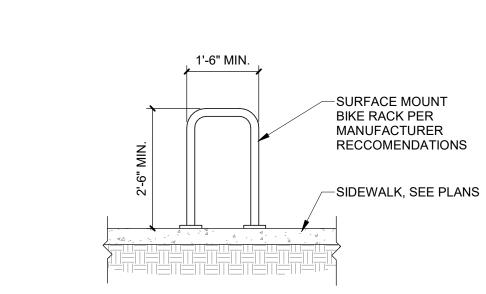

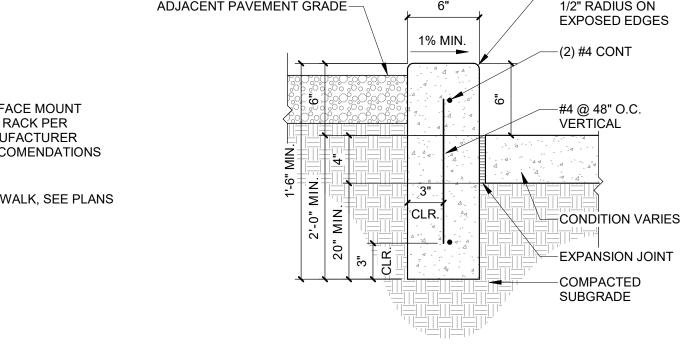

CONDITION VARIES, SEE SITE

6'-0"

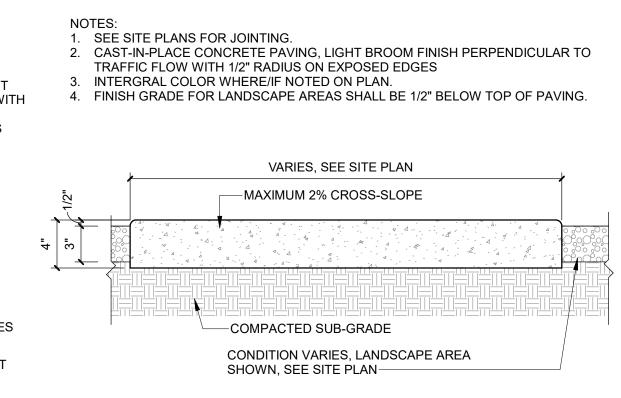

WHERE BACK OF CURB AND GUTTER IS EXPOSED ALONG A RAM, ADD1/2" RADIUS

CAST-IN-PLACE CONCRETE, LIGHT BROOM FINISH, WITH 1/2" RADIUS ON EXPOSED

CONCRETE CURB & GUTTER

1'-6"

-(1) #4 CONT

MATCH SLOPE

OF ROADWAY

ON EXPOSED EDGES.

EXPANSION JOINT

CONCRETE

COMPACTED


CONDITION VARIES.

SIDEWALK SHOWN -



BASIS OF DESIGN, ANOVA U-BIKE RACK, COLOR: TBD


2. 2 BIKE CAPACITY PER RACK. 4 TOTAL PER PAD.

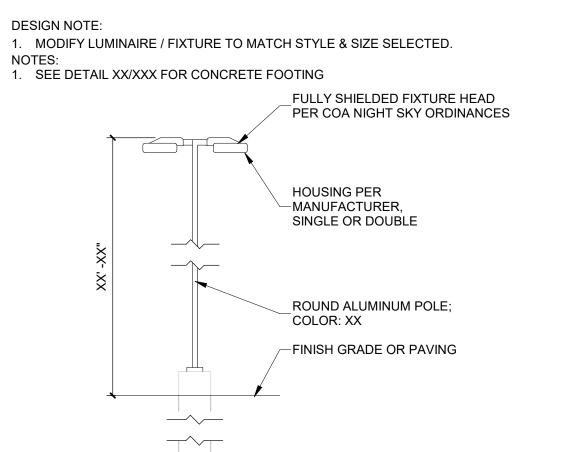

-CONCRETE HEADER CURB BEYOND -DETECTABLE WARING SURFACE IN THE CITY R.O.W CONCRETE RAMP HTYPICAL AT EDGE. |-6"||- (2) #4 CONTINUOUS -COMPACTED SUB-GRADE

RAMP TRANSITION

B5) CONCRETE SIDEWALK

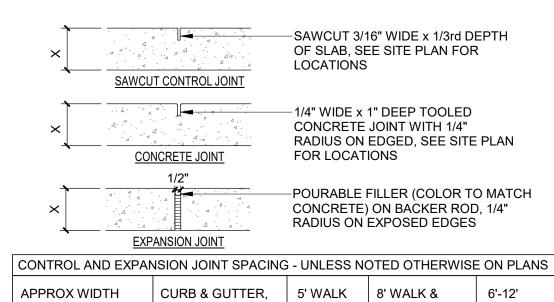

CONTROL AND EXPANSION JOINT SPACING - UNLESS NOTED OTHERWISE ON PLAN				
APPROX WIDTH OF CONCRETE	CURB & GUTTER, ROLL, HEADER, FLUSH CURBS	5' WALK	8' WALK & BLDG APRON	6'-12' WALK
CONTROL JOINTS	4" O.C.	5' O.C.	8' O.C.	6' O.C.
EXPANSION JOINTS	4" O.C.	5' O.C.	8' O.C.	6' O.C.

CONCRETE JOINTS & JOINT SPACING 1 1/2" = 1'-0"

in Progress

Architecture



SEAL

NOTED ON

PLAN

(2) #4 CONT

#4 @ 32" OC

TRANSVERSE

PROJECT

ISSUED FOR

ÖQ

PERMIT REVISIONS DRA'

DRAWN BY	BH
REVIEWED BY	CWW
DATE	07/10/23
PROJECT NO:	22-0083

DRAWING NAME

ENLARGED PLANS AND **DETAILS**

SHEET NO SDP 1.2

PARKING LIGHT POLE

PLAN. WHERE LANDSCAPE MULCH TO 1/2" BELOW CONCRETE, LIGHT -BROOM FINISH, WITH ADJACENT PAVEMENT GRADE-1/2" RADIUS ON CONCRETE HEADER CURB

PAINTED CROSSWALK

WHEN CONDITION OCCURS IN

PAVING-

2'-0" WIDE

TRAFFIC PAINT

COLOR: WHITE

-PLAN, ACCESSIBLE RAMP

SHOWN, SEE XX/XXXX

CAST-IN-PLACE

-CURB AND GUTTER

SEE XX/XXXX


RIGHT OF WAY USE REFLECTIVE PAINT.

PLAN, ACCESSIBLE RAMP SHOWN, SEE XX/XXXX

—STOP BAR

CONDITION VARIES, SEE SITE SUB-GRADE-

DIRECTIONAL PAVEMENT

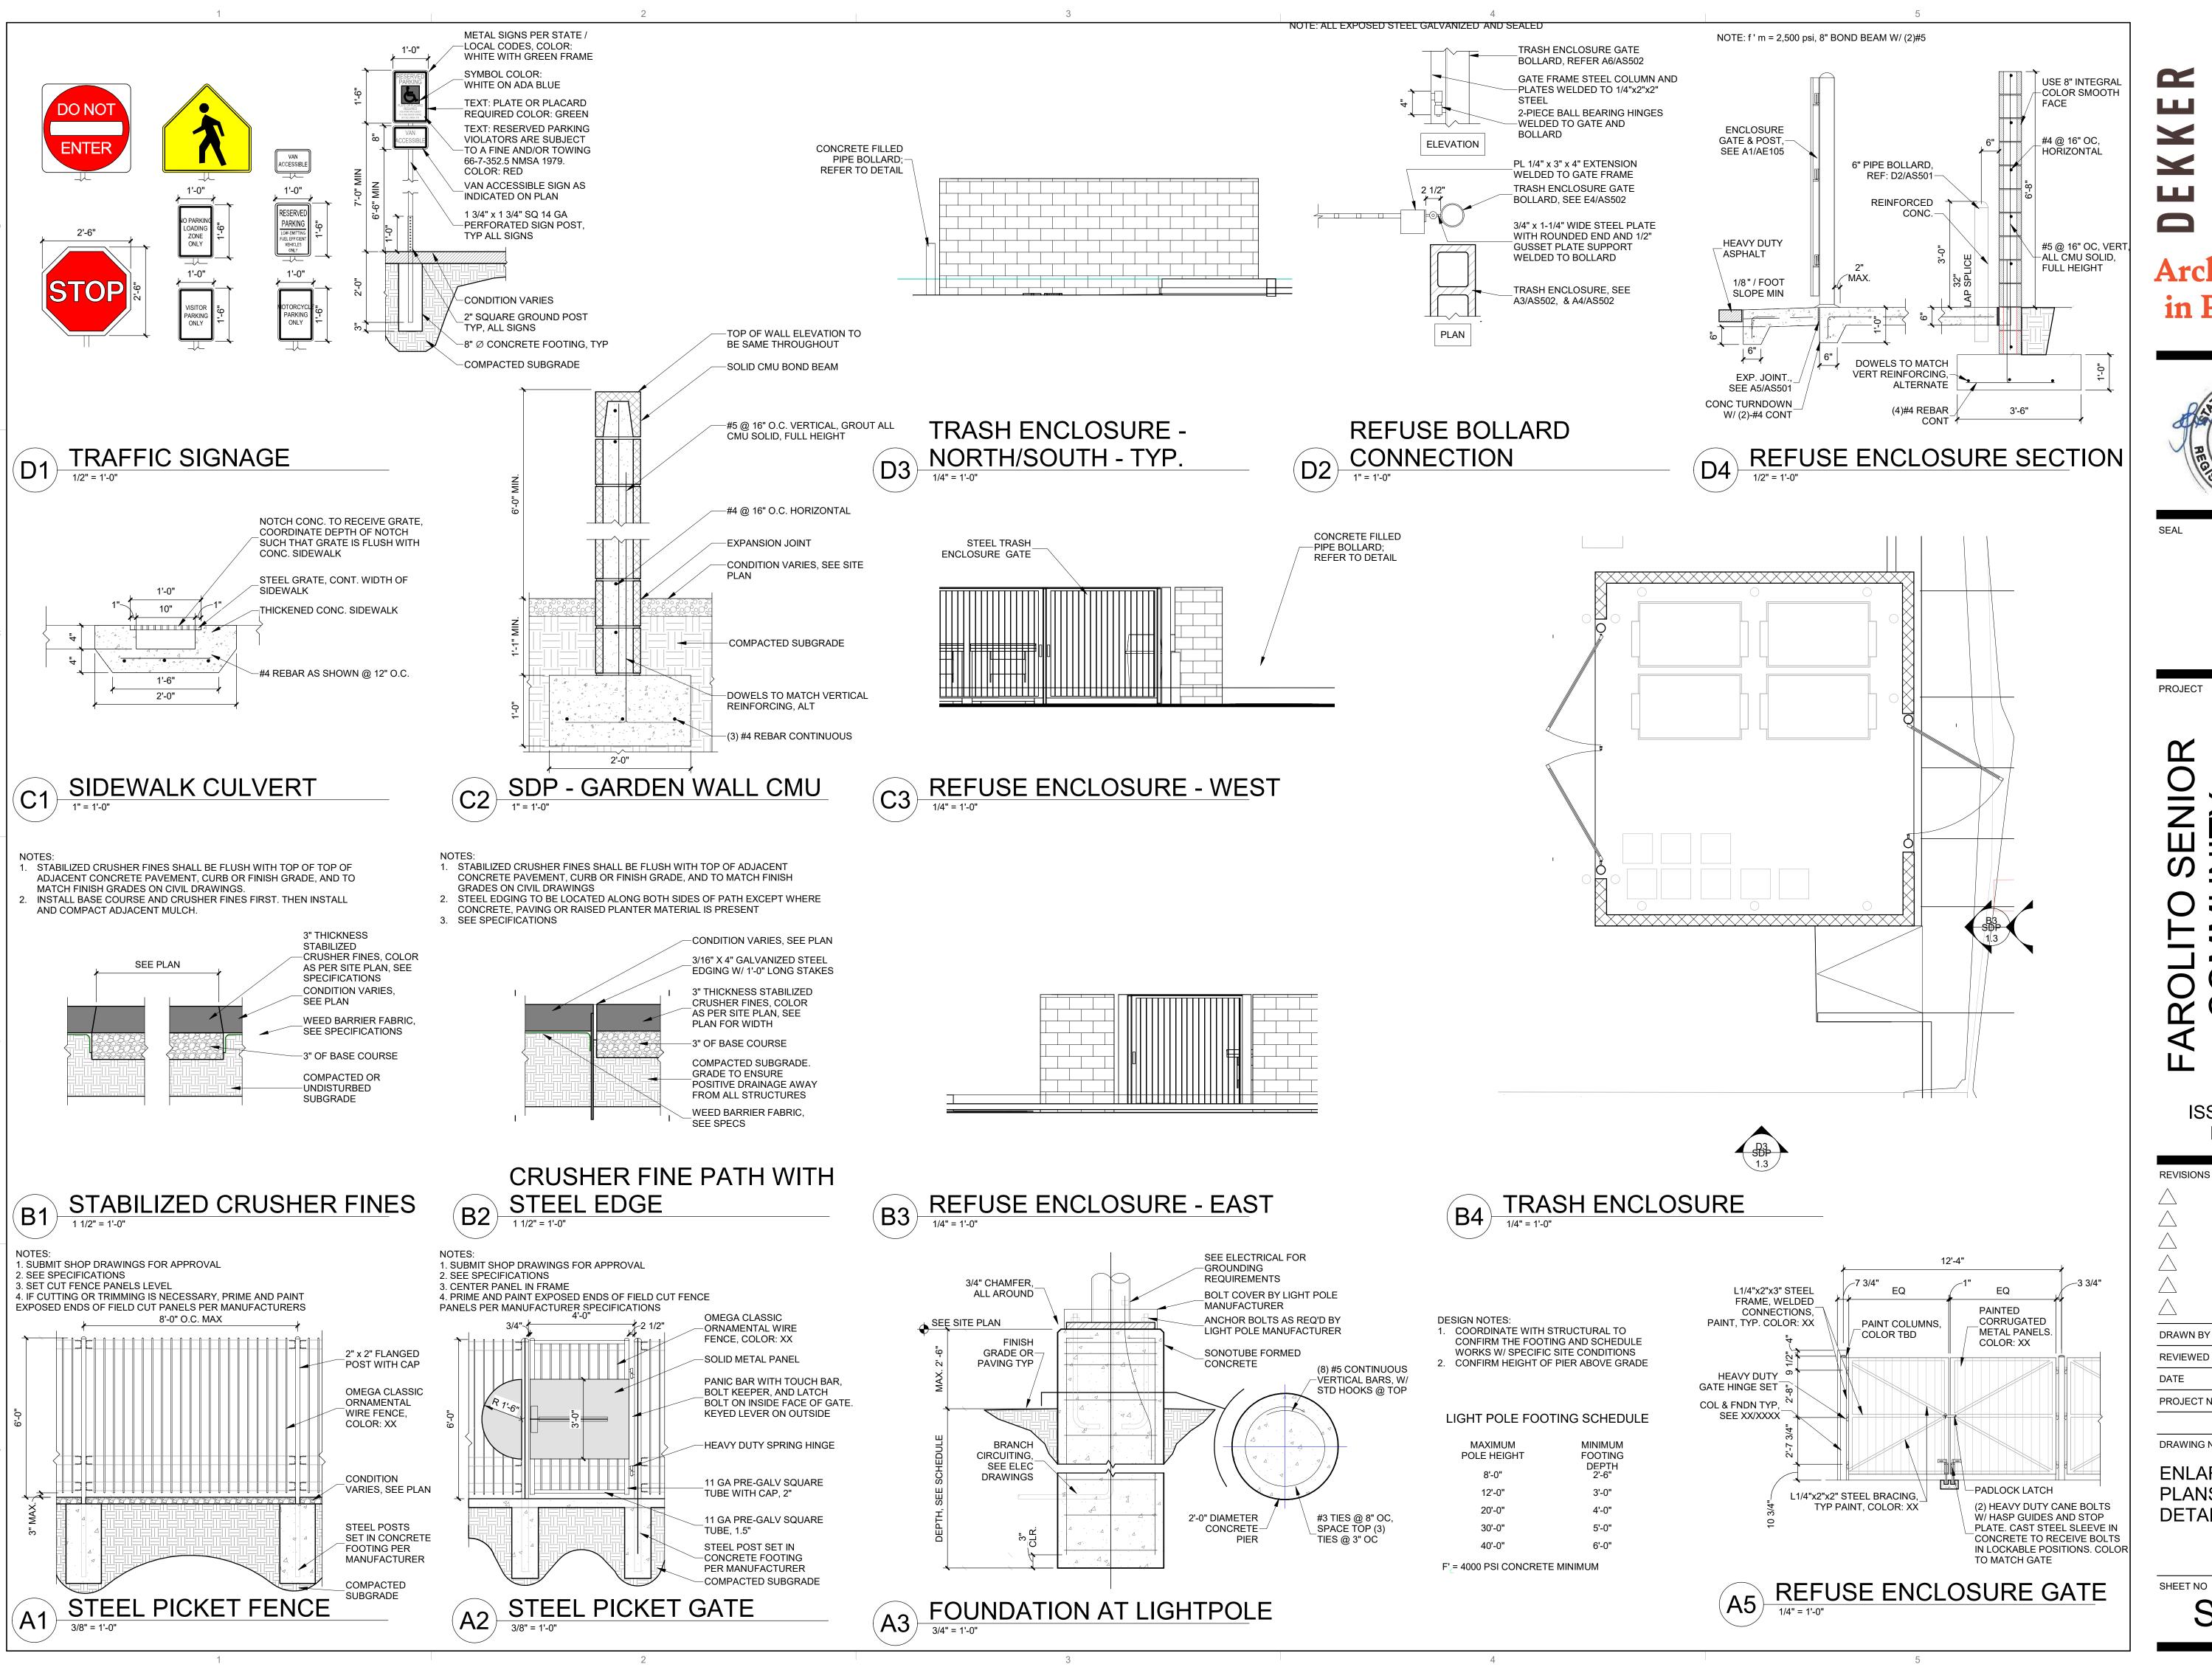

Architecture in Progress




ISSUED FOR PERMIT

DRAWN BY CWW REVIEWED BY 07/10/23 DATE PROJECT NO: 22-0083

DRAWING NAME

ENLARGED PLANS AND **DETAILS**

SHEET NO **SDP 1.3**

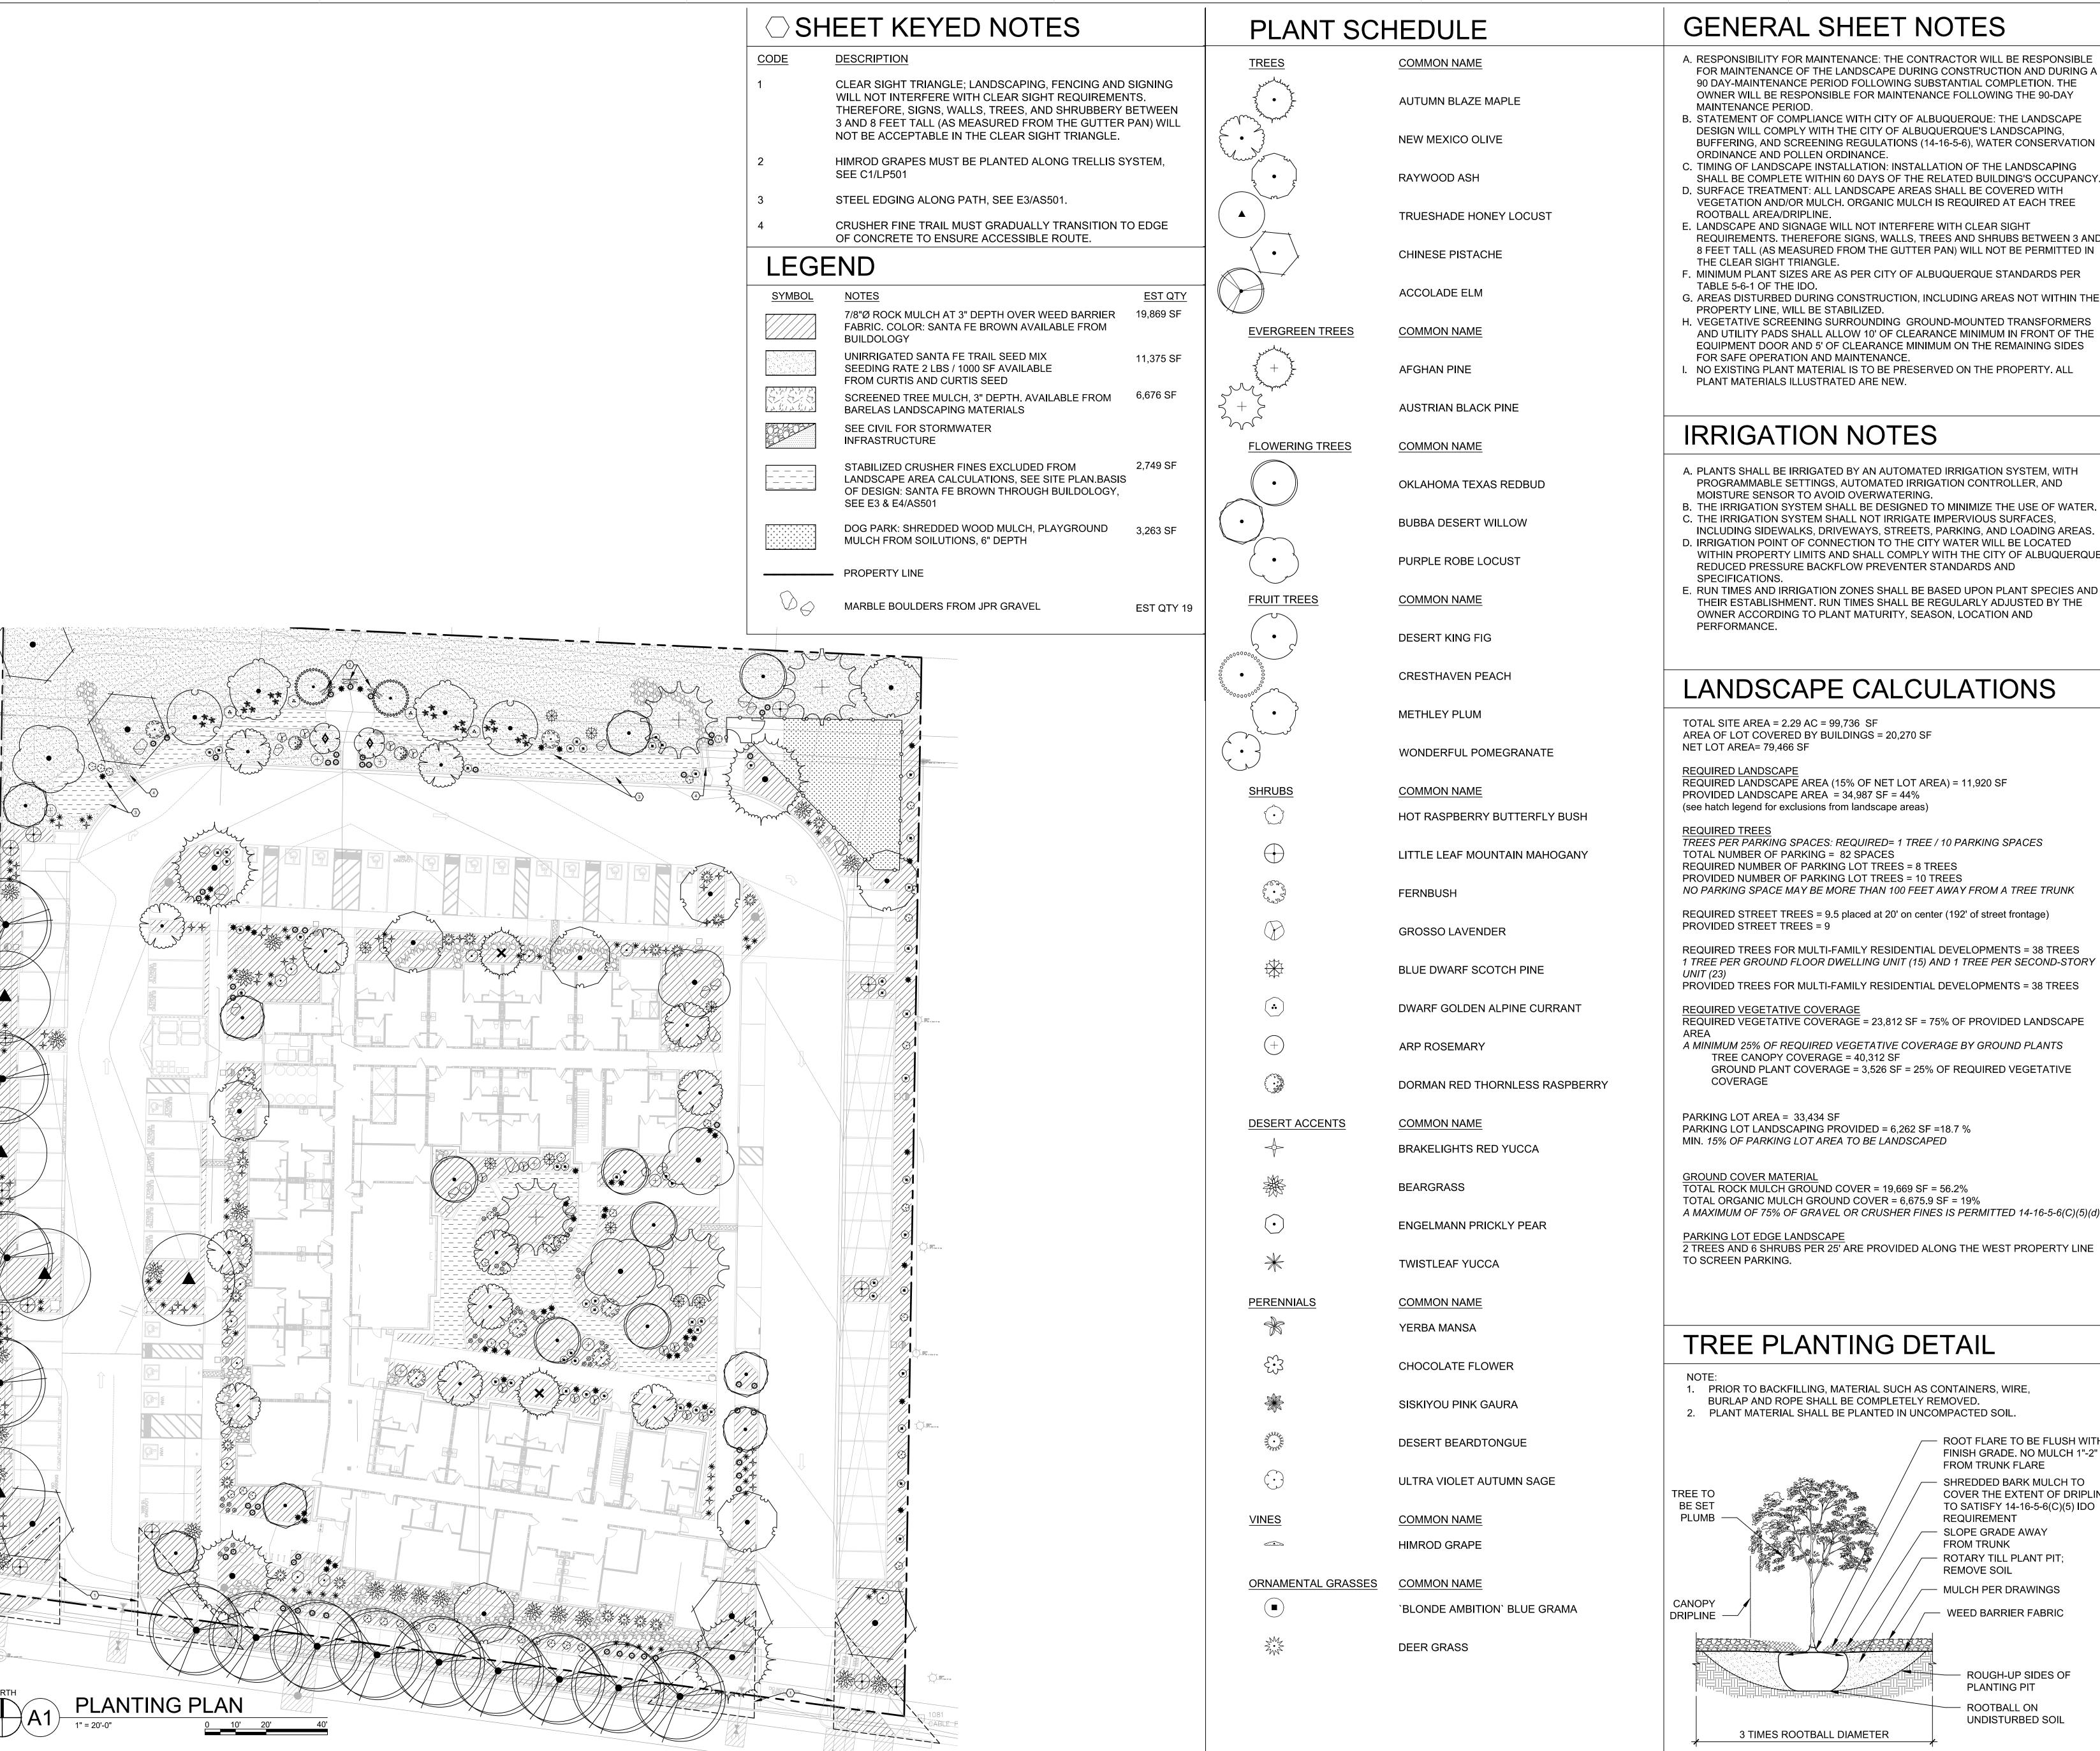

GENERAL SHEET NOTES

- A. RESPONSIBILITY FOR MAINTENANCE: THE CONTRACTOR WILL BE RESPONSIBLE FOR MAINTENANCE OF THE LANDSCAPE DURING CONSTRUCTION AND DURING A 90 DAY-MAINTENANCE PERIOD FOLLOWING SUBSTANTIAL COMPLETION. THE OWNER WILL BE RESPONSIBLE FOR MAINTENANCE FOLLOWING THE 90-DAY MAINTENANCE PERIOD.
- B. STATEMENT OF COMPLIANCE WITH CITY OF ALBUQUERQUE: THE LANDSCAPE DESIGN WILL COMPLY WITH THE CITY OF ALBUQUERQUE'S LANDSCAPING, BUFFERING, AND SCREENING REGULATIONS (14-16-5-6), WATER CONSERVATION
- ORDINANCE AND POLLEN ORDINANCE. C. TIMING OF LANDSCAPE INSTALLATION: INSTALLATION OF THE LANDSCAPING SHALL BE COMPLETE WITHIN 60 DAYS OF THE RELATED BUILDING'S OCCUPANCY. D. SURFACE TREATMENT: ALL LANDSCAPE AREAS SHALL BE COVERED WITH
- ROOTBALL AREA/DRIPLINE. E. LANDSCAPE AND SIGNAGE WILL NOT INTERFERE WITH CLEAR SIGHT REQUIREMENTS. THEREFORE SIGNS, WALLS, TREES AND SHRUBS BETWEEN 3 AND 8 FEET TALL (AS MEASURED FROM THE GUTTER PAN) WILL NOT BE PERMITTED IN
- THE CLEAR SIGHT TRIANGLE. F. MINIMUM PLANT SIZES ARE AS PER CITY OF ALBUQUERQUE STANDARDS PER
- TABLE 5-6-1 OF THE IDO. G. AREAS DISTURBED DURING CONSTRUCTION, INCLUDING AREAS NOT WITHIN THE PROPERTY LINE, WILL BE STABILIZED.
- H. VEGETATIVE SCREENING SURROUNDING GROUND-MOUNTED TRANSFORMERS AND UTILITY PADS SHALL ALLOW 10' OF CLEARANCE MINIMUM IN FRONT OF THE EQUIPMENT DOOR AND 5' OF CLEARANCE MINIMUM ON THE REMAINING SIDES FOR SAFE OPERATION AND MAINTENANCE.
- I. NO EXISTING PLANT MATERIAL IS TO BE PRESERVED ON THE PROPERTY. ALL PLANT MATERIALS ILLUSTRATED ARE NEW.

IRRIGATION NOTES

- A. PLANTS SHALL BE IRRIGATED BY AN AUTOMATED IRRIGATION SYSTEM, WITH PROGRAMMABLE SETTINGS, AUTOMATED IRRIGATION CONTROLLER, AND MOISTURE SENSOR TO AVOID OVERWATERING.
- B. THE IRRIGATION SYSTEM SHALL BE DESIGNED TO MINIMIZE THE USE OF WATER. C. THE IRRIGATION SYSTEM SHALL NOT IRRIGATE IMPERVIOUS SURFACES, INCLUDING SIDEWALKS, DRIVEWAYS, STREETS, PARKING, AND LOADING AREAS. D. IRRIGATION POINT OF CONNECTION TO THE CITY WATER WILL BE LOCATED
- WITHIN PROPERTY LIMITS AND SHALL COMPLY WITH THE CITY OF ALBUQUERQUE REDUCED PRESSURE BACKFLOW PREVENTER STANDARDS AND SPECIFICATIONS. E. RUN TIMES AND IRRIGATION ZONES SHALL BE BASED UPON PLANT SPECIES AND THEIR ESTABLISHMENT. RUN TIMES SHALL BE REGULARLY ADJUSTED BY THE

LANDSCAPE CALCULATIONS

TOTAL SITE AREA = 2.29 AC = 99,736 SF AREA OF LOT COVERED BY BUILDINGS = 20,270 SF NET LOT AREA= 79,466 SF

REQUIRED LANDSCAPE REQUIRED LANDSCAPE AREA (15% OF NET LOT AREA) = 11,920 SF

PROVIDED LANDSCAPE AREA = 34,987 SF = 44% (see hatch legend for exclusions from landscape areas)

TREES PER PARKING SPACES: REQUIRED= 1 TREE / 10 PARKING SPACES TOTAL NUMBER OF PARKING = 82 SPACES REQUIRED NUMBER OF PARKING LOT TREES = 8 TREES PROVIDED NUMBER OF PARKING LOT TREES = 10 TREES NO PARKING SPACE MAY BE MORE THAN 100 FEET AWAY FROM A TREE TRUNK

REQUIRED STREET TREES = 9.5 placed at 20' on center (192' of street frontage) PROVIDED STREET TREES = 9

REQUIRED TREES FOR MULTI-FAMILY RESIDENTIAL DEVELOPMENTS = 38 TREES 1 TREE PER GROUND FLOOR DWELLING UNIT (15) AND 1 TREE PER SECOND-STORY

PROVIDED TREES FOR MULTI-FAMILY RESIDENTIAL DEVELOPMENTS = 38 TREES

REQUIRED VEGETATIVE COVERAGE

REQUIRED VEGETATIVE COVERAGE = 23,812 SF = 75% OF PROVIDED LANDSCAPE

A MINIMUM 25% OF REQUIRED VEGETATIVE COVERAGE BY GROUND PLANTS TREE CANOPY COVERAGE = 40,312 SF GROUND PLANT COVERAGE = 3,526 SF = 25% OF REQUIRED VEGETATIVE

COVERAGE


PARKING LOT AREA = 33,434 SF PARKING LOT LANDSCAPING PROVIDED = 6,262 SF =18.7 % MIN. 15% OF PARKING LOT AREA TO BE LANDSCAPED

GROUND COVER MATERIAL TOTAL ROCK MULCH GROUND COVER = 19,669 SF = 56.2% TOTAL ORGANIC MULCH GROUND COVER = 6,675.9 SF = 19%

A MAXIMUM OF 75% OF GRAVEL OR CRUSHER FINES IS PERMITTED 14-16-5-6(C)(5)(d) PARKING LOT EDGE LANDSCAPE

TREE PLANTING DETAIL

1. PRIOR TO BACKFILLING, MATERIAL SUCH AS CONTAINERS, WIRE, BURLAP AND ROPE SHALL BE COMPLETELY REMOVED. 2. PLANT MATERIAL SHALL BE PLANTED IN UNCOMPACTED SOIL

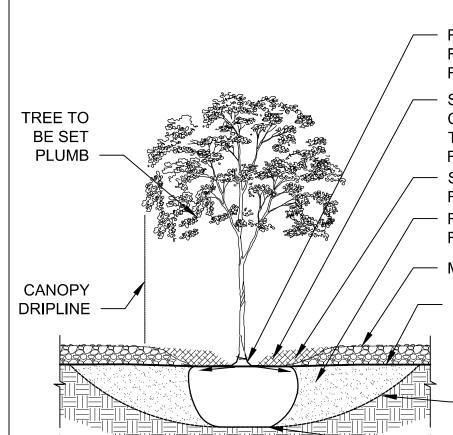

3 TIMES ROOTBALL DIAMETER

ROOT FLARE TO BE FLUSH WITH FINISH GRADE. NO MULCH 1"-2" FROM TRUNK FLARE — SHREDDED BARK MULCH TO COVER THE EXTENT OF DRIPLINE TO SATISFY 14-16-5-6(C)(5) IDO REQUIREMENT SLOPE GRADE AWAY FROM TRUNK ROTARY TILL PLANT PIT; **REMOVE SOIL** - MULCH PER DRAWINGS

WEED BARRIER FABRIC

ROOTBALL ON

UNDISTURBED SOIL

ROUGH-UP SIDES OF PLANTING PIT

DEKKER PERICH SABATINI

ARCHITECTURE DESIGN **INSPIRATION**

ARCHITECT



ENGINEER

PROJECT


APPLICATION TO **DESIGN REVIEW** BOARD (DRB)

REVISIONS

DRAWN BY **REVIEWED BY** 08/18/2023 DATE 22-0083 PROJECT NO. DRAWING NAME

PLANTING PLAN

SHEET NO. LP101

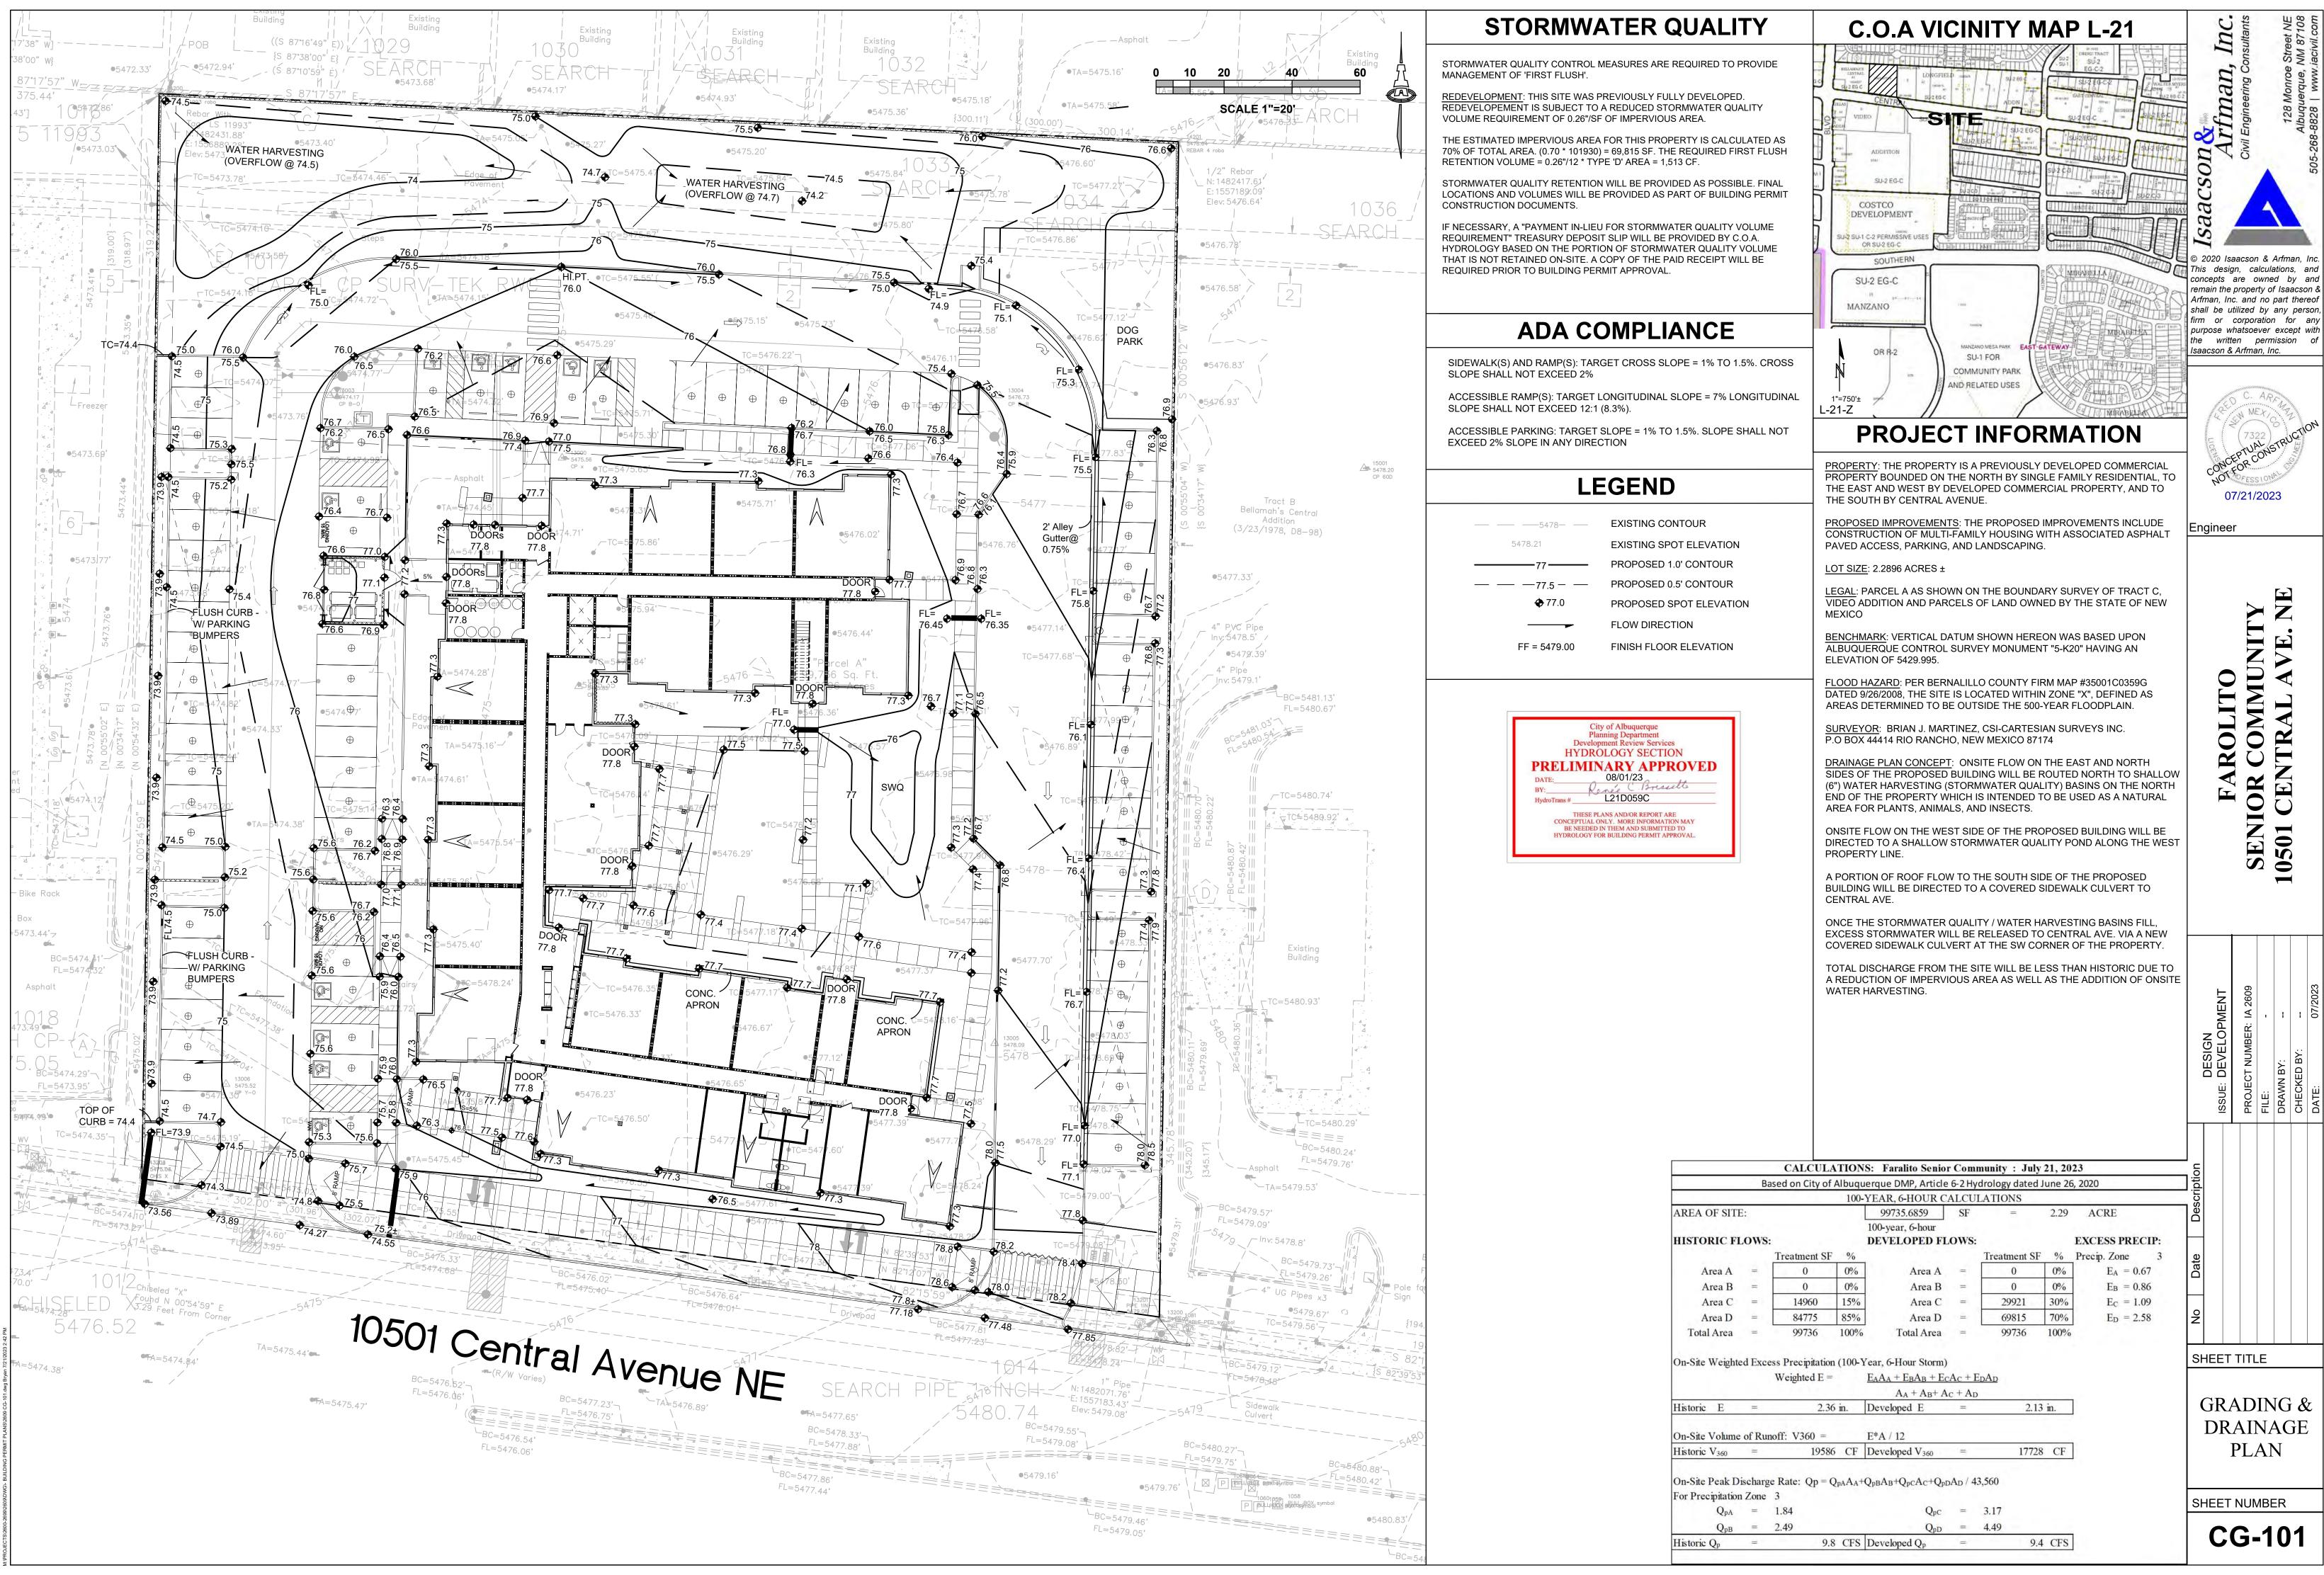

FIRE LINE

POST INDICATOR VALVE

└ X" GATE VALVE

SCALE: N.T.S.

4"-45° BEND ----

Know what's **below. Call** before you dig.

SERVICE LINE

SCALE: N.T.S.

- 8",6",4"x4" WYE

DOUBLE CLEANOUT

KEYED NOTES

WATER KEYED NOTES

- 1. REMOVE EXISTING 8" CAP AND CONNECT NEW 8" WATERLINE.
- 2. 8" x 6" TEE.
- 3. 8" x 6" REDUCER.
- 4. 6" 11 ½° BEND. (LT=3')
- 5. 6" 45° BEND. (LT=9')
- 6. PRIVATE 6" GATE VALVE W/ BOX. (LT=46') PER ABCWUA STD DWG 2326, 2328 & 2329
- 7. PRIVATE FIRE HYDRANT PER ABCWUA STD DWG 2340.
- PAINTED SAFETY ORANGE.

8. PIV (POST INDICATOR VALVE).

- 9. $\frac{3}{4}$ " ELECTRICAL CONDUIT W/ PULL STRING FROM PIV
- 10. WALL MOUNT FDC (FIRE DEPARTMENT CONNECTION).
- 11. REMOVE 2 EXISTING 2" CAPS AND MANIFOLD TOGETHER INTO 1 - 3" WATER SERVICE LINE.

SEWER KEYED NOTES

- 20. INSTALL 4' DIA. TYPE E MANHOLE PER ABCWUA STD DWGS #2102 & #2109.
- 21. 8" SANITARY SEWER SERVICE AT 8.44% (2% MIN. SLOPE).
- 22. INSTALL DOUBLE CLEAN OUT PER DETAIL THIS SHEET.
- 23. SEE MECHANICAL PLAN FOR CONTINUATION. (INV.=5472.0)

DRY UTILITY KEYED NOTES

- 30. ELECTRIC LINE, SEE SITE ELECTRIC PLAN.
- 31. GAS LINE, SIZE TO BE DETERMINED.
- 32. EXTERNAL GAS METER WITH FULL-BORE GAS SHUT OFF VALVE DOWN STREAM OF GAS METER.

ABCWUA CONNECTION PERMIT ITEMS (NOT PART OF THIS PLAN)

- 40. PUBLIC WATERLINE AND 8" GATE VALVES W/BOX, PART OF PRIVATE FIRE SUPPRESSION LINE CONNECTION TO 10" PUBLIC WATER LINE.
- 41. 2 NEW PUBLIC 2" WATER METERS
- 42. REMOVE AND DISPOSE EXISTING WATER METER BOX, CLOSE CORP STOP AT
- 43. 4' SANITARY SEWER MANHOLE AND NEW 8" SERVICE LINE TO ROW.

GENERAL NOTES

- A. EXISTING UTILITY LINES ARE SHOWN IN AN APPROXIMATE MANNER ONLY AND MAY BE INCOMPLETE OR OBSOLETE. SUCH LINES MAY OR MAY NOT EXIST WHERE SHOWN OR NOT SHOWN. ALL UTILITIES SHOULD BE FIELD VERIFIED AND LOCATED BY THE CONTRACTOR PRIOR TO COMMENCEMENT OF ANY CONSTRUCTION. THE CONTRACTOR IS FULLY RESPONSIBLE FOR ANY AND ALL DAMAGE CAUSED BY ITS FAILURE TO LOCATE, IDENTIFY AND PRESERVE ANY AND ALL EXISTING UTILITIES, PIPELINES, AND UNDERGROUND UTILITY LINES.
- B. CONTRACTOR SHALL NOT USE VIBRATORY COMPACTION EQUIPMENT OR HEAVY VEHICLES OVER EXISTING UTILITIES.
- C. SITE STORM DRAIN, ELECTRIC LINES & TRANSFORMERS AND GAS LINES ARE SHOWN FOR GENERAL INFORMATION ONLY TO PROVIDE AN OVERVIEW OF SITE UTILITIES AND POTENTIAL CONFLICTS. SEE MECHANICAL PLANS FOR GAS LINE SIZING. SEE CG-101 FOR STORM DRAIN DESIGN.
- D. ALL WATER FITTINGS SHALL HAVE JOINT RESTRAINTS (LT). SEE RESTRAINED JOINT CRITERIA NOTES THIS SHEET. (LT) LENGTH SHOWN ON KEYED NOTES.
- E. ALL ABOVE GROUND UTILITY EQUIPMENT AND FITTINGS SHALL BE PAINTED IN COLORS TO MATCH BUILDING COLORS.
- F. WATERLINES 4" IN DIAMETER OR LARGER SHALL BE PVC PIPE MEETING
- AWWA C900 DR-18 REQUIREMENTS. G. SANITARY SEWER LINE MATERIALS SHALL BE PVC SDR-35 PIPE.
- H. COORDINATION WITH WATER AUTHORITY CROSS CONNECTION SECTION WILL BE REQUIRED TO ENSURE PROPER BACKFLOW CONTAINMENT IS IN PLACE PRIOR TO RELEASE OF METER FOR THE SITE. CONTACT THE CROSS CONNECTION SECTION AT 505-289-3454.
- J. COORDINATION WITH THE WATER AUTHORITY PRE-TREATMENT ENGINEER IS REQUIRED TO ENSURE THE SITE COMPLIES WITH WATER AUTHORITY SEWER USE ORDINANCE. CONTACT THE PRE-TREATMENT ENGINEER AT 505-289-3439.

RESTRAINED JOINT CRITERIA FOR WATERLINE FITTINGS

- 1. ALL MECHANICAL JOINTS SHALL BE RESTRAINED AT THE FITTINGS PER KEYED NOTES THIS SHEET.
- 2. THE CONTRACTOR SHALL PROVIDE A MINIMUM PIPE LENGTH OF 20 LF FROM ALL MECHANICAL JOINTS. ALL PIPE JOINTS WITHIN 20 LF OF A MECHANICAL JOINT SHALL BE RESTRAINED AT THE CONTRACTOR'S EXPENSE.
- 3. THE CONTRACTOR SHALL RESTRAIN ALL PIPE JOINTS IN THE SPECIFIED DISTANCE LISTED IN THE KEYED NOTES.
- 4. THE CONTRACTOR SHALL RESTRAIN ALL FIRE HYDRANT JOINTS FROM THE TEE ON THE MAIN TO THE FIRE HYDRANT FLANGE.


DEPTH OF BURY: 3.0 FT. MINIMUM MATERIAL:

SOIL TYPE: GM/SM - SILTY GRAVELS AND SILTY SANDS, GRAVEL-SAND-SILT MIXTURES.

TEST PRESSURE: 150 PSI

TRENCH TYPE 4: PIPE BEDDED IN SAND, GRAVEL, OR CRUSHED STONE TO DEPTH OF 1/8 PIPE DIAMETER, 4 INCH MINIMUM; BACKFILL COMPACTED TO TOP OF PIPE.

DIFFERENT CRITERIA, E.G., GREATER DEPTH OF BURY, ETC., WILL REQUIRE DIFFERENT RESTRAINED LENGTHS. THESE MUST BE CALCULATED BY A QUALIFIED PROFESSIONAL ENGINEER AND APPROVED BY ABCWUA.

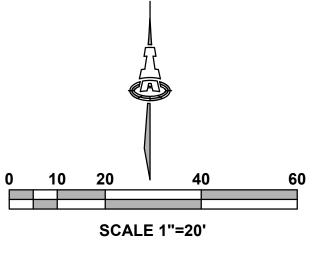

LEGEND

	O L I I D
	EXISTING WATERLINE
\triangleleft	EXISTING FIRE HYDANT
\bowtie	EXISTING WATER VALVE
	EXISTING SEWER LINE
	EXISTING SEWER MANHOLE
	NEW FIRE LINE
H	NEW WATER VALVE
•	NEW FIRE HYDANT
\	NEW FDC
Θ	NEW PIV
	NEW SEWER LINE
\bowtie	PUBLIC WATER VALVE
\triangleleft	PUBLIC FIRE HYDANT
(LT=X')	DISTANCE JOINTS TO BE RESTRAINED FROM


FITTING OR VALVE



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Architecture

in Progress

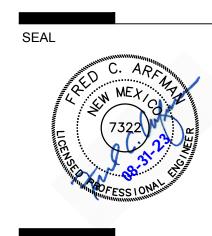

PROJECT

LINNWWO VENUE NM 871 SENIOR

ISSUED FOR PERMIT

REVISIONS

DRAWN BY JTS/BJB/DEC **REVIEWED BY** FCA/IMA DATE 09/01/2023 PROJECT NO. IA 2609 22-0083

DRAWING NAME


PLAN

CU101

UTILITY



Architecture in Progress

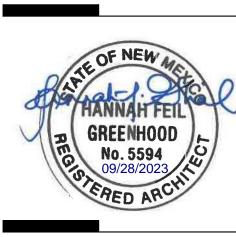

PROJECT

10501 CENTRAL A ALBUQUERQUE,

ISSUED FOR **PERMIT**

REVISIONS DRAWN BY CWW **REVIEWED BY** DATE 05/14/23 PROJECT NO: 22-0083

DRAWING NAME

EXTERIOR ELEVATIONS -SOUTH AND WEST

SHEET NO

SDP 4.1




Architecture in Progress



PROJECT

ISSUED FOR **PERMIT**

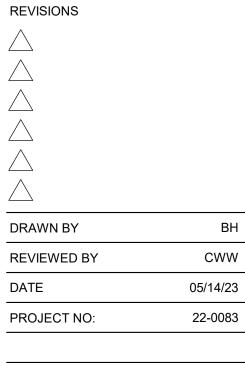

DRAWING NAME

EXTERIOR ELEVATIONS -NORTH AND EAST

SHEET NO

SDP 4.2

COMPLETED SITE PLAN CHECKLIST

Project #: _____ Application #: _____

This checklist will be used to verify the completene Department. Because development proposals vary in that are not specified here. Also there may additional VPO or if located in DT-UC-MS or PT areas. See the responsible for providing a complete submittal. Certification	n type and scale, there m al requirements if a site is IDO or AGIS for boundari	ay be submittal requirements located in CPO, HPO, and/or es. Nonetheless, applicants are
I CERTIFY THAT THE SUBMITTED SITE PLAN IS COMPLETE SPECIFIED IN THIS CHECKLIST IS PROVIDED. FURTHER, PROVISIONALLY AND THAT INACCURATE AND/OR INCORPEDITION OF THE APPLICATION OR IN	I UNDERSTAND THAT THIS	S APPLICATION IS BEING ACCEPTED
A DELAY OF ONE MONTH OR MORE IN THE DATE THE APPLICATION IS SCHEDULED FOR PUBLIC HEARING.	(hh	09/29/2023

Applicant or Agent Signature / Date

Site plan packets shall be composed of the following plan sheets (unless otherwise approved in writing prior to submittal by the Planning Department):

- **1. Site Plan (**including utilities and easements)
- 2. Landscaping Plan
- 3. Grading and Drainage Plan
- 4. Utility Plan
- 5. Building and Structure Elevations
- 6. Previously approved Development Plan (if applicable)

The electronic format must be organized in the above manner.

The following checklist describes the minimum information necessary for each plan element. The Applicant must include all checklist items on their site plan drawings and confirm inclusion by checking off the items below. Non-applicable items must be labeled "N/A." Each non-applicable designation must be explained by notation on the Checklist.

NOTE: There may be addition information required if site is located with a CPO, VPO or HPO and/or any other special areas as defined by the IDO.

NOTE: If there requests for deviations (Section 14-16-6-4(O), they must be clearly labelled on the site plan (Sheet 1) as well as addressed in the application letter made with the submittal.

SHEET #1 - SITE PLAN

A. General Information

<u>X</u> 1. Date of drawing and/or last revision

<u>X</u> 2. Scale: 1.0 acre or less 1" = 10' 1.0 - 5.0 acres 1" = 20' Over 5 acres 1" = 50'

Over 20 acres 1" = 100'

- X 3. Bar scale
- X 4. North arrow
- <u>x</u> 5. Legend
- <u>x</u> 6. Scaled vicinity map
- X 7. Property lines (clearly identify)
- X 8. Existing and proposed easements (identify each)
- NA₉. Phases of development, if applicable

B. Proposed Development

1. Structural

- <u>x</u> A. Location of existing and proposed structures (distinguish between existing & proposed) and include any accessory structures
- <u>x</u> B. Square footage of each structure
- x C. Proposed use of each structure
- x D. Signs (freestanding) and other improvements
- X E. Walls, fences, and screening: indicate height, length, color and materials
- <u>x</u> F. Dimensions of all principal site elements or typical dimensions
- X G. Loading facilities
- x H. Site lighting (indicate height & fixture type)
- X I. Indicate structures within 20 feet of site
- <u>x</u> J. Elevation drawing of refuse container and enclosure, if applicable.
- <u>x</u> K. Existing zoning/land use of all abutting properties

2. Parking, Loading and Internal Circulation

- X A. Parking layout with spaces numbered per aisle and totaled.
 - <u>X</u> 1. Location and typical dimensions, including motorcycle spaces, bicycle spaces, ADA accessible spaces, and compact spaces
 - <u>X</u> 2. Calculations: spaces required and proposed (include any reduction calculations) for motorcycle, bicycle, compact and ADA spaces
 - X_3. On street parking spaces
- <u>X</u> B. Bicycle parking & facilities
 - X 1. Bicycle racks location and detail
 - \underline{X} 2. Other bicycle facilities, if applicable
- <u>x</u> C. Vehicular Circulation (Refer to DPM and IDO)
 - X 1. Ingress and egress locations, including width and curve radii dimensions
 - X 2. Drive aisle locations, including width and curve radii dimensions
 - <u>X</u> 3. End aisle locations, including width and curve radii dimensions
 - <u>x</u> 4. Location & orientation of refuse enclosure, with dimensions
 - <u>X</u> 5. Loading, service area, and refuse service locations and dimensions
- <u>x</u> D. Pedestrian Circulation
 - <u>X</u> 1. Location and dimensions of all sidewalks and pedestrian paths (including ADA connection from ROW to building and from ADA parking to building)

X 2. Location and dimension of drive aisle crossings, including paving treatment X 3. Location and description of amenities, including patios, benches, tables, etc.
 NA E. Off-Street Loading ___ 1. Location and dimensions of all off-street loading areas
 NA F. Vehicle Stacking and Drive-Through or Drive-Up Facilities ___ 1. Location and dimensions of vehicle stacking spaces and queuing lanes ___ 2. Landscaped buffer area if drive-through lanes are adjacent to public R/W ___ 3. Striping and Sign details for one-way drive through facilities

3. Streets and Circulation

- X A. Locate and identify adjacent public and private streets and alleys.
 - <u>x</u> 1. Existing and proposed pavement widths, right-of-way widths and curve radii
 - <u>x</u> 2. Identify existing and proposed turn lanes, deceleration lanes and similar features related to the functioning of the proposal, with dimensions
 - X 3. Location of traffic signs and signals related to the functioning of the proposal
 - <u>x</u> 4. Identify existing and proposed medians and median cuts
 - <u>X</u> 5. Sidewalk widths and locations, existing and proposed
 - <u>x</u> 6. Location of street lights
 - X 7. Show and dimension clear sight triangle at each site access point
 - <u>x</u> 8. Show location of all existing driveways fronting and near the subject site.
- X B. Identify Alternate transportation facilities within site or adjacent to site
 - X 1. Bikeways and bike-related facilities
 - X 2. Pedestrian trails and linkages
 - X 3. Transit facilities, including routes, bus bays and shelters existing or required

4. Phasing

<u>NA</u> A. Proposed phasing of improvements and provision for interim facilities. Indicate phasing plan, including location and square footage of structures and associated improvements including circulation, parking and landscaping.

SHEET #2 - LANDSCAPING PLAN

- X 1. Scale must be same as scale on sheet #1 Site plan
- _X 2. Bar Scale
- _x 3. North Arrow
- _X 4. Property Lines
- X 5 Existing and proposed easements
- <u>x</u> 6. Identify nature of ground cover materials
 - X A. Impervious areas (pavement, sidewalks, slope pavings, curb and gutters, etc.)
 - X B. Pervious areas (planting beds, gravel areas, grass, ground cover vegetation, etc.)
 - <u>X</u> C. Ponding areas either for drainage or landscaping/recreational use

- X 7. Identify type, location and size of plantings (common and/or botanical names).
 - X A. Existing, indicating whether it is to preserved or removed.
 - <u>x</u> B. Proposed, to be established for general landscaping.
 - <u>X</u> C. Proposed, to be established for screening/buffering.
- X 8. Describe irrigation system Phase I & II . . .
- <u>x</u> 9. Planting Beds, indicating square footage of each bed
- _X 10. Turf Area only 20% of landscaped area can be high water turf; provide square footage and percentage.
- <u>X</u> 11. Responsibility for Maintenance (statement)
- x 12. Landscaped area requirement; square footage and percent (specify clearly on plan)
- _X 13. Landscaped buffer areas provided; dimensions, label clearly that it is a landscape buffer, square footage and percent (specify clearly on plan)
- X 14. Planting or tree well detail
- <u>x</u> 15. Street Trees (only trees from the Official Albuquerque Plant Palette and Sizing list or 8 inch caliper or larger will be counted)
- <u>x</u> 16. Parking lot edges and interior calculations, dimensions and locations including tree requirements
- X 17. Show Edge Buffer Landscaping (14-16-5-6(D)) location, dimensions and plant material

SHEET #3 -GRADING AND DRAINAGE PLAN

A separate grading and drainage plan (and drainage report) must be submitted to the DRS Hydrology Section prior to the DRB submittal for a site plan (See DRWS Form).

A. General Information

- x 1. Scale must be same as Sheet #1 Site Plan
- _x_ 2. Bar Scale
- _x_ 3. North Arrow
- _X 4. Property Lines
- x 5. Existing and proposed easements
- <u>x</u> 6. Building footprints
- _x _ 7. Location of Retaining walls

B. Grading Information

- _X 1. On the plan sheet, provide a narrative description of existing site topography, proposed grading improvements and topography within 100 feet of the site.
- X 2. Indicate finished floor elevation and provide spot elevations for all corners of the site (existing and proposed) and points of maximum cut or fill exceeding 1 foot.
- <u>X</u> 3. Identify ponding areas, erosion and sediment control facilities.
- _x_ 4. Cross Sections

Provide cross section for all perimeter property lines where the grade change is greater than 4 feet at the point of the greatest grade change. Provide one additional cross section in each direction within no more than 100 feet of the reference point.

SHEET #4- UTILITY PLAN

- X A. Fire hydrant locations, existing and proposed. (or submit signed off Fire One Plan)
- X B. Distribution lines
- X C. Right-of-Way and easements, existing and proposed, on the property and adjacent to the boundaries, with identification of types and dimensions.
- X D. Existing water, sewer, storm drainage facilities (public and/or private).
- <u>x</u> E. Proposed water, sewer, storm drainage facilities (public and/or private)
- X F. Existing electric lines both overhead and underground. Power Poles shown with dimensions to proposed buildings and structures must be clearly shown.

SHEET #5 - BUILDING AND STRUCTURE ELEVATIONS

A. General Information

- X A. Scale
- X B. Bar Scale
- X C. Detailed Building Elevations for each facade
 - X 1. Identify facade orientation
 - X 2. Dimensions of facade elements, including overall height and width
 - X 3. Location, material and colors of windows, doors and framing
 - <u>x</u> 4. Materials and colors of all building elements and structures
 - <u>X</u> 5. Location and dimensions of mechanical equipment (roof and/or ground mounted)

B. Building Mounted Signage

- X 1. Site location(s)
- X 2. Sign elevations to scale
- X 3. Dimensions, including height and width
- X 4. Sign face area dimensions and square footage clearly indicated
- X 5. Lighting
- <u>X</u> 6. Materials and colors for sign face and structural elements.
- X 7. List the sign restrictions per the IDO

AUTHORIZATION LETTER



Stephanie Garcia Richard COMMISSIONER

State of New Mexico Commissioner of Public Lands

310 OLD SANTA FE TRAIL P.O. BOX 1148 SANTA FE, NEW MEXICO 87504-1148 COMMISSIONER'S OFFICE

Phone (505) 827-5760 Fax (505) 827-5766 www.nmstatelands.org

September 21, 2023

Mr. Anthony Santi Dekker Perich Sabatini 7601 Jefferson NE, Suite 100 Albuquerque, NM 87109

RE: Project Site Address: 10501 CENTRAL AVE NE, ALBUQUERQUE, NM 87123, aka, Parcel A as shown on the Boundary Survey of Tract C, Video Addition and Parcels of Land Owned by the State of New Mexico Situated Within the NW 1/4 NW 1/4 sec. 28, T10N, R4E, NMPM, April 2016, recorded with the County Clerk of Bernalillo County on February 12, 2020 as Doc. No. 2020013489, containing 2.2856 acres, more or less.

Mr. Santi:

On September 20, 2023, I received a call from you requesting our support in your efforts to entitle the subject property on behalf of our Lessee. The State Land Office is not a zoning authority and state trust lands are not technically subject to municipal zoning. The State Land Office does appreciate, however, the important role zoning plays in ensuring land development occurs consistent with community needs and desires. As such, as a matter of practice the agency generally requires lessees to follow municipal zoning. Paragraph 21 of the Lease, requires this:

21. COMPLIANCE WITH LAWS. Lessee shall fully comply at its own expense with all federal state, and local laws, regulations, rules, ordinances and requirements, applicable to the Leased Premises or to Lessee's operations thereon, including but not limited to all applicable laws governing water; endangered or threatened species; Hazardous Materials; environmental protection; land use; health and safety; cultural, historic or archeological / paleontological properties; and all New Mexico State Land Office Rules and Regulations, including those that may be promulgated hereafter. Lessee's obligations under this Paragraph include but are not limited to compliance with NMSA 1978 Section 19-6-5, requiring a lessee of State Trust Land to protect the Leased Premises from waste or trespass.

At the beginning of 2023, the New Mexico State Land Office entered into a long-term lease with the

Farolito Apartments Limited Partnership LLLP (Farolito). The approved use in the agreement is affordable housing.

As such, we support negotiations and processes between the City of Albuquerque and Farolito to meet those ends which will allow the approved use. If you or anyone at the City of Albuquerque has any questions for the New Mexico State Land Office in regards to this matter, please do not hesitate calling me.

Sincerely,

Jim Bordegaray

Director, Commercial Resources Division

(505) 827-5777

jbordegaray@slo.state.nm.us

cc: Felipe Rael, Executive Director, Greater Albuquerque Housing Partnership

JUSTIFICATION LETTER

September 29, 2023

Jay Rodenbeck, Development Facilitation Team City of Albuquerque Planning Department 600 2nd St., Plaza del Sol Albuquerque, NM 87106



Re: Farolito Senior Community - Mixed-use Multifamily

Dear Mr. Rodenbeck,

Dekker Perich Sabatini, as the agent for Farolito Apartments Limited Partnership LLLP

By: Farolito Senior LLC its General Partner

By: Greater Albuquerque Housing Partnership,

is seeking approval of a Site Plan Administrative for a new multifamily development located at 10501 Central Ave. NE. The proposed development would include 82 apartment units, and amenities including a dog park, outdoor gathering areas, and indoor gathering space. The apartment building will include a mix of one-bedroom and two-bedroom units.

The subject property is an approximately 2.2 acre parcel on Central Ave. between Eubank and Juan Tabo. The subject property is zoned MX-H: Mixed-Use High Intensity in an area of change and along a major transit corridor.

The proposed development consists of one four-story building. The building is designed in a Contemporary Southwest style with an emphasis on simplicity in geometric forms and in expression of materials. The "push and pull" of building massing is used to achieve multiple volumetric forms with a pleasing visual rhythm. The building is defined by clean lines, sharp corners, and straight parapets which serve to screen equipment on the flat roofs. The building includes recessed openings, muted desert colors, and pops of more vibrant color for visual interest.

Per IDO Section 6-5(G)(1)(f), the proposed development is subject to the Site Plan – Administrative procedures and review and decision criteria. The proposed site plan complies with the criteria of IDO Section 6-5(G)(3) Review and Decision Criteria for Site Plan – Administrative as outline below. The criteria are bolded, and the responses are italicized.

6-5(G)(3)(a) The Site Plan complies with all applicable standards in this IDO, the DPM, other adopted City regulations, and any conditions specifically applied to development of the property in a prior permit or approval affecting the property.

The proposed site plan complies with all applicable standards in the IDO, the DPM, and other adopted city regulations as required. There are no other prior approvals affecting the property.

6-5(G)(3)(b) The City's existing infrastructure and public improvements, including but not limited to its street, trail, drainage, and sidewalk systems, have adequate capacity to serve the proposed development or the applicant has agreed to install required infrastructure and public improvements pursuant to Subsection 14-16-1-7(B)(2) and 14-16-5-4(N) and/or a signed an Infrastructure Improvements Agreement (IIA) pursuant to Subsection 14-16-5-4(O) to add adequate capacity.

6-5(G)(3)(c) If the subject property is within an approved Master Development Plan, the Site Plan shall meet any relevant standards in the Master Development Plan in addition to any IDO standards applicable in the zone district the subject property is in.

The subject property does not fall within the boundaries of any approved Master Development Plan; therefore this criterion is not applicable.

6-5(G)(3)(d) If the subject property is within an approved Framework Plan, the Site Plan shall meet any relevant standards in the Framework Plan in addition to any IDO standards applicable to the type of development.

The subject property does not fall within the boundaries of any approved Framework Plan; therefore this criterion is not applicable.

Based on the rationale presented in this letter, we respectfully request approval of the proposed site plan. If you have any questions or need clarification, please contact me at anthonys@dpsdesign.org or at (505)761-9700.

Sincerely,

Anthony Santi

Dekker Perich Sabatini

09 SIGN POSTING AGREEMENT

<u>DFT SIGN POSTING AGREEMENT – A PUBLIC NOTICE REQUIREMENT</u>

All development applications are required to complete public notice under the Integrated Development Ordinance, Section 6-1, Table 6-1-1. https://www.cabq.gov/planning/codes-policies-regulations/integrated-development-ordinance-1 All applicants are obligated to satisfy all of the public notice requirements, i.e., sending email notifications, mailing notices, and posting signage on the subject property. **This form covers posting signs.** Adherence to sign posting requirements will inform the public of a proposed project and relevant project details.

Signs should be picked up at the Development Review Services office, located at 600 2nd St in the Plaza Del Sol building. Signs are available upon the acceptance of the application. The cost for the signs is included in the project application fee. It is critical that the signs be prominently located and clearly visible without any obstructions from each street frontage.

Applicants are responsible to maintain posting from time of application through the appeal period (15 days following a final decision on the application). Signs must be posted within 3 days of application acceptance and remain for at least 15 days. Evidence of the sign posting must also be provided within 3 days. In addition, applicants must ensure that required signs are in place during the 15-day appeal period after the project approval. Evidence of posting includes: Time stamped photographs of the sign at the location must be submitted as a supplement to the application.

Failure to install or replace the signs during the required timeframe may result in your application being deferred.

LOCATION

- A. The sign shall be conspicuously located, i.e, within twenty feet of the public sidewalk (or edge of a street).
- B. The face of the sign shall be parallel to the street.
- C. No barrier shall prevent a person from coming within five feet of the sign to read it.

NUMBER

- A. One sign shall be posted on each street frontage.
- B. If the land does not abut a public street, a sign shall be placed at the edge of the public right-of-way of the nearest paved street, in addition to the sign placed on the property.

PHYSICAL POSTING

- A. A heavy stake with two crossbars or a full plywood backing works best to keep the sign in place, especially during high winds.
- B. Large nails or staples are best for attaching signs to a post or backing; the sign tears out less easily.

I have read and understand all of the public notice requirements. By my signature, I acknowledge that: I understand (A) I have read the sign posting requirements; (B) I understand my obligation to keep the signs posted for (15) days at the time of application, and (15) days after application approval, (C) where/how the sign(s) should be posted, and (D) agree to provide evidence of posting.

I further certify that the required public notice signs were posted per the instructions above.

SIGNATURE & DATE:	Cha	09/29/2023
PROJECT NUMBER &	ADDRESS:	

10 Required Content of Notice at Submittal

1. Office of Neighborhood Coordination notice inquiry response

Anthony Santi

From: Carmona, Dalaina L. <dlcarmona@cabq.gov>

Sent: Tuesday, October 3, 2023 2:37 PM

To: Anthony Santi

Subject: 10501 Central Ave. NE Public Notice Inquiry Sheet Submission

Attachments: IDOZoneAtlasPage L-21-Z.pdf

Dear Applicant:

As of Tuesday, October 3, 2023, there are **NO** neighborhood associations to notify. You will need to attach a copy of this e-mail from the Office of Neighborhood Coordination (ONC) to your application when you submit it to the Planning Department.

Please note that the ONC does not have any jurisdiction over any other aspect of your application beyond this neighborhood contact information. We can't answer questions about sign postings, pre-construction meetings, permit status, site plans, buffers, or project plans, so we encourage you to contact the Planning Department at: 505-924-3857 Option #1, e-mail: devhelp@cabq.gov, or visit: https://www.cabq.gov/planning/online-planning-permitting-applications with those types of questions.

Thank you.



Dalaina L. Carmona

Senior Administrative Assistant Office of Neighborhood Coordination **Council Services Department** 1 Civic Plaza NW, Suite 9087, 9th Floor Albuquerque, NM 87102 505-768-3334

dlcarmona@cabq.gov or ONC@cabq.gov Website: www.cabq.gov/neighborhoods









Confidentiality Notice: This e-mail, including all attachments is for the sole use of the intended recipient(s) and may contain confidential and privileged information. Any unauthorized review, use, disclosure or distribution is prohibited unless specifically provided under the New Mexico Inspection of Public Records Act. If you are not the intended recipient, please contact the sender and destroy all copies of this message.

From: webmaster@cabq.gov <webmaster@cabq.gov>

Sent: Tuesday, October 3, 2023 1:22 PM

To: Office of Neighborhood Coordination <anthonys@dpsdesign.org>

Cc: Office of Neighborhood Coordination <onc@cabq.gov>

Subject: Public Notice Inquiry Sheet Submission

[EXTERNAL] Forward to phishing@cabq.gov and delete if an email causes any concern.

Public Notice Inquiry For: Administrative Decision If you selected "Other" in the question above, please describe what you are seeking a Public Notice Inquiry for below: **Contact Name Anthony Santi** Telephone Number 5057619700 **Email Address** anthonys@dpsdesign.org Company Name Dekker/Perich/Sabatini **Company Address** 7600 Jefferson St. NE Suite 100 City Albuquerque State NM ZIP 87109 Legal description of the subject site for this project: TRACT IN N 1/2 NW 1/4 NW 1/4 CONT 2.2860 AC M/LTRACT IN N 1/2 NW 1/4 NW 1/4 CONT 2.2860 AC M/L Physical address of subject site: 10501 Central Ave. NE Subject site cross streets: Central and Eubank Other subject site identifiers: This site is located on the following zone atlas page: L-21-Z Captcha

Χ

11 Additional Materials

- Fire 1 Plan Approved
 Solid Waste Plan Approved

10501 CENTRAL AVE NE ALBUQUERQUE, NM 87123 SENIOR LIVING COMPLEX

OCCUPANCY GROUP R-2

BUILDING IS TYPE VB 76,639 SQ. FT. BUILDING IS SPRINKELED, NFPA-13-R FIRE FLOW IS 7,500 = 3,750 GPM. = 4 FIRE HYDRANTS

MAX. BUILDING HEIGHT IS 51'-6" STAND PIPE IS REQUIRED. HIGHEST 4TH FLOOR LEVEL IS 33'-6"

3 NEW FIRE HYDRANTS 1 EXISTING FIRE HYDRANT NEAR SITE

ALL FIRE DEPARTMENT CONNECTIONS SHALL HAVE A MINIMUM DISTANCE OF 3' FROM ANY PERMANENT OBJECTS.

BUILDING TO HAVE A PREMISES ID VISIBLE FROM CENTRAL AVE

BUILDING TO HAVE KNOX BOXES AT


ALL GATES ARE ELECTRICALLY OPERATED WITH A KNOX KEY SWITCH. EMERGENCY ACCESS.

ALL ACCESS ROADS AND FIRE LANES HAVE GRADES LESS THAN 10% AND A LOAD CAPACITY OF 75,000 POUNDS.

ALL ACCESS ROADS AND FIRE PATHS WILL ACCOMMODATE A 28' MINIMUM TRUCK TURNING RADIUS

FIRE APPARATUS ROADS SHALL HAVE AN UNOBSTRUCTED HEIGHT NOT LESS THAN 13'-6".

THERE ARE NO OVERHEAD OBSTRUCTIONS ON SITE TO PROHIBIT LADDER TRUCK OPERATIONS

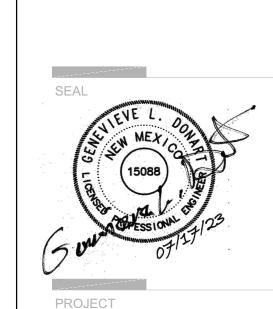

VENUE NE NM 87123

ISSUED FOR PERMIT

REVISIONS


JTS/BJB/DEC PROJECT NO. IA 2609 22-0083


DRAWING NAME HYDRANT LOCATION


& ACCESS PLAN SHEET NO.

FIRE 1


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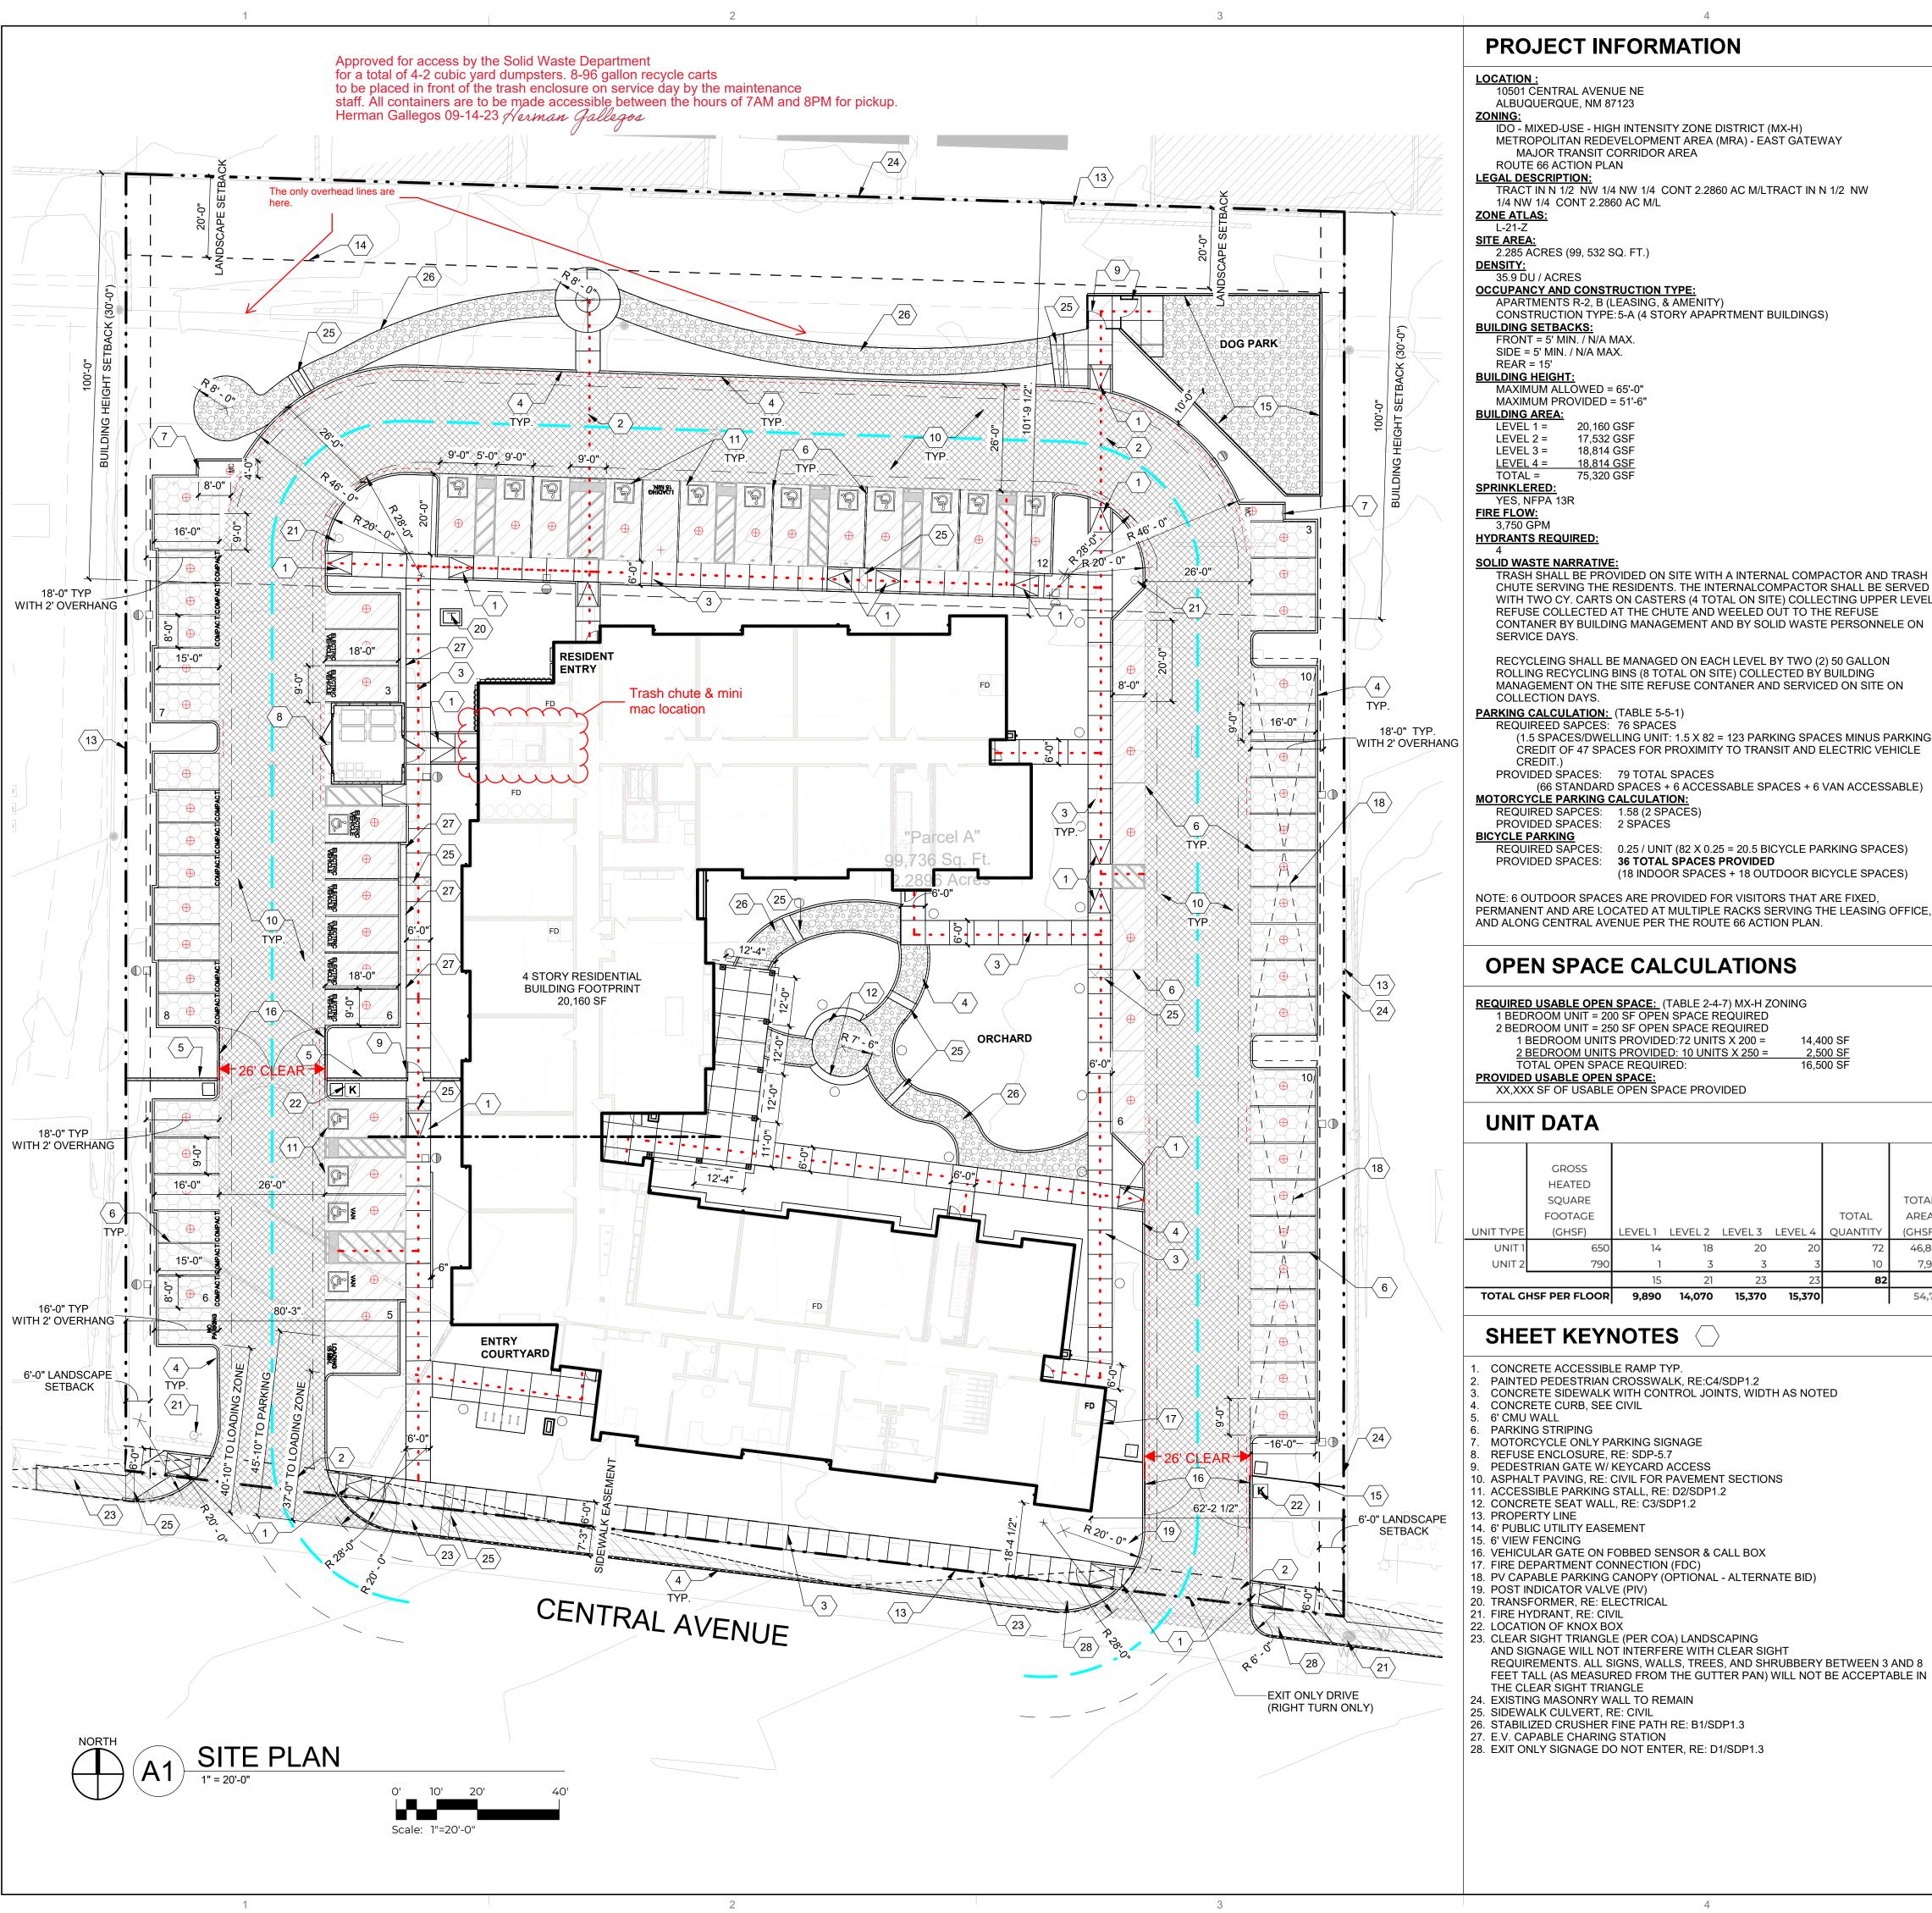


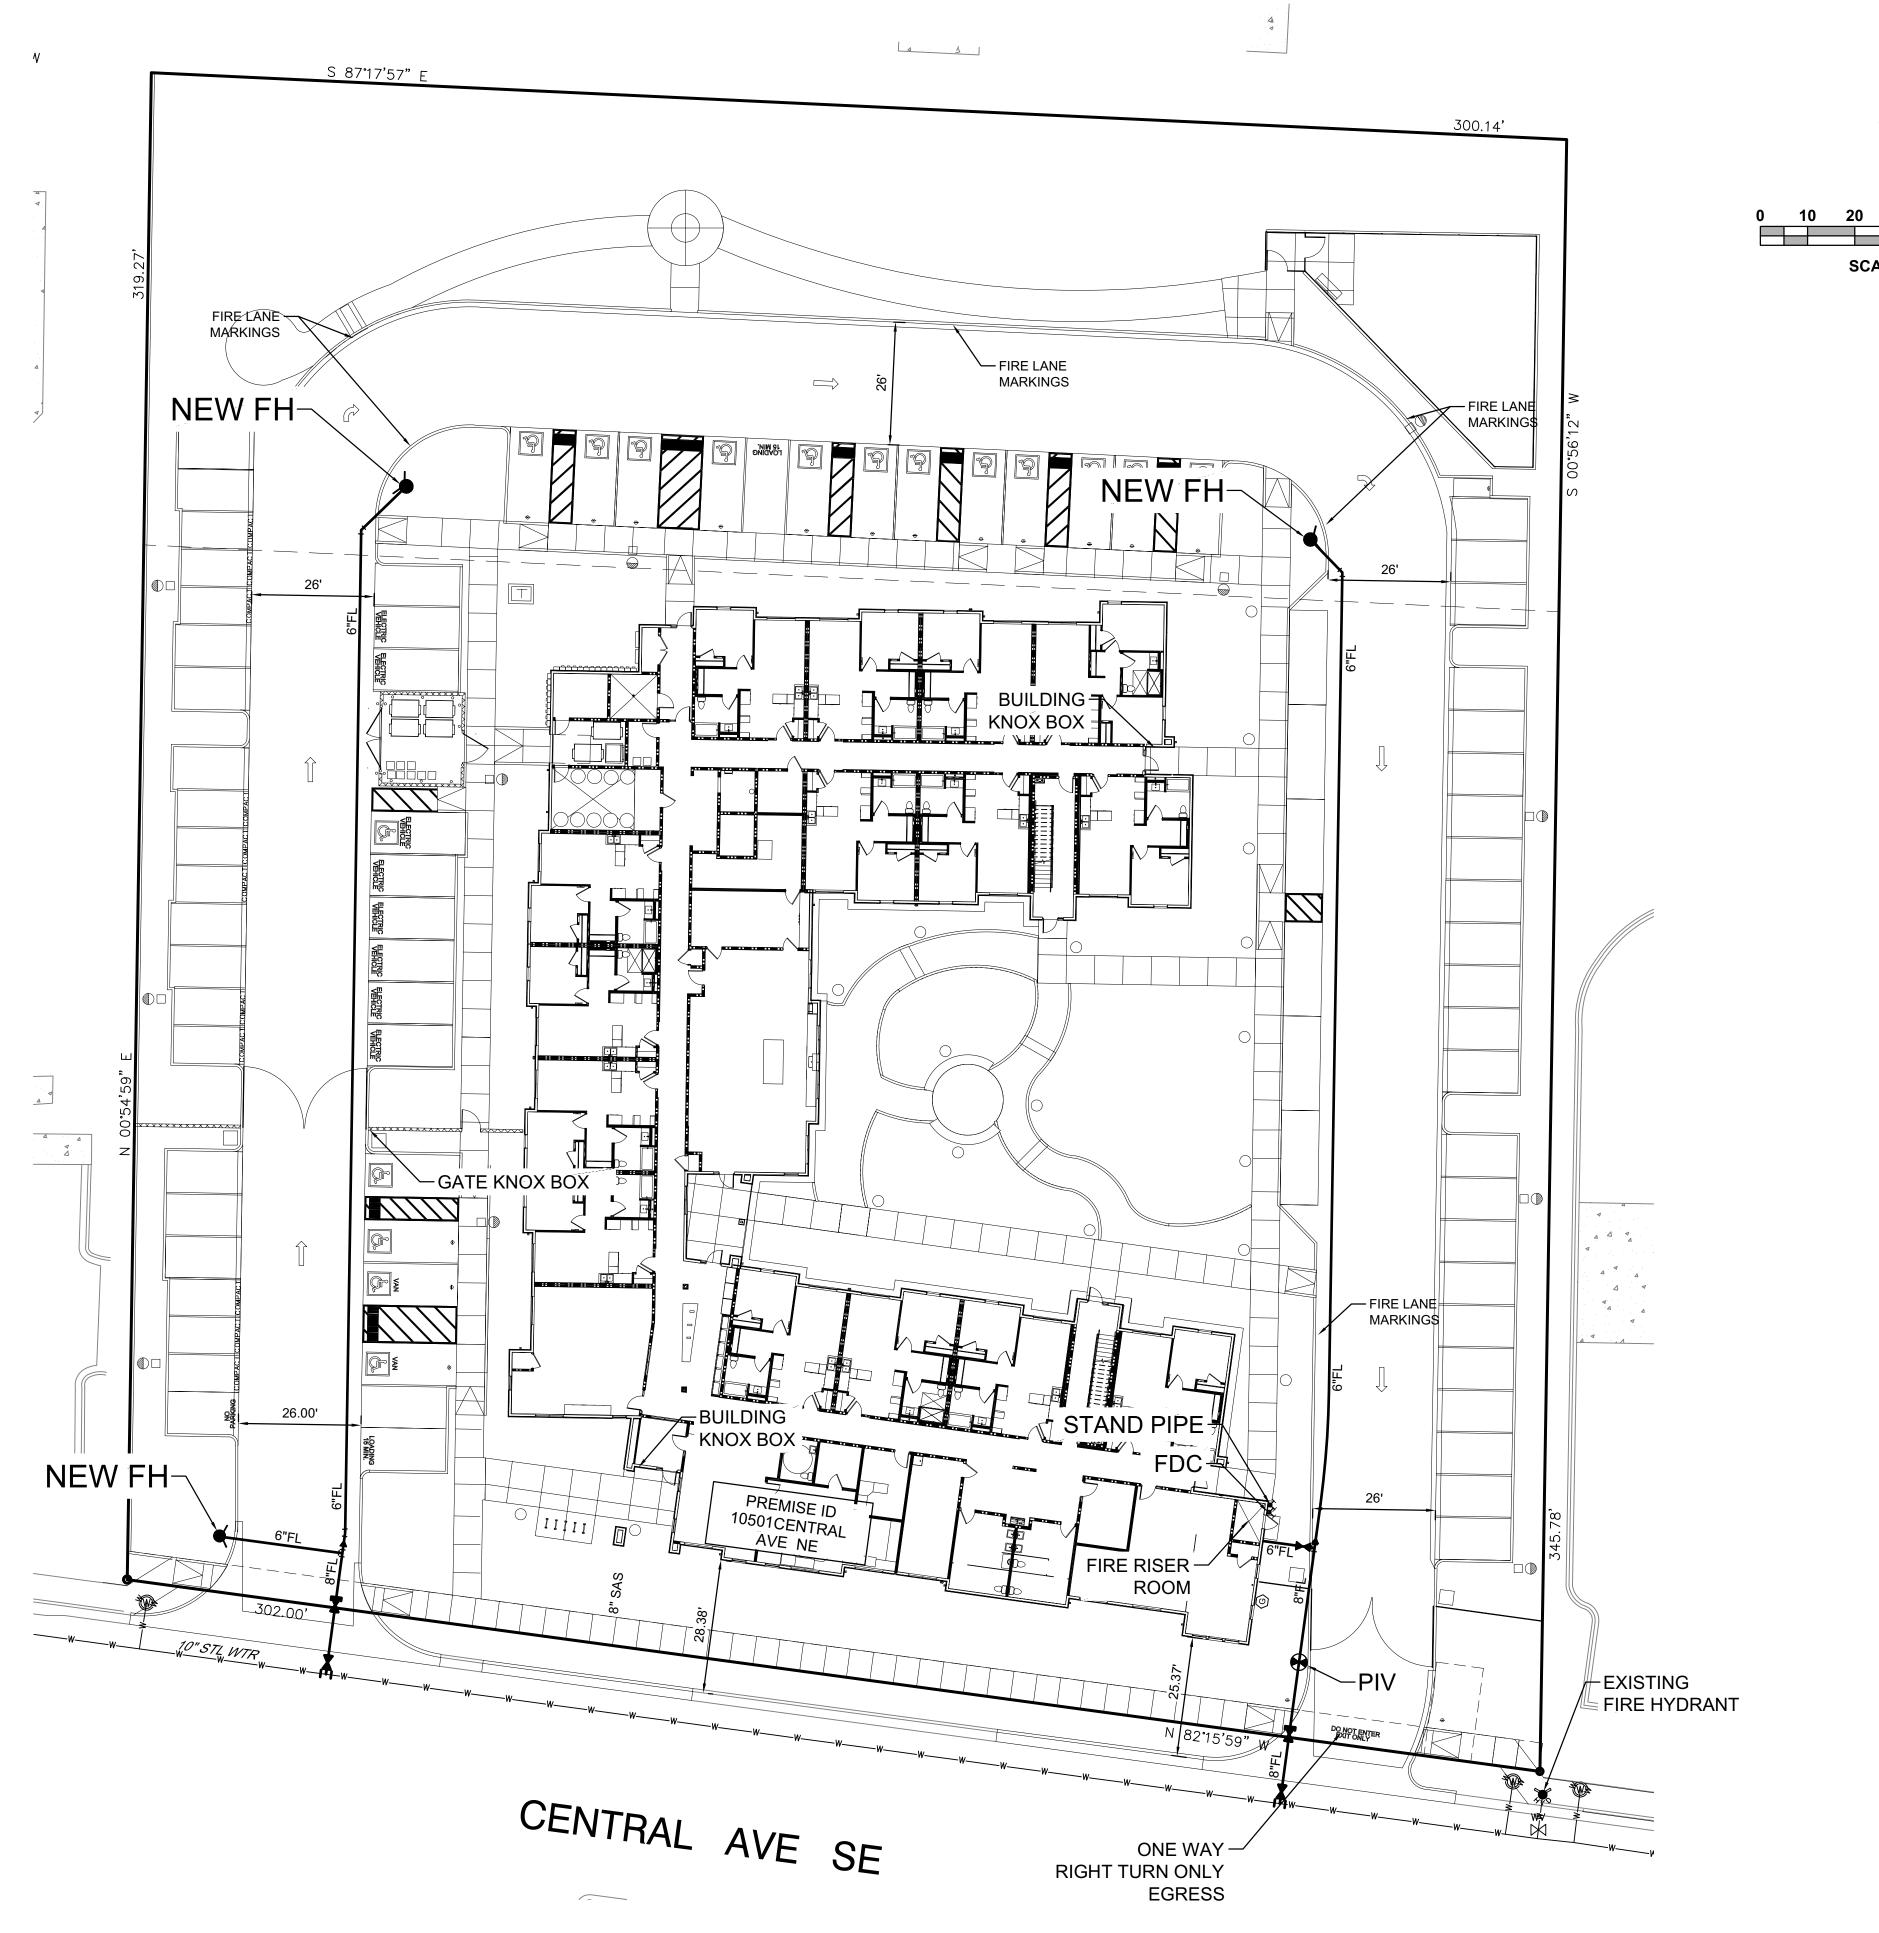

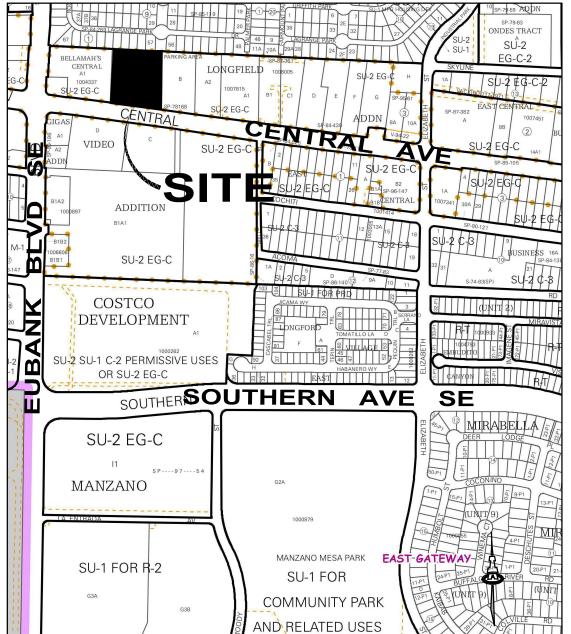

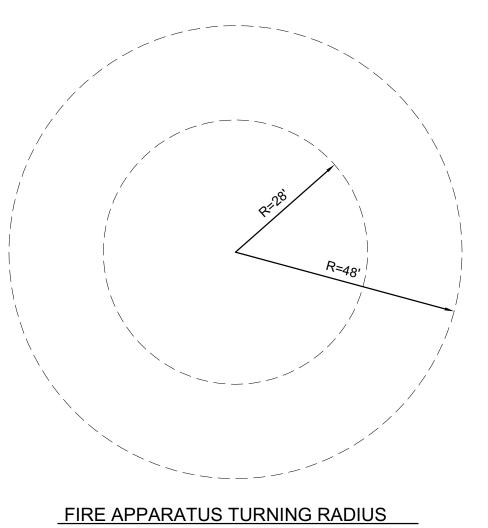SCALE 1"=20'

L-21

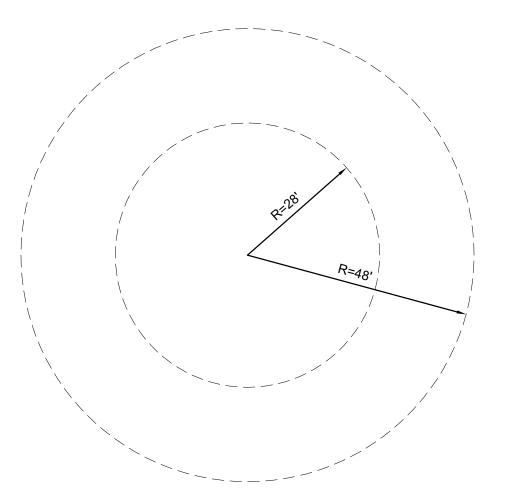

IDO - MIXED-USE - HIGH INTENSITY ZONE DISTRICT (MX-H)
METROPOLITAN REDEVELOPMENT AREA (MRA) - EAST GATEWAY

TRACT IN N 1/2 NW 1/4 NW 1/4 CONT 2.2860 AC M/LTRACT IN N 1/2 NW

APARTMENTS R-2, B (LEASING, & AMENITY) CONSTRUCTION TYPE: 5-A (4 STORY APAPRTMENT BUILDINGS)

TRASH SHALL BE PROVIDED ON SITE WITH A INTERNAL COMPACTOR AND TRASH CHUTE SERVING THE RESIDENTS. THE INTERNALCOMPACTOR SHALL BE SERVED WITH TWO CY. CARTS ON CASTERS (4 TOTAL ON SITE) COLLECTING UPPER LEVEL REFUSE COLLECTED AT THE CHUTE AND WEELED OUT TO THE REFUSE

RECYCLEING SHALL BE MANAGED ON EACH LEVEL BY TWO (2) 50 GALLON ROLLING RECYCLING BINS (8 TOTAL ON SITE) COLLECTED BY BUILDING MANAGEMENT ON THE SITE REFUSE CONTANER AND SERVICED ON SITE ON

(1.5 SPACES/DWELLING UNIT: 1.5 X 82 = 123 PARKING SPACES MINUS PARKING CREDIT OF 47 SPACES FOR PROXIMITY TO TRANSIT AND ELECTRIC VEHICLE

PROVIDED SPACES: 79 TOTAL SPACES (66 STANDARD SPACES + 6 ACCESSABLE SPACES + 6 VAN ACCESSABLE)

PROVIDED SPACES: 36 TOTAL SPACES PROVIDED (18 INDOOR SPACES + 18 OUTDOOR BICYCLE SPACES)

NOTE: 6 OUTDOOR SPACES ARE PROVIDED FOR VISITORS THAT ARE FIXED, PERMANENT AND ARE LOCATED AT MULTIPLE RACKS SERVING THE LEASING OFFICE, AND ALONG CENTRAL AVENUE PER THE ROUTE 66 ACTION PLAN.

REQUIRED USABLE OPEN SPACE: (TABLE 2-4-7) MX-H ZONING 1 BEDROOM UNIT = 200 SF OPEN SPACE REQUIRED 2 BEDROOM UNIT = 250 SF OPEN SPACE REQUIRED 14,400 SF

TOTAL GHSF PER FLOOR		9,890	14,070	15,370	15,370		54,700
		15	21	23	23	82	
UNIT 2	790	1	3	3	3	10	7,900
UNIT 1	650	14	18	20	20	72	46,800
UNIT TYPE	(GHSF)	LEVEL1	LEVEL 2	LEVEL 3	LEVEL 4	QUANTITY	(GHSF)
	FOOTAGE					TOTAL	AREA
SQUARE							TOTAL
	HEATED						
	GROSS						

- CONCRETE SIDEWALK WITH CONTROL JOINTS, WIDTH AS NOTED
- 10. ASPHALT PAVING, RE: CIVIL FOR PAVEMENT SECTIONS
- 11. ACCESSIBLE PARKING STALL, RE: D2/SDP1.2
- 16. VEHICULAR GATE ON FOBBED SENSOR & CALL BOX
- 18. PV CAPABLE PARKING CANOPY (OPTIONAL ALTERNATE BID)
- 23. CLEAR SIGHT TRIANGLE (PER COA) LANDSCAPING
- REQUIREMENTS. ALL SIGNS, WALLS, TREES, AND SHRUBBERY BETWEEN 3 AND 8
- 26. STABILIZED CRUSHER FINE PATH RE: B1/SDP1.3
- 28. EXIT ONLY SIGNAGE DO NOT ENTER, RE: D1/SDP1.3

GENERAL SHEET NOTES

- A. SITE PLAN DIMENSIONS ARE IN DECIMAL UNITS. DIMENSIONS ARE TO FACE OF CURB, OR WALL, OR EDGE OF PAVEMENT UNLESS OTHERWISE NOTED. B. SITE PLAN SHALL COMPLY WITH LOCAL, FEDERAL AND ACCESSIBILITY STANDARDS
- & GUIDELINES, INCLUDING THE INTERNATIONAL FIRE CODE (IFC) 2015. C. VERIFY EXISTING UTILITY LOCATIONS BEFORE EXCAVATION.
- D. COORDINATE WITH OWNER FOR ALLOWABLE STAGING AREAS DURING
- E. REPAIR AREAS TO MATCH PRE-CONSTRUCTION CONDITION WHERE UTILITY
- OF WORK BOUNDARY.
- E. ALL EXISTING ASPHALT AND CONCRETE TO BE REMOVED PRIOR TO CONSTRUCTION
- G. REMOVE EXISTING TREES PRIOR TO CONSTRUCTION H. UTILITIES AND ASSOCIATED EQUIPMENT SHOWN FOR REFERENCE ONLY.
- COORDINATE LOCATION AND INSTALLATION. SEE CIVIL ALL CURBS AND ACCESSIBLE RAMPS WILL BE DESIGNED AND BUILT ACCORDING TO THE CITY OF ALBUQUERQUE STANDARDS.
- AN ACCESSIBLE ROUTE, IN COMPLIANCE WITH ACCESSIBILITY STANDARDS OF THE PROJECT, CONNECTS FROM THE BUILDING TO ACCESSIBLE PARKING SPACES AND TO ALL SITE AMENITIES AS REQUIRED
- K. ALL LIGHT FIXTURES AND LIGHTING DESIGN SHALL COMPLY WITH THE CITY OF ALBUQUERQUE INTEGRATED DEVELOPMENT ORDINANCE (IDO): SECTION 14-16-5-8 OUTDOOR LIGHTING.
- . REFER TO CIVIL AND ELECTRICAL FOR DEMOLITION ITEMS.
- M. REFER TO CIVIL FOR PAVING PLAN AND PAVING DETAILS. N. STREETS, PARKING SPACES AND ASSOCIATED DRIVES TO BE ASPHALT UNLESS NOTED OTHERWISE.
- O. SIDEWALK JOINTS SHALL FOLLOW PATTERN AS SHOWN ON SITE PLAN. P. PROVIDE POURABLE SEALANT AT ALL EXPANSION JOINTS IN CONCRETE SIDEWALK, WHERE EXPANSION JOINT MATERIAL IS PROVIDED BETWEEN WALLS
- AND SIDEWALKS AND BETWEEN ASPHALT AND CONCRETE JOINTS. Q. PROVIDE AIR ENTRAINED CONCRETE WITH MEDIUM BROOM FINISH AT ALL SITE CONCRETE. SLOPE ALL CONCRETE SIDEWALKS TO DRAIN, TYP. RE: CIVIL FOR
- SPOT ELEVATIONS, AND GRADING AND DRAINAGE REQUIREMENTS. R. EXISTING LANDSCAPE AREAS ADJACENT TO THE PROJECT SITE ARE TO BE PROTECTED A DEMOLITION AND CONSTRUCTION.
- LANDSCAPE AND SIGNAGE WILL NOT INTERFERE WITH CLEAR SIGHT REQUIREMENTS. THEREFORE SIGNS, WALLS AND PLANTING BETWEEN 3 FEET AND 8 FEET TALL (AS MEASURED FROM THE GUTTER PAN) WILL NOT BE PERMITTED IN
- THE CLEAR SIGHT TRIANGLE. T. $\,$ WORK WITHIN THE PUBLIC RIGHT OF WAY REQUIRES A WORK ORDER WITH DRC APPROVED PLANS PER CITY OF ALBUQUERQUE.
- ALL RAMPS, SIDEWALKS, CURBS AND GUTTERS IN THE R.O.W. SHALL BE INSTALLED PER CITY OF ALBUQUERUQE STANDARD DRAWINGS. SOLID WASTE CONNECTION IS THE RESPONSIBILITY OF THE CITY OF
- ALBUQUERQUE SOLID WASTE DEPARTMENT. W. DURING CONSTRUCTION, COORDINATE WITH CITY OF ALBUQUERQUE'S MEDIAN LANDSCAPING PROJECT AT THIS LOCATION.
- X. ALL IMPROVEMENTS LOCATED IN THE RIGHT OF WAY MUST BE INCLUDED ON THE WORK ORDER.



LEGEND

Zoning information as of May 17, 2018 The Zone Districts and Overlay Zones are established by the Integrated Development Ordinance (IDO).

LANDSCAPED AREA HEAVY DUTY ASPHALT (RATED FOR UP TO 75,000 LBS) LIGHT DUTY ASPHALT STABALIZED DECOMPOSED GRANITE PATH (ACCESABLE) PERMIABLE PAVING, RE: CIVIL ----- PROPERTY LINE SETBACK (SEE DEMENTION FOR ADDITIONAL DETAILS) **- - - - -** ACCESSIBLE ROUTE

FIRELANE STRIPPING MARKING FIRE ACCESS LANE, RE: C2/SDP 1.2

Petroglyph National Monument Areas Outside of City Limits

Airport Protection Overlay (APO) Zon

Feet 1000

REFUSE TRUCK ROUTE

FIRE HYDRANT LOCATION, RE: CIVIL FIRE DEPARTMENT CONNECTION (FDC) WALL MOUNTED

EXISTING FIRE HYDRANT LOCATION

TRANSFORMER, RE: ELECTRICAL

PROPOSED 20' LIGHT POLE PHOTOVOLTAIC (PV) CARPORT, ATLERNATE BID

(SEPERATE PERMIT REQUIRED) BIKE RACK (4 BIKE CAPACITY) RE: B2/SDP 1.2

SITE BENCH



SEAL

PROJECT

ISSUED FOR **PERMIT**

04

REVISIONS DRAWN BY

REVIEWED BY CWW DATE 05/12/23 PROJECT NO: 22-0083

DRAWING NAME

TRAFFIC **CIRCULATION** PLAN

SHEET NO

TCL