
DRAWING INDEX

SITE DEVELOPMENT PLAN
SITE DETAILS
SITE DETAILS
LANDSCAPE PLAN
LANDSCAPE DETAILS
GRADING AND DRAINAGE PLAN
EXTERIOR ELEVATIONS
FIRE HYDRANT LOCATION AND ACCESS PLAN SDP 1.3 SDP 2.1 SDP 2.2


Architecture

in Progress

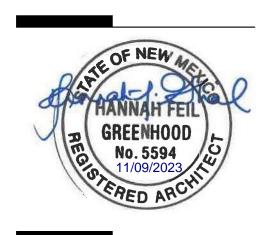

ARCHITECT

VICINITY MAP

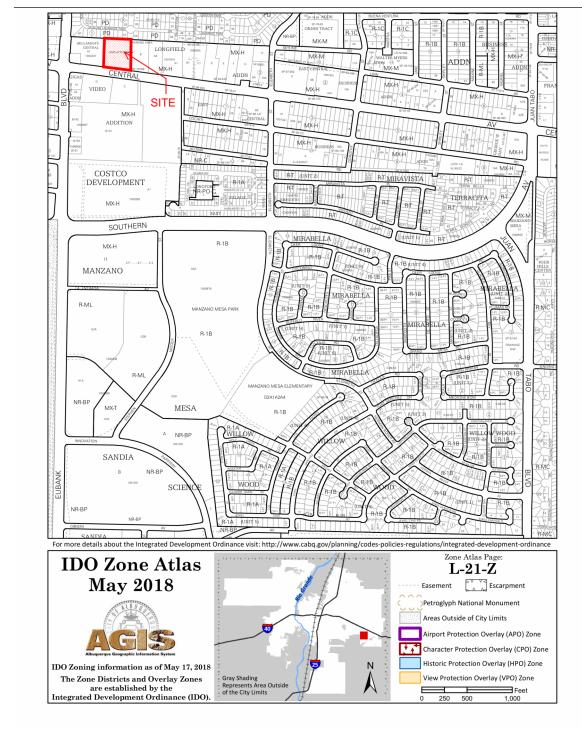


FAROLITO SENIOR COMMUNITY

PROJECT TEAM OWNER **FAROLITO APARTMENTS** LIMITED PARTNERSHIP LLLP 320 GOLD AVENUE SW ALBUQUERQUE, NM 87102 (505) 244-1614


ARCHITECT DEKKER PERICH SABATINI 7601 JEFFERSON NE, SUITE 100 ALBUQERQUE, NM 87109 (505) 761-9700

LANDSCAPE ARCHITECT DEKKER PERICH SABATINI 7601 JEFFERSON NE, SUITE 100 ALBUQERQUE, NM 87109 (505) 761-9700

CIVIL ENGINEER ISAACSON & ARFMAN, INC. 128 MONROE STREET NE ALBUQUERQUE, NM 87108 (505) 268-8828

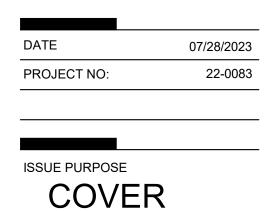

10501 CENTRAL, ALBUQUERQUE

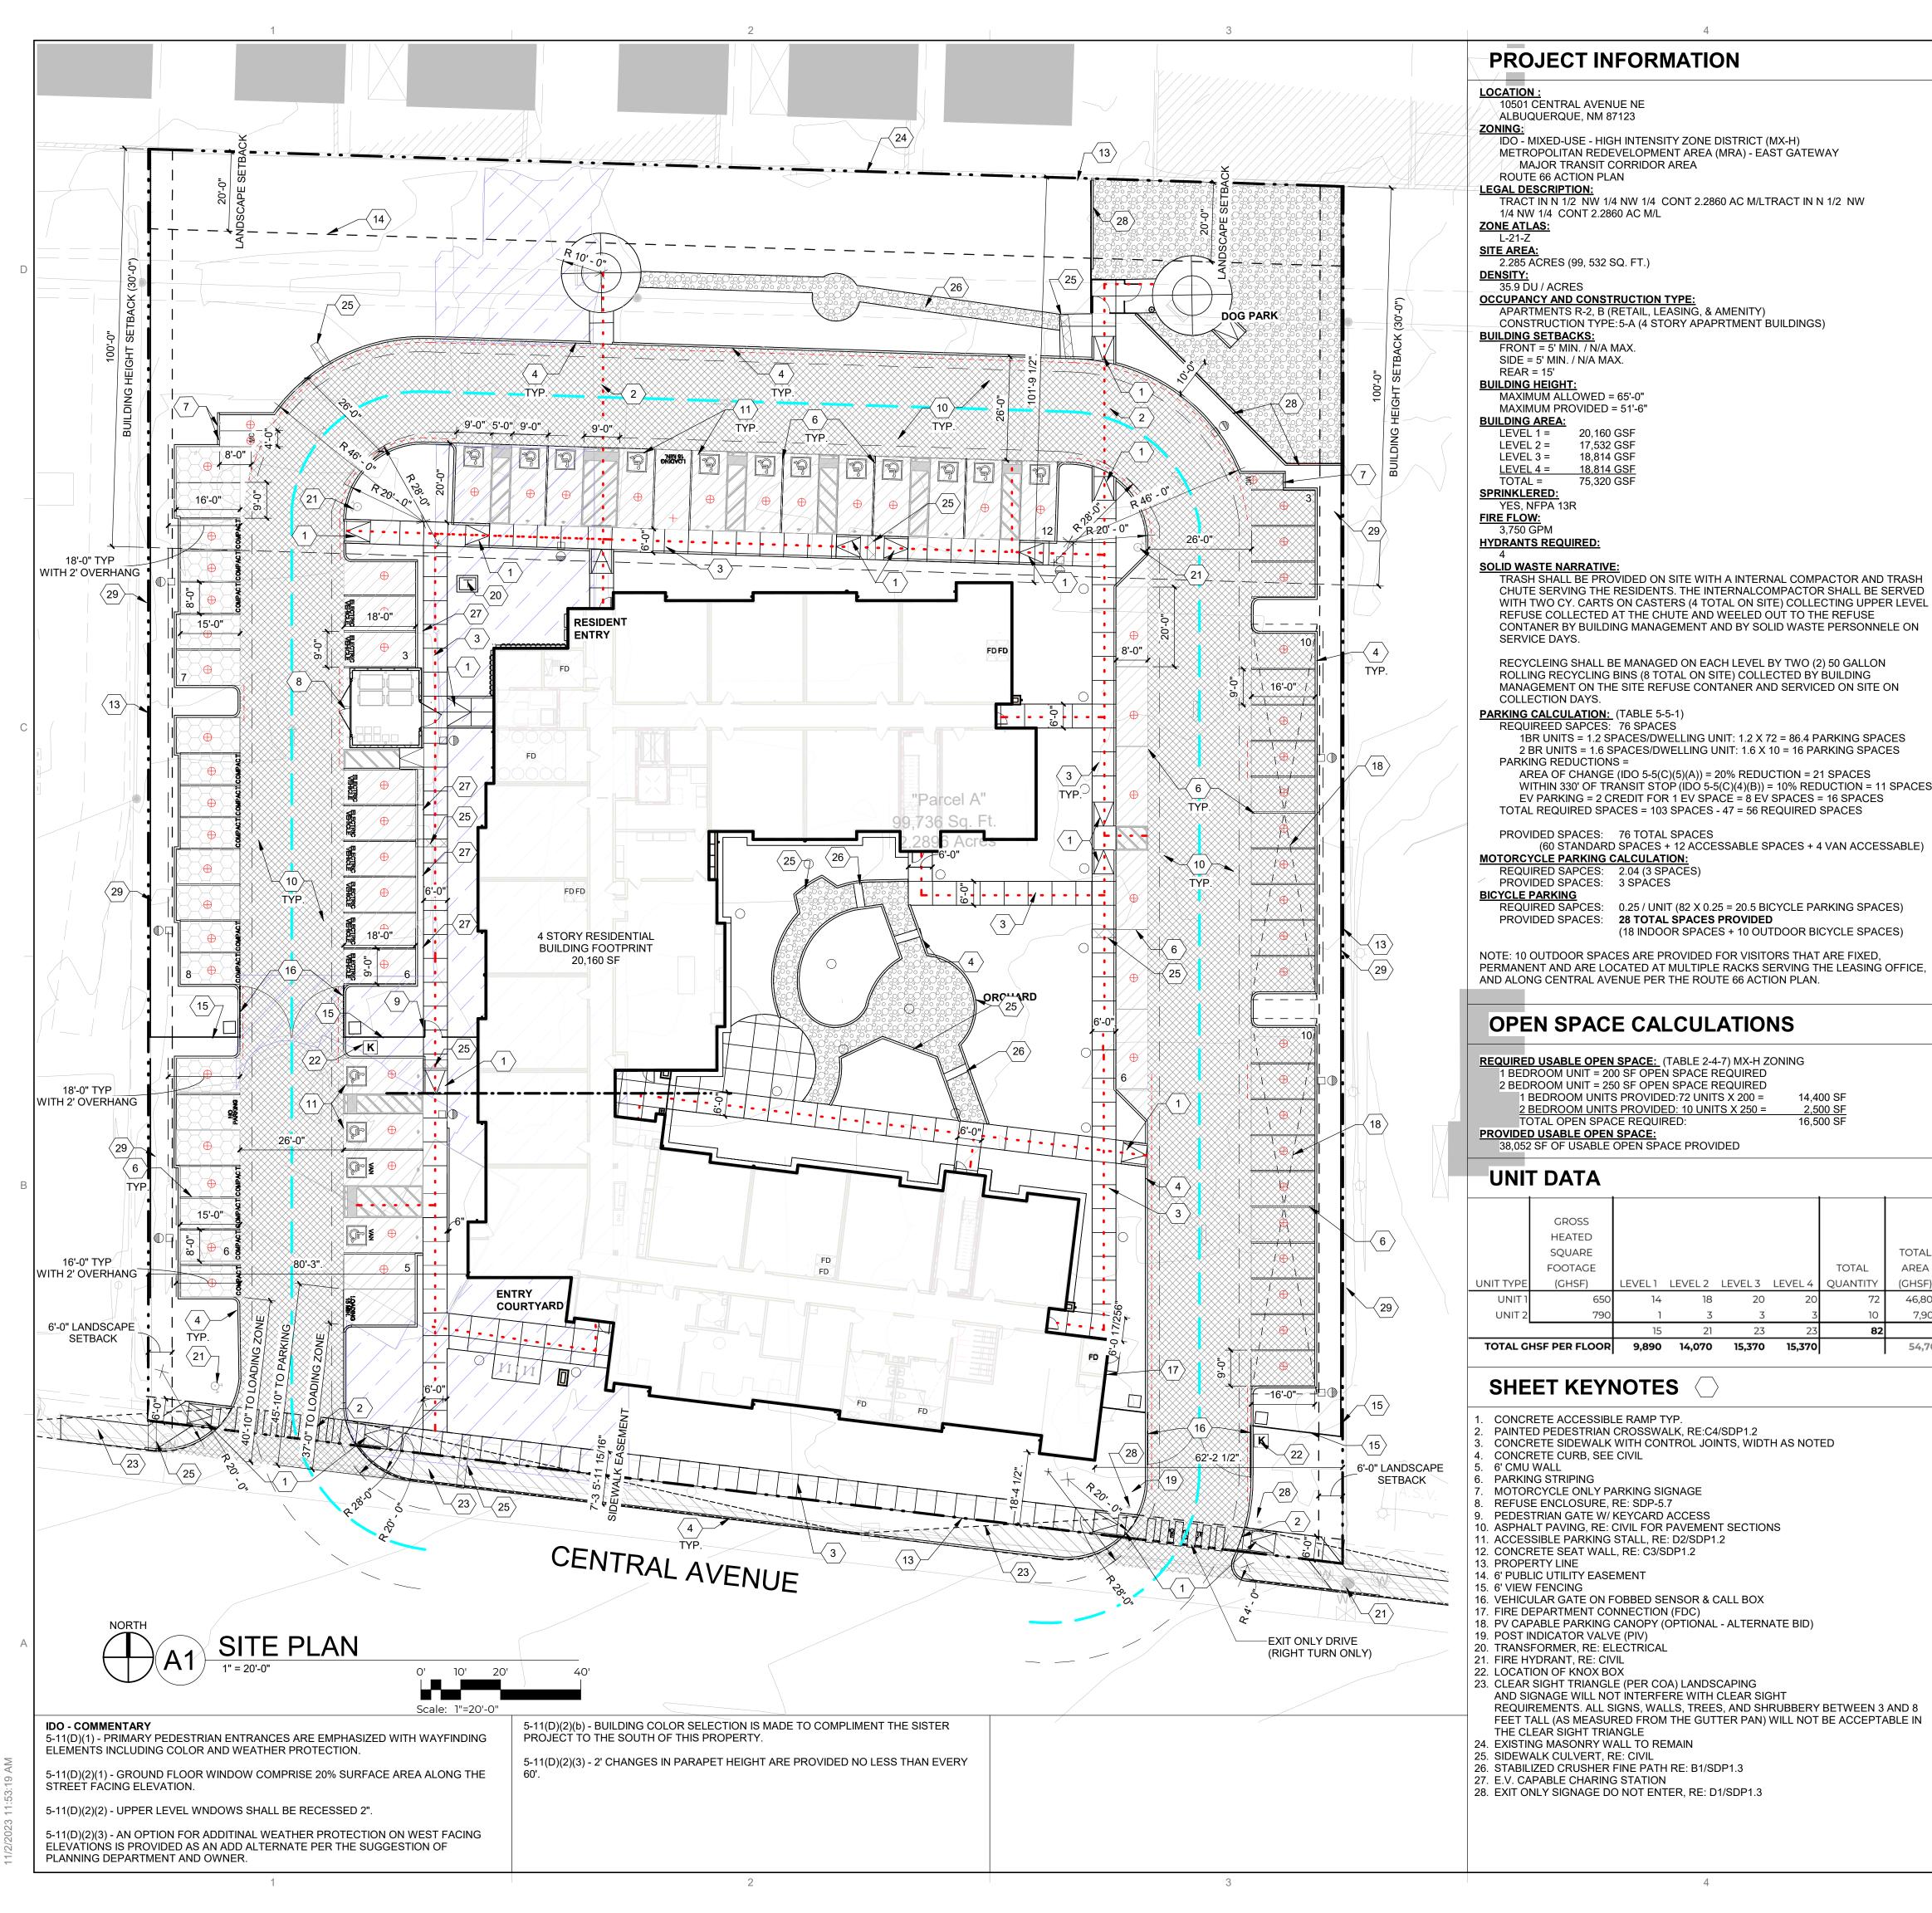

GENERAL SHEET NOTES

A. SITE PLAN DIMENSIONS ARE IN DECIMAL UNITS. DIMENSIONS ARE TO FACE OF CURB, OR WALL, OR EDGE OF PAVEMENT UNLESS OTHERWISE NOTED. B. SITE PLAN SHALL COMPLY WITH LOCAL, FEDERAL AND ACCESSIBILITY STANDARDS

& GUIDELINES, INCLUDING THE INTERNATIONAL FIRE CODE (IFC) 2015. C. VERIFY EXISTING UTILITY LOCATIONS BEFORE EXCAVATION. D. COORDINATE WITH OWNER FOR ALLOWABLE STAGING AREAS DURING

E. REPAIR AREAS TO MATCH PRE-CONSTRUCTION CONDITION WHERE UTILITY WORK, GRADING AND/OR STAGING OCCURS, INCLUDING AREAS OUTSIDE OF LIMIT

OF WORK BOUNDARY. F. ALL EXISTING ASPHALT AND CONCRETE TO BE REMOVED PRIOR TO

CONSTRUCTION G. REMOVE EXISTING TREES PRIOR TO CONSTRUCTION

H. UTILITIES AND ASSOCIATED EQUIPMENT SHOWN FOR REFERENCE ONLY. COORDINATE LOCATION AND INSTALLATION. SEE CIVIL

ALL CURBS AND ACCESSIBLE RAMPS WILL BE DESIGNED AND BUILT ACCORDING TO THE CITY OF ALBUQUERQUE STANDARDS. AN ACCESSIBLE ROUTE, IN COMPLIANCE WITH ACCESSIBILITY STANDARDS OF THE

PROJECT, CONNECTS FROM THE BUILDING TO ACCESSIBLE PARKING SPACES AND

TO ALL SITE AMENITIES AS REQUIRED K. ALL LIGHT FIXTURES AND LIGHTING DESIGN SHALL COMPLY WITH THE CITY OF ALBUQUERQUE INTEGRATED DEVELOPMENT ORDINANCE (IDO): SECTION 14-16-5-8

OUTDOOR LIGHTING. .. REFER TO CIVIL AND ELECTRICAL FOR DEMOLITION ITEMS. M. REFER TO CIVIL FOR PAVING PLAN AND PAVING DETAILS.

N. STREETS, PARKING SPACES AND ASSOCIATED DRIVES TO BE ASPHALT UNLESS NOTED OTHERWISE. O. SIDEWALK JOINTS SHALL FOLLOW PATTERN AS SHOWN ON SITE PLAN.

P. PROVIDE POURABLE SEALANT AT ALL EXPANSION JOINTS IN CONCRETE SIDEWALK, WHERE EXPANSION JOINT MATERIAL IS PROVIDED BETWEEN WALLS AND SIDEWALKS AND BETWEEN ASPHALT AND CONCRETE JOINTS.

Q. PROVIDE AIR ENTRAINED CONCRETE WITH MEDIUM BROOM FINISH AT ALL SITE CONCRETE. SLOPE ALL CONCRETE SIDEWALKS TO DRAIN, TYP. RE: CIVIL FOR SPOT ELEVATIONS, AND GRADING AND DRAINAGE REQUIREMENTS. R. EXISTING LANDSCAPE AREAS ADJACENT TO THE PROJECT SITE ARE TO BE

PROTECTED A DEMOLITION AND CONSTRUCTION. S. LANDSCAPE AND SIGNAGE WILL NOT INTERFERE WITH CLEAR SIGHT REQUIREMENTS. THEREFORE SIGNS, WALLS AND PLANTING BETWEEN 3 FEET AND 8 FEET TALL (AS MEASURED FROM THE GUTTER PAN) WILL NOT BE PERMITTED IN THE CLEAR SIGHT TRIANGLE.

WORK WITHIN THE PUBLIC RIGHT OF WAY REQUIRES A WORK ORDER WITH DRC APPROVED PLANS PER CITY OF ALBUQUERQUE. ALL RAMPS, SIDEWALKS, CURBS AND GUTTERS IN THE R.O.W. SHALL BE

INSTALLED PER CITY OF ALBUQUERUQE STANDARD DRAWINGS. SOLID WASTE CONNECTION IS THE RESPONSIBILITY OF THE CITY OF ALBUQUERQUE SOLID WASTE DEPARTMENT

W. DURING CONSTRUCTION, COORDINATE WITH CITY OF ALBUQUERQUE'S MEDIAN LANDSCAPING PROJECT AT THIS LOCATION.

PR-2023-009368 PROJECT NUMBER:

Is an Infrastructure List required? () Yes ()No If yes, then a set of approved DRC plans with a work order is required for any construction within Public Right-of-Way or for construction of public improvements.

SI-2023-01642

DFT SITE DEVELOPMENT PLAN APPROVAL

Application Number:

Traffic Engineering, Transportation Division	Date
ABCWUA	Date
Parks and Recreation Department	Date
Hydrology	Date
Code Enforcement	Date
* Environmental Health Department (conditional)	Date
Solid Waste Management	 Date

Date

LEGEND

TOTAL

AREA

(GHSF)

46,800

7,900

TOTAL

OUANTITY

Planning Department

14,400 SF

	LANDSCAPED AREA
	HEAVY DUTY ASPHALT (RATED FOR UP TO 75,000 LBS)
600 000 000 000	LIGHT DUTY ASPHALT
f.of.of.of.of.of. o. o. o. o. o. f.of.of.of.of.of.of.	STABALIZED DECOMPOSED GRANITE PATH (ACCESABLE)
	PERMIABLE PAVING
—··	PROPERTY LINE
	SETBACK (SEE DEMENTION FOR ADDITIONAL DETAILS)
	ACCESSIBLE ROUTE
	FIRELANE STRIPPING MARKING FIRE ACCESS LANE, RE: XX/SDP 1
	REFUSE TRUCK ROUTE
⟨ ○ ⟩	EXISTING FIRE HYDRANT LOCATION
\longleftrightarrow	PROPOSED FIRE HYDRANT LOCATION
Y	FIRE DEPARTMENT CONNECTION (FDC) WALL MOUNTED
T	PROPOSED TRANSFORMER LOCATION
	PROPOSED 20' LIGHT POLE

OPTIONAL PHOTOVOLTAIC (PV) CARPORT.

BIKE RACK (4 BIKE CAPACITY) RE: XX/SDP 1.2

(SEPERATE PERMIT REQUIRED)



PROJECT

ISSUED FOR **PERMIT**


REVISIONS


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DRAWN BY	BH
REVIEWED BY	CWW
DATE	05/12/23
PROJECT NO:	22-0083


DRAWING NAME

SITE DEVELOPMENT PLAN

SHEET NO **SDP 1.1**

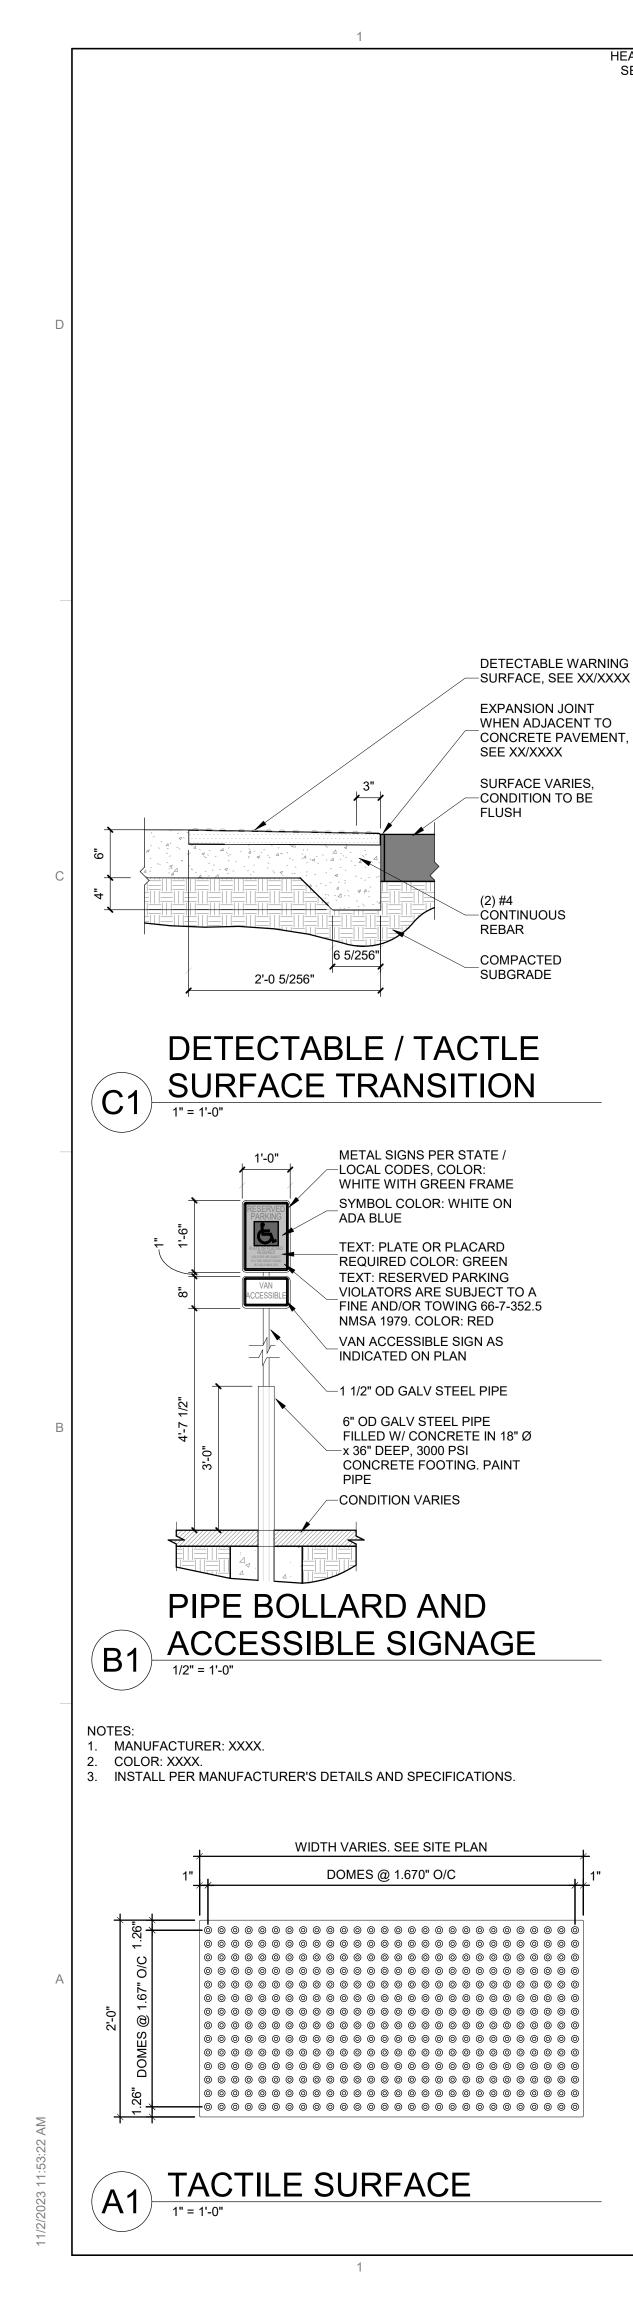

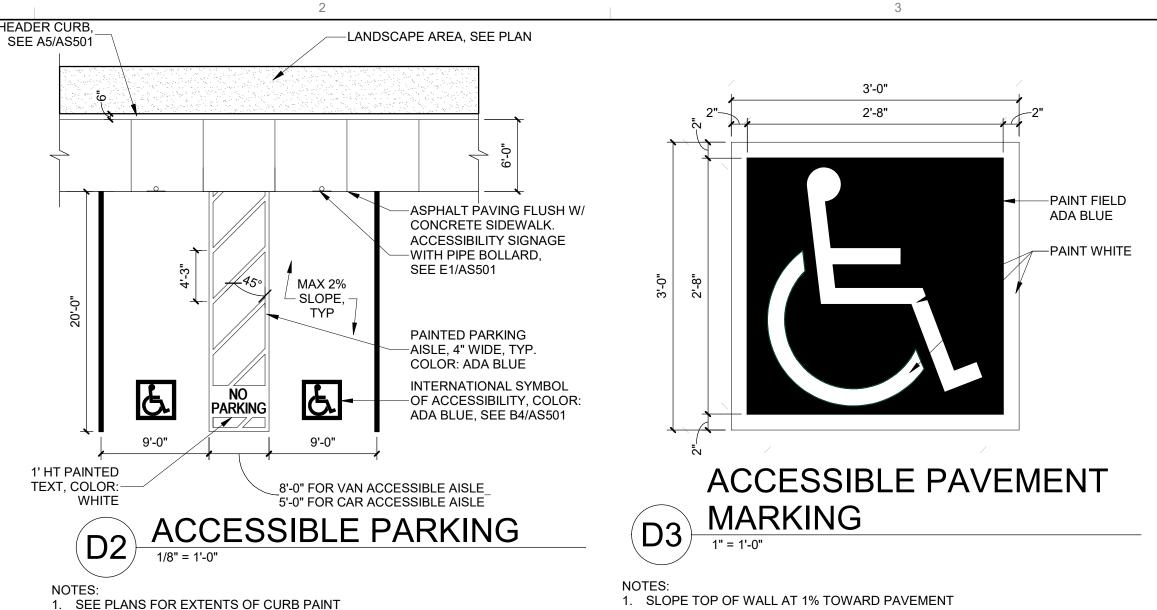

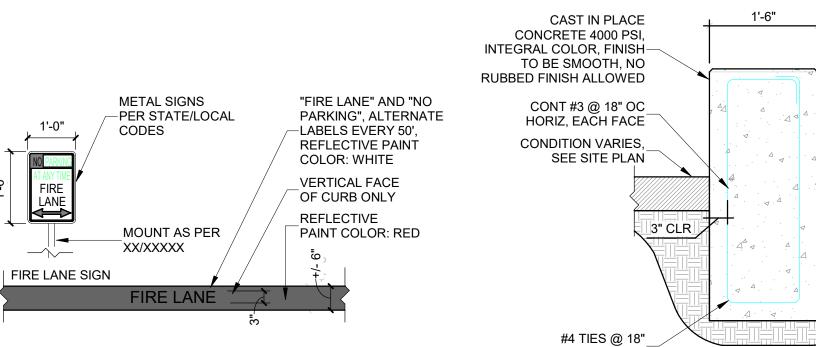

-2"Ø BICYCLE RACK

ANCHORED TO

CONCRETE PAD

AROUND BICYCLE

STALL PER COA

—1' CLEAR ZONE

FIRE STRIPING AND SIGNAGE

1. BASIS OF DESIGN, ANOVA U-BIKE RACK, COLOR: TBD

1'-0"

ARROW

4'-0" MIN

CONCRETE PAD

2'-0"


1. PAINT ARROWS WHERE SHOWN IN PLAN. COLOR: WHITE

BICYCLE RACK PLAN

2. WHERE CONDITION OCCURS IN RIGHT OF WAY, USE REFLECTIVE PAINT

DIRECTIONAL PAVEMENT

(C2)

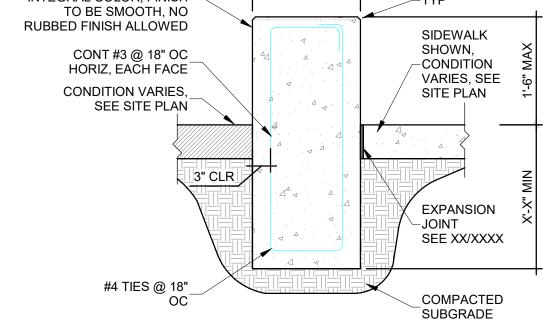


CONCRETE SEAT WALL


BASIS OF DESIGN, ANOVA U-BIKE RACK, COLOR: TBD


2. 2 BIKE CAPACITY PER RACK. 4 TOTAL PER PAD.


1/2" CHAMFER,

2. TOP OF WALL TO BE CONSTANT FOR EACH INDIVIDUAL WALL

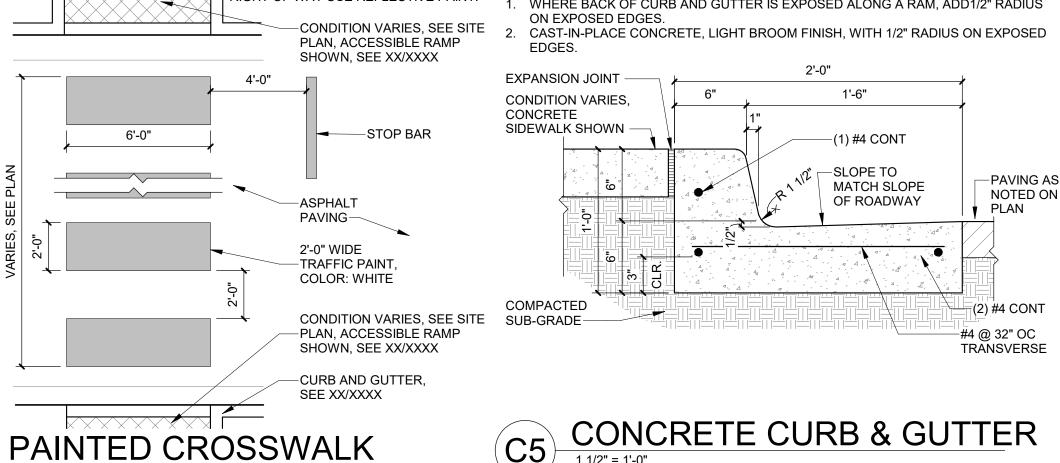

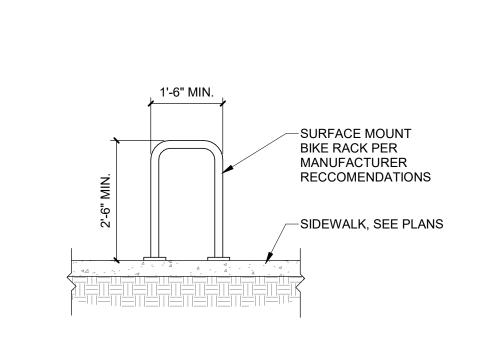


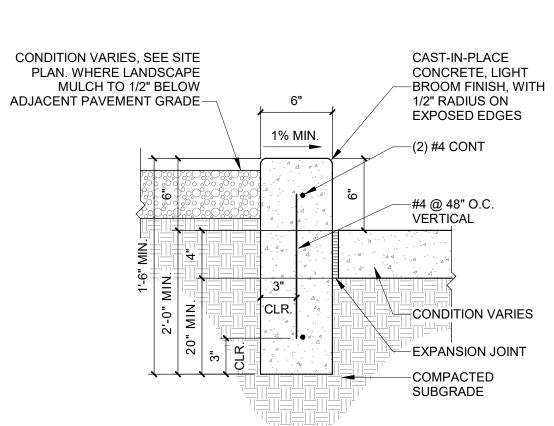

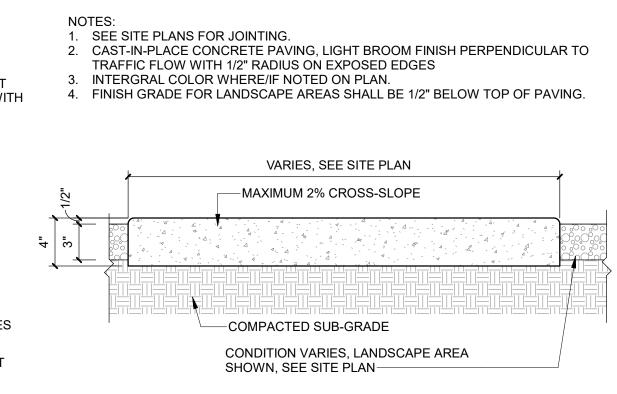






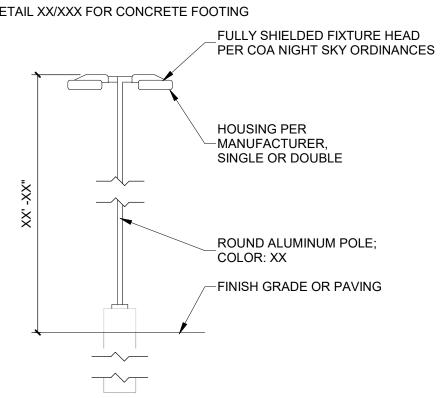


PARKING LIGHT POLE

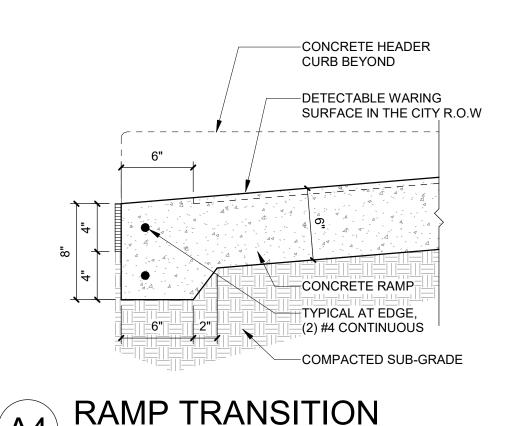

SAWCUT CONTROL JOINT 1/4" WIDE x 1" DEEP TOOLED **CONCRETE JOINT WITH 1/4"** RADIUS ON EDGED, SEE SITE PLAN **CONCRETE JOINT** FOR LOCATIONS POURABLE FILLER (COLOR TO MATCH CONCRETE) ON BACKER ROD, 1/4" RADIUS ON EXPOSED EDGES



CONCRETE HEADER CURB

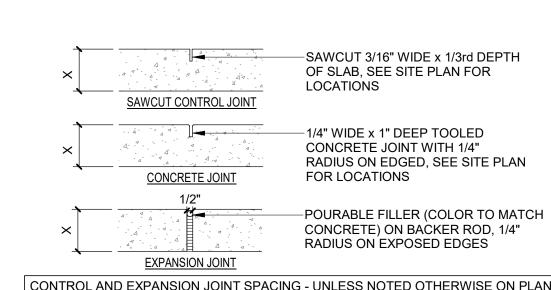


EXPANSION JOINT					
CONTROL AND EXPANSION JOINT SPACING - UNLESS NOTED OTHERWISE ON PLANS					
APPROX WIDTH OF CONCRETE	CURB & GUTTER, ROLL, HEADER, FLUSH CURBS	5' WALK	8' WALK & BLDG APRON	6'-12' WALK	
CONTROL JOINTS	4" O.C.	5' O.C.	8' O.C.	6' O.C.	
EXPANSION JOINTS	4" O.C.	5' O.C.	8' O.C.	6' O.C.	



WHEN CONDITION OCCURS IN RIGHT OF WAY USE REFLECTIVE PAINT. WHERE BACK OF CURB AND GUTTER IS EXPOSED ALONG A RAM, ADD1/2" RADIUS

CONCRETE CURB & GUTTER

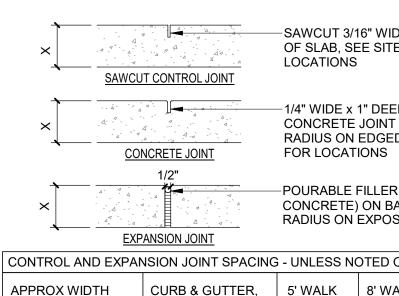

CONTROL AND EXPANSION JOINT SPACING - UNLESS NOTED OTHERWISE ON PLANS					
APPROX WIDTH OF CONCRETE	CURB & GUTTER, ROLL, HEADER, FLUSH CURBS	5' WALK	8' WALK & BLDG APRON	6'-12' WALK	
CONTROL JOINTS	4" O.C.	5' O.C.	8' O.C.	6' O.C.	
EXPANSION JOIN	TS 4" O.C.	5' O.C.	8' O.C.	6' O.C.	

B5) CONCRETE SIDEWALK

DRAWN BY **REVIEWED BY** DATE PROJECT NO:

REVISIONS

DRAWING NAME **ENLARGED** PLANS AND

DETAILS

ÖQ

CWW

07/10/23

22-0083

ISSUED FOR

PERMIT


Architecture

in Progress

SEAL


PROJECT

SHEET NO SDP 1.2

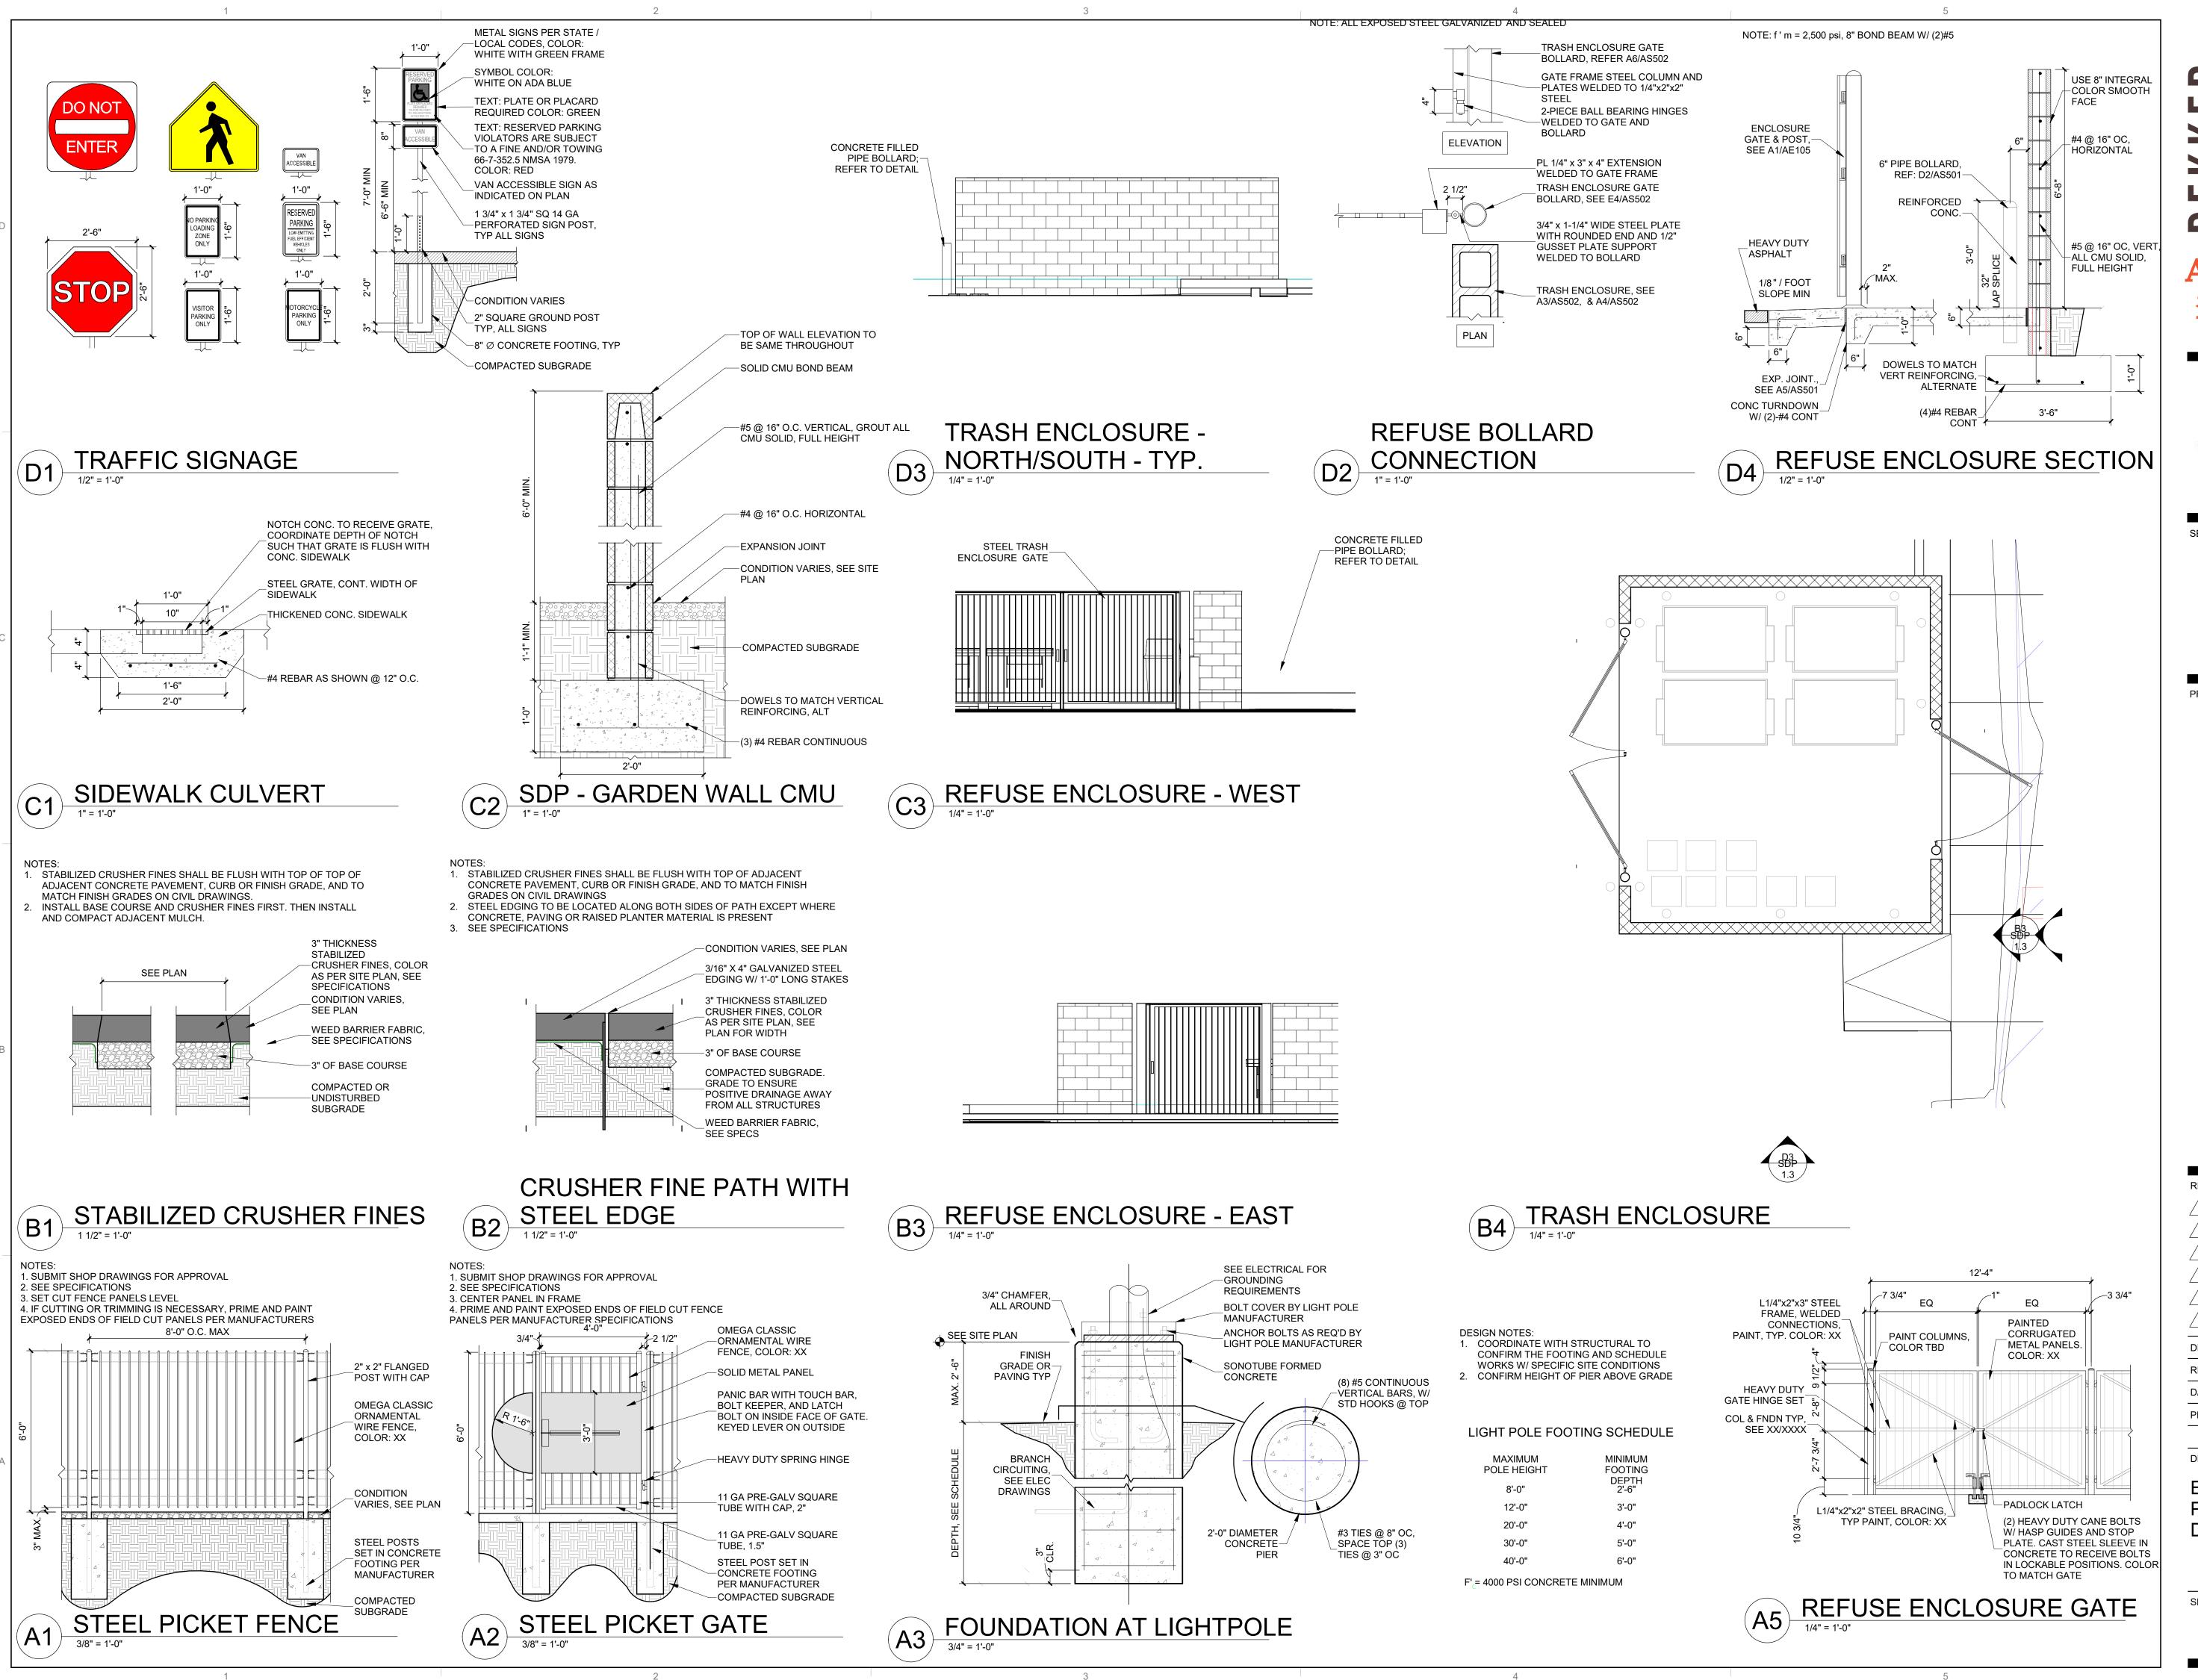

DEKKER PERICH SABATIN

Architecture in Progress

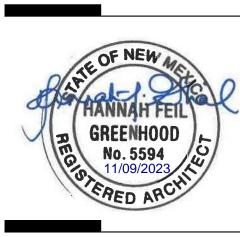

SEAL

PROJECT


OLITO SENIOR
CENTRAL AVENUE NE

ISSUED FOR PERMIT

DRAWING NAME

ENLARGED PLANS AND DETAILS

SHEET NO SDP 1.3

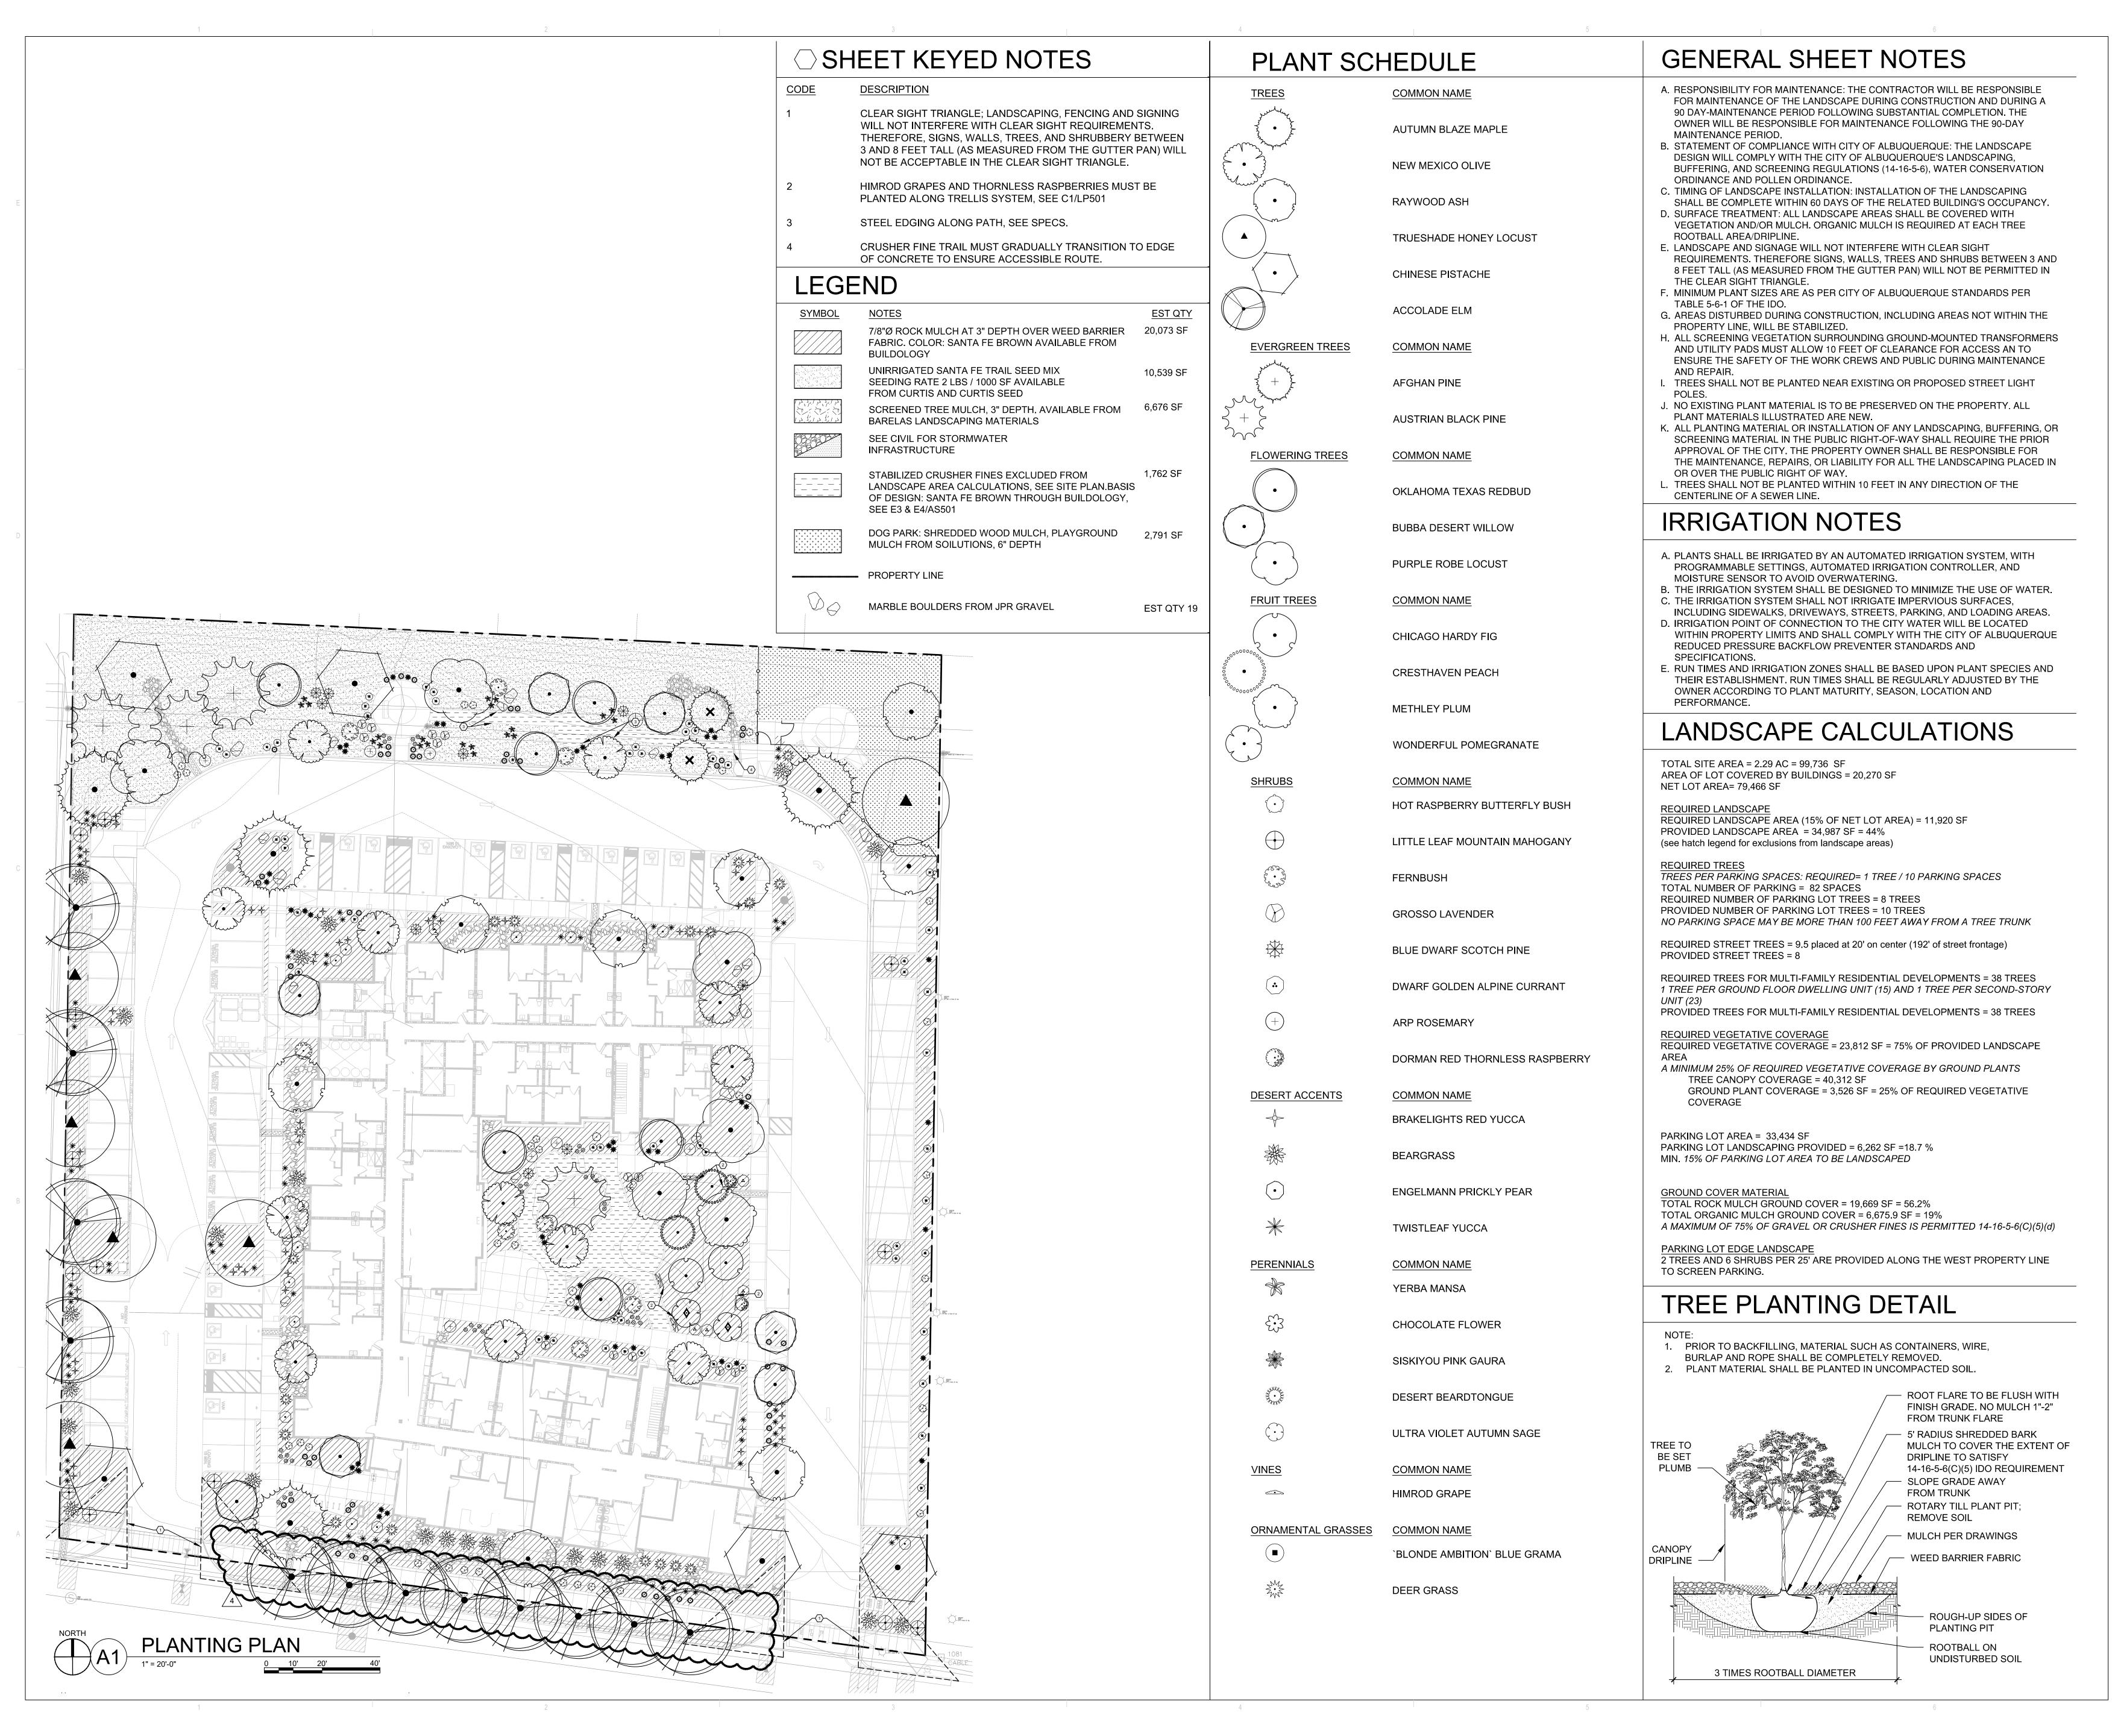

DEKKER
PERICH
SABATINI

ARCHITECTURE DESIGN INSPIRATION

ARCHITECT

ENGINEER

PROJECT

OLITO SENIOR COMMUNITY
10501 CENTRAL AVE SE
ALBUQUERQUE, NM 87123

APPLICATION TO DESIGN REVIEW BOARD (DRB)

REVISIONS

10/30/2023 ADD 003

11/17/2023 ADD 004

...

DRAWN BY E

REVIEWED BY D

DATE 08/18/202:

REVIEWED BY DS
DATE 08/18/2023
PROJECT NO. 22-0083
DRAWING NAME

PLANTING PLAN

SHEET NO.

LP101


2		3
LAN	DSCAPE MATERIALS	
SYMBOL	NOTES	EST QTY
	7/8"Ø ROCK MULCH AT 3" DEPTH OVER WEED BARRIER FABRIC BASIS. COLOR: SANTA FE BROWN AVAILABLE FROM BUILDOLOGY	20,073 SF
	UNIRRIGATED SANTA FE TRAIL SEED MIX SEEDING RATE 2 LBS / 1000 SF AVAILABLE FROM CURTIS AND CURTIS SEED	10,539 SF
	SCREENED TREE MULCH, 3" DEPTH. AVAILABLE FROM BARELAS LANDSCAPING MATERIALS	6,676 SF
	SEE CIVIL FOR STORMWATER INFRASTRUCTURE	
	STABILIZED CRUSHER FINES EXCLUDED FROM LANDSCAPE AREA CALCULATIONS, SEE SITE PLAN. BASIS OF DESIGN: SANTA FE BROWN THROUGH BUILDOLOGY, SEE E3 & E4/AS501	1,762 SF
***********	DOG PARK: SHREDDED WOOD MULCH, PLAYGROUND MULCH FROM SOILUTIONS, 6" DEPTH	2,791 SF
	DULDER, AVAILABLE FROM JPR GRAVEL TO BE SELECTED BY LANDSCAPE ARCHITECT PRIOR TO PURCHAS	E
	4'x4'x4' BOULDER	6 EA
\Diamond	3'x3'x3' BOULDER	13 EA

PLANT SCHEDULE				\mathbf{z}				
TREES SEE A2/LP501	QTY	BOTANICAL NAME	COMMON NAME	SIZE/COND.	MAT. HT.	MAT. DIA.	WATER USE	田芸三
A CONTRACTOR OF THE CONTRACTOR	4	ACER FREEMANII `AUTUMN BLAZE`	AUTUMN BLAZE MAPLE	2" CAL	40.00	30.00	LOW	X X X X X X X X X X X X X X X X X X X
SEE A3/LP501	12	FORESTIERA NEOMEXICANA	NEW MEXICO OLIVE	24" BOX, MULTI-TRUNK	15.00	15.00	MED	
2 • E	8	FRAXINUS OXYCARPA 'RAYWOOD'	RAYWOOD ASH	2" CAL.	35.00	25.00		D D S
SEE A3/LP501	6	GLEDITSIA TRIACANTHOS INERMIS 'TRUESHADE'	TRUESHADE HONEY LOCUST	24" BOX MULTI-TRUNK, 3 TRUNK MIN.	30.00	45.00		Architecture
•	5	PISTACIA CHINENSIS	CHINESE PISTACHE	2" CAL.	40.00	30.00		in Progress
	13	ULMUS X 'ACCOLADE'	ACCOLADE ELM	2" CAL	50.00	40.00		
EVERGREEN TREES	QTY	BOTANICAL NAME	COMMON NAME	SIZE/COND.	MAT. HT.	MAT. DIA.	WATER USE	STATE OF NEW METEO
SEE A2/LP501	2	PINUS ELDARICA	AFGHAN PINE	6` HT.	35.00	20.00		COURTNEY L. McKELVEY
2 + 2	4	PINUS NIGRA NIGRA	AUSTRIAN BLACK PINE	6` HT.	50.00	25.00		521 SCAPE ARCHITECTOR
FLOWERING TREES	<u>QTY</u>	BOTANICAL NAME	COMMON NAME	SIZE/COND.	MAT. HT.	MAT. DIA.	WATER USE	SEAL
SEE A2/LP501	6	CERCIS CANADENSIS TEXENSIS 'OKLAHOMA'	OKLAHOMA TEXAS REDBUD	2" CAL, B&B	15.00	15.00		
• SEE A3/LP501	7	CHILOPSIS LINEARIS 'BUBBA'	BUBBA DESERT WILLOW	24" BOX MULTI-TRUNK, 3 TRUNK MIN.	20.00	20.00		
	4	ROBINIA PSEUDOACACIA `PURPLE ROBE`	PURPLE ROBE LOCUST	2" CAL.	35.00	25.00	LOW	
FRUIT TREES	QTY	BOTANICAL NAME	COMMON NAME	SIZE/COND.	MAT. HT.	MAT. DIA.	WATER USE	PROJECT
SEE A2/LP501	2 {	FICUS CARICA 'CHICAGO HARDY'	CHICAGO HARDY FIG	15 GAL	15.00	12.00	^	
	2	PRUNUS PERSICA 'CRESTHAVEN'	CRESTHAVEN PEACH	2" CAL	15.00	15.00	3 \	
00000000000000000000000000000000000000	2	PRUNUS SALICINA `METHLEY`	METHLEY PLUM	15 GAL	20.00	20.00		
(2	PUNICA GRANATUM 'WONDERFUL'	WONDERFUL POMEGRANATE	15 GAL	10.00	10.00		>
SHRUBS SEE A1/LP501	QTY	BOTANICAL NAME	COMMON NAME	SIZE/COND.	MAT. HT.	MAT. DIA.	WATER USE	Z
	4	BUDDLEJA X 'HOT RASPBERRY'	HOT RASPBERRY BUTTERFLY BUSH	5 GAL	3.00	3.00		\geq \square_{κ}
	14	CERCOCARPUS INTRICATUS	LITTLE LEAF MOUNTAIN MAHOGANY	5 GAL	8.00	5.00		5 2 3
\$ \$ \$ \$ \$ \$ \$ \$ \$ \$ \$ \$ \$ \$ \$ \$ \$ \$ \$	8	CHAMAEBATIARIA MILLEFOLIUM	FERNBUSH	5 GAL	6.00	6.00	LOW	
	13	LAVANDULA X INTERMEDIA `GROSSO`	GROSSO LAVENDER	5 GAL	3.00	3.00		
	9	PINUS SYLVESTRIS 'GLAUCA NANA'	BLUE DWARF SCOTCH PINE	15 GAL	6.00	6.00		S RAL 300 S
•	4	RIBES ALPINUM `AUREUM`	DWARF GOLDEN ALPINE CURRANT	5 GAL	3.00	4.00		
+	8	ROSMARINUS OFFICINALIS 'ARP'	ARP ROSEMARY	5 GAL	3.50	4.00		SEN JOUE
	2	RUBUS X 'DORMAN RED'	DORMAN RED THORNLESS RASPBERRY	5 GAL	5.00	4.00		1 TO 0501 ALBU
DESERT ACCENTS SEE B2/LP501	QTY	BOTANICAL NAME	COMMON NAME	SIZE/COND.	MAT. HT.	MAT. DIA.	WATER USE	
A	44	HESPERALOE PARVIFLORA `BRAKELIGHTS`	BRAKELIGHTS RED YUCCA	5 GAL	2.50	2.50	LOW	8
	22	NOLINA MICROCARPA	BEARGRASS	5 GAL	5.00	5.00	LOW	
	14	OPUNTIA ENGELMANNII	ENGELMANN PRICKLY PEAR	5 GAL	3.00	5.00	LOW	Щ
	64	YUCCA PALLIDA	TWISTLEAF YUCCA	5 GAL	2.00	2.00		APPLICATION TO
PERENNIALS SEE A1/LP501	<u>QTY</u> 21	BOTANICAL NAME ANEMOPSIS CALIFORNICA	COMMON NAME YERBA MANSA	SIZE/COND. 1 GAL	MAT. HT. 1.50	MAT. DIA. 2.00	WATER USE	DESIGN REVIEW BOARD (DRB)
£.3	35	BERLANDIERA LYRATA	CHOCOLATE FLOWER	1 GAL	1.50	1.50		
	47	GAURA LINDHEIMERI `SISKIYOU PINK`	SISKIYOU PINK GAURA	1 GAL	2.50	2.50	MED	REVISIONS 9/22/23 ADD 001
anne e	50	PENSTEMON PSEUDOSPECTABILIS	DESERT BEARDTONGUE	5 GAL	2.00	2.00		10/30/2023 ADD 003
	32	SALVIA GREGGII `ULTRA VIOLET`	ULTRA VIOLET AUTUMN SAGE	1 GAL	1.50	2.50	LOW	
<u>VINES</u> SEE C1/LP501	<u>QTY</u>	BOTANICAL NAME	COMMON NAME	SIZE/COND.	MAT. HT.	MAT. DIA.	WATER USE	DRAWN BY EH/TC
	3	VITIS LABRUSCA `HIMROD`	HIMROD GRAPE	5 GAL	15.00	10.00		REVIEWED BY CM DATE 09/01/2023
ORNAMENTAL GRASSES SEE A1/LP501	QTY	BOTANICAL NAME	COMMON NAME	SIZE/COND.	MAT. HT.	MAT. DIA.	WATER USE	PROJECT NO. 22-0083
	56	BOUTELOUA GRACILIS `BLONDE AMBITION`	`BLONDE AMBITION` BLUE GRAMA	5 GAL	2.50	2.50	LOW	DRAWING NAME
E. E	18	MUHLENBERGIA RIGENS	DEER GRASS	5 GAL	4.00	4.00	LOW	PLANTING DETAILS



VI	SIONS		
7	9/22/23	ADD 001	
7	10/30/2023	ADD 003	
7			
7			
7			
7			
RA۱	NN BY		EH/TC
VI	EWED BY		CM
TE	Ī		09/01/2023
RO.	JECT NO.		22-0083
RA۱	WING NAN	ΛΕ	

SHEET NO.

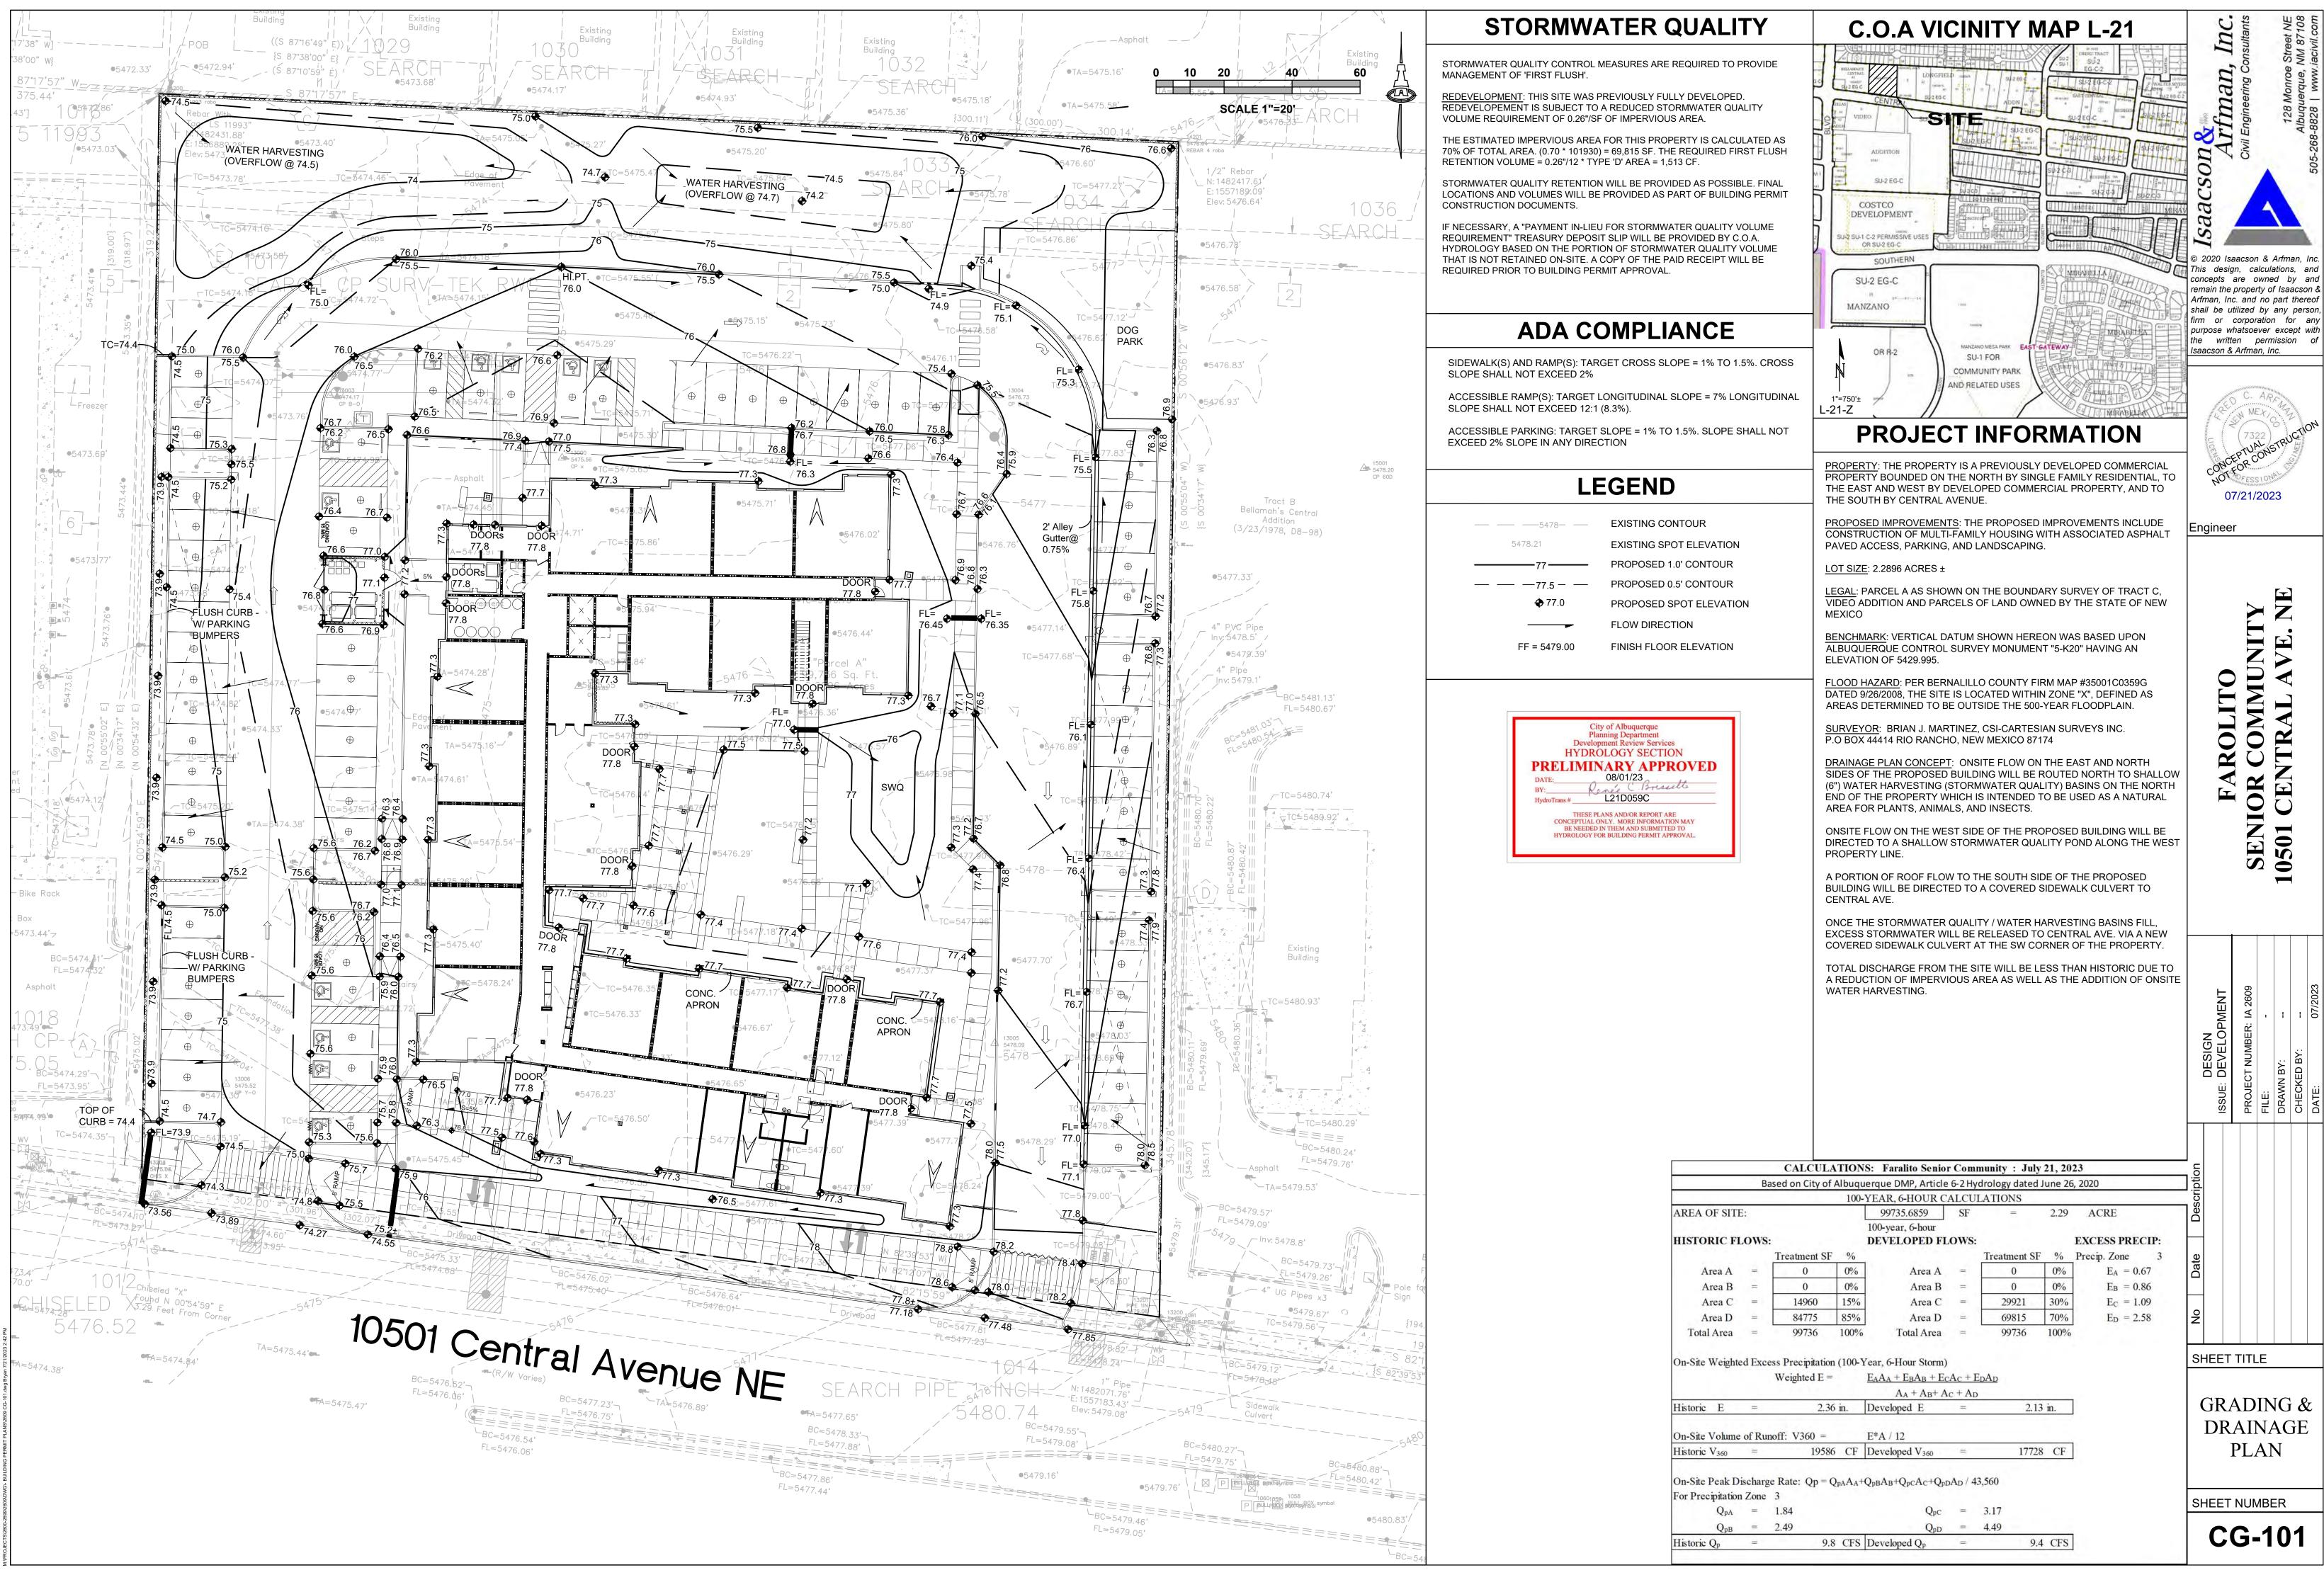

nts

NE 108

FIRE LINE

POST INDICATOR VALVE

└ X" GATE VALVE

SCALE: N.T.S.

4"-45° BEND ----

Know what's **below. Call** before you dig.

SERVICE LINE

SCALE: N.T.S.

- 8",6",4"x4" WYE

DOUBLE CLEANOUT

KEYED NOTES

WATER KEYED NOTES

- 1. REMOVE EXISTING 8" CAP AND CONNECT NEW 8"
- 2. 8" x 6" TEE.
- 3. 8" x 6" REDUCER.

WATERLINE.

- 4. 6" 11 ½° BEND. (LT=3')
- 5. 6" 45° BEND. (LT=9')
- 6. PRIVATE 6" GATE VALVE W/ BOX. (LT=46') PER ABCWUA STD DWG 2326, 2328 & 2329
- 7. PRIVATE FIRE HYDRANT PER ABCWUA STD DWG 2340. PAINTED SAFETY ORANGE.
- 8. PIV (POST INDICATOR VALVE).
- 9. $\frac{3}{4}$ " ELECTRICAL CONDUIT W/ PULL STRING FROM PIV
- 10. WALL MOUNT FDC (FIRE DEPARTMENT CONNECTION).
- 11. REMOVE 2 EXISTING 2" CAPS AND MANIFOLD TOGETHER INTO 1 - 3" WATER SERVICE LINE.

SEWER KEYED NOTES

- 20. INSTALL 4' DIA. TYPE E MANHOLE PER ABCWUA STD DWGS #2102 & #2109.
- 21. 8" SANITARY SEWER SERVICE AT 8.44% (2% MIN. SLOPE).
- 22. INSTALL DOUBLE CLEAN OUT PER DETAIL THIS SHEET.
- 23. SEE MECHANICAL PLAN FOR CONTINUATION. (INV.=5472.0)

DRY UTILITY KEYED NOTES

- 30. ELECTRIC LINE, SEE SITE ELECTRIC PLAN.
- 31. GAS LINE, SIZE TO BE DETERMINED.
- 32. EXTERNAL GAS METER WITH FULL-BORE GAS SHUT OFF VALVE DOWN STREAM OF GAS METER.

ABCWUA CONNECTION PERMIT ITEMS (NOT PART OF THIS PLAN)

- 40. PUBLIC WATERLINE AND 8" GATE VALVES W/BOX, PART OF PRIVATE FIRE SUPPRESSION LINE CONNECTION TO 10" PUBLIC WATER LINE.
- 41. 2 NEW PUBLIC 2" WATER METERS
- 42. REMOVE AND DISPOSE EXISTING WATER METER BOX, CLOSE CORP STOP AT
- 43. 4' SANITARY SEWER MANHOLE AND NEW 8" SERVICE LINE TO ROW.

GENERAL NOTES

- A. EXISTING UTILITY LINES ARE SHOWN IN AN APPROXIMATE MANNER ONLY AND MAY BE INCOMPLETE OR OBSOLETE. SUCH LINES MAY OR MAY NOT EXIST WHERE SHOWN OR NOT SHOWN. ALL UTILITIES SHOULD BE FIELD VERIFIED AND LOCATED BY THE CONTRACTOR PRIOR TO COMMENCEMENT OF ANY CONSTRUCTION. THE CONTRACTOR IS FULLY RESPONSIBLE FOR ANY AND ALL DAMAGE CAUSED BY ITS FAILURE TO LOCATE, IDENTIFY AND PRESERVE ANY AND ALL EXISTING UTILITIES, PIPELINES, AND UNDERGROUND UTILITY LINES.
- B. CONTRACTOR SHALL NOT USE VIBRATORY COMPACTION EQUIPMENT OR HEAVY VEHICLES OVER EXISTING UTILITIES.
- C. SITE STORM DRAIN, ELECTRIC LINES & TRANSFORMERS AND GAS LINES ARE SHOWN FOR GENERAL INFORMATION ONLY TO PROVIDE AN OVERVIEW OF SITE UTILITIES AND POTENTIAL CONFLICTS. SEE MECHANICAL PLANS FOR GAS LINE SIZING. SEE CG-101 FOR STORM DRAIN DESIGN.
- D. ALL WATER FITTINGS SHALL HAVE JOINT RESTRAINTS (LT). SEE RESTRAINED JOINT CRITERIA NOTES THIS SHEET. (LT) LENGTH SHOWN ON KEYED NOTES.
- E. ALL ABOVE GROUND UTILITY EQUIPMENT AND FITTINGS SHALL BE PAINTED IN COLORS TO MATCH BUILDING COLORS.
- F. WATERLINES 4" IN DIAMETER OR LARGER SHALL BE PVC PIPE MEETING
- AWWA C900 DR-18 REQUIREMENTS. G. SANITARY SEWER LINE MATERIALS SHALL BE PVC SDR-35 PIPE.
- H. COORDINATION WITH WATER AUTHORITY CROSS CONNECTION SECTION WILL BE REQUIRED TO ENSURE PROPER BACKFLOW CONTAINMENT IS IN PLACE PRIOR TO RELEASE OF METER FOR THE SITE. CONTACT THE CROSS CONNECTION SECTION AT 505-289-3454.
- J. COORDINATION WITH THE WATER AUTHORITY PRE-TREATMENT ENGINEER IS REQUIRED TO ENSURE THE SITE COMPLIES WITH WATER AUTHORITY SEWER USE ORDINANCE. CONTACT THE PRE-TREATMENT ENGINEER AT 505-289-3439.

RESTRAINED JOINT CRITERIA FOR WATERLINE FITTINGS

- 1. ALL MECHANICAL JOINTS SHALL BE RESTRAINED AT THE FITTINGS PER KEYED NOTES THIS SHEET.
- 2. THE CONTRACTOR SHALL PROVIDE A MINIMUM PIPE LENGTH OF 20 LF FROM ALL MECHANICAL JOINTS. ALL PIPE JOINTS WITHIN 20 LF OF A MECHANICAL JOINT SHALL BE RESTRAINED AT THE CONTRACTOR'S EXPENSE.
- 3. THE CONTRACTOR SHALL RESTRAIN ALL PIPE JOINTS IN THE SPECIFIED DISTANCE LISTED IN THE KEYED NOTES.
- 4. THE CONTRACTOR SHALL RESTRAIN ALL FIRE HYDRANT JOINTS FROM THE TEE ON THE MAIN TO THE FIRE HYDRANT FLANGE.


DEPTH OF BURY: 3.0 FT. MINIMUM MATERIAL:

SOIL TYPE: GM/SM - SILTY GRAVELS AND SILTY SANDS, GRAVEL-SAND-SILT MIXTURES.

TEST PRESSURE: 150 PSI

TRENCH TYPE 4: PIPE BEDDED IN SAND, GRAVEL, OR CRUSHED STONE TO DEPTH OF 1/8 PIPE DIAMETER, 4 INCH MINIMUM; BACKFILL COMPACTED TO TOP OF PIPE.

DIFFERENT CRITERIA, E.G., GREATER DEPTH OF BURY, ETC., WILL REQUIRE DIFFERENT RESTRAINED LENGTHS. THESE MUST BE CALCULATED BY A QUALIFIED PROFESSIONAL ENGINEER AND APPROVED BY ABCWUA.

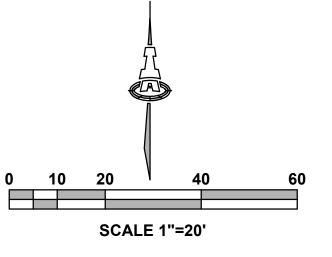

LEGEND

	OLIND
w	EXISTING WATERLINE
Q	EXISTING FIRE HYDANT
\bowtie	EXISTING WATER VALVE
	EXISTING SEWER LINE
 	EXISTING SEWER MANHOLE
	NEW FIRE LINE
M	NEW WATER VALVE
•	NEW FIRE HYDANT
\	NEW FDC
8	NEW PIV
	NEW SEWER LINE
\bowtie	PUBLIC WATER VALVE
\triangleleft	PUBLIC FIRE HYDANT
(LT=X')	DISTANCE JOINTS TO BE RESTRAINED FROM

FITTING OR VALVE



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DATE DRAWING NAME UTILITY **PLAN**

CU101

PROJECT **LINNWWO**

Architecture

in Progress

ISSUED FOR PERMIT


REVISIONS

SENIOR

DRAWN BY JTS/BJB/DEC **REVIEWED BY** FCA/IMA 09/01/2023 PROJECT NO. IA 2609 22-0083



Architecture in Progress

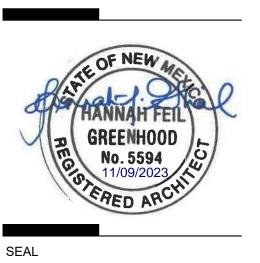

PROJECT

ISSUED FOR **PERMIT**

REVISIONS	
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DRAWN BY	В
REVIEWED BY	CW\
DATE	05/14/2
PROJECT NO:	22-008
DRAWING NAME	


EXTERIOR ELEVATIONS -SOUTH AND WEST

SHEET NO

SDP 4.1



Architecture in Progress

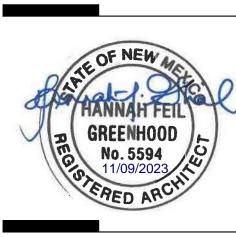

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REVISIONS DRAWN BY CWW **REVIEWED BY** DATE 05/14/23 PROJECT NO: 22-0083

DRAWING NAME

EXTERIOR ELEVATIONS -NORTH AND EAST

SHEET NO

SDP 4.2